Madison Metropolitan School District Randall Elementary School - 5th Addition - 2016

1802 Regent St. Madison, WI 53726



414 359 3060 209 south water street milwaukee, wisconsin 53204 2310 crossroads drive suite 2000 madison, wisconsin 53718 608 240 9900 205 north orange avenue suite 202 sarasota, florida 34236 941 348 3618

intelligent designs. inspired results.

www.prarch.com

Sheet Index

000 TITLE SHEET

General

EXISTING CONDITIONS MAP OVERALL SITE PLAN SITE DEMOLITION PLAN

DETAIL SITE PLAN GRADING PLAN

DETAILS

LIFE SAFETY PLANS AND DEMOLITION PLANS

EXISTING CONDITIONS PHOTOS

EXTERIOR ELEVATIONS

Project Information

Project Date: 08 MAR 16 PRA Project Number: 140248-14 Owner Project Number: 026_Addition_2016

CITY OF MADISON - LANDMARKS COMMISSION PERMIT APPLICATION

Applicable Codes and Zoning

International Building Code (IBC) 2009 International Existing Building Code (IEBC) 2009 Wisconsin Commercial Building Code SPS 360-366 Educational Occupancy, Group E Zoning: City of Madison Ordinances

Type of Construction

Existing Building - Type VB, Unprotected - Non-Sprinklered New Construction (Addition) - Type IIB, Unprotected - Non-Sprinklered

ADA Access Route

Refer to Sheet A050

Building Area

Existing Building:	
Basement Floor:	24,907 SQ FT
First Floor:	23,881 SQ FT
Second Floor:	21,027 SQ FT


Remodel Area: 420 SQ FT Basement Floor: 376 SQ FT First Floor: 0 SQ FT Second Floor:

Second Floor:

0 SQ FT Basement Floor: 151 SQ FT

151 SQ FT

Project Location

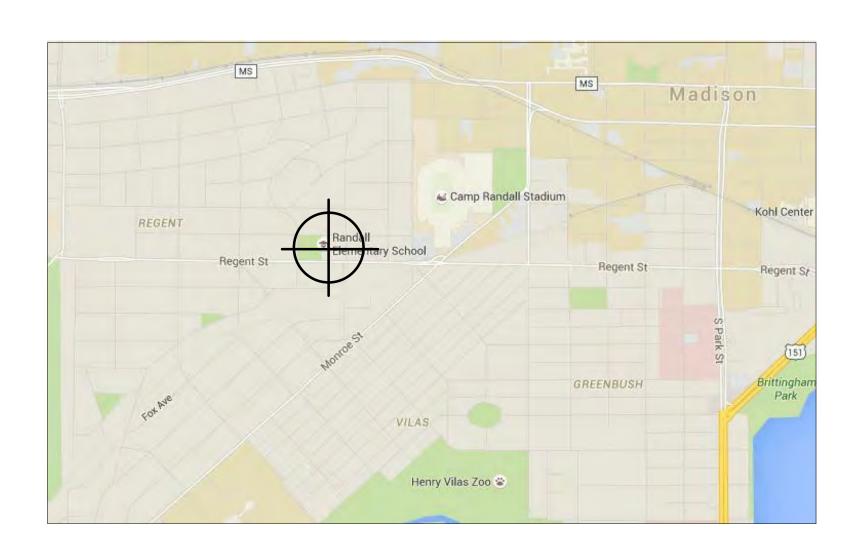

Project Team

OWNER

MADISON METROPOLITAN SCHOOL DISTRICT Tel (608) 204-7900 4711 Pflaum Road Madison, WI 53718

CIVIL

WYSER ENGINEERING, LLC 201 1/2 E. Main Street Mt. Horeb, WI 53572

CIVIL

KJWW Engineering Consultants 1800 Deming Way, Suite 200 Middleton, WI 53562

STRUCTURAL

KJWW Engineering Consultants 1800 Deming Way, Suite 200 Middleton, WI 53562

PLUMBING

KJWW Engineering Consultants 1800 Deming Way, Suite 200 Middleton, WI 53562

MECHANICAL

KJWW Engineering Consultants 1800 Deming Way, Suite 200 Middleton, WI 53562

ELECTRICAL

KJWW Engineering Consultants 1800 Deming Way, Suite 200 Middleton, WI 53562

Tel (608) 223-9600

Tel (608) 843-3388


Tel (608) 223-9600

Tel (608) 223-9600

Tel (608) 223-9600

Tel (608) 223-9600

REGENT STREET

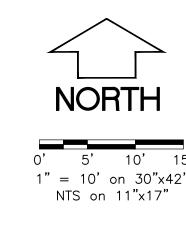





I80

COUNTY,

DISON,

Revisions: 00/00/00 Addendum No. 1 15-0292 Number

PERMIT

08 MAR 16

1. FIELD WORK PERFORMED BY WYSER ENGINEERING, LLC. ON NOVEMBER 19TH, 2015.

BENCHMARK

CLEAN OUT UNKNOWN

- 2. NORTH REFERENCE FOR THIS TOPOGRAPHIC AND UTILITY MAP ARE BASED ON THE WISCONSIN COUNTY COORDINATE SYSTEM GRID NORTH ~ TRUE NORTH.
- 3. ELEVATIONS ARE BASED ON THE NORTH AMERICAN VERTICAL DATUM OF 1988 (NAVD88). 4. SUBSURFACE UTILITIES AND FIXTURES SHOWN ON THIS MAP HAVE BEEN APPROXIMATED BY LOCATING SURFACE FEATURES AND ACCESSORIES, DIGGERS HOTLINE FIELD MARKINGS AND EXISTING MAPS AND RECORDS.
- 5. BEFORE EXCAVATION, APPROPRIATE UTILITY COMPANIES SHOULD BE CONTACTED. FOR EXACT LOCATION OF UNDERGROUND UTILITIES, CONTACT DIGGERS HOTLINE, AT 1.800.242.8511 OR 811
- 6. THE ACCURACY OF THE BENCHMARKS SHOWN ON THIS MAP SHALL BE VERIFIED BEFORE USE. WYSER ENGINEERING, LLC. DOES NOT WARRANT THE ACCURACY OF THESE BENCHMARKS. 7. THIS PARCEL IS SUBJECT TO ALL EASEMENTS AND AGREEMENTS, BOTH RECORDED AND

BENCHMARK TABLE		
BM LABEL	ELEVATION	DESCRIPTION
BM - 1	909.27	FINISHED FLOOR ELEVATION INSIDE RANDALL ELEM.
BM - 2	904.79	PK NAIL IN CENTER OF RANDALL ELEM. COURTYARD
BM - 3	911.71	PK NAIL IN ELEVATED PLAYGROUND WEST OF BUILDING

\$HEETS: C101, C102, C200

60 BIKE STALLS LOCATED IN THIS — AREA

TO REMAIN.

— DUMPSTER LOCATED IN THIS AREA

MADISON PARKS PROPERTY

DUMPSTER LOCATED IN THIS AREA

SCHOOL DISTRICT PROPERTY

EXISTING 22 STALL PARKING LOT

EXISTING

BUILDING

TO REMAIN.

REGENT STREET

BUILDING FOOTPRINT ASPHALT PAVEMENT $1" = 20' \text{ on } 30' \times 42'$

1. UNDERLYING SITE CONTOURS AND INFORMATION BASED ON TOPOGRAPHIC & UTILITY DATA AS WAS SHOT IN THE FIELD THE WEEK OF NOVEMBER 16TH, 2015. WYSER ENGINEERING SHALL NOT BE HELD RESPONSIBLE FOR ANY ERRORS OR OMISSIONS THAT MAY ARISE AS A RESULT OF ERRONEOUS OR INCOMPLETE INFORMATION PROVIDED BY OTHERS. CONTRACTOR TO CONFIRM ALL ELEVATIONS,

- 2. BENCHMARK INFORMATION CAN BE FOUND ON THE EXISTING CONDITIONS MAP. THE BENCHMARK LOCATIONS ARE SHOWN FOR REFERENCE ONLY ON THIS PLAN. THE BENCHMARKS SHALL BE VALIDATED BY LICENSED LAND SURVEYOR PRIOR TO CONSTRUCTION. CONTRACTOR ASSUMES RISK ASSOCIATED
- 3. CONTRACTOR TO OBTAIN APPROPRIATE PERMITS FOR STREET OPENINGS & TO WORK WITHIN THE CITY'S
- 4. WYSER ENGINEERING SHALL BE HELD HARMLESS AND DOES NOT WARRANT ANY DEVIATIONS BY THE OWNER OR CONTRACTOR FROM THE APPROVED CONSTRUCTION PLANS THAT MAY RESULT IN DISCIPLINARY ACTIONS BY REGULATORY AGENCIES.
- 5. IF ANY ERRORS, DISCREPANCIES, OR OMISSIONS WITHIN THE PLAN BECOME APPARENT, IT SHALL BE BROUGHT TO THE ATTENTION OF THE ENGINEER PRIOR TO CONSTRUCTION SO THAT CLARIFICATION OR REDESIGN MAY OCCUR.
- 6. ALL MUNICIPAL UTILITY CONNECTIONS, WORK IN ROW, PUBLIC OUTLOTS AND PUBLIC EASEMENTS SHALL BE IN ACCORDANCE WITH CITY OF MADISON STANDARD SPECIFICATIONS FOR PUBLIC WORKS CONSTRUCTION- LATEST EDITION.

SITE INFORMATION BLOCK: SITE ADDRESS: 1802 REGENT STREET LOT ACREAGE: 1.32 AC

SITE DISTURBANCE AS PART OF THIS PROJECT: 1,000 SF PERCENT OF SITE DISTURBANCE TO LOT ACREAGE: 1.7% USE OF PROPERTY: INSTITUTIONAL

TOTAL NUMBER OF EXISTING/PROPOSED PARKING STALLS: STANDARD: 32 ACCESSIBLE: 2

TOTAL NUMBER OF EXISTING/PROPOSED BIKE STALLS: 60

- EXISTING IMPERVIOUS AREA WITHIN SITE DISTURBANCE LIMITS: ROOFTOP: 0 SF PAVEMENT: 995 SF IMPERVIOUS RATIO OF DISTURBANCE LIMITS: 1.0
- REDEVELOPMENT IMPERVIOUS AREA: ROOFTOP: 306 SF

PAVEMENT: 689 SF

- MAINTENANCE IMPERVIOUS AREA (INCLUDED IN DISTURBED ROOFTOP: 0 SF PAVEMENT: 0 SF
- FINAL IMPERVIOUS AREA WITHIN SITE DISTURBANCE LIMITS: ROOFTOP: 306 SQ.FT. PAVED: 689 SQ.FT. TOTAL IMPERVIOUS AREA: 995 SQ.FT. IMPERVIOUS RATIO OF DISTURBANCE LIMITS: 1.0

NTS on 11'x17'

Sheet No.:

Toll Free (800) 242-8511 -or- 811


Hearing Impaired TDD (800) 542-2289


www.DiggersHotline.com

NORTH ROBY


OVERALL SITE PLAN

1" = 20'

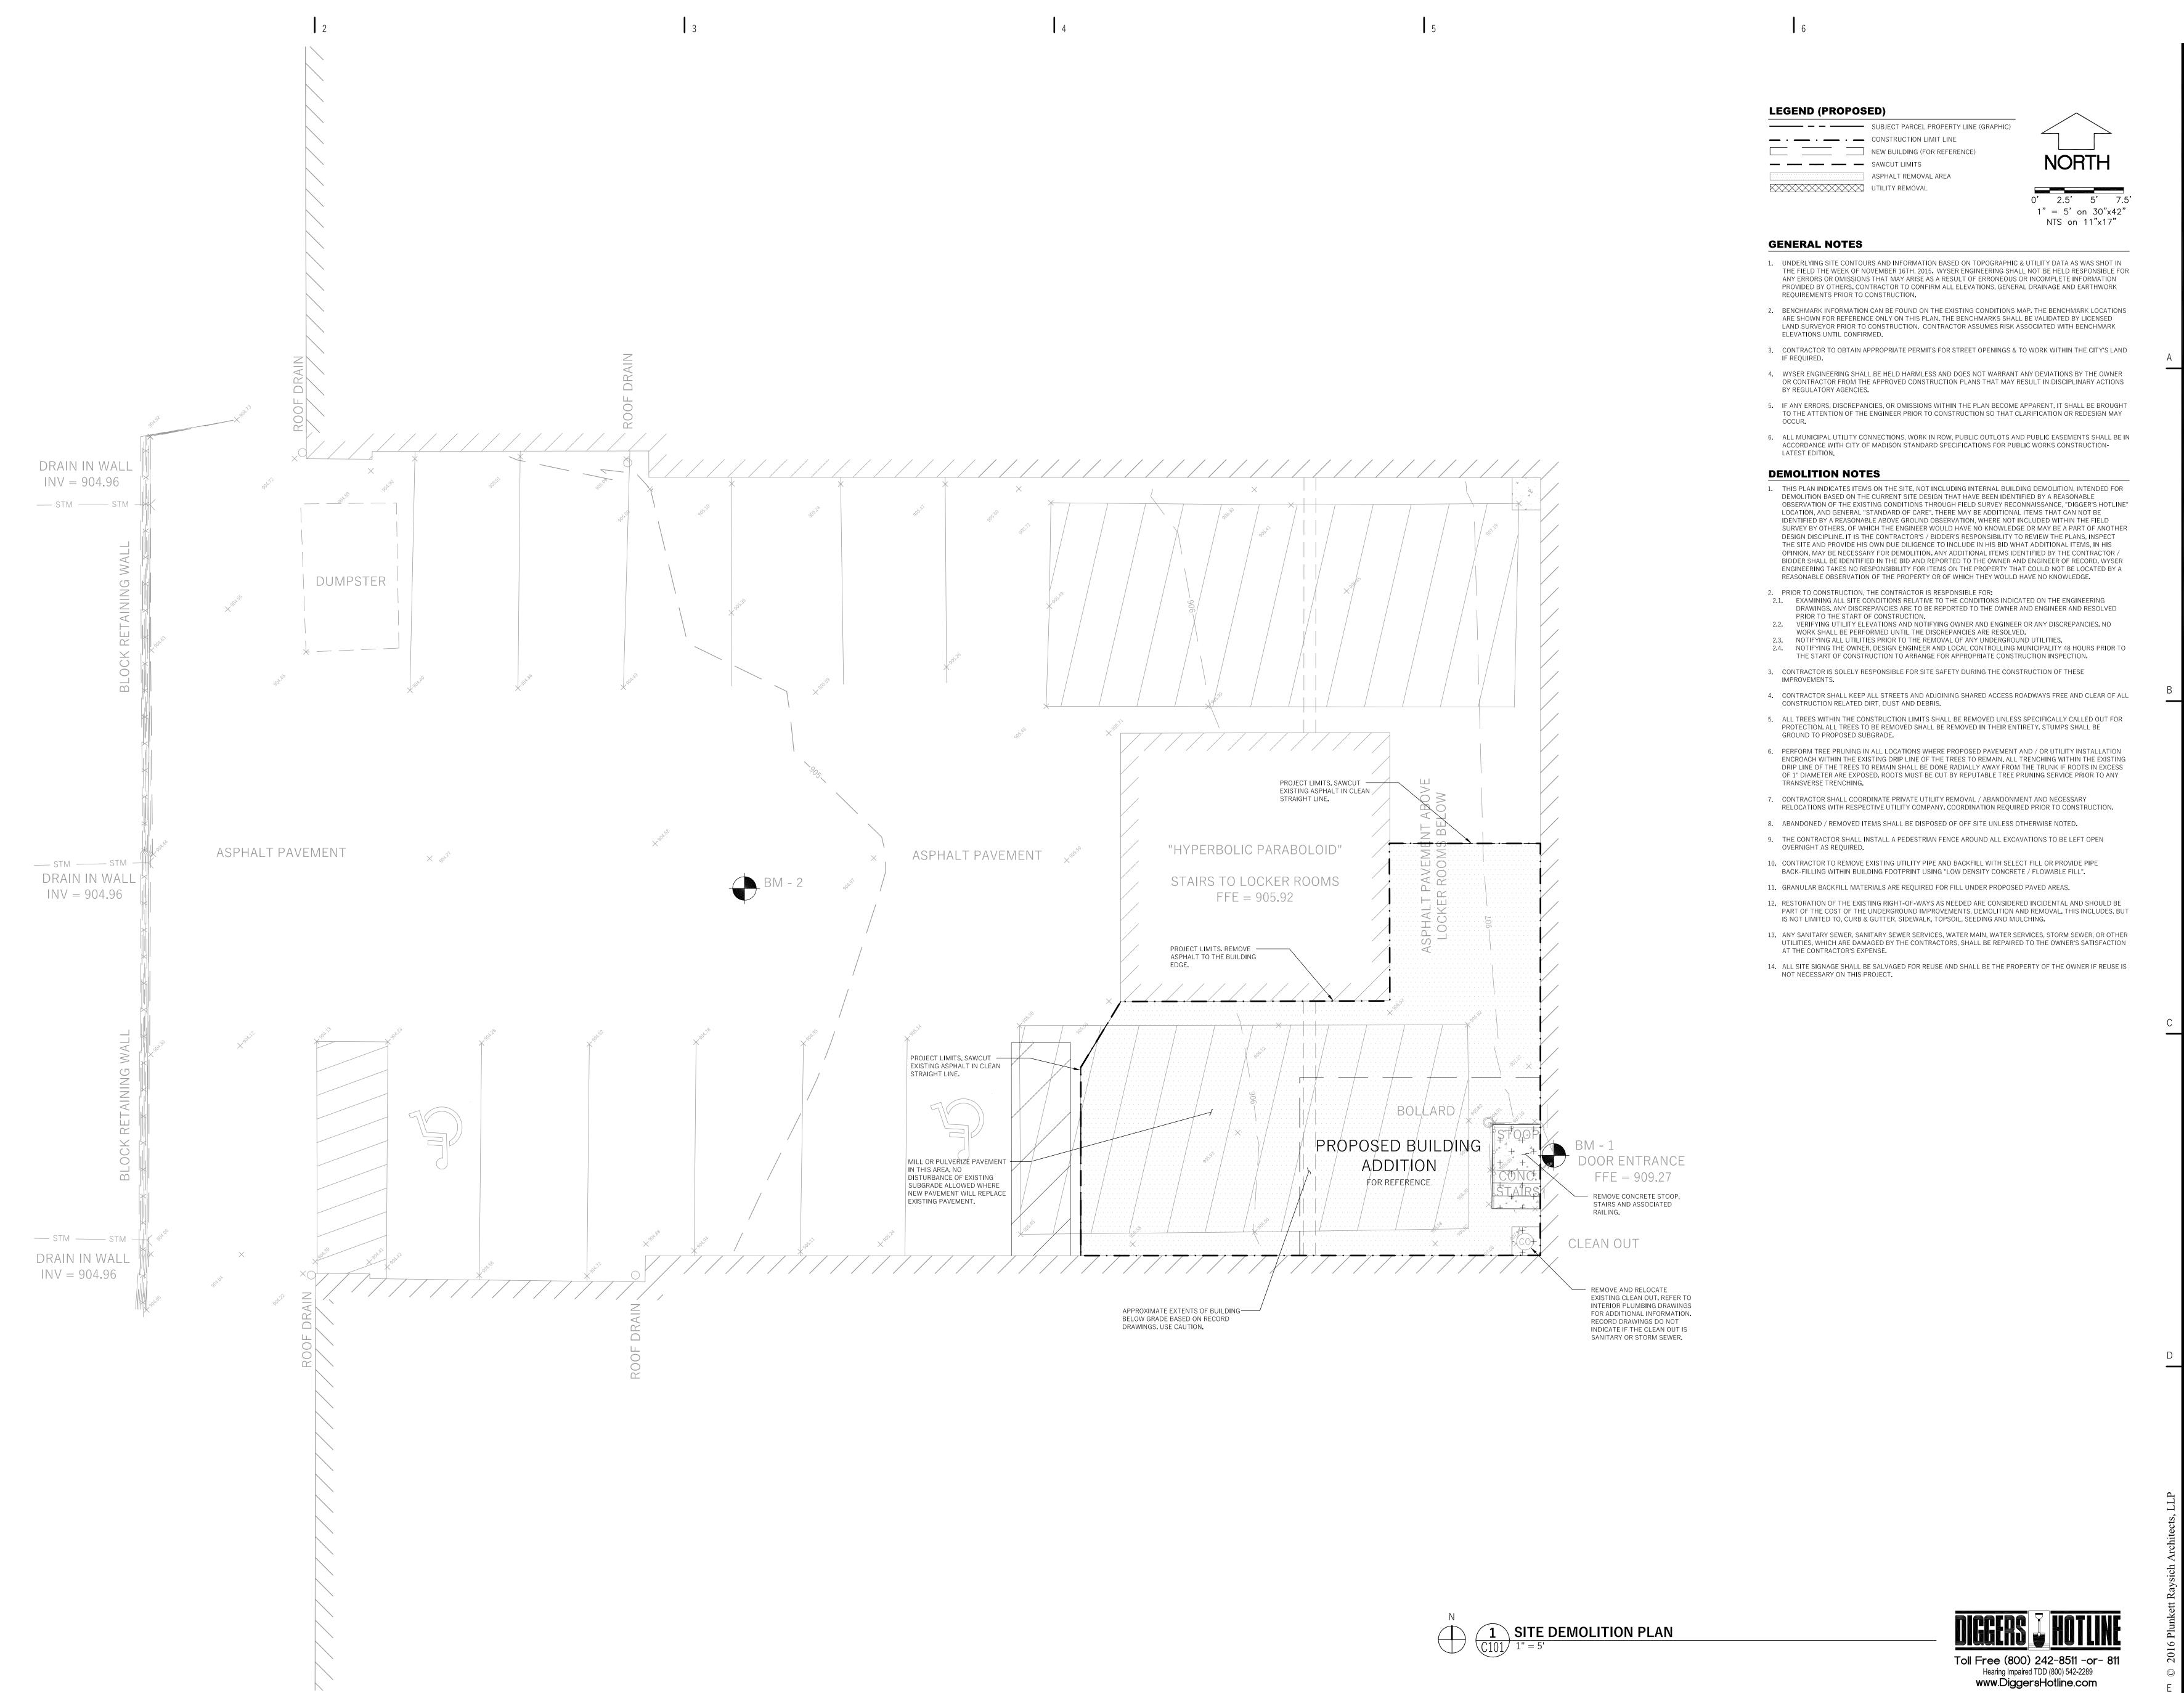

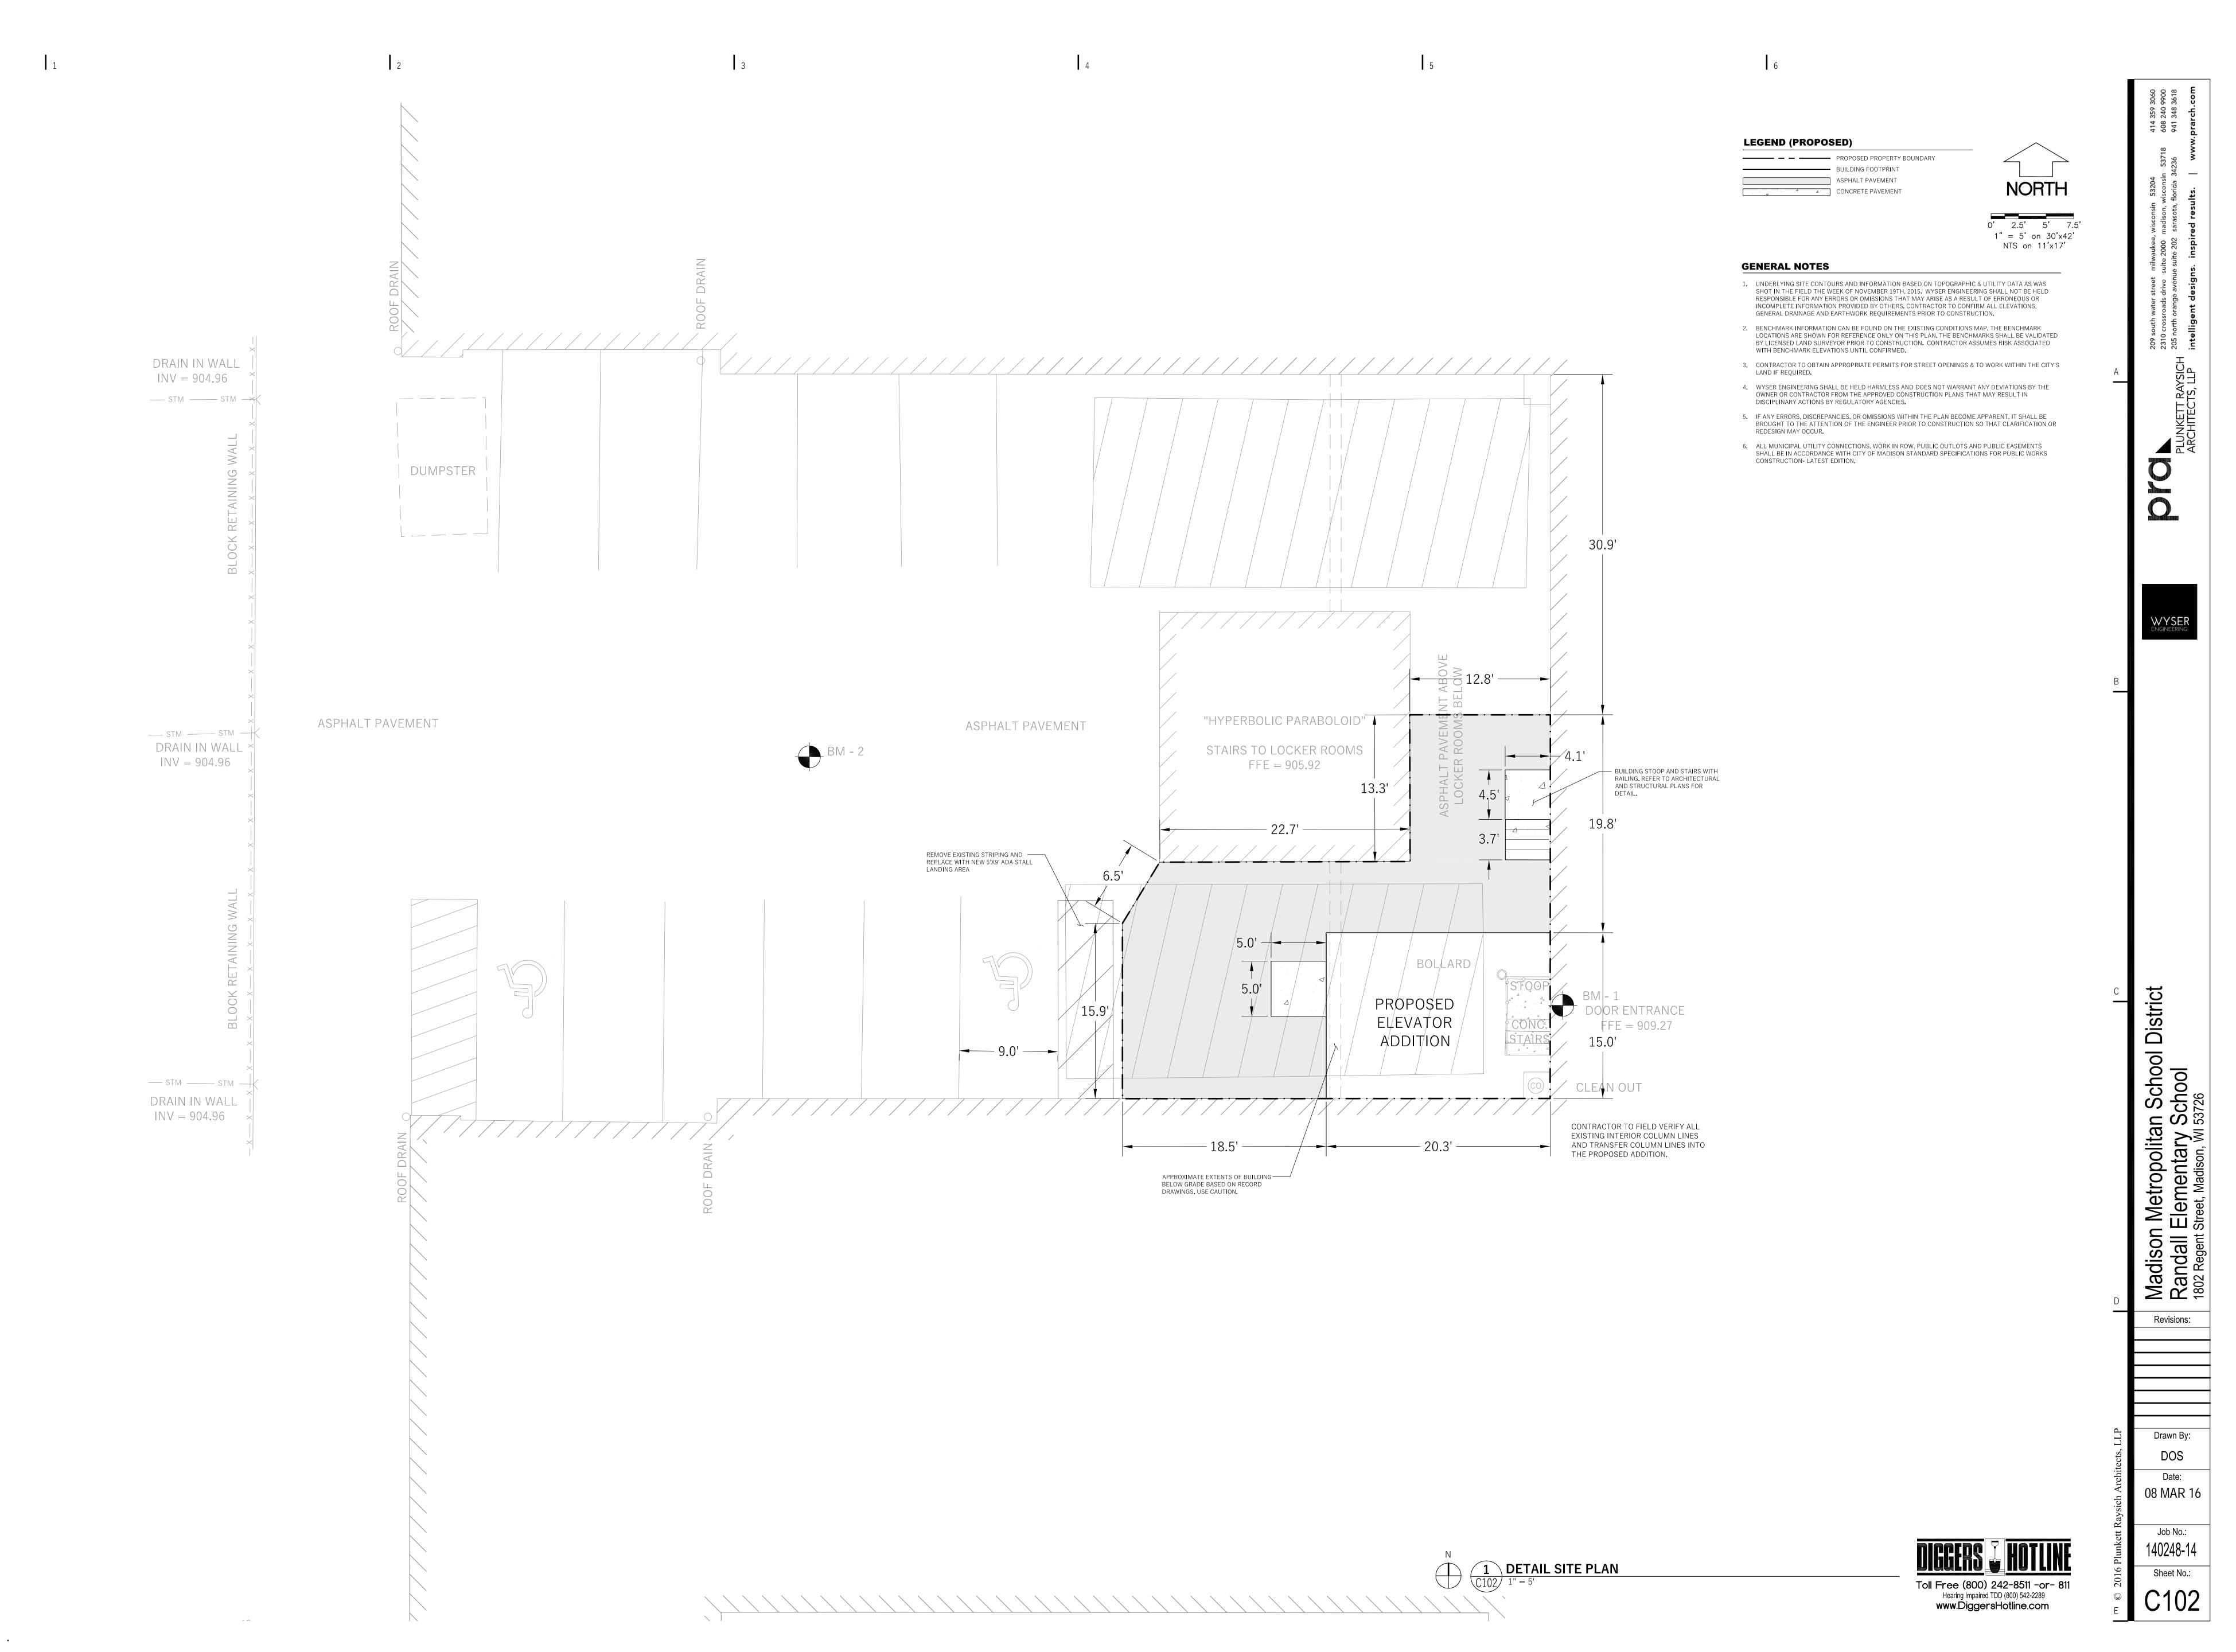

Plunkett Raysich Architects, LLP — March 04, 2016 — 4:20pm W:\2015\150292_PRA — MMSD-Randall Elementary\Dwg\15-0292_Civil Design.dwg [Site Plan

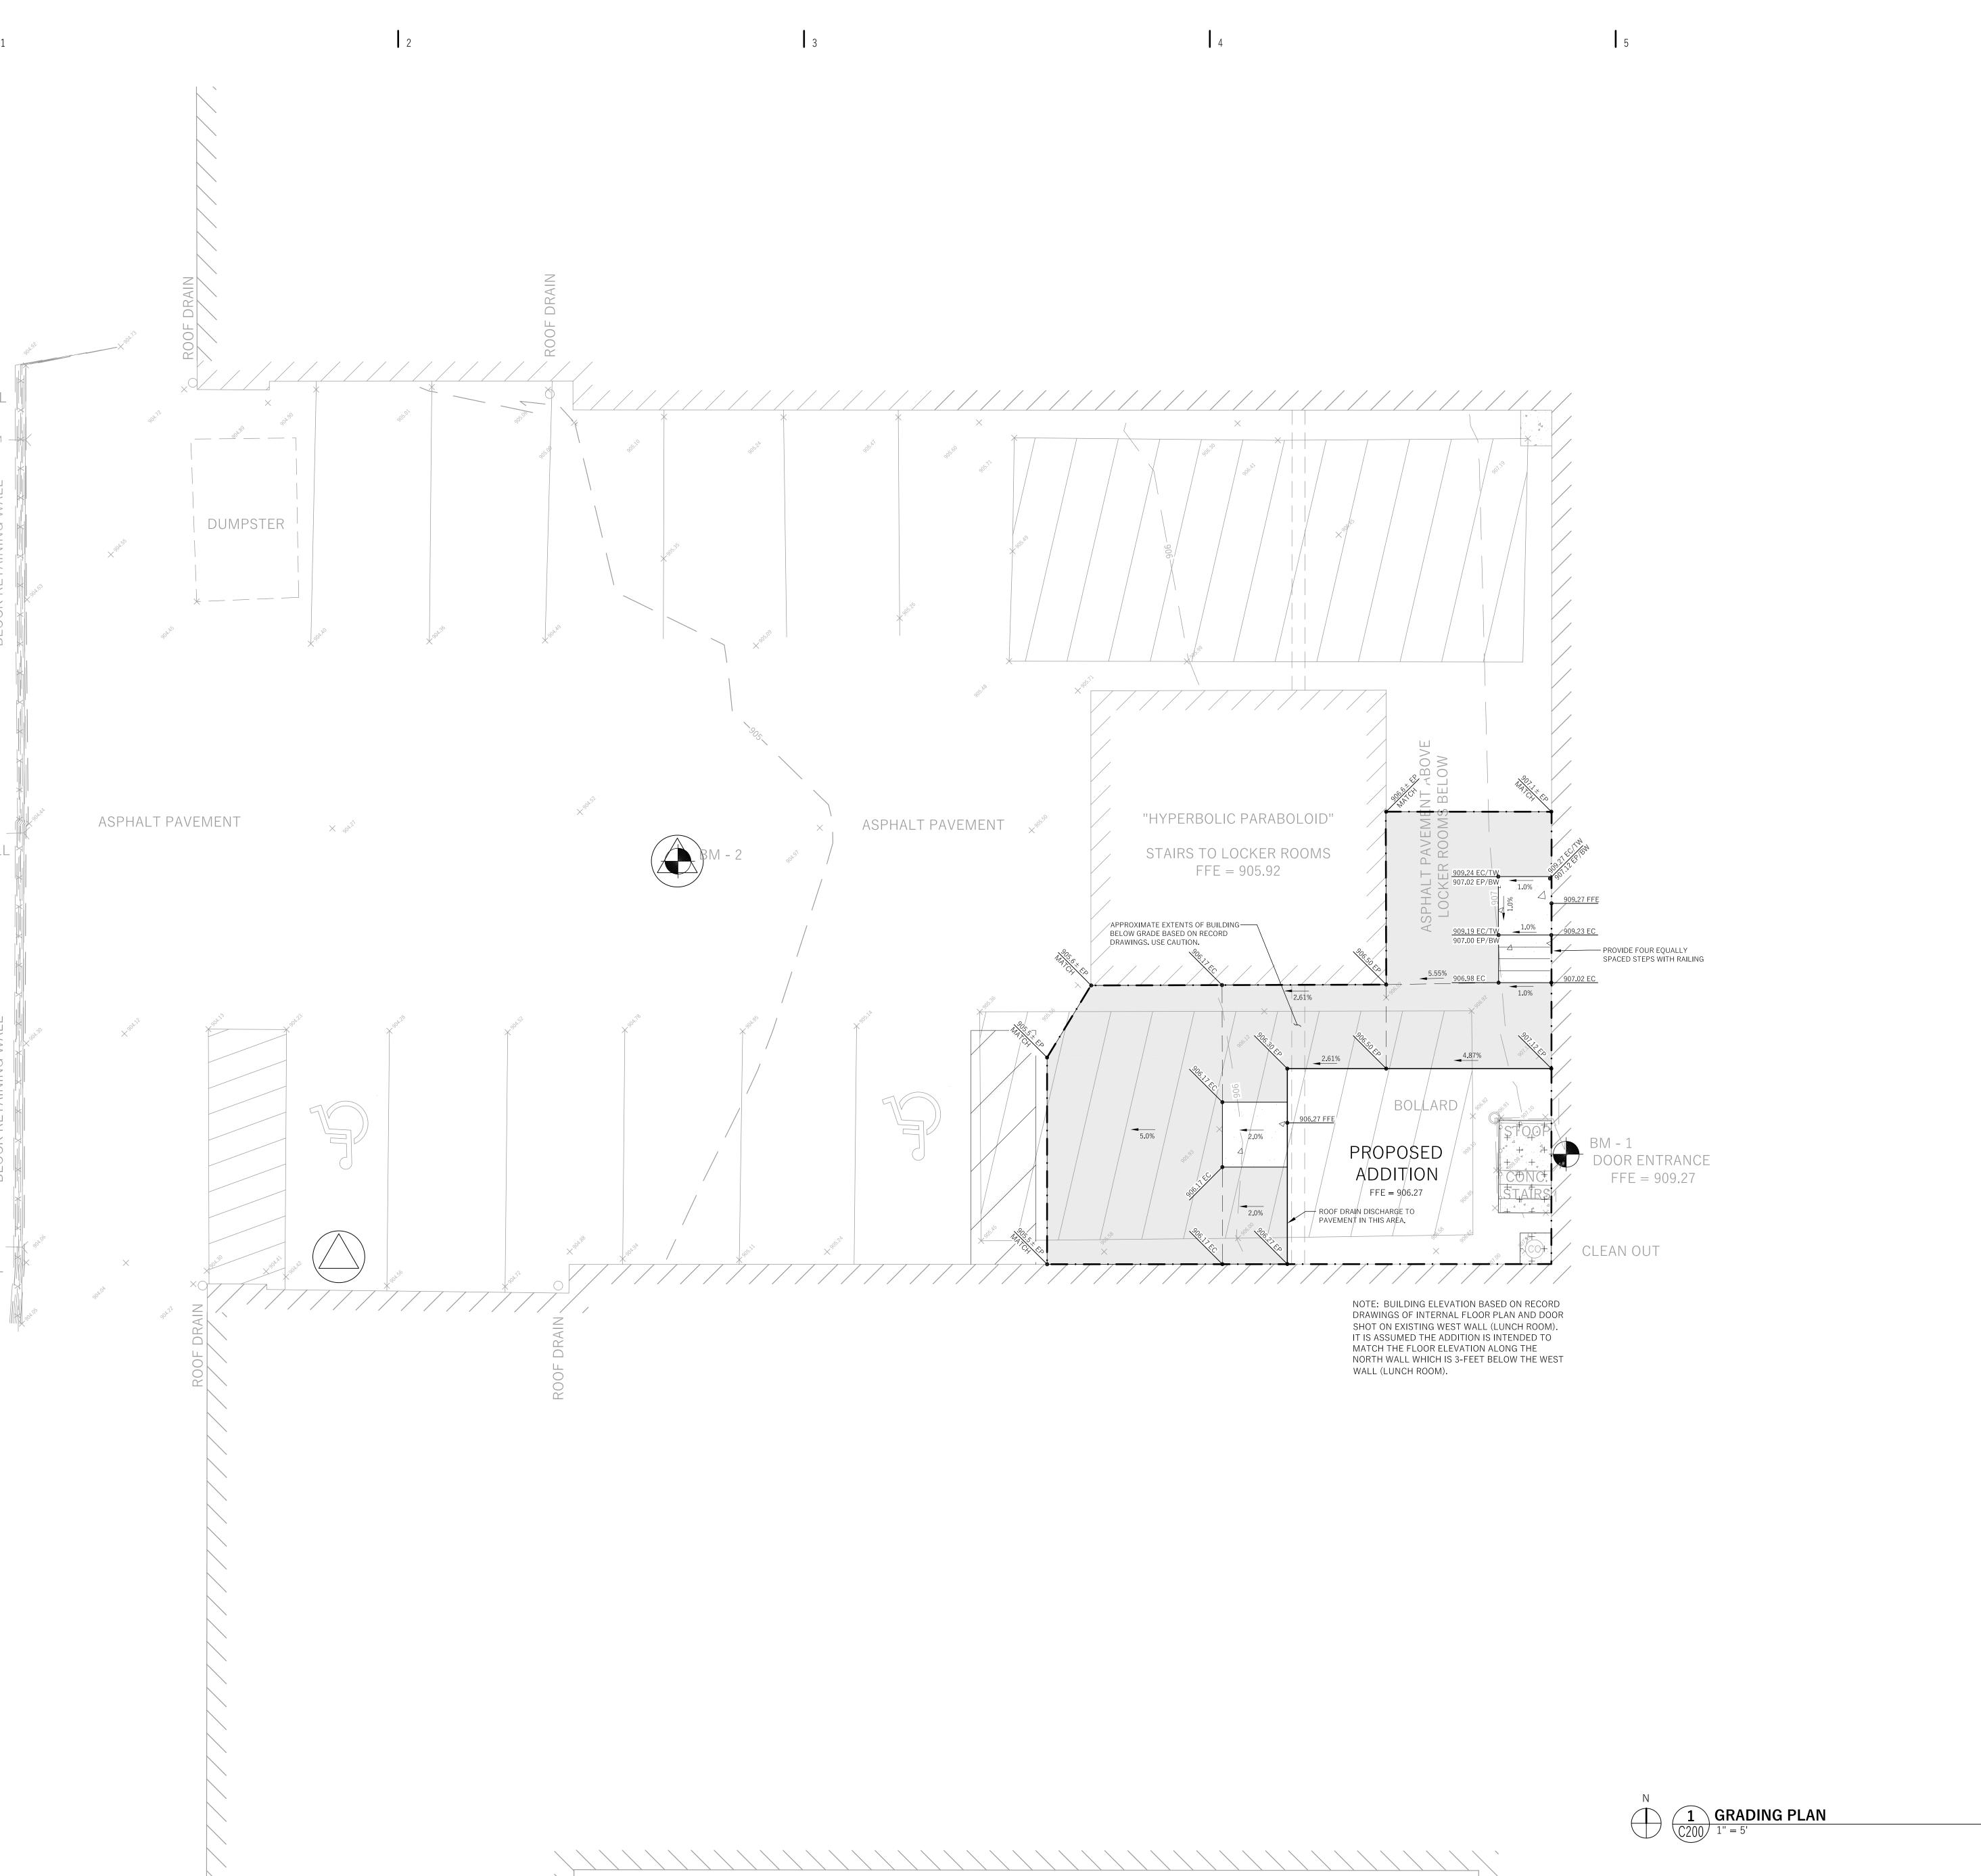

LEGEND (PROPOSED)

PROPERTY BOUNDARY

BUILDING FOOTPRINT

ASPHALT PAVEMENT

CONCRETE PAVEMENT

PROPOSED MAJOR CONTOUR

PROPOSED MINOR CONTOUR

906 PROPOSED MINOR CONTOUR

SPOT GRADE

DRAINAGE GRADE BREAK



0' 5' 10' 15' 1" = 10' on 30'x42'

NTS on 11'x17'

GENERAL NOTES

1. UNDERLYING SITE CONTOURS AND INFORMATION BASED ON TOPOGRAPHIC & UTILITY DATA AS WAS SHOT IN THE FIELD THE WEEK OF NOVEMBER 29TH, 2015. WYSER ENGINEERING SHALL NOT BE HELD RESPONSIBLE FOR ANY ERRORS OR OMISSIONS THAT MAY ARISE AS A RESULT OF ERRONEOUS OR INCOMPLETE INFORMATION PROVIDED BY OTHERS. CONTRACTOR TO CONFIRM ALL ELEVATIONS, GENERAL DRAINAGE AND EARTHWORK REQUIREMENTS PRIOR TO CONSTRUCTION.

DRAINAGE ARROW

- 2. BENCHMARK INFORMATION CAN BE FOUND ON THE EXISTING CONDITIONS MAP. THE BENCHMARK LOCATIONS ARE SHOWN FOR REFERENCE ONLY ON THIS PLAN. THE BENCHMARKS SHALL BE VALIDATED BY LICENSED LAND SURVEYOR PRIOR TO CONSTRUCTION. CONTRACTOR ASSUMES RISK ASSOCIATED WITH BENCHMARK ELEVATIONS UNTIL CONFIRMED.
- 3. CONTRACTOR TO OBTAIN APPROPRIATE PERMITS FOR STREET OPENINGS & TO WORK WITHIN THE CITY'S LAND IF REQUIRED.
- 4. WYSER ENGINEERING SHALL BE HELD HARMLESS AND DOES NOT WARRANT ANY DEVIATIONS BY THE OWNER OR CONTRACTOR FROM THE APPROVED CONSTRUCTION PLANS THAT MAY RESULT IN DISCIPLINARY ACTIONS BY REGULATORY AGENCIES.

5. IF ANY ERRORS, DISCREPANCIES, OR OMISSIONS WITHIN THE PLAN BECOME APPARENT, IT SHALL BE

BROUGHT TO THE ATTENTION OF THE ENGINEER PRIOR TO CONSTRUCTION SO THAT CLARIFICATION OR REDESIGN MAY OCCUR.

6. ALL MUNICIPAL UTILITY CONNECTIONS, WORK IN ROW, PUBLIC OUTLOTS AND PUBLIC EASEMENTS SHALL BE

IN ACCORDANCE WITH CITY OF MADISON STANDARD SPECIFICATIONS FOR PUBLIC WORKS CONSTRUCTION-LATEST EDITION.

CONSTRUCTION SITE EROSION CONTROL REQUIREMENTS 1. ALL EROSION AND SEDIMENT CONTROL PRACTICES SHALL BE IMPLEMENTED IN ACCORDANCE WITH THE

- CURRENT WISCONSIN DEPARTMENT OF NATURAL RESOURCES (WDNR) EROSION AND SEDIMENT CONTROL TECHNICAL STANDARDS (dnr.wi.gov).
- EROSION AND SEDIMENT CONTROL MEASURES SHALL BE INSTALLED PRIOR TO SITE DISTURBANCE.
 ENGINEER / OWNER / CITY OF MADISON HAS THE RIGHT TO REQUIRE CONTRACTOR TO IMPLEMENT ADDITIONAL EROSION CONTROL MEASURES AS NECESSARY. CONTRACTOR MUST NOTIFY THE CITY OF MADISON BUILDING INSPECTOR TWO (2) WORKING DAYS IN ADVANCE OF ANY SOIL DISTURBANCE
- 4. EROSION AND SEDIMENT CONTROL PRACTICES SHALL BE INSPECTED ONCE PER WEEK AND FOLLOWING EACH RAINFALL EVENT. INSPECTION REPORTING SHALL BE IN ACCORDANCE WITH MUNICIPAL REQUIREMENTS SHALL BE THE RESPONSIBILITY OF THE CONTRACTOR.
- 5. IT IS THE CONTRACTOR'S RESPONSIBILITY TO MAINTAIN EROSION AND SEDIMENT CONTROL PRACTICES IN WORKING ORDER. EROSION CONTROL MEASURES SHALL BE REMOVED ONLY AFTER SITE CONSTRUCTION IS
- 6. DEWATERING PRACTICES SHALL COMPLY WITH TECHNICAL STANDARD 1061.

COMPLETE WITH ALL SOIL SURFACES HAVING AN ESTABLISHED VEGETATIVE COVER.

- 7. ALL SLOPES EXCEEDING 25% (4:1) SHALL BE STABILIZED WITH A CLASS I, TYPE B EROSION MAT.
- 8. DUST CONTROL SHALL BE MITIGATED IN ACCORDANCE WITH WDNR TECHNICAL STANDARD 1068.
- 9. ALL DISTURBED AREAS SHALL BE SEEDED AND MULCHED IMMEDIATELY FOLLOWING FINAL GRADING
- SEED MIX AND RATE SHALL BE, AT A MINIMUM, IN ACCORDANCE WITH WDNR TECHNICAL STANDARD 1059.
 PRIOR TO CONSTRUCTION, CONTRACTOR SHALL PROVIDE VEGETATION PLAN FOR ENGINEER / OWNER FOR APPROVAL.

\\/\Y\$E!

<u>C</u>

dison Metropolitan Schoo Idall Elementary School

Revisions

Revisions:

Drawn By: DOS

08 MAR 16

Job No.:


Job No.: 140248-14
Sheet No.:

Toll Free (800) 242-8511 -or- 811

Hearing Impaired TDD (800) 542-2289

www.DiggersHotline.com

DETAILS
C300 NTS

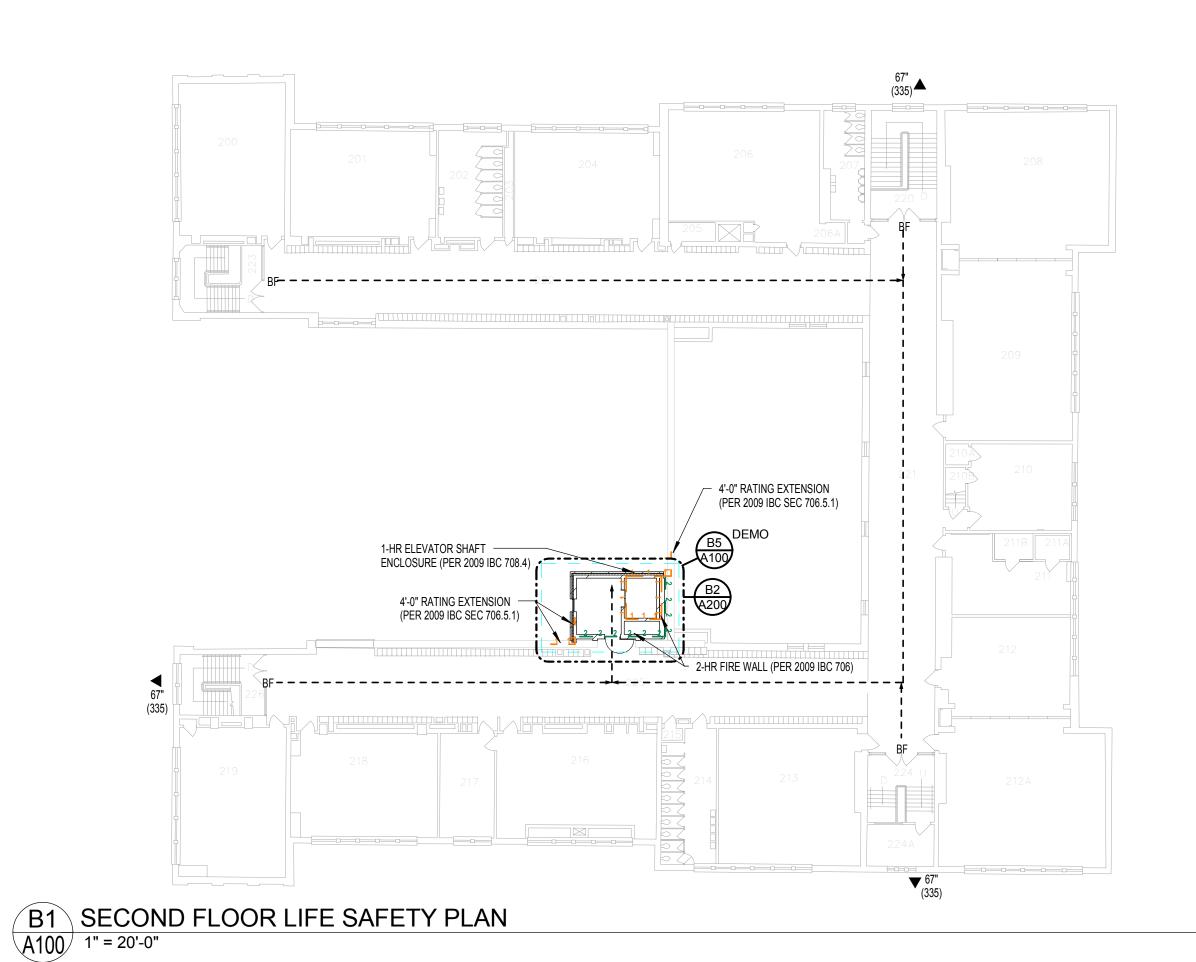

SUMMARY OF CODE REVIEW WORKSHEETS/INFORMATION:

---- ACCESSIBLE MEANS OF EGRESS

FIRE EXTINGUISHER

DRINKING FOUNTAIN

EXIT WIDTH


Occupant Load


Existing building occupant load


proposed addition/remodel work.

remains unchanged with the

MAX OCCUPANTS ACCOMODATED BY EXIT

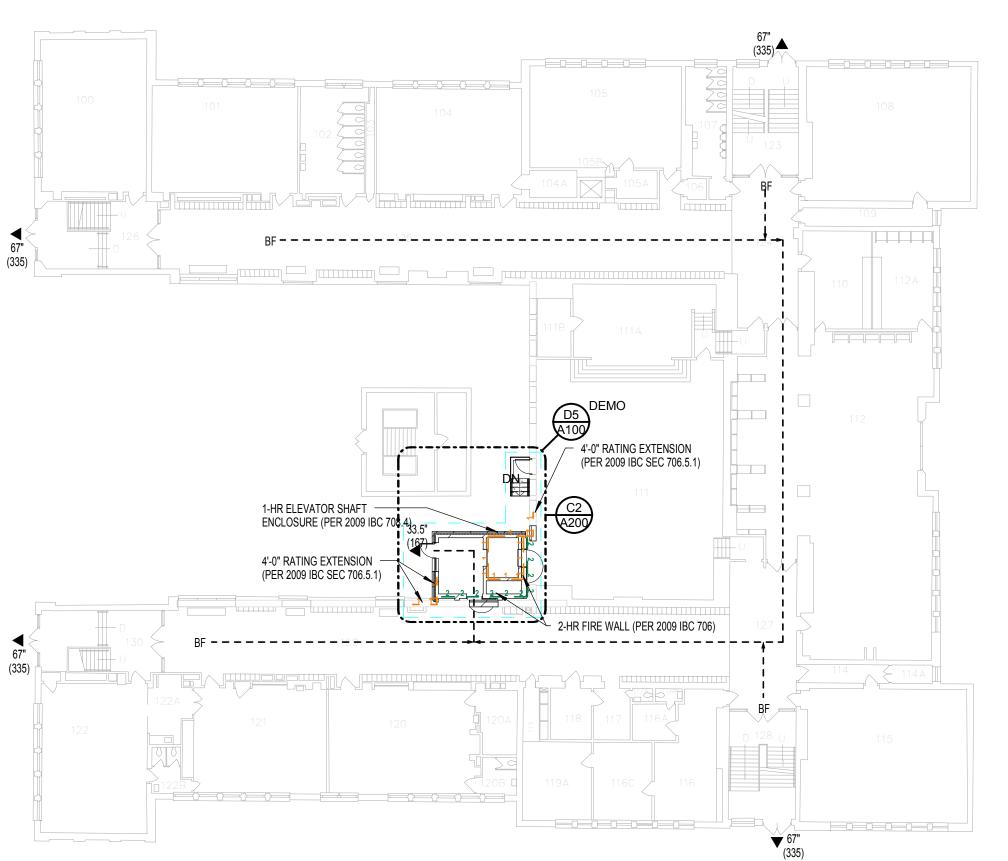

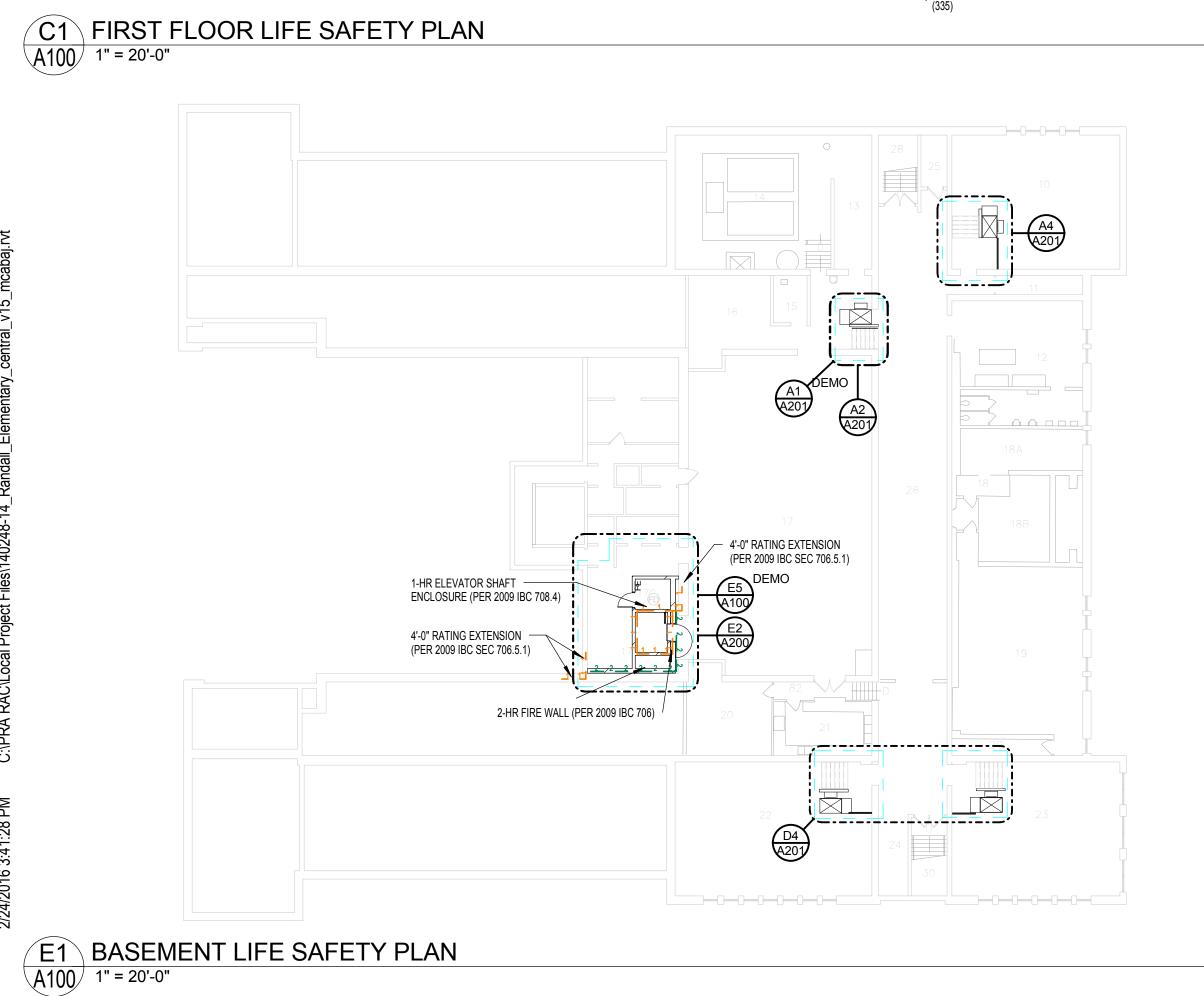

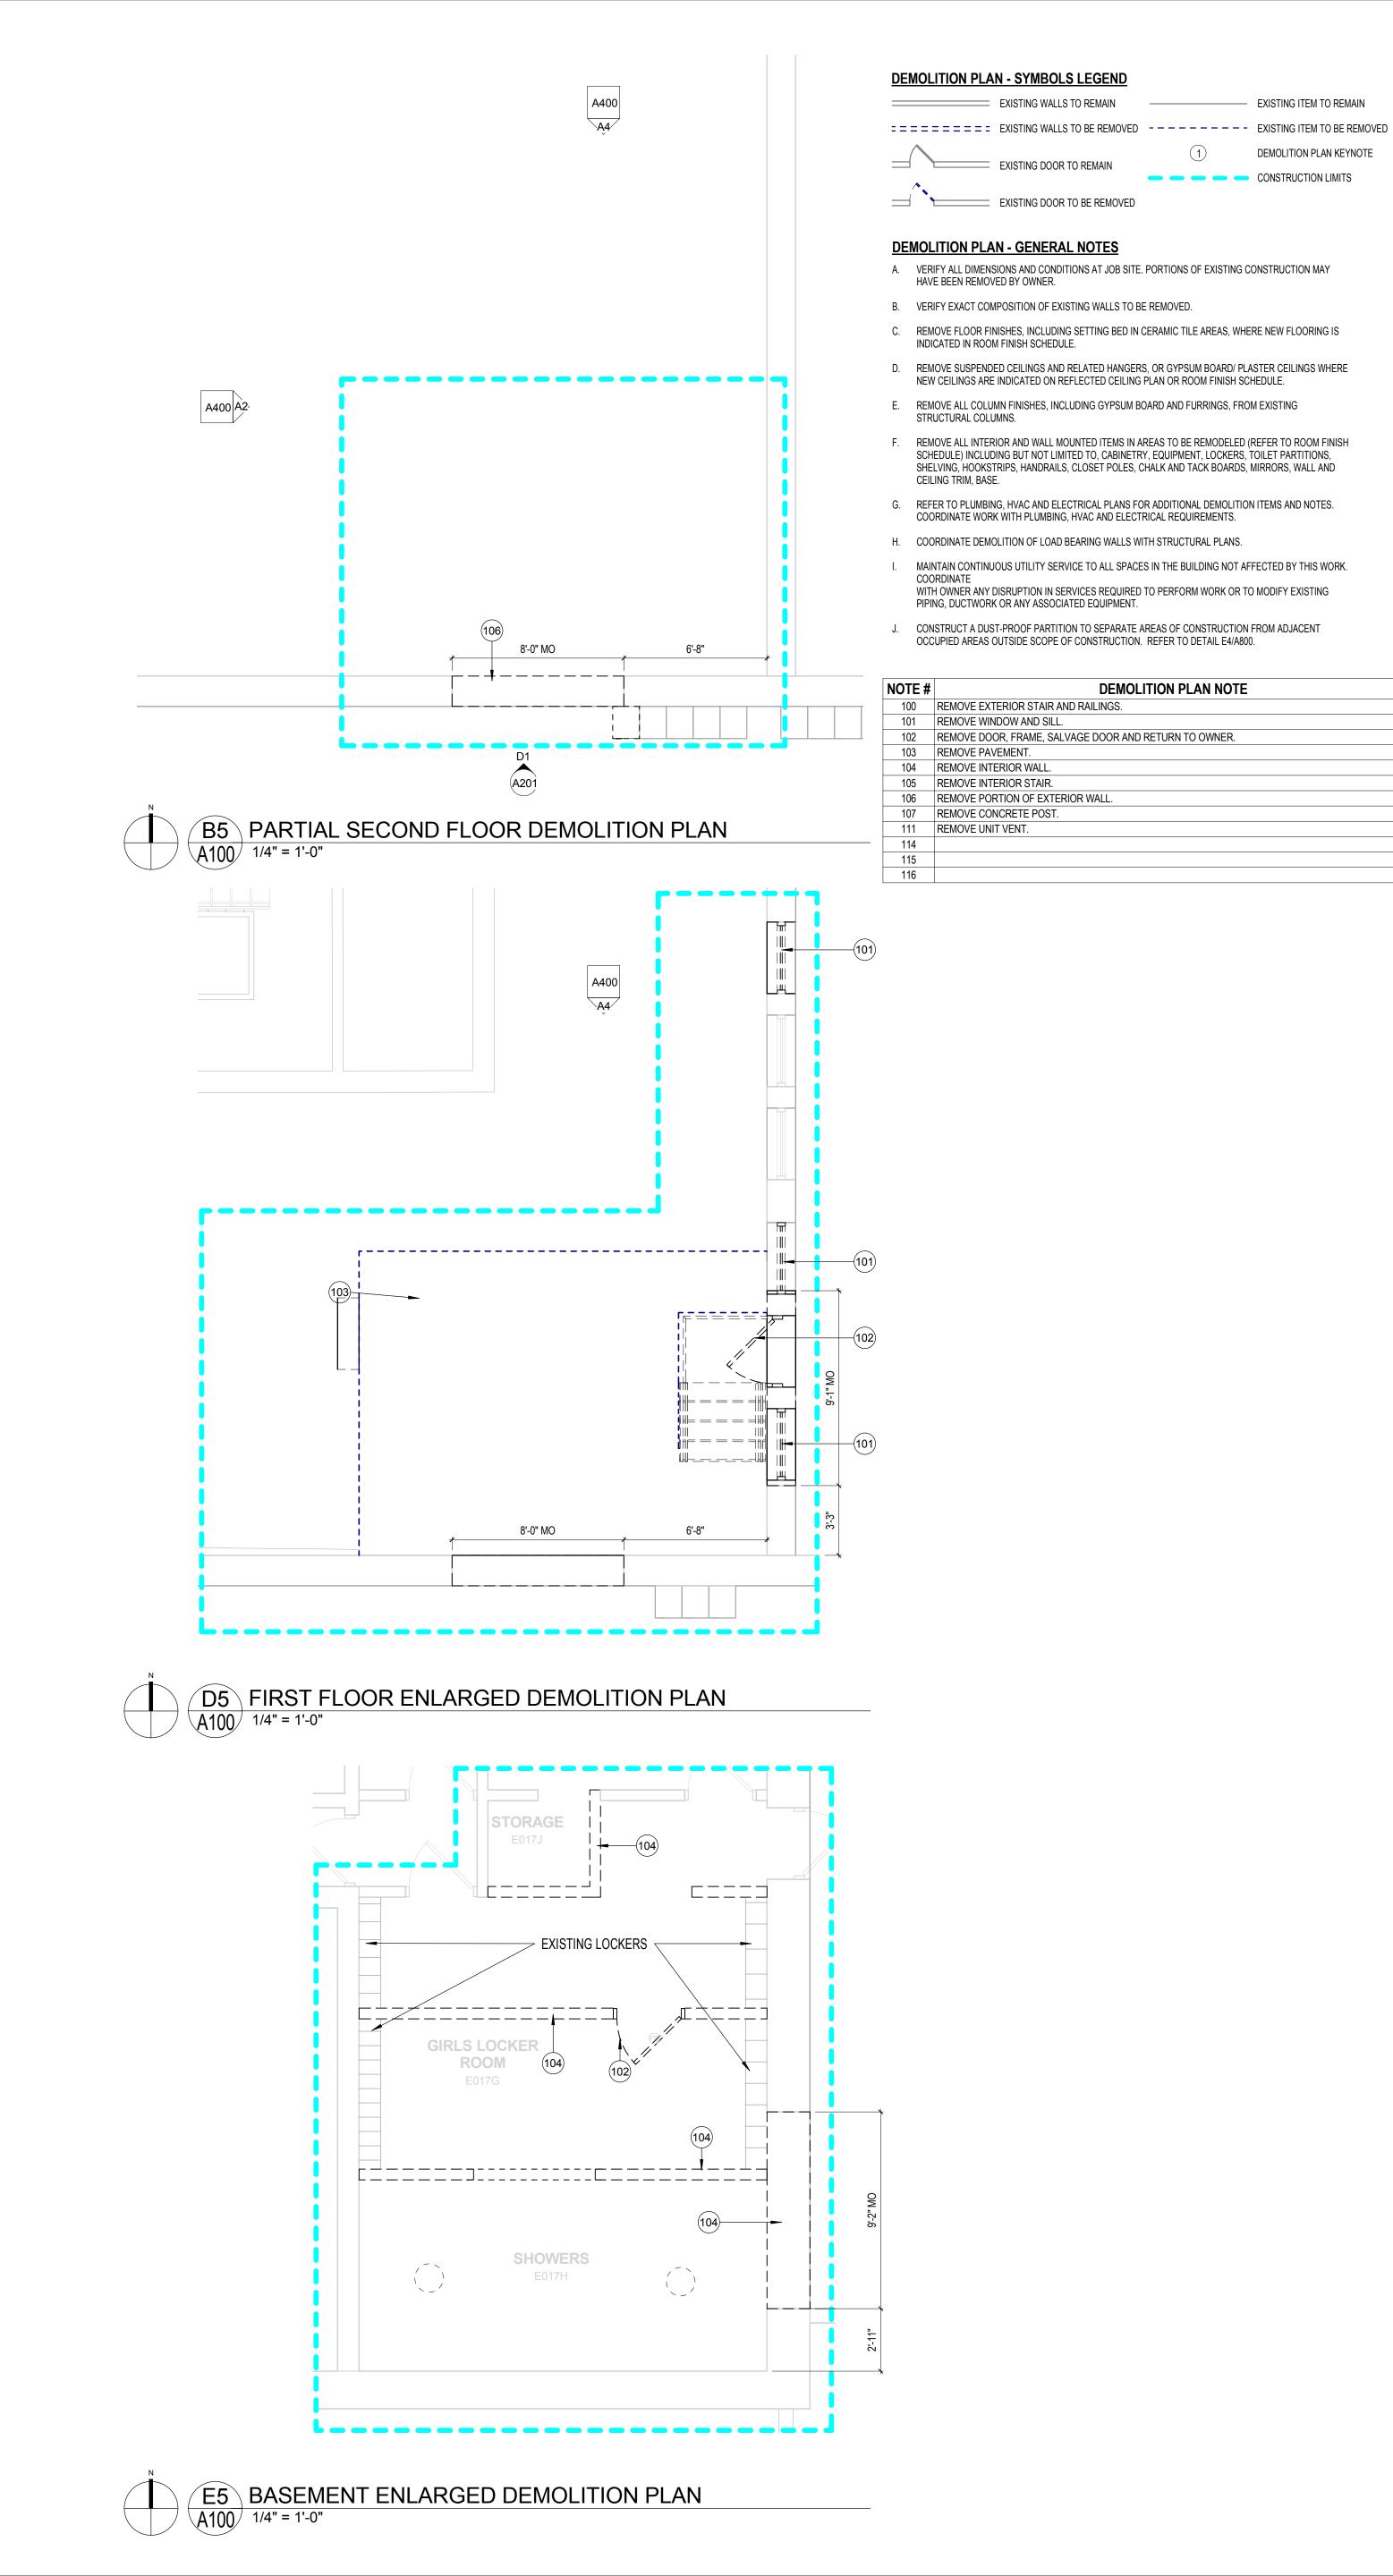

Drawn By:

Job No.:

140248-14


Sheet No.:

Madison Metropolitian School District Randall Elementary School - 5th Addition 1802 Regent St., Madison, WI 53726


2016

D1 VIEW OF EXISTING MAINTENANCE BUILDING
A110




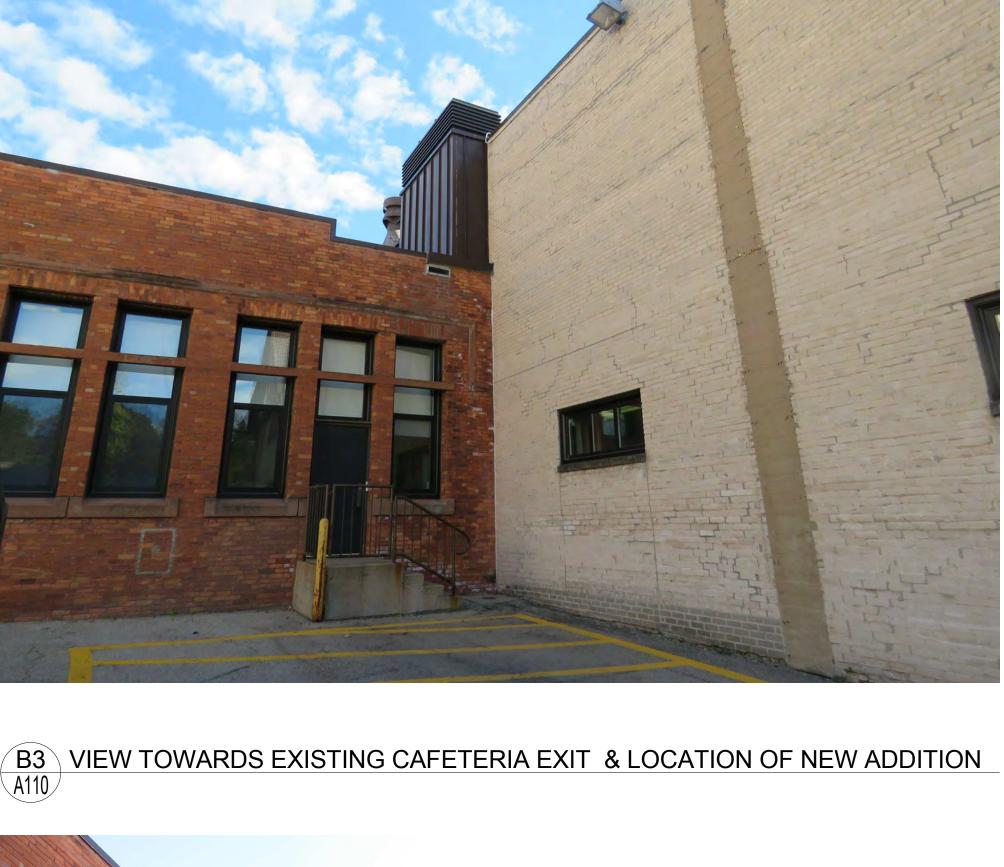


D3 VIEW TOWARDS EXISTING CAFETERIA EXIT & LOCATION OF NEW ADDITION
A110

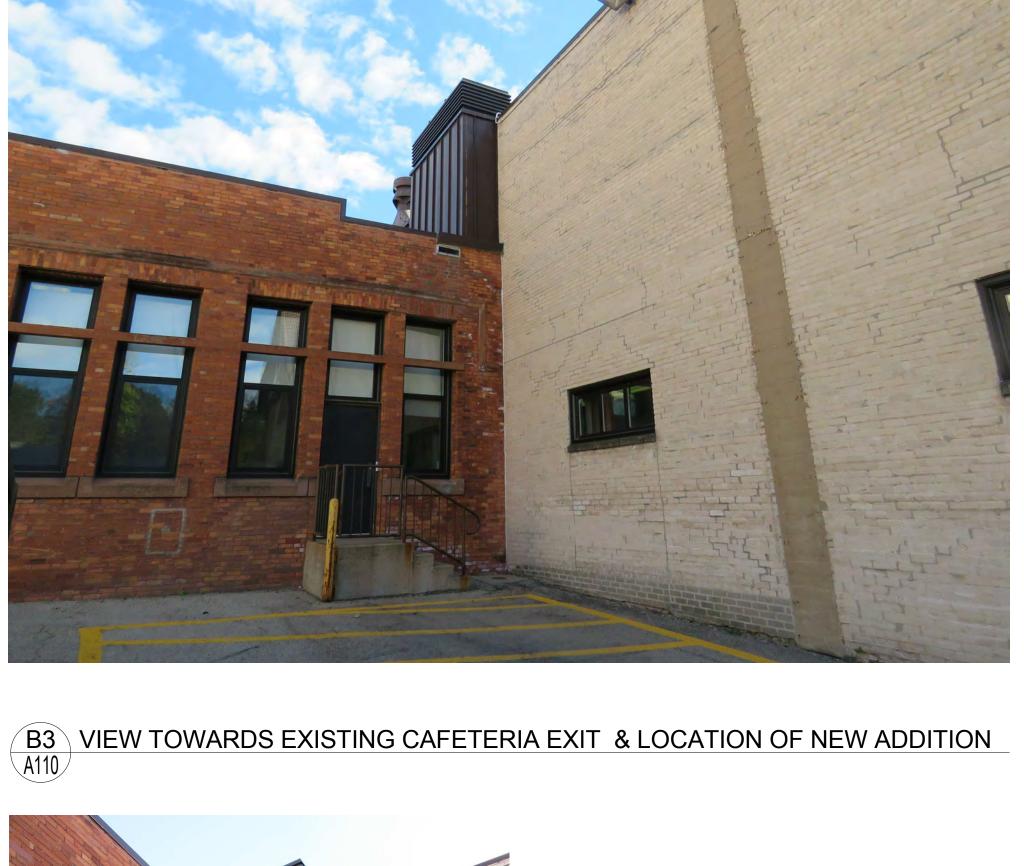



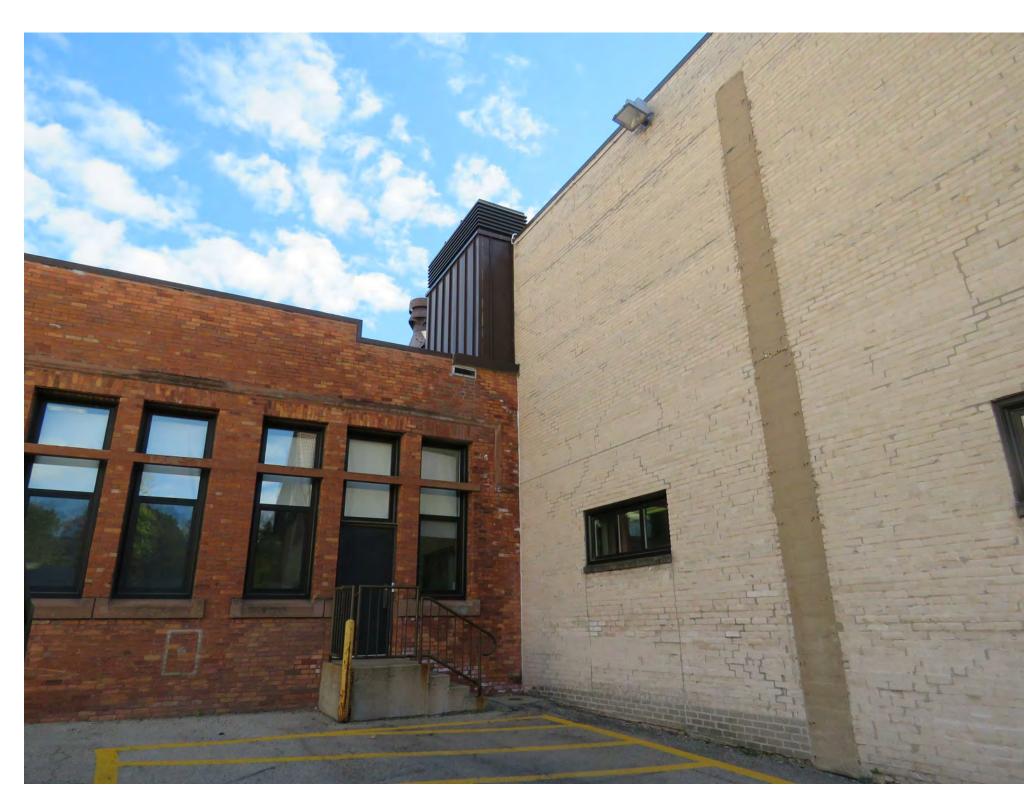

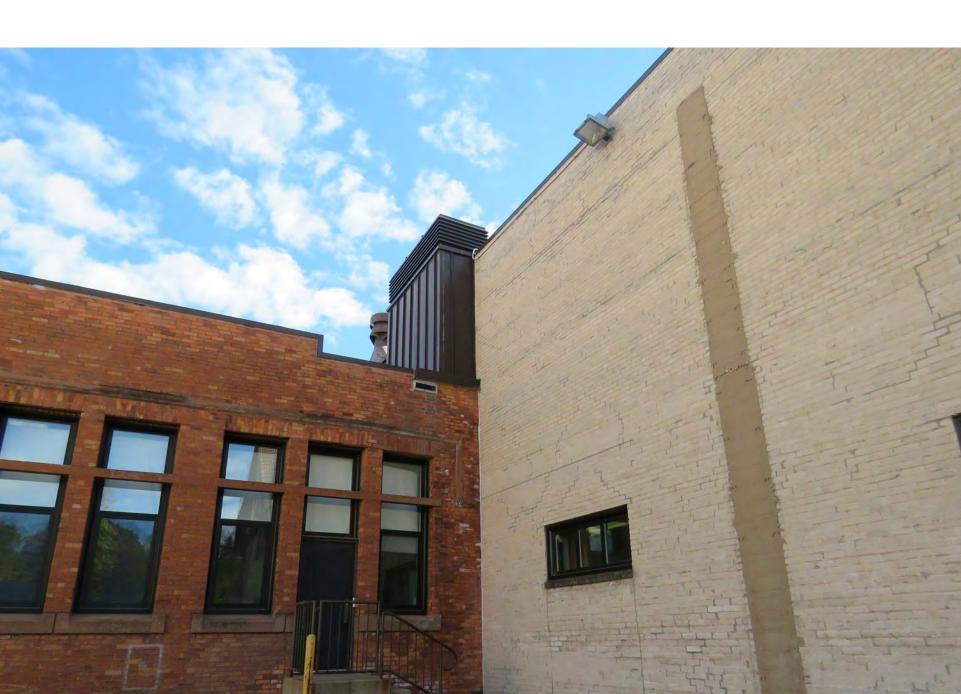



A400 B2

C2 FIRST FLOOR ENLARGED PLAN
A200 1/4" = 1'-0"

CORRIDOR

2M12

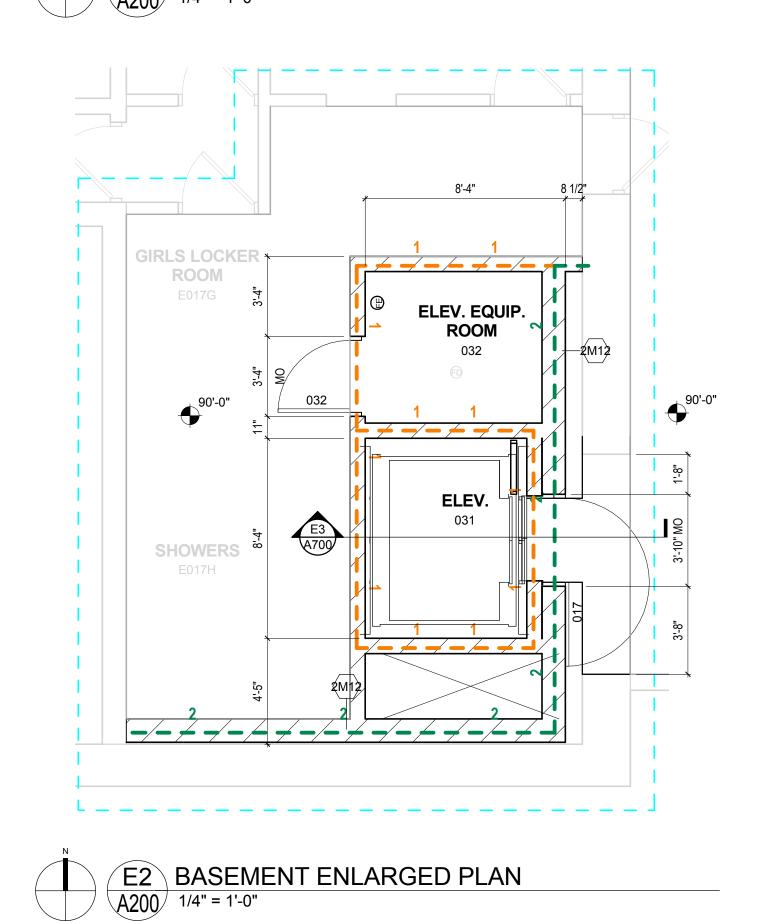

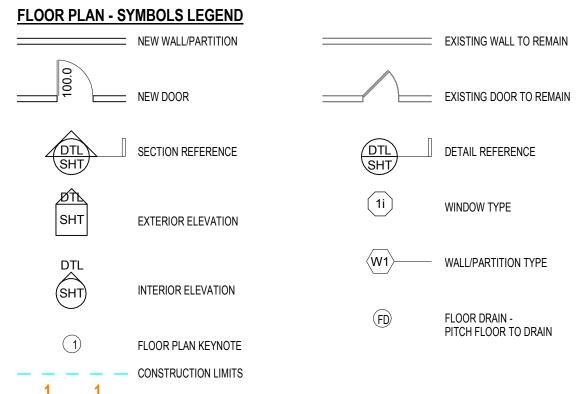

— L ONE HOUR FIRE RESISTIVE CONSTRUCTION **— — — TWO HOUR FIRE RESISTIVE CONSTRUCTION**

FLOOR PLAN - GENERAL NOTES

- A. DIMENSIONS ON FLOOR PLAN ARE BASED ON FACE OF FINISHED WALL TO FACE OF FINISHED WALL (NOMINAL).
- B. VERIFY ALL DIMENSIONS AND CONDITIONS AT JOB SITE. PORTIONS OF EXISTING CONSTRUCTION MAY HAVE BEEN REMOVED BY OWNER.
- C. MAINTAIN CONTINUOUS UTILITY SERVICE TO ALL SPACES IN THE BUILDING NOT AFFECTED BY THIS WORK. COORDINATE WITH OWNER ANY DISRUPTION IN SERVICES REQUIRED TO PERFORM WORK OR TO MODIFY EXISTING PIPING, DUCTWORK OR ANY ASSOCIATED EQUIPMENT.
- D. REFER TO SHEET A890 FOR ROOM FINISH SCHEDULE AND NOTES.
- E. REFER TO SHEET A890 FOR DOOR SCHEDULES, DOOR TYPES, AND NOTES.

NOTE # FLOOR PLAN NOTE

KEYNOTE LEGEND - EXTERIOR WALL TYPES EXTERIOR WALL DESCRIPTION


- W1 EXTERIOR WALL: MASONRY CAVITY WALL CONSISTING OF 4" FACE BRICK, 1-3/4" AIR SPACE, 3" RIGID INSULATION, SPRAY APPLIED AIR AND VAPOR BARRIER SYSTEM ON 8" CONCRETE MASONRY UNIT BACK-UP WALL WITH ADJUSTABLE (TWO-PIECE) HORIZONTAL MASONRY JOINT REINFORCING @ 16" OC (REFER TO STRUCTURAL DRAWINGS FOR REQUIRED VERTICAL REINFORCING). PROVIDE CAVITY DRAINAGE MATERIAL, FLASHING, CAVITY WEEPS/VENTS @ 24" OC AND MASONRY EXPANSION AND CONTROL JOINTS. COMPARTMENTALIZE THE CAVITY AND PROVIDE CAVITY WEEPS/VENTS AT TOP/BOTTOM OF CAVITY.
- W1A EXTERIOR WALL: MASONRY CAVITY WALL CONSISTING OF 4" FACE BRICK, 1-3/4" AIR SPACE, 3" RIGID INSULATION, SPRAY APPLIED AIR AND VAPOR BARRIER SYSTEM ON 8" CAST IN PLACE CONCRETE BACK-UP WALL WITH ADJUSTABLE (TWO-PIECE) HORIZONTAL MASONRY JOINT REINFORCING @ 16" OC (REFER TO STRUCTURAL DRAWINGS FOR REQUIRED VERTICAL REINFORCING). PROVIDE CAVITY DRAINAGE MATERIAL, FLASHING, CAVITY WEEPS/VENTS @ 24" OC AND MASONRY EXPANSION AND CONTROL JOINTS. COMPARTMENTALIZE THE CAVITY AND PROVIDE CAVITY WEEPS/VENTS AT TOP/BOTTOM OF CAVITY.
- WB3 EXTERIOR WALL (BELOW GRADE): REINFORCED CAST-IN-PLACE CONCRETE FOUNDATION WALL. PROVIDE 2" RIGID FOUNDATION INSULATION, EXTEND 48" VERTICALLY ON WALL AND 24" HORIZONTALLY BELOW FLOOR
- WB4 EXTERIOR WALL (BELOW GRADE): 12" REINFORCED CAST-IN-PLACE CONCRETE FOUNDATION WALL WITH SHEET MEMBRANE WATERPROOFING. TERMINATE ALL MEMBRANE PERIMETER EDGES WITH 1/8" x 1" ALUMINUM COMPRESSION BAR WITH CONTINUOUS SEALANT. SHEET MEMBRANE MUST INTERFACE WITH VERTICAL WALL AIR & VAPOR BARRIER LINE. PROVIDE 2" RIGID FOUNDATION INSULATION, EXTEND FULL HEIGHT VERTICALLY.


KEYNOTE LEGEND - INTERIOR PARTITION TYPES INTERIOR PARTITION DESCRIPTION

- 2M12 INTERIOR MASONRY PARTITION: 12" CONCRETE BLOCK. PROVIDE 2 HR RATED UL #U465 DESIGN WHERE 2 HR CONSTRUCTION IS INDICATED ON PLANS. M8 INTERIOR MASONRY PARTITION: 8" CONCRETE BLOCK.
- P6 INTERIOR PARTITION: 6" STEEL STUDS @ 16" OC WITH ONE LAYER 5/8" GYPSUM BOARD @ EACH FACE. PROVIDE 1 HR RATED UL #U465 DESIGN WHERE 1 HR CONSTRUCTION IS INDICATED ON PLANS.

MASONRY PARTITIONS - GENERAL NOTES

- MASONRY PARTITIONS INDICATED WITH THE FOLLOWING HATCH PATTERN:
- ALL MASONRY PARTITIONS SHALL BE 8" CONCRETE BLOCK UNLESS OTHERWISE NOTED OR DIMENSIONED. REFER TO FLOOR
- PROVIDE UL RATED CONCRETE BLOCK AT ALL FIRE RATED PARTITIONS.
- SEAL ALL WALL PENETRATIONS AT PERIMETER AND FIRESTOP ALL RATED PARTITIONS.
- EXTEND CONCRETE BLOCK PARTITIONS FULL HEIGHT TO UNDERSIDE OF STEEL DECK ABOVE (OR PRECAST PLANK ABOVE IF APPLICABLE). REFER TO DETAIL A5/A810. PROVIDE HORIZONTAL MASONRY JOINT REINFORCEMENT AT 16" OC VERTICALLY. REFER TO STRUCTURAL DRAWINGS FOR VERTICAL REINFORCEMENT REQUIREMENTS.

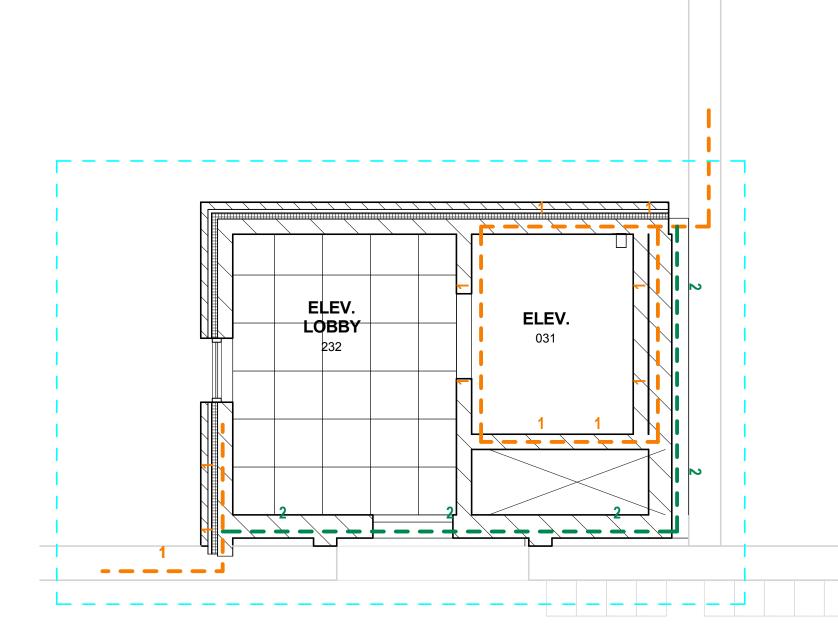

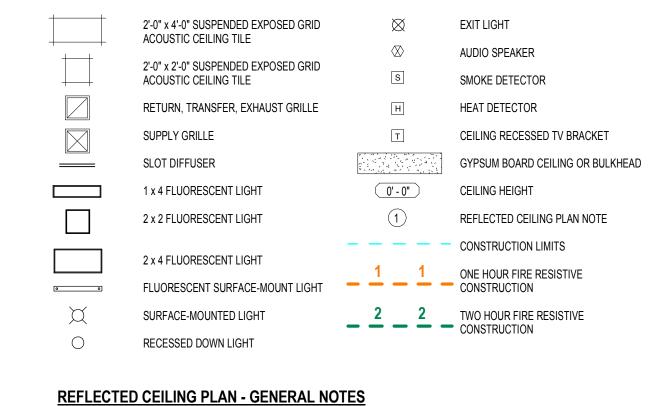


A. PERIMETER CEILING TILES SHALL NOT BE LESS THAN 4".

REFLECTED CEILING PLAN - SYMBOLS LEGEND


- B. LOCATE ALL SPRINKLER HEADS, SMOKE DETECTORS, AUDIO SPEAKERS, HEAT SENSORS IN THE CENTER OF CEILING TILE (OR IN THE CENTER OF THE RAISED/RECESSED FIELD OF A PATTERNED TILE).
- C. REMOVE EXISTING CEILING SYSTEM WHERE NEW WALLS PENETRATE EXISTING CEILING SYSTEMS TO REMAIN. PATCH TO MATCH EXISTING CEILING SYSTEM TO NEW WALL.
- CEILING HEIGHTS SHALL BE 9'-0" UNLESS NOTED OTHERWISE ON THE REFLECTED CEILING PLANS.

NOTE # REFLECTED CEILING PLAN NOTE



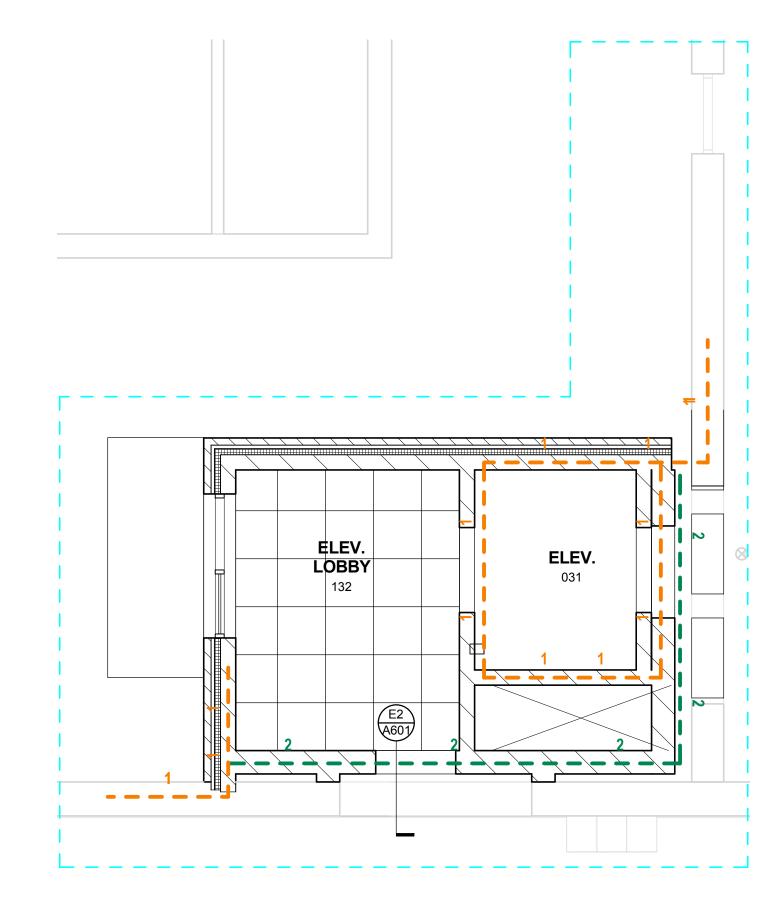

C5 FIRST FLOOR REFLECTED CEILING PLAN A200 1/4" = 1'-0"

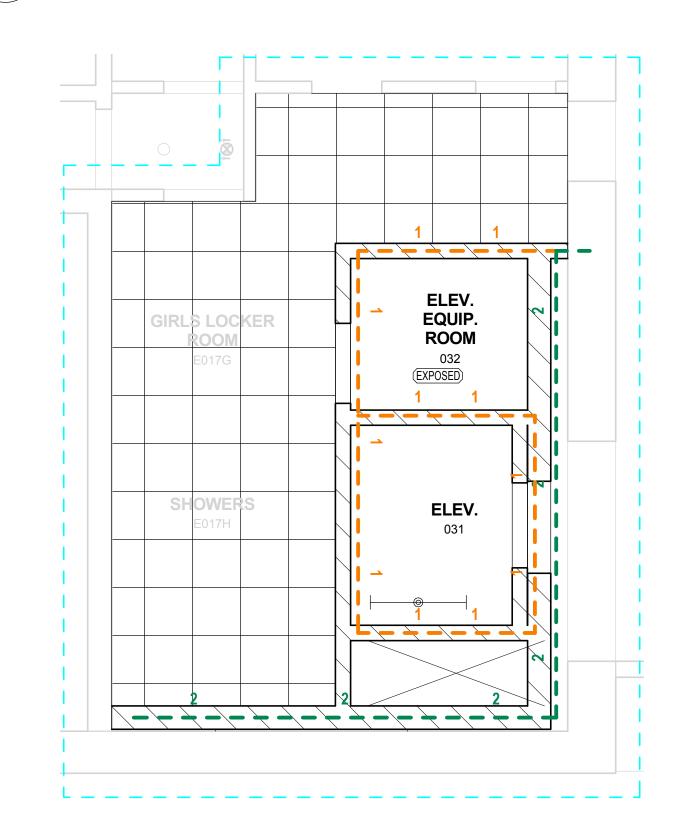




Randall Elementary St. Madison, WI 53726 Revisions

2016


5th Addition

Drawn By:


140248-14 Sheet No.:

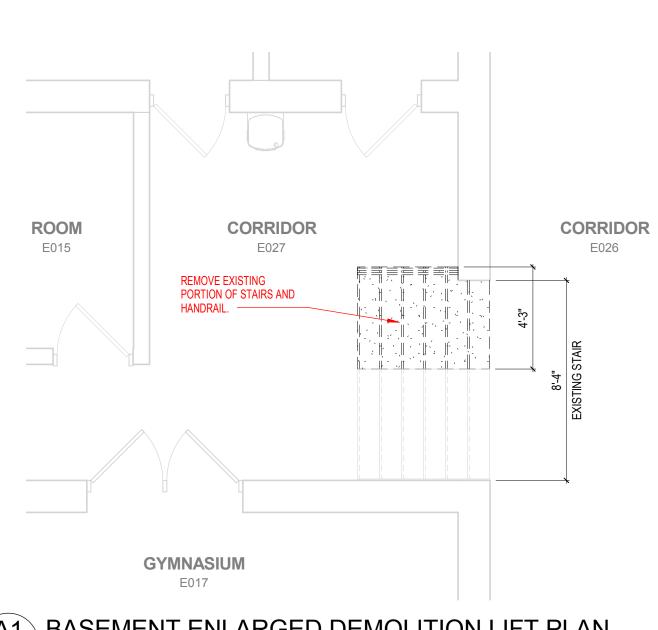


A1 BASEMENT ENLARGED DEMOLITION LIFT PLAN
A201 1/4" = 1'-0"

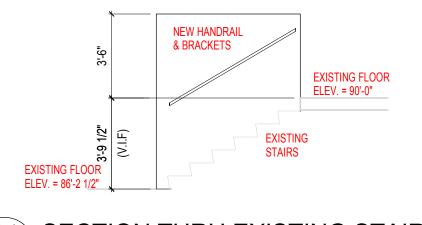


B1 SECTION THRU EXISTING STAIRS
A201 1/4" = 1'-0"

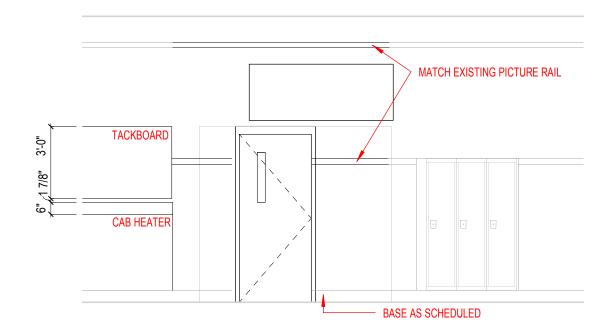


C1 NEW INTERIOR ELEVATION
A201 1/4" = 1'-0"

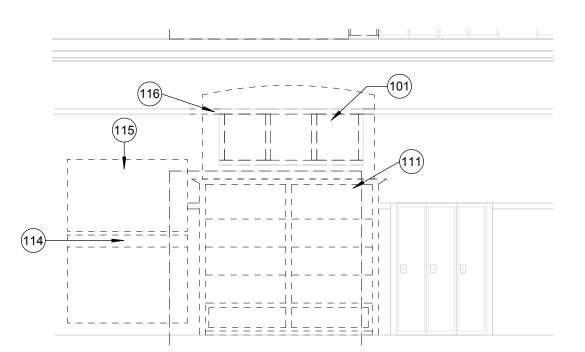


D1 EXISTING AND DEMOLITION INTERIOR ELEVATION
A201 1/4" = 1'-0"

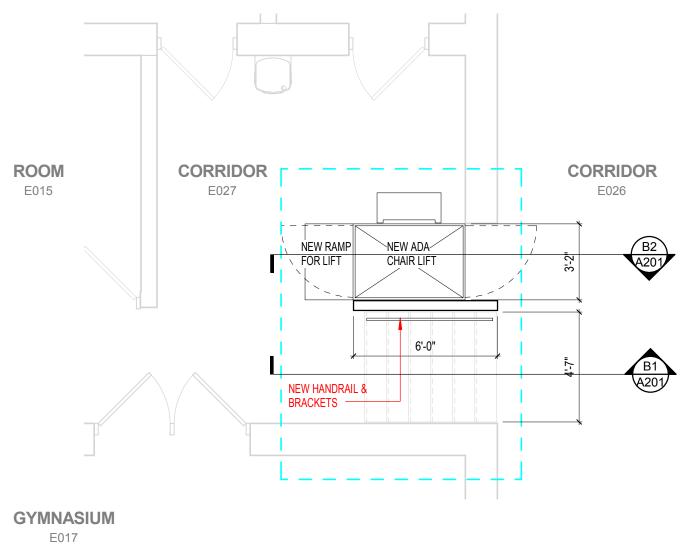



BASEMENT ENLARGED LIFT PLAN

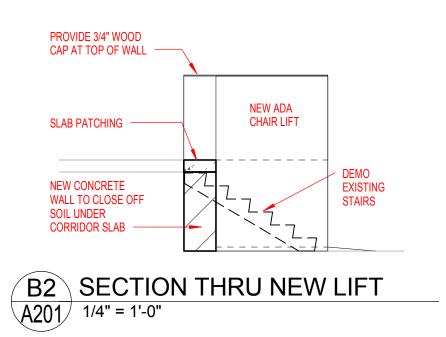

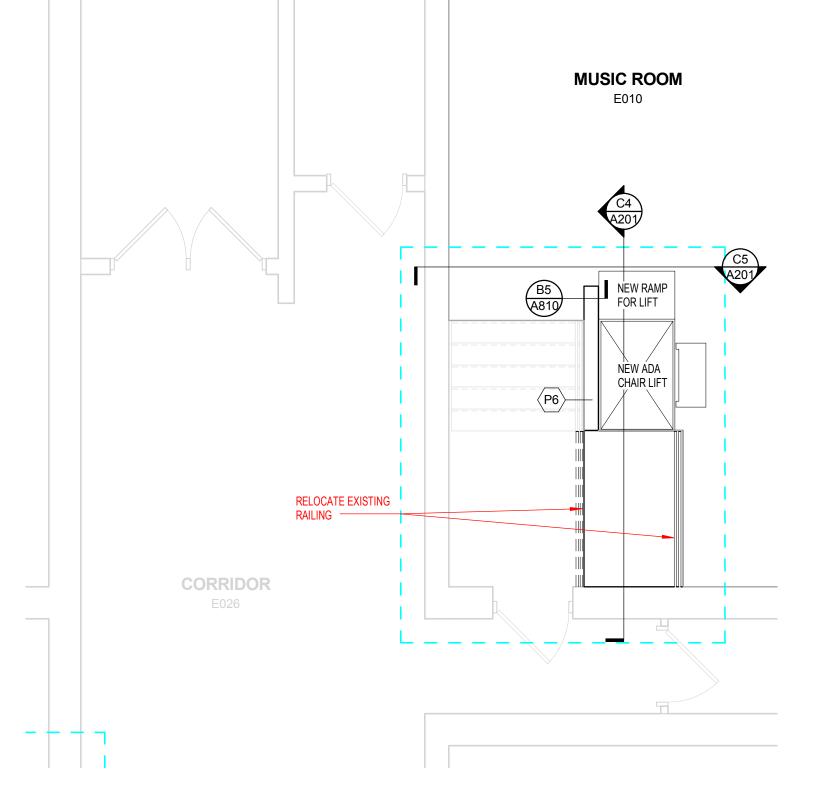



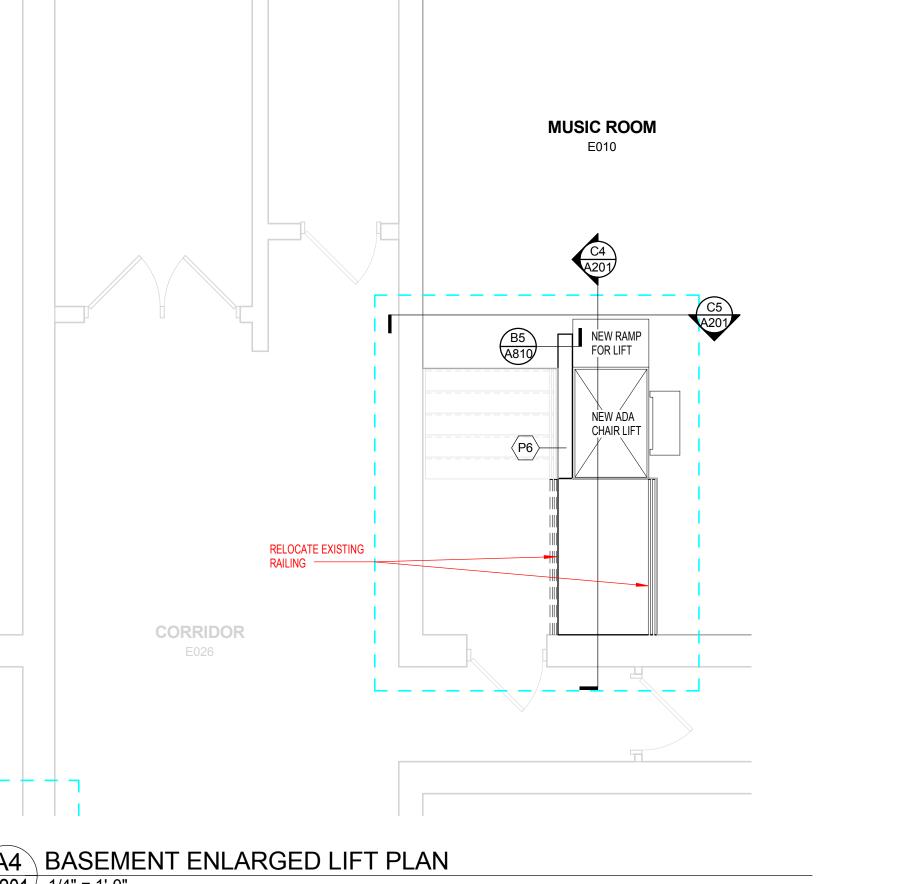

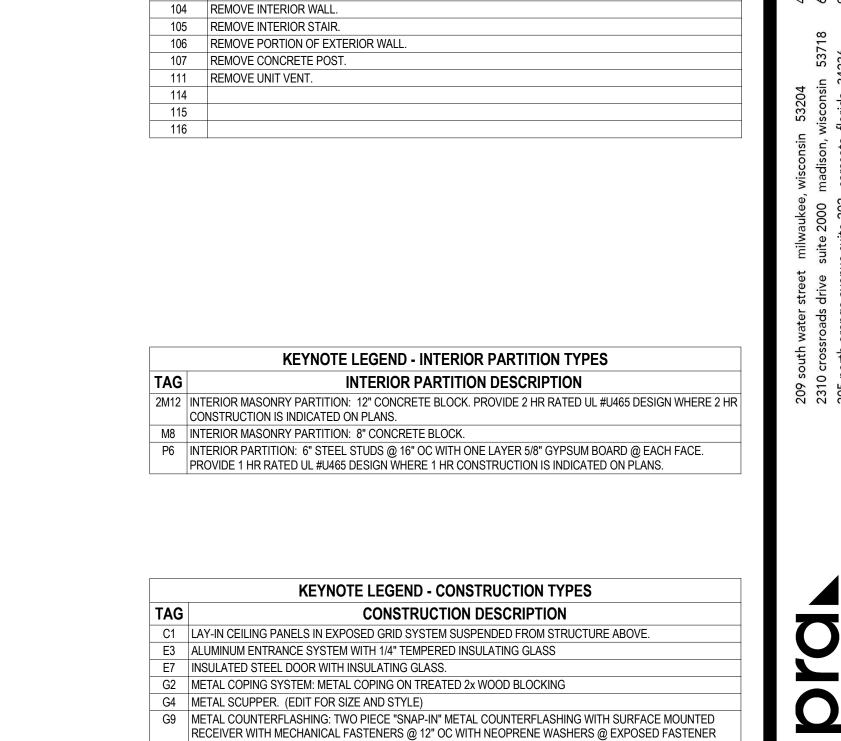

G10 METAL COUNTERFLASHING: TWO PIECE "SNAP-IN" METAL COUNTERFLASHING WITH RECEIVER BUILT INTO

R1 SINGLE PLY ROOFING SYSTEM: LOOSELY LAID AND BALLASTED EPDM MEMBRANE WITH BALLAST PROTECTIVE MAT ON X" OF RIGID INSULATION (ON VAPOR RETARDER) ON 5/8" EXTERIOR SHEATHING ON

R2 SINGLE PLY ROOFING SYSTEM: FULLY ADHERED EPDM MEMBRANE ON X" OF RIGID INSULATION (ON VAPOR RETARDER) ON 5/8" EXTERIOR SHEATHING ON METAL DECK.

S1 REINFORCED CONCRETE SLAB ON VAPOR BARRIER ON DRAINAGE FILL

DEMOLITION PLAN NOTE

NOTE #


100 REMOVE EXTERIOR STAIR AND RAILINGS.


103 REMOVE PAVEMENT.


MASONRY MORTAR JOINT.

METAL DECK.

101 REMOVE WINDOW AND SILL.
102 REMOVE DOOR, FRAME, SALVAGE DOOR AND RETURN TO OWNER.

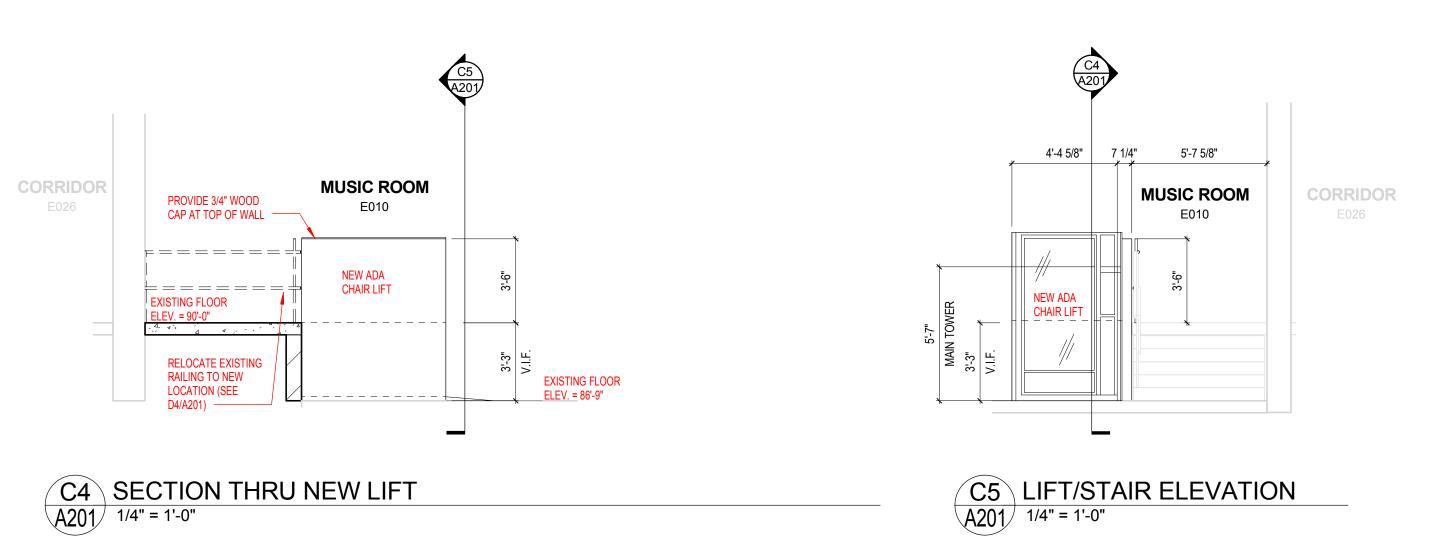


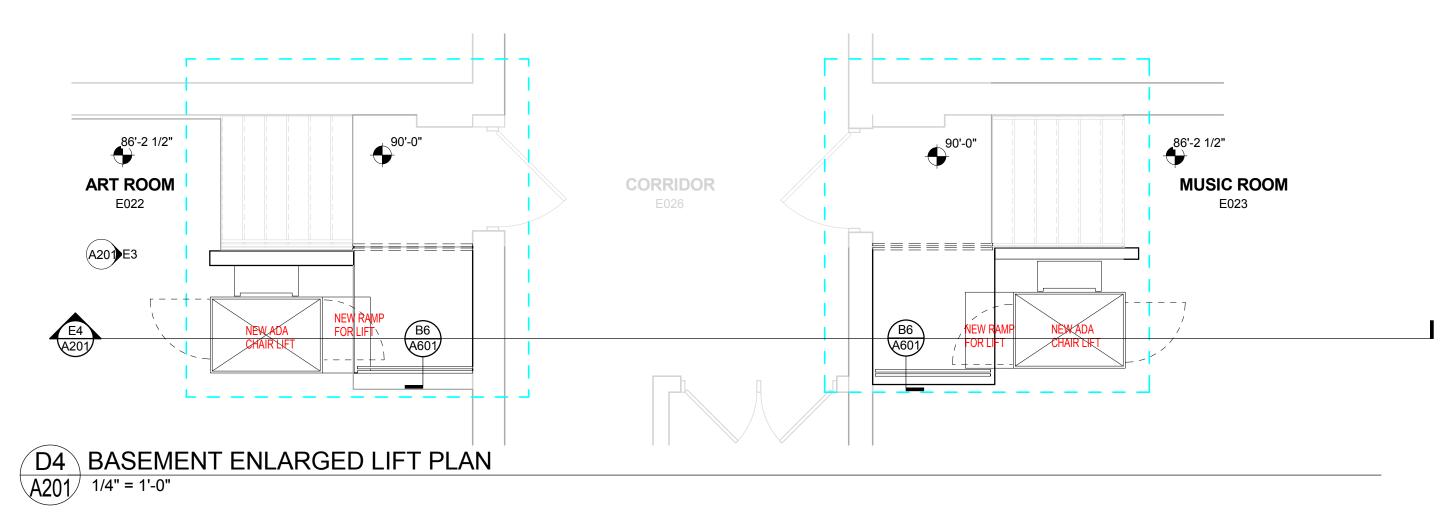

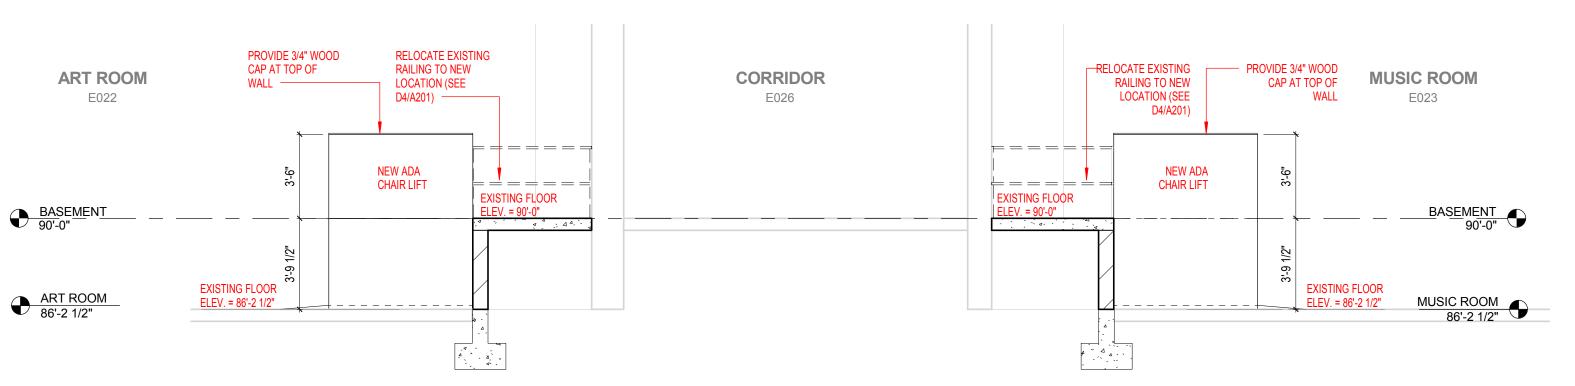



5'-8" 7 1/4" 4'-7"

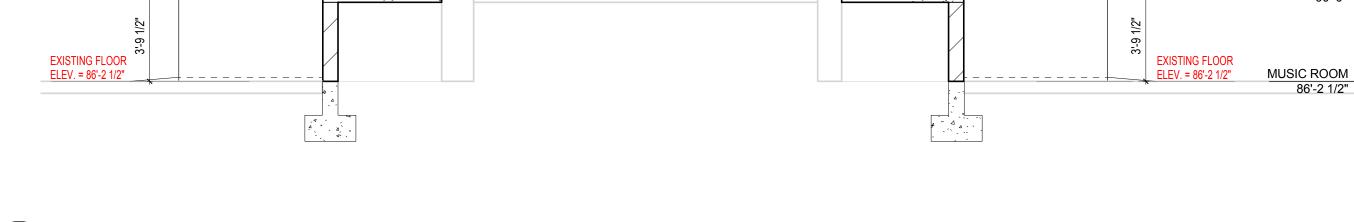

School Randall Elementary Stable 1802 Regent St. Madison, WI 53726 Revisions

2016

5th Addition

Drawn By: 08 MAR 16

> 140248-14 Sheet No.:

A201

E4 SECTION THRU NEW LIFTS
A201 1/4" = 1'-0"

ROOF PLAN - SYMBOLS LEGEND

ROOF PLAN NOTE

- - - CONSTRUCTION LIMITS

ROOF PLAN - GENERAL NOTES

HVAC, AND ELECTRICAL REQUIREMENTS.

C. PROVIDE POSITIVE ROOF DRAINAGE INCLUDING TAPERED INSULATION LAYOUT. PROVIDE SADDLES AND CRICKETS AT

D. PROVIDE 24" WIDE CONCRETE PAVER WALKWAY FROM ROOF SCUTTLE TO ALL MECHANICAL ROOFTOP UNITS AND ALL ROOF ACCESS LADDERS. PROVIDE PAVERS AROUND PERIMETER OF ROOF SCUTTLE AND HVAC ROOFTOP UNITS.

ROOF PLAN NOTE

KEYNOTE LEGEND - CONSTRUCTION TYPES

E3 ALUMINUM ENTRANCE SYSTEM WITH TEMPERED INSULATING GLASS (EDIT FOR SCHOOLS: 1/4" TEMPERED

G9 METAL COUNTERFLASHING: TWO PIECE "SNAP-IN" METAL COUNTERFLASHING WITH SURFACE MOUNTED RECEIVER WITH MECHANICAL FASTENERS @ 12" OC WITH NEOPRENE WASHERS @ EXPOSED FASTENER

G10 METAL COUNTERFLASHING: TWO PIECE "SNAP-IN" METAL COUNTERFLASHING WITH RECEIVER BUILT INTO

SINGLE PLY ROOFING SYSTEM: LOOSELY LAID AND BALLASTED EPDM MEMBRANE WITH BALLAST PROTECTIVE MAT ON X" OF RIGID INSULATION (ON VAPOR RETARDER) ON 5/8" EXTERIOR SHEATHING ON

R2 SINGLE PLY ROOFING SYSTEM: FULLY ADHERED EPDM MEMBRANE ON X" OF RIGID INSULATION (ON VAPOR RETARDER) ON 5/8" EXTERIOR SHEATHING ON (EDIT FOR ROOF FRAMING/DECKING/VAPOR RETARDER). S1 X" REINFORCED CONCRETE SLAB ON VAPOR RETARDER ON X" DRAINAGE FILL. (EDIT FOR THICKNESSES)

EXTERIOR ELEVATION NOTE

EXTERIOR ELEVATIONS - GENERAL NOTES

C. REFER TO SHEET XXX FOR WINDOW FRAME ELEVATIONS

E. FIBER CEMENT COLOR TO BE REDWOOD STAIN.

D. SEALANT COLORS TO MATCH ADJACENT FINISHED SURFACES.

A. PAINT ALL EXPOSED STEEL LINTELS TO MATCH ADJACENT MASONRY COLOR

B. TRIM ALL EXTERIOR LIGHTING FIXTURES, OUTLETS, HOSE BIBBS AND ALL OTHER SIDING PENETRATIONS WITH 1X4 FIBER CEMENT TRIM (TYP.)

C1 LAY-IN CEILING PANELS IN EXPOSED GRID SYSTEM SUSPENDED FROM STRUCTURE ABOVE.

G2 METAL COPING SYSTEM: METAL COPING ON TREATED 2x WOOD BLOCKING

CONSTRUCTION DESCRIPTION

ALL ROOF TOP EQUIPMENT AND PENETRATIONS TO ENSURE POSITIVE DRAINAGE.

PROVIDE PAVERS AT LANDINGS BELOW ROOF ACCESS LADDERS.

ORD

NOTE #

NOTE #

GLASS IN DOORS).

MASONRY MORTAR JOINT.

INSULATED STEEL DOOR WITH INSULATING GLASS.

(EDIT FOR ROOF FRAMING/DECKING/VAPOR RETARDER).

G4 METAL SCUPPER. (EDIT FOR SIZE AND STYLE)

CONSTRUCTION


FOR

Job No.: 140248-14

Sheet No.:

EXISTING SHED NOT SHOWN FOR B4 NORTH ELEVATION - EXISTING AND DEMOLITION A202 1/8" = 1'-0"


EXISTING SHED NOT SHOWN FOR SECOND FLOOR C4 WEST ELEVATION - EXISTING AND DEMOLITION A202 1/8" = 1'-0"

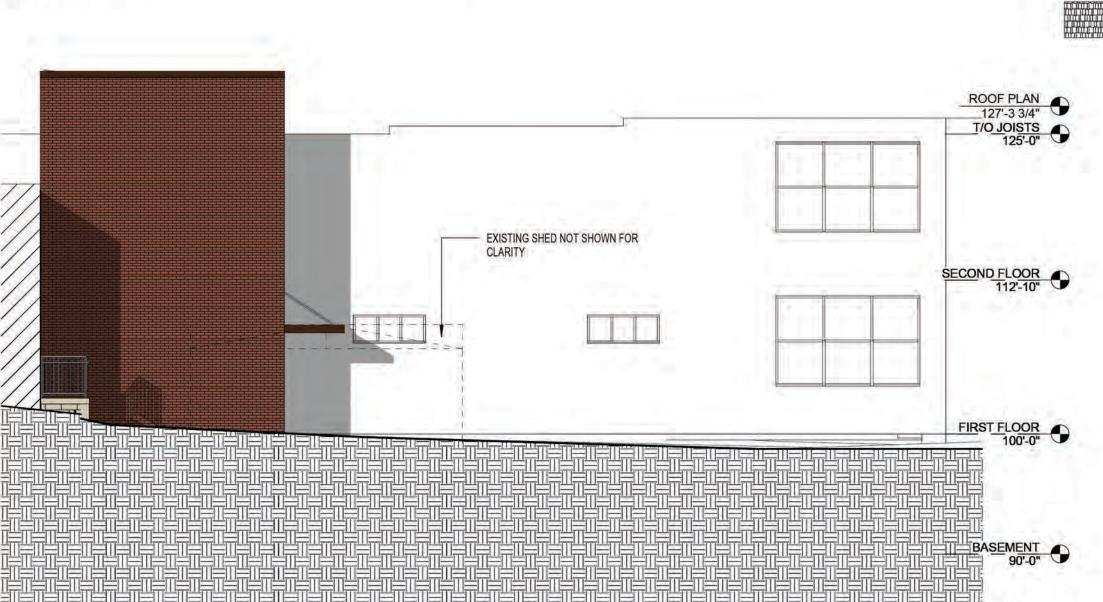


D4 NORTH ELEVATION - ADDITION A202 1/8" = 1'-0"



E4 WEST ELEVATION -ADDITION
A202 1/8" = 1'-0"

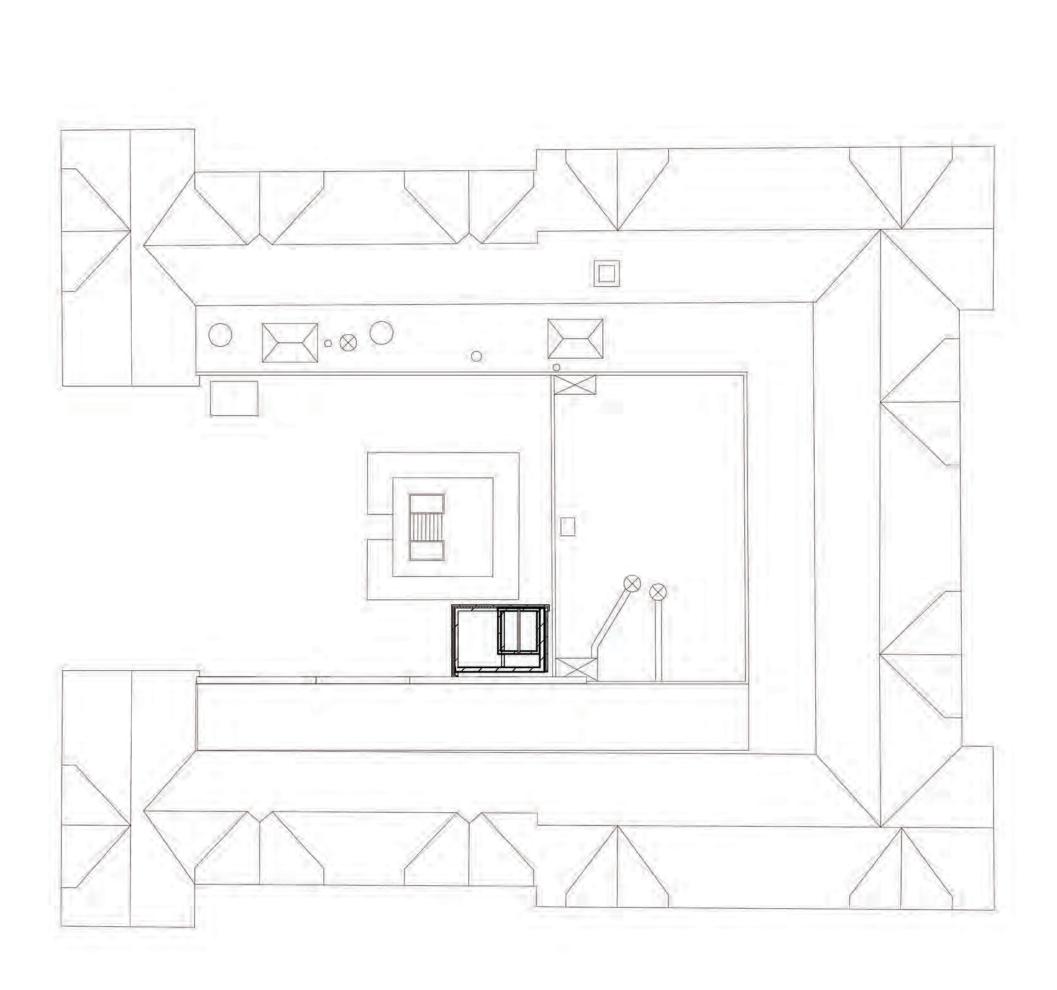

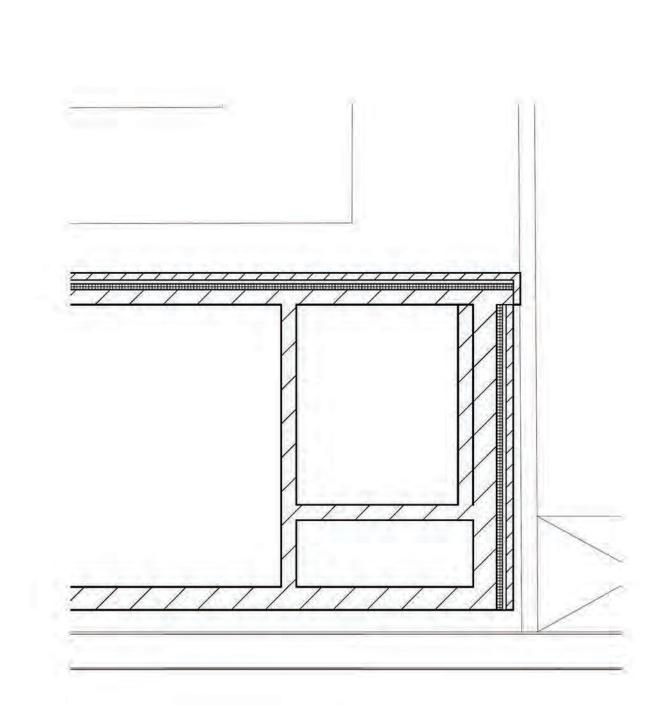

E1 ROOF PLAN A202 1" = 20'-0"

C1 ROOF DEMOLITION PLAN
A202 1" = 20'-0"

E3 ROOF PLAN A202 1/4" = 1'-0"



CONSTRUCTION ch Architects. 11 P

VIEW FROM COURTYARD TOWARDS ELEVATOR ADDITION - MAINTENANCE BUILDING SHOWN

A410

