APPLICATION FOR URBAN DESIGN COMMISSION

Project # _____ Legistar # _____

AGENDA ITEM # _____

REVIEW AND APPROVAL

DAT	E SUBMITTED:	Action Requested Informational Presentation	
UDC	MEETING DATE:	Initial Approval and/or Recommendation Final Approval and/or Recommendation	
PROJ	JECT ADDRESS: 2501 East Springs Drive		P
ALD!	ERMANIC DISTRICT: <u>17</u>	-	Ξ
	NER/DEVELOPER (Partners and/or Principals) on Goben, DMG Holding Company LLC_	ARCHITECT/DESIGNER/OR AGENT: _Arlan Kay, Architecture Network Inc	IEASE
	415 Pflaum Rd		
1 — 12 2 — M	1adison, WI 53716	_Madison, WI 53703	D
T CON	TACT PERSON: _ Arlan Kay, Architecture Ne	·	PRINT!
(See S	well as a fee) School, Public Building or Space (Fee may be r New Construction or Addition to or Remodelin, Sq. Ft. Planned Commercial Site Section B for:)	g of a Retail, Hotel or Motel Building Exceeding 40,00	
(See S	New Construction or Exterior Remodeling in C Section C for:) R.P.S.M. Parking Variance (Fee required)	. District (1 oc requirea)	
(See S	Section D for:) Comprehensive Design Review* (Fee required) Street Graphics Variance* (Fee required)		
	Other		

*Public Hearing Required (Submission Deadline 3 Weeks in Advance of Meeting Date)

Where fees are required (as noted above) they apply with the first submittal for either initial or final approval of a project.

OPERATION PLAN Goben Cars, 2501 East Springs Drive Operation and Traffic Plan

AVERAGE TRAFFIC COUNT: Mondays we get an average of 10 customers that drive on the lot, Tuesdays 7 customers, Wednesdays 4-6 customers, Thursdays 5-6 customers, Fridays 8-10 customers, and Saturdays 15-25 customers. This study is based on the traffic we follow at our Madison East location and also our Middleton West location. They vary within 10%. We estimate that the new location will start out the same and within a year increase 10-15% in volume through the days of the week.

TRAFFIC FLOW: Traffic will enter the driveway on East Springs Drive. When you enter that driveway it angles and turns right. Studies show that most traffic naturally will turn right as that is a human mind reaction. The way this lot is laid out 80% of our inventory will be displayed in this direction, which is where our customer parking is located. A very small percentage will go left upon entering the lot towards the back of the property.

DOUBLE STACK PARKING IN FRONT ROW: The reason we do this is so that it does not look like a parking lot and gives it a display atmosphere. We also do this for safety reasons. It is much safer to have cars only move out of their spots on one side of the drive aisle, than it is to have two sides where cars are being moved. When a car in the front row is being demonstrated we move the first car out of its spot with another salesperson guiding it so they don't hit anything or anyone. Once the first car is out, the second salesman puts the car that was in the back row into the front row, so the main salesman can stay with the customer and car at all times. When the other car comes back from demonstration it gets parked in the second row.

CAR CARRIER PLAN: Over 75% of our inventory is purchased between Milwaukee and Chicago. These auctions have retired people that drive the individual cars in to the dealership. On average, once a month a car carrier delivers cars. All deliveries generally come in on a Thursday or Friday. We feel the best location for the car carrier to deliver cars would be to come in off I90 exit on to high crossing Blvd come over the highway and make the first right on to Annamark Drive. They would then make a left at the drive between Texas Roadhouse and Pot Bellies. From there they can continue into the back area of 2501 East Springs Drive, and pull off into the 10' wide buffer zone along the rear inventory storage for unloading.

TEST DRIVE PLAN: When exiting the driveway they would make a right on East Springs Drive and make a right on Annamark Drive, they would follow Annamark Drive around to make a right on High Crossing Blvd, a right on to East Springs Drive, and lastly a right into Goben Cars. Essentially, this would just be circling the block.

DIFFERENCE OF OPERATION BETWEEN PRE-OWNED CAR DEALERSHIPS AND NEW CAR DEALERSHIPS: A new car dealership does a lot more then just selling new cars. For example, most of their sales are new car sales which means that they have to have shipments every week of car carriers dropping off cars. They also service hundreds of customers a day between their service and parts departments. Pre-owned car dealerships like this one only sell used cars, so we do not have car carriers coming in weekly to drop off cars. We do not do retail service or parts sales. We also have very few employees compared to a new car store.

The reason we have chosen this site is because it is a high traffic intersection, which is very important for marketing used cars. Because car dealerships are big ticket items you only need to sell 2-3 cars per day. There is not a lot of drive through traffic for this type of business as compared to a restaurant, or a bank. These types of businesses would be getting hundreds of customers per day and make this intersection have too high intensity of traffic. This property is also located at the beginning of automobile row. Just because there is a highway I90 that goes under High Crossing Blvd should have no bearing on the fact that High Crossing Boulevard is a central shopping destination for automobiles. We offer a different option for car buyers in that we specialize in used cars versus new cars. The corridor also offers a variety of other services, with a Home Depot, American TV, Best Buy, and a large movie theater. The zoning for this site is the same as the zoning throughout High Crossing Blvd and therefore makes a nice addition to a lot that has been vacant for years.



215 Martin Luther King Jr. Blvd; Room LL-100 PO Box 2985; Madison, Wisconsin 53701-2985 Phone: 608.266.4635 | Facsimile: 608.267.8739

- The following information is required for all applications for Plan Commission review except subdivisions or land divisions, which should be filed using the <u>Subdivision Application</u>.
- A separate Urban Design Commission application is no longer required for projects requiring both Urban Design Commission and Plan Commission approvals.
- This form may also be completed online at http://www.cityofmadison.com/developmentcenter/landdevelopment

FOR C	OFFICE USE ONLY:		
Amt. Paid Receipt No.			
Date Received			
Received By			
Parcel No.			
Aldermanic District			
GQ			
Zoning District			
For Co	omplete Submittal		
Application	Letter of Intent		
Photos	Legal Descript.		
Plan Sets	Zoning Text		
Alder Notification	Waiver		
Ngbrhd. Assn Not.	Waiver		
Date Sign Issued			

• All Land Use Applications should be filed with the Zo Administrator at the above address.	Date Sign Issued
Project Address: 2501 East Springs Drive	Project Area in Acres: 1.8 acres
Project Title (if any): Goben Cars	
2. This is an application for (Check all that apply to you	ur Land Use Application):
☐ Zoning Map Amendment from	to
☐ Major Amendment to Approved PD-GDP Zoning	☐ Major Amendment to Approved PD-SIP Zoning
✓ Conditional Use, or Major Alteration to an Approve	d Conditional Use
☐ Demolition Permit	
☐ Review of Minor Alteration to Planned Developme	nt by the Plan Commission Only
3. Applicant, Agent & Property Owner Information:	
Applicant's Name: Don Goben	Company: DMG Holding Company LLC
Street Address: 1415 Pflaum Rd Cit	y/State: Madison, WI zip: 53716
Telephone: (60δ)216-0500 Fax: ()	Email: gobencars1@yahoo.com
Project Contact Person: Arlan Kay, AIA	Company: Architecture Network Inc
Street Address: 116 E Dayton St Cit	y/State: Madison, WI zip: 53703
Telephone: <u>(608251-7515</u> Fax: <u>(608251-7566</u>	Email: arlan_archnet@tds.net
Property Owner (if not applicant):	
Street Address: Cit	y/State: Zip:
4. Project Information:	
Provide a brief description of the project and all proposed u	ses of the site: Used car dealership and outdoor
display	
Development Schedule: Commencement March 15, 20	Completion July 31, 2013

5. Required Submittals:	
-------------------------	--

- Site Plans, fully dimensioned and describing pertinent project details, submitted as follows below and depicting all lot lines; existing, altered, demolished and/or proposed buildings; parking areas and driveways; sidewalks; the location of any new signs; existing and proposed utility locations; building elevations, materials and floorplans, and; landscaping:
 - Seven (7) copies of a full-sized plan set drawn to a scale of 1 inch = 20 feet (collated, stapled and folded)
 - Twenty (20) copies of the plan set reduced to fit onto 11 X 17-inch paper (collated, stapled and folded)
 - For projects also being reviewed by the <u>Urban Design Commission</u>, twelve (12) additional 11 X 17-inch copies.
 - One (1) copy of the plan set reduced to fit onto 8 ½ X 11-inch paper
- REVISED! Letter of Intent: Twelve (12) copies describing this application in detail including, but not limited to: existing conditions; the project schedule; names of persons involved (contractor, architect, civil engineer, etc.); details of the project, including proposed uses, building square footage, number of dwelling units, auto and bike parking stalls, etc.; hours of operation; value of land; project cost; any public subsidy requested, and; number of construction and full-time equivalent jobs created. For projects also being reviewed by the Urban Design Commission, provide twelve (12) additional copies of the letter.
- Filing Fee: Refer to the Land Use Application Information & Fee Schedule. Make checks payable to: City Treasurer.
- **☑ Electronic Submittal:** All applicants are required to submit copies of all items submitted in hard copy with their application (including this application form, the letter of intent, complete plan sets, etc.) as Adobe Acrobat PDF files on a non-returnable CD to be included with their application materials, orby e-mail to <u>pcapplications@cityofmadison.com</u>.

In Addition, The Following Items May Also Be Required With Your Application:

Legal Description of Property: For any application for rezoning, the description must be submitted as an electronic word
document via CD or e-mail. For applications requesting rezoning to more than one district, a separate description of
each district shall be submitted.

☐ For any applications proposing **Demolition or Removal** of existing buildings, the following items are required:

- Prior to the filing of an application, the applicant or his/her agent is required to notify a list of interested persons
 registered with the City 30 or 60 days prior to filing their application using the online notification tool found at:
 https://www.cityofmadison.com/developmentCenter/demolitionNotification/
- A photo array (6-12 photos) of the **interior and exterior** of the building(s) to be demolished or removed. A written assessment of the condition of the building(s) to be demolished or removed is highly recommended.
- Approval of a Reuse & Recycling Plan by the City's Recycling Coordinator is required prior to issuance of permits.

A Zoning Text shall accon	npany all Planne	d Development	District (PD/PCD	/PUD) applications

6. Applicant Declarations:

Conformance v	vith adopted City plans: The site is located within the limits of the East Towns	e - Burke
Heights	Plan, which recommends Retail Commercial use	for this property.

- ▶ Pre-application Notification: Section 28.12 of the Zoning Code requires that the applicant notify the district alder and any nearby neighborhood and business associations in writing no later than 30 days prior to filing this request. List the alderperson, neighborhood association(s), and business association(s) AND the dates you sent the notices: Joe Clausius Dist. 17, 13 Dec 2012; no neighborhood association, no business association
 - → If a waiver has been granted to this requirement, please attach any correspondence to this effect to this form.
- Pre-application Meeting with Staff: Prior to preparation of this application, the applicant is required to discuss the proposed development and review process with Zoning and Planning Division staff; note staff persons and date.

 Planning Staff: Kevin Firchow

 Date: 13 Dec 2012 Zoning Staff: Pat Anderson

 Date: 13 Dec 2012
- → The applicant attests that this form is accurately completed and all required materials are submitted:

Name of Applicant	Relation to Property Owner_
Authorizing Signature of Property Owner	Date





SHEET INDEX

TS1.1	TITLI	E SHEET

DP-1.0 OVERALL DEVELOPMENT PLAN (11X17 Only)

DP-1.1 AERIAL PHOTO - DEVELOPMENT (11X17 Only)

C1.0 SITE PLAN

C1.1 SITE GRADING, UTILITY, STORM WATER PLAN

L-1.0 LANDSCAPE PLAN

C3.1 SITE LIGHTING PLAN

C3.2 SITE LIGHTING FIXTURES

C1.0A FUTURE SITE PLAN

A1.1 FLOOR PLAN

A2.1 ELEVATIONS

A2.2 ELEVATIONS

A3.1 SITE RENDERING - CORNER (11X17 Only)

A3.2 SITE RENDERING - EAST SPRINGS DRIVE (11X17 Only)



116 East Dayton Street Madison, WI 53703 608-251-7515 Phone 608-251-7566 Fax



GOBEN CARS East Springs Drive


REV-1	01-30-2013
KL_V-1	01-30-2013
DATE:	12-19-2012
SCALE:	-
PROJECT:	K1214
DRAWN BY:	KAC

TITLE SHEET

DRAWING NUMBER

TS1.1

Í "EQR| TKLJ V"D| "⊰CTEJ KVGEVWTGP GVY QTM"KPE

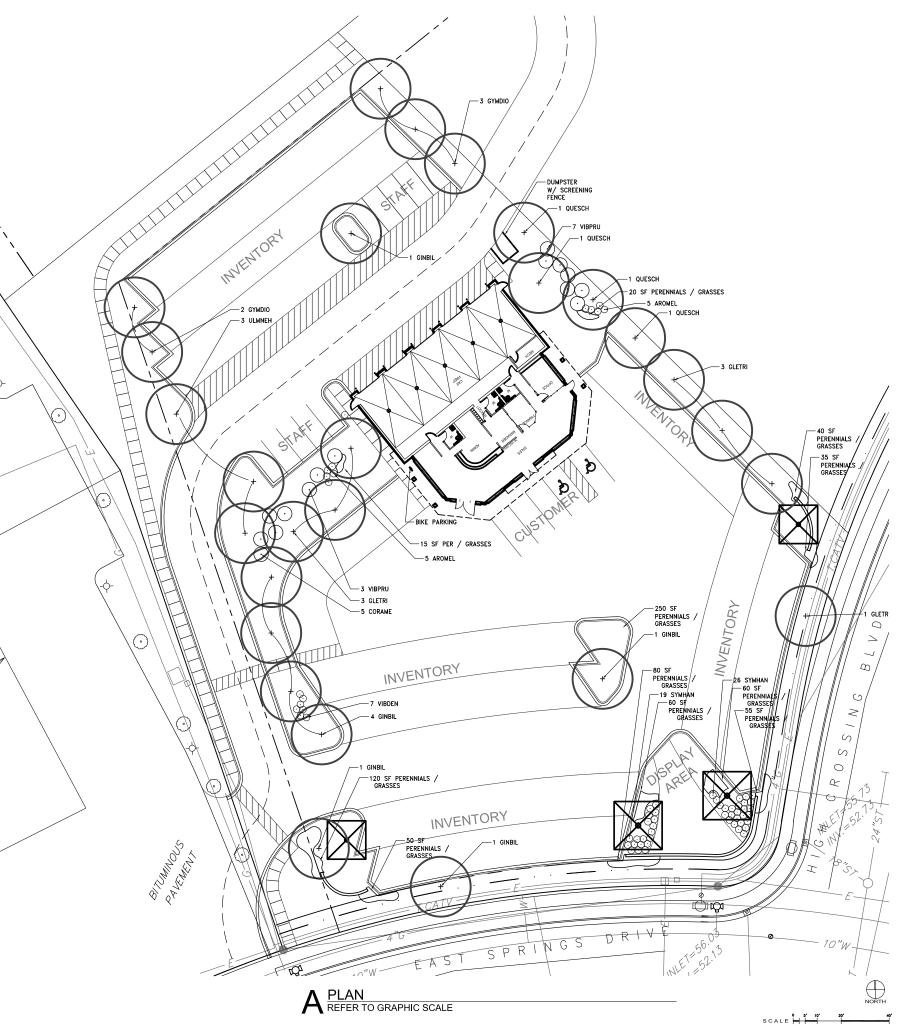

uantity	ER PLAN	Scientific Name	Common Name	Size	Root	Spacing
uanning	Rey	Scientific Name	Common Name	3126	ROOL	Spacing
27	TREES					
	CELOCP	Celtis occidentalis ' Prairie Pride'	Prairie Pride Hackberry	2.5" cal.	B&B	Plan
7	GLETIS	Gleditsia triacanthos var. inermis 'Skyline'	Thornless Common Honeylocust	2.5" cal.	B&B	Plan
8	GINBIL	Ginkgo biloba	Ginkgo biloba	2.5" cal.	B&B	Plan
5	GYMDIO	Gymnocladus dioicus 'Expresso'	Expresso Kentucky Coffeetree	2.5" cal.	B&B	Plan
4	QUESCH	Quercus macrocarpa	Bur Oak	2.5" cal.	B&B	Plan
3	ULMNEH	Ulmus x 'New Horizon'	Accolade Smoothlead Elm	2.5" cal.	B&B	Plan
15	SMALL TRE	ES				
	AMEGRA	Amelanchier grandiflora	Apple Serviceberry	4' ht.	B&B	Plan
	CRACIN	Crataegus crus-galli var. inermis	Thornless Cockspur Hawthorn	4' ht.	B&B	Plan
5	CORAME	Corylus americana	American Hazelnut	5 gal.	Cont.	Plan
10	VIBPRU	Viburnum prunifolium	Blackhaw Viburnum	4' ht.	B&B	Plan
62	SHRUBS					
10	AROMEL	Aronia melanocarpa	Black Chokeberry	5 gal.	Cont.	Plan
	PHYOPU	Physocarpus opulifolius	Common Ninebark	5 gal.	Cont.	Plan
	RHUAGL	Rhus aromatica 'Gro-low'	Grow-low Sumac	5 gal.	Cont.	Plan
	SYRMPA	Syringa meyeri 'Palibin'	Palivin Lilac	5 gal.	Cont.	Plan
45	SYMHAN	Symphoricarpos x chenaultii 'Hancock'	Hancock Coralberry	2 gal	Cont.	Plan
7	VIBDEN	Viburnum dentatum	Arrowwood Viburnum	5 gal.	Cont.	Plan
300	Perennials					
15	ALLCER	Allium cernuum	Nodding Onion	gal.	Cont.	18"
15	ANECAN	Anemone canadensis	Meadow Anemone	gal.	Cont.	18"
15	ASCTUB	Asclepias tuberosa	Butterflyweed	gal.	Cont.	18"
15	ASTAZU	Aster azureus	Sky Blue Aster	gal.	Cont.	18"
15	CORPAL	Coreopsis palmata	Prairie Coreopsis	gal.	Cont.	18"
15	ECHPUR	Echinacea purpurea	Purple Coneflower	gal.	Cont.	18"
15	EUPMGA	Eupatorium maculatum 'Gateway'	Spotted Joe Pye Weed	gal.	Cont.	18"
15	HEURIC	Heuchera richardsonii	Prairie Alum Root	gal.	Cont.	18"
15	LIAPYC	Liatris pychnostachya	Blazing Star	gal.	Cont.	18"
15	MISSGR	Miscanthus sinsensis 'Gracillimus'	Maiden Grass	gal.	Cont.	18"
15	PANVRO	Panicum virgatum 'Rotstahlbusch'	Red Switch Grass	gal.	Cont.	18"
15	PARINT	Parthenium integrifolium	Wild Quinine		Cont.	18"
		ů	1 111 1	gal.		18"
15	PENDHR	Penstemon digitalis 'Husker Red'	Foxglove Beard Tongue	gal.	Cont.	18"
15	PETPUR	Petalostemum purpureum	Purple Prairie Clover	gal.	Cont.	
15	PHYVIR	Physostegia virginiana	Obedient Plant	gal.	Cont.	18"
15	RATPIN	Ratibida pinnata	Yellow Coneflower	gal.	Cont.	18"
15	RUDFGO	Rudbeckia fulgida 'Goldsturm'	Goldsturm Black-eyed Susan	gal.	Cont.	18"
15	SCHSCO	Schizachyrium scoparius	Little Bluestem	gal.	Cont.	18"
15	SEDHER	Sedum 'Herbstfreude'	Autumn Joy Sedum	gal.	Cont.	18"
15	SPOHET	Sporobolus heterolepis	Prairie Dropseed	gal.	Cont.	18"

B PLANT SCHEDULE

LANDSCAPE WORKSHEET

Parking Lots, Storage Areas and Loading Areas (Section 28.04 Madison General Ordinance)

Project Location/Address: 2501 EAST SPRINGS DRIVE	
Name of Project: GOBEN CARS	
Owner/Contact: ARLAN KAY, AIA; ARCHITECTURE NETWO	RK, INC
116 P DAVTON CT. MADTCON WT 52702	

FOR PARKING LOTS WITH GREATER THAN 20 STALLS, LANDSCAPE PLANS MUST BE STAMPED BY A REGISTERED

Number of Trees Required

The number of trees required for a parking lot is based on the number of parking stalls. Using the Schedule for Required Trees on the reverse side of this worksheet, determine the number of trees required. (Example: One tree is required for 10 parking stalls).

Landscape requirements for storage areas are determined by dividing the total square footage of the storage area by (300) square feet. This converts area to statilis. [Example: 10,000 square feet are equivalent to (33) statils or (3) trees and (160) points].

Number of Parking Stalls -Total Square Footage of the Storage Area Divided by Three Hundred (300) Square Fee

II. Number of Landscape Points Required
The number of points required is also based on the number of parking stalls. Using the Point
Schedule for Landscape Elements on the reverse side of this worksheet, determine the number of points required. (Example: 49.5 points are required for 10 stalls). A point fraction of
(.5) or less may be disregarded, while a fraction in excess of (.5) must be counted as one
point. Thus: 49.5 points would be rounded down to 49.0 points required. The number of points required for loading areas is (75) points for each loading bert (See Schedule on reverse side)

Tabulation of Points and Credits
Indicate below the quantity and points for all pertinent landscape elements. Also, credit information for boundary screening and any existing elements to be retained.

Number of Points Required (See Schedule on reverse side

				CREDITS		
ELEMENT	POINT VALUE	QUANTITY	POINTS ACHIEVED	QUANTITY	Points	
Canopy Tree: 2" - 2 1/2*	35	14	490			
Deciduous Shrub	2	58	116			
Evergreen Shrub	3	0				
Decorative Wall or Fence (per 10 L.F.)	5	0				
Earth Berm (per 10 L.F.) Avg. Height 30" Avg. Height 15"	5 2	0				
Evergreen Trees 3' height minimum	15	0				
Canopy Tree or Small Tree 1 ½" – 2" Caliper (i.e., Crab, Hawthorn)	15	25	375			
		Sub Totals	981	+		

*Trees required in Part I above, are not to be included in the point count.

981 Total No. of Points Provided (Equal to or greater than point required)

Approved by:	 ate:

C LANDSCAPE WORKSHEET



116 East Dayton Street Madison, WI 53703 608-251-7515 Phone 608-251-7566 Fax www.architecture-network.net

Living Habitats

Ecological Sen Custom Artworks 6457 North Sayre Avenue Chicago, Illinois 60631 p: 773-467-1634




REVISIONS:	
1	30 JANUARY 2013
DATE:	12/19/2012
SCALE:	1
PROJECT:	1"=20'-00"
DRAWN BY:	: AP / HN

LANDSCAPE PLAN

DRAWING NAME:





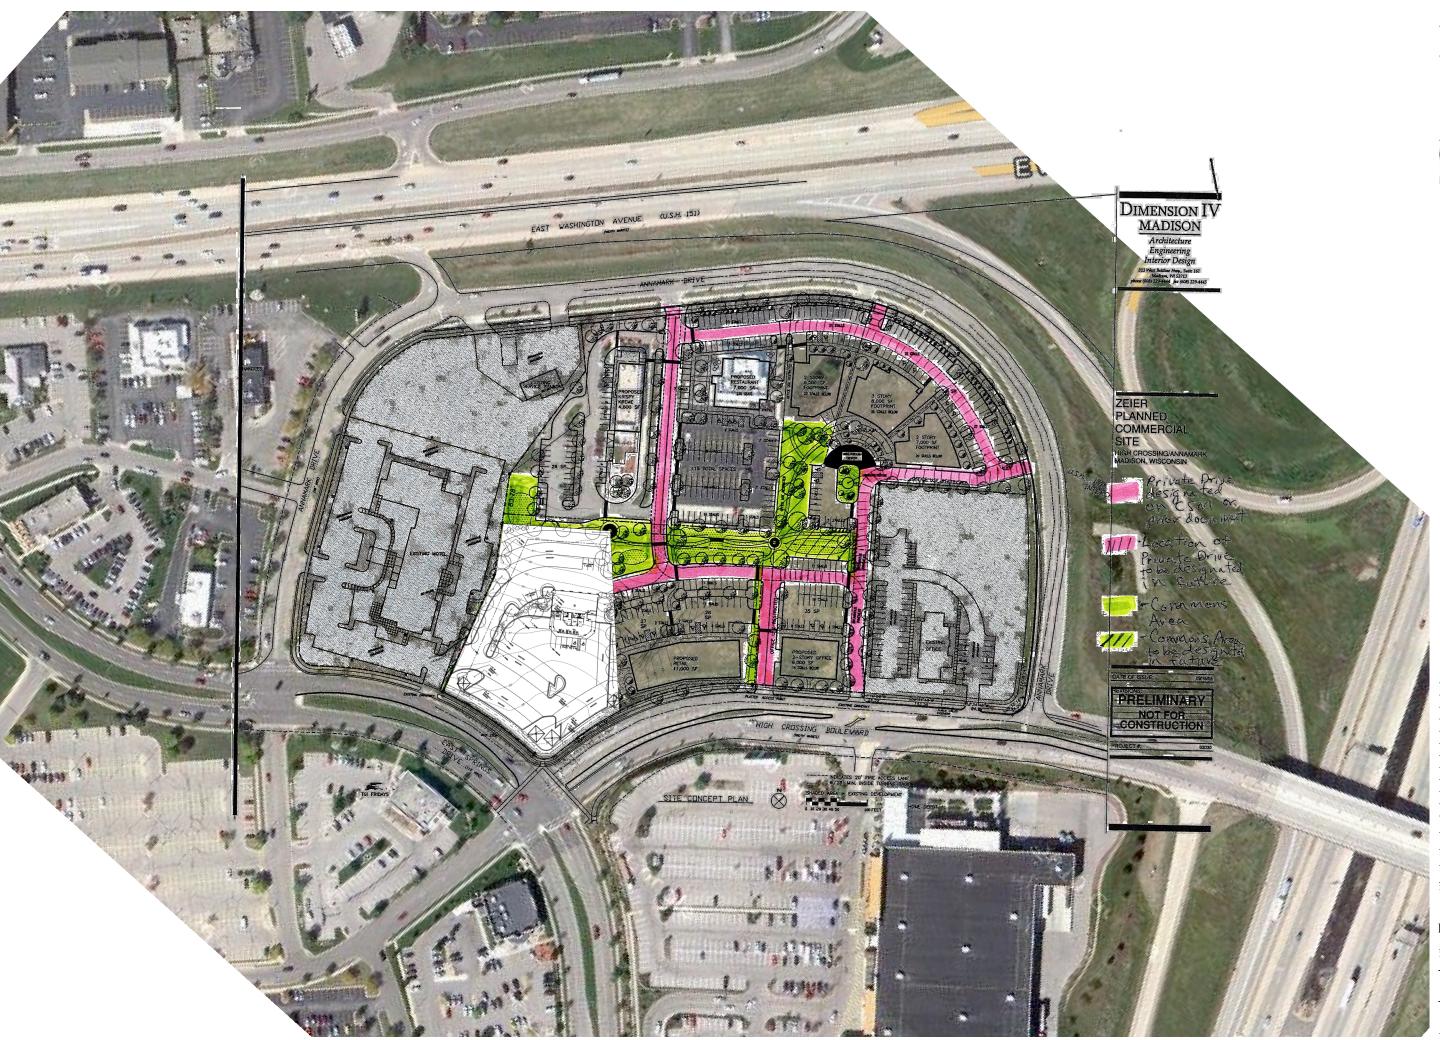





GODEN CAR

REVISION	IS:	

DATE: 19 DEC 2012

SCALE: NTS

PROJECT: K1214

DRAWN BY: ASH

DRAWING NAME:

DRAWING NAME:

 $\begin{array}{c} \text{OVERALL} \\ \text{DEVELOPMENT PLAN} \stackrel{\text{\tiny Cl. Sign}}{\underset{\sim}{\stackrel{}{\sim}}} \end{array}$

DRAWING NUMBER

DP-1.0 [2]

214 SiteOverall 121217.vwx





GOBEN CARS East Springs Drive Madison, Wisconsin

EVISIONS		
REV-1	01-30-2013	
ATE:	12-19-2012	
CALE:	1/8"=1'-0"	

DRAWN BY: KAC
DRAWING NAME:
FLOOR PLAN

PROJECT: K1214

DRAWING NUMBER:

A1.1

T 'EORI THE J V'DI "CTEJ BYGEVWTG'PGVY O'TM"BPE





SHEET INDEX

TC4 4	
TS1.1	TITLE SHEET

DP-1.0 OVERALL DEVELOPMENT PLAN (11X17 Only)

DP-1.1 AERIAL PHOTO - DEVELOPMENT (11X17 Only)

C1.0 SITE PLAN

C1.1 SITE GRADING, UTILITY, STORM WATER PLAN

L-1.0 LANDSCAPE PLAN

C3.1 SITE LIGHTING PLAN

C3.2 SITE LIGHTING FIXTURES

C1.0A FUTURE SITE PLAN

A1.1 FLOOR PLAN

A2.1 ELEVATIONS

A2.2 ELEVATIONS

A3.1 SITE RENDERING - CORNER (11X17 Only)

A3.2 SITE RENDERING - EAST SPRINGS DRIVE (11X17 Only)



116 East Dayton Street Madison, WI 53703 608-251-7515 Phone 608-251-7566 Fax www.architecture-network.ne




GOBEN CARS

REVISIONS:	
REV-1	01-30-2013
DATE:	12-19-2012
SCALE:	-
PROJECT:	K1214
DRAWN BY:	KAC
DRAWING	V. 1 2 0F

TITLE SHEET

DRAWING NUMI

TS1.1

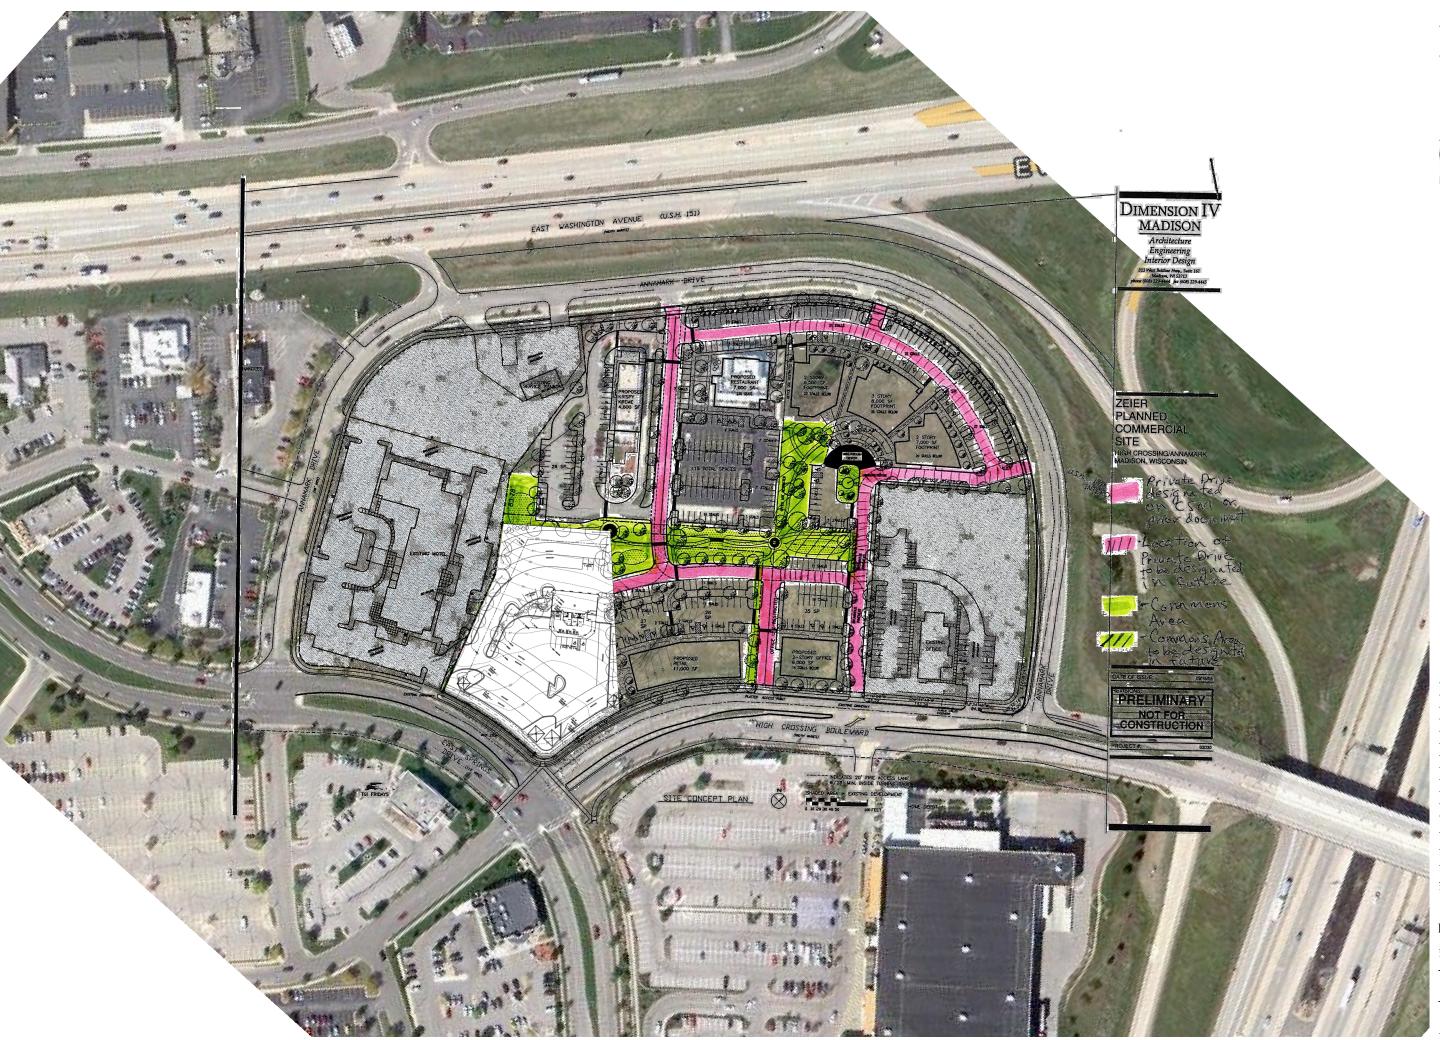






SCALE: PROJECT: K1214 DRAWN BY: ASH

DRAWING NAME:

 $\begin{array}{c} \text{OVERALL} \\ \text{DEVELOPMENT PLAN} \stackrel{\text{\tiny CLS}}{\overset{\text{\tiny NS}}{\overset{\text{\tiny NS}}{\overset{\text{\tiny NS}}{\overset{\text{\tiny NS}}}}}} \end{array}$

DP-1.0 [2]



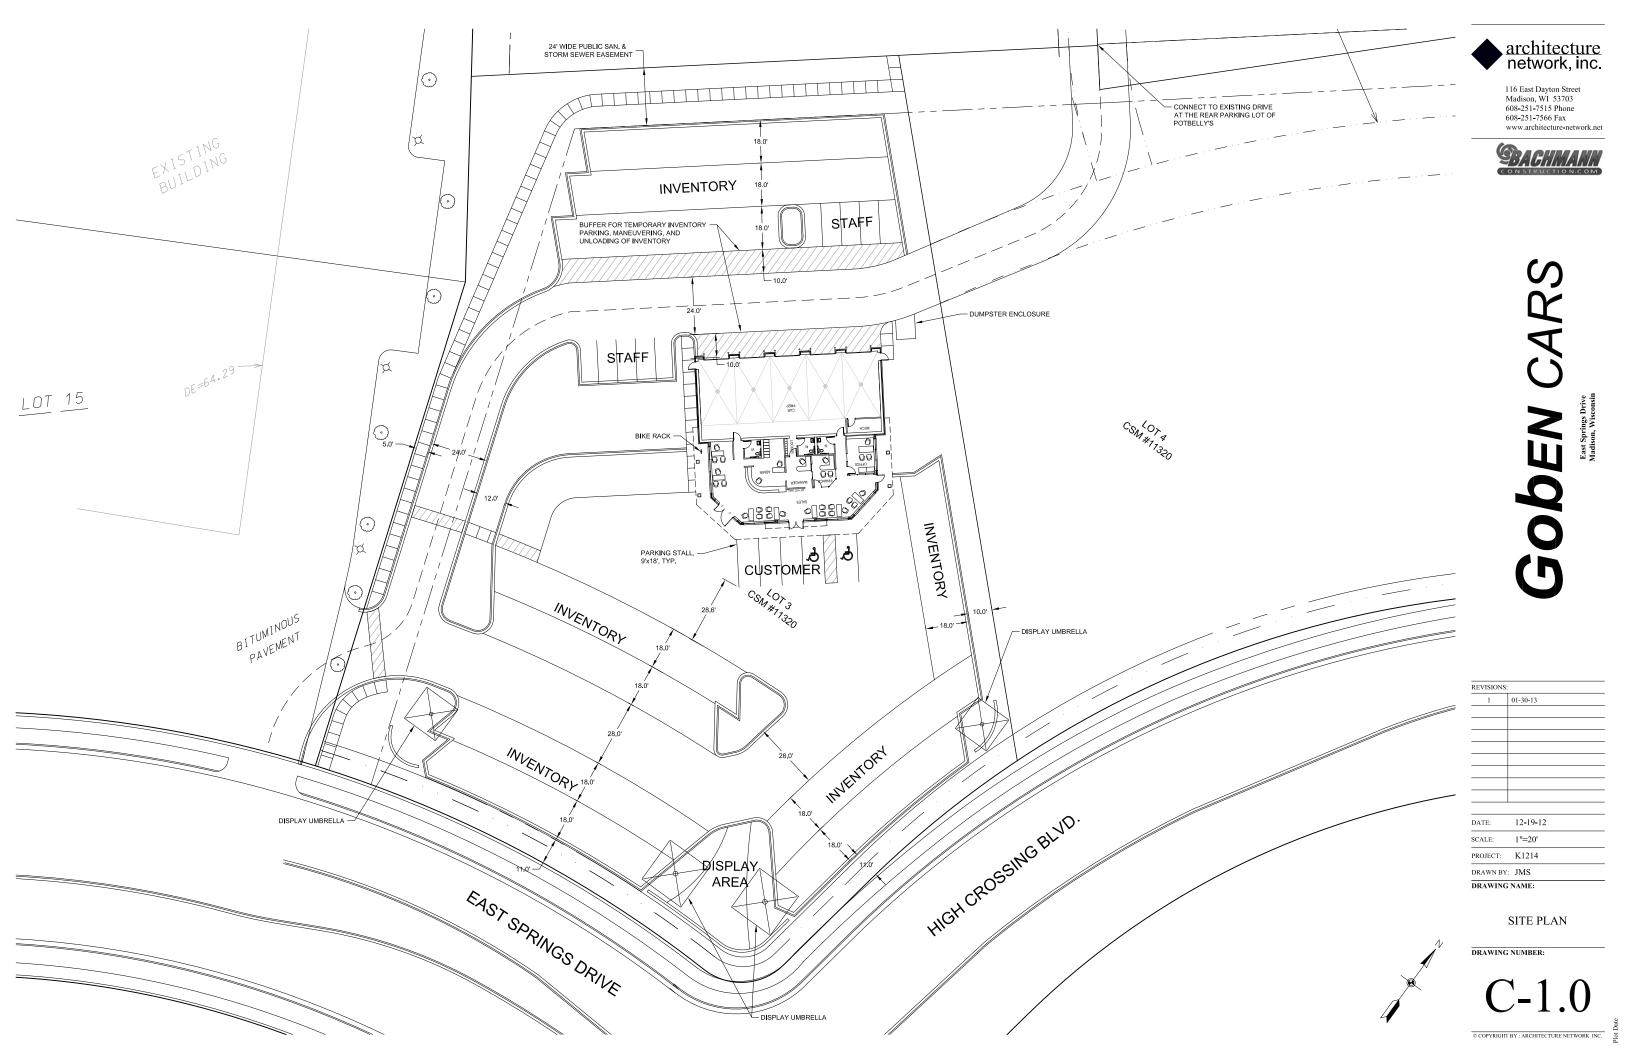




architecture network, inc.

www.architecture-network.net

BACHMANN

GRADING, UTILITY AND STORM WATER PLAN

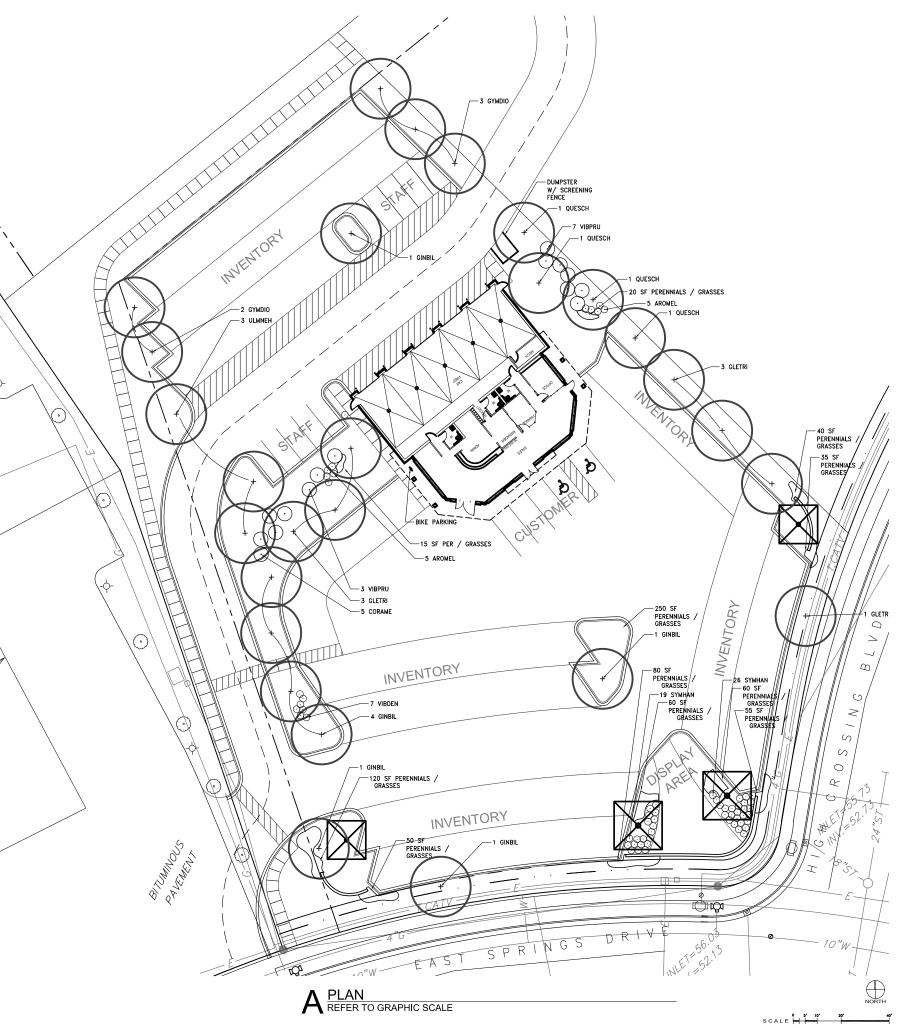

uantity	Key	Scientific Name	Common Name	Size	Root	Spacing
adiracy	itey	ocienane Name	Common Name	OIZE	Root	Opacing
27	TREES	·				
	CELOCP	Celtis occidentalis ' Prairie Pride'	Prairie Pride Hackberry	2.5" cal.	B&B	Plan
7	GLETIS	Gleditsia triacanthos var. inermis 'Skyline'	Thornless Common Honeylocust	2.5" cal.	B&B	Plan
8	GINBIL	Ginkgo biloba	Ginkgo biloba	2.5" cal.	B&B	Plan
5	GYMDIO	Gymnocladus dioicus 'Expresso'	Expresso Kentucky Coffeetree	2.5" cal.	B&B	Plan
4	QUESCH	Quercus macrocarpa	Bur Oak	2.5" cal.	B&B	Plan
3	ULMNEH	Ulmus x 'New Horizon'	Accolade Smoothlead Elm	2.5" cal.	B&B	Plan
15	SMALL TREE	is i				
	AMEGRA	Amelanchier grandiflora	Apple Serviceberry	4' ht.	B&B	Plan
	CRACIN	Crataegus crus-galli var. inermis	Thornless Cockspur Hawthorn	4' ht.	B&B	Plan
5	CORAME	Corylus americana	American Hazelnut	5 gal.	Cont.	Plan
10	VIBPRU	Viburnum prunifolium	Blackhaw Viburnum	4' ht.	B&B	Plan
62	SHRUBS	1				
10	AROMEL	Aronia melanocarpa	Black Chokeberry	5 gal.	Cont.	Plan
	PHYOPU	Physocarpus opulifolius	Common Ninebark	5 gal.	Cont.	Plan
	RHUAGL	Rhus aromatica 'Gro-low'	Grow-low Sumac	5 gal.	Cont.	Plan
	SYRMPA	Syringa meyeri 'Palibin'	Palivin Lilac	5 gal.	Cont.	Plan
45	SYMHAN	Symphoricarpos x chenaultii 'Hancock'	Hancock Coralberry	2 gal	Cont.	Plan
7	VIBDEN	Viburnum dentatum	Arrowwood Vibumum	5 gal.	Cont.	Plan
300	Perennials					
15	ALLCER	Allium cernuum	Nodding Onion	gal.	Cont.	18"
15	ANECAN Anemone canadensis		Meadow Anemone	gal.	Cont.	18"
15	ASCTUB	Asclepias tuberosa	Butterflyweed	gal.	Cont.	18"
15	ASTAZU Aster azureus		Sky Blue Aster	gal.	Cont.	18"
15			Prairie Coreopsis	gal.	Cont.	18"
15	ECHPUR	Echinacea purpurea	Purple Coneflower	gal.	Cont.	18"
15	EUPMGA	Eupatorium maculatum 'Gateway'	Spotted Joe Pye Weed	gal.	Cont.	18"
15	HEURIC	Heuchera richardsonii	Prairie Alum Root	gal.	Cont.	18"
15	LIAPYC	Liatris pychnostachya	Blazing Star	gal.	Cont.	18"
15	MISSGR	Miscanthus sinsensis 'Gracillimus'	Maiden Grass	gal.	Cont.	18"
_			Red Switch Grass		Cont.	18"
15	PANVRO	Panicum virgatum 'Rotstahlbusch'		gal.		18"
15	PARINT	Parthenium integrifolium	Wild Quinine	gal.	Cont.	18"
15	PENDHR	Penstemon digitalis 'Husker Red'	Foxglove Beard Tongue	gal.	Cont.	
15	PETPUR	Petalostemum purpureum	Purple Prairie Clover	gal.	Cont.	18"
15	PHYVIR	Physostegia virginiana	Obedient Plant	gal.	Cont.	18"
15	RATPIN	Ratibida pinnata	Yellow Coneflower	gal.	Cont.	18"
15	RUDFGO	Rudbeckia fulgida 'Goldsturm'	Goldsturm Black-eyed Susan	gal.	Cont.	18"
15	SCHSCO	Schizachyrium scoparius	Little Bluestem	gal.	Cont.	18"
15	SEDHER	Sedum 'Herbstfreude'	Autumn Joy Sedum	gal.	Cont.	18"
15	SPOHET	Sporobolus heterolepis	Prairie Dropseed	gal.	Cont.	18"

B PLANT SCHEDULE

LANDSCAPE WORKSHEET

Parking Lots, Storage Areas and Loading Areas (Section 28.04 Madison General Ordinance)

Project Lo	cation/	Addro	ess:	2501	EAST	S	PRIN	īGS	DRI	VE			
Name of F	roject:	GOB	EN	CAR	S								
Owner/Co	ntact: A	RL	AN	KAY,	AIA	; A	RCH1	ITE	CTUR	Ε	NETWOR	К,	INC
Address:	116	E	DA'	YTON	ST:	MAI	DISO	N.	WI	5	3703		

FOR PARKING LOTS WITH GREATER THAN 20 STALLS, LANDSCAPE PLANS MUST BE STAMPED BY A REGISTERED

Number of Trees Required

The number of trees required for a parking lot is based on the number of parking stalls. Using the Schedule for Required Trees on the reverse side of this worksheet, determine the number of trees required. (Example: One tree is required for 10 parking stalls).

Landscape requirements for storage areas are determined by dividing the total square footage of the storage area by (300) square feet. This converts area to statilis. [Example: 10,000 square feet are equivalent to (33) statils or (3) trees and (160) points].

Number of Parking Stalls -Total Square Footage of the Storage Area Divided by Three Hundred (300) Square Fee

II. Number of Landscape Points Required
The number of points required is also based on the number of parking stalls. Using the Point
Schedule for Landscape Elements on the reverse side of this worksheet, determine the number of points required. (Example: 49.5 points are required for 10 stalls). A point fraction of
(.5) or less may be disregarded, while a fraction in excess of (.5) must be counted as one
point. Thus: 49.5 points would be rounded down to 49.0 points required. The number of points required for <u>loading areas</u> is (75) points for each loading b (See Schedule on reverse side)

Tabulation of Points and Credits
Indicate below the quantity and points for all pertinent landscape elements. Also, credit information for boundary screening and any existing elements to be retained.

Number of Points Required (See Schedule on reverse sid

				CREDITS		
ELEMENT	POINT VALUE	QUANTITY	POINTS ACHIEVED	QUANTITY	Points	
Canopy Tree: 2" - 2 1/2*	35	14	490			
Deciduous Shrub	2	58	116			
Evergreen Shrub	3	0				
Decorative Wall or Fence (per 10 L.F.)	5	0				
Earth Berm (per 10 L.F.) Avg. Height 30" Avg. Height 15"	5 2	0				
Evergreen Trees 3' height minimum	15	0				
Canopy Tree or Small Tree 1 ½" – 2" Caliper (i.e., Crab, Hawthorn)	15	25	375			
		Sub Totals	981	+		

*Trees required in Part I above, are not to be included in the point count.

981 Total No. of Points Provided (Equal to or greater than points required)

C LANDSCAPE WORKSHEET



116 East Dayton Street Madison, WI 53703 608-251-7515 Phone 608-251-7566 Fax www.architecture-network.net

Living Habitats

Ecological Sen Custom Artworks 6457 North Sayre Avenue Chicago, Illinois 60631 p: 773-467-1634




REVISIONS:	
1	30 JANUARY 2013
DATE:	12/19/2012
SCALE:	1
PROJECT:	1"=20'-00"
DRAWN BY	: AP / HN


LANDSCAPE PLAN


DRAWING NAME:




© COPYRIGHT BY : ARCHITECTURE NETWORK INC.

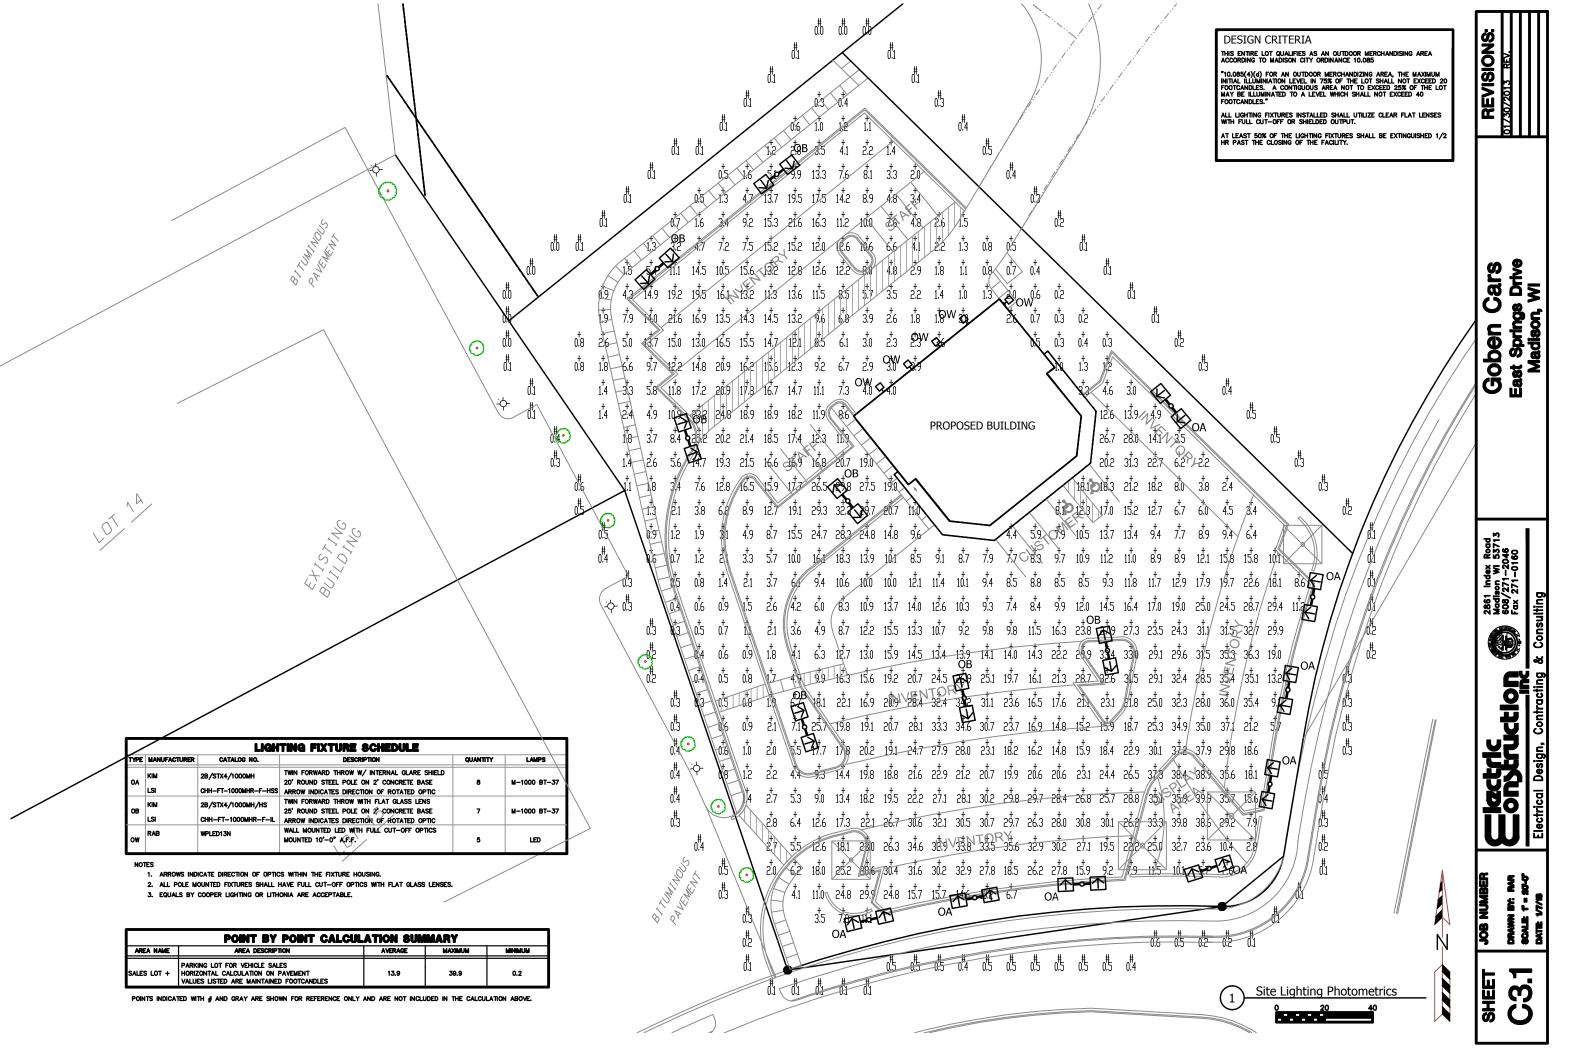


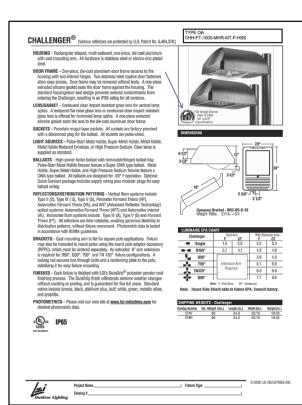

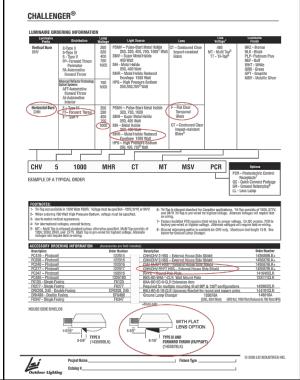



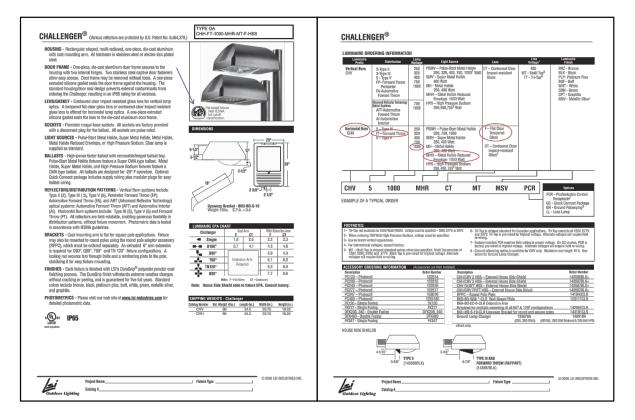


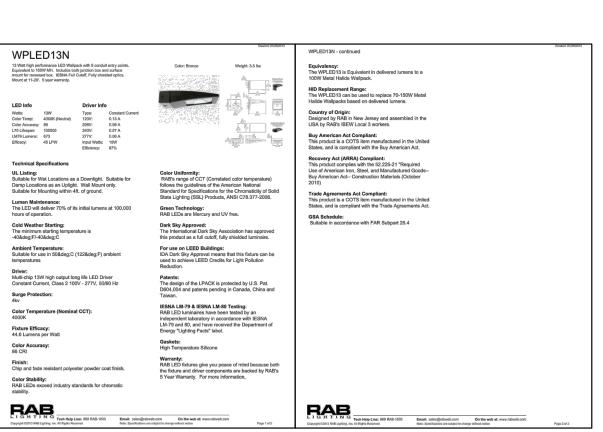

(2)

Type OB

Mounted on 25 Feet Round Pole

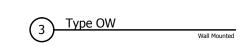



Goben Cars
East Springs Drive
Madison, Wi


dex Road WI 53713 1-2046 1-0160




| ketric | onstruction

ST. PAR NOME 17778

S SHEET 8

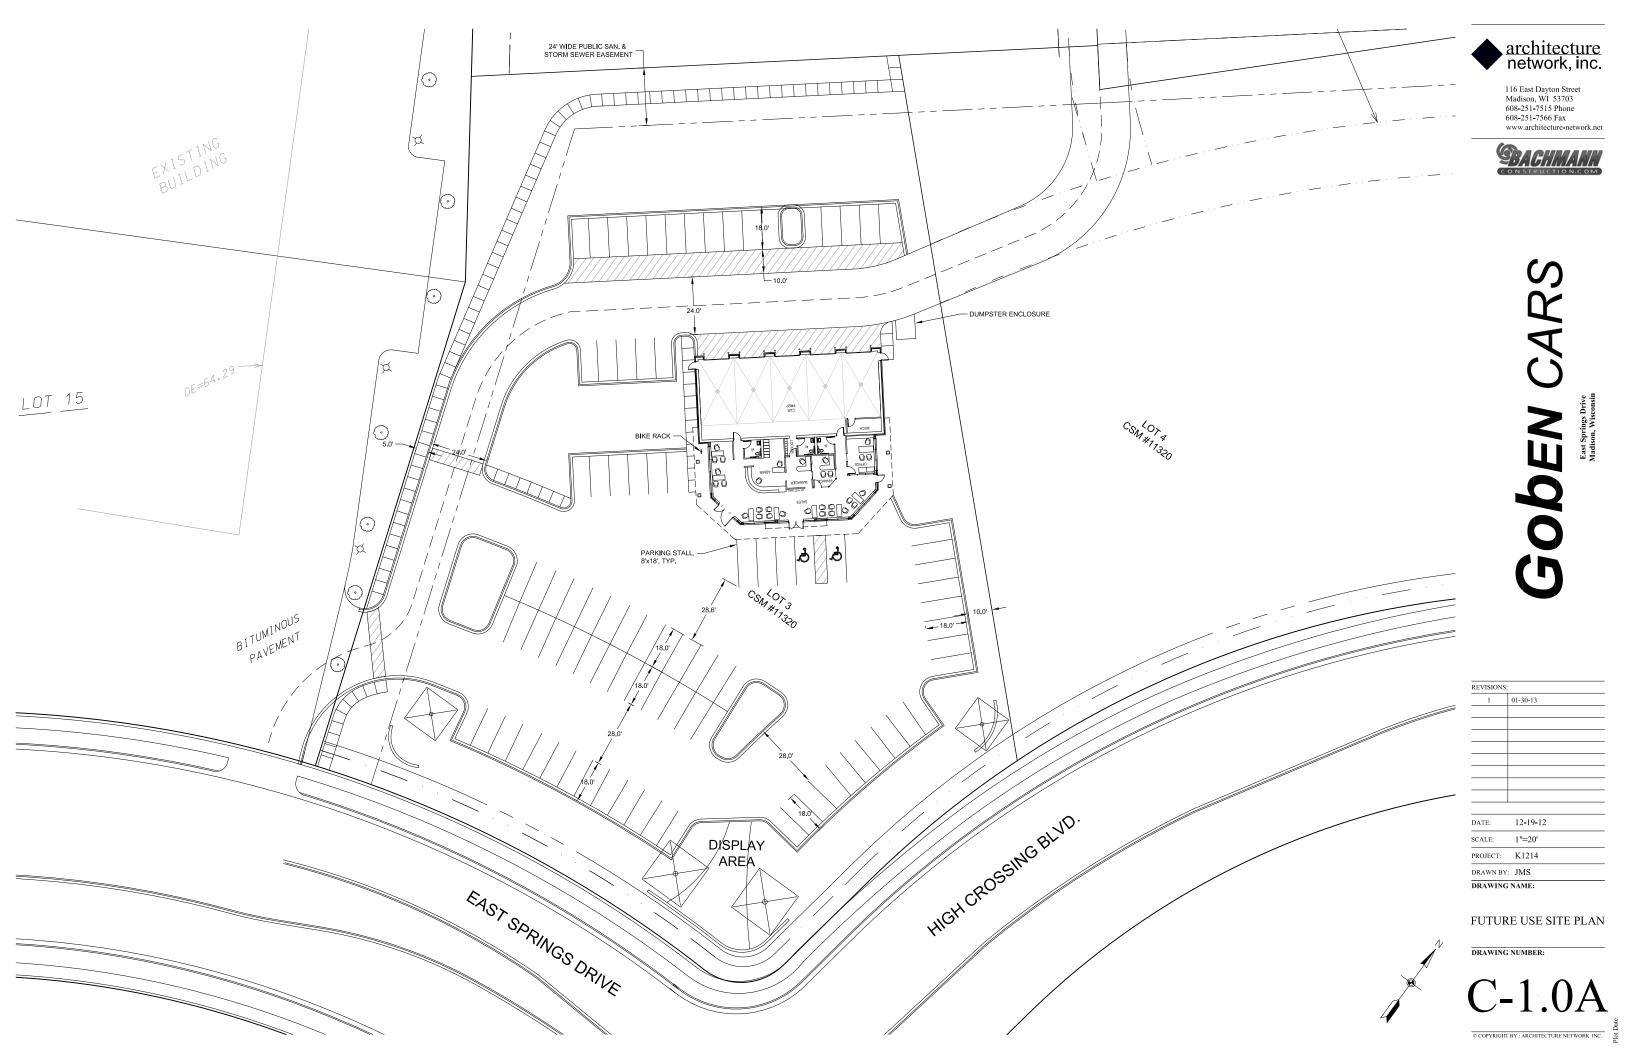

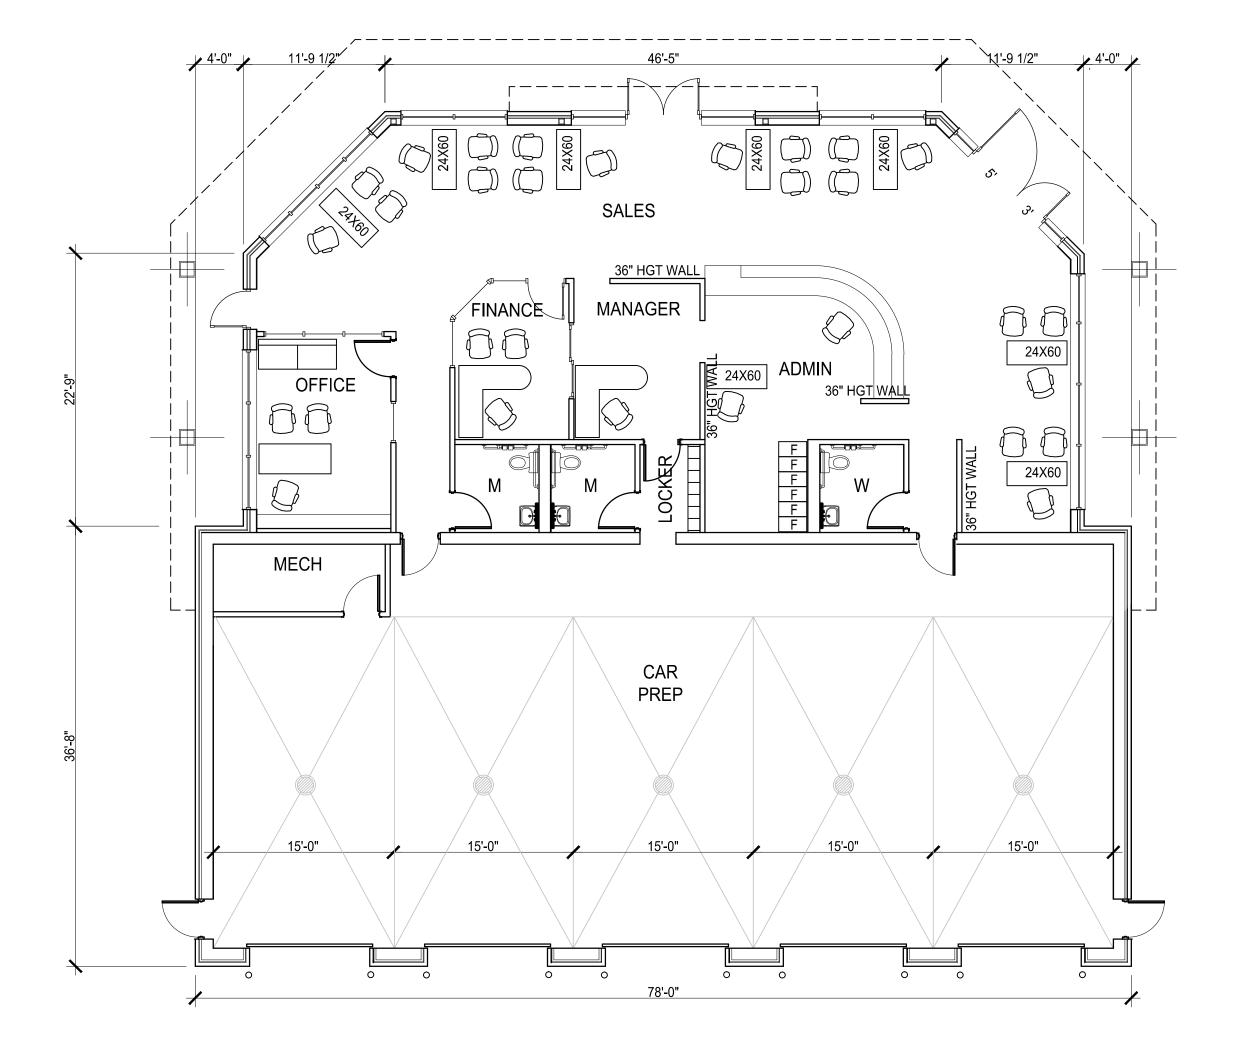





GOBEN CARS East Springs Drive Madison, Wisconsin

REVISIONS	:	
REV-1	01-30-2013	
DATE:	12-19-2012	
SCALE:	1/8"=1'-0"	

DRAWN BY: KAC
DRAWING NAME:
FLOOR PLAN

PROJECT: K1214

DRAWING NUMBER:

A1.1



BACHMANN

SCALE: PROJECT: K1214

DRAWN BY: DB DRAWING NAME:

SITE VIEW from East Springs Drive


DRAWING NUMBER:



-





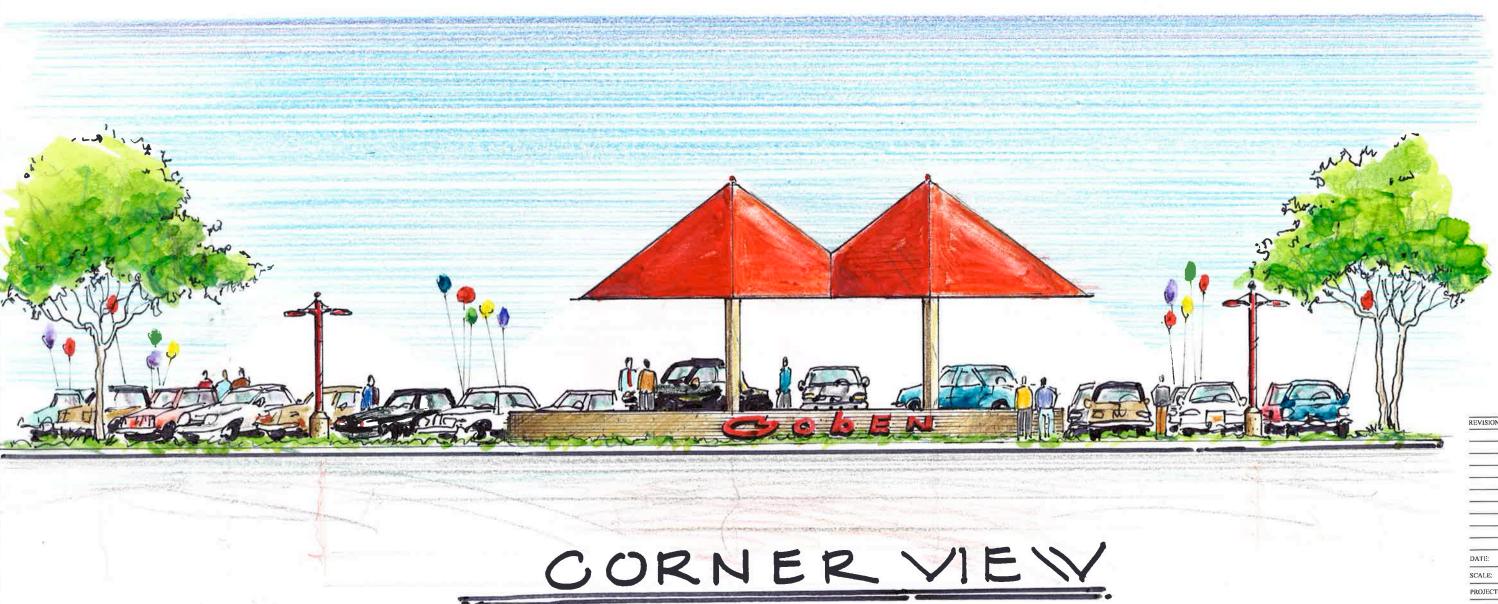

1" = 10'

REVISIO:	NS:	
	1	
	-	_
		_


1/8"=1'-0"

DRAWN BY: DB DRAWING NAME;

SITE VIEW from corner of High Crossing Blvd East Springs Drive

DRAWING NUMBER:

S COPYRIGHT BY : ARCHITECTURE NETWORK INC.

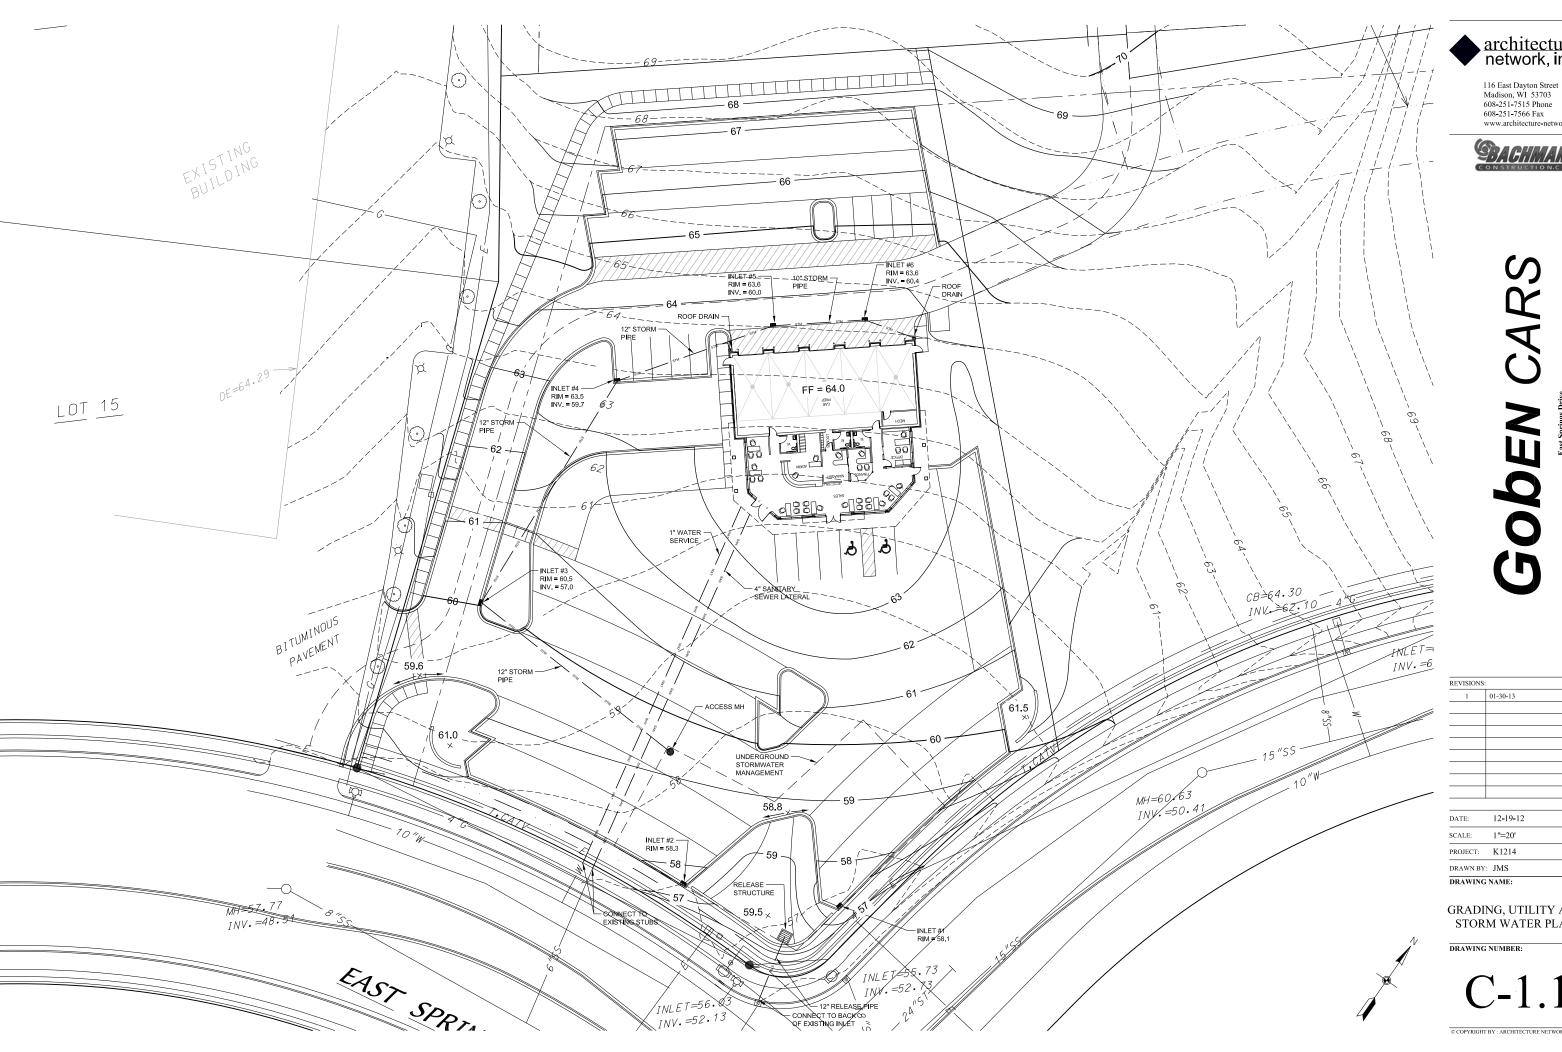


architecture network, inc.


www.architecture-network.net


BACHMANN N.COM

EVISIONS:	
1	01-30-13
ATE:	12-19-12
CALE:	1"=20'
ROJECT:	K1214

GRADING, UTILITY AND STORM WATER PLAN

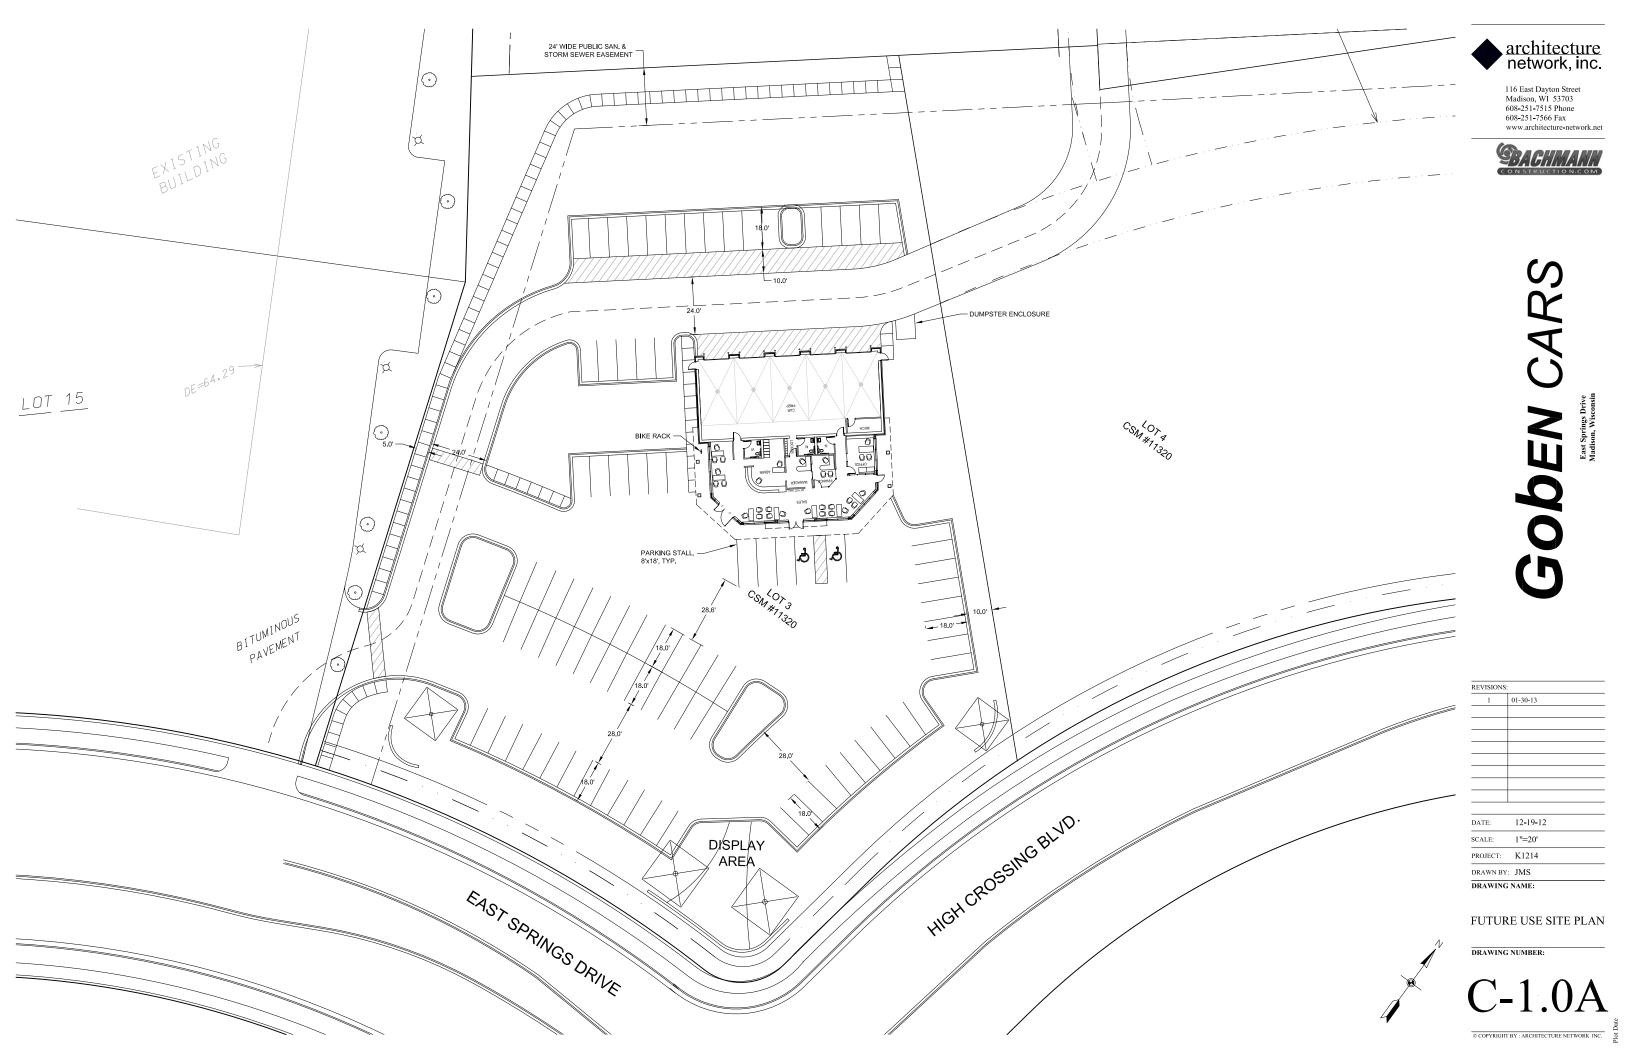

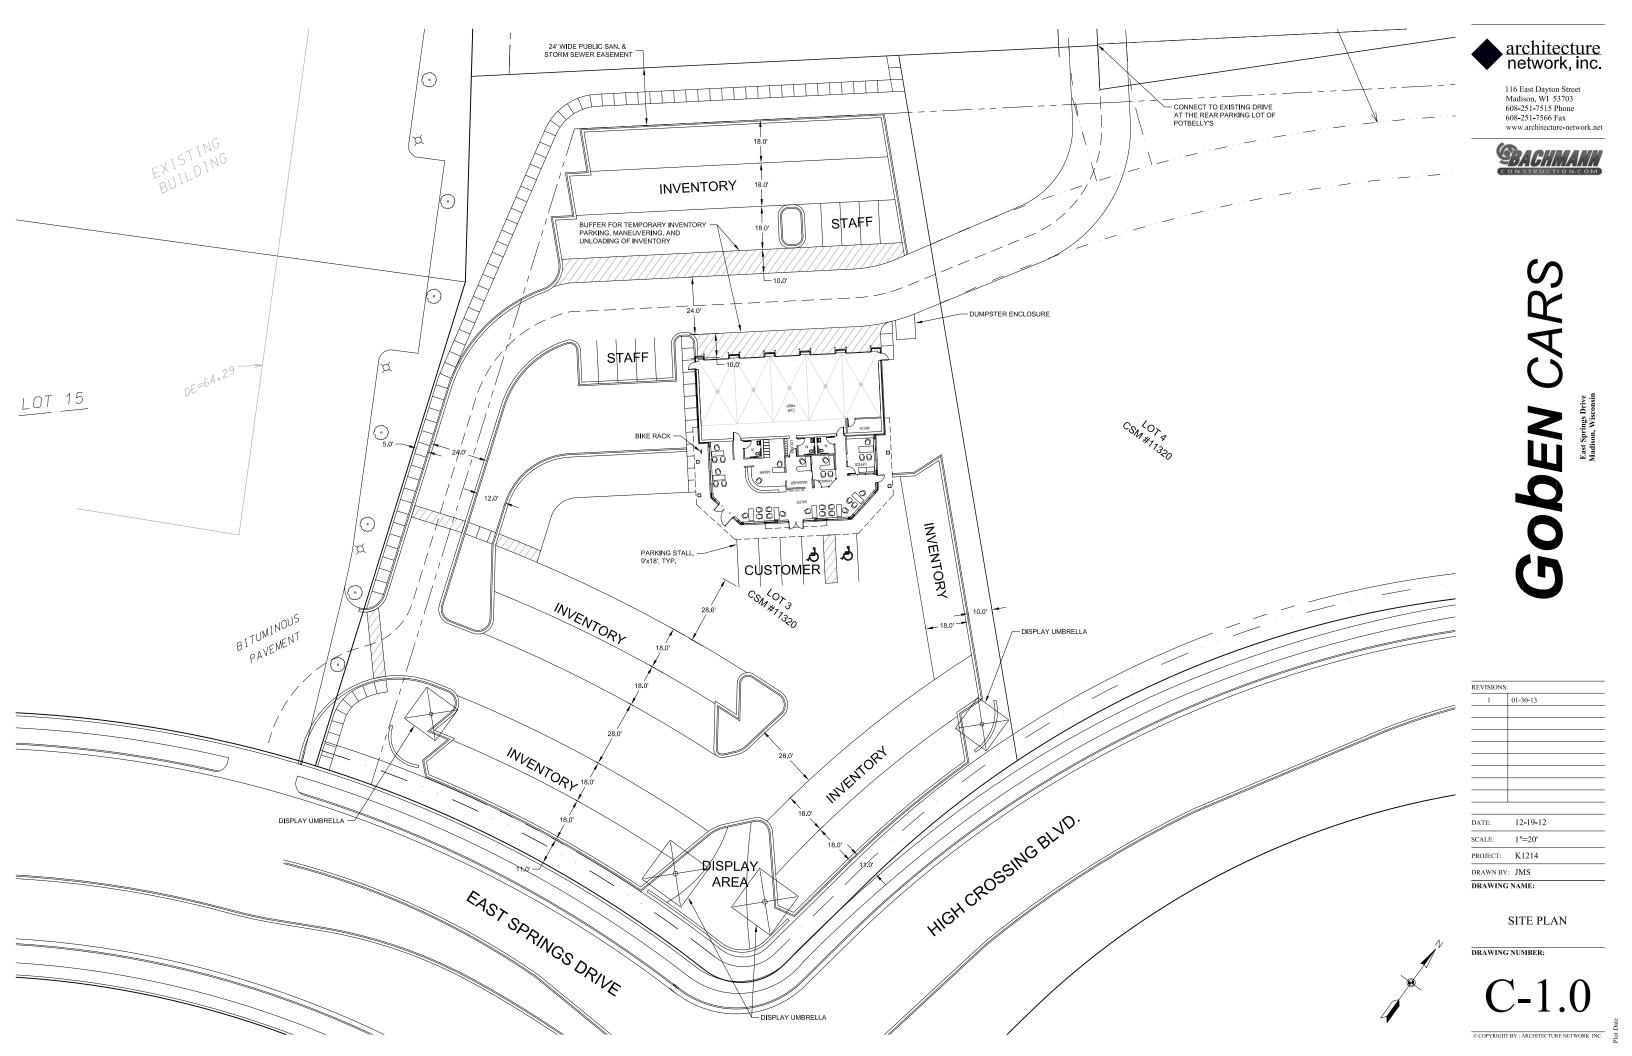

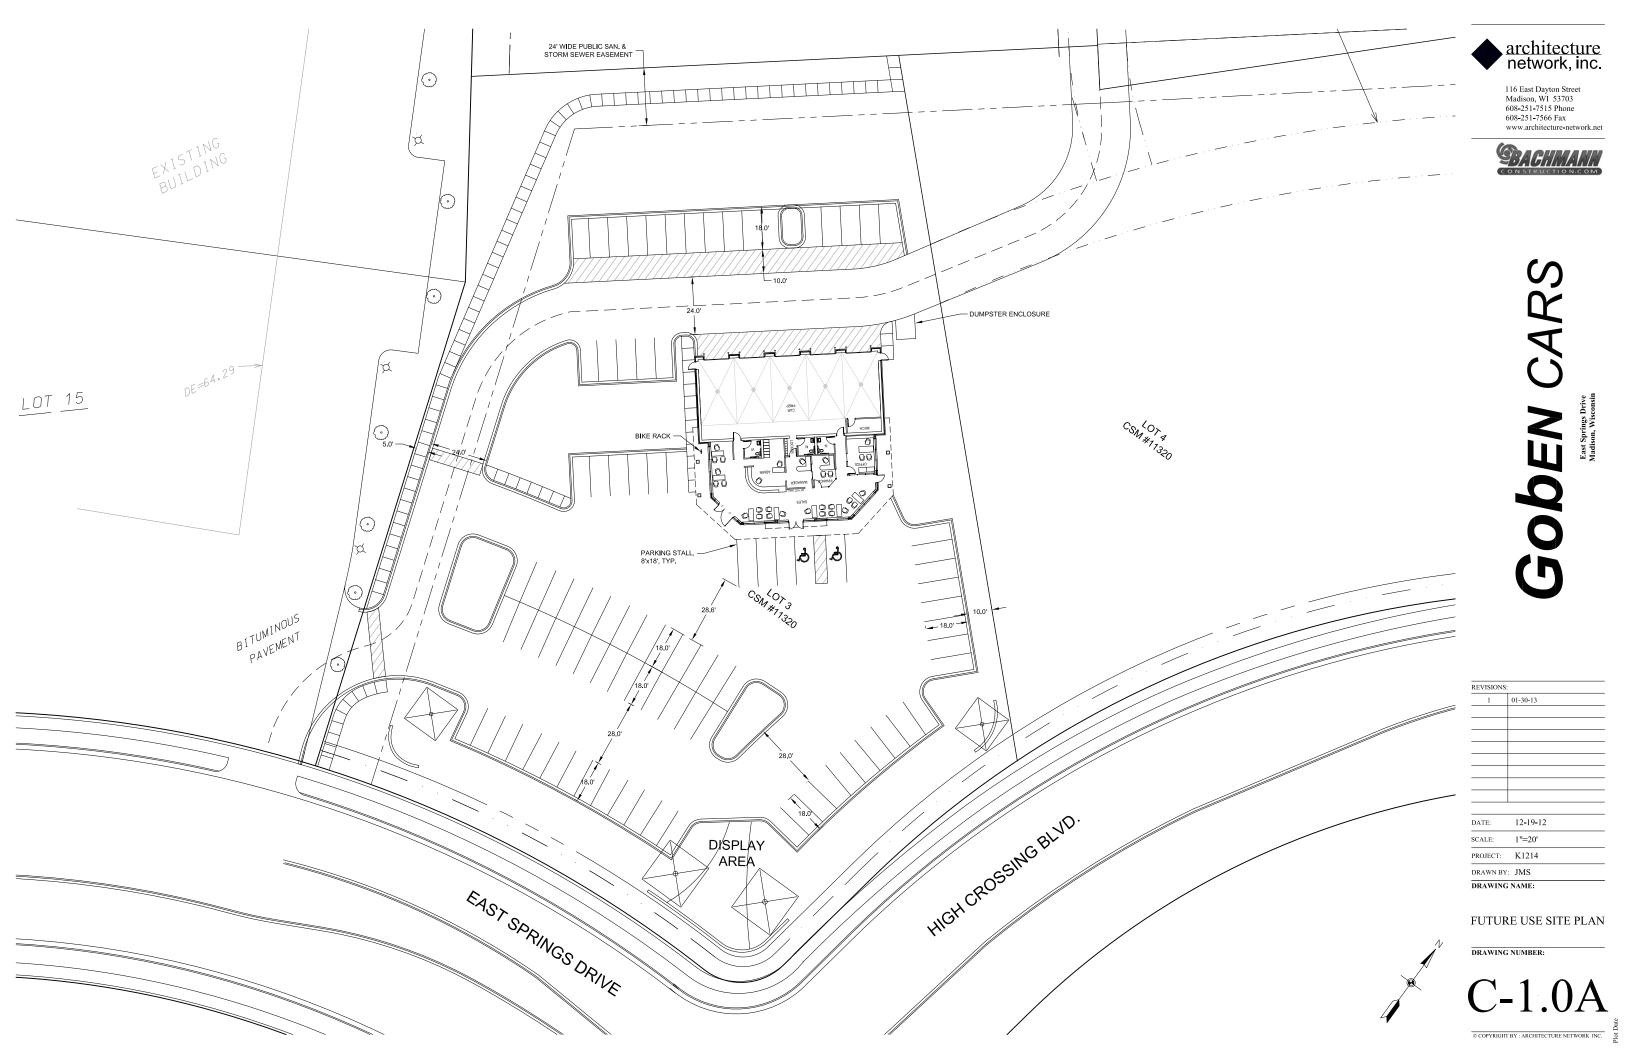



BACHMANN

REVISION	S:	
_	-	-
	1	

SCALE:

PROJECT: K1214

DRAWN BY: DB

DRAWING NAME: SITE VIEW from East Springs Drive


DRAWING NUMBER:



-





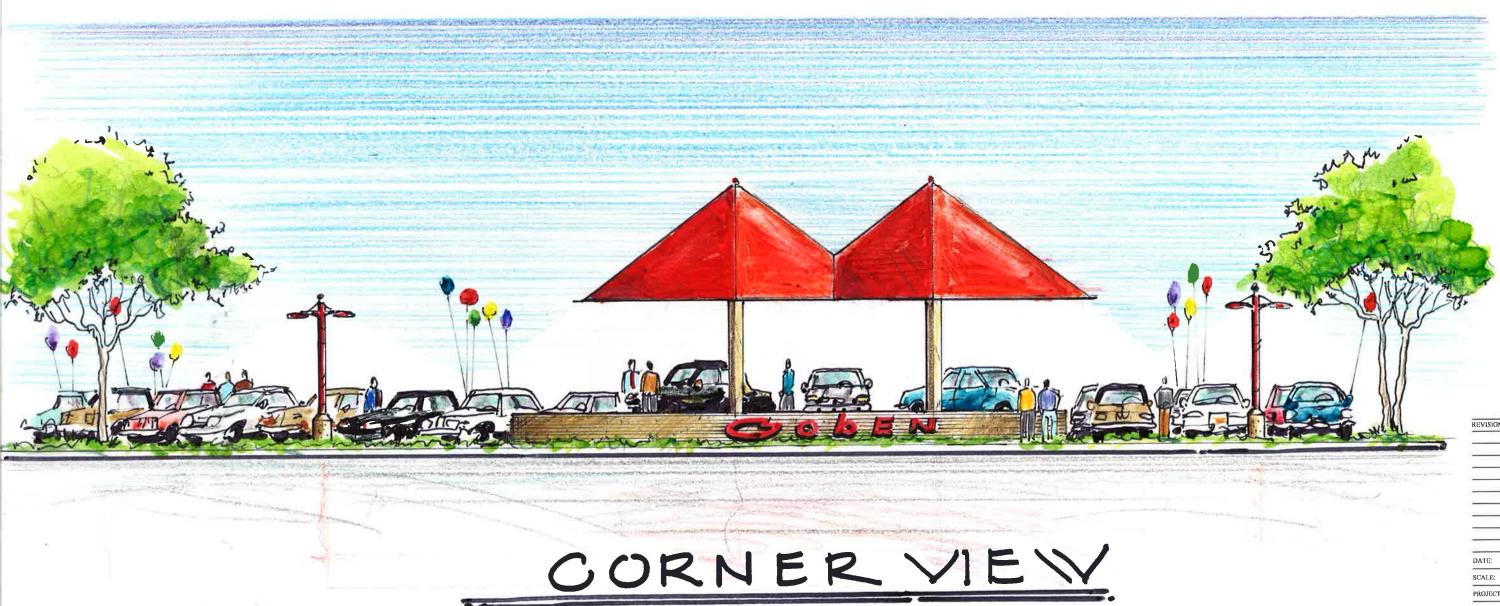

|" = |0'

REVISION	ONS:			
	_			
_	_	_		_


1/8"=1'-0"


DRAWN BY: DB DRAWING NAME;


SITE VIEW from corner of High Crossing Blvd East Springs Drive

DRAWING NUMBER:


6 COPYRIGHT BY : ARCHITECTURE NETWORK INC.

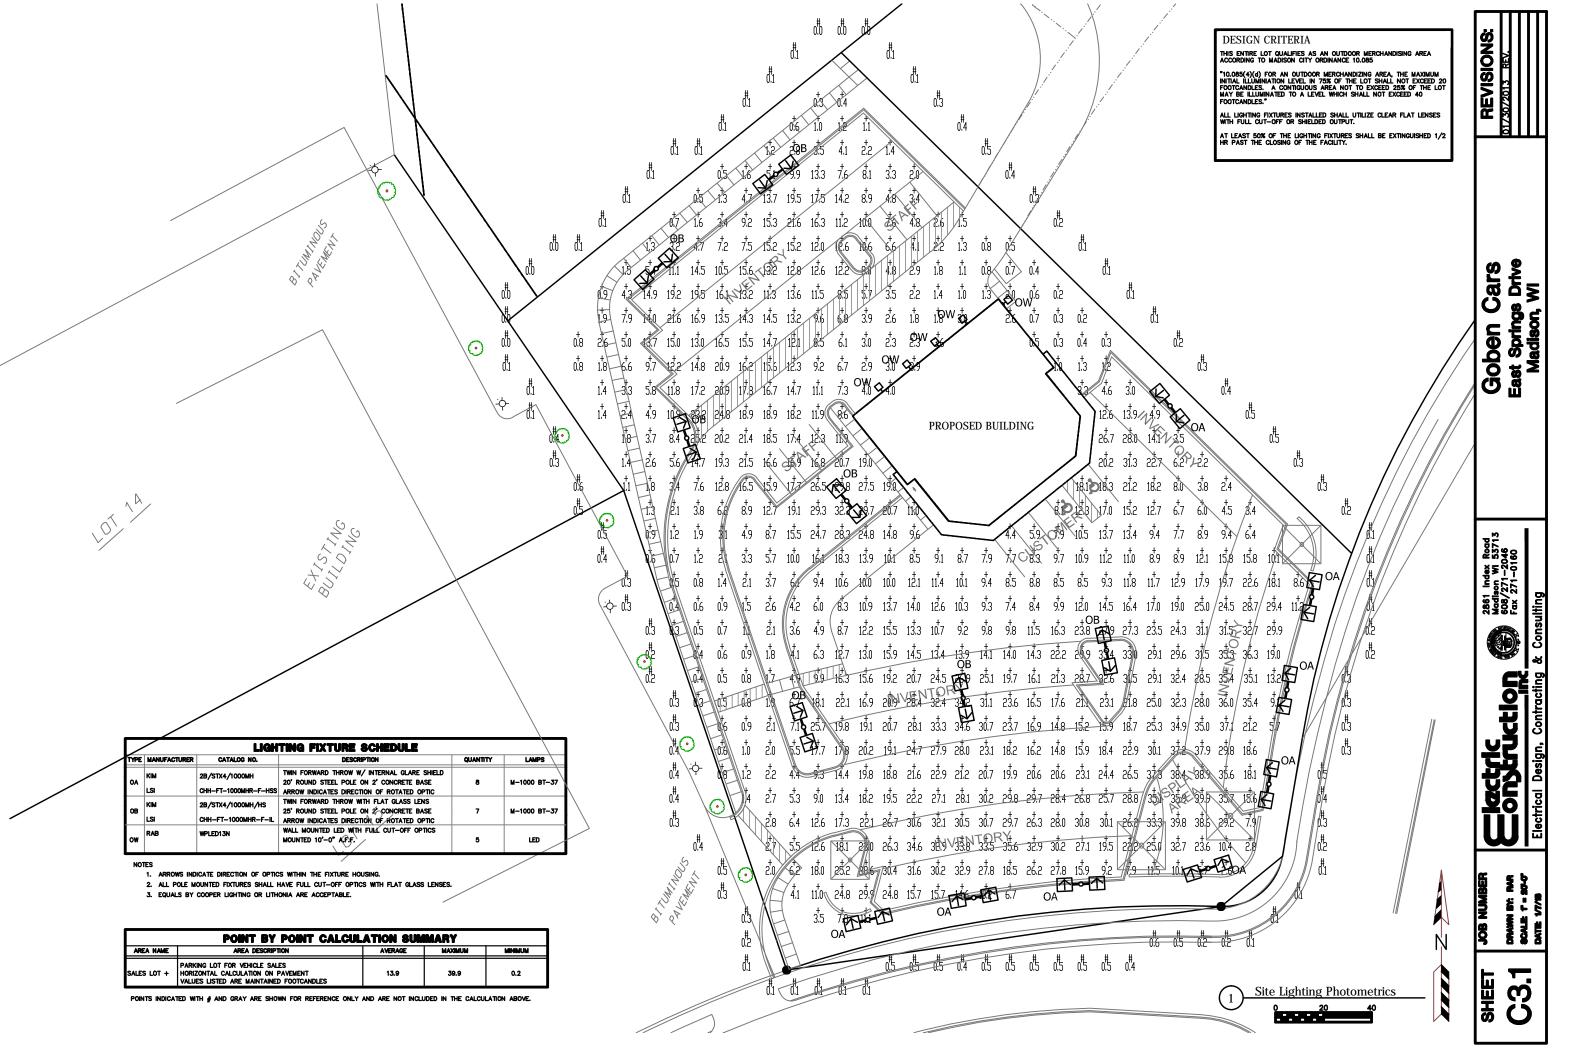


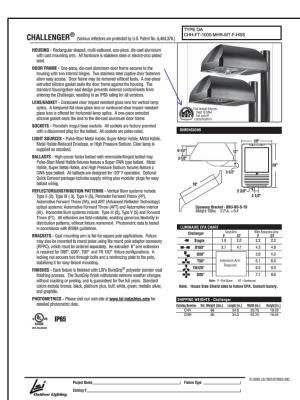


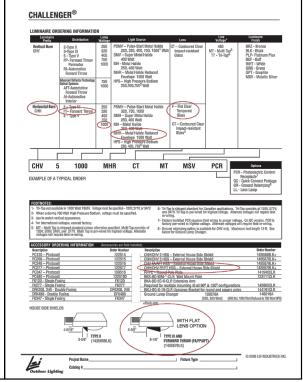



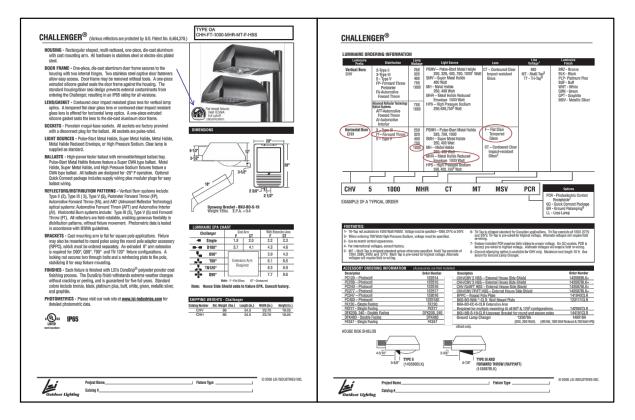

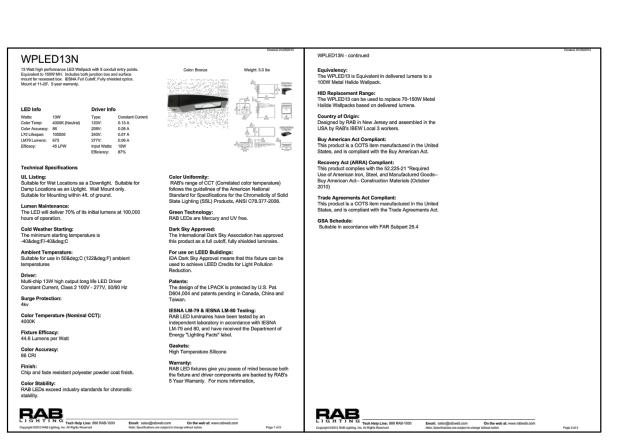

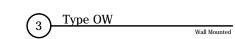

Type OB

Mounted on 25 Feet Round Pole

(2)



REVISIONS:

Goben Cars
East Springs Drive
Madison, Wi

dex Road WI 53713 1-2046 1-0160

