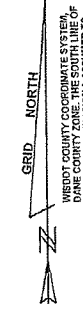
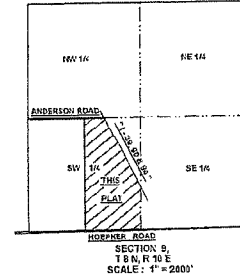


INTERSTATE COMMERCE PARK

BEING A DIVISION OF LOT 2, CERTIFIED SURVEY MAP NO. 6410 AND LOTS 1, 2, 3 AND OUTLOT 1, CERTIFIED SURVEY MAP NO. 11284 ALL LOCATED IN THE NE 1/4 OF THE SW 1/4 AND IN THE SE 1/4 OF THE SW 1/4 OF SECTION 9, T8N, R10E, CITY OF MADISON, DANE COUNTY, WISCONSIN.

#4137450

LOCATION SKETCH



SCALE: 1" = 100'

LEGEND

- 3/4" SQ. ID. ROUND IRON STAKE FOUND
- 1-1/4" X 30" SOLID ROUND IRON STAKE SET, 4.50 LBS. / FT.
- OTHER LOT CORNERS MARKED BY 3/4" X 24" SOLID ROUND IRON STAKES, 1.50 LBS. / FT.
- RECORDED AS
- UTILITY EASEMENT

CURVE TABLE

CURVE NO.	LOT NO.	RADIUS	CENTRAL ANGLE	LONG CHORD DIST.	BEARING	ARC LENGTH	TANGENT BEARING
1-2	6	25.00	90°00'00"	35.36	S 44°28'34"W	39.27	
3-4	6	25.00	90°00'00"	35.36	S 45°31'26"E	39.27	
5-6	7	25.00	90°00'00"	35.36	S 44°28'34"W	39.27	
7-8	7	317.00	26°10'34"	145.57	S 13°36'43"E	146.82	
9-10	13	217.00	62°45'58"	225.01	S 68°04'58"E	237.72	
11-12	26	283.00	62°45'58"	294.76	N 68°04'58"W	310.02	
13-14	26	283.00	23°25'46"	115.00	N 38°25'23"W	115.81	
15-16	27	283.00	23°25'46"	115.00	N 61°52'08"W	115.81	
17-18	28	283.00	15°52'24"	76.15	N 81°31'44"W	76.40	N 50°08'46"W
19-20	28	383.00	28°10'34"	173.46	N 13°36'43"W	174.88	
21-22	20	383.00	15°21'06"	102.31	N 08°11'58"W	102.62	
23-24	21	383.00	10°49'28"	72.25	N 21°17'46"W	72.36	
25-26	16	25.00	90°00'00"	25.00	N 45°31'08"W	35.36	
27-28	32	59.00	38°05'04"	28.15	S 72°24'36"E	30.63	
29-30	32	60.00	83°17'51"	87.23	N 83°28'32"E	70.75	S 54°51'33"E

NOTES:

- LANDS CONTAINED WITHIN THIS PLAT ARE SUBJECT TO DANE COUNTY HEIGHT LIMITATION ZONING REQUIREMENTS.
- ALL LOTS WITHIN THIS PLAT ARE SUBJECT TO THE AVIGATION EASEMENTS RECORDED IN THE DANE COUNTY OFFICE OF THE REGISTER OF DEEDS AS DOCUMENT NO. 4111035 AND DOCUMENT NO. 4121457 (CORRECTED IN THE AFFIDAVIT OF CORRECTION RECORDED AS DOCUMENT NO. 4126118).
- LOT 5 AND LOT 6 OF THIS PLAT ARE SUBJECT TO THE DEED RESTRICTION CONTAINED IN DOCUMENT NO. 4113494.

NOTE: VISION CORNER

"NO STRUCTURE OR IMPROVEMENT OF ANY KIND IS PERMITTED WITHIN THE VISION CORNER. NO VEGETATION WITHIN THE VISION CORNER MAY EXCEED 30 INCHES IN HEIGHT."

NOTE:

"THE OWNER OF LOTS 16, 17 & 18, INTERSTATE COMMERCE PARK, MAY BE REQUIRED TO CONVEY, AT NO COST, PRIVATE INGRESS AND EGRESS RIGHTS TO MANUFACTURERS DRIVE TO THE BENEFIT OF THE OWNER OF THE APPROXIMATELY FIVE (5) ACRE UNPLATTED TRACT OF LAND IMMEDIATELY EAST OF AND ADJACENT TO INTERSTATE COMMERCE PARK. INGRESS AND EGRESS LOCATION WILL BE CONVEYED AND APPROVED AT THE TIME DEVELOPMENT PLANS ARE APPROVED FOR LOTS 16, 17 AND 18, INTERSTATE COMMERCE PARK, BY THE CITY OF MADISON."


There are no objections to this plat with respect to s. 236.15, 236.16, 236.20 and 236.21 (1) and (2), Wis. Stats. as provided by s. 236.12, Wis. Stats.

Certified *Rennell Power*, 20 05
Department of Administration

REVISED: AUGUST 25, 2005
REVISED: NOVEMBER 14, 2005

THIS INSTRUMENT DRAFTED BY:
BADGER SURVEYING & MAPPING SERVICE, LLC
2702 INTERNATIONAL LANE, SUITE 114
MADISON, WI 53704
(608) 244-2010

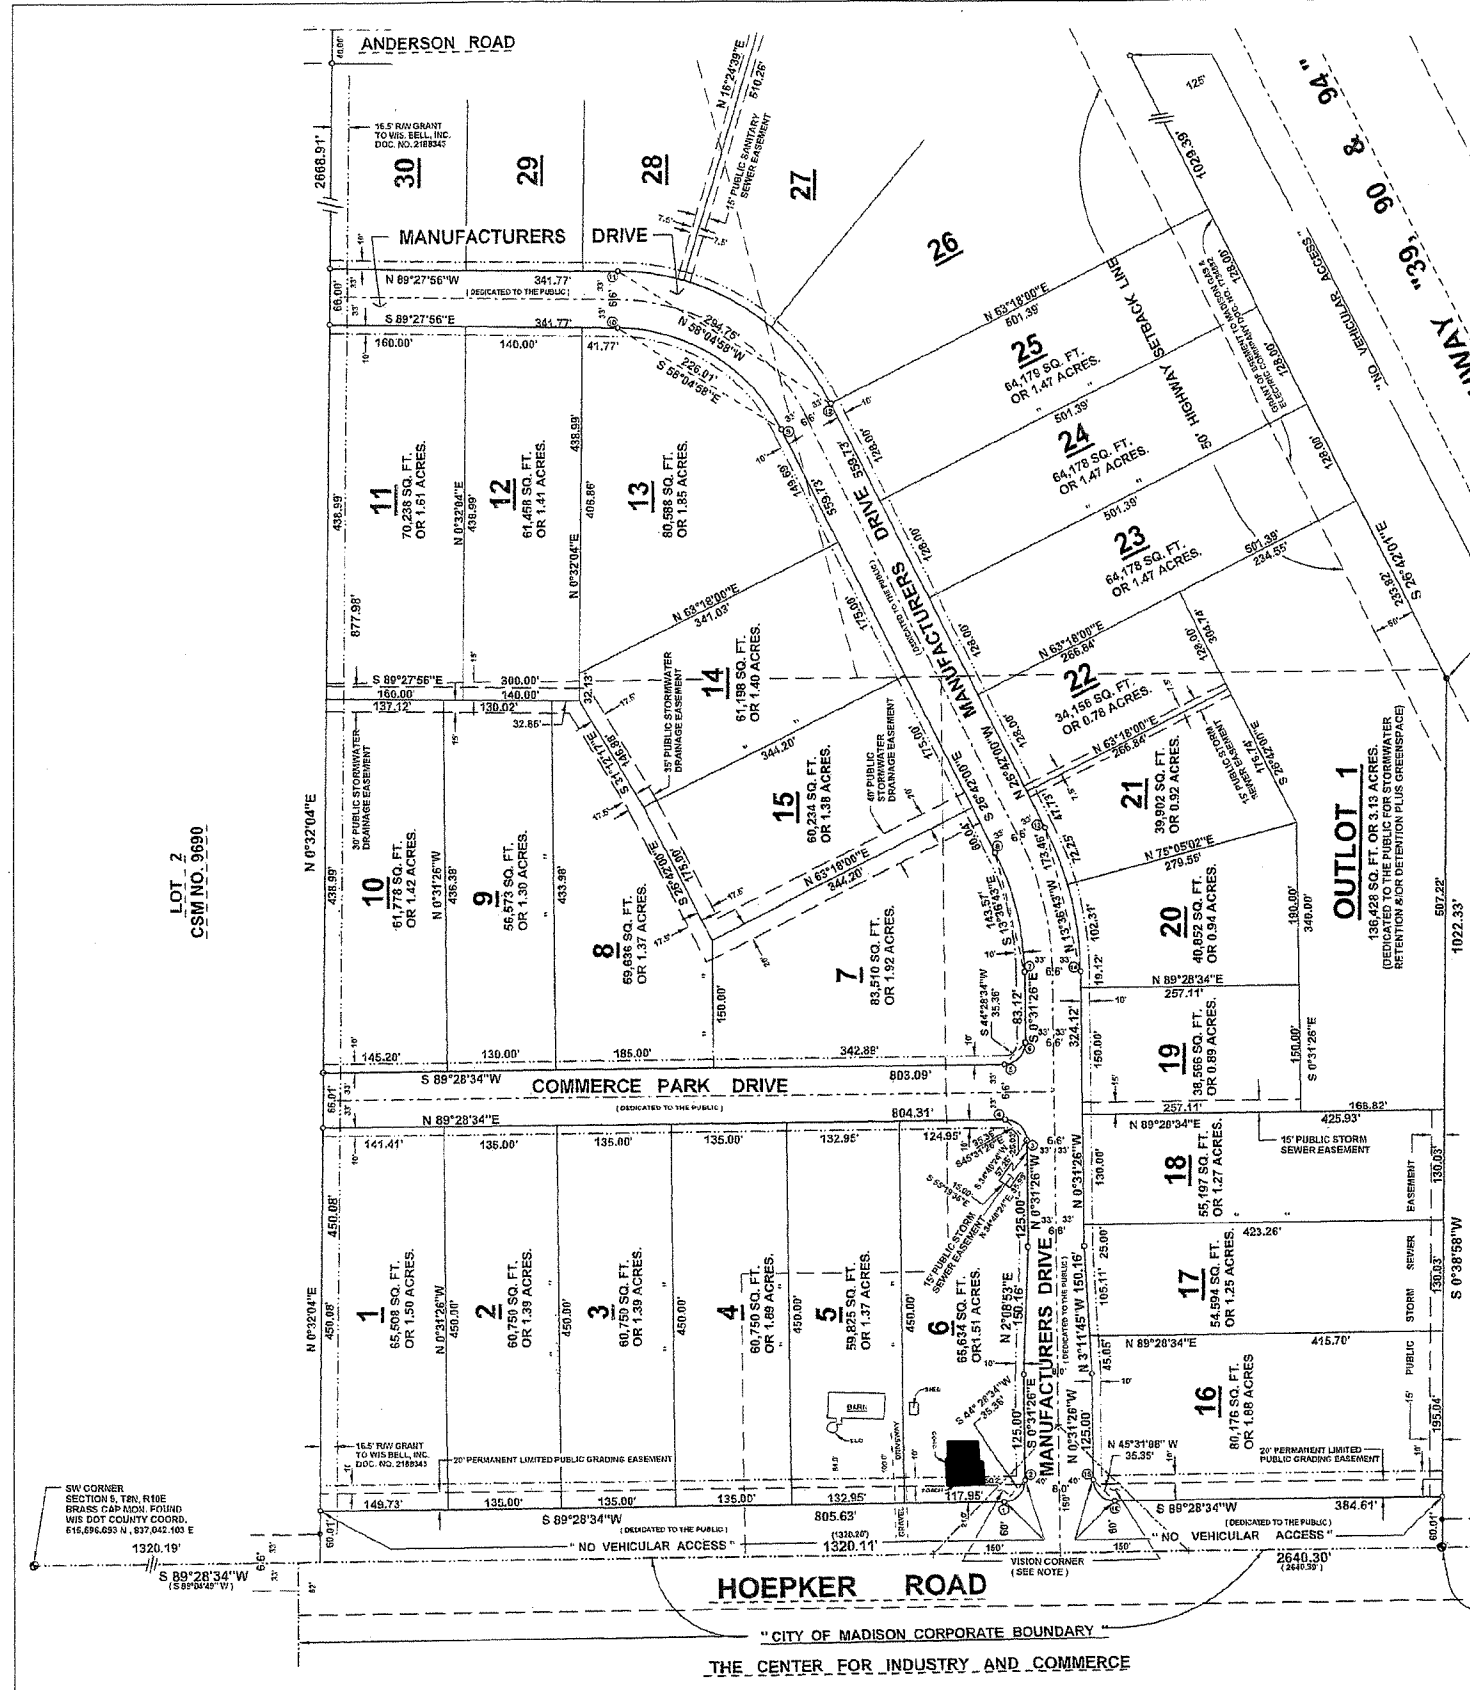JN 26-102F
SHEET 1 OF 3 PAGES



HOUSE TO BE DEMOLISHED

ATTACHMENT B

LEGEND (PROPOSED)

- SUBJECT PARCEL PROPERTY LINE (GRAPHIC)
- PROPERTY LINES (GRAPHIC)
- RIGHT-OF-WAY (GRAPHIC)
- NEW BUILDING
- NEW CONCRETE PAD
- NEW ASPHALT PAVEMENT TYPE I
- NEW ASPHALT PAVEMENT TYPE II
- NEW ASPHALT PAVEMENT TYPE I W/ SEALCOAT
- 18" CURBS AND GUTTER
- NEW FENCE
- EXISTING FENCE TO REMAIN
- PROPOSED MAJOR CONTOUR
- PROPOSED MINOR CONTOUR
- DRAINAGE SLOPE AND DIRECTION
- DRAINAGE GRADE BREAK
- STORM SEWER
- CLASS III EROSION MATTING
- SILT FENCE
- DITCH CHECK
- INLET PROTECTION
- SPOT ELEVATION

CONSTRUCTION SITE EROSION CONTROL REQUIREMENTS

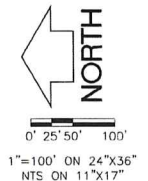
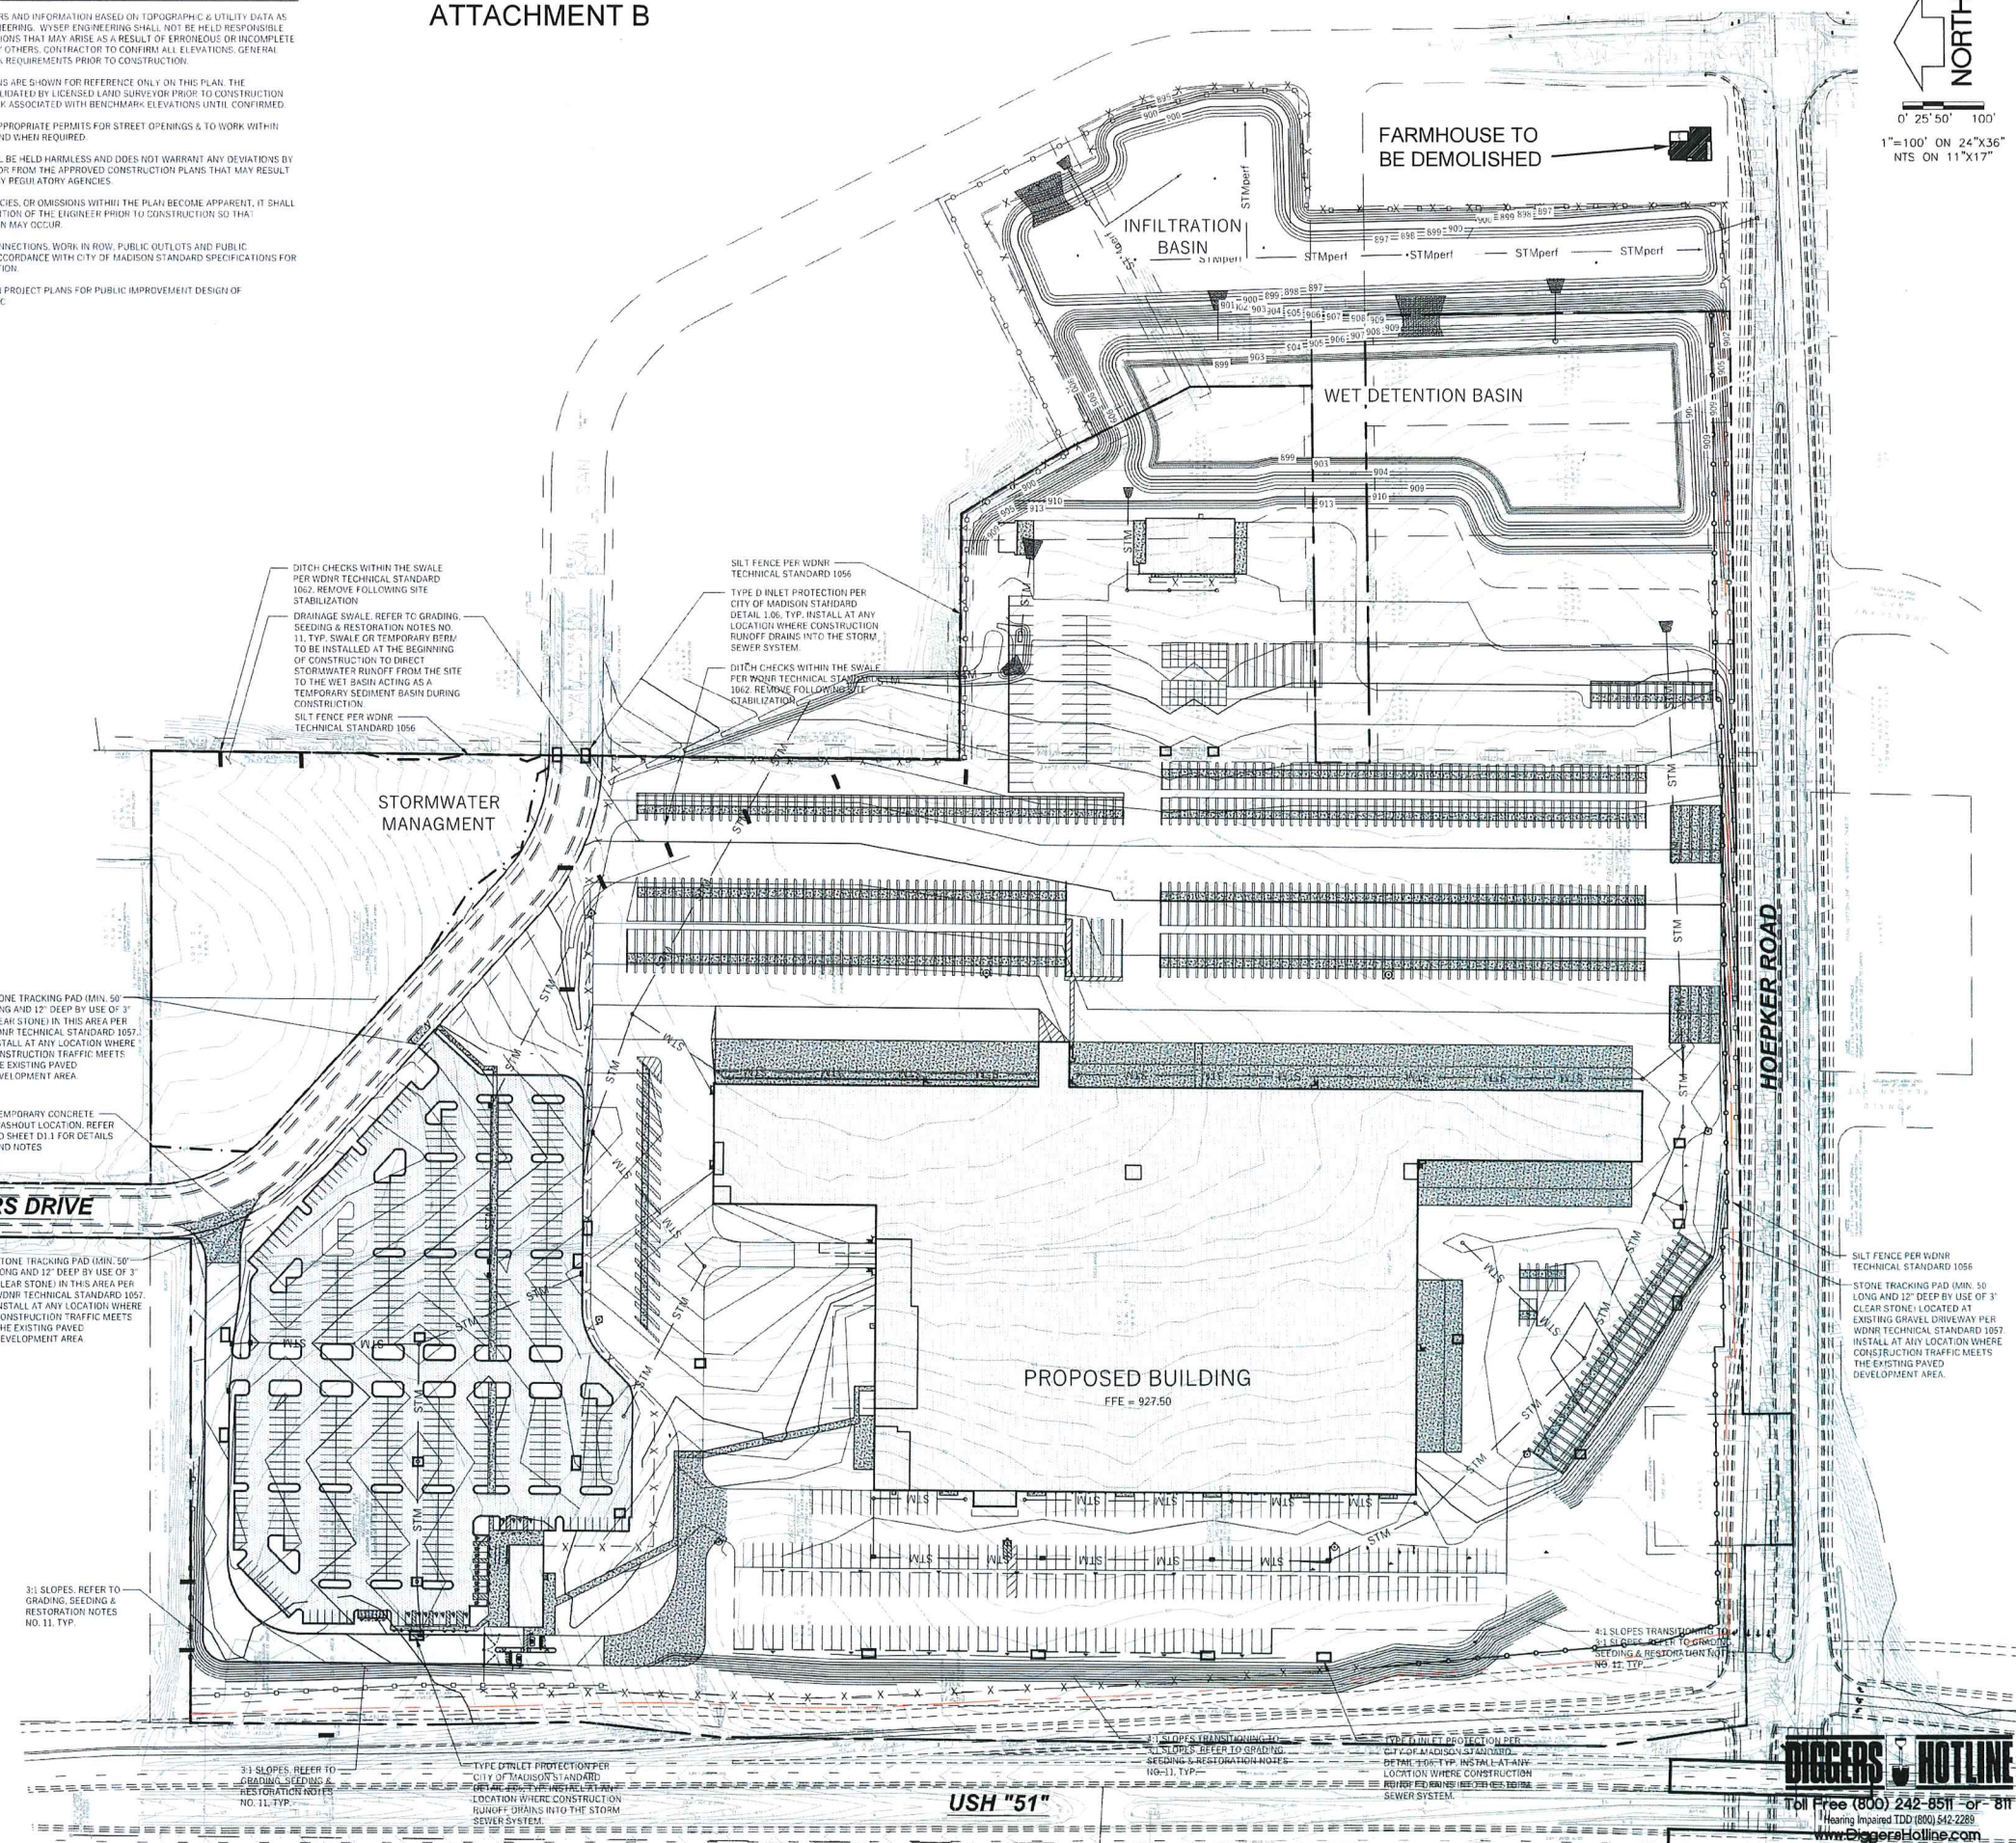
1. ALL EROSION AND SEDIMENT CONTROL PRACTICES SHALL BE IMPLEMENTED IN ACCORDANCE WITH THE CURRENT WISCONSIN DEPARTMENT OF NATURAL RESOURCES (WDNR) EROSION AND SEDIMENT CONTROL TECHNICAL STANDARDS (em.wis.gov).
2. EROSION AND SEDIMENT CONTROL MEASURES SHALL BE INSTALLED PRIOR TO SITE DISTURBANCE.
3. ENGINEER / CITY OF MADISON / DANE COUNTY LAND CONSERVATION / WDNR HAS THE RIGHT TO REQUIRE CONTRACTOR TO IMPLEMENT ADDITIONAL EROSION CONTROL MEASURES AS NECESSARY. CONTRACTOR MUST NOTIFY THE CITY OF MADISON BUILDING INSPECTOR TO HAVE A PRECONSTRUCTION MEETING A MINIMUM OF TWO (2) WORKING DAYS IN ADVANCE OF ANY SOIL DISTURBANCE ACTIVITIES.
4. EROSION AND SEDIMENT CONTROL PRACTICES SHALL BE INSPECTED ONCE PER WEEK AND FOLLOWING EACH MAJOR RAIN EVENT. INSPECTION REPORTING SHALL BE IN ACCORDANCE WITH MUNICIPAL REQUIREMENTS SHALL BE THE RESPONSIBILITY OF THE CONTRACTOR.
5. IT IS THE CONTRACTOR'S RESPONSIBILITY TO MAINTAIN EROSION AND SEDIMENT CONTROL PRACTICES IN WORKING ORDER. EROSION CONTROL MEASURES SHALL BE REMOVED ONLY AFTER SITE CONSTRUCTION IS COMPLETE WITH ALL SOIL SURFACES HAVING AN ESTABLISHED VEGETATIVE COVER.
6. DEWATERING PRACTICES SHALL COMPLY WITH TECHNICAL STANDARD 1061.
7. DUST CONTROL SHALL BE MITIGATED IN ACCORDANCE WITH WDNR TECHNICAL STANDARD 1068.
8. ALL DISTURBED AREAS SHALL BE SEEDED AND MULCHED IMMEDIATELY FOLLOWING FINAL GRADING ACTIVITIES.
9. SEED MIX AND RATE SHALL BE, AT A MINIMUM, IN ACCORDANCE WITH WDNR TECHNICAL STANDARD 1059.
10. PRIOR TO CONSTRUCTION, CONTRACTOR SHALL PROVIDE VEGETATION PLAN FOR ENGINEER / OWNER APPROVAL. VEGETATION PLAN AND BIORETENTION INSTALLATION SHALL BE IN ACCORDANCE WITH WDNR TECHNICAL STANDARD 1064.
11. CONTRACTOR TO PROVIDE SOLID LID OR METAL PLATE ON ALL OPER. MANHOLES DURING CONSTRUCTION TO MINIMIZE SEDIMENT FROM ENTERING THE STORM SEWER SYSTEM.
12. THE CONTRACTOR IS RESPONSIBLE FOR OBTAINING A COPY OF THE MUNICIPAL EROSION CONTROL PERMIT AND VERIFYING AND FOLLOWING ALL APPLICABLE REQUIREMENTS.

GENERAL NOTES

1. UNDERLYING SITE CONTOURS AND INFORMATION BASED ON TOPOGRAPHIC & UTILITY DATA AS PROVIDED TO WYSER ENGINEERING. WYSER ENGINEERING SHALL NOT BE HELD RESPONSIBLE FOR ANY ERRORS OR OMISSIONS THAT MAY ARISE AS A RESULT OF ERRONEOUS OR INCOMPLETE INFORMATION PROVIDED BY OTHERS. CONTRACTOR TO VERIFY ALL ELEVATIONS, GENERAL DRAINAGE AND EARTHWORK REQUIREMENTS PRIOR TO CONSTRUCTION.
2. THE BENCHMARK LOCATIONS ARE SHOWN FOR REFERENCE ONLY ON THIS PLAN. THE BENCHMARKS SHALL BE VALIDATED BY LICENSED LAND SURVEYOR PRIOR TO CONSTRUCTION. CONTRACTOR ASSUMES RISK ASSOCIATED WITH BENCHMARK ELEVATIONS UNTIL CONFIRMED.
3. CONTRACTOR TO OBTAIN APPROPRIATE PERMITS FOR STREET OPENINGS & TO WORK WITHIN THE TOWNS AND CITY'S LAND WHEN REQUIRED.
4. WYSER ENGINEERING SHALL BE HELD HARMLESS AND DOES NOT WARRANT ANY DEVIATIONS BY THE OWNER OR CONTRACTOR FROM THE APPROVED CONSTRUCTION PLANS THAT MAY RESULT IN DISCIPLINARY ACTIONS BY REGULATORY AGENCIES.
5. IF ANY ERRORS, DISCREPANCIES, OR OMISSIONS WITHIN THE PLAN BECOME APPARENT, IT SHALL BE BROUGHT TO THE ATTENTION OF THE ENGINEER PRIOR TO CONSTRUCTION SO THAT CLARIFICATION OR REVISION MAY OCCUR.
6. ALL MUNICIPAL UTILITY CONNECTIONS, WORK, IN ROW, PUBLIC OUTLETS AND PUBLIC EASEMENTS SHALL BE IN ACCORDANCE WITH CITY OF MADISON STANDARD SPECIFICATIONS FOR PUBLIC WORKS CONSTRUCTION.
7. REFER TO CITY OF MADISON PROJECT PLANS FOR PUBLIC IMPROVEMENT DESIGN OF MANUFACTURERS DRIVE, NHC.

GRADING, SEEDING & RESTORATION NOTES

1. ALL GRADES SHOWN ARE FINAL FINISHED SURFACE GRADES.
2. AREAS TO BE SEEDED SHALL HAVE A MINIMUM 6 INCHES TOPSOIL UNLESS OTHERWISE NOTED.
3. RESTORATION SHALL OCCUR AS SOON AS PRACTICABLE AFTER THE DISTURBANCE, WITHIN 7 DAYS OF TOPSOILING.
4. AREAS NOT RESTORED WITH EROSION MATTING OR OTHER STABILIZATION MEASURES SHALL BE STABILIZED WITH MULCH.
5. APPLY ANIONIC POLYMER TO DISTURBED AREAS IF EROSION BECOMES PROBLEMATIC.
6. INSTALL EROSION CONTROLS ON THE DOWNSTREAM SIDE OF STOCKPILES AND PROVIDE TEMPORARY SEEDING ON STOCKPILES WHICH ARE TO REMAIN IN PLACE FOR MORE THAN 7 DAYS.
7. CONTRACTOR SHALL CHISEL-PLOW OR DEEP TILL WITH DOUBLE TIMES THE STORMWATER MANAGEMENT FACILITY JUST PRIOR TO SEEDING AND MULCHING TO PROVIDE INFILTRATION.
8. MULCH SHALL BE WEED-FREE STRAW AND SHALL BE INSTALLED AT THE RATE OF 2 TONS PER ACRE PER SECTION 627 OF STANDARD SPECIFICATIONS FOR HIGHWAY AND STRUCTURE CONSTRUCTION (WISDOT 2014).
9. PERMANENT SEEDING SHALL NOT OCCUR BETWEEN SEPTEMBER 15TH AND APRIL 15TH. ALTERNATE SEEDING/PLANTING METHODS AND/OR EROSION PROTECTION MAY BE NECESSARY FOR SEEDING/PLANTING THAT OCCURS DURING THAT TIME. COORDINATE WITH THE OWNER AS NECESSARY.
10. TEMPORARY STABILIZATION SHALL CONSIST OF ONE OR MORE OF THE FOLLOWING OPTIONS:
 - a. TEMPORARY SEEDING CONSISTING OF ANNUAL RYE GRASS APPLIED AT A RATE OF 1.5 LBS PER 100 SQUARE FEET.
 - b. WISDOT PAL CLASS I TYPE B URBAN EROSION CONTROL MAT.
11. ALL SLOPES EXCEEDING 6:1 SHALL USE PRESCRIPTIVE COMPLIANCE INCLUDING SOIL INTERUPTION PER WDNR TECH. STD. 1071, SOIL STABILIZATION (PERMANENT SEEDING AND CLASS I TYPE B EROSION MATTING ON SLOPES OR CLASS II TYPE B MATTING IN DRAINAGE SWALES) AND LIMITING THE MAX PERIOD OF BARE SOIL TO 60 DAYS FOR LAND DISTURBANCE BETWEEN SEPTEMBER 16 AND MAY 1 AND 30 DAYS FOR LAND DISTURBANCE BETWEEN MAY 2 AND SEPTEMBER 15.



RUEDEBUSCH DEVELOPMENT & CONSTRUCTION
 DEVELOPMENT • CONSTRUCTION • EROSION • CONSULTING
 4605 DOVETAIL DRIVE • MADISON, WI 53704
 PHONE: 608.249.2012 FAX: 608.249.2032

WYSER ENGINEERING
 608.843.3388
 www.wyserengineering.com

INDUSTRIAL DEVELOPMENT -
 TOWN OF BURKE
 HOECKER ROAD
 MADISON, WISCONSIN


DATE:	
NO.	REVISION:

SHEET TITLE:
GRADING AND EROSION CONTROL PLAN

JOB NUMBER:	Project Number
DESIGNED BY:	DOS
DRAWN BY:	DOS
CHECKED BY:	WYW
DATE:	05.14.19
SHEET NO:	C3.0

DIGGERS & HOTLINE
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ATTACHMENT C
SCALE 1"=80'

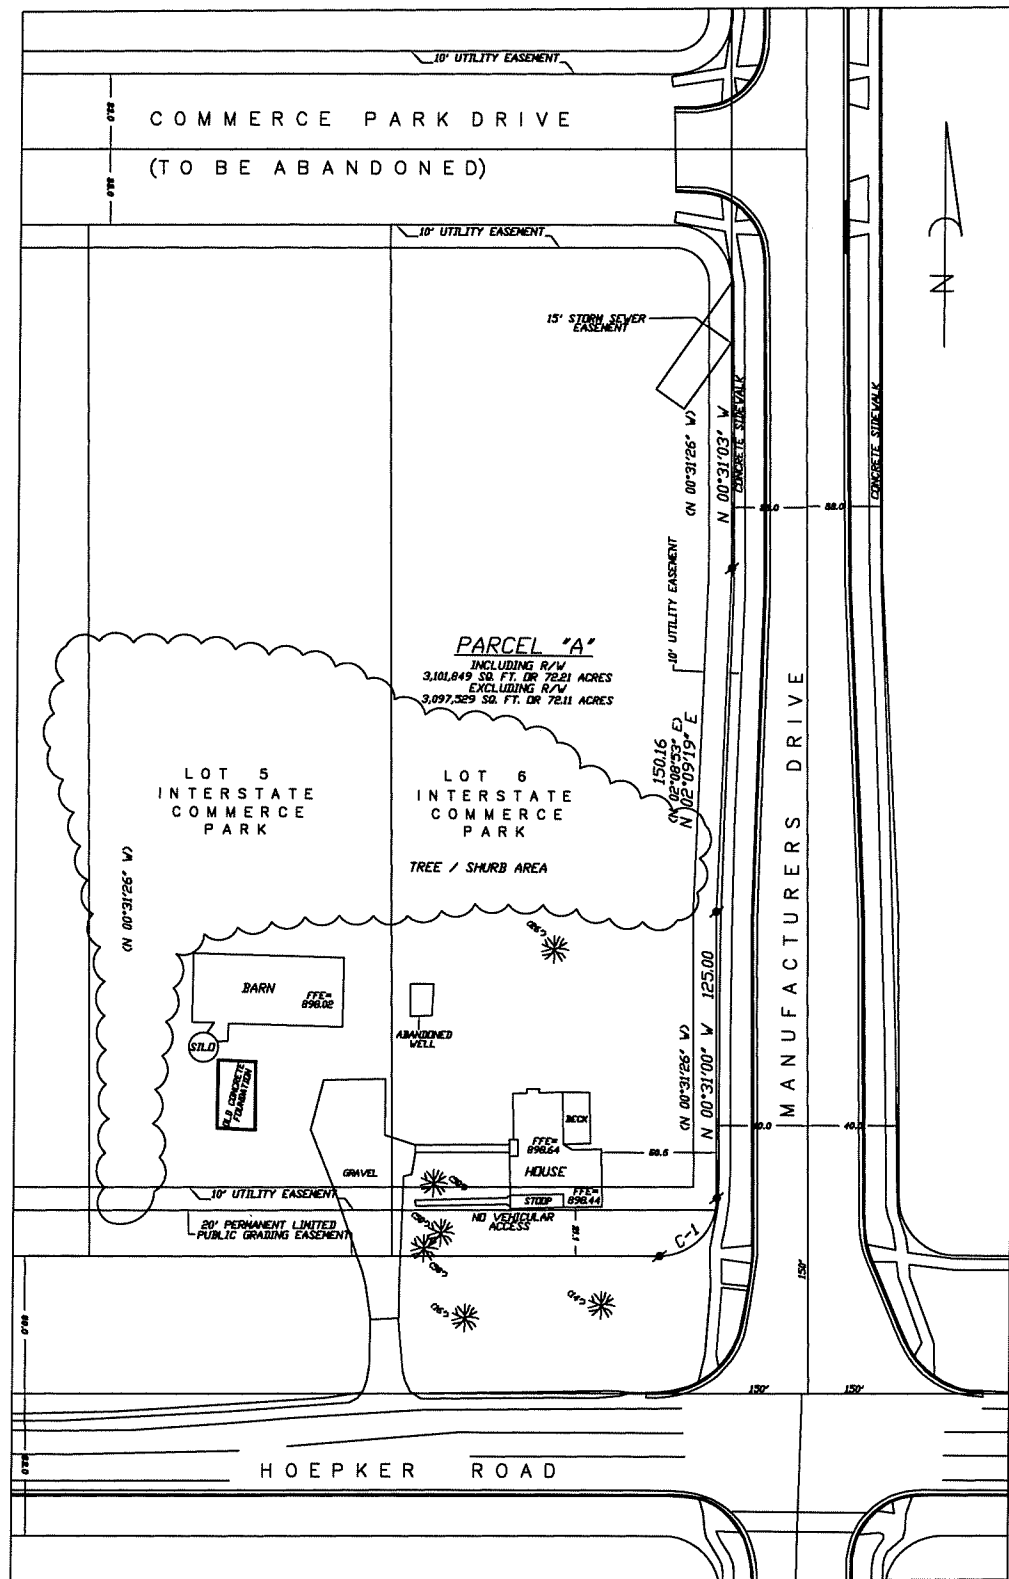