

Madison, Wisconsin

CITY OF MADISON

CITY ENGINEERING DIVISION
DEPARTMENT OF PUBLIC WORKS
PLAN OF PROPOSED IMPROVEMENT

MARQUETTE STREET RECONSTRUCTION ASSESSMENT DISTRICT - 2009

MILWAUKEE STREET TO SACHS STREET

CITY PROJECT NO. 53W0490
CONTRACT NO. 6282

CONVENTIONAL SIGNS

- GAS — G —
- ELECTRIC — E —
- OVERHEAD ELECTRIC — OH —
- TELEPHONE OR TELEGRAPH — T —
- STORM SEWER — ST —
- SANITARY SEWER — SAN —
- WATER — W —
- FIBER OPTICS TELEPHONE — FO —
- STREET LIGHT ELECTRIC — SL —
- POWER POLE — ☉ —
- LIGHT POLE — ☀ —
- PROPERTY IRON — ○ —
- RAILROAD — ————

NOTES:

CURB THRU HANDICAP RAMPS SHALL HAVE A MAXIMUM SLOPE OF 1" PER 12" FROM FLOWLINE TO BACK OF CURB.

SEE CROSS SECTION SHEETS FOR ADDITIONAL TOP OF CURB GRADES

FIELD VERIFY ALL UTILITY LOCATIONS

INDEX OF SHEETS

SHEET NO.	1	TITLE
SHEET NO.	EC-1	EROSION CONTROL PLAN
SHEET NO.	D-1 - D-2	TYPICAL SECTIONS AND DETAILS
SHEET NO.	P-1 - P-3	STREET PLAN & PROFILE
SHEET NO.	U-1 - U-2	UTILITY PLAN & PROFILE
SHEET NO.	U-3 - U-4	STORM SEWER SCHEDULE
SHEET NO.	U-5	SANITARY SEWER SCHEDULE
SHEET NO.	W-1 - W-2	WATER MAIN PLAN & PROFILE
SHEET NO.	W-3	WATER - ESTIMATE OF MATERIALS
SHEET NO.	E-1	ELECTRICAL PLAN
SHEET NO.	X-1 - X-7	CROSS SECTIONS

END PROJECT

BEGIN PROJECT



PROJECT LOCATION



City of Madison

PROJECT APPROVED
XXXX
BY THE COMMON COUNCIL
OF MADISON, WISCONSIN

STREET DESIGN
APPROVED BY:

City Engineer

Date


STREET GRADES
DESIGNED BY:

ELECTRICAL
DESIGNED BY:

STORM SEWER
DESIGNED BY:

WATER MAIN
DESIGNED BY:

SANITARY SEWER
DESIGNED BY:



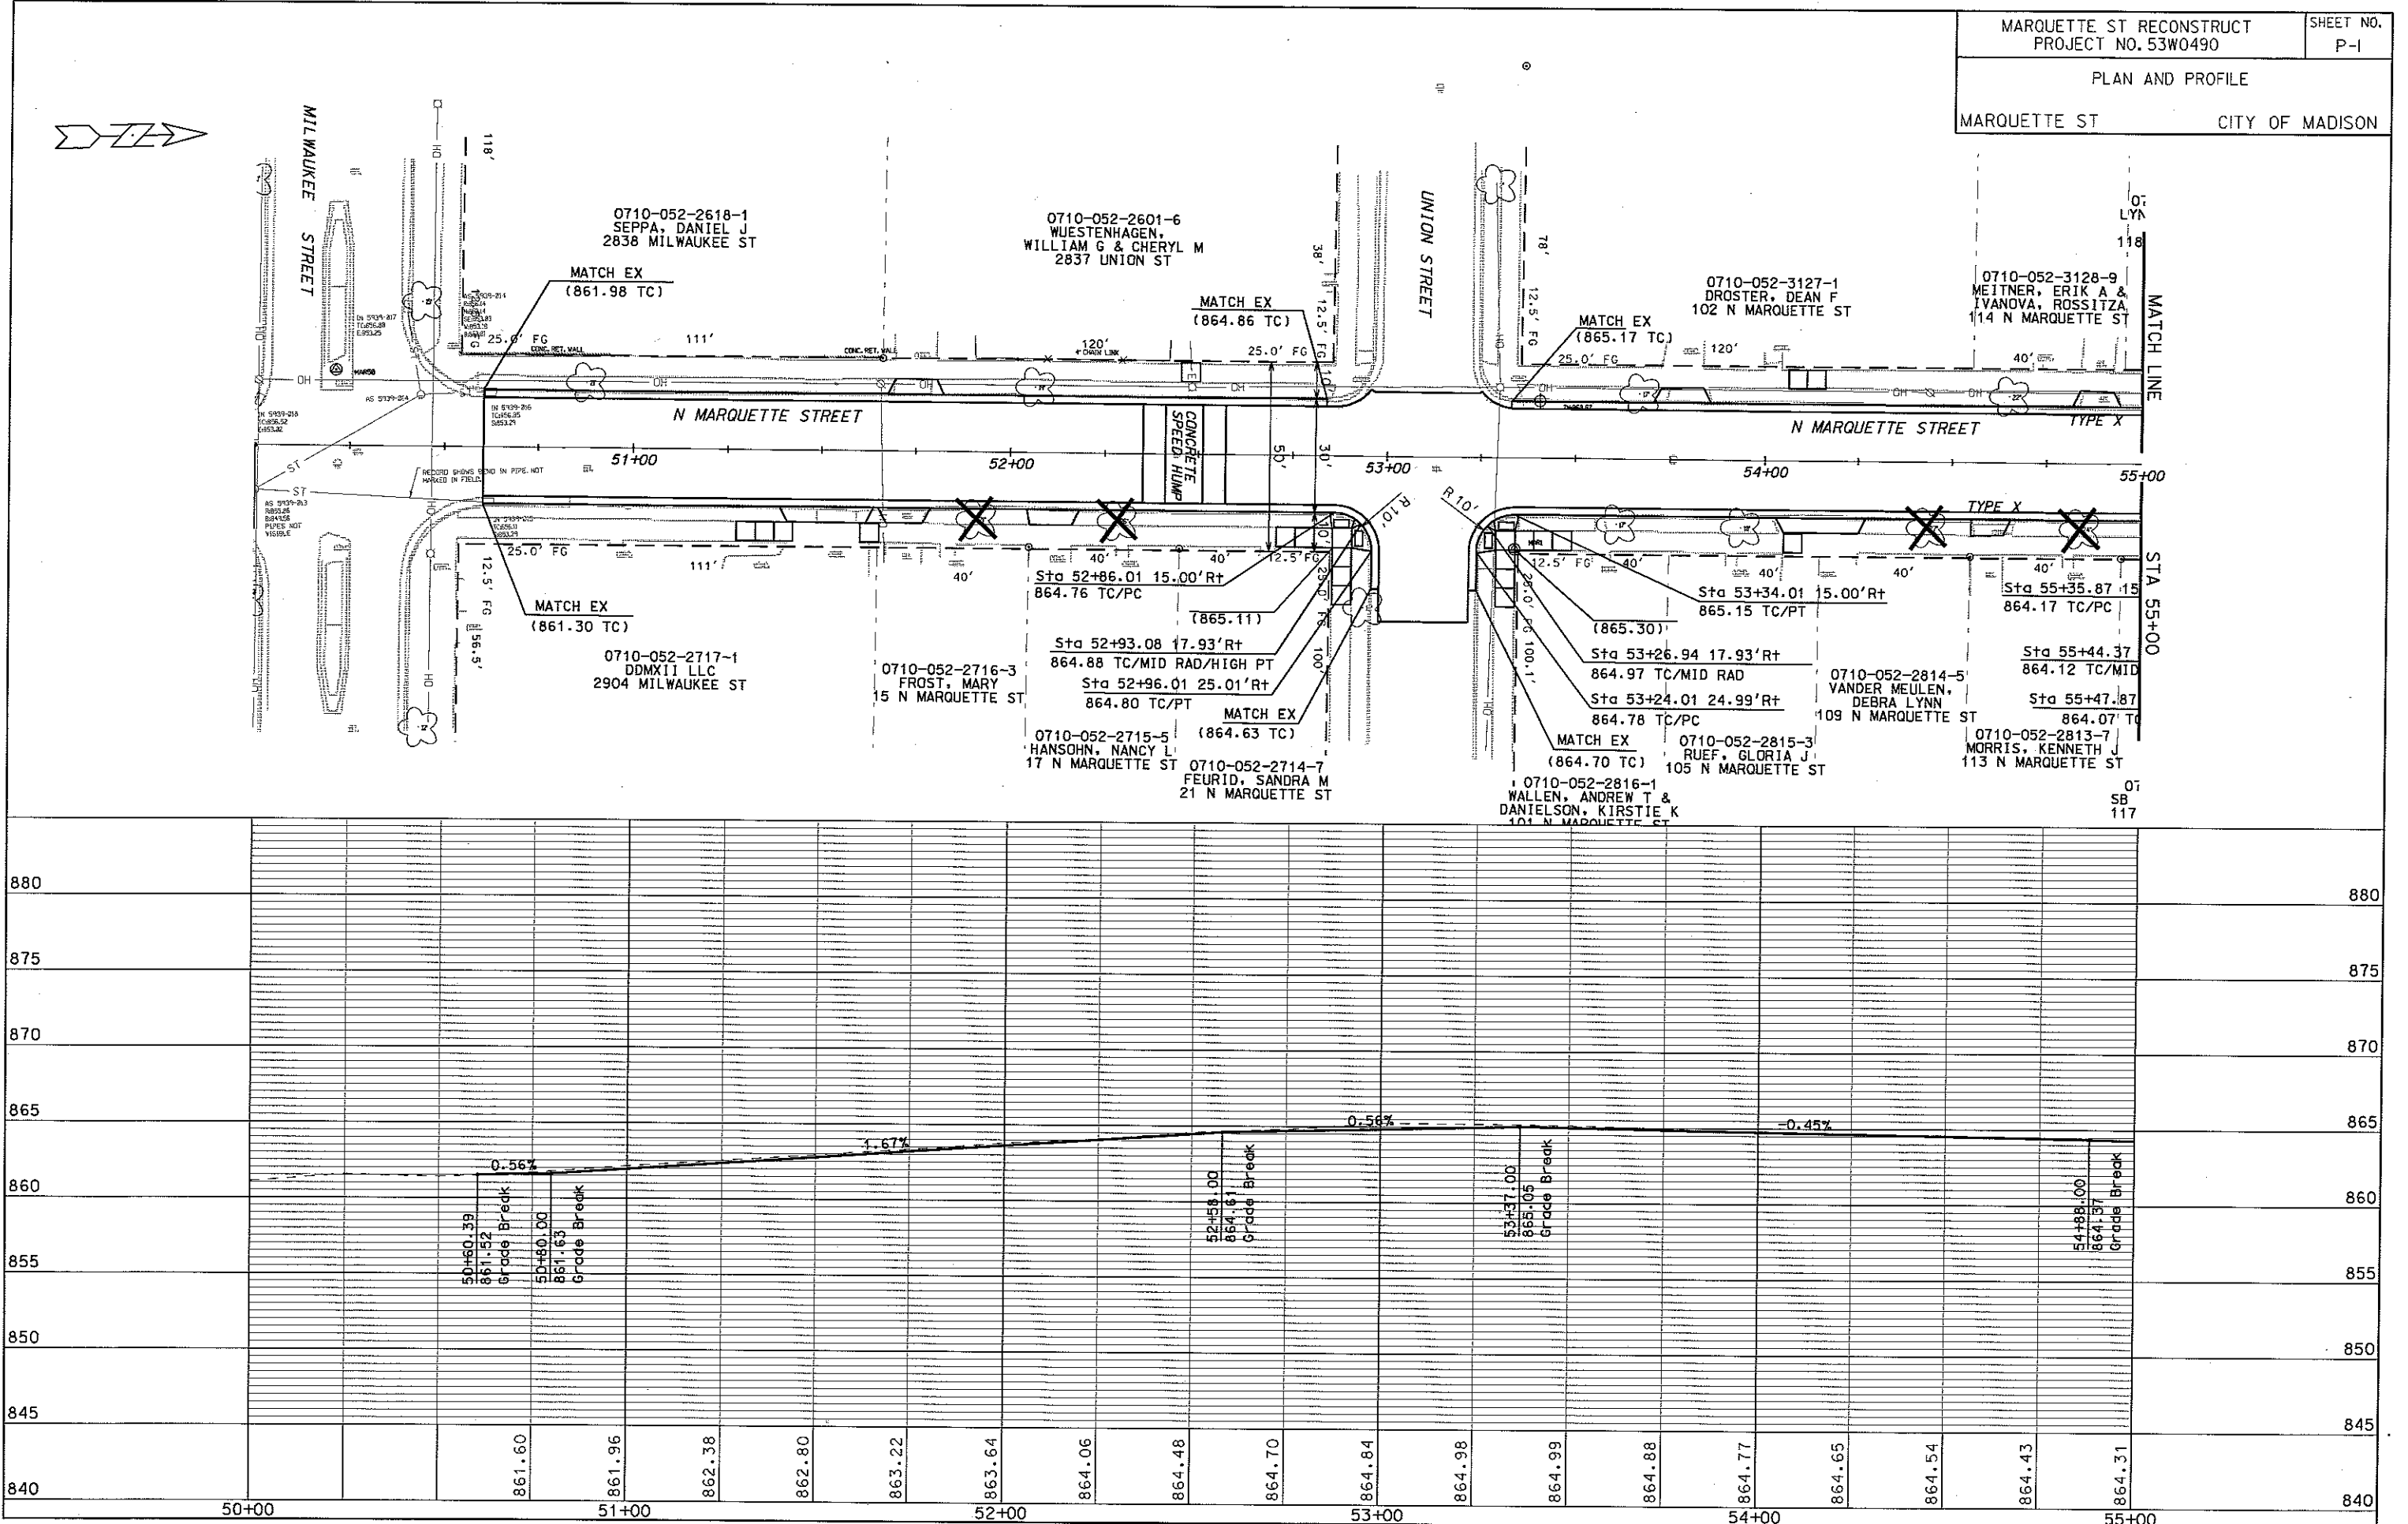


PLOT SCALE: 1" = 40'

PLOT NAME: 53W0490.P1

REV. DATE: 4/20/2009

ORIGINATOR: CITY OF MADISON, STREETS DIVISION

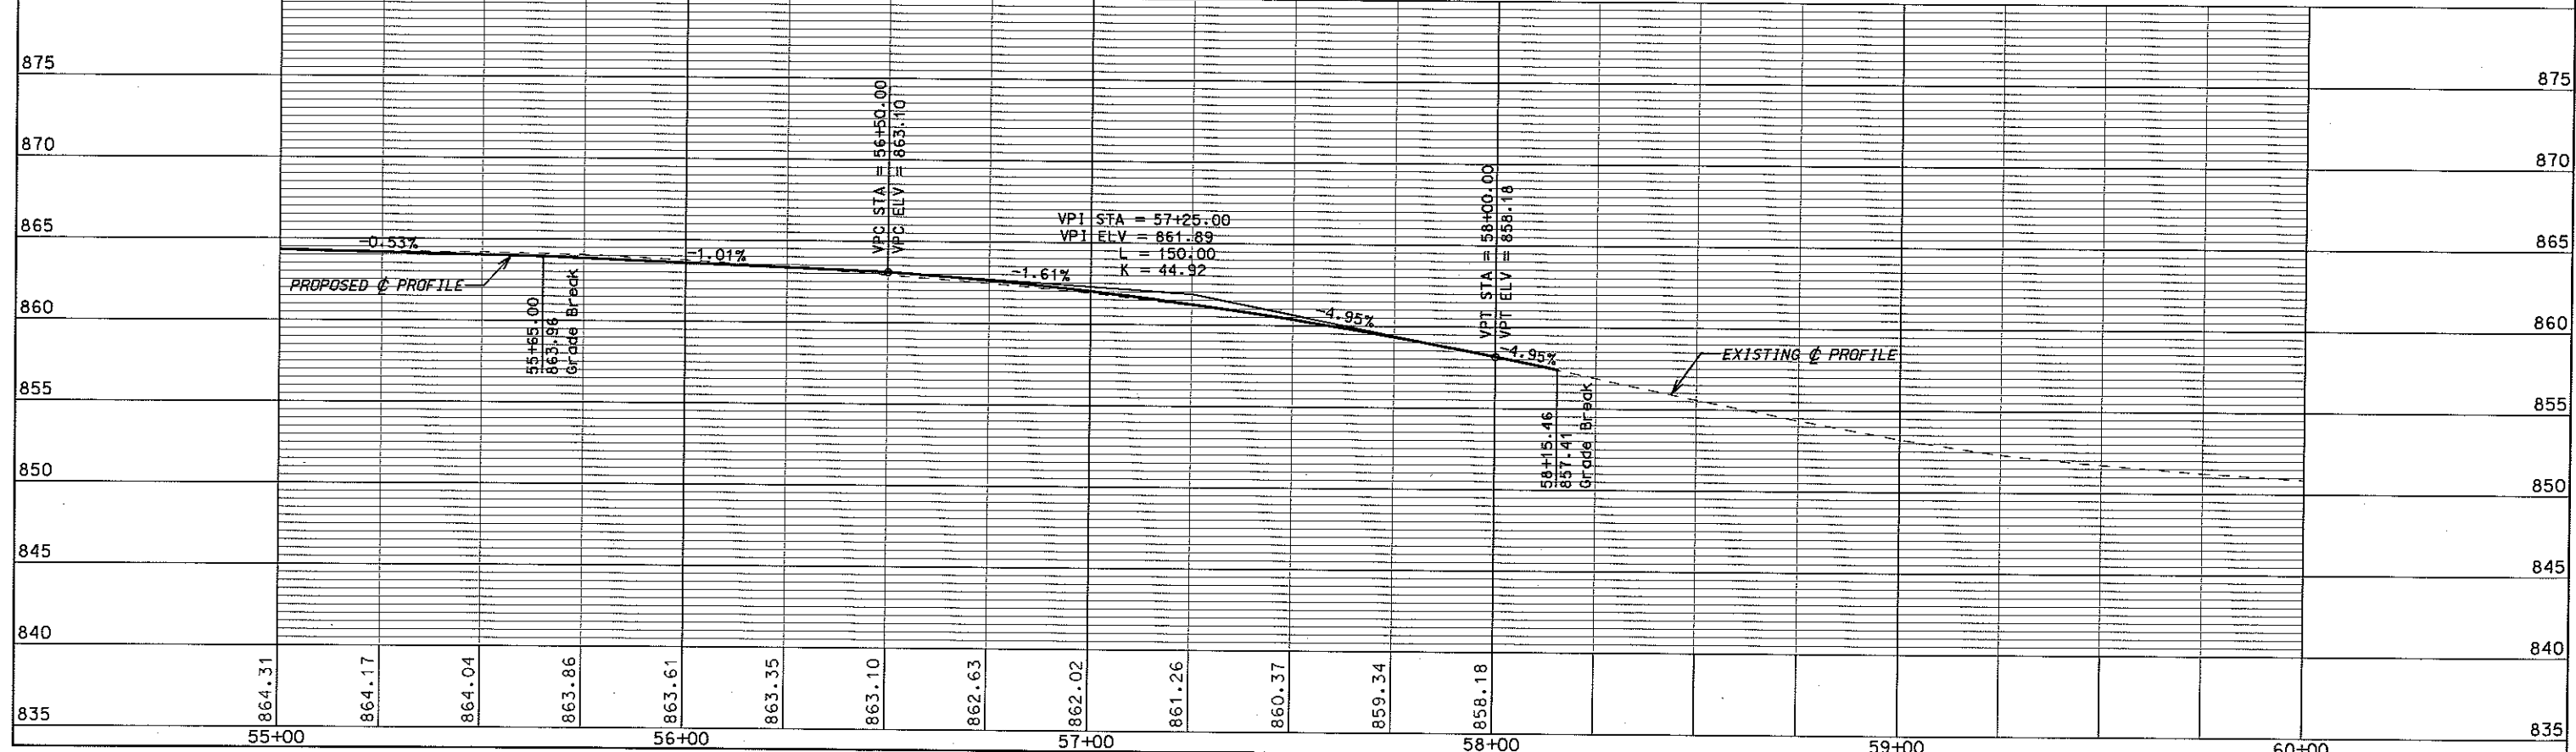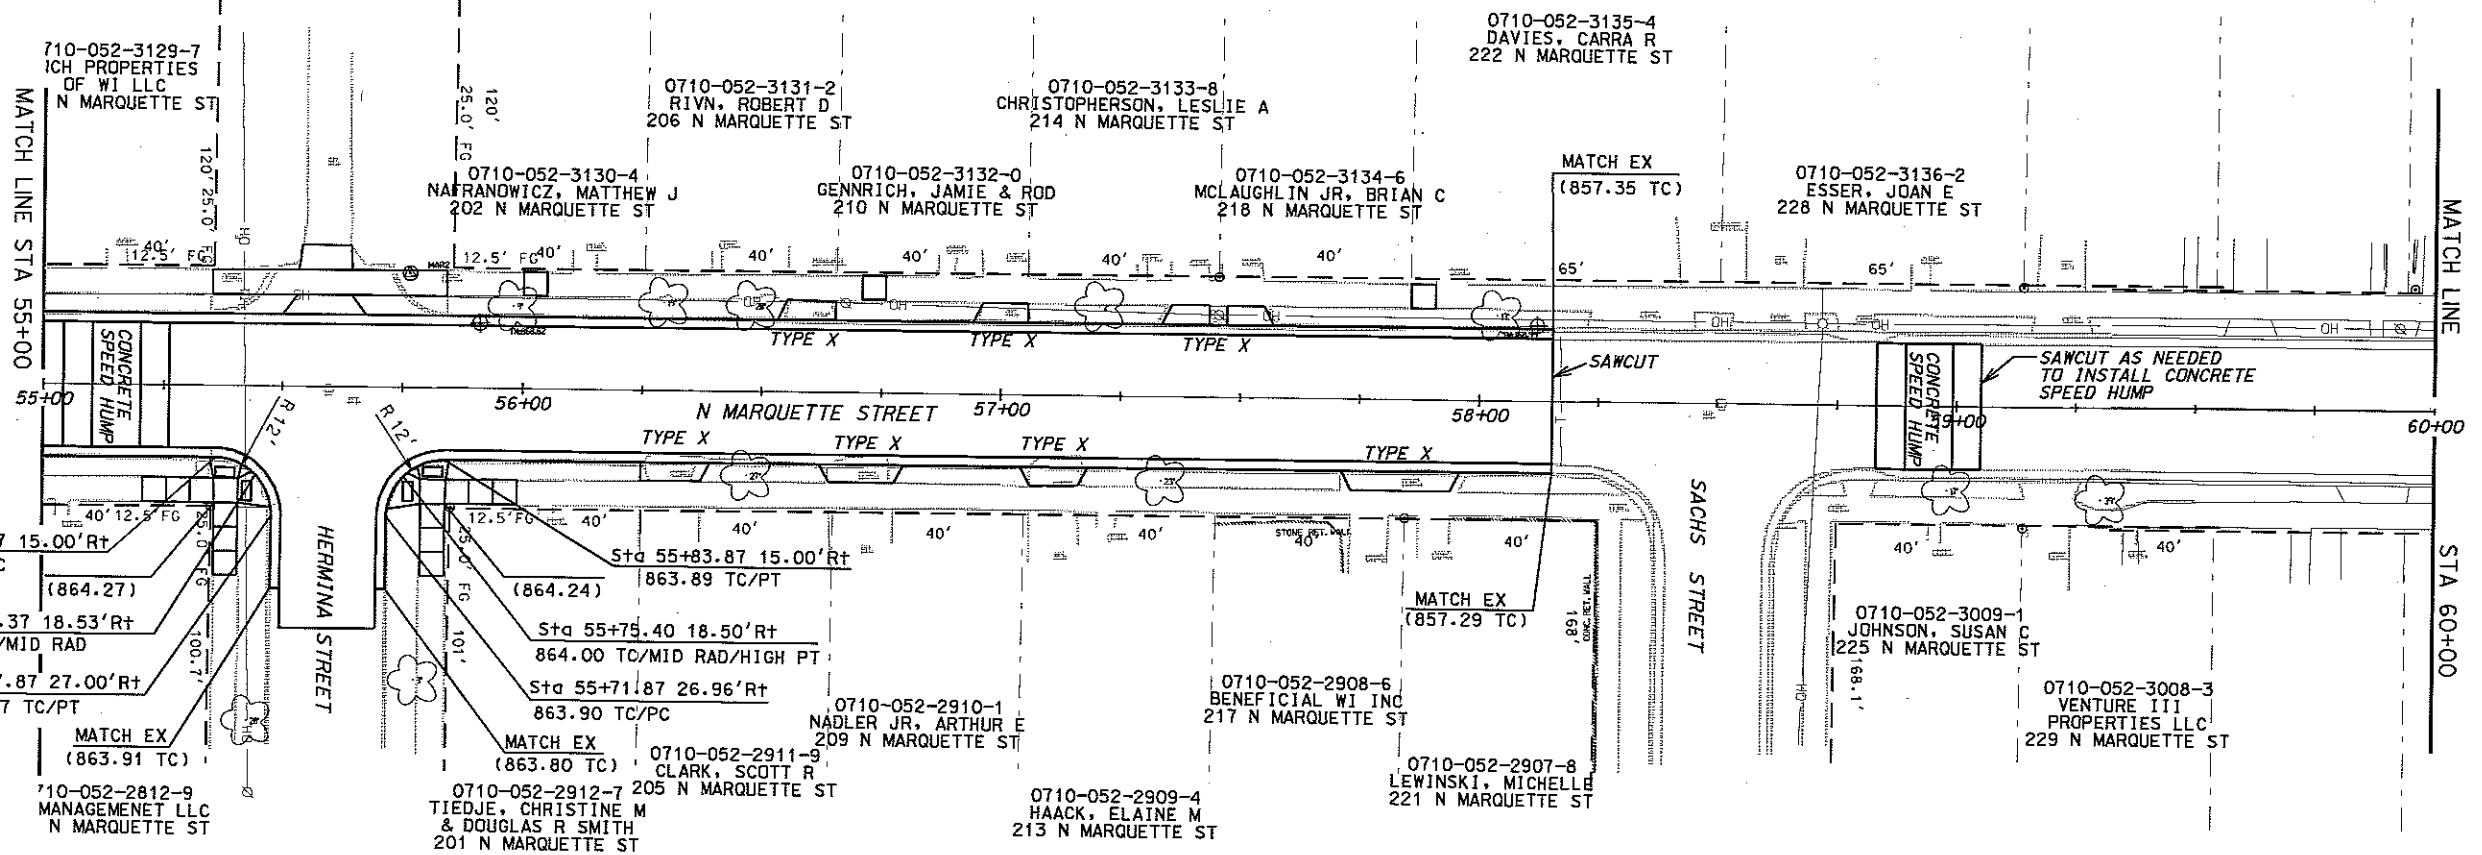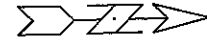

PLOT SCALE: _____

PLOT NAME: _____

REV. DATE: _____

ORIGINATOR: CITY OF MADISON, STREETS DIVISION

