URBAN DESIGN COMMISSION APPLICATION



City of Madison Planning Division Madison Municipal Building, Suite 017 215 Martin Luther King, Jr. Blvd. P.O. Box 2985 Madison, WI 53701-2985 (608) 266-4635



| FOR OFFICE USE ONLY: | |
|----------------------|-------------------|
| Date Received | Initial Submittal |
| Paid | Revised Submittal |

Complete all sections of this application, including the desired meeting date and the action requested. If your project requires both UDC and Land Use application submittals, a completed Land Use Application and If you need an interpreter, translator, materials in alternate formats or other accommodations to access these forms, please call the Planning Division at (608) 266-4635.

Si necesita interprete, traductor, materiales en diferentes formatos, u otro tipo de ayuda para acceder a estos formularios, por favor llame al (608) 266-4635.

| | be submitted. | are also required to | ntaub ntawv ua lwm hom ntawv los sis lwm cov kev pab kom paub txog cov lus qhia no, thov hu rau Koog Npaj (Planning Division) (608) 266-4635. |
|------------------------|--|--------------------------|---|
| 1. | Project Information | | |
| | Address (list all addresses on the pr | oject site): | |
| | Title: | | |
| 2. | Application Type (check all that | apply) and Requested Da | ate |
| | UDC meeting date requested | | |
| | New development | | or previously-approved development |
| | Informational | Initial Approval | Final Approval |
| 3. | Project Type | | |
| | Project in an Urban Design Dist | trict | Signage |
| | Project in the Downtown Core I | ` '' | Comprehensive Design Review (CDR) |
| | Mixed-Use District (UMX), or Mix | | Modifications of Height, Area, and Setback |
| | Project in the Suburban Employment Center District (SEC), Campus Institutional District (CI), or Employment Campus District (EC) | | Sign Exceptions as noted in Sec. 31.043(3), MGO |
| | Planned Development (PD) | | Other |
| | General Development Pla | n (GDP) | Please specify |
| | Specific Implementation F | Plan (SIP) | |
| | Planned Multi-Use Site or Resid | dential Building Complex | |
| 4. | Applicant, Agent, and Property | Owner Information | |
| | Applicant name | | _ Company |
| | Street address | | City/State/Zip |
| Telephone | | | |
| Project contact person | | | Company |
| Street address | | | City/State/Zip |
| | Telephone | | Email |
| | Property owner (if not applicant) | | |
| | Street address | | City/State/Zip |
| | Telephone | | |
| | Di anno Di anno di Contra della | Dec | PAGE 1 OF 4 |

URBAN DESIGN COMMISSION APPROVAL PROCESS



Introduction

The City of Madison's Urban Design Commission (UDC) has been created to:

- Encourage and promote high quality in the design of new buildings, developments, remodeling, and additions so as to maintain and improve the established standards of property values within the City.
- Foster civic pride in the beauty and nobler assets of the City, and in all other ways possible assure a functionally efficient
 and visually attractive City in the future.

Types of Approvals

There are three types of requests considered by the UDC:

- <u>Informational Presentation</u>. A request for an Informational Presentation to the UDC may be requested prior to seeking any approvals to obtain early feedback and direction before undertaking detailed design efforts. Applicants should provide details on the context of the site, design concept, site and building plans, and other relevant information to help the UDC understand the proposal and provide feedback. (Does not apply to CDR's or Signage Modification requests)
- <u>Initial Approval</u>. Applicants may, at their discretion, request Initial Approval of a proposal by presenting preliminary design information. As part of their review, the Commission will provide feedback on the design information that should be addressed at Final Approval stage.
- <u>Final Approval</u>. Applicants may request Final Approval of a proposal by presenting all final project details. Recommendations or concerns expressed by the UDC in the Initial Approval must be addressed at this time.

Presentations to the Commission

The Urban Design Commission meets virtually via Zoom, typically on the second and fourth Wednesdays of each month at 4:30 p.m. Applicant presentations are strongly encouraged, although not required. Prior to the meeting, each individual speaker is required to complete an online registration form to speak at the meeting. A link to complete the online registration will be provided by staff prior to the meeting. Please note that individual presentations will be limited to a **maximum of three (3) minutes**. The pooling of time may be utilized to provide one speaker more time to present, however the additional time will be based on the number of registrants from the applicant team, i.e. two (2) applicant registrants = six (6) minutes for one (1) speaker.

Primarily, the UDC is interested in the appearance and design quality of projects. Emphasis should be given to the site plan, landscape plan, lighting plan, building elevations, exterior building materials, color scheme, and graphics. Please note that presentation slides, in a PDF file format, are required to be submitted **the Friday before** the UDC meeting.

URBAN DESIGN DEVELOPMENT PLANS CHECKLIST



The items listed below are minimum application requirements for the type of approval indicated. Please note that the UDC and/or staff may require additional information in order to have a complete understanding of the project.

| 1. Informa | tional Presentation | | |
|--------------|---|---|--|
| | Locator Map |) | Requirements for All Plan Sheets |
| | Letter of Intent (If the project is within | | 1. Title block |
| | an Urban Design District, a summary of how the development proposal addresses | | 2. Sheet number |
| | the district criteria is required) | Providing additional information beyond these | 3. North arrow |
| | Contextual site information, including | minimums may generate | 4. Scale, both written and graphic |
| | photographs and layout of adjacent buildings/structures | a greater level of feedback | 5. Date |
| | Site Plan | from the Commission. | Fully dimensioned plans, scaled at 1"= 40' or larger |
| | Two-dimensional (2D) images of | | ** All plans must be legible, including |
| _ | proposed buildings or structures. | J | the full-sized landscape and lighting plans (if required) |
| 2. Initial A | pproval | | |
| | Locator Map | |) |
| | Letter of Intent (If the project is within a development proposal addresses the distri | | ry of <u>how</u> the Providing additional |
| | Contextual site information, including photogr | aphs and layout of adjacent building | gs/structures information |
| | Site Plan showing location of existing and bike parking, and existing trees over 18" di | | minimums may |
| | Landscape Plan and Plant List (must be legi | ble) | generate a greater level of |
| | Building Elevations in both black & white ar and color callouts | nd color for all building sides, inclu | ding material feedback from the Commission. |
| | PD text and Letter of Intent (if applicable) | | J |
| 3. Final Ap | proval | | |
| All the r | equirements of the Initial Approval (see abo | ve), plus : | |
| | Grading Plan | | |
| | Lighting Plan, including fixture cut sheets a | nd photometrics plan (must be le | gible) |
| | Utility/HVAC equipment location and scree | ning details (with a rooftop plan i | if roof-mounted) |
| | Site Plan showing site amenities, fencing, to | rash, bike parking, etc. (if applical | ole) |
| | PD text and Letter of Intent (if applicable) | | |
| | Samples of the exterior building materials | | |
| | Proposed sign areas and types (if applicable | e) | |
| 4. Signage | Approval (Comprehensive Design Review (| CDR), Sign Modifications, and Sig | n Exceptions (per <u>Sec. 31.043(3)</u>) |
| | Locator Map | | |
| | Letter of Intent (a summary of <u>how</u> the propose | | |
| | Contextual site information, including pho project site | | |
| | Site Plan showing the location of existing si driveways, and right-of-ways | gnage and proposed signage, dim | nensioned signage setbacks, sidewalks |
| | Proposed signage graphics (fully dimension | - | · · |
| | Perspective renderings (emphasis on pedes | | · |
| | Illustration of the proposed signage that m | • | ÷ , |
| | Graphic of the proposed signage as it relate | es to what the <u>Ch. 31, MGO</u> would | d permit |

5. Required Submittal Materials

Application Form

• A completed application form is required for <u>each</u> UDC appearance. For projects also requiring Plan Commission approval, applicants must also have submitted an accepted application for Plan Commission consideration prior to obtaining any formal action (Initial or Final Approval) from the UDC.

Letter of Intent

- If the project is within an Urban Design District, a summary of how the development proposal addresses the district criteria is required.
- For signage applications, a summary of how the proposed signage is consistent with the applicable Comprehensive Design Review (CDR) or Signage Modification review criteria is required.

Development Plans (Refer to checklist on Page 4 for plan details)

Filing Fee (Refer to Section 7 (below) for a list of application fees by request type)

Electronic Submittal

- Complete electronic submittals <u>must</u> be received prior to the application deadline before an application will be scheduled for a UDC meeting. Late materials will not be accepted. All plans must be legible and scalable when reduced. Individual PDF files of each item submitted should be submitted via email to <u>UDCapplications@cityofmadison.com</u>. The email must include the project address, project name, and applicant name.
- Email Size Limits. Note that <u>an individual email cannot exceed 20MB</u> and <u>it is the responsibility of the applicant</u> to present files in a manner that can be accepted. Applicants who are unable to provide the materials electronically should contact the Planning Division at (608) 266-4635 for assistance.

Notification to the District Alder

• Please provide an email to the District Alder notifying them that you are filing this UDC application. Please send this as early in the process as possible and provide a copy of that email with the submitted application.

| . Apı | plicant Declarations | |
|-------|--|--------------------------|
| 1. | Prior to submitting this application, the applicant is required to disc This application was discussed with | |
| 2. | The applicant attests that all required materials are included in the is not provided by the application deadline, the application will consideration. | |
| Nar | ne of applicant | Relationship to property |
| Aut | horizing signature of property owner | Date |

7. Application Filing Fees

Fee payments are due by the submittal date. Payments received after the submittal deadline may result in the submittal being scheduled for the next application review cycle. Fees may be paid in-person, via US Mail, or City drop box. If mailed, please mail to: City of Madison Building Inspection, P.O. Box 2984, Madison, WI 53701-2984. The City's drop box is located outside the Municipal Building at 215 Martin Luther King, Jr. Blvd. on the E Doty Street side of the building. Please make checks payable to City Treasurer, and include a completed application form or cover letter indicating the project location and applicant information with all checks mailed or submitted via the City's drop box.

Please consult the schedule below for the appropriate fee for your request:

Urban Design Districts: \$350 (per §33.24(6) MGO).

Minor Alteration in the Downtown Core District (DC) or Urban Mixed-Use District (UMX): \$150

(per §33.24(6)(b) MGO)

Comprehensive Design Review: \$500

(per §31.041(3)(d)(1)(a) MGO)

Minor Alteration to a Comprehensive Sign Plan: \$100 (per §31.041(3)(d)(1)(c) MGO)

All other sign requests to the Urban Design Commission, including, but not limited to: appeals from the decisions of the Zoning Administrator, requests for Sign Modifications (of height, area, and setback), and additional sign code approvals: \$300 (per §31.041(3)(d)(2) MGO)

A filing fee is not required for the following project applications if part of the combined application process involving both Urban Design Commission and Plan Commission:

- Project in the Downtown Core District (DC), Urban Mixed-Use District (UMX), or Mixed-Use Center District (MXC)
- Project in the Suburban Employment Center District (SEC), Campus Institutional District (CI), or Employment Campus District (EC)
- Planned Development (PD): General Development Plan (GDP) and/or Specific Implementation Plan (SIP)
- Planned Multi-Use Site or Residential Building Complex



April 29, 2024

Jessica Vaughn
UDC Secretary
City of Madison
Planning Department
215 Martin Luther King Jr. Blvd.
Madison, WI 53703

Re: Lighthouse Christian School 6402 Schroeder Road Madison, WI 53711

Dear Ms. Vaughn

This letter of intent with a summary of the project being submitted for Urban Design Commission and Plan Commission review for the above-mentioned project. Per our pre-application meeting on April 11,2024 this is considered a major amendment to the existing conditional use.

The project consists of an addition to the existing Lighthouse Christian School at 6402 Schroeder Road. The existing building is a 1-story, 37,250 s.f. school. The addition is a 7,500 +/- s.f., one story addition consisting of new classrooms, multi-purpose space and teachers lounge. The addition is to the south end of the existing building facing Schroeder Road.

As we are doing our addition off the existing south façade, this is also considered a demolition to the existing façade as we are covering up more than 50% of the existing street facing façade. While we are not physically demolishing the wall, we have applied for the demolition permit and notice.


We have addressed the Urban Design Commission guidelines with the addition, keeping a low profile building to reflect the surrounding neighborhood. The elevations are a mix of metal panels and glazing with various sized windows and building articulation to provide an engaging experience for the students and surrounding community. Additionally, we understand the ordinance for bird safety glazing and have included bird safe glazing where applicable.


Please find attached the UDC review application, plans, notice of demolition and waiver from the Alder in this district.


Sincerely,


Jeffrey M Stowe Architect


Enclosures

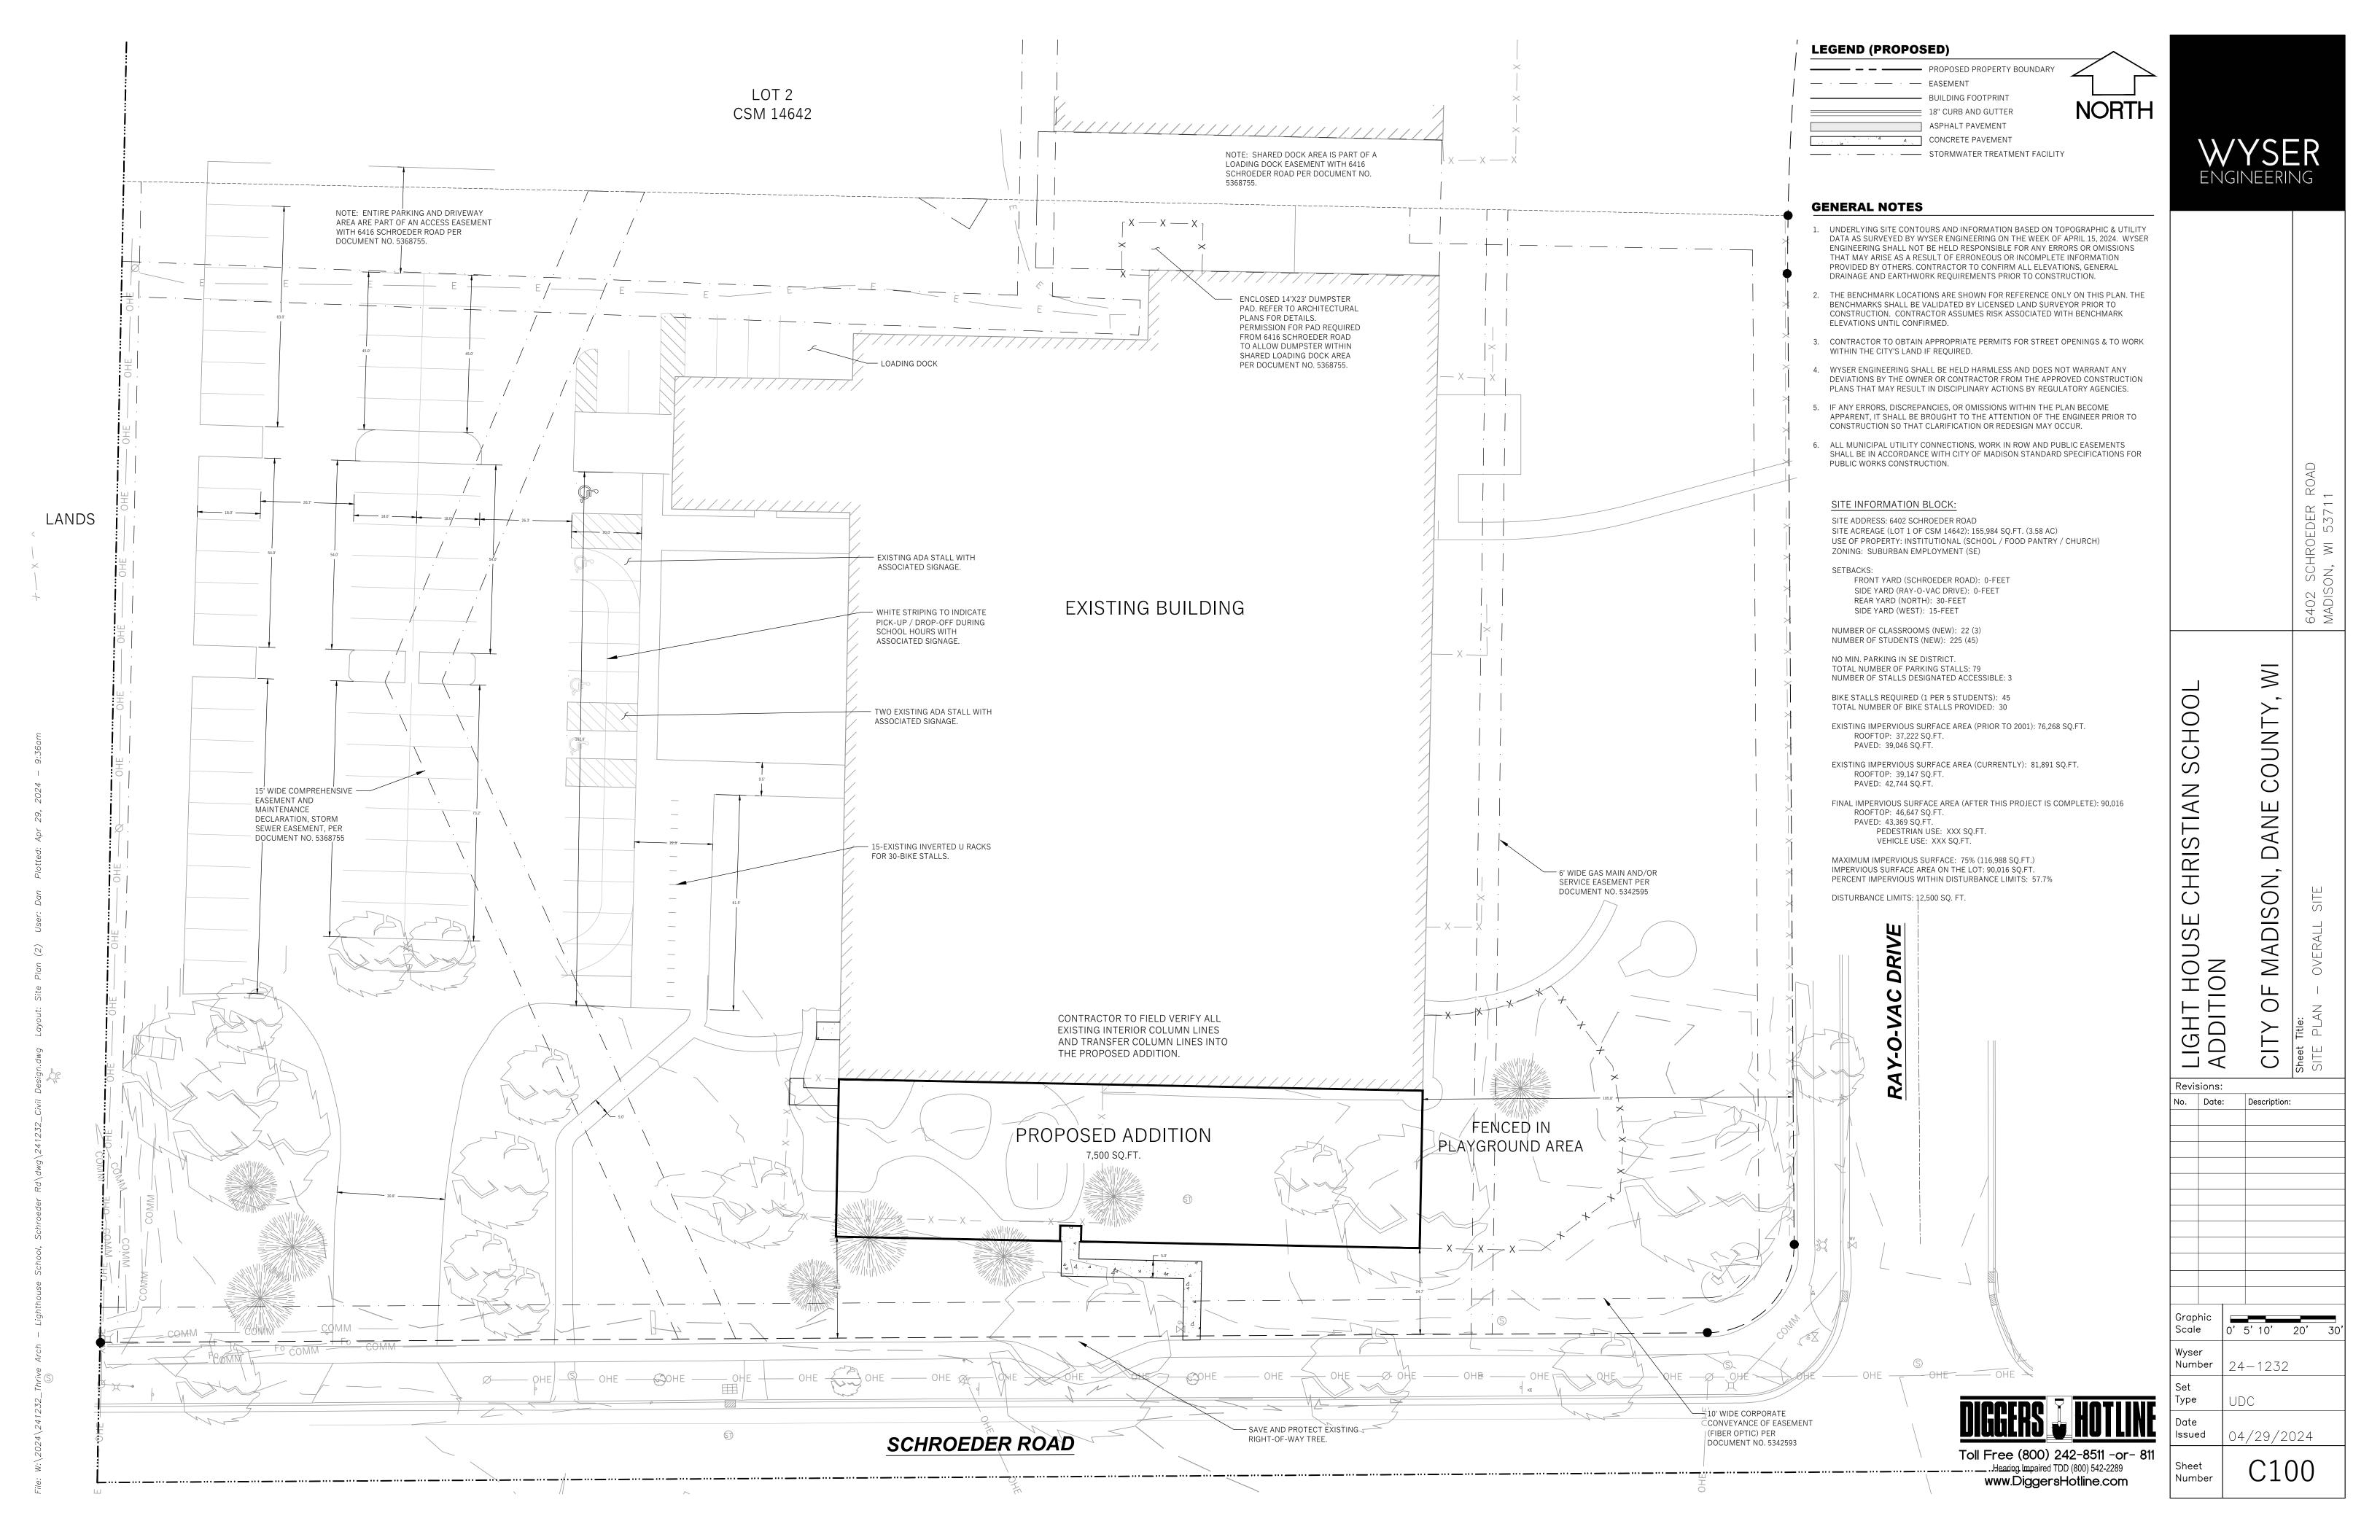

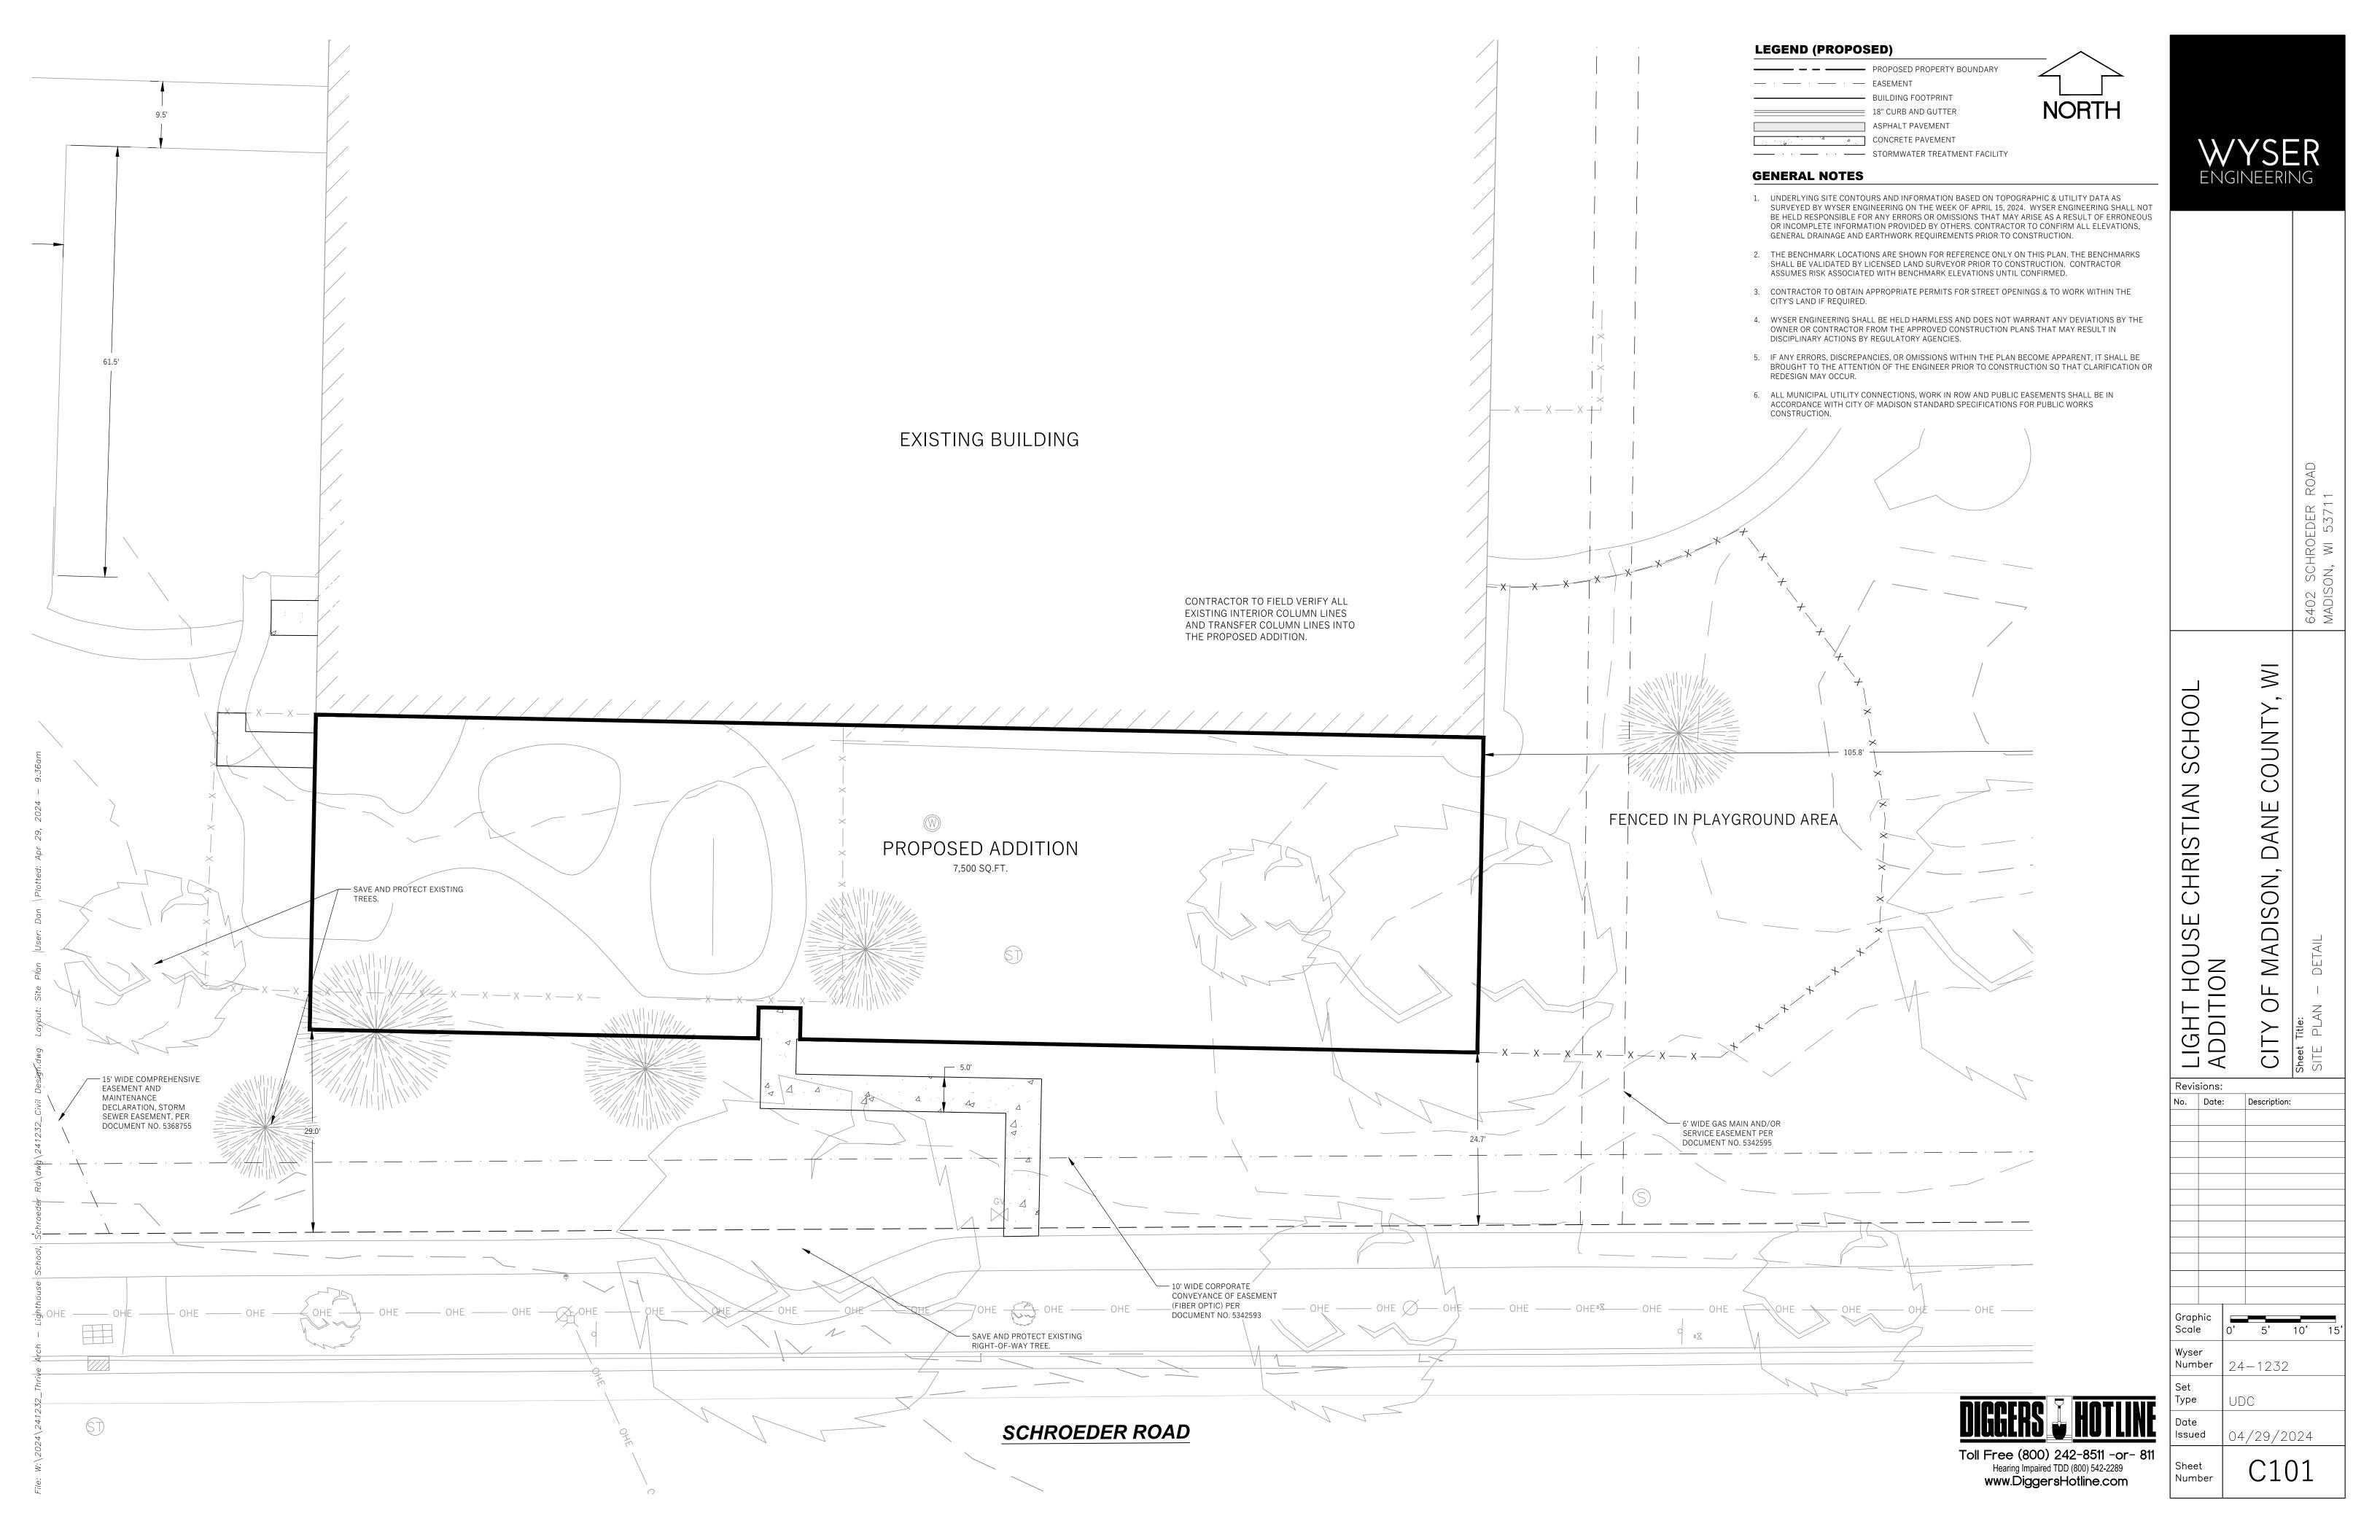

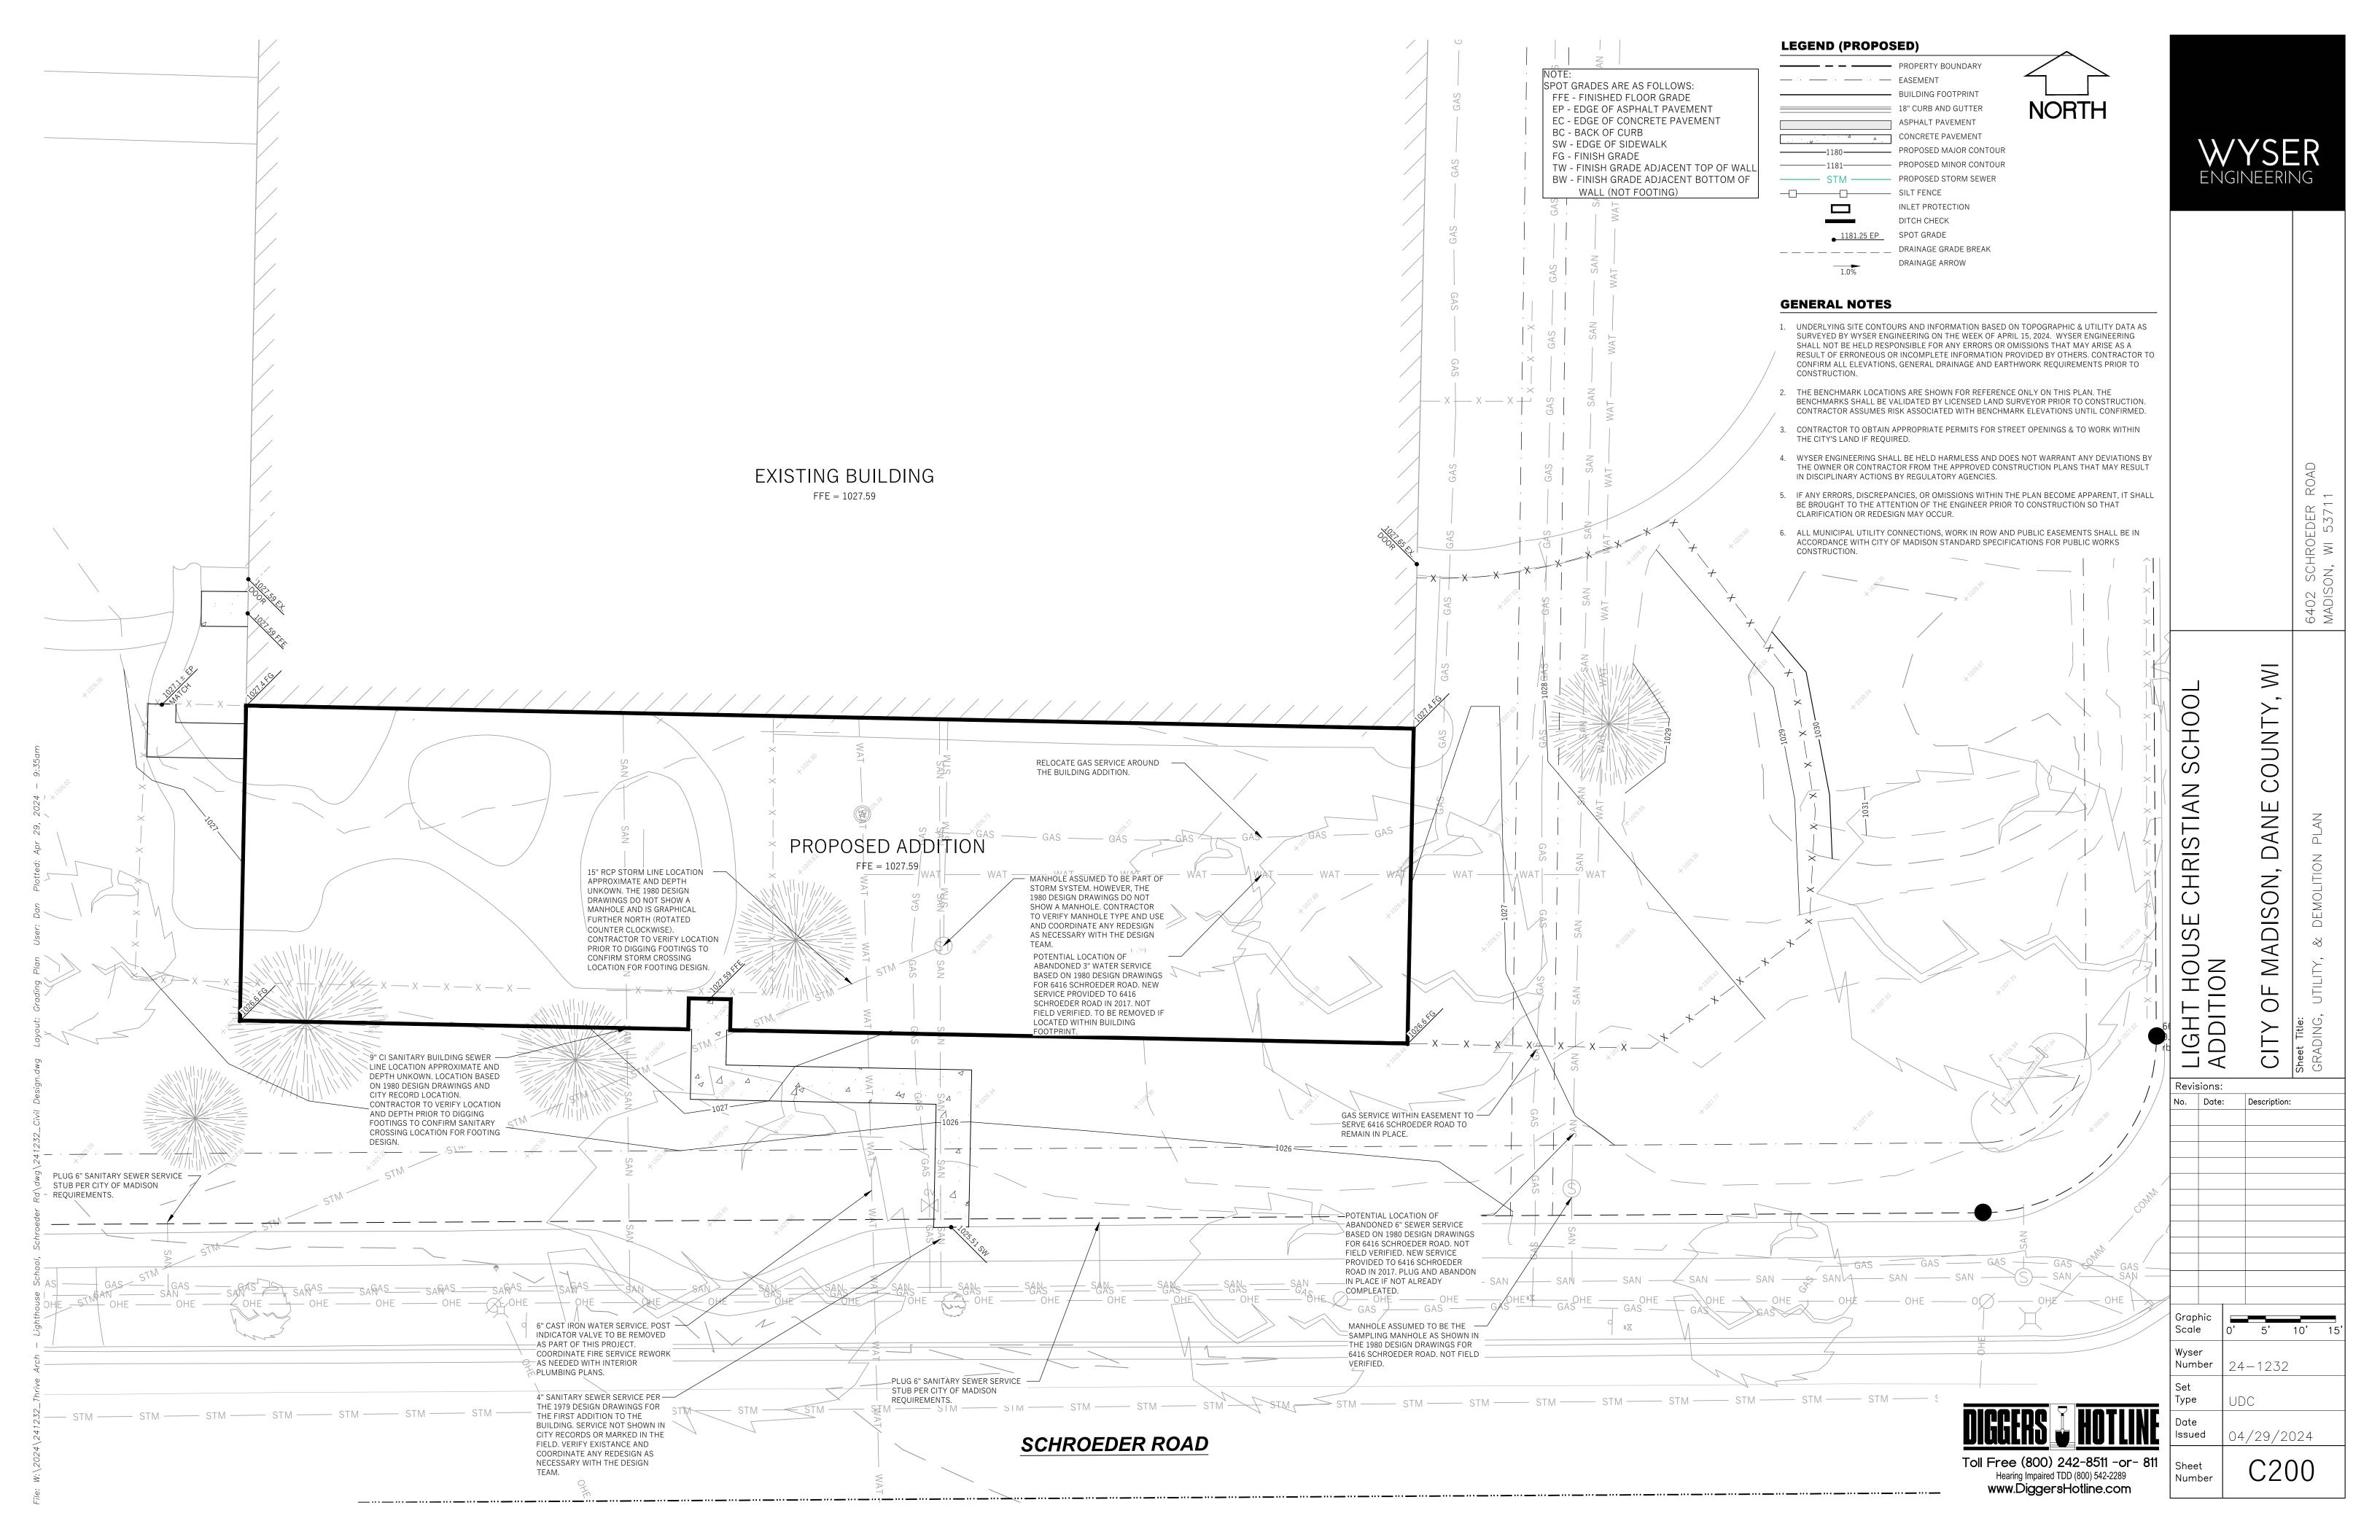

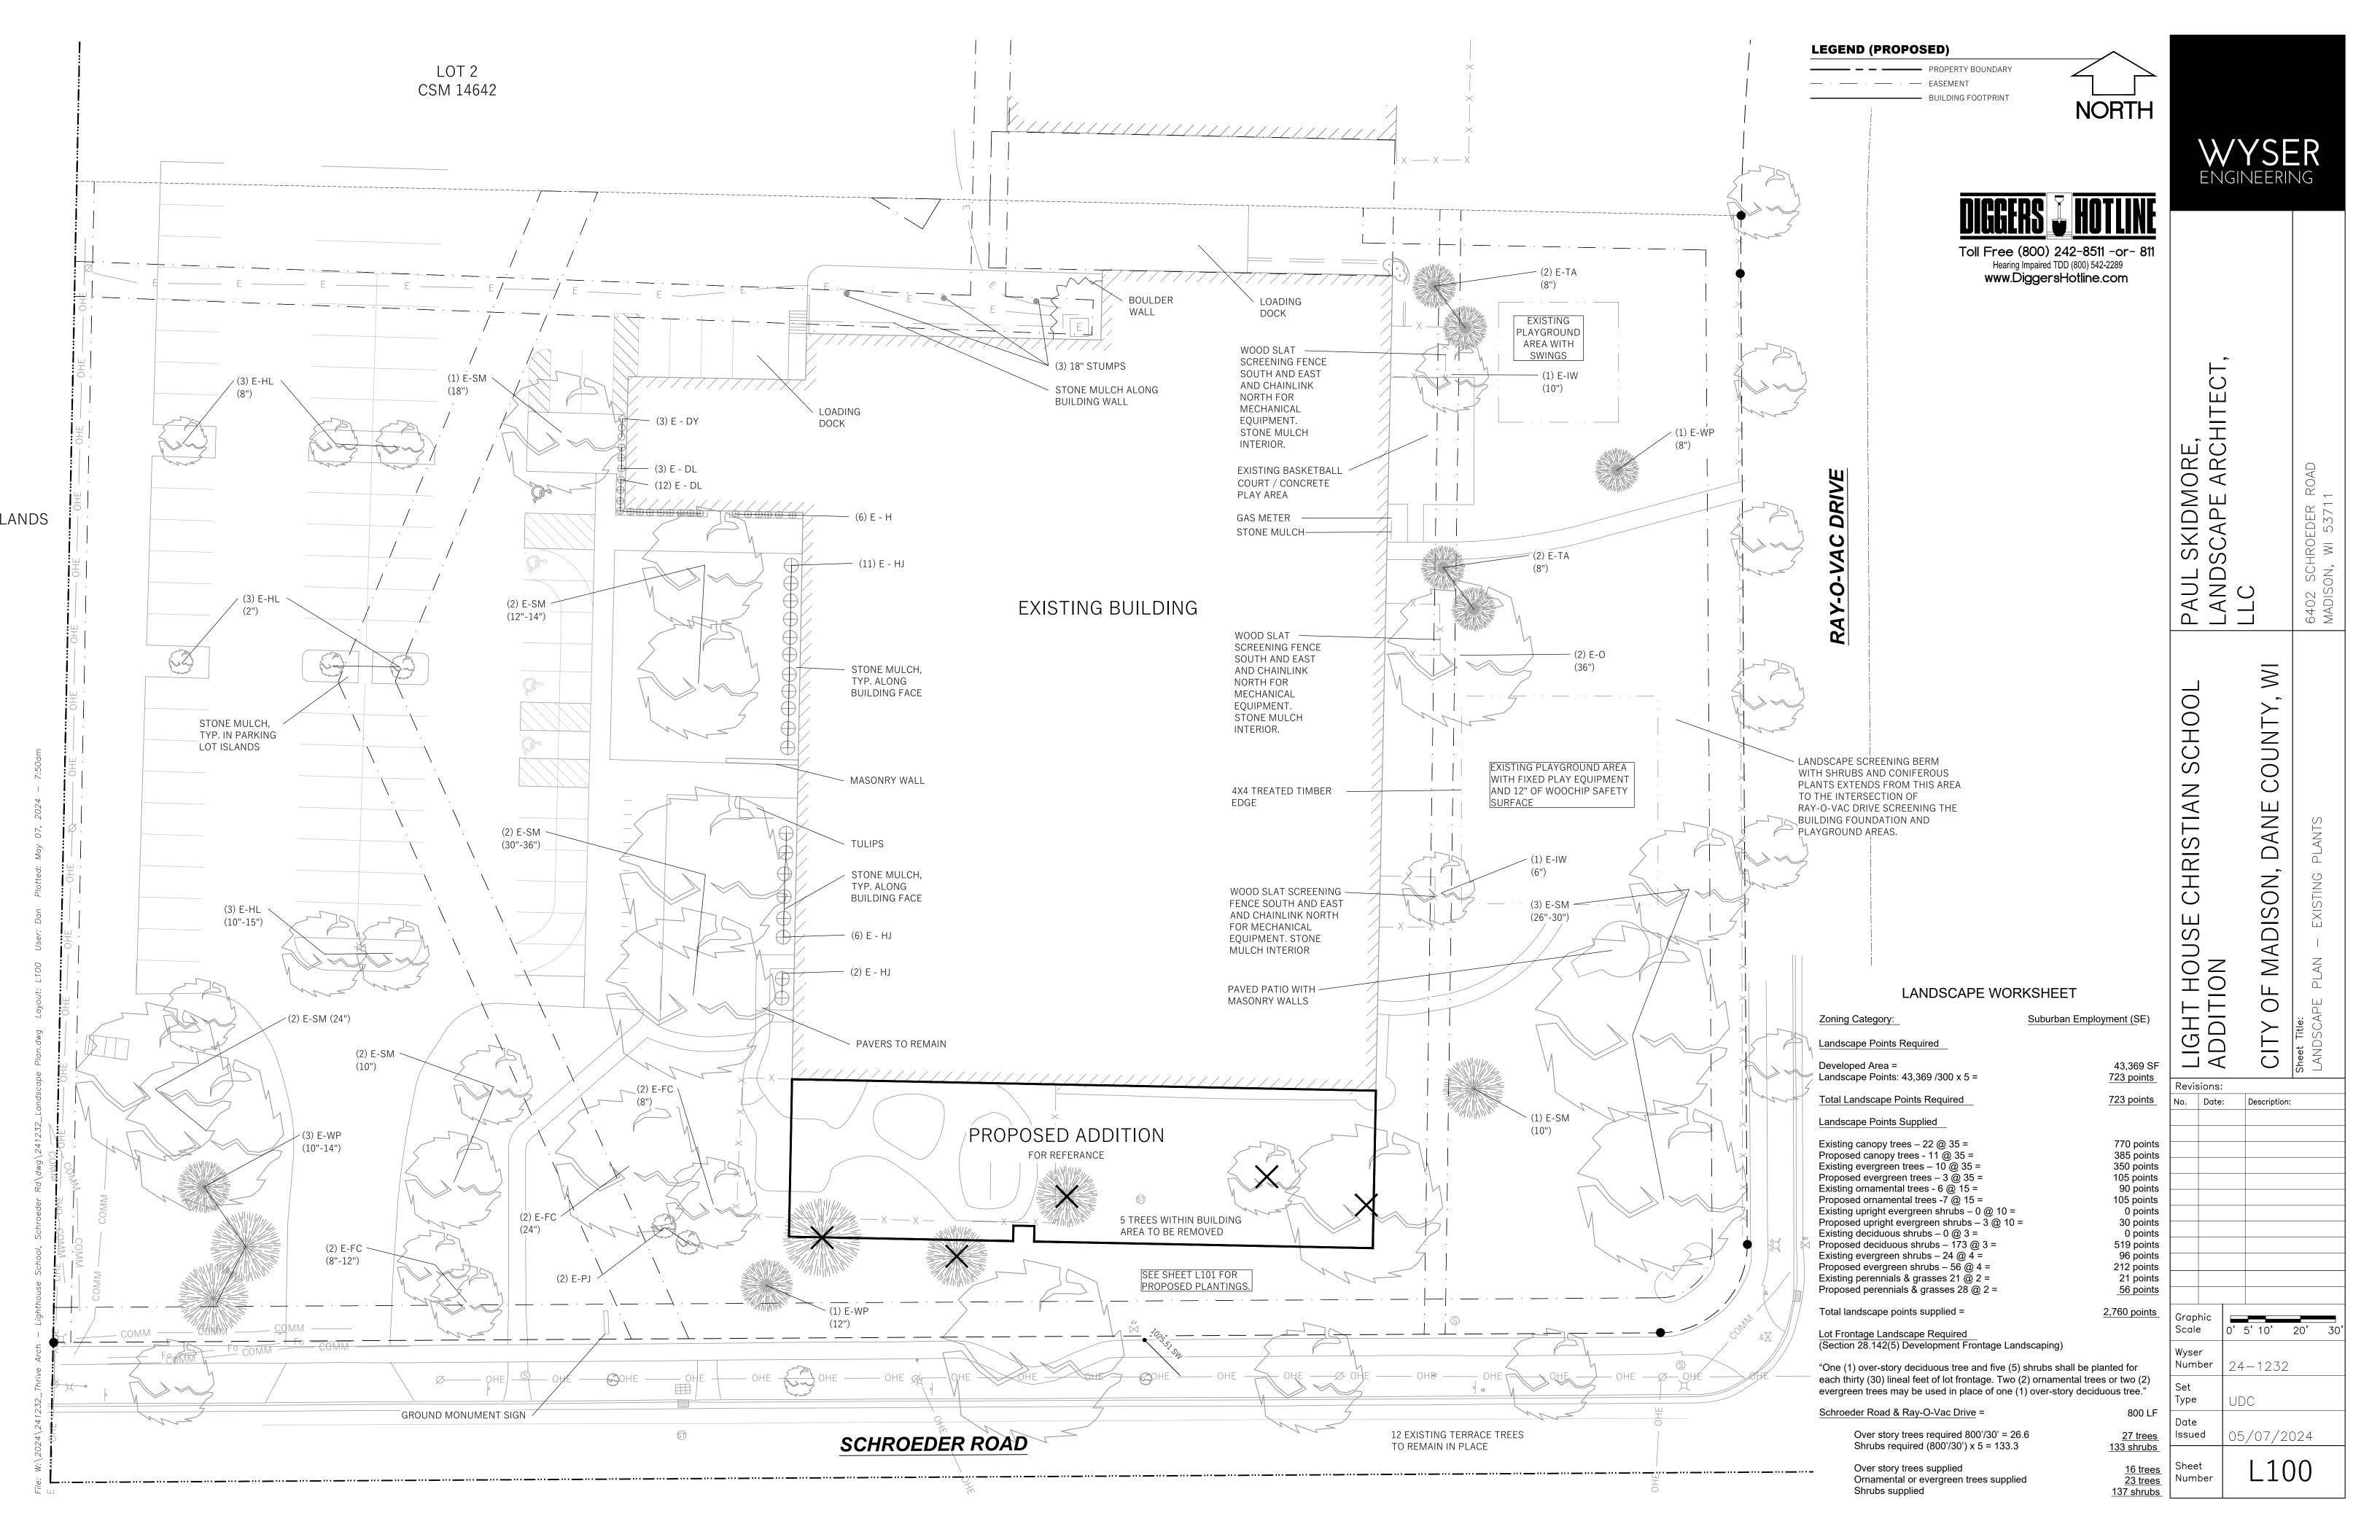

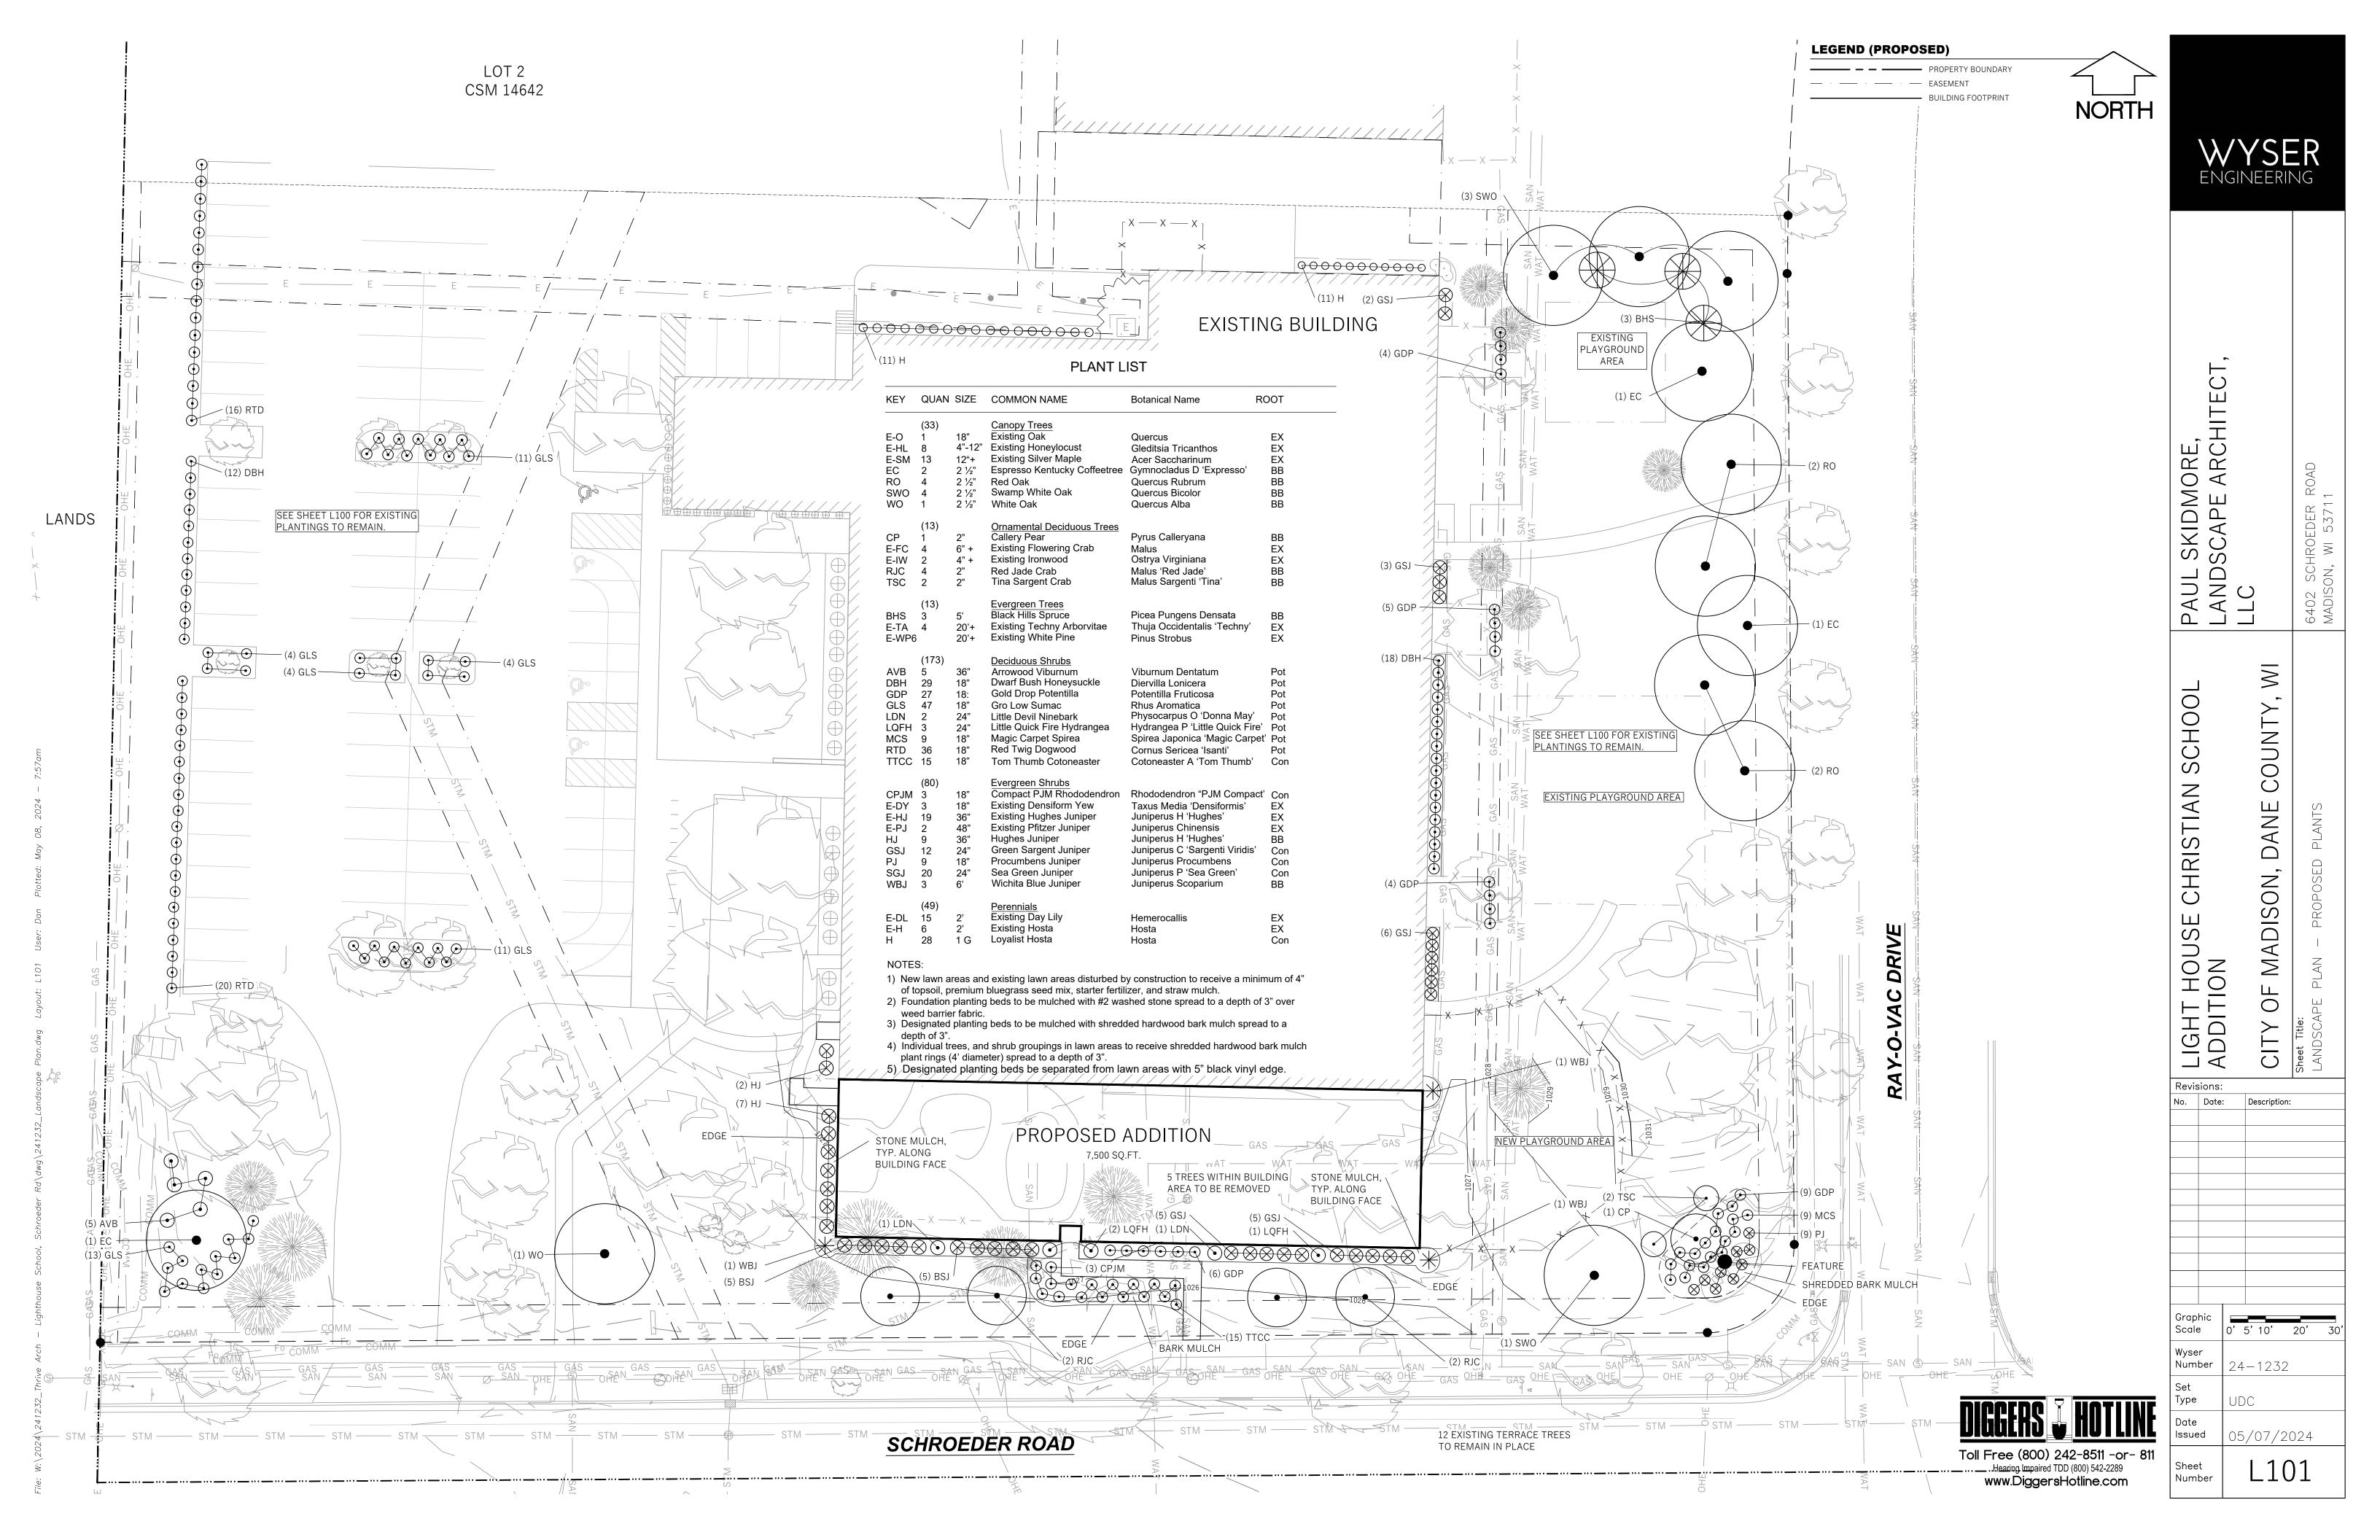



05/29/24 LED Info **Driver Info** Watts 15W Color Temp 3000K/4000K/5000K 0.07A

70 CRI Color: Bronze Accuracy 240V 0.06A L70 Lifespan 100,000 Hours 277V 0.05A Lumens 1761/1904/1852 lm Input Watts 14.2/14/14.2W Efficacy 124/136.2/130.3 lm/W

Construction

Need help? Tech help line: (888) 722-1000 Email: sales@rablighting.com Website: www.rablighting.com

Copyright © 2024 RAB Lighting All Rights Reserved Note: Specifications are subject to change at any time without notice

Cold Weather Starting:

Technical Specifications Field Adjustability Field Adjustable: Color temperature selectable by 3000K, 4000K and Compliance UL Listed: Electrical Suitable for wet locations

IESNA LM-79 & LM-80 Testing: RAB LED luminaires and LED components have been tested by an independent laboratory in accordance with IESNA LM-79 and LM-80. IP Rating: Ingress protection rating of IP65 for dust and water

This product is listed by Design Lights Consortium (DLC) as an ultra-efficient premium product that qualifies for the highest tier of rebates from DLC Member Utilities. Designed to meet DLC 5.1 DLC Product Code: PL0MVJOV62Q3

Performance 100,000-Hour LED lifespan based on IES LM-80 results and TM-21 calculations

Wattage Equivalency: Ambient Temperature : Equivalent to 70W Metal Halide Max Power Temp Rating: 50°C (122°F) Middle Power Temp Rating: 50°C (122°F)) Low Power Temp Rating: 50°C (122°F) **LED Characteristics**

Long-life, high-efficiency, surface-mount LEDs Precision die-cast aluminum housing and door Constant Current, Class 2, 120-277V, 50/60 Hz, 120V: Polycarbonate lens 0.13A, 208V: 0.07A, 240V: 0.06A, 277V: 0.05A

Driver includes dimming control wiring for 0-10V back, sides, top and bottom make installation a snap dimming systems. Requires separate 0-10V DC dimming circuit. Dims down to 10%. Adjustable from 0° (full cutoff) to 90°. 7 settings at 15° each. 120-277V Integrated button photocell included.

> Green Technology: Mercury and UV free. RoHS-compliant components.

Hinged wiring access and conduit entries on the

Surge Protection: Formulated for high durability and long-lasting color L-N:2.5KV,L/N-GND:2.5KV

All values are typical (tolerance +/- 10%)

is subject to all terms and conditions found at rablighting.com/warranty. Buy American Act Compliance: RAB values USA manufacturing! Upon request, RAB may be able to manufacture this product to be compliant with the Buy American Act (BAA). Please contact customer service to request a quote for the product to be made BAA compliant.

Features Selectable CCT Adjustable cutoff Integrated photocell 0-10V dimming, standard

Ordering Matrix ADJ SLIM17FA 15 **15** = 15W **ADJ** = Angle Adjustable

Need help? Tech help line: (888) 722-1000 Email: sales@rablighting.com Website: www.rablighting.com Copyright © 2024 RAB Lighting All Rights Reserved Note: Specifications are subject to change at any time without notice Page 1 of 2

Page 2 of 2 0.0 0.0 0.0 0.0 0.0 0.1 0.1 0.2 0.4 0.9 1.8 3.2 4.6 4.5 2.9 1.6 0.7 0.3 0.2 0.1 0.0 0.0 0.0 0.0 0.0 0.0 0.0 0.0 0.0 0.1 0.1 0.2 0.4 0.8 1.4 2.3 3.1 3.0 2.1 1.2 0.7 0.4 0.2 0.1 0.1 0.0 0.0 0.0 0.0 0.0 0.0 0.0 0.1 0.1 0.2 0.3 0.6 0.9 1.3 1.7 1.6 1.3 0.8 0.5 0.3 0.2 0.1 0.1 0.0 0.0 0.0 0.0 0.0 0.0 0.0 0.1 0.1 0.1 0.2 0.3 0.5 0.7 0.8 0.8 0.7 0.8 0.3 0.2 0.1 0.1 0.0 0.0 0.0 0.0 0.0 0.0 0.0 0.0 0.0 0.1 0.1 0.1 0.2 0.2 0.3 0.3 0.3 0.3 0.2 0.2 0.1 0.1 0.0 0.0 0.0

| Luminaire Sche | edule | | | | | | | |
|----------------|-------|--------------|-----|------------------|-------------|-------|-----------|-----------|
| Symbol | Qty | Label | Tag | Description | Arrangement | LLF | Luminaire | Luminaire |
| | | | | | | | Lumens | Watts |
| ₽ | 2 | slim17fa15ad | W15 | SLIM17FA15ADJ_4K | Single | 0.900 | 1761 | 13.98 |
| | | j_4k | | | _ | | | |

| Calculation Su | ummary | | | | | | |
|----------------|-------------|-------|------|-----|-----|---------|---------|
| Label | CalcType | Units | Avg | Max | Min | Avg/Min | Max/Min |
| CalcPts_1 | Illuminance | Fc | 0.13 | 4.8 | 0.0 | N.A. | N.A. |

\$ 5.0 \$ 0.0 \$ 0.0 \$ 0.0 \$ 0.1 \$ 0.0

tion to the term term to the t

1. STANDARD REFLECTANCE OF 80/50/20 UNLESS NOTED OTHERWISE.

2. NOT A CONSTRUCTION DOCUMENT- FOR DESIGN PURPOSES ONLY.

3. STANDARD INDOOR CALC POINTS @ 30" AFF UNLESS NOTED OTHERWISE. 4. STANDARD OUTDOOR CALC POINTS @ GRADE UNLESS NOTED OTHERWISE.

5. EGRESS CALC POINTS @ 0'-0" AFF.


6. PHOTOMETRICS ARE ESTIMATED LIGHTING CALUCULATIONS.

VIKING ELECTRIC ASSUMES NO RESPONSIBILITY FOR INSTALLED LIGHT LEVELS DUE TO FIELD CONDITIONS.

7. VIKING ELECTRIC NOT RESPONSIBLE FOR FINAL REVIEW OF CODE REQUIREMENTS.





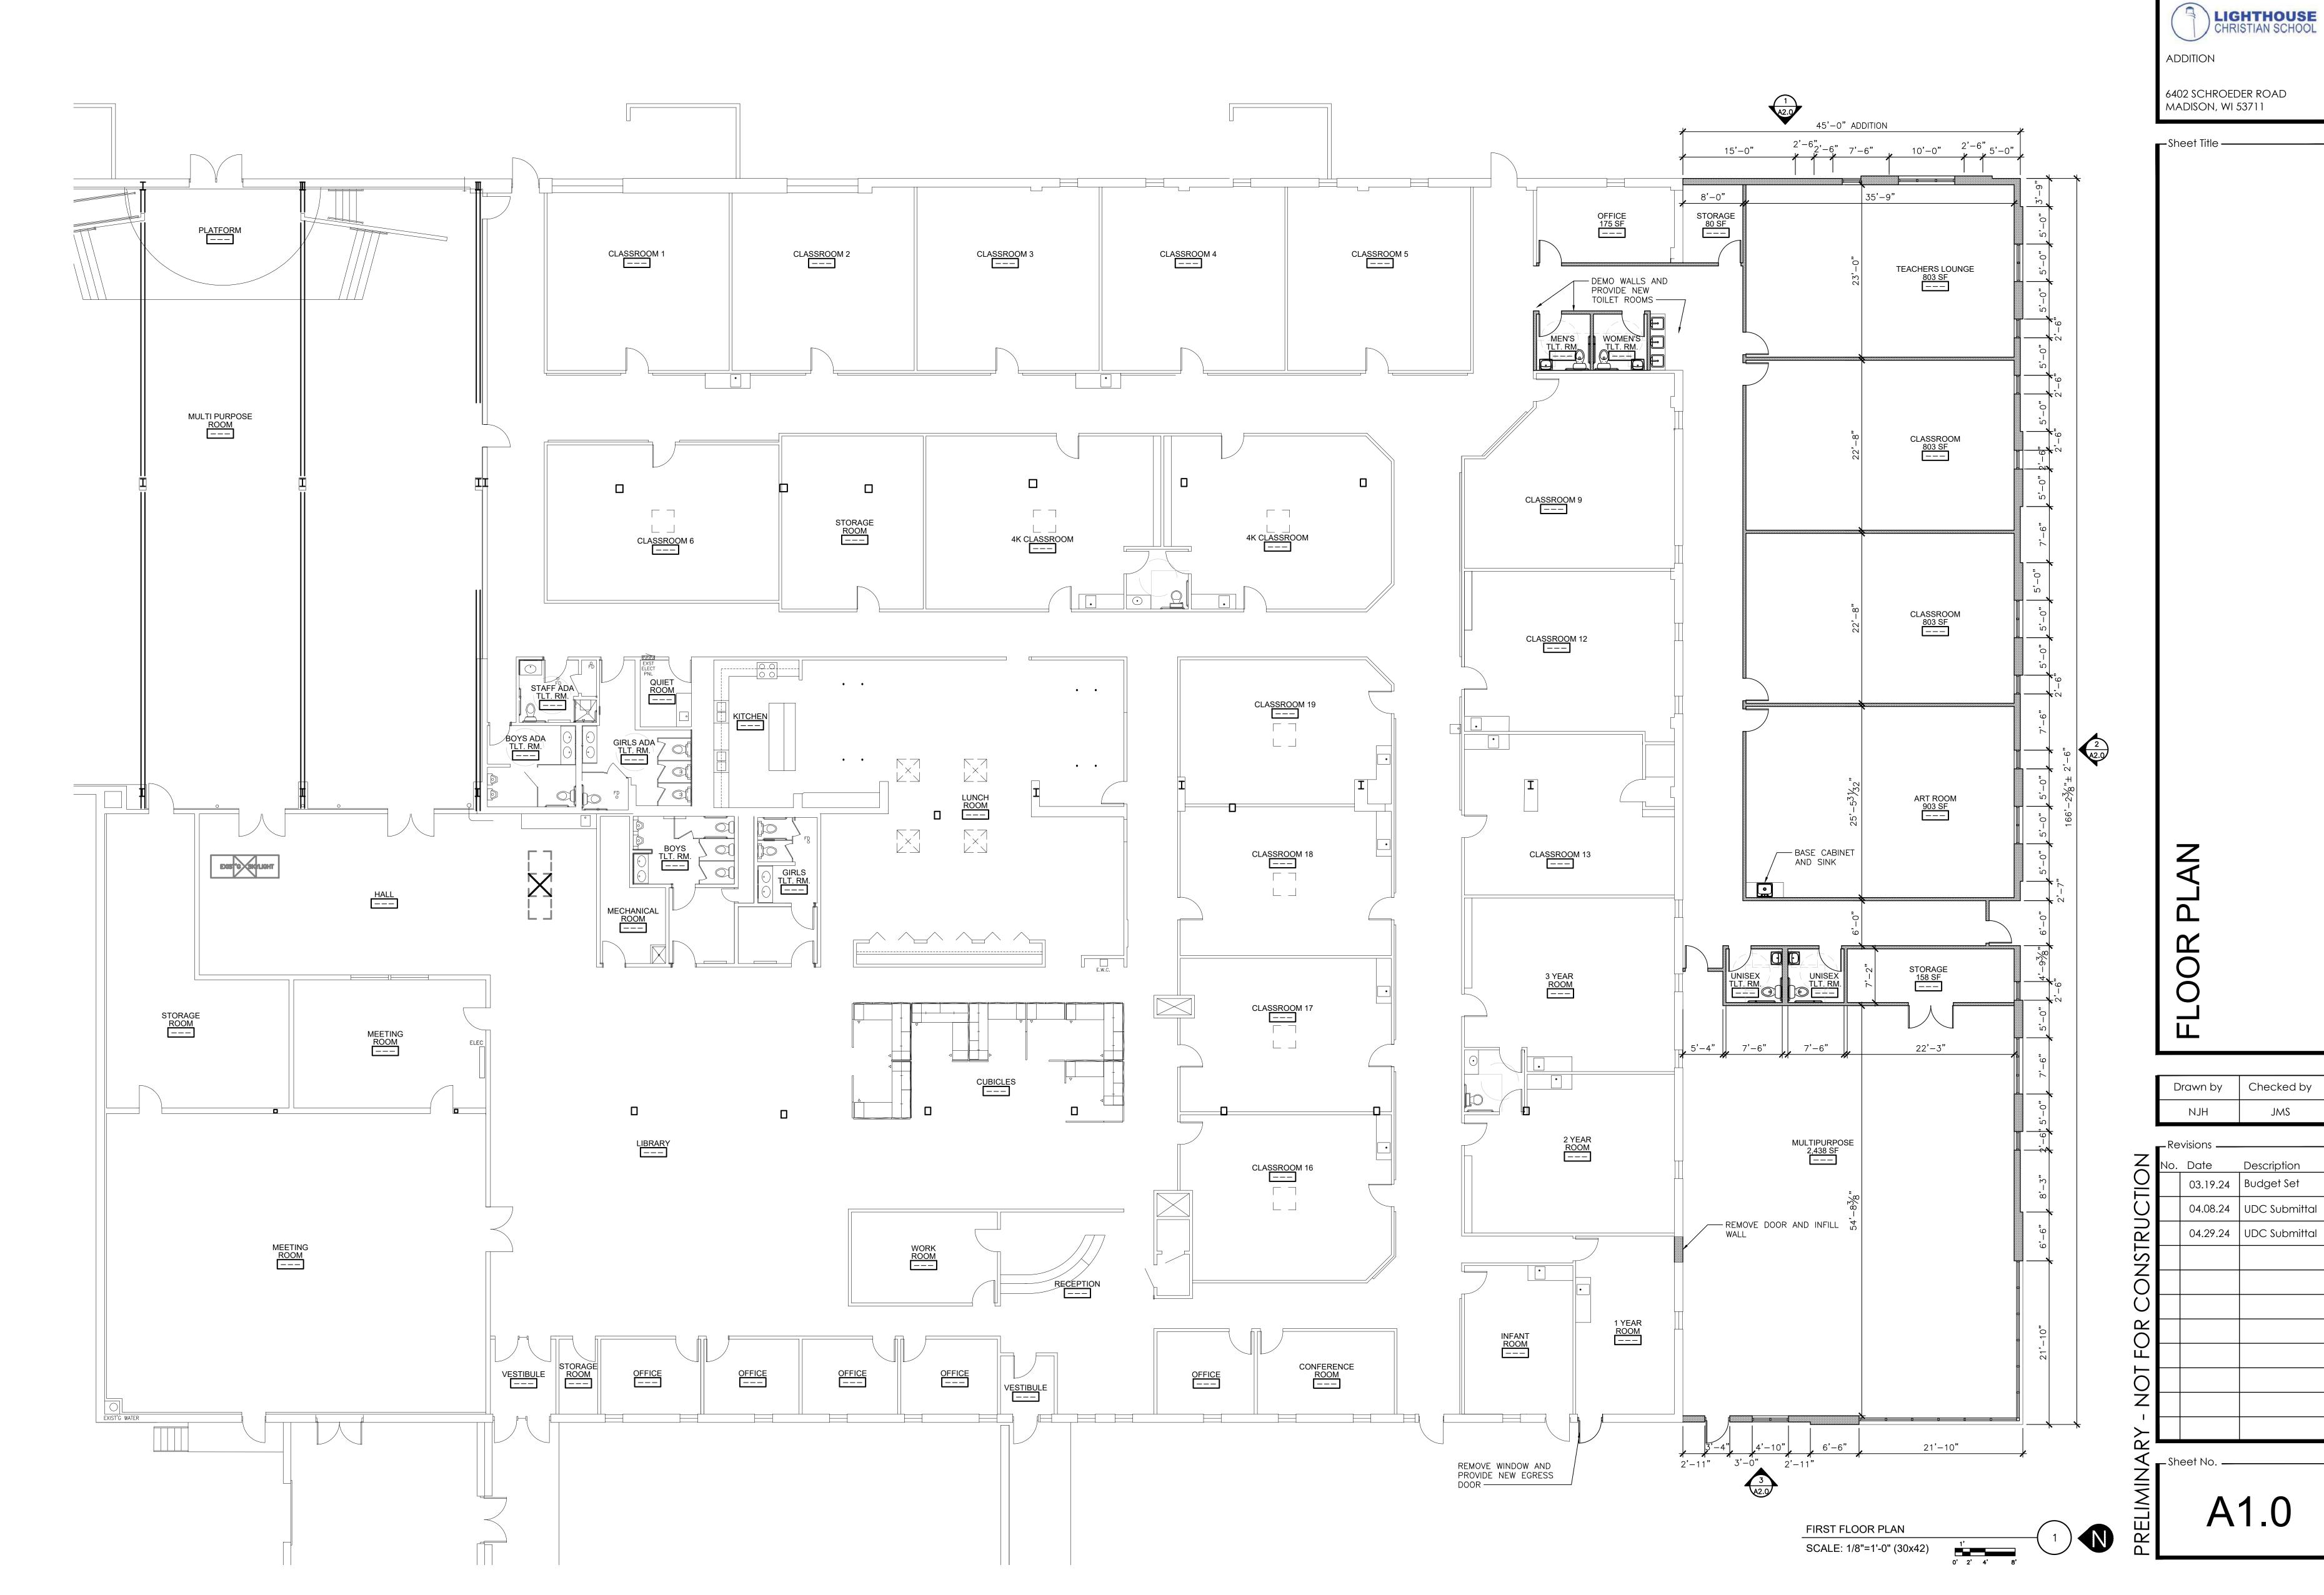





Sheet Title —————

ROOF CONSTRUCTION

- 45 MIL. BALLASTED EPDM

- (2) LAYERS (R-30) EPS INSULATION

PREFINISHED METAL WALL COPING

ROOF OVER

45'-0"ADDITION

ROOF JOISTS SLOPE 1/4"

ROOF DRAIN

SCUPPER

ROOF DRAIN

OVERFLOW DRAIN TO DOWNSPOUT —

PER 1' – SEE STRUCTURAL FOR BEARING ELEVATIONS

> - OVERFLOW DRAIN TO SCUPPER AND

DOWNSPOUT ----

<u>_______</u>

RTU-2 2,200 LBS

TAPERED
INSULATION
ROOF CRICKET

EQUIPMENT SCREENING

FENCE. SEE DETAIL 3/A1.2

22'-2"±

ROOF HATCH, SEE DETAIL 2/A1.2

— TAPERED INSULATION ROOF CRICKET

SCREENING

FENCE. SEE DETAIL 3/A1.2

- MECH. EQUIPMENT

PARTIAL ROOF PLAN

SCALE: 1/8"=1'-0" (30x42)

ROOF JOISTS SLOPE 1/4" PER 1' — SEE STRUCTURAL

OVERFLOW DRAIN TO SCUPPER AND

DOWNSPOUT ----


RTU-2

1,100 LBS


FOR BEARING ELEVATIONS


EXISTING ROOF


| Drawn by | Checked by |
|----------|------------|
| NJH | JMS |
| | |

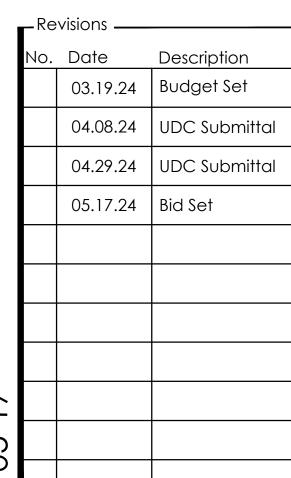


Sheet No. ——

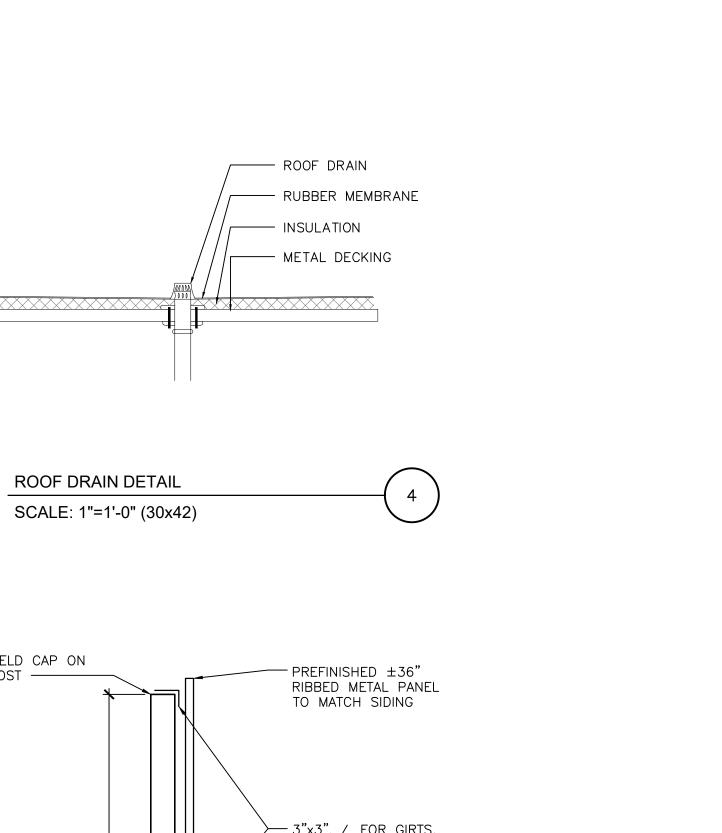

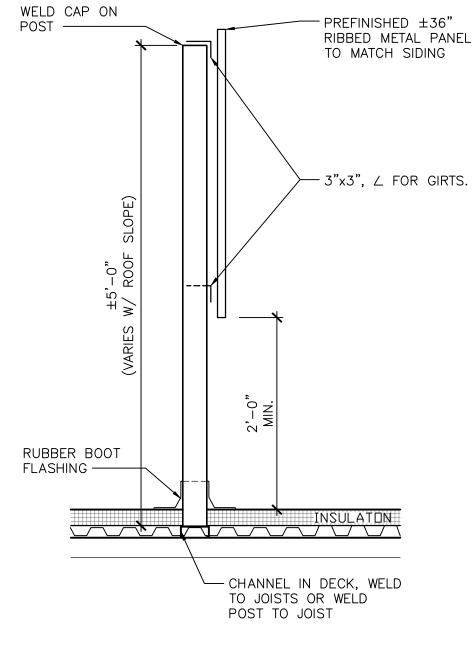

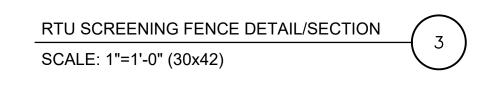

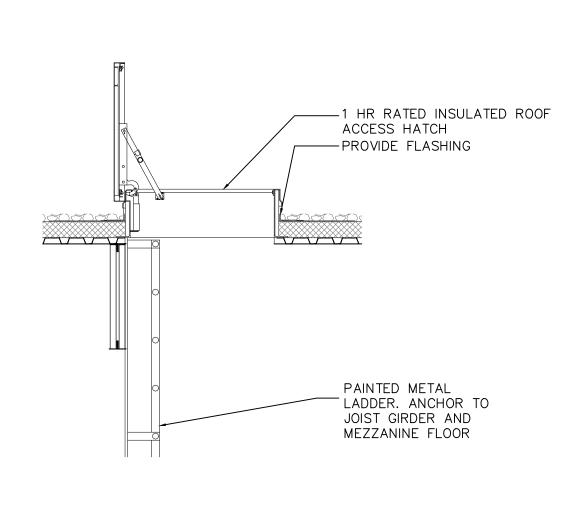

ROOF HATCH/LADDER DETAIL SCALE: 1/2"=1'-0" (30x42)



Architect 259 South Street, Suite A WAUKESHA, WI 53186 p: 833-380-6180 Project Info. — 24025 —


LIGHTHOUSE CHRISTIAN SCHOOL

ADDITION


6402 SCHROEDER ROAD MADISON, WI 53711

Sheet Title ———


EXISTING GOOGLE STREET VIEW - OCT. 2023 SCALE: NTS

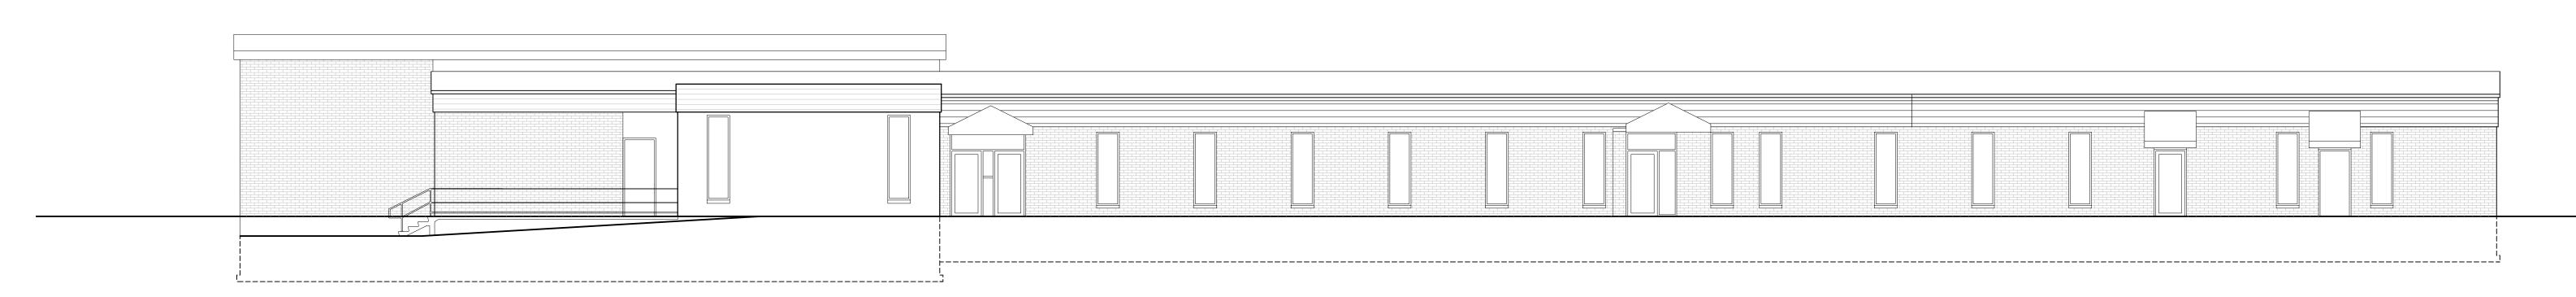

EXISTING WEST ELEVATION - SEE SHEET A2.1 FOR PROPOSED ELEVATIONS / SCALE: 1/8"=1'-0" (30x42)

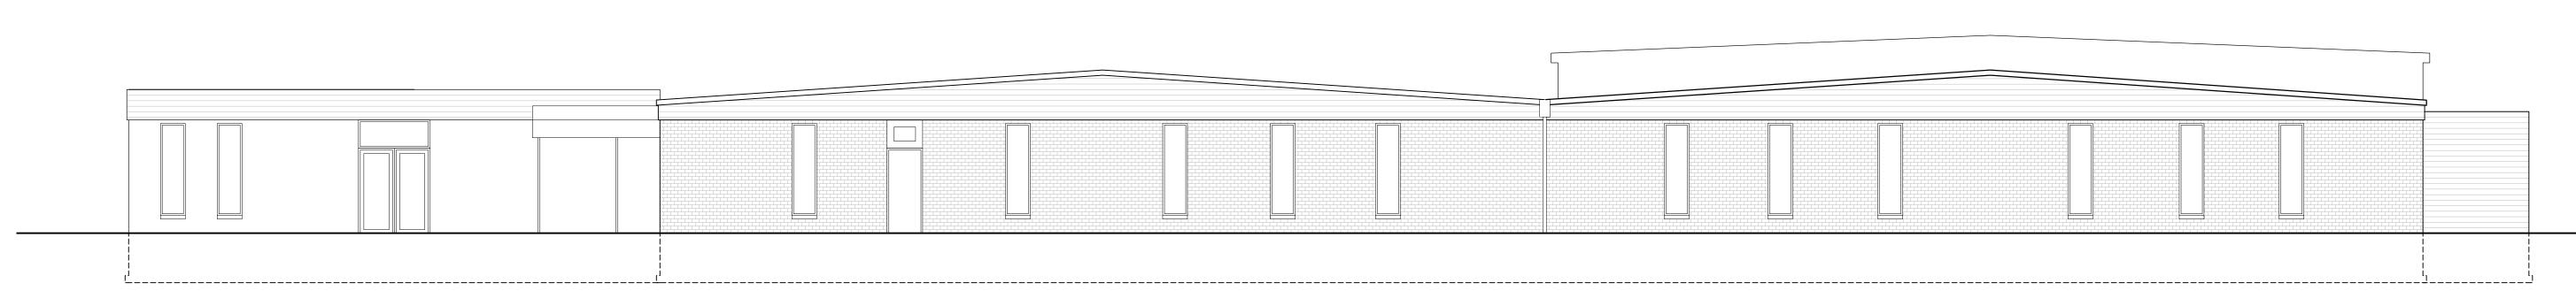

EXISTING SOUTH ELEVATION - SEE SHEET A2.1 FOR PROPOSED ELEVATIONS SCALE: 1/8"=1'-0" (30x42)

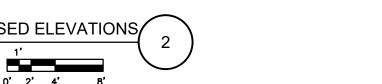

Sheet No. ——

Drawn by Checked by

lo. Date Description

04.08.24 UDC Submittal

04.29.24 UDC Submittal

EXISTING EAST ELEVATION - SEE SHEET A2.1 FOR PROPOSED ELEVATIONS

SCALE: 1/8"=1'-0" (30x42)

BIRD SAFE GLASS ORDINANCE

- PER 28.129(4)(a)2.
 FOR BUILDING FAÇADES WHERE THE FIRST SIXTY (60) FEET FROM GRADE ARE COMPRISED OF LESS
- THAN FIFTY PERCENT (50%) GLASS: a. AT LEAST EIGHTY-FIVE PERCENT (85%) OF THE GLASS ON GLASS AREAS FIFTY (50) SQUARE FEET OR OVER MUST BE TREATÈD; AND
- O. OF ALL GLASS AREAS OVER FIFTY (50) SQUARE FEET, ANY GLASS WITHIN FIFTEEN (15) FEET OF A BÚILDING CORNER MUST BE TREATÉD.

BIRD SAFE GLASS CALCULATIONS

SOUTH ELEVATION AREA = 2,265 S.F. SOUTH ELEVATION WINDOW AREA = 327.5 S.F.

EAST ELEVATION AREA = 590 S.F. EAST ELEVATION WINDOW AREA = 51 S.F.

WEST ELEVATION AREA = 669 S.F. WEST ELEVATION WINDOW AREA = 135 S.F.

TYP. WINDOW AREA (SINGLE) = 13 S.f.TYP. WINDOW AREA (PAIR OF WINDOWS) = 25.5 S.F. TYP. WINDOW AREA (3 SETS OF WINDOWS) = 38.2 S.F.

PROVIDING BIRD SAFE GLAZING AT SWC CLUSTER OF

| ELEVATION KEYNOTES

- $\langle 1 \rangle$ METAL PANEL SIDING = PAC-CLAD HIGHLINE B2, COLOR- STONE WHITE
- METAL PANEL SIDING = PAC-CLAD HIGHLINE S2, COLOR PACIFIC BLUE
- COMPOSITE SIDING = AZEK TIMBERTECH CLOSED JOINT SIDING, COLOR ENGLISH WALNUT.
- 4 ALUMINUM STOREFRONT, COLOR DARK BRONZE.

EXISTING BUILDING BEYOND

EXISTING BUILDING

4
5
7
3

ADDITION

TOP OF WALL

FIN. FLR. EL. 100'-0" (1027.59')

- 5 1" INSULATED, CLEAR, LOW-E GLAZING
- 6 1" INSULATED, CLEAR, LOW-E GLAZING W/ BIRD SAFE FILM/PATTERN
- 7 1" INSULATED ALUMINUM PANEL. VARIOUS COLORS TO MATCH PAC-CLAD // INTERSTATE BLUE, BONE WHITE, AND BERKSHIRE BLUE.
- $\langle 8 \rangle$ PRE-FINISHED METAL COPING. COLOR TO MATCH WALL (BELOW) COLOR.
- ALUMINUM STOREFRONT DOOR AND TRANSOM WINDOW. COLOR DARK 9 BRONZE w/ 1" INSULATED, CLEAR, LOW-E GLAZING
- 10 Existing building No change to materials
- METAL PANEL RTU SCREENING = PAC-CLAD HIGHLINE MI, COLOR STONE WHITE
- PARAPET WALL w/COPING WHERE ADDITION MEETS EXISTING ROOF LINE.
 WALL TO FOLLOW EXISTING ROOF SLOPE, 12" ABOVE EXISTING
- (13) EXISTING WOOD MECHANICAL SCREENING FENCES TO REMAIN




Architect 259 South Street, Suite A WAUKESHA, WI 53186 p: 833-380-6180

Project Info. — 24025 − LIGHTHOUSE CHRISTIAN SCHOOL

ADDITION

6402 SCHROEDER ROAD Madison, WI 53711

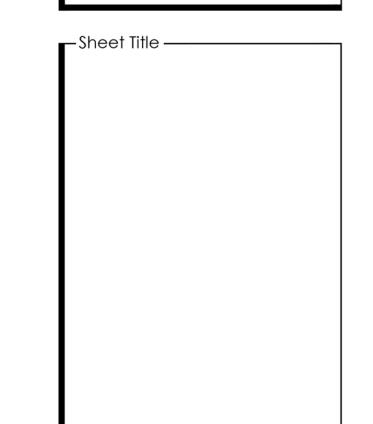

EXISTING BEYOND

| Drawn by | Checked by |
|----------|------------|
| NJH | SML |

■ Revisions —— No. Date Description 03.19.24 Budget Set 04.08.24 UDC Submittal 04.29.24 UDC Submittal 05.17.24 Bid Set △ 05.29.24 UDC Submittal

_Sheet No. ___

EAST ELEVATION SCALE: 1/8"=1'-0" (30x42)

ADDITION

WEST ELEVATION

SOUTH ELEVATION

SCALE: 1/8"=1'-0" (30x42)

SCALE: 1/8"=1'-0" (30x42)

EXISTING BUILDING

 $4\sqrt{5}\sqrt{7}\sqrt{3}$

ADDITION

WINDOW AREA LESS THAN 50% OF FACADE

WINDOWS ON SOUTH AND WEST FACADE PER ORDINANCE







ADDITION

6402 SCHROEDER ROAD MADISON, WI 53711


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PERSPECTIVE RENDERING VIEW FROM SW N.T.S.



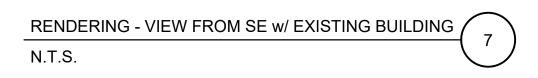

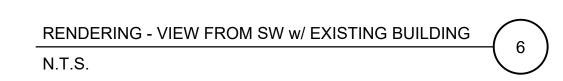

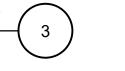

PERSPECTIVE RENDERING VIEW FROM SE







PERSPECTIVE RENDERING VIEW FROM SW - SCHROEDER AND LAURIE

N.T.S.

Drawn by Checked by NJH JMS

Revisions

No. Date Description

No. Date Description

O3.19.24 Budget Set

O4.08.24 UDC Submittal

O4.29.24 UDC Submittal

—Sheet No. ——

A9.0

BONE WHITE



STONE WHITE



TIMBERTECH® CLADDING



INSULATED ALUMINUM WINDOW INFILL PANELS ELEVATION KEYNOTE 7

Vitro Architectural Glass

Product Data Sheet



Aesthetic Description

Solarban® 70 glass (formerly Solarban® 70XL glass) is a solar control, low-e glass that brilliantly combines the clear appearance of transparent, color-neutral glass with an exceptional combination of solar control and visible light transmittance (VLT), The world's first triple-silver, magnetron sputter vacuum


deposition (MSVD) coating, Solarban® 70 glass expands the design possibilities for buildings in two important ways. First, Solarban* 70 glass enables architects to incorporate vast areas of vision glass into their designs without a corresponding increase in cooling equipment capacity.

Second, architects can specify a clear aesthetic while achieving solar control performance that was once attainable only through the use of tinted glass and a solar control, low-e coating in an insulated glass unit (IGU).

Performance Options

When coupled with conventional clear glass in a one-inch IGU, Solarban* 70 glass achieves a Visible Light Transmittance (VLT of 64 percent and a Solar Heat Gain Coefficient (SHGC) of 0.27 to produce a Light to Solar Gain (LSG) ratio of 2.37, making it one of the industry's highest-performing glasses.

The clear aesthetic of Solarban® 70 glass also makes the product exceptionally versatile, offering architects an extensive array of performance and appearance options. For instance, for projects that require advanced solar control performance, Solarban" 70 glass can be coated on the second (#2) surface of nearly all of

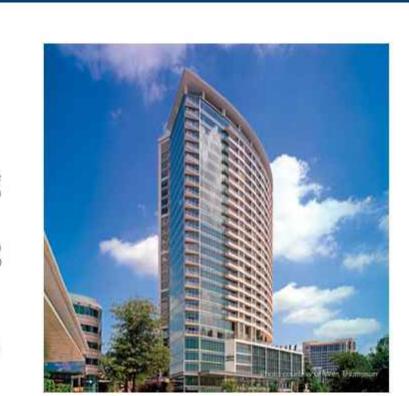


Location: Dallas, TX | Product: Solarbon® 70XL Glass | Architect of Record: PageSoutherlandPage | Design Architect: Gromatzky Dupree & Associates | Glass Fabricator: Trulite Glass and Aluminum Solutions | Glazing Contractor: Haley-Green

Vitro Architectural Glass' (formerly PPG glass) wide range of tinted glasses to produce SHGCs as low as 0.19 and LSG ratios ranging from 1.68 to 2.15.


For more color and reflectivity choices, Solarban® 70 glass may be specified on the third (#3) surface of an IGU behind a tinted lite or in combination with Solarcool® reflective or Vistacool® subtly reflective color-enhanced glasses.



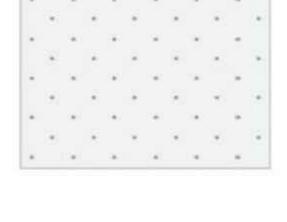


1" - INSULATED, LOW-E GLAZING & BIRD GLAZING ELEVATION KEYNOTES 5 & 6




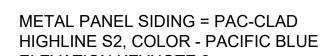


15.356" NOMINAL

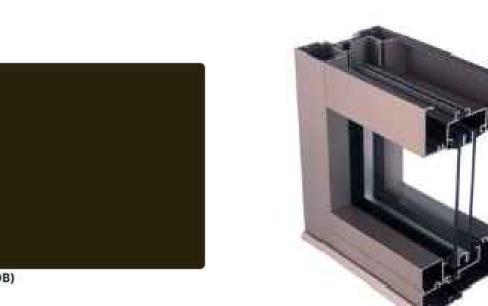





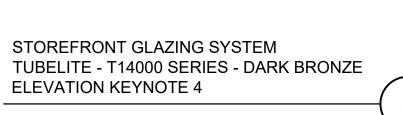



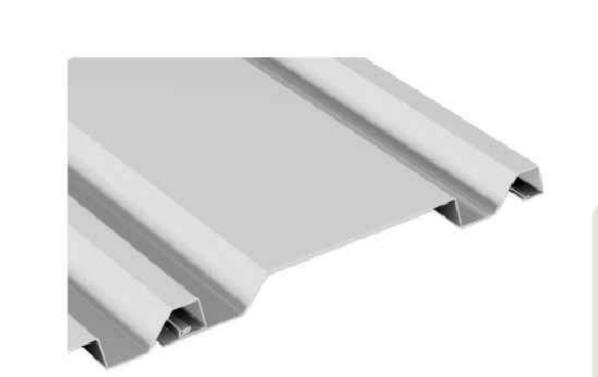


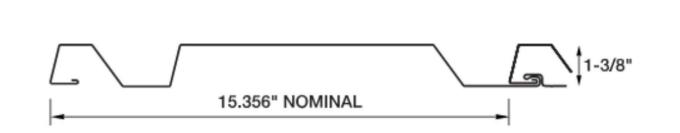

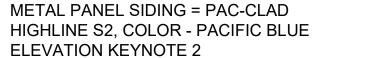

1-3/8"



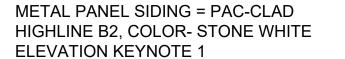

English Walnut

AZEK TIMBERTECH CLOSED JOINT SIDING

COLOR - ENGLISH WALNUT

ELEVATION KEYNOTE 3



PProject Info. — 24025 —

ADDITION

6402 SCHROEDER ROAD MADISON, WI 53711

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_Revisions ____ o. Date Description 03.19.24 Budget Set 04.08.24 | UDC Submittal 04.29.24 UDC Submittal

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