



# UW HEALTH: EAST MADISON HOSPITAL PHASE 1 EXPANSION


Client Logo

Client Project Number  
**53150**

Flad Project Number  
**24764-00**

**4602 EASTPARK BLVD.  
MADISON, WI 53718**

Project Location

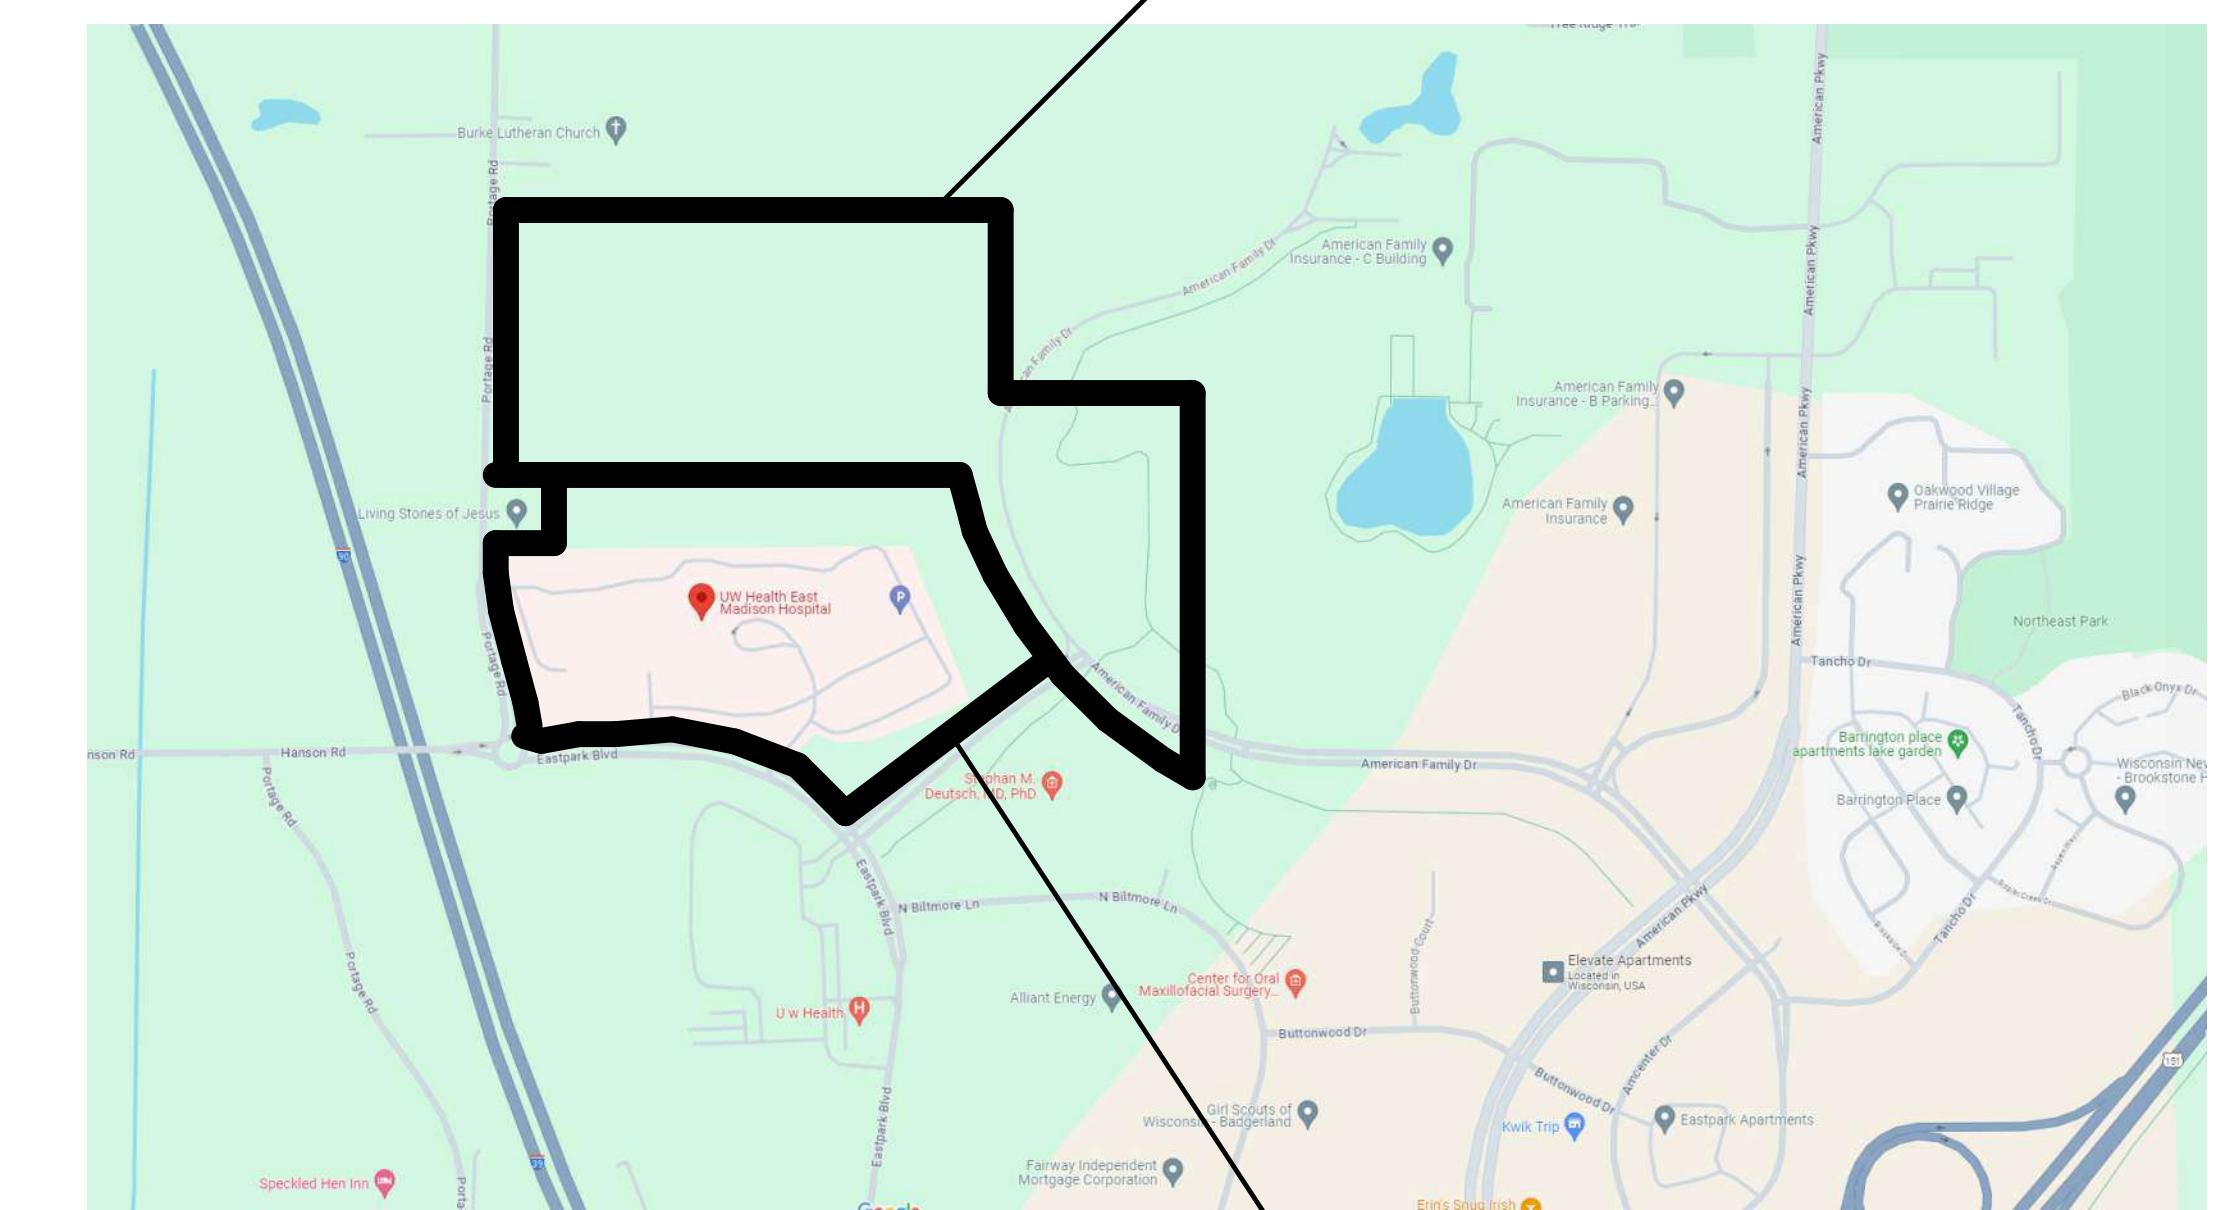

Site Key Plan - Location Plan

Date  
**08/07/24**

Description of Package  
**LAND USE APPLICATION - PLANS ARCHITECTURAL  
General**

Optional Project Info

Project Image - Rendering

Optional Project Info

Architect



Flad & Associates, Inc.  
644 Science Drive  
Madison, WI 53711  
Tel 608-238-2601  
Fax 608-238-6727  
Flad.com

Civil Engineer



Ruekert & Mielke, Inc.  
4630 S Blumore Lane  
Madison, WI 53718  
Tel 608-819-2600  
ruekertmielke.com/  
Flad.com

Structural Engineer



Flad & Associates, Inc.  
644 Science Drive  
Madison, WI 53711  
Tel 608-238-2601  
Fax 608-238-6727  
Flad.com

MEP Engineer



Affiliated Engineers, Inc.  
5802 Research Park Blvd.  
Madison, WI 53719  
Tel 608-238-2601  
aeieng.com

Medical Equipment Planner



Walsh Consulting Group, Inc.  
1275 Milwaukee Avenue  
Glenview, IL 60025  
Tel 847-699-2500  
Fax 847-699-2524  
wcg-inc.com

General Contractor



Findorff  
300 S. Bedford Street  
Madison, WI 53703  
Tel 608-257-5321  
findorff.com/

Consultant

Stamps & Approvals

Project Regulatory Data

Volume Index

Project:	By Project	Building Type:	By Project
Location:	By Project	Sprinklers:	By Project
Owner:	By Project	Zoning:	By Project
Building Code:	By Project	Accessibility Requirements:	By Project
Occupancy:	By Project	Governing Agency or Authority:	By Project

Volume 1 - Civil and Landscape  
Volume 2 - Site Plan  
Volume 3 - Architectural and Medical Equipment  
Volume 4 - Fire Protection, Plumbing, and Med Gas  
Volume 5 - Mechanical  
Volume 6 - Electrical and Technology





AviProtek®  
Bird Friendly Glass

GLAZING SPECIFICATION WITH BIRD SAFE PATTERN

1. 1/8" thickness : 1mm  
Type GL4 - Insulating Glass Units: Clear and Spandrel  
1. Basis of Design: Vitro Architectural Glass: [www.vitroglazings.com](http://www.vitroglazings.com).

b. Outboard Lite: Vitro Acidly low iron, 1/4 inch thick, minimum.  
1. Product: AviProtek® pattern 215 on surface #1.

2. Inboard Lite: Annealed float glass, 1/4 inch thick, minimum.

XT.3 EXCLUSIV  
BIRD FRIENDLY ACID-ETCHED GLASS

IMPORTANT NOTE

This document has precedence over information published in other Walker print or digital material



AviProtek®  
Bird Friendly Glass

ORDERING GUIDELINES

All orders should include the following product information:  
 • AviProtek® pattern number, if applicable  
 • Low-E coating number of Vitro Architectural Glass Solartite® glass product, if applicable  
 • Glass substrate (clear, Starphire Ultra-Clear®, Solargray® & Solarbronze®)  
 • Glass thickness  
 • Stock sheet size  
 • Tempering of low-iron glass is highly recommended to correct slight color variances caused by the manufacturing processes. Walker is not responsible for said color variances if the low-iron glass is not tempered.

SAMPLES

Samples may be ordered as follows:  
 • Walker Textured® AviProtek® sample kit  
 • 12" x 12" monolithic samples in selected substrates and thicknesses  
 • 12" x 12" double glazed samples in selected substrates  
 • Mock up of selected projects

AviProtek® E Samples  
 • 12" x 12" monolithic or insulated glass unit samples are available on demand for a selection of glass substrates. Please contact customer service to confirm availability.

PATTERN DIRECTION ON STOCK SHEET 96" X 130"

• All directional patterns are available along the 96" or the 130" side

CUSTOM PATTERNS

Custom patterns meeting bird friendly standards are also available on demand (except AviProtek® T).



AviProtek®  
Bird Friendly Glass

PROPERTIES AND PERFORMANCE CHARACTERISTICS

Stock sheets of all Walker® Textured® and AviProtek® are etched over the entire surface, except for a 1" unusable border on all four sides of our stock etched products with the exception of the Vitro finish with a 3/4" unusable border. Variations in opacity within a sheet will be indistinctive to the naked eye when viewed under normal conditions.

The AviProtek® surface (except AviProtek® T) does not have any significant impact on the light and performance values of an insulated unit. Therefore, values will be similar to units without patterned acid-etched glass.

For complete glass performance data of a one-inch insulating glass unit with Solarban® 60VT or 70VT solar control glass, please contact Vitro Architectural Glass Customer Service Department.

The performance data of AviProtek® T is as follows:

TABLE A1 AVIOPROTEK® T LIGHT & ENERGY PERFORMANCE VALUES									
Sheet	Insulation Thickness	Thickness	Low-E	Visible Light					
1	1/4"	1/4"		80%	80%	80%	80%	80%	80%
2	1/4"	1/4"		80%	80%	80%	80%	80%	80%
3	1/4"	1/4"		80%	80%	80%	80%	80%	80%

Notes:  
 1. Figures may vary due to the manufacturing tolerance. All insulation data is based on NPIC methodology using the URLA Window 3.2 program.  
 2. Visible light transmission is measured at 550 nm. Visible light reflectance is measured at 550 nm. Visible light transmittance is measured at 550 nm.  
 3. Shading coefficient is the ratio of the amount of solar energy absorbed through a glass versus 1.00 ft² of glass under the same design conditions. It is measured at 1000 W/m² solar insolation at 40° angle of incidence. Shading coefficient is determined by the following formula:  
 Shading coefficient = (Visible light transmittance) / (Visible light reflectance) \* (Visible light transmittance) + (Visible light reflectance)  
 4. Solar Heat Gain Coefficient (SHGC) measures the solar heat gain through the glass related to the incident solar radiation. It is equal to 0.0% of the shading coefficient.

.../...



AviProtek®  
Bird Friendly Glass

LIMITED WARRANTY FOR AVIOPROTEK® T

Walker Glass Co. Ltd. hereby warrants that, with proper handling and maintenance, the applied coating will not peel under normal conditions for a period of 10 years following the date of purchase. Walker further warrants that the applied coating will not become discolored or change in appearance during the period of the coating that will not diminish under normal conditions for a period of 10 years following the date of purchase.

In the event of any claim under this warranty, Walker must be notified in writing at the address indicated on the original invoice. Walker reserves the right to inspect any AVIOPROTEK® T glass alleged to be defective in the location where the defect was first detected. Under this warranty, Walker is limited at Walker's exclusive discretion, to either:

• Walker supplying without charge and F.O.B. Walker's plant, a sufficient quantity of sheets of the size and substrate originally supplied by Walker to replace the AVIOPROTEK® T glass proven to be defective.

• Walker refunding an amount equal to the amount originally charged per square foot for the AVIOPROTEK® T glass times the quantity of square feet of AVIOPROTEK® T glass proven to be defective. Walker's liability shall be limited solely to the cost of the defect under this warranty. In no event shall Walker be liable to any person or entity for indirect, special, incidental or consequential damages or charges for any reason, including but limited to related labor and/or material costs.

Conditions

This Warranty is void under any of the following conditions:

• The AVIOPROTEK® T glass is broken or fractured.

• The surface of the AVIOPROTEK® T glass has been damaged.

• The glass has been subjected to extreme temperatures or installed contrary to Walker's written guidelines.

EXCEPT FOR THE EXPRESS WARRANTY DESCRIBED ABOVE, WALKER NEITHER EXPRESSES NOR IMPLIES ANY OTHER WARRANTIES OF ANY KIND AND NO WARRANTY SHALL BE IMPLIED BY OPERATION OR LAW OR OTHERWISE.

No variation or change from this warranty may be binding upon Walker unless made in writing specifically referring to this Warranty and signed by an officer of Walker.



AviProtek®  
Bird Friendly Glass

GUIDELINES FOR HANDLING, FABRICATION, AND CLEANING (Cont.)

PACKING  
AVIOPROTEK® T glass should be separated from contact with adjacent glass by using paper interleaving or small cork bars around the glass perimeter.

CLEANING AND MAINTENANCE  
Refer to Walker Textured® post installation cleaning guidelines at: <http://www.walkerglass.com/post-page-guidelines-for-handling>



Ruekert-Mielke  
Flad Structural  
ENGINEERS

AEI Affiliated  
Engineers

WALSH  
CONSULTING GROUP

Findorff



AviProtek®  
Bird Friendly Glass

GUIDELINES FOR PRODUCT SELECTION AND ORDERING

PRODUCT SELECTION CRITERIA

Walker Textured® flat surface and AviProtek® patterned acid-etched glass products provide bird collision deterrence.

Product selection should be based on design intent and type of application in conjunction with the performance data outlined below.

The Walker Textured® bird friendly program offers 3 different options:

• AviProtek® E: Acid-etched markers on the outside surface

• AviProtek® E: Acid-etched markers on the outside surface with Vitro® Architectural Glass solar control Low-E coating on position 2

• AviProtek® T: Transparent UV markers on the outside surface 1 of the glass



AviProtek®  
Bird Friendly Glass

LEED POINTS

LEED credits that can be obtained with Walker Textured® AviProtek® are as follows:

LEED v4.1 requirements for Building Design + Construction (BD+C)  
LEED v4.1 requirements for Interior Design + Construction (ID+C)

Energy and Atmosphere

• Project may use a variety of strategies, including building envelope, of which the glazing is part.

• Available for AviProtek® E low-e coated glass

Materials and Resources

Building Product Disclosure and Optimization

• Product Disclosure (under our EPD)

Indoor Environmental Quality

• Low-Emitting Materials

• Thermal Comfort available for AviProtek® E low-e coated glass

Innovation

• Bird Collision Deterrence

The following documents covering Walker Textured® AviProtek® products are available on demand:

• EPD - Environmental Product Declaration

• HPPD - Health Product Declaration

To request a copy of the above-mentioned documents or for more information please contact your sales representative or our customer service department.

Environmental Data Sheet

The Environmental data sheet is a shortened version of the EPD and is available here: <http://www.uwaffiliates.com/documents/sustainable-materials>



AviProtek®  
Bird Friendly Glass

PROPERTIES AND PERFORMANCE CHARACTERISTICS (Cont.)

TABLE A2  
AVIOPROTEK® PATTERN SPECIFICATIONS AND BIRD DETERRENCE DATA


Appliance	Description	Type	Dimensions	Compliance with National Glass Manufacturers Association Bird Deterrence Standard (the percentage of birds that will not land on the glass)		Notes
				100% No birds landed	95% No birds landed	
Autofix® 215	Vertical window	215	30" x 40"	YES	YES	95%
Autofix® 214	Vertical window	214	30" x 40"	YES	YES	95%
Autofix® 213	Vertical window	213	30" x 40"	YES	YES	95%
Autofix® 212	Vertical window	212	30" x 40"	YES	YES	95%
Autofix® 211	Vertical window	211	30" x 40"	YES	YES	95%
Autofix® 210	Vertical window	210	30" x 40"	YES	YES	95%
Autofix® 209	Vertical window	209	30" x 40"	YES	YES	95%
Autofix® 208	Vertical window	208	30" x 40"	YES	YES	95%
Autofix® 207	Vertical window	207	30" x 40"	YES	YES	95%
Autofix® 206	Vertical window	206	30" x 40"	YES	YES	95%
Autofix® 205	Vertical window	205	30" x 40"	YES	YES	95%
Autofix® 204	Vertical window	204	30" x 40"	YES	YES	95%
Autofix® 203	Vertical window	203	30" x 40"	YES	YES	95%
Autofix® 202	Vertical window	202	30" x 40"	YES	YES	95%
Autofix® 201	Vertical window	201	30" x 40"	YES	YES	95%
Autofix® 200	Vertical window	200	30" x 40"	YES	YES	95%
Autofix® 199	Vertical window	199	30" x 40"	YES	YES	95%
Autofix® 198	Vertical window	198	30" x 40"	YES	YES	95%
Autofix® 197	Vertical window	197	30" x 40"	YES	YES	95%
Autofix® 196	Vertical window	196	30" x 40"	YES	YES	95%
Autofix® 195	Vertical window	195	30" x 40"	YES	YES	95%
Autofix® 194	Vertical window	194	30" x 40"	YES	YES	95%
Autofix® 193	Vertical window	193	30" x 40"	YES	YES	95%
Autofix® 192	Vertical window	192	30" x 40"	YES	YES	95%
Autofix® 191	Vertical window	191	30" x 40"	YES</		

Flad


Ruekert-Mielke

Flad Structural  
ENGINEERSAEI Affiliated  
EngineersWALSH  
CONSULTING GROUP


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2 ISOMETRIC - SE

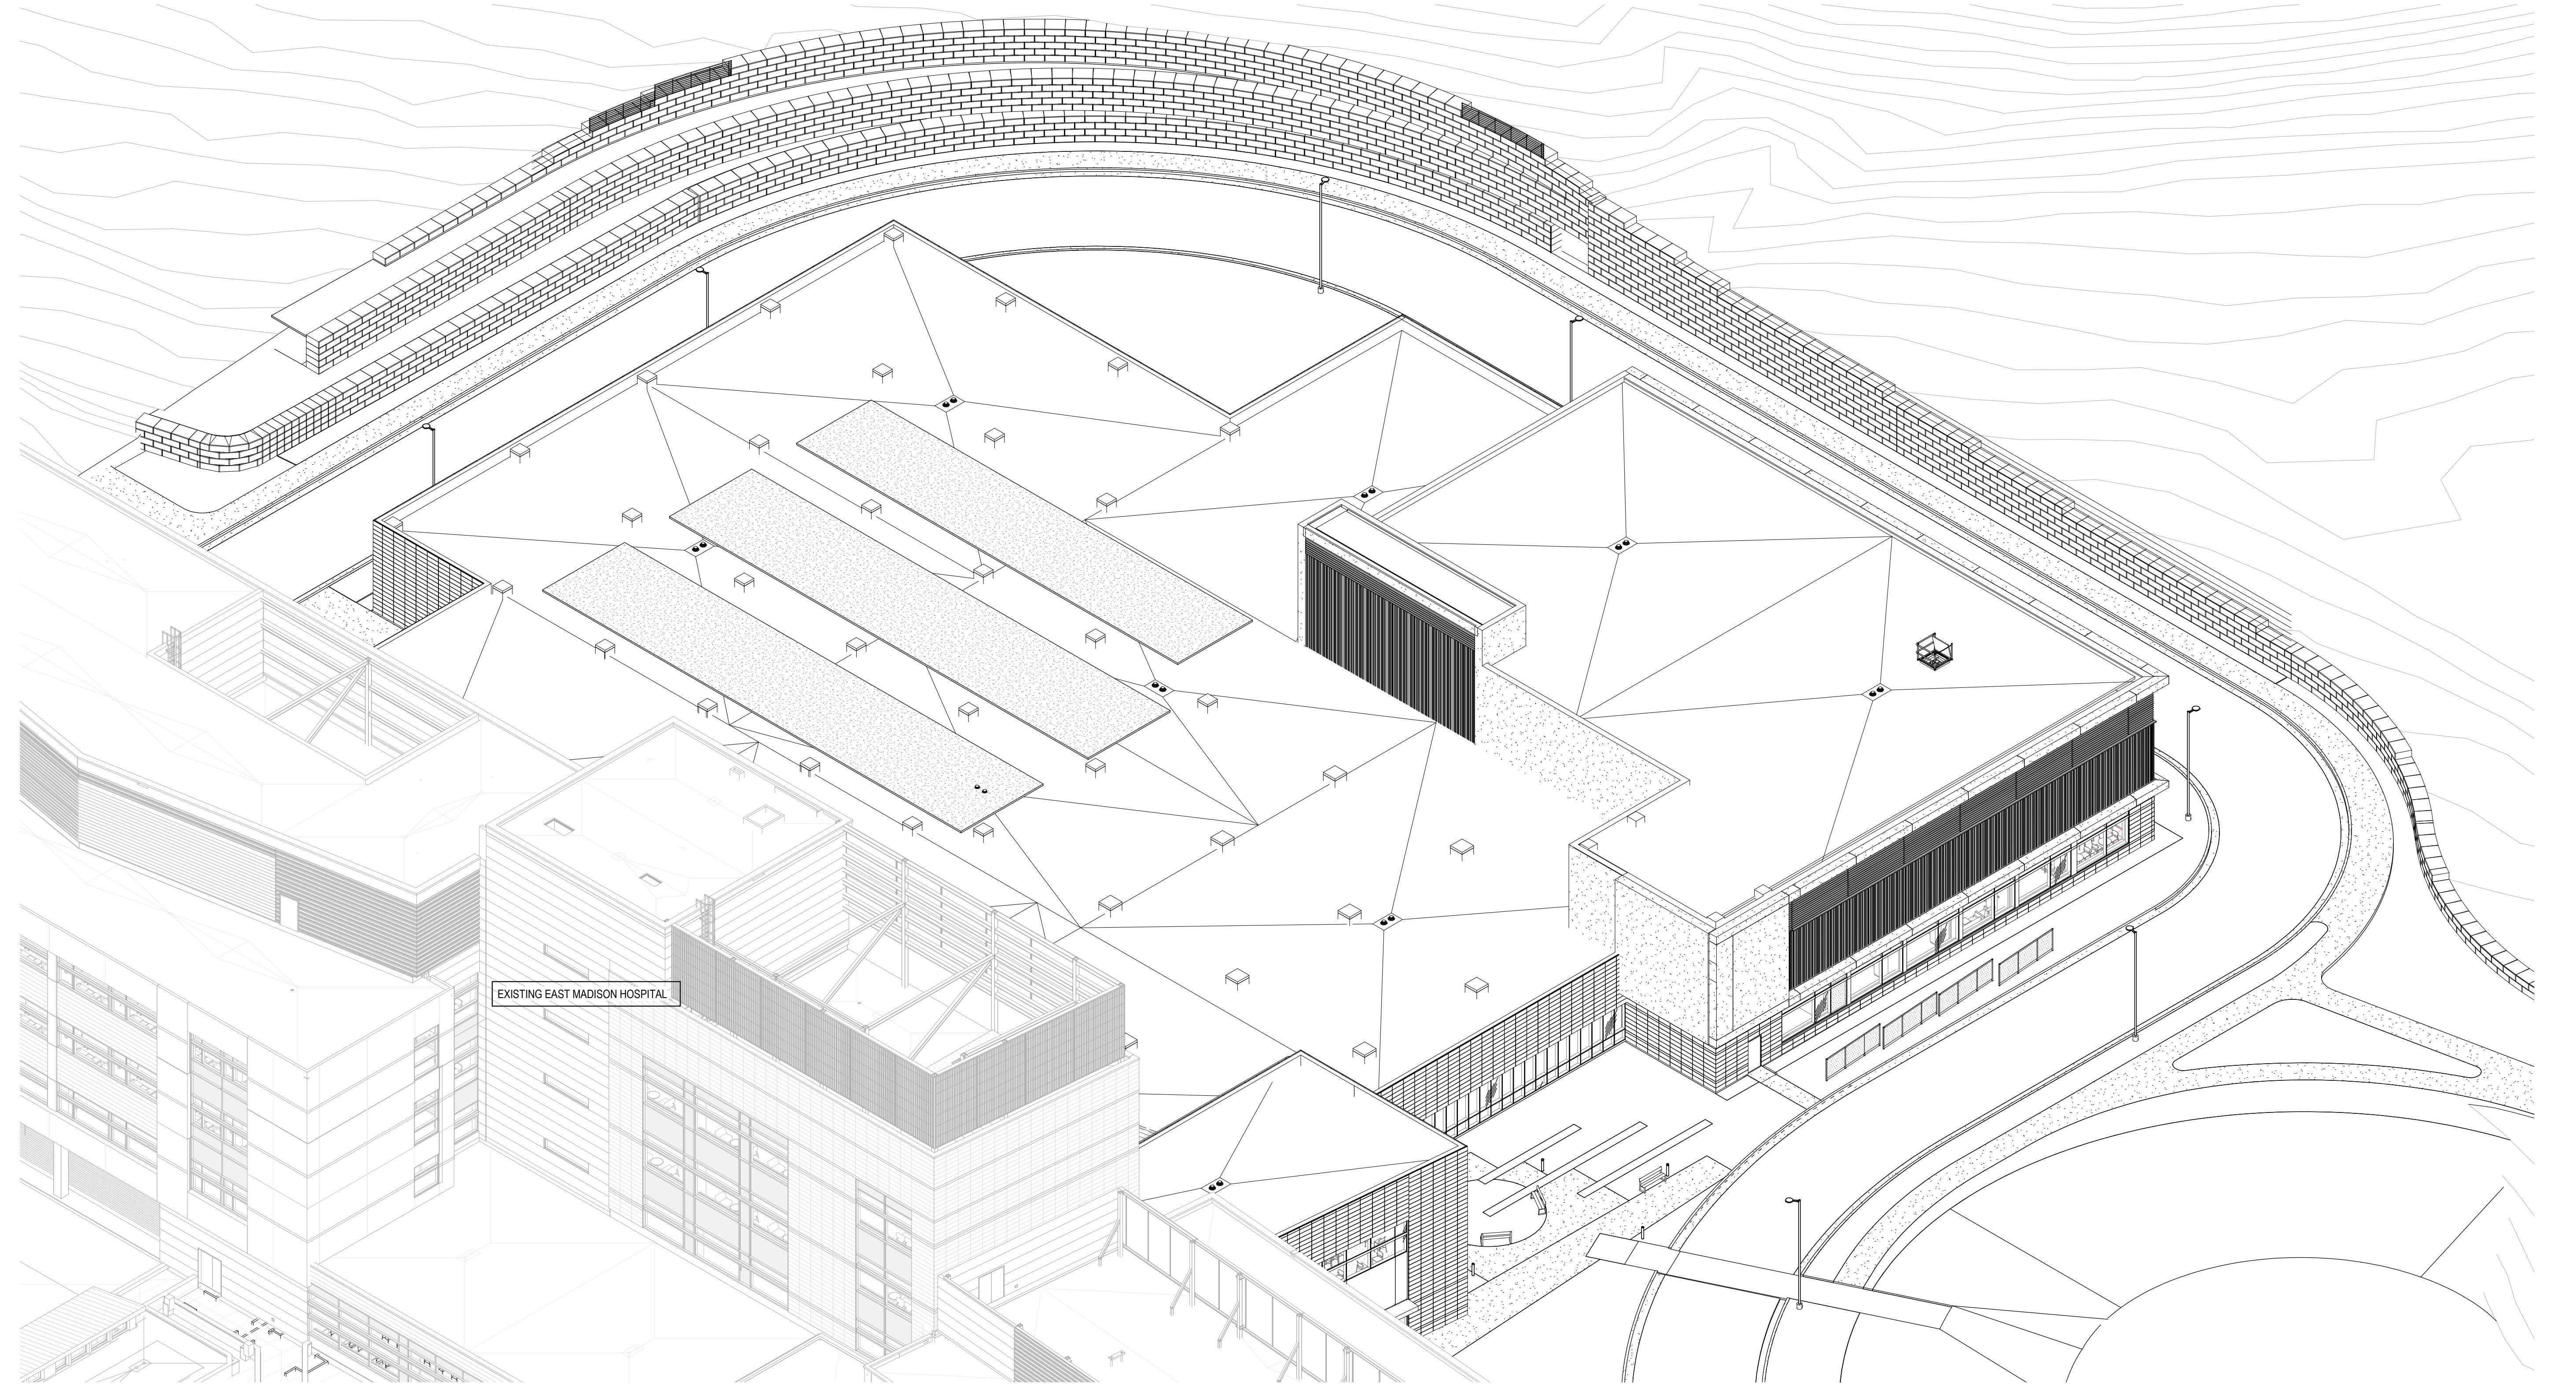

1 ISOMETRIC - NE

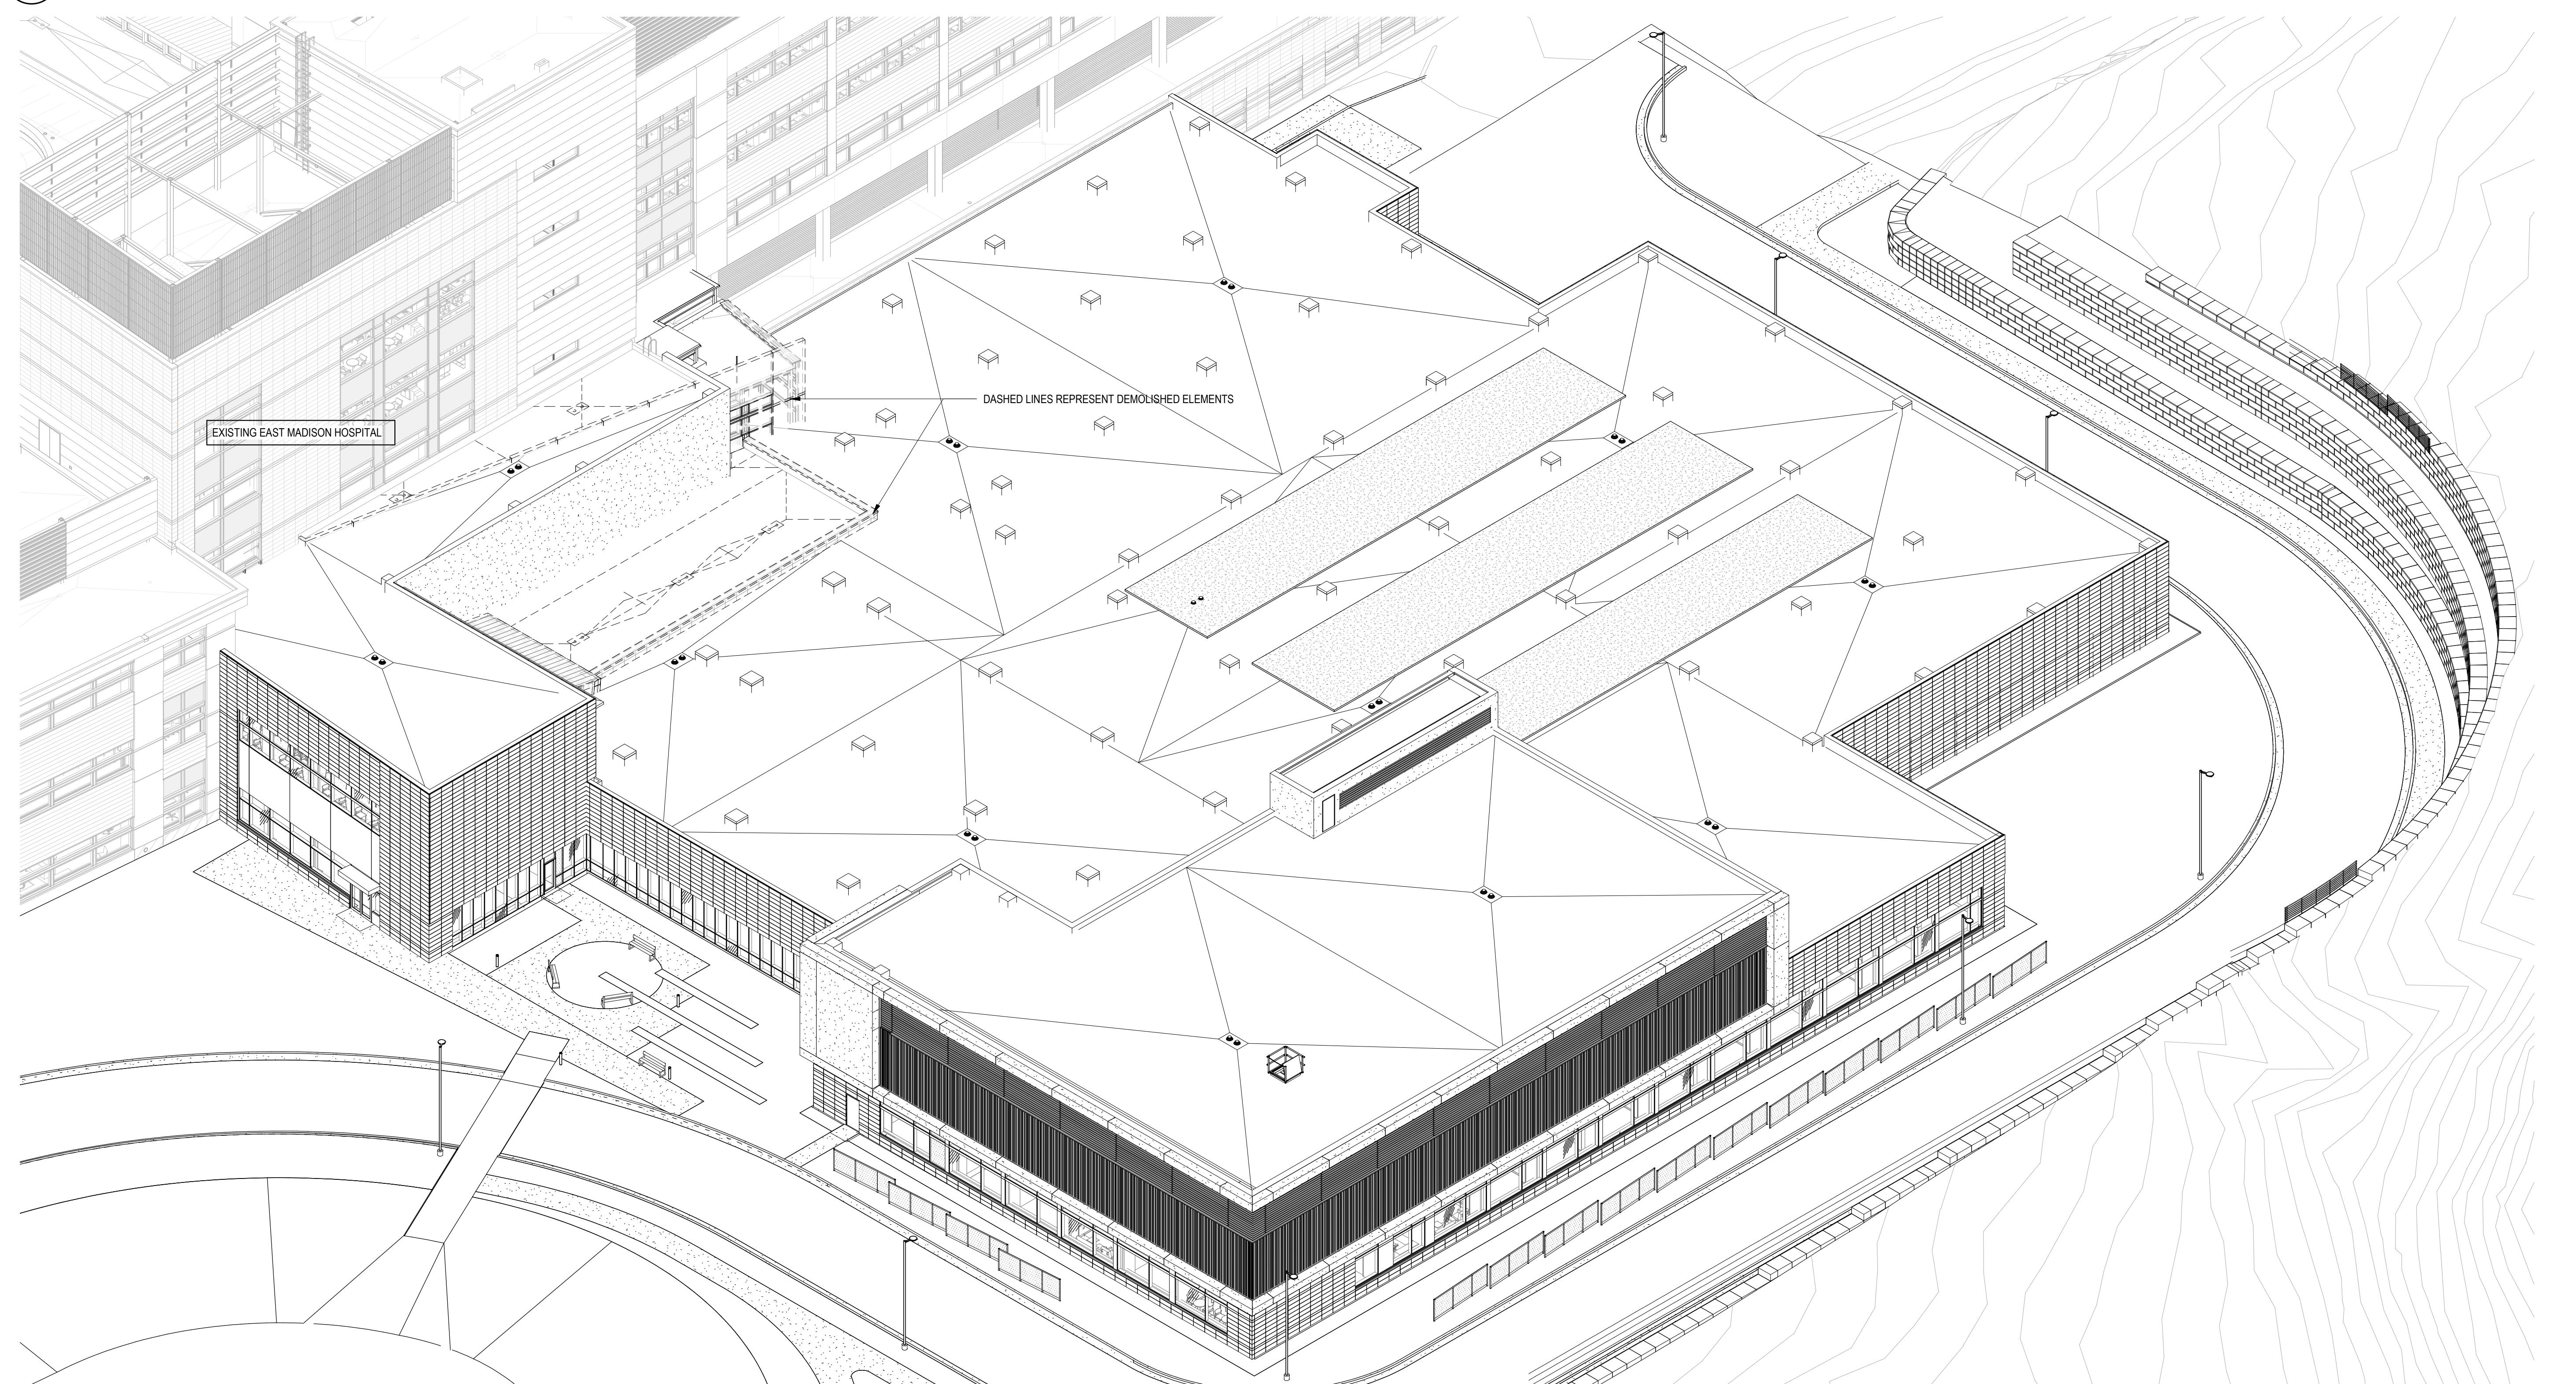

**NOT FOR  
CONSTRUCTION**

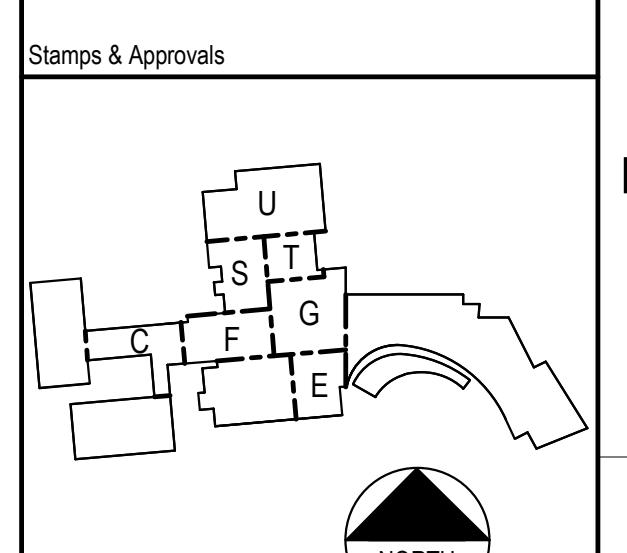Rev. Date Description  
Project Title

UWHealth

**UW HEALTH:  
EAST MADISON  
HOSPITAL**

4602 EASTPARK BLVD.  
MADISON, WI 53718

**PHASE 1  
EXPANSION**

Project Phase  
LAND USE APPLICATION  
Date  
08/07/24  
Drawn By  
FLAD

Project Number  
24764-00  
Checked By  
FLAD

Sheet Title  
**3D REPRESENTATION  
SE/NE**

Sheet Number  
**A-010**


Rev. No.

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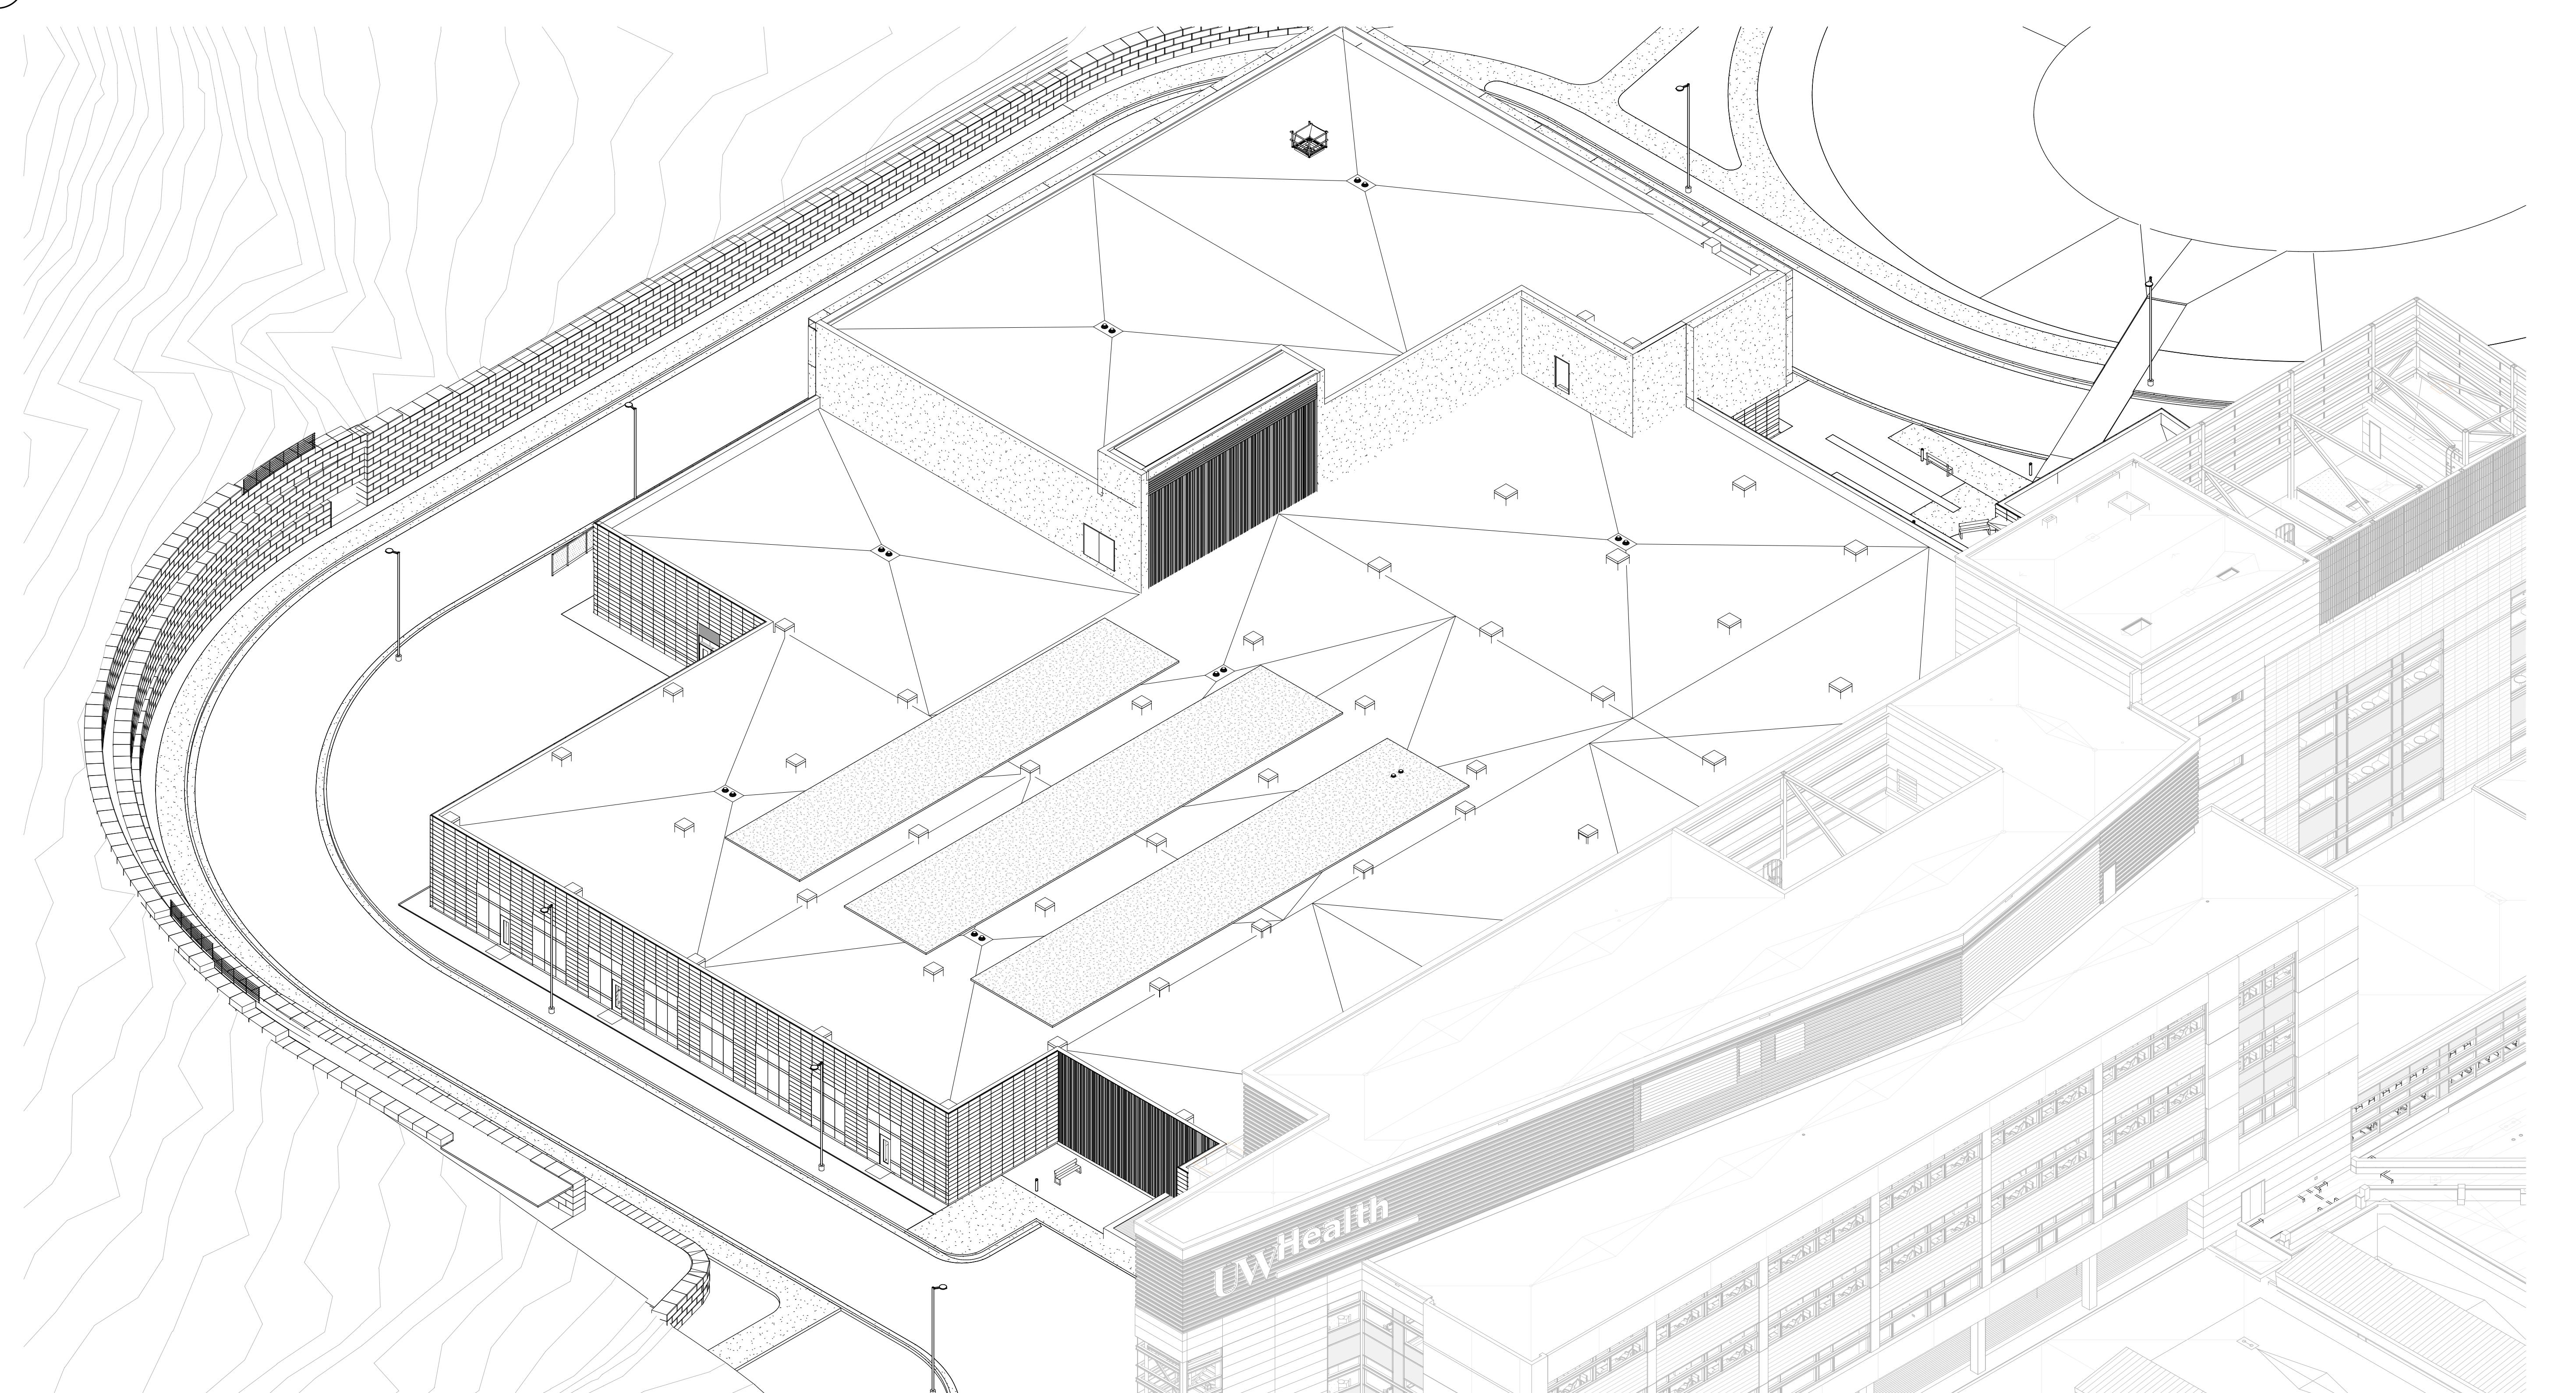
Ruekert-Mielke

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ENGINEERSAEI Affiliated  
EngineersWALSH  
CONSULTING GROUP


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2 ISOMETRIC - NW

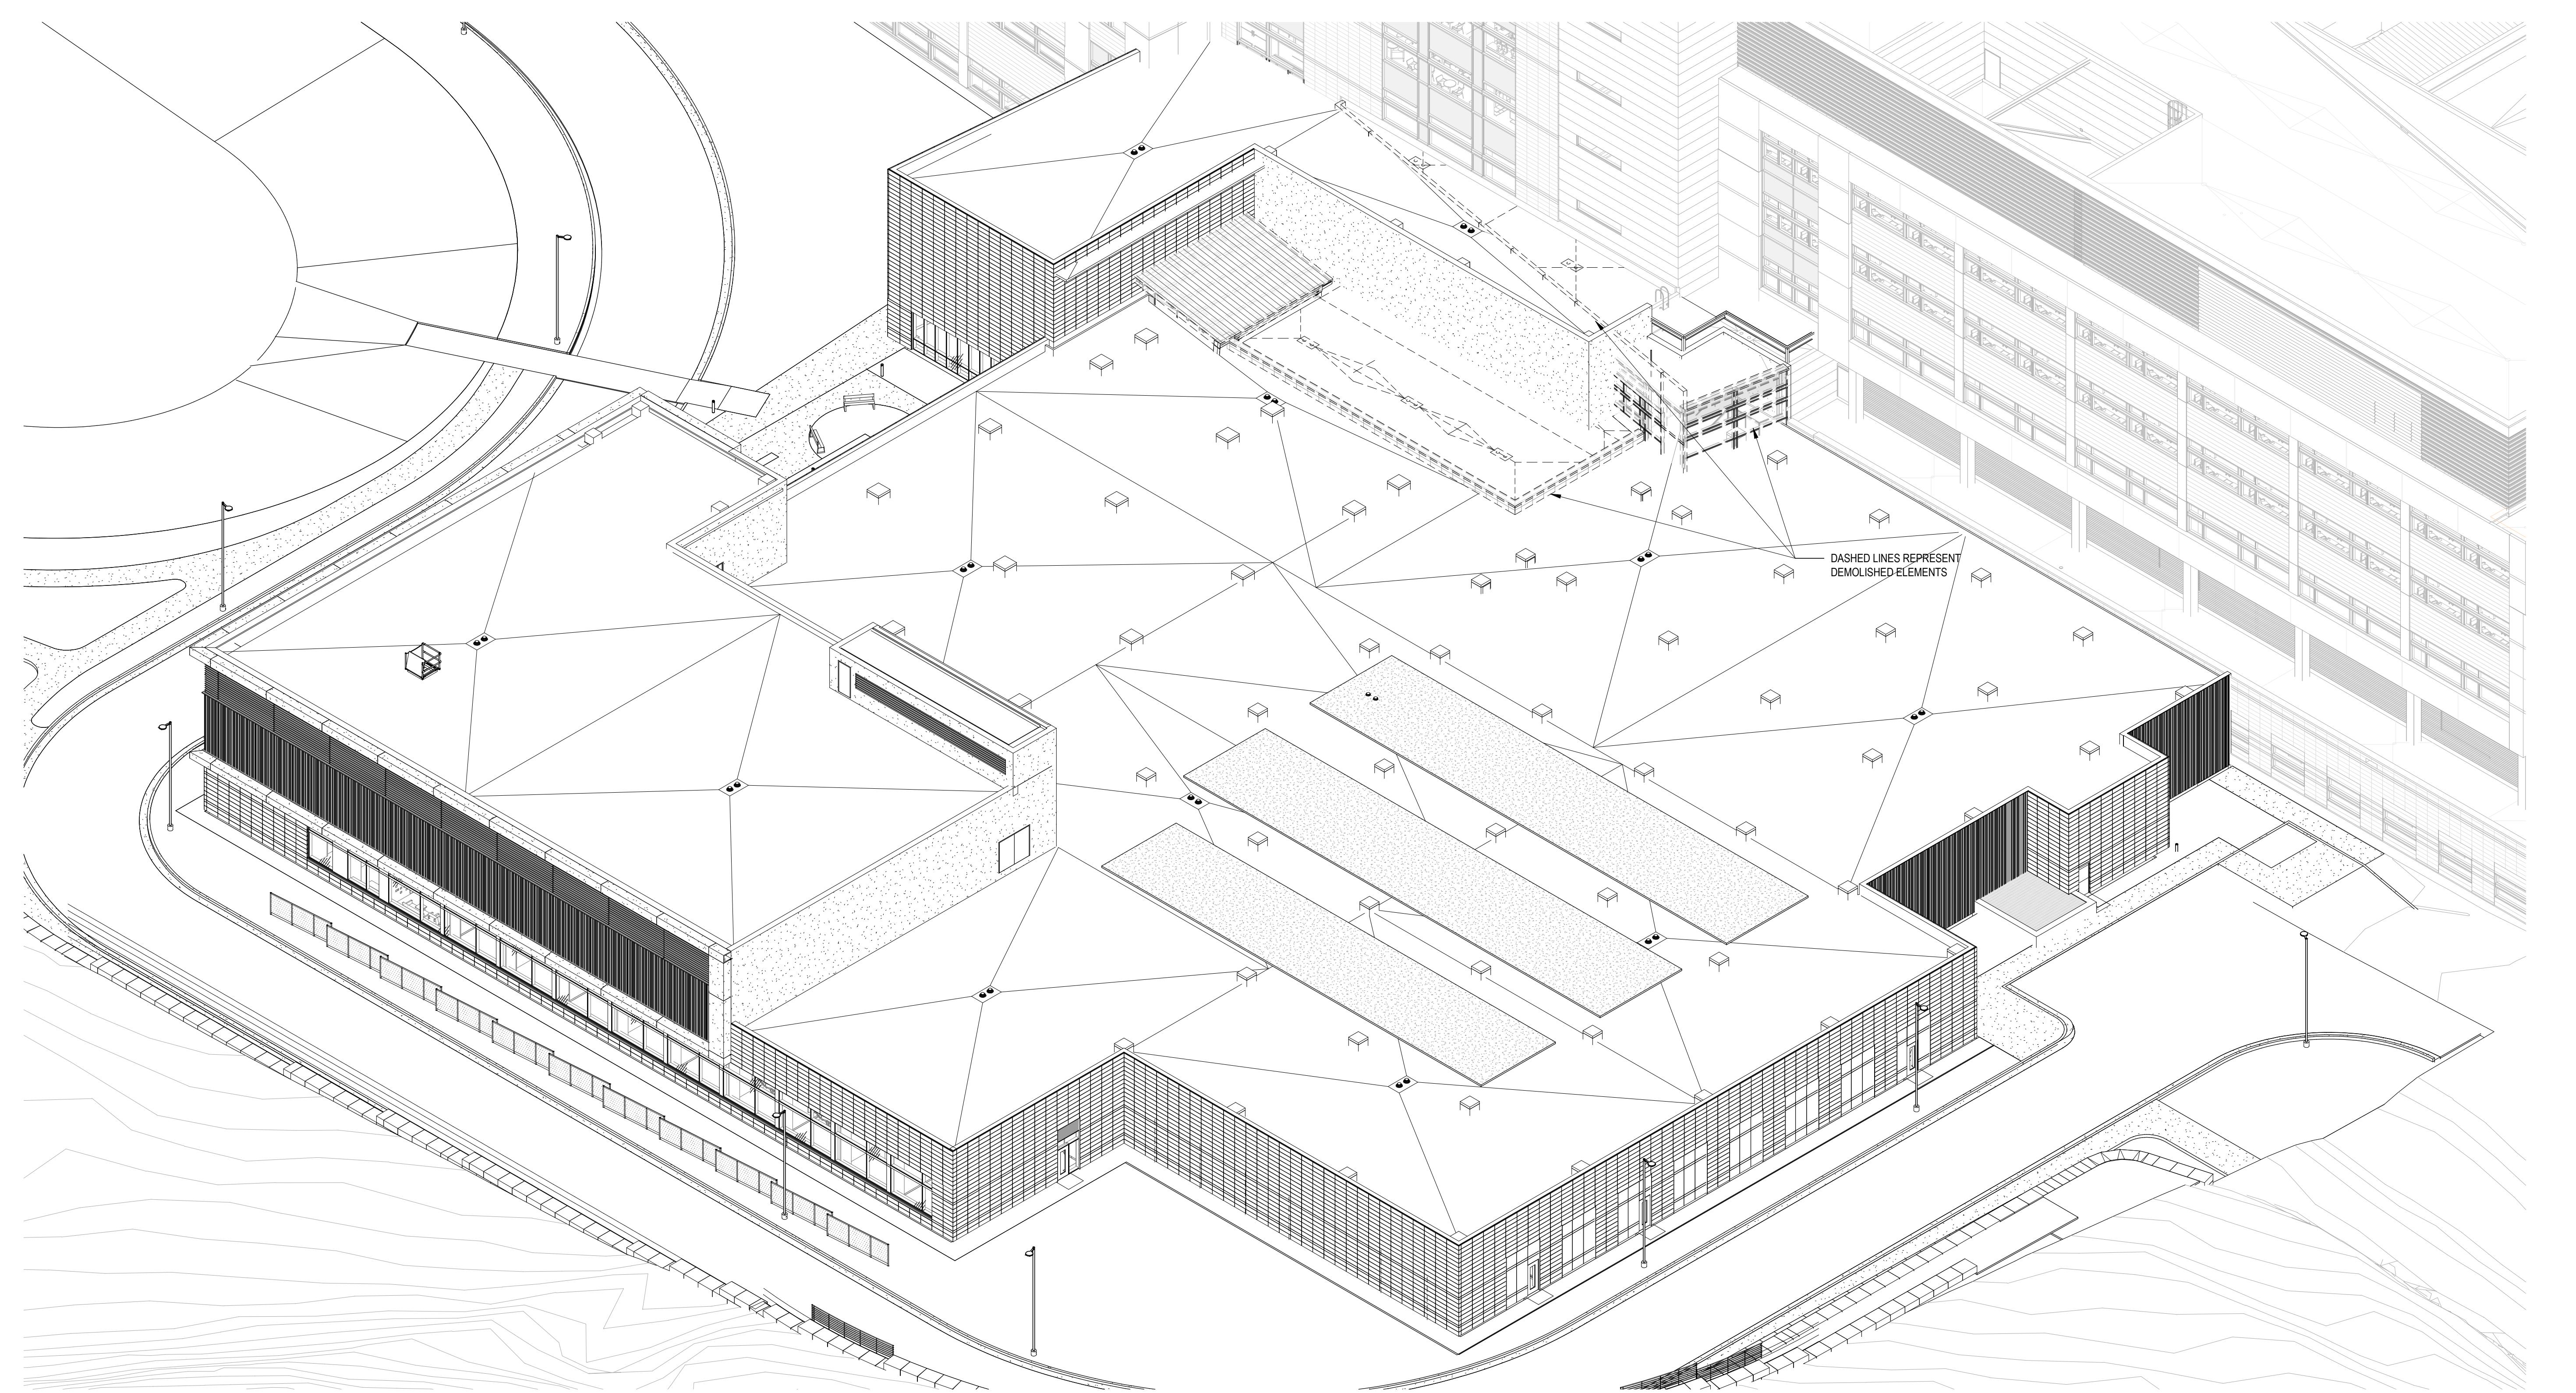

1 ISOMETRIC - SW



NOT FOR  
CONSTRUCTION

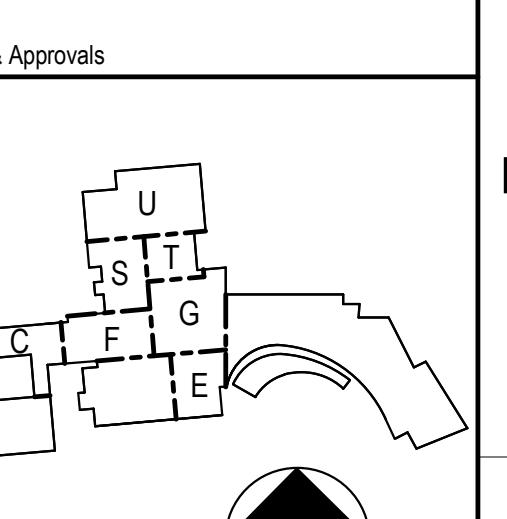UWHealth

**UW HEALTH:  
EAST MADISON  
HOSPITAL**

4602 EASTPARK BLVD.  
MADISON, WI 53718

**PHASE 1  
EXPANSION**

Project Phase  
LAND USE APPLICATION


Date 08/07/24 Drawn By FLAD

Project Number 24764-00 Checked By FLAD

Sheet Title 3D REPRESENTATION

NW/SW


Sheet Number A-011 Rev. No.

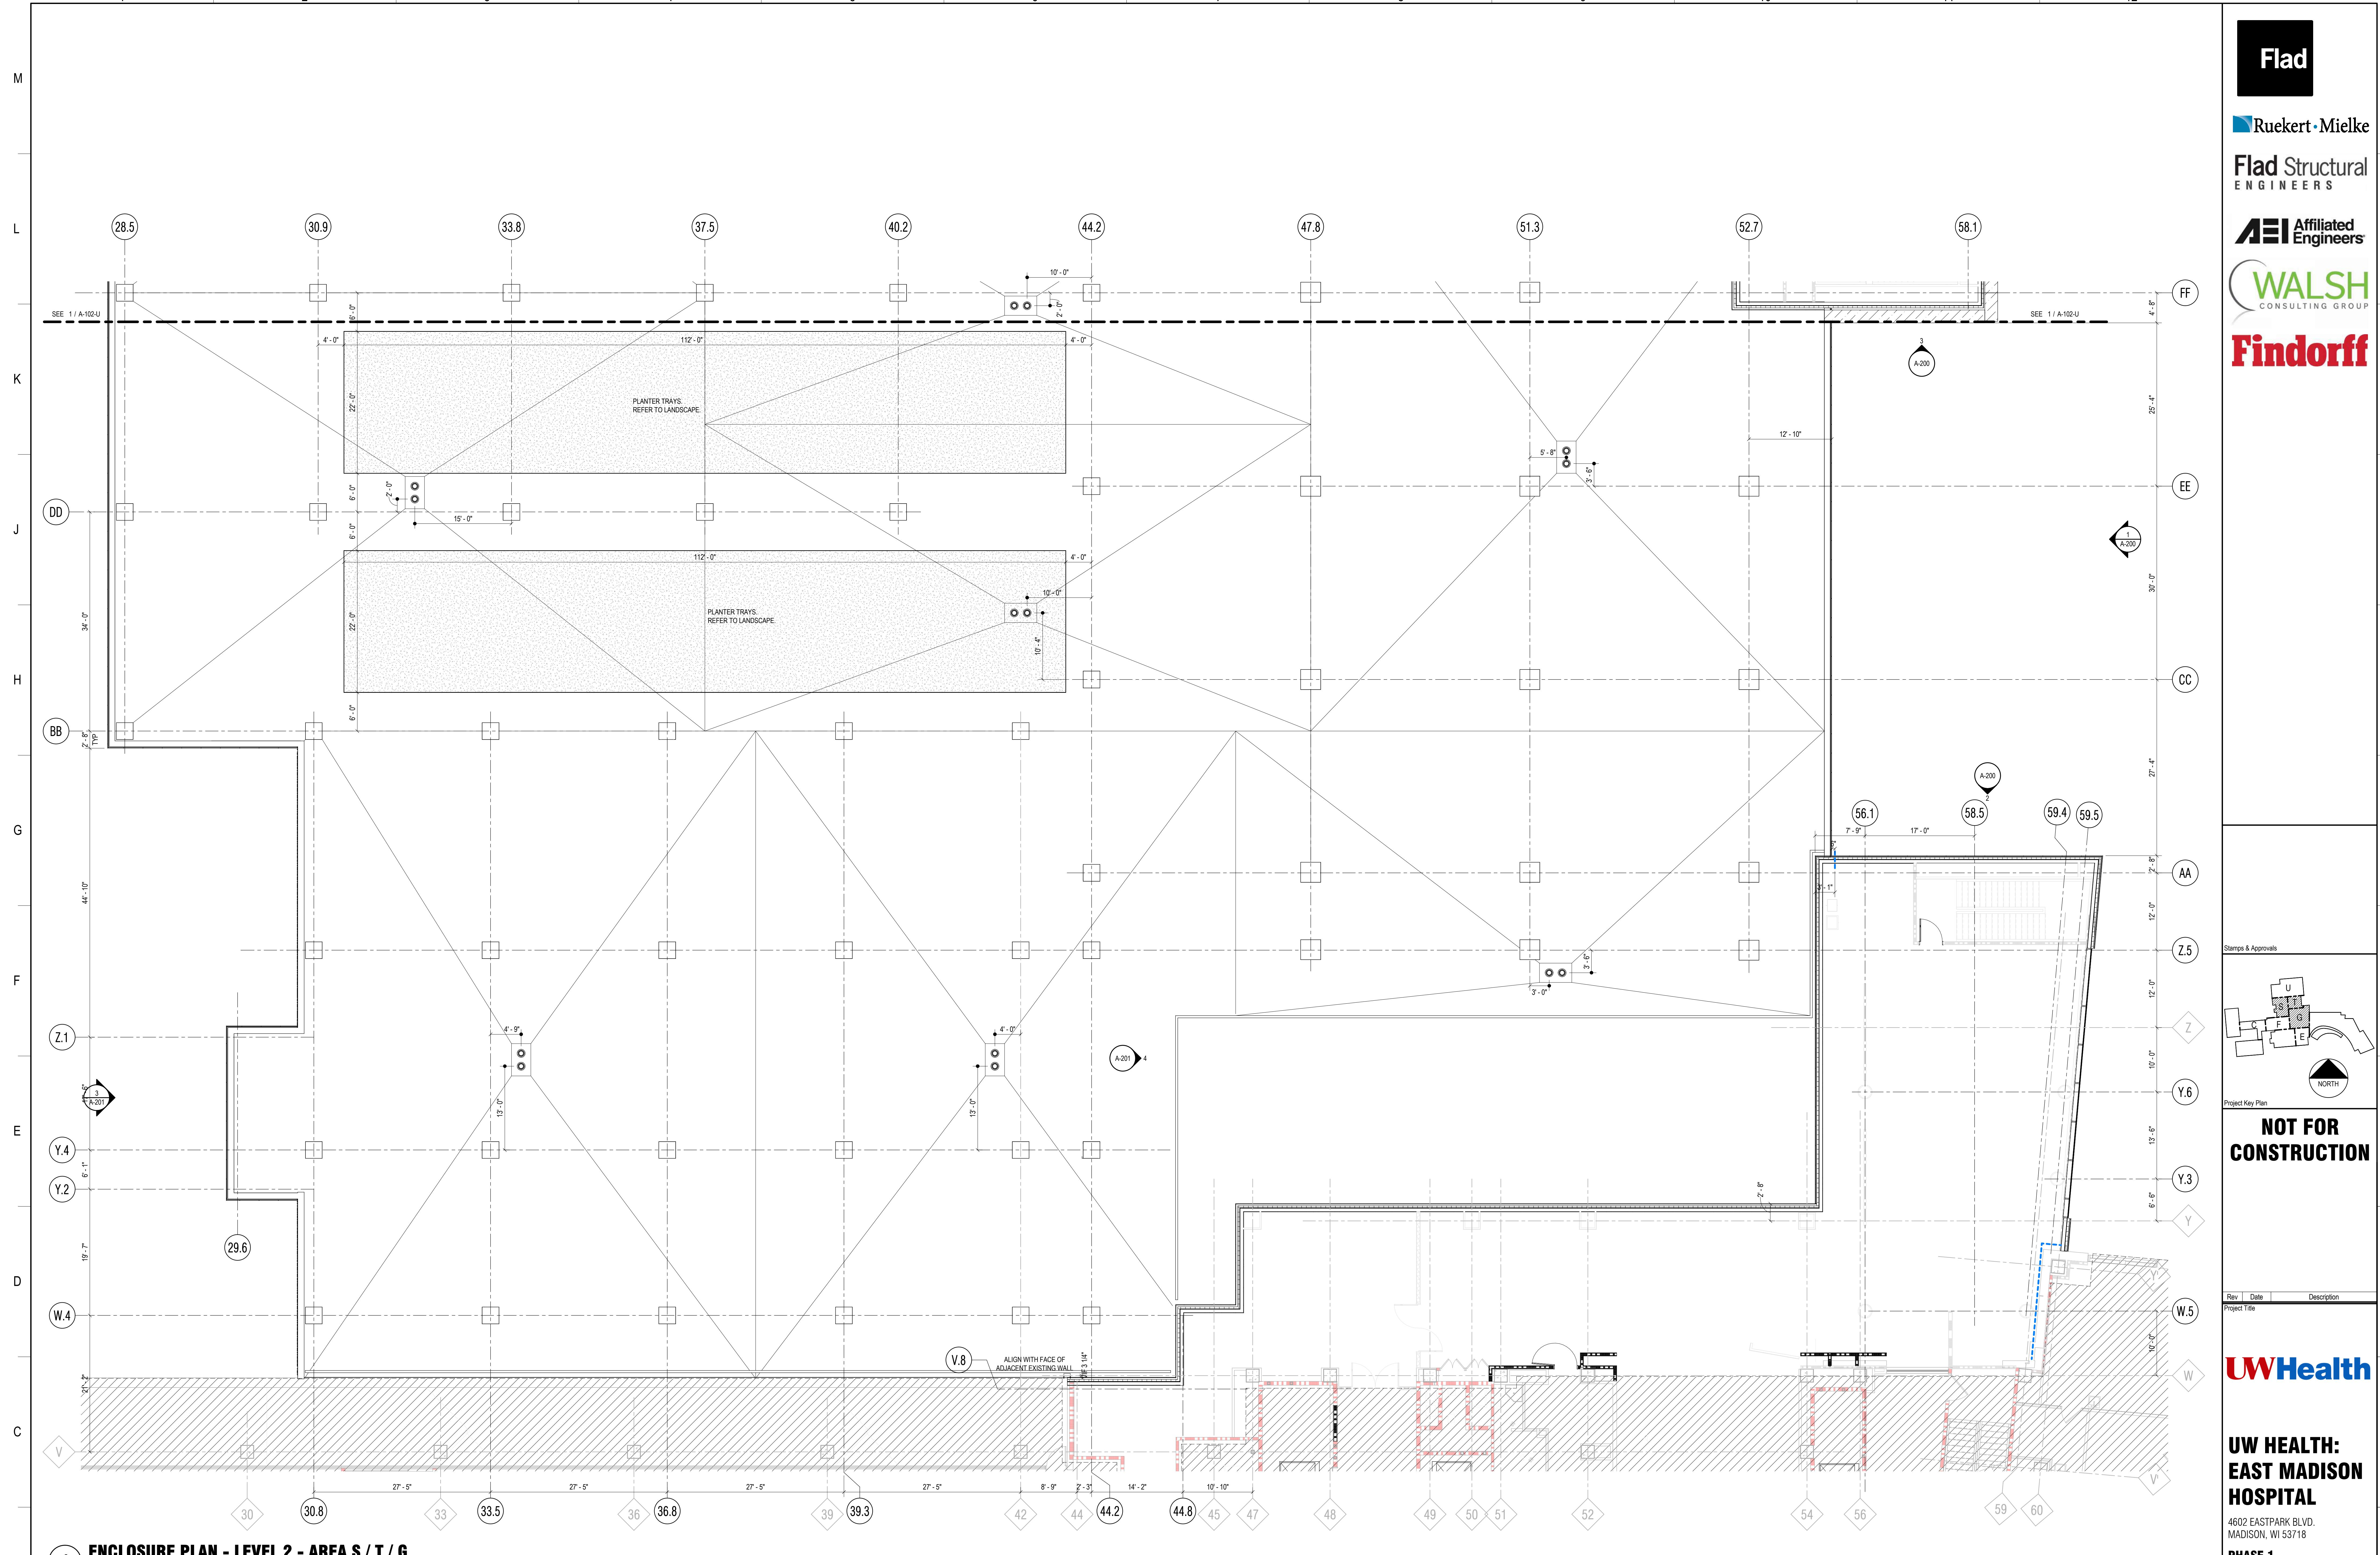

# ENCLOSURE PLAN - LEVEL 2 - AREA S / T / G

1/8" = 1'-0"

GENERAL SHEET NOTES		GENERAL EXTERIOR NOTES		SHEET KEYNOTES		SPEC KEYNOTES	
A	<p>1 REFER TO G-100 SERIES FOR LIFE SAFETY PLANS LOCATING RATED CONSTRUCTION, EG: SMOKE BARRIERS, FIRE BARRIERS, AND SMOKE PARTITIONS.</p> <p>2 REFER TO THE AD SERIES FOR ARCHITECTURAL DEMOLITION PLANS AND ELEVATIONS.</p> <p>3 REFER TO A-100 SERIES FOR ENCLOSURE PLANS, EXTERIOR ELEVATION CALLOUTS, AND SECTION CALLOUTS.</p> <p>4 REFER TO A-110 SERIES FOR FLOOR PLANS AND INTERIOR ELEVATION CALLOUTS.</p> <p>5 REFER TO A-120 SERIES FOR REFLECTED CEILING PLANS.</p> <p>6 REFER TO A-130 SERIES FOR FINISH PLANS.</p> <p>7 REFER TO A-140 SERIES FOR FURNITURE PLANS.</p> <p>8 REFER TO A-200 SERIES FOR EXTERIOR ELEVATIONS.</p> <p>9 REFER TO A-300 SERIES FOR BUILDING AND WALL SECTIONS.</p> <p>10 REFER TO A-400 SERIES FOR ENLARGED VIEWS.</p> <p>11 REFER TO A-500 SERIES FOR EXTERIOR DETAILS.</p> <p>12 REFER TO A-550 SERIES FOR INTERIOR DETAILS.</p> <p>13 REFER TO A-600 SERIES FOR SCHEDULES.</p> <p>14 REFER TO FIRE PROTECTION, PLUMBING, MED GAS, MECHANICAL, ELECTRICAL, AND TECHNOLOGY DRAWINGS FOR SPECIFIC DEVICE AND FIXTURE INFORMATION.</p>	<p>1 FLOOR PLAN CUT PLANE AT 4'-0" AFF U.N.O.</p> <p>2 FLOOR ELEVATIONS ARE TO TOP OF SLAB U.N.O.</p> <p>3 INTERIOR PARTITIONS, CEILING, AND EQUIPMENT ARE SHOWN FOR REFERENCE ONLY. REFER TO THE INTERIOR FLOOR PLANS, CEILING PLANS, AND INTERIOR DETAILS FOR MORE INFORMATION.</p> <p>4 ALL PANEL JOINTS AND REVEALS ARE DIMENSIONED TO THE CENTERLINE OF THE JOINT U.N.O.</p> <p>5 DIMENSIONS FOR CURTAINWALL ARE TO THE EXTERIOR FACE OF GLASS.</p> <p>6 PROVIDE 4" CURTAINWALL INSULATION BEHIND ALL SPANDREL GLASS. TAPE ALL JOINTS AND PENETRATIONS.</p> <p>7 PROVIDE INSULATED BLANK-OFF PANEL AT INACTIVE LOUVERS. COORDINATE LOCATION WITH MECHANICAL.</p>	<p>1 FLOOR PLAN CUT PLANE AT 4'-0" AFF U.N.O.</p> <p>2 FLOOR ELEVATIONS ARE TO TOP OF SLAB U.N.O.</p> <p>3 INTERIOR PARTITIONS, CEILING, AND EQUIPMENT ARE SHOWN FOR REFERENCE ONLY. REFER TO THE INTERIOR FLOOR PLANS, CEILING PLANS, AND INTERIOR DETAILS FOR MORE INFORMATION.</p> <p>4 ALL PANEL JOINTS AND REVEALS ARE DIMENSIONED TO THE CENTERLINE OF THE JOINT U.N.O.</p> <p>5 DIMENSIONS FOR CURTAINWALL ARE TO THE EXTERIOR FACE OF GLASS.</p> <p>6 PROVIDE 4" CURTAINWALL INSULATION BEHIND ALL SPANDREL GLASS. TAPE ALL JOINTS AND PENETRATIONS.</p> <p>7 PROVIDE INSULATED BLANK-OFF PANEL AT INACTIVE LOUVERS. COORDINATE LOCATION WITH MECHANICAL.</p>	<p>1 FLOOR PLAN CUT PLANE AT 4'-0" AFF U.N.O.</p> <p>2 FLOOR ELEVATIONS ARE TO TOP OF SLAB U.N.O.</p> <p>3 INTERIOR PARTITIONS, CEILING, AND EQUIPMENT ARE SHOWN FOR REFERENCE ONLY. REFER TO THE INTERIOR FLOOR PLANS, CEILING PLANS, AND INTERIOR DETAILS FOR MORE INFORMATION.</p> <p>4 ALL PANEL JOINTS AND REVEALS ARE DIMENSIONED TO THE CENTERLINE OF THE JOINT U.N.O.</p> <p>5 DIMENSIONS FOR CURTAINWALL ARE TO THE EXTERIOR FACE OF GLASS.</p> <p>6 PROVIDE 4" CURTAINWALL INSULATION BEHIND ALL SPANDREL GLASS. TAPE ALL JOINTS AND PENETRATIONS.</p> <p>7 PROVIDE INSULATED BLANK-OFF PANEL AT INACTIVE LOUVERS. COORDINATE LOCATION WITH MECHANICAL.</p>	<p>1 FLOOR PLAN CUT PLANE AT 4'-0" AFF U.N.O.</p> <p>2 FLOOR ELEVATIONS ARE TO TOP OF SLAB U.N.O.</p> <p>3 INTERIOR PARTITIONS, CEILING, AND EQUIPMENT ARE SHOWN FOR REFERENCE ONLY. REFER TO THE INTERIOR FLOOR PLANS, CEILING PLANS, AND INTERIOR DETAILS FOR MORE INFORMATION.</p> <p>4 ALL PANEL JOINTS AND REVEALS ARE DIMENSIONED TO THE CENTERLINE OF THE JOINT U.N.O.</p> <p>5 DIMENSIONS FOR CURTAINWALL ARE TO THE EXTERIOR FACE OF GLASS.</p> <p>6 PROVIDE 4" CURTAINWALL INSULATION BEHIND ALL SPANDREL GLASS. TAPE ALL JOINTS AND PENETRATIONS.</p> <p>7 PROVIDE INSULATED BLANK-OFF PANEL AT INACTIVE LOUVERS. COORDINATE LOCATION WITH MECHANICAL.</p>	<p>1 FLOOR PLAN CUT PLANE AT 4'-0" AFF U.N.O.</p> <p>2 FLOOR ELEVATIONS ARE TO TOP OF SLAB U.N.O.</p> <p>3 INTERIOR PARTITIONS, CEILING, AND EQUIPMENT ARE SHOWN FOR REFERENCE ONLY. REFER TO THE INTERIOR FLOOR PLANS, CEILING PLANS, AND INTERIOR DETAILS FOR MORE INFORMATION.</p> <p>4 ALL PANEL JOINTS AND REVEALS ARE DIMENSIONED TO THE CENTERLINE OF THE JOINT U.N.O.</p> <p>5 DIMENSIONS FOR CURTAINWALL ARE TO THE EXTERIOR FACE OF GLASS.</p> <p>6 PROVIDE 4" CURTAINWALL INSULATION BEHIND ALL SPANDREL GLASS. TAPE ALL JOINTS AND PENETRATIONS.</p> <p>7 PROVIDE INSULATED BLANK-OFF PANEL AT INACTIVE LOUVERS. COORDINATE LOCATION WITH MECHANICAL.</p>	<p>1 FLOOR PLAN CUT PLANE AT 4'-0" AFF U.N.O.</p> <p>2 FLOOR ELEVATIONS ARE TO TOP OF SLAB U.N.O.</p> <p>3 INTERIOR PARTITIONS, CEILING, AND EQUIPMENT ARE SHOWN FOR REFERENCE ONLY. REFER TO THE INTERIOR FLOOR PLANS, CEILING PLANS, AND INTERIOR DETAILS FOR MORE INFORMATION.</p> <p>4 ALL PANEL JOINTS AND REVEALS ARE DIMENSIONED TO THE CENTERLINE OF THE JOINT U.N.O.</p> <p>5 DIMENSIONS FOR CURTAINWALL ARE TO THE EXTERIOR FACE OF GLASS.</p> <p>6 PROVIDE 4" CURTAINWALL INSULATION BEHIND ALL SPANDREL GLASS. TAPE ALL JOINTS AND PENETRATIONS.</p> <p>7 PROVIDE INSULATED BLANK-OFF PANEL AT INACTIVE LOUVERS. COORDINATE LOCATION WITH MECHANICAL.</p>
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**1 ENCLOSURE PLAN - LEVEL 2 - AREA U**

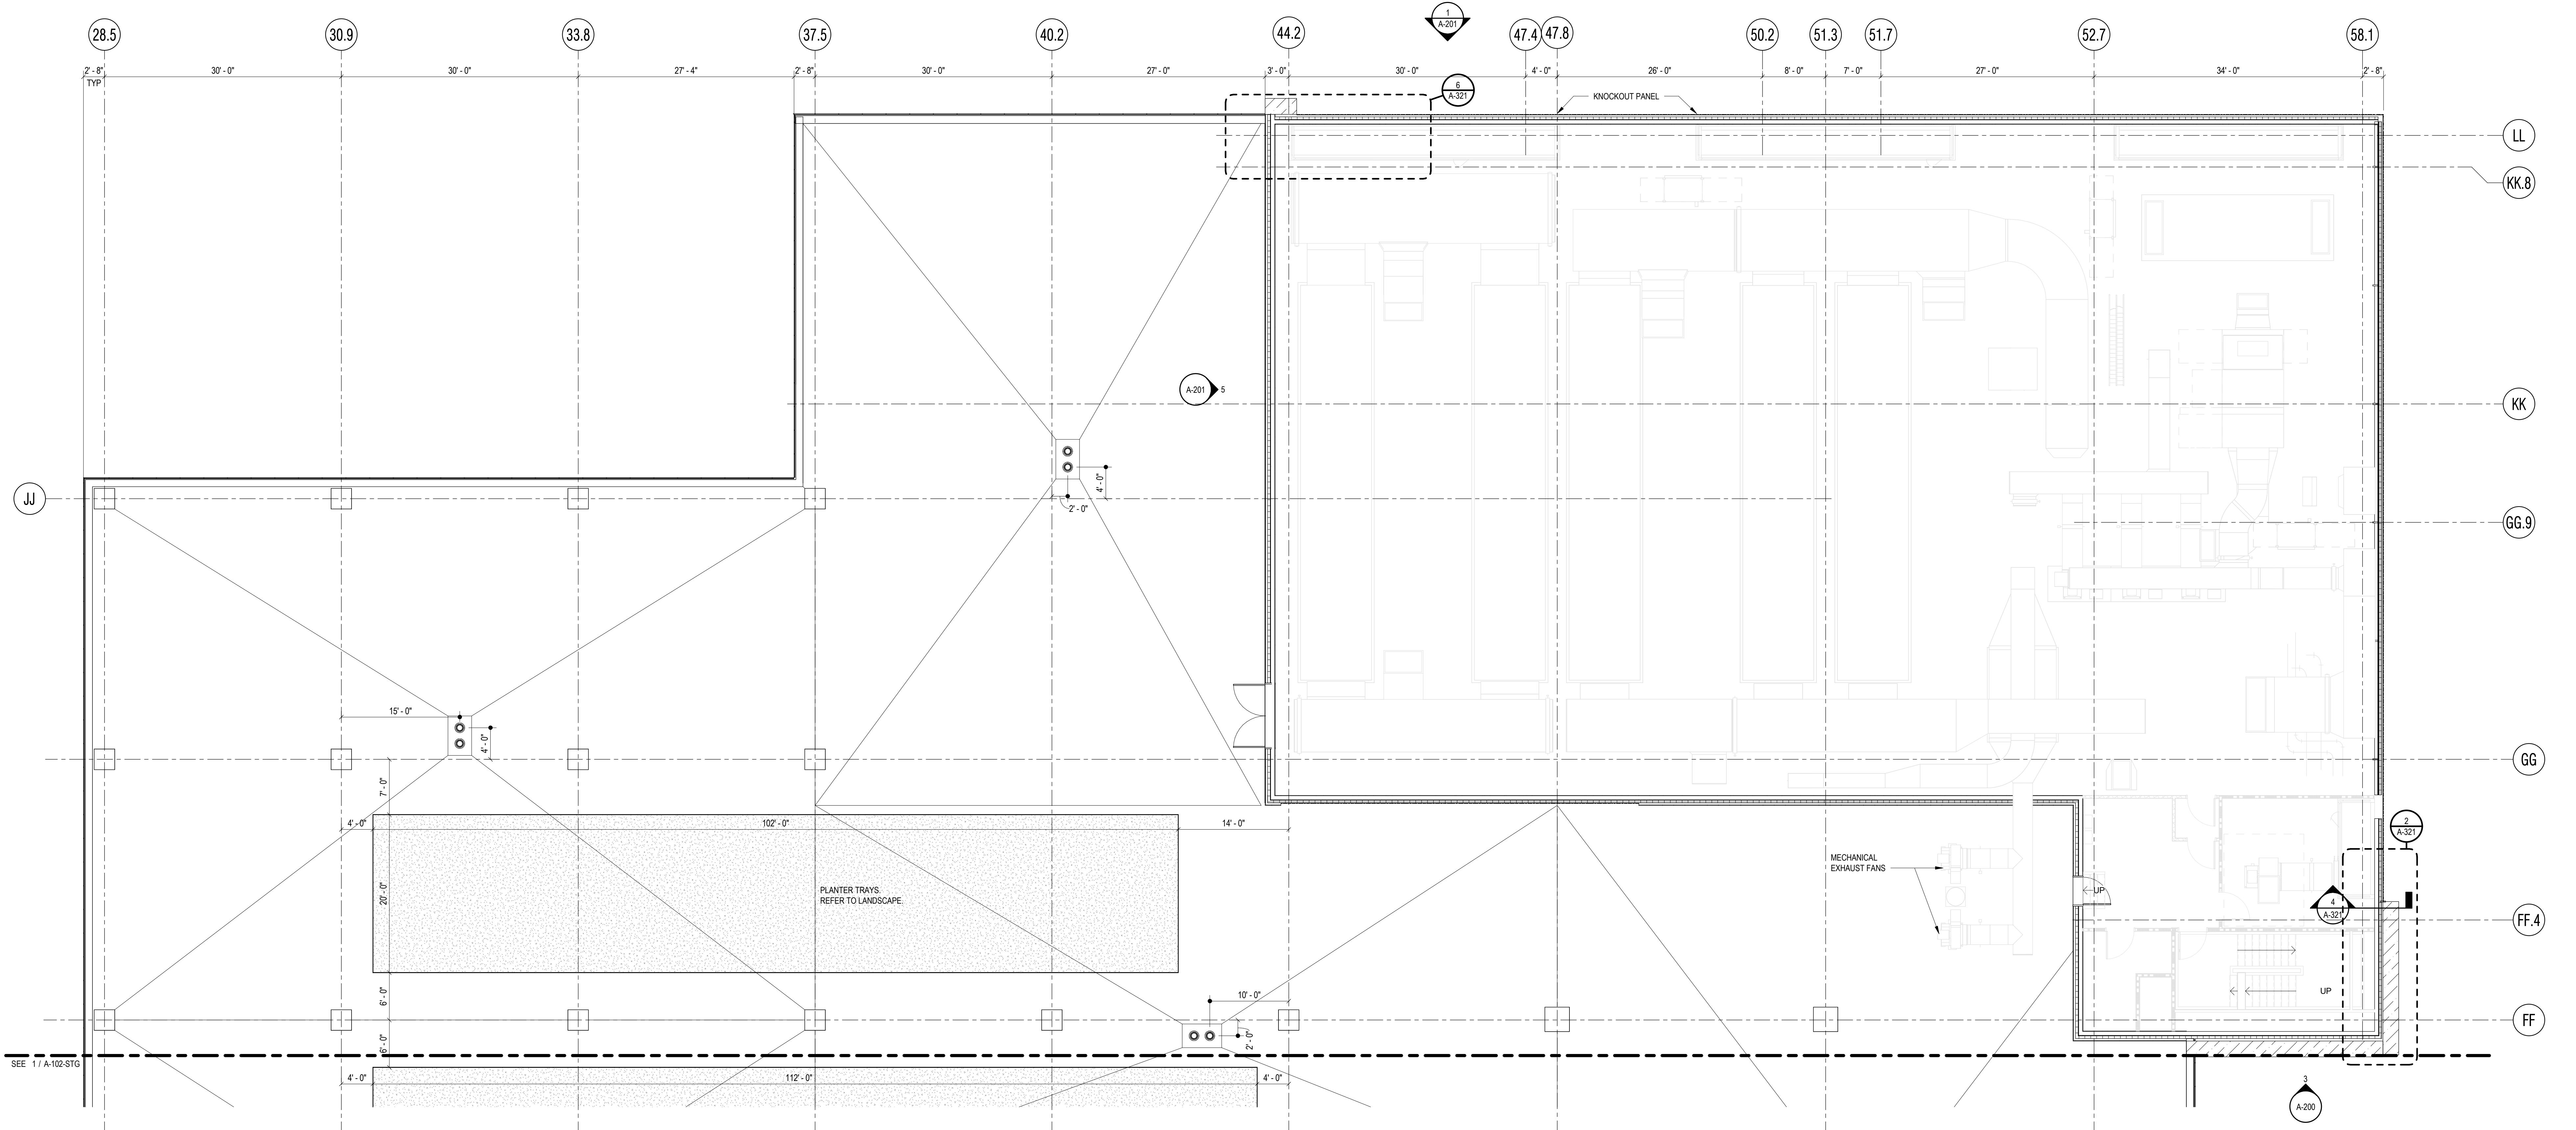1/8" = 1'-0"


**GENERAL SHEET NOTES**

- 1 REFER TO G-100 SERIES FOR LIFE SAFETY PLANS LOCATING RATED CONSTRUCTION, EG: SMOKE BARRIERS, FIRE BARRIERS, AND SMOKA PARTITIONS.
- 2 REFER TO THE AD SERIES FOR ARCHITECTURAL DEMOLITION PLANS AND ELEVATIONS.
- 3 REFER TO A-100 SERIES FOR ENCLOSURE PLANS, EXTERIOR ELEVATION CALLOUTS, AND SECTION CALLOUTS.
- 4 REFER TO A-110 SERIES FOR FLOOR PLANS AND INTERIOR ELEVATION DETAILS.
- 5 REFER TO A-120 SERIES FOR REFLECTED CEILING PLANS.
- 6 REFER TO A-130 SERIES FOR PLANT PLANS.
- 7 REFER TO A-140 SERIES FOR FURNITURE PLANS.
- 8 REFER TO A-200 SERIES FOR EXTERIOR ELEVATIONS.
- 9 REFER TO A-300 SERIES FOR BUILDING AND WALL SECTIONS.
- 10 REFER TO A-400 SERIES FOR ENLARGED VIEWS.
- 11 REFER TO A-500 SERIES FOR EXTERIOR DETAILS.
- 12 REFER TO A-600 SERIES FOR INTERIOR DETAILS.
- 13 REFER TO A-800 SERIES FOR FURNITURES.
- 14 REFER TO FIRE PROTECTION, PLUMBING, MED GAS, MECHANICAL, ELECTRICAL, AND TECHNOLOGY DRAWINGS FOR SPECIFIC DEVICE AND FIXTURE INFORMATION.

**GENERAL EXTERIOR NOTES**

- 1 FLOOR PLAN CUT PLANS AT 1/4" OFF UNO.
- 2 FLOOR ELEVATIONS ARE TO TOP OF S-40 UNO.
- 3 INTERIOR PARTITIONS, CEILING, AND EQUIPMENT ARE SHOWN FOR REFERENCE ONLY. REFER TO THE INTERIOR FLOOR PLANS, CEILING PLANS, AND INTERIOR DETAILS FOR MORE INFORMATION.
- 4 ALL PANEL JOINTS AND REVEALS ARE DIMENSIONED TO THE CENTERLINE OF THE JOINT UNO.
- 5 DIMENSIONS FOR CURTAINWALL ARE TO THE EXTERIOR FACE OF THE CURTAINWALL.
- 6 PROVIDE 4" CURTAINWALL INSULATION. SEAL ALL JOINTS WITH GLASS TAPE. ALL JOINTS AND PENETRATIONS PROVIDE INSULATED BLANK-OFF PANEL AT INACTIVE LOUVERS. COORDINATE LOCATION WITH MECHANICAL.
- 7

**SHEET KEYNOTES****SPEC KEYNOTES**

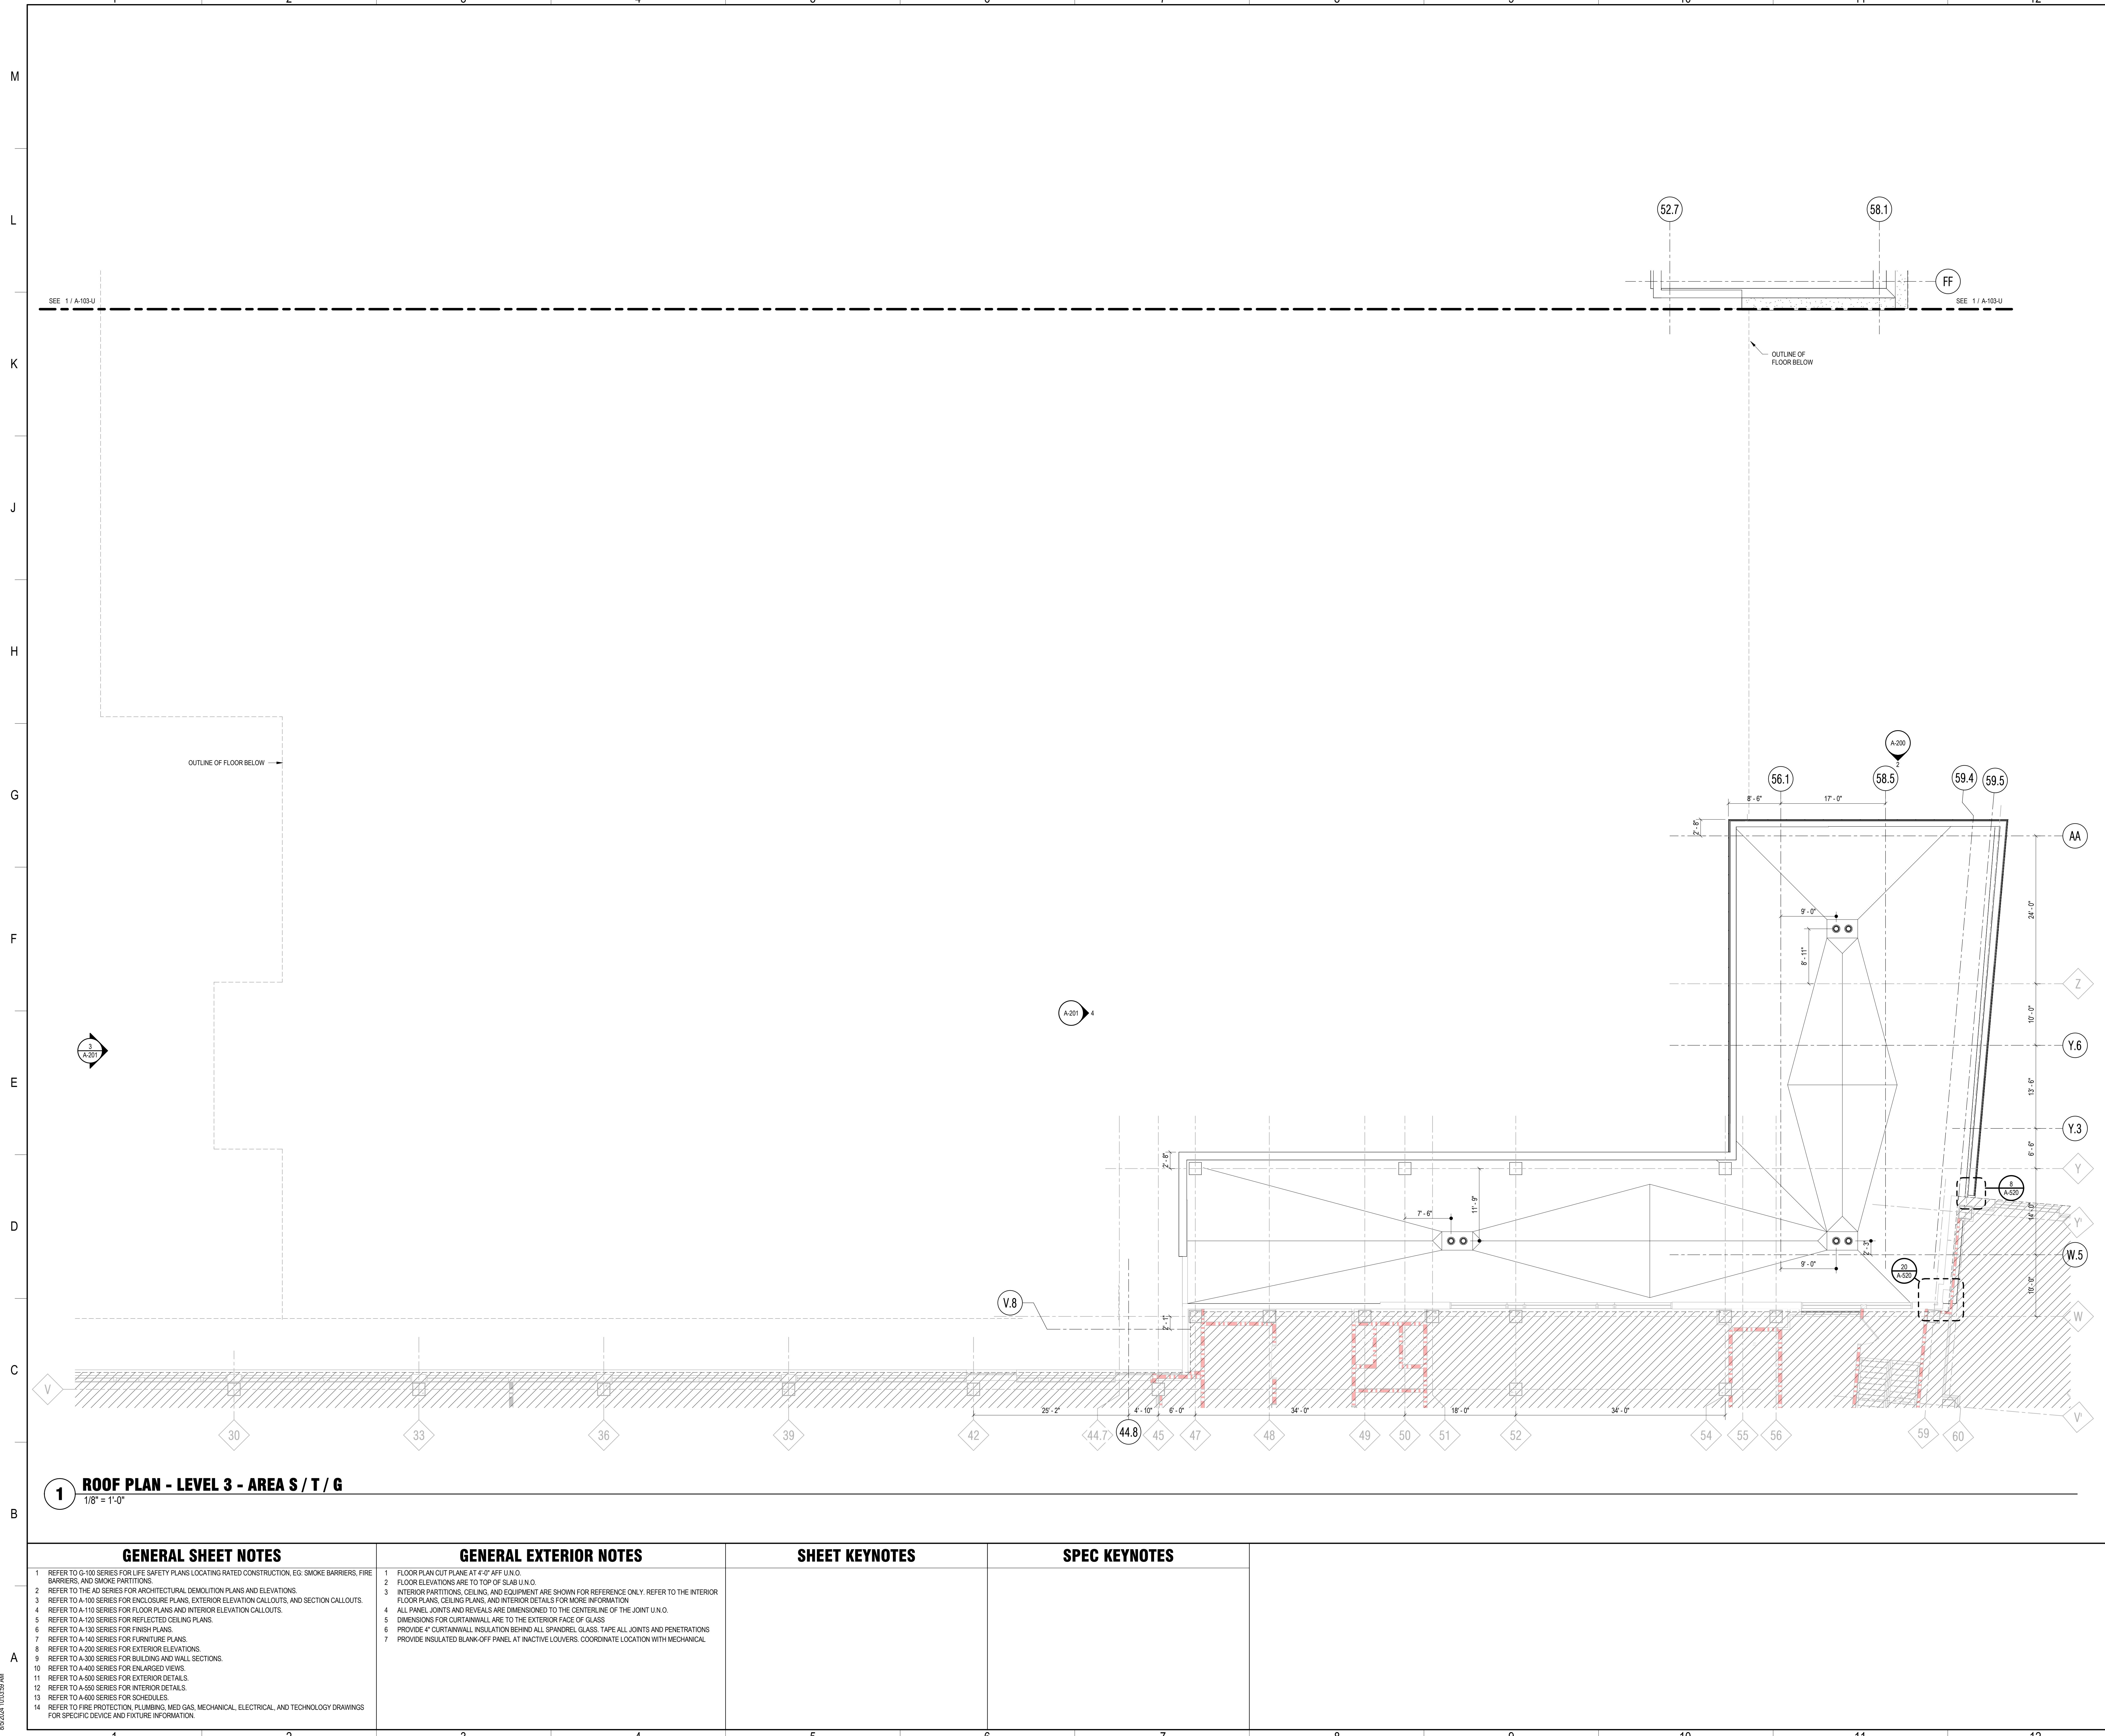

# 1 ROOF PLAN - LEVEL 3 - AREA S / T / G

1/8" = 1'

## GENERAL SHEET NOTES

REFER TO G-100 SERIES FOR LIFE SAFETY PLANS LOCATING RATED CONSTRUCTION, EG: SMOKE BARRIERS, FIRE BARRIERS, AND SMOKE PARTITIONS.

REFER TO THE AD SERIES FOR ARCHITECTURAL DEMOLITION PLANS AND ELEVATIONS.

REFER TO A-100 SERIES FOR ENCLOSURE PLANS, EXTERIOR ELEVATION CALLOUTS, AND SECTION CALLOUTS.

REFER TO A-110 SERIES FOR FLOOR PLANS AND INTERIOR ELEVATION CALLOUTS.

REFER TO A-120 SERIES FOR REFLECTED CEILING PLANS.

REFER TO A-130 SERIES FOR FINISH PLANS.

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REFER TO A-200 SERIES FOR EXTERIOR ELEVATIONS.

REFER TO A-300 SERIES FOR BUILDING AND WALL SECTIONS.

REFER TO A-400 SERIES FOR ENLARGED VIEWS.

REFER TO A-500 SERIES FOR EXTERIOR DETAILS.

REFER TO A-550 SERIES FOR INTERIOR DETAILS.

REFER TO A-600 SERIES FOR SCHEDULES.

REFER TO FIRE PROTECTION, PLUMBING, MED GAS, MECHANICAL, ELECTRICAL, AND TECHNOLOGY DRAWINGS FOR SPECIFIC DEVICE AND FIXTURE INFORMATION.

## **GENERAL EXTERIOR NOTE**

- 1 FLOOR PLAN CUT PLANE AT 4'-0" AFF U.N.O.
- 2 FLOOR ELEVATIONS ARE TO TOP OF SLAB U.N.O.
- 3 INTERIOR PARTITIONS, CEILING, AND EQUIPMENT ARE SHOWN FOR REFERENCE ONLY. REFER TO THE IN FLOOR PLANS, CEILING PLANS, AND INTERIOR DETAILS FOR MORE INFORMATION
- 4 ALL PANEL JOINTS AND REVEALS ARE DIMENSIONED TO THE CENTERLINE OF THE JOINT U.N.O.
- 5 DIMENSIONS FOR CURTAINWALL ARE TO THE EXTERIOR FACE OF GLASS
- 6 PROVIDE 4" CURTAINWALL INSULATION BEHIND ALL SPANDREL GLASS. TAPE ALL JOINTS AND PENETRAT
- 7 PROVIDE INSULATED BLANK-OFF PANEL AT INACTIVE LOUVERS. COORDINATE LOCATION WITH MECHANIC

## SHEET KEYNOTES

## SPEC KEYNOTES

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# OSPITAL

SON, WI 53718

**ANSION**


## USE APPLICATION

'24	Drawn By FLAD
umber -00	Checked By FLAD

# **F PLAN - LEVEL 3 - A S / T / G**

Kos, T., &

Number	Rev. No.
<b>103-STG</b>	

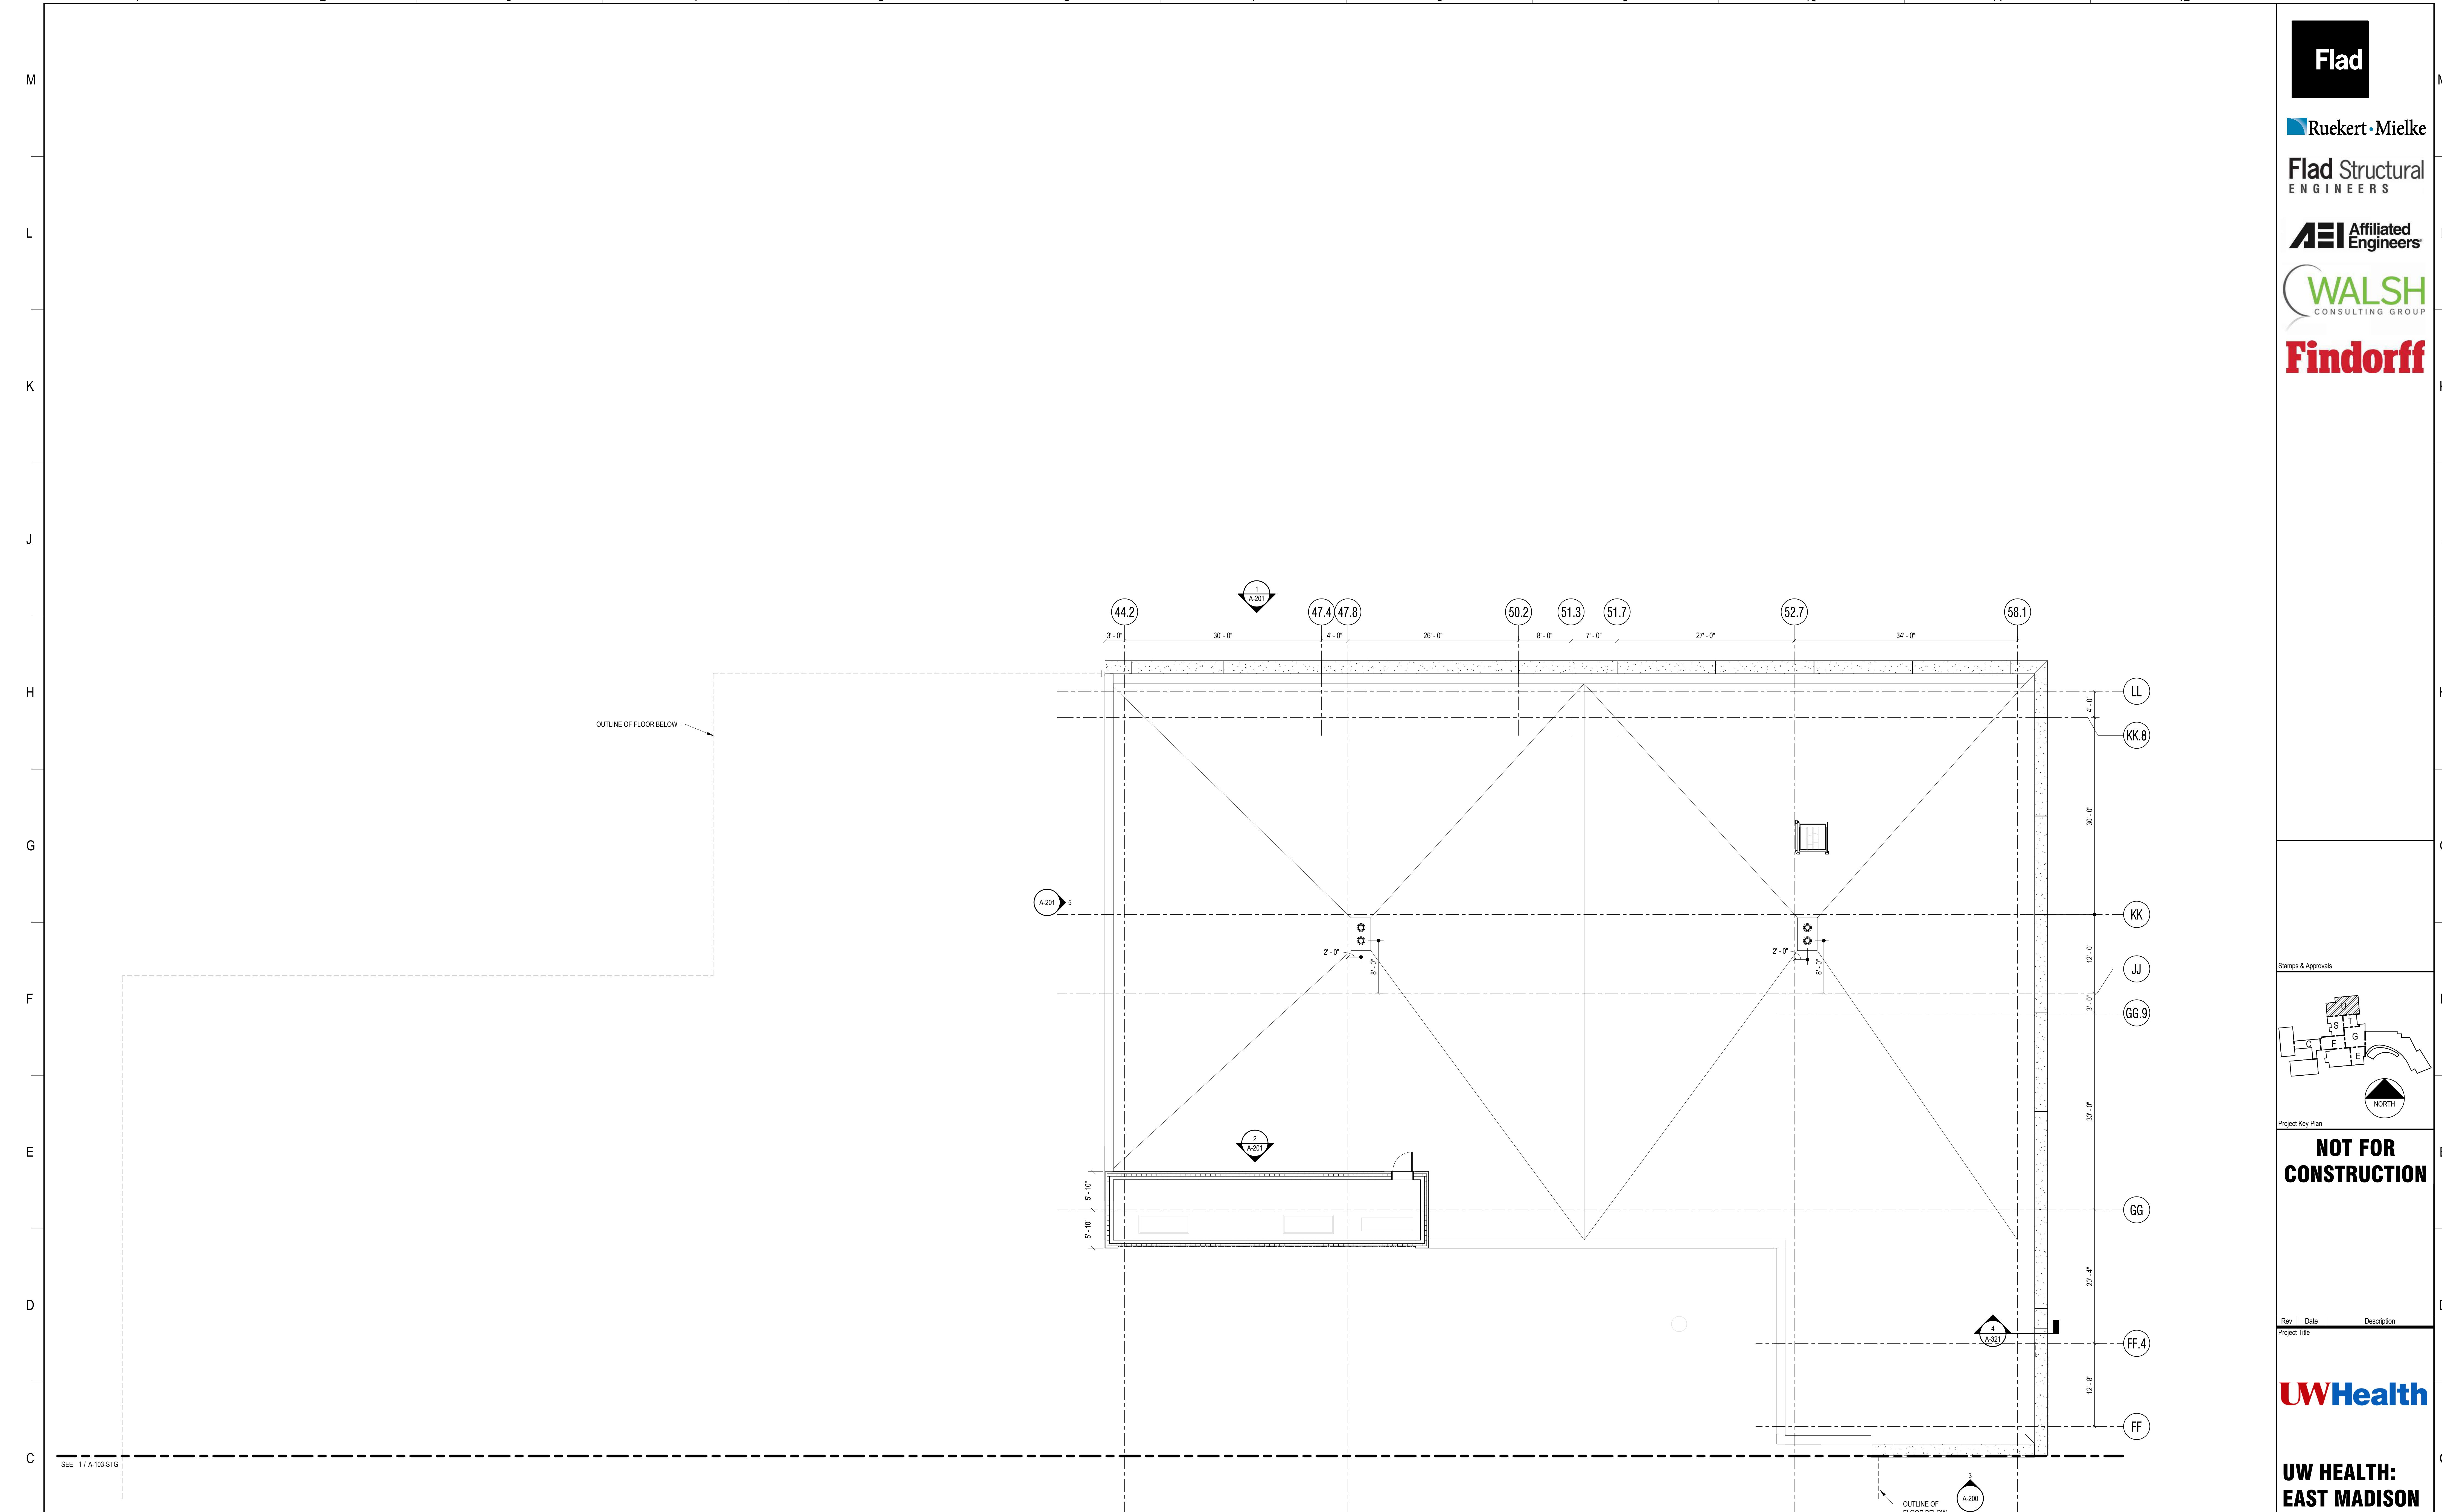
**1 ROOF PLAN - LEVEL 3 - AREA U**

1/8" = 1'-0"

**GENERAL SHEET NOTES**

- 1 REFER TO G-100 SERIES FOR LIFE SAFETY PLANS LOCATING RATED CONSTRUCTION, EG: SMOKE BARRIERS, FIRE BARRIERS, AND SMOKA PARTITIONS.
- 2 REFER TO THE AD SERIES FOR ARCHITECTURAL DEMOLITION PLANS AND ELEVATIONS.
- 3 REFER TO A-100 SERIES FOR ENCLOSURE PLANS, EXTERIOR ELEVATION CALLOUTS, AND SECTION CALLOUTS.
- 4 REFER TO A-110 SERIES FOR FLOOR PLANS AND INTERIOR ELEVATION CALLOUTS.
- 5 REFER TO A-120 SERIES FOR REFLECTED CEILING PLANS.
- 6 REFER TO A-130 SERIES FOR ROOF PLANS.
- 7 REFER TO A-140 SERIES FOR FURNITURE PLANS.
- 8 REFER TO A-200 SERIES FOR EXTERIOR ELEVATIONS.
- 9 REFER TO A-300 SERIES FOR BUILDING AND WALL SECTIONS.
- 10 REFER TO A-400 SERIES FOR ENLARGED VIEWS.
- 11 REFER TO A-500 SERIES FOR EXTERIOR DETAILS.
- 12 REFER TO A-600 SERIES FOR INTERIOR DETAILS.
- 13 REFER TO A-800 SERIES FOR FURNITURES.
- 14 REFER TO FIRE PROTECTION, PLUMBING, MED GAS, MECHANICAL, ELECTRICAL, AND TECHNOLOGY DRAWINGS FOR SPECIFIC DEVICE AND FIXTURE INFORMATION.

**GENERAL EXTERIOR NOTES**

- 1 FLOOR PLAN CUT PLANS AT A-201, ETC.
- 2 FLOOR ELEVATIONS ARE TO TOP OF SLAB UNLESS OTHERWISE STATED.
- 3 INTERIOR PARTITIONS, CEILING, AND EQUIPMENT ARE SHOWN FOR REFERENCE ONLY. REFER TO THE INTERIOR FLOOR PLANS, CEILING PLANS, AND INTERIOR DETAILS FOR MORE INFORMATION.
- 4 ALL PANEL JOINTS AND REVEALS ARE DIMENSIONED TO THE CENTERLINE OF THE JOINT UNLESS OTHERWISE STATED.
- 5 DIMENSIONS FOR CURTAINWALL ARE TO THE EXTERIOR FACE OF THE CURTAINWALL.
- 6 PROVIDE 4" CURTAINWALL INCAUTERIALIZED, ALL SURFACES GLASS, TAPE ALL JOINTS AND PENETRATIONS.
- 7 PROVIDE INSULATED BLANK-OFF PANEL AT INACTIVE LOUVERS. COORDINATE LOCATION WITH MECHANICAL.

**SHEET KEYNOTES****SPEC KEYNOTES**

## GENERAL SHEET NOTES

Flad

 Ruekert • Mielke


# Flad Structural ENGINEERS

 **AEI** Affiliated Engineers®

WALSH  
CONSULTING GROUP

# Findorff

- 1 REFER TO G-100 SERIES FOR LIFE SAFETY PLANS LOCATING RATED CONSTRUCTION, EG: SMOKE BARRIERS, FIRE BARRIERS, AND SMOKE PARTITIONS.
- 2 REFER TO THE AD SERIES FOR ARCHITECTURAL DEMOLITION PLANS AND ELEVATIONS.
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- 4 REFER TO A-110 SERIES FOR FLOOR PLANS AND INTERIOR ELEVATION CALLOUTS.
- 5 REFER TO A-120 SERIES FOR REFLECTED CEILING PLANS.
- 6 REFER TO A-130 SERIES FOR FINISH PLANS.
- 7 REFER TO A-140 SERIES FOR FURNITURE PLANS.
- 8 REFER TO A-200 SERIES FOR EXTERIOR ELEVATIONS.
- 9 REFER TO A-300 SERIES FOR BUILDING AND WALL SECTIONS.
- 10 REFER TO A-400 SERIES FOR ENLARGED VIEWS.
- 11 REFER TO A-500 SERIES FOR EXTERIOR DETAILS.
- 12 REFER TO A-550 SERIES FOR INTERIOR DETAILS.
- 13 REFER TO A-600 SERIES FOR SCHEDULES.
- 14 REFER TO FIRE PROTECTION, PLUMBING, MED GAS, MECHANICAL, ELECTRICAL, AND TECHNOLOGY DRAWINGS FOR SPECIFIC DEVICE AND FIXTURE INFORMATION.

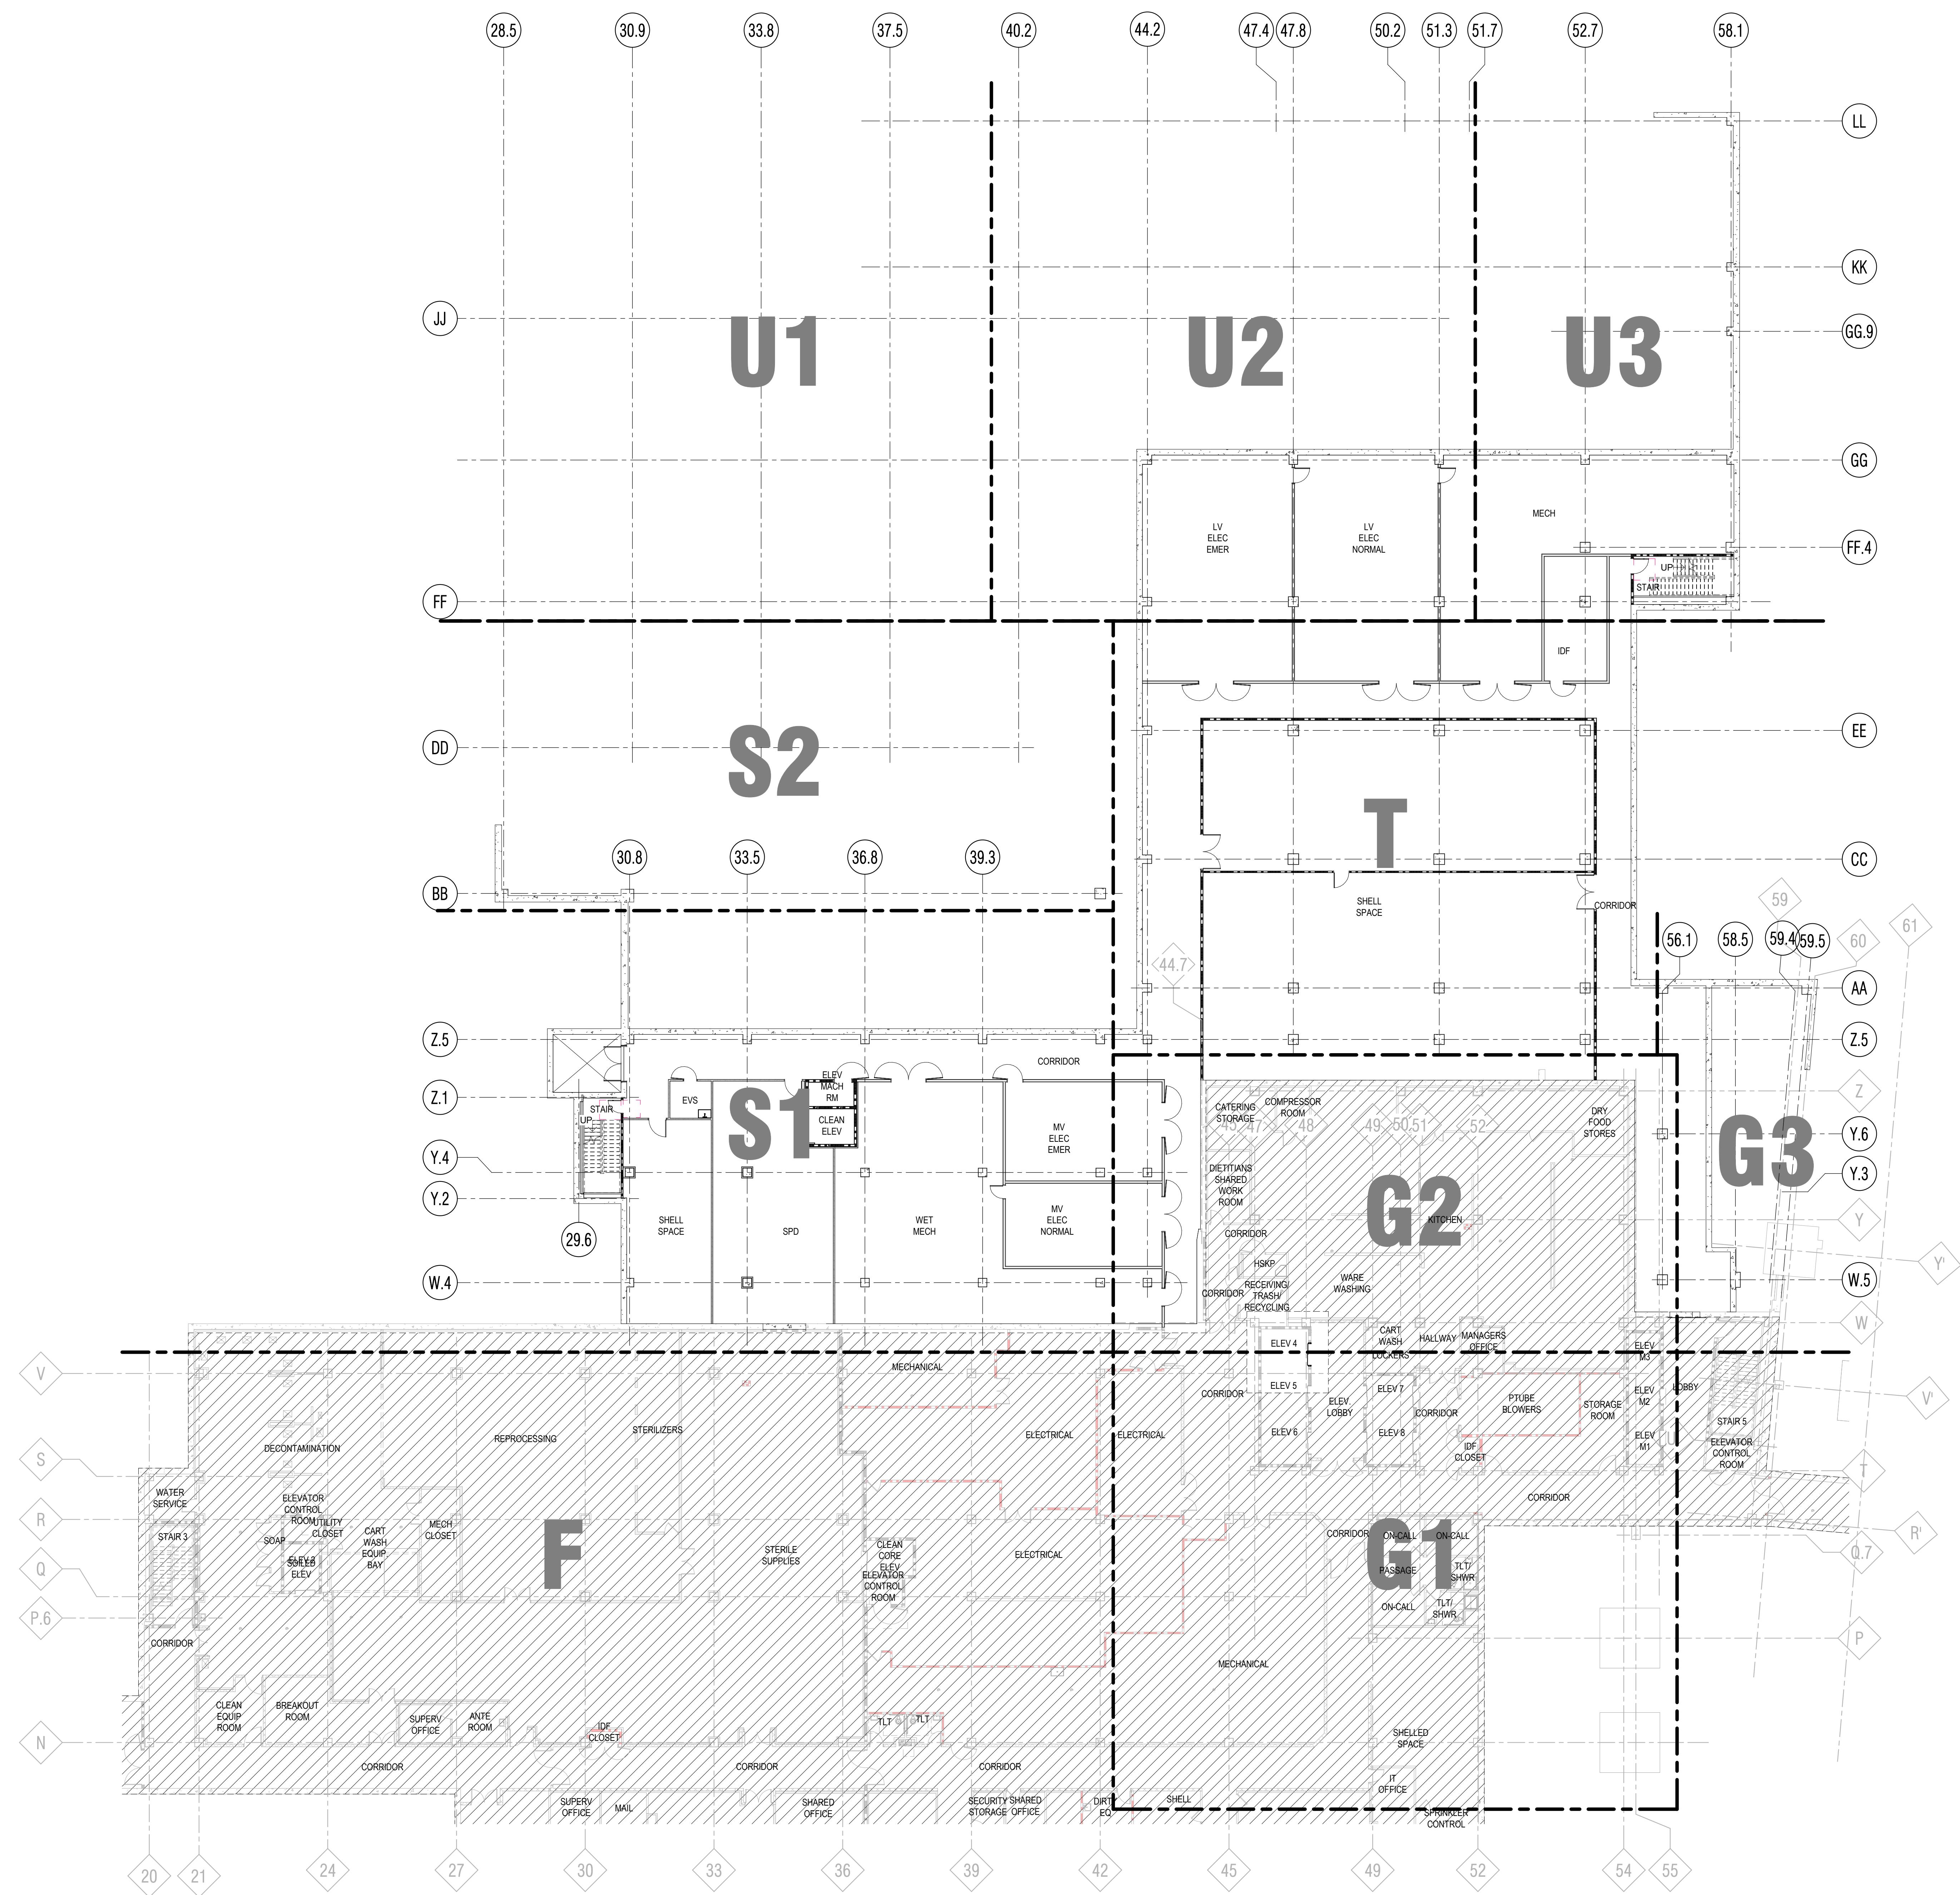

# 1 OVERALL FLOOR PLAN - LOWER LEVEL

1/16" = 1'



# NOT IN SCOPE

For more information, contact the Office of the Vice President for Research and the Office of the Vice President for Student Affairs.

Sheet Number



## GENERAL SHEET NOTES

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# Flad Structural E N G I N E E R S

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# Findorff

REFER TO G-100 SERIES FOR LIFE SAFETY PLANS LOCATING RATED CONSTRUCTION, EG: SMOKE BARRIERS, FIRE BARRIERS, AND SMOKE PARTITIONS.

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REFER TO A-110 SERIES FOR FLOOR PLANS AND INTERIOR ELEVATION CALLOUTS.

REFER TO A-120 SERIES FOR REFLECTED CEILING PLANS.

REFER TO A-130 SERIES FOR FINISH PLANS.

REFER TO A-140 SERIES FOR FURNITURE PLANS.

REFER TO A-200 SERIES FOR EXTERIOR ELEVATIONS.

REFER TO A-300 SERIES FOR BUILDING AND WALL SECTIONS.


REFER TO A-400 SERIES FOR ENLARGED VIEWS.

REFER TO A-500 SERIES FOR EXTERIOR DETAILS.

REFER TO A-550 SERIES FOR INTERIOR DETAILS.

REFER TO A-600 SERIES FOR SCHEDULES.

REFER TO FIRE PROTECTION, PLUMBING, MED GAS, MECHANICAL, ELECTRICAL, AND TECHNOLOGY DRAWINGS FOR SPECIFIC DEVICE AND FIXTURE INFORMATION.

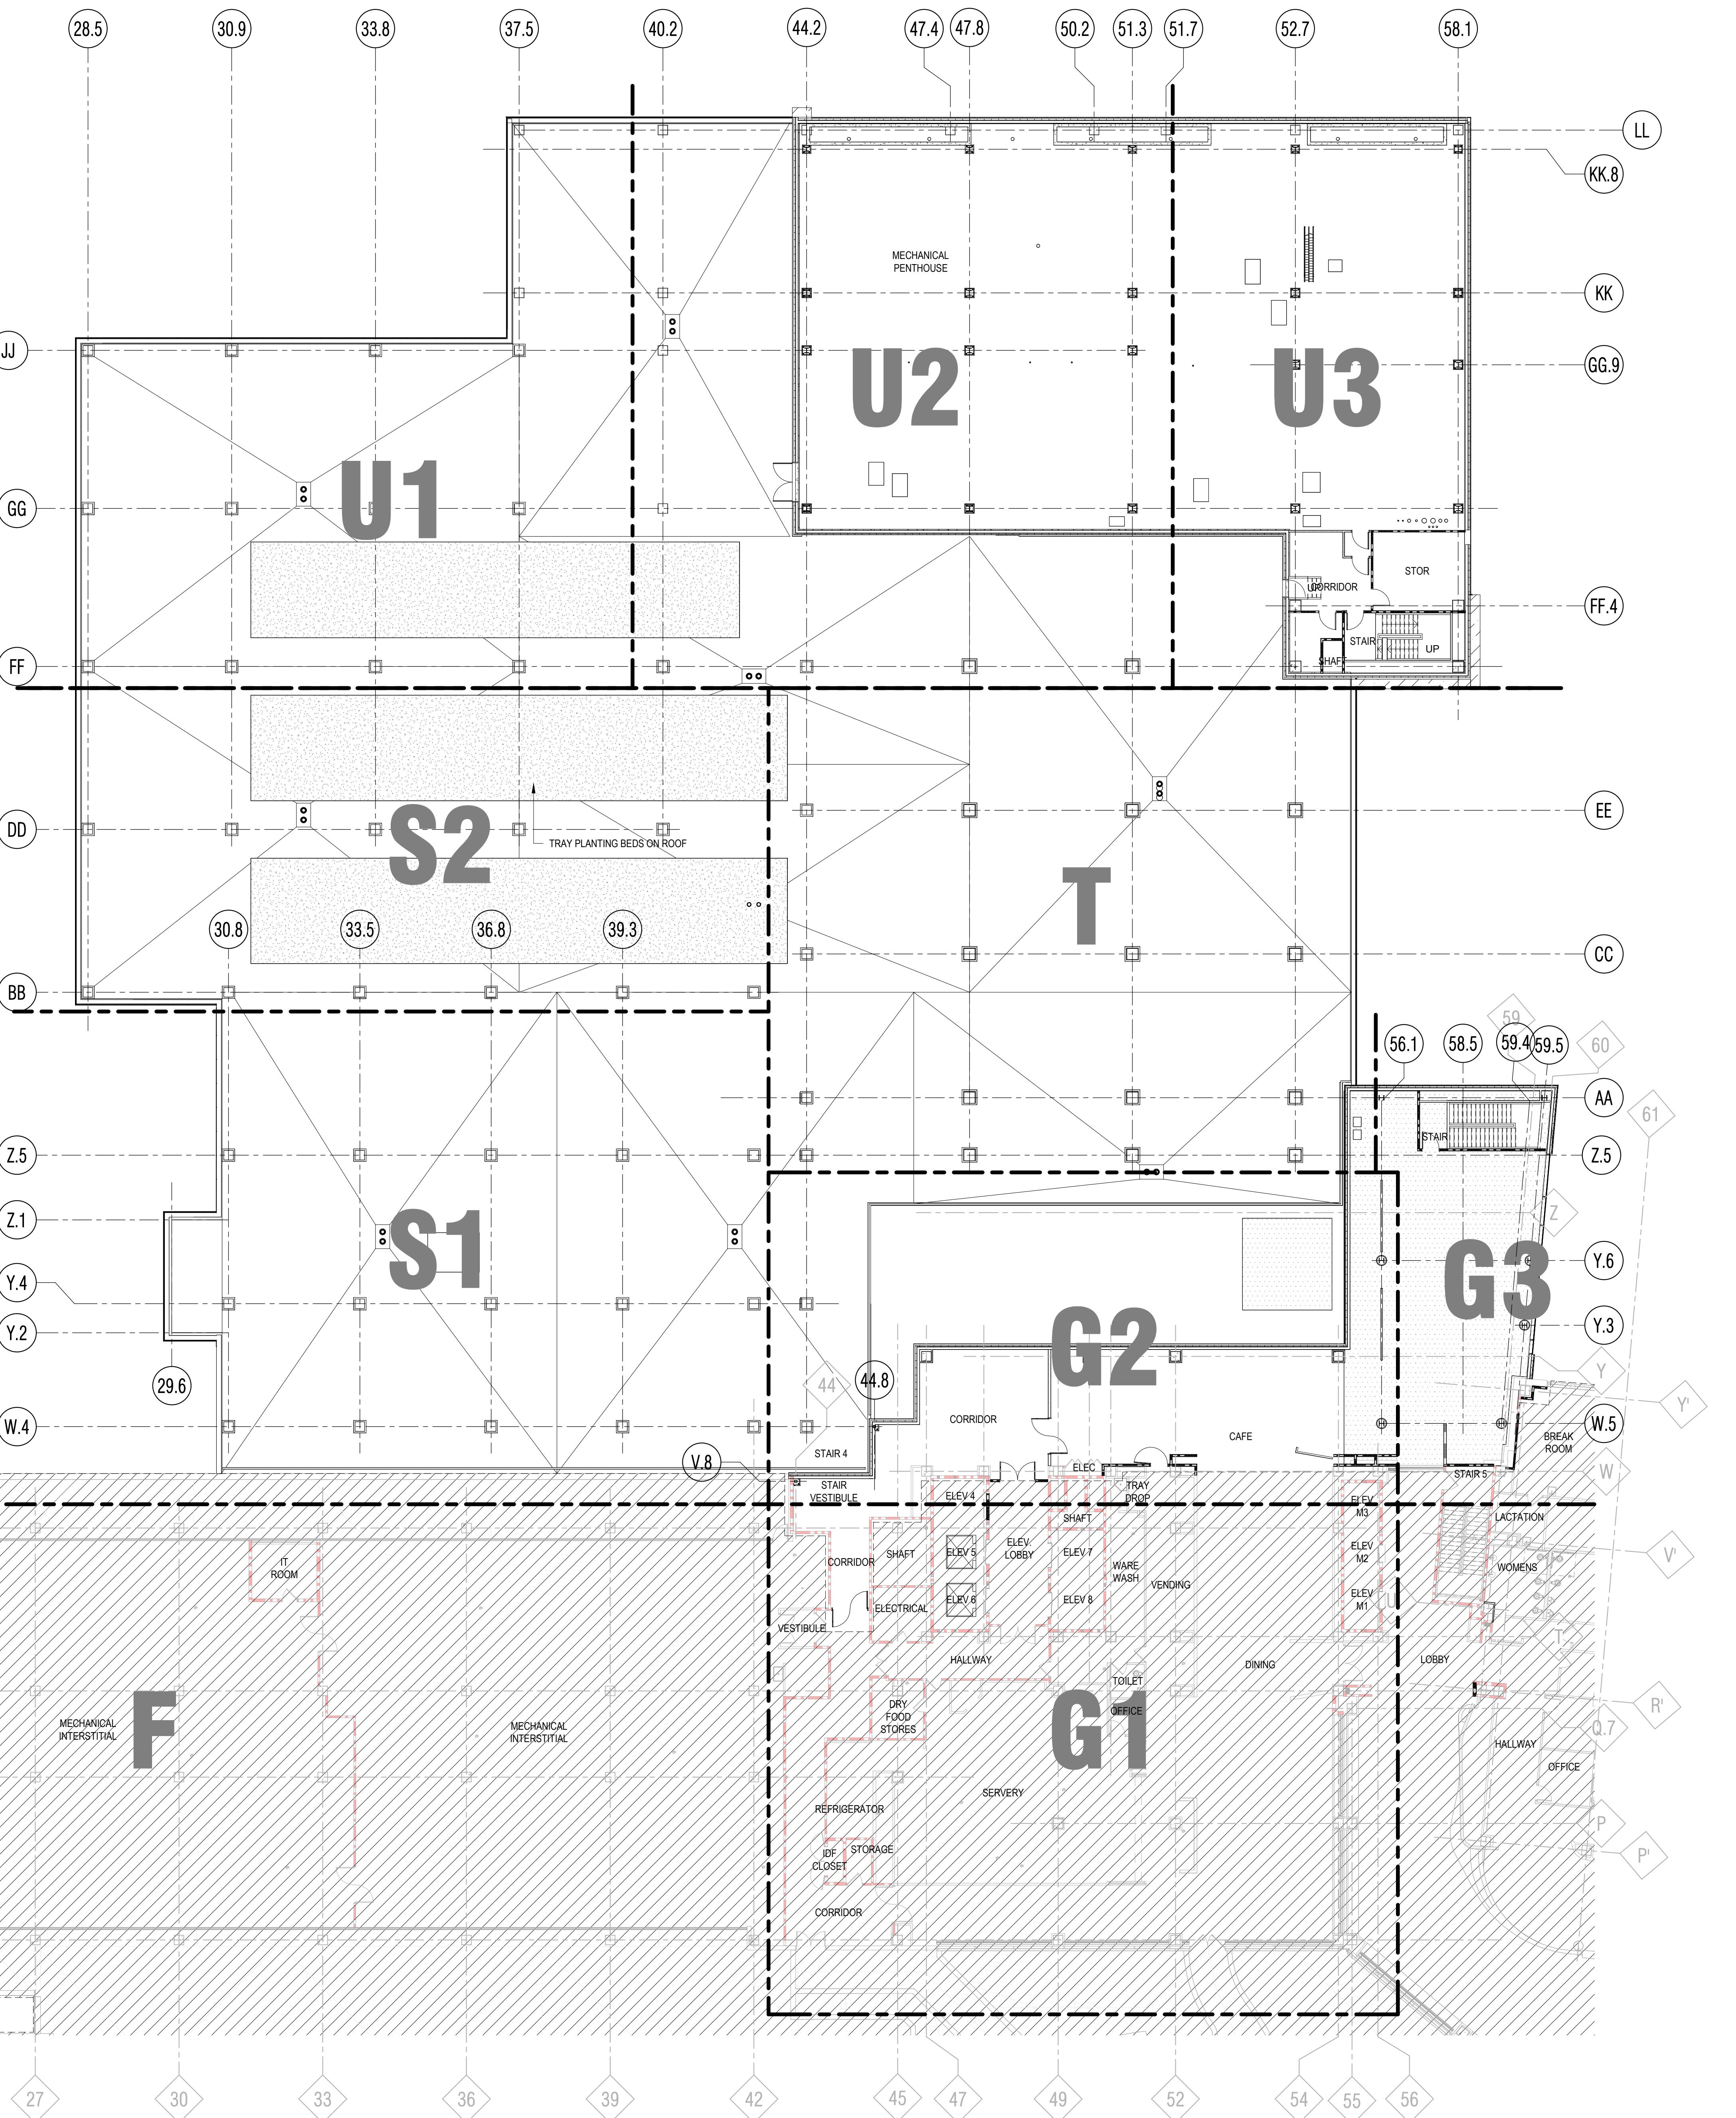

# 1 OVERALL FLOOR PLAN - LEVEL 2

1/16" = 1' 0"

1/16" = 1'-0"



# NOT IN SCOPE

Sheet Number

GLAZING CALCULATIONS	
TOTAL SF OF GLAZING AREAS < 50 SF	690 SF (19%)
TOTAL SF OF GLAZING AREAS > 50 SF*	2,932 SF (81%)
* ALL VISION GLAZING WITH AN AREA OF 50 SF OR ABOVE TO BE TREATED WITH BIRD SAFE PATTERN COMPLYING WITH MADISON CITY ORDINANCE 28.129.	

Flad


Ruekert·Mielke

Flad Structural  
ENGINEERS

AEI Affiliated  
Engineers

WALSH  
CONSULTING GROUP

Findorff

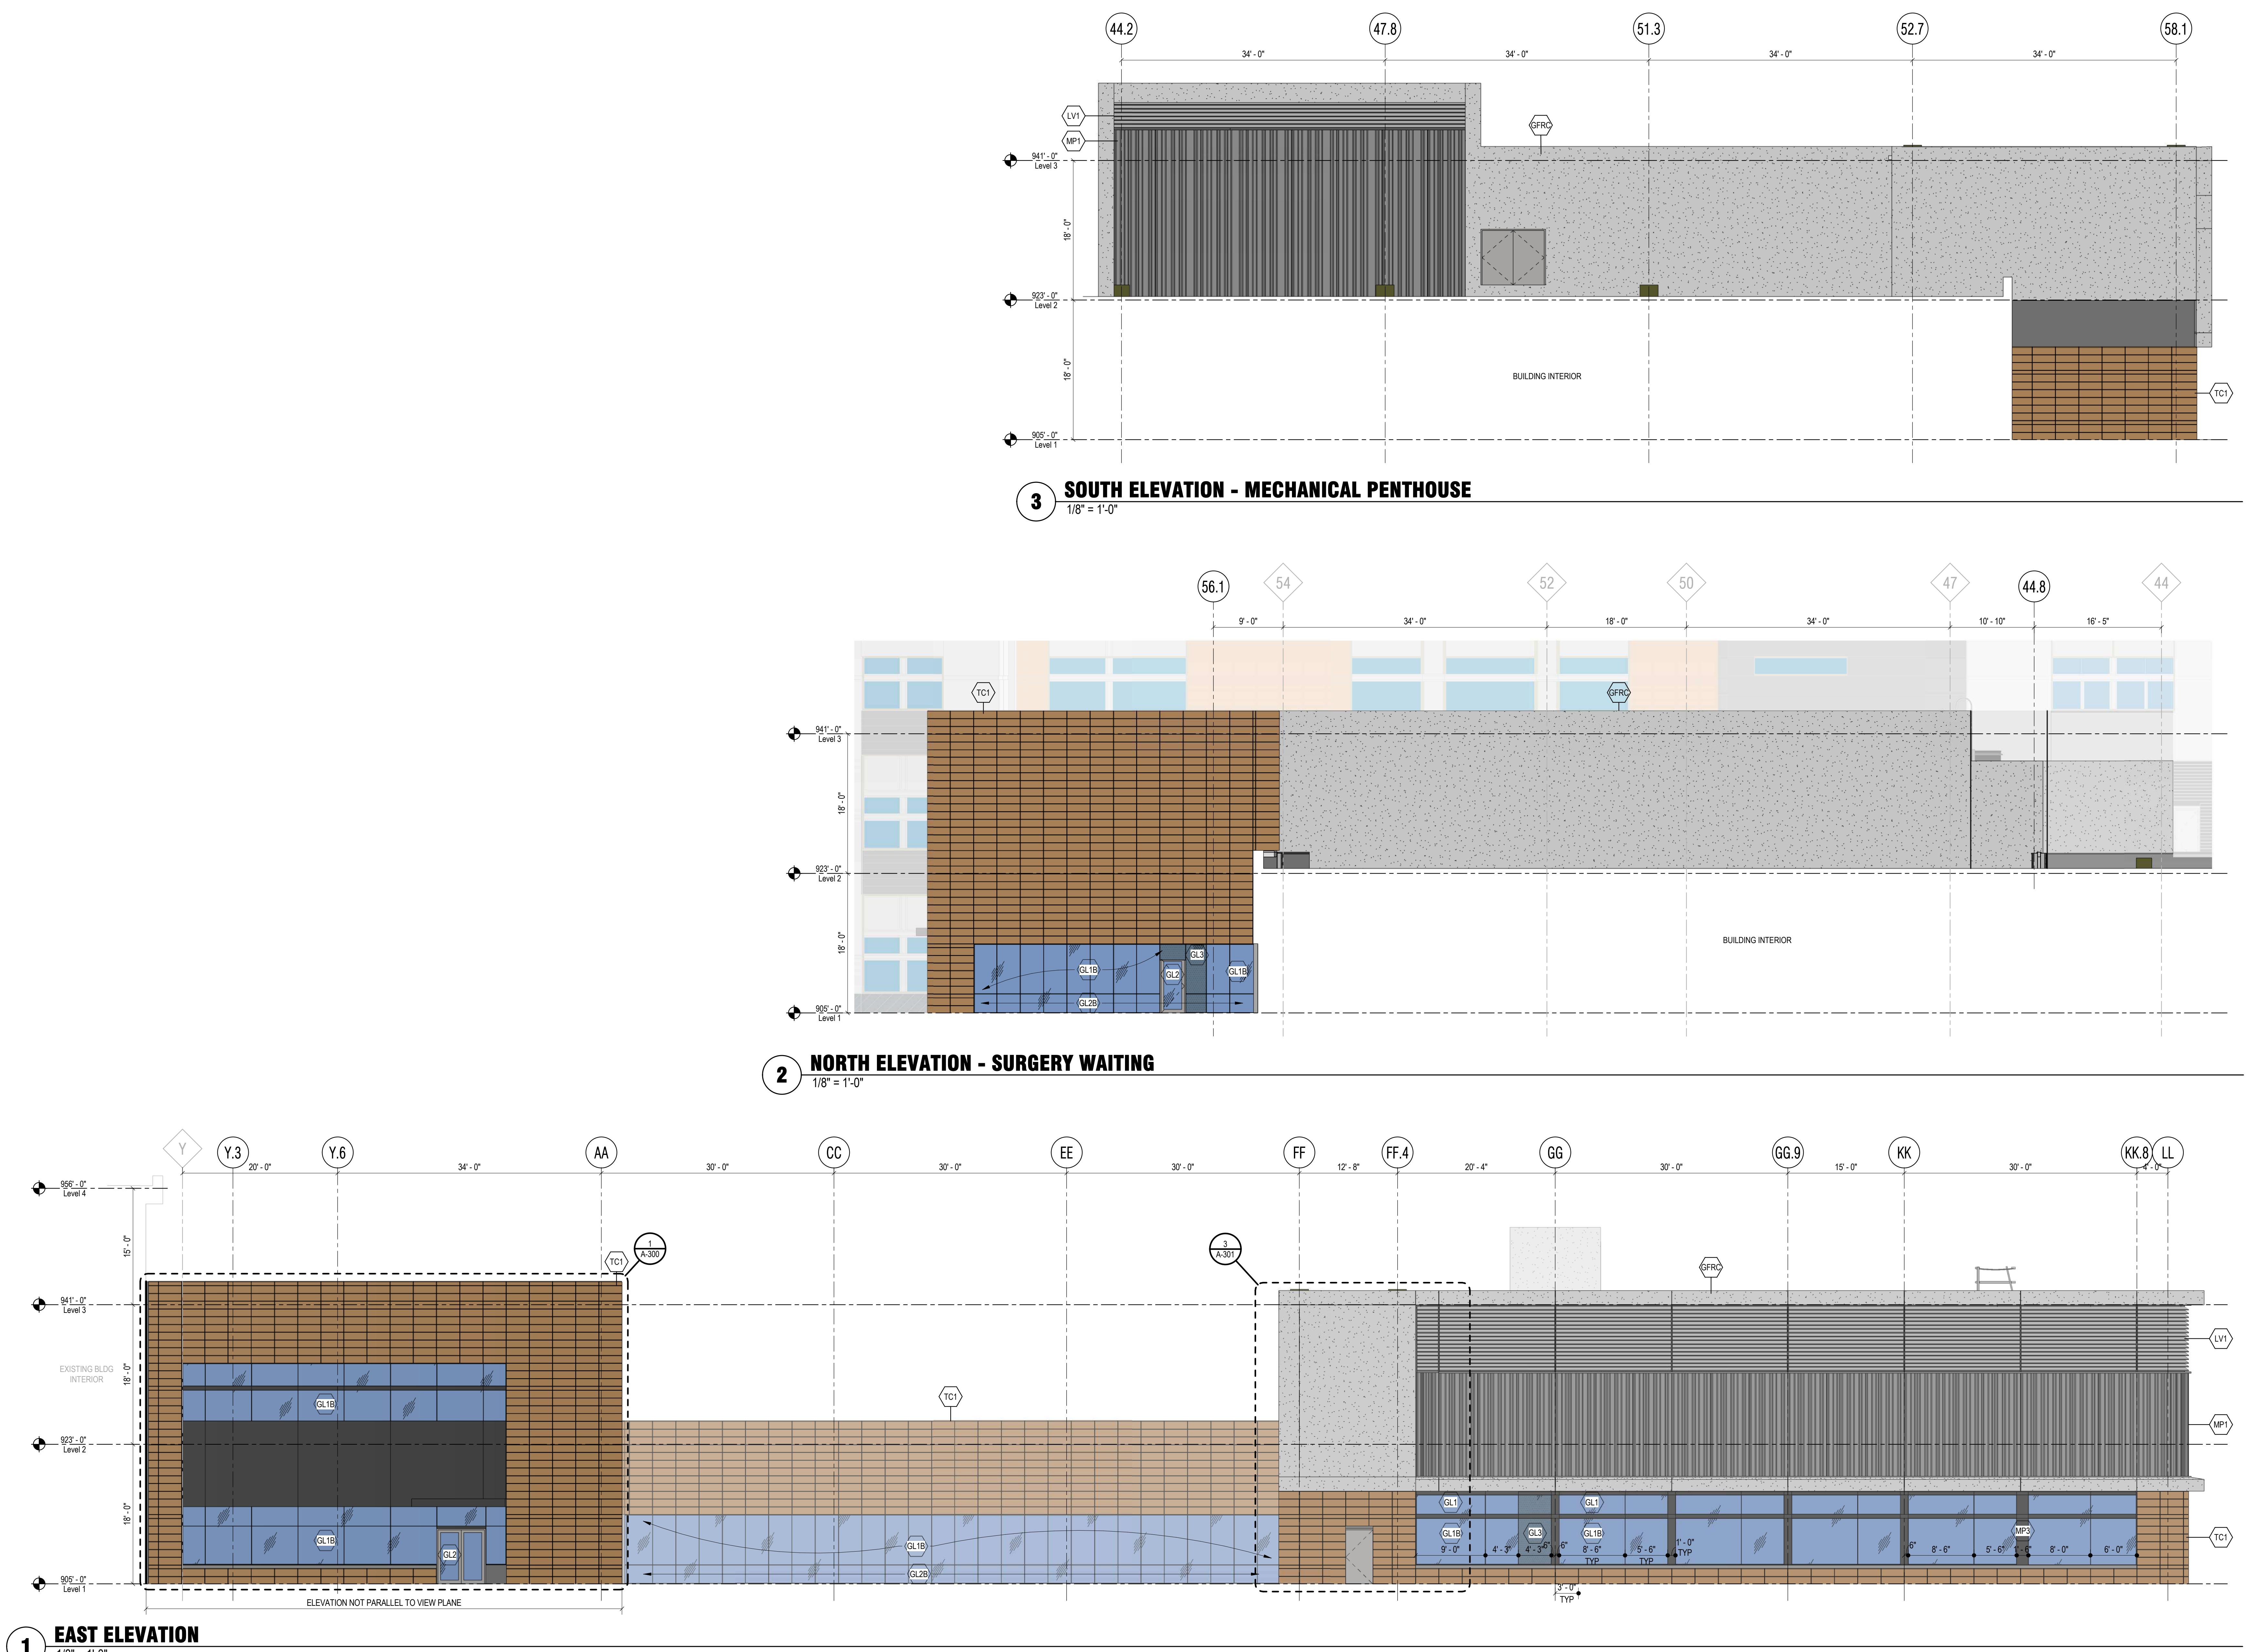

#### GENERAL SHEET NOTES

- 1 REFER TO G-100 SERIES FOR LIFE SAFETY PLANS LOCATING RATED CONSTRUCTION, EG: SMOKE BARRIERS, FIRE BARRIERS, AND SMOKA PARTITIONS.
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#### GENERAL EXTERIOR NOTES

- 1 FLOOR PLAN CUT PLANS AT 1/8" REF UNO.
- 2 FLOOR ELEVATIONS ARE TO TOP OF SLAB UNO.
- 3 INTERIOR PARTITIONS, CEILING, AND EQUIPMENT ARE SHOWN FOR REFERENCE ONLY. REFER TO THE INTERIOR FLOOR PLANS, CEILING PLANS, AND INTERIOR DETAILS FOR MORE INFORMATION.
- 4 ALL PANEL JOINTS AND REVEALS ARE DIMENSIONED TO THE CENTERLINE OF THE JOINT UNO.
- 5 DIMENSIONS FOR CURTAINWALL ARE TO THE EXTERIOR FACE OF GLASS.
- 6 PROVIDE 4" CURTAINWALL INACTIVE LOUVERS. ALL SPACERS GLUE TAPE ALL JOINTS AND PENETRATIONS.
- 7 PROVIDE INSULATED BLANK-OFF PANEL AT INACTIVE LOUVERS. COORDINATE LOCATION WITH MECHANICAL.

#### SHEET KEYNOTES

#### SPEC KEYNOTES


#### EXTERIOR MATERIALS LEGEND

- (MP1) - COATED VERTICAL STEEL SIDING
- (GL1) - VISION GLASS
- (MP2) - COATED FLAT METAL PANEL, COLOR TO MATCH MP1
- (GL2) - VISION GLASS WITH BIRD SAFE PATTERN
- (MP3) - COATED METAL PANEL GLAZED INTO WINDOW SYSTEM - COLOR TO MATCH MULLION COLOR, TYP.
- (GL3) - TEMPERED VISION GLASS
- (TC1) - TERRA COTTA PANEL RAIN SCREEN SYSTEM
- (GL4) - TEMPERED VISION GLASS WITH BIRD SAFE PATTERN
- (GL5) - OPAQUE SPANDREL GLASS
- (SFRC) - GLASS FIBER REINFORCED CONCRETE


**UW Health**  
**UW HEALTH: EAST MADISON HOSPITAL**  
4602 EASTPARK BLVD.  
MADISON, WI 53718

**PHASE 1 EXPANSION**

Project Phase  
LAND USE APPLICATION  
Date  
08/07/24  
Drawn By  
FLAD  
Project Number  
24764-00  
Checked By  
FLAD  
Sheet Title  
**EXTERIOR ELEVATIONS**  
Sheet Number  
A-200  
Rev. No.

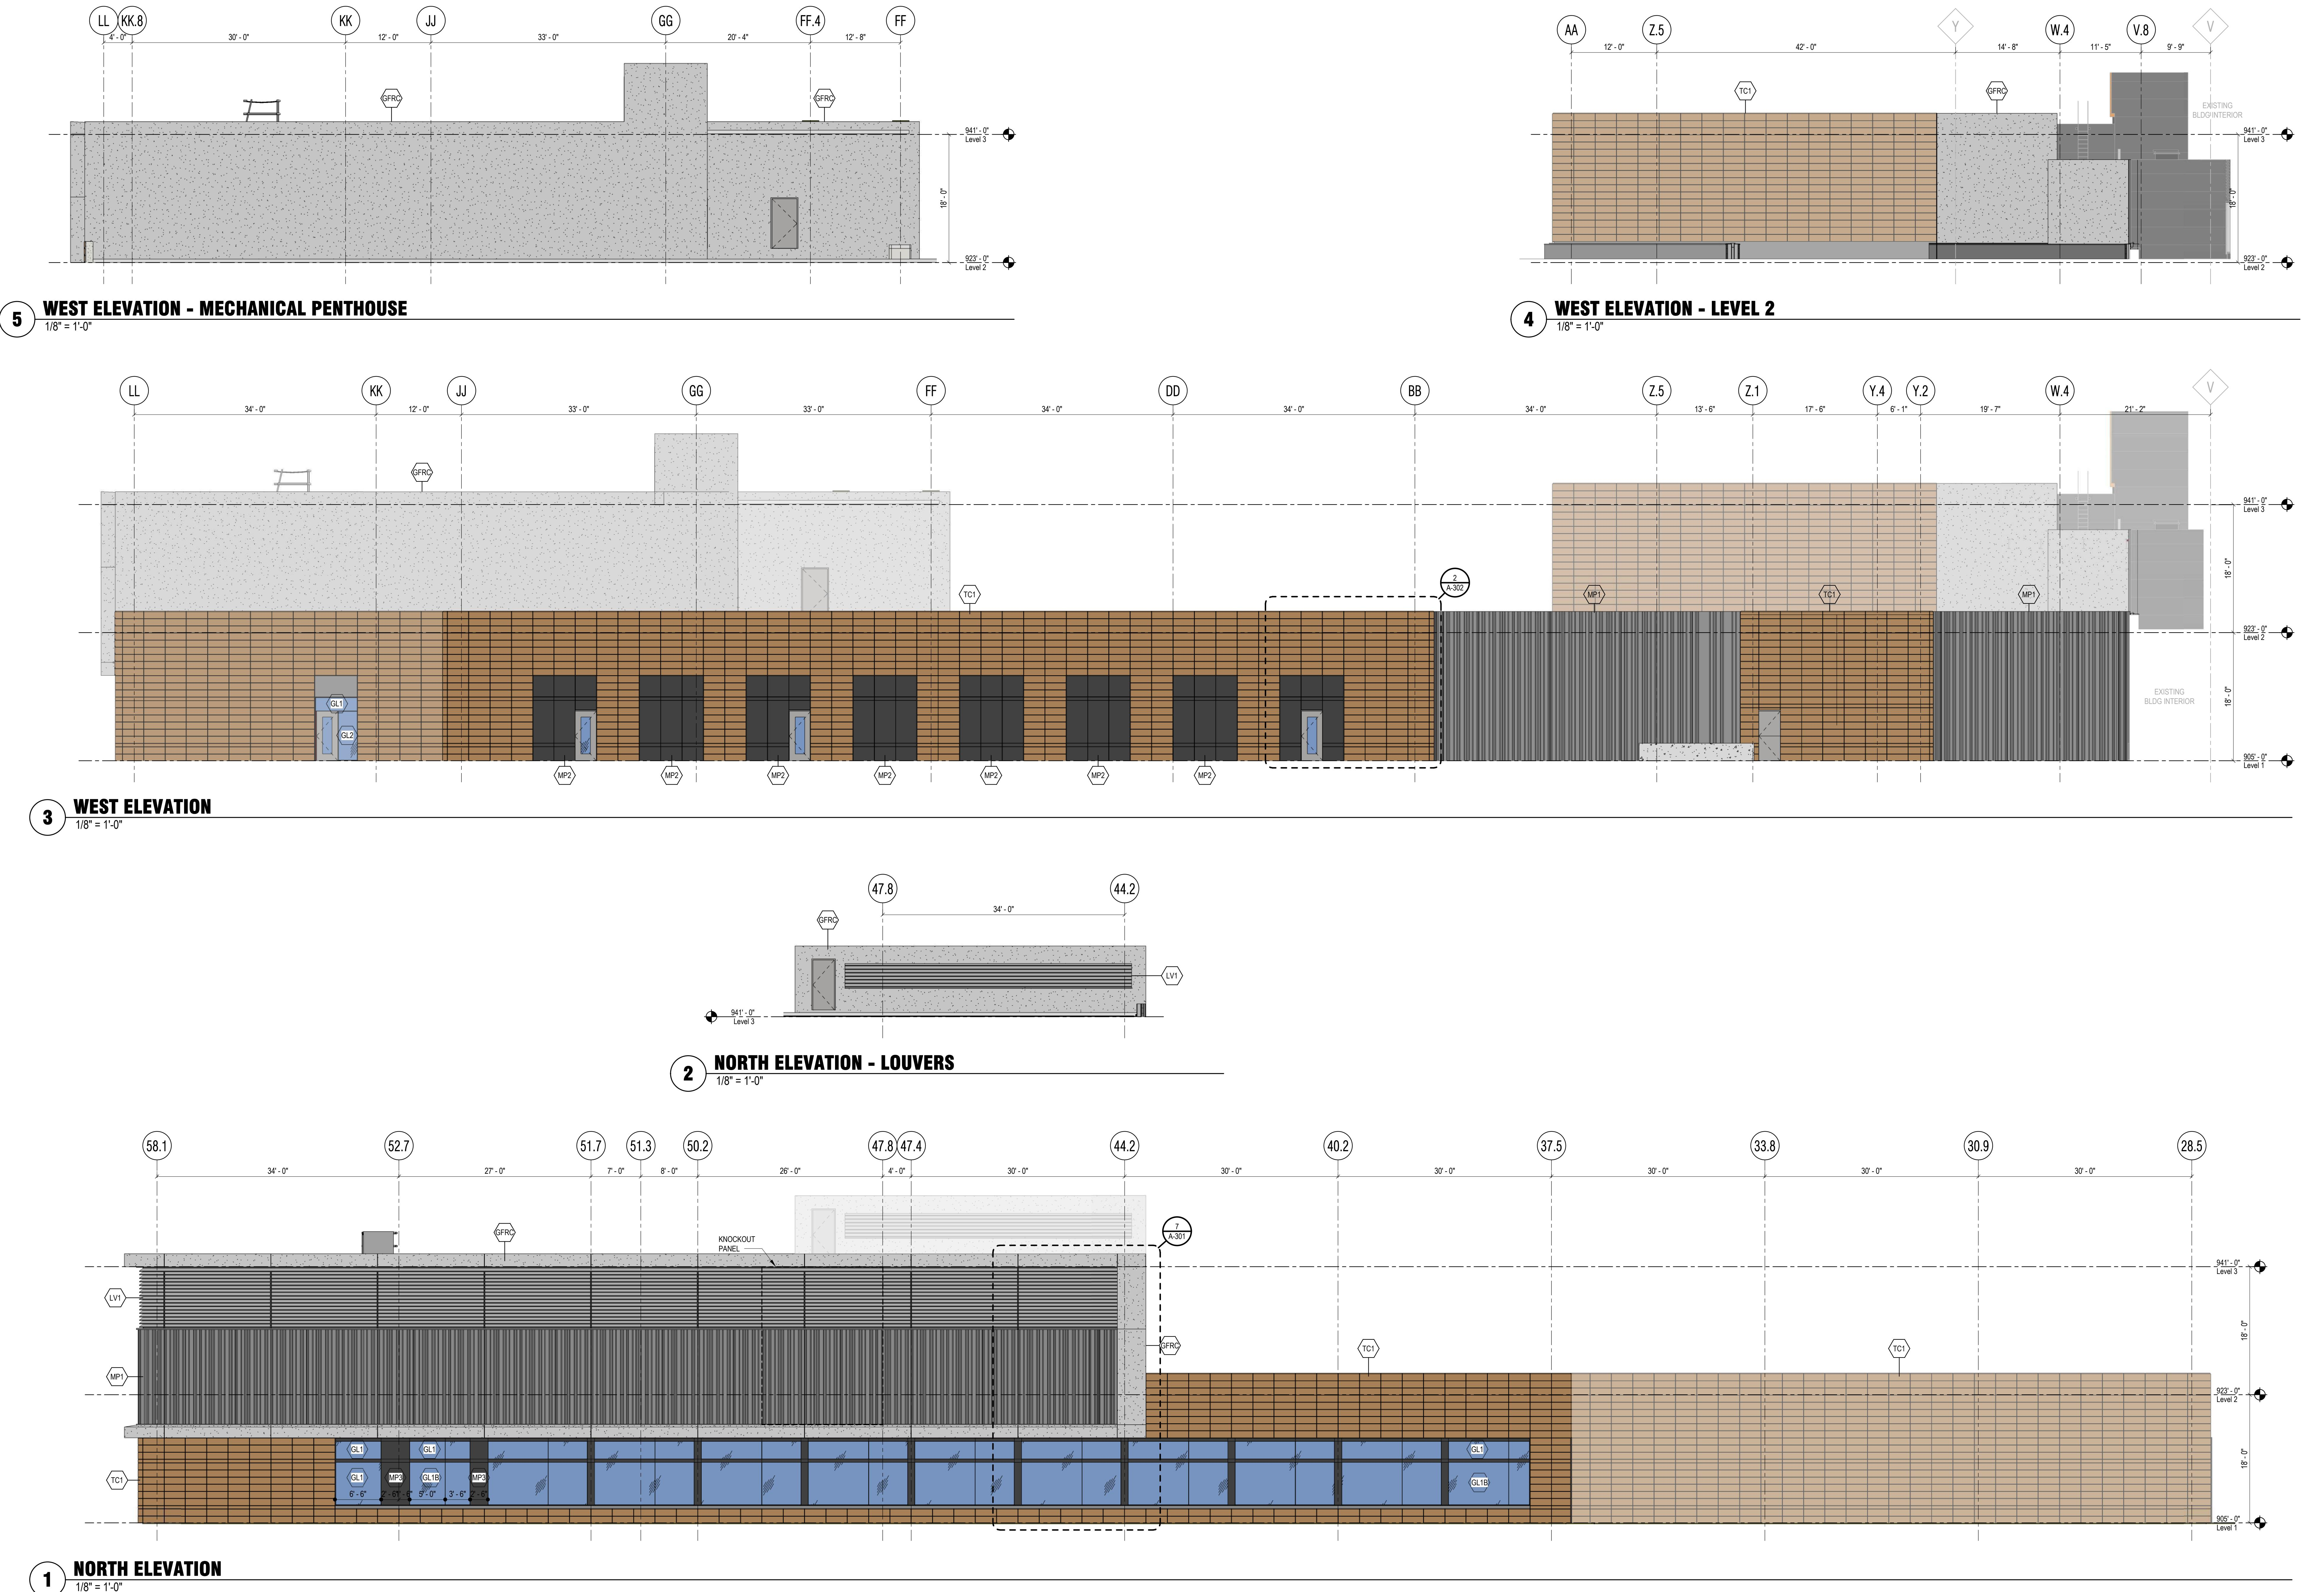


GENERAL SHEET NOTES		GENERAL EXTERIOR NOTES		SHEET KEYNOTES		SPEC KEYNOTES		EXTERIOR MATERIALS LEGEND			
<p>1 REFER TO G-100 SERIES FOR LIFE SAFETY PLANS LOCATING RATED CONSTRUCTION, EG: SMOKE BARRIERS, FIRE BARRIERS, AND SMOKE PARTITIONS.</p> <p>2 REFER TO THE AD SERIES FOR ARCHITECTURAL DEMOLITION PLANS AND ELEVATIONS.</p> <p>3 REFER TO A-100 SERIES FOR ENCLOSURE PLANS, EXTERIOR ELEVATION CALLOUTS, AND SECTION CALLOUTS.</p> <p>4 REFER TO A-110 SERIES FOR FLOOR PLANS AND INTERIOR ELEVATION CALLOUTS.</p> <p>5 REFER TO A-120 SERIES FOR REFLECTED CEILING PLANS.</p> <p>6 REFER TO A-130 SERIES FOR FINISH PLANS.</p> <p>7 REFER TO A-140 SERIES FOR FURNITURE PLANS.</p> <p>8 REFER TO A-200 SERIES FOR EXTERIOR ELEVATIONS.</p> <p>9 REFER TO A-300 SERIES FOR BUILDING AND WALL SECTIONS.</p> <p>10 REFER TO A-400 SERIES FOR ENLARGED VIEWS.</p> <p>11 REFER TO A-500 SERIES FOR EXTERIOR DETAILS.</p> <p>12 REFER TO A-550 SERIES FOR INTERIOR DETAILS.</p> <p>13 REFER TO A-600 SERIES FOR SCHEDULES.</p> <p>14 REFER TO FIRE PROTECTION, PLUMBING, MED GAS, MECHANICAL, ELECTRICAL, AND TECHNOLOGY DRAWINGS FOR SPECIFIC DEVICE AND FIXTURE INFORMATION.</p>		<p>1 FLOOR PLAN CUT PLANE AT 4'-0" AFF U.N.O.</p> <p>2 FLOOR ELEVATIONS ARE TO TOP OF SLAB U.N.O.</p> <p>3 INTERIOR PARTITIONS, CEILING, AND EQUIPMENT ARE SHOWN FOR REFERENCE ONLY. REFER TO THE INTERIOR FLOOR PLANS, CEILING PLANS, AND INTERIOR DETAILS FOR MORE INFORMATION</p> <p>4 ALL PANEL JOINTS AND REVEALS ARE DIMENSIONED TO THE CENTERLINE OF THE JOINT U.N.O.</p> <p>5 DIMENSIONS FOR CURTAINWALL ARE TO THE EXTERIOR FACE OF GLASS</p> <p>6 PROVIDE 4" CURTAINWALL INSULATION BEHIND ALL SPANDREL GLASS. TAPE ALL JOINTS AND PENETRATIONS</p> <p>7 PROVIDE INSULATED BLANK-OFF PANEL AT INACTIVE LOUVERS. COORDINATE LOCATION WITH MECHANICAL</p>		<p>1 GLASS - COATED VERTICAL STEEL SING</p> <p>2 GLASS - COATED METAL PANEL WITH SPANDREL</p> <p>3 GLASS - COATED METAL PANEL LAZED INTO WINDOW SYSTEM COLOR TO MATCH MILK COLOR</p> <p>4 GLASS - THERMAL INSULATED PANEL</p> <p>5 GLASS - THERMAL INSULATED PANEL</p> <p>6 GLASS - THERMAL INSULATED PANEL</p> <p>7 GLASS - COATED ALUMINUM STORM PROOF LOUVERS WITH CONCEALED VERTICAL SPLICES, TYPE L1</p> <p>8 GRC - GLASS FIBER REINFORCED CONCRETE</p>		<p>1 GLASS - COATED VERTICAL STEEL SING</p> <p>2 GLASS - COATED METAL PANEL WITH SPANDREL</p> <p>3 GLASS - COATED METAL PANEL LAZED INTO WINDOW SYSTEM COLOR TO MATCH MILK COLOR</p> <p>4 GLASS - THERMAL INSULATED PANEL</p> <p>5 GLASS - THERMAL INSULATED PANEL</p> <p>6 GLASS - THERMAL INSULATED PANEL</p> <p>7 GLASS - COATED ALUMINUM STORM PROOF LOUVERS WITH CONCEALED VERTICAL SPLICES, TYPE L1</p> <p>8 GRC - GLASS FIBER REINFORCED CONCRETE</p>		<p>1 GLASS - COATED VERTICAL STEEL SING</p> <p>2 GLASS - COATED METAL PANEL WITH SPANDREL</p> <p>3 GLASS - COATED METAL PANEL LAZED INTO WINDOW SYSTEM COLOR TO MATCH MILK COLOR</p> <p>4 GLASS - THERMAL INSULATED PANEL</p> <p>5 GLASS - THERMAL INSULATED PANEL</p> <p>6 GLASS - THERMAL INSULATED PANEL</p> <p>7 GLASS - COATED ALUMINUM STORM PROOF LOUVERS WITH CONCEALED VERTICAL SPLICES, TYPE L1</p> <p>8 GRC - GLASS FIBER REINFORCED CONCRETE</p>		<p>1 GLASS - COATED VERTICAL STEEL SING</p> <p>2 GLASS - COATED METAL PANEL WITH SPANDREL</p> <p>3 GLASS - COATED METAL PANEL LAZED INTO WINDOW SYSTEM COLOR TO MATCH MILK COLOR</p> <p>4 GLASS - THERMAL INSULATED PANEL</p> <p>5 GLASS - THERMAL INSULATED PANEL</p> <p>6 GLASS - THERMAL INSULATED PANEL</p> <p>7 GLASS - COATED ALUMINUM STORM PROOF LOUVERS WITH CONCEALED VERTICAL SPLICES, TYPE L1</p> <p>8 GRC - GLASS FIBER REINFORCED CONCRETE</p>	

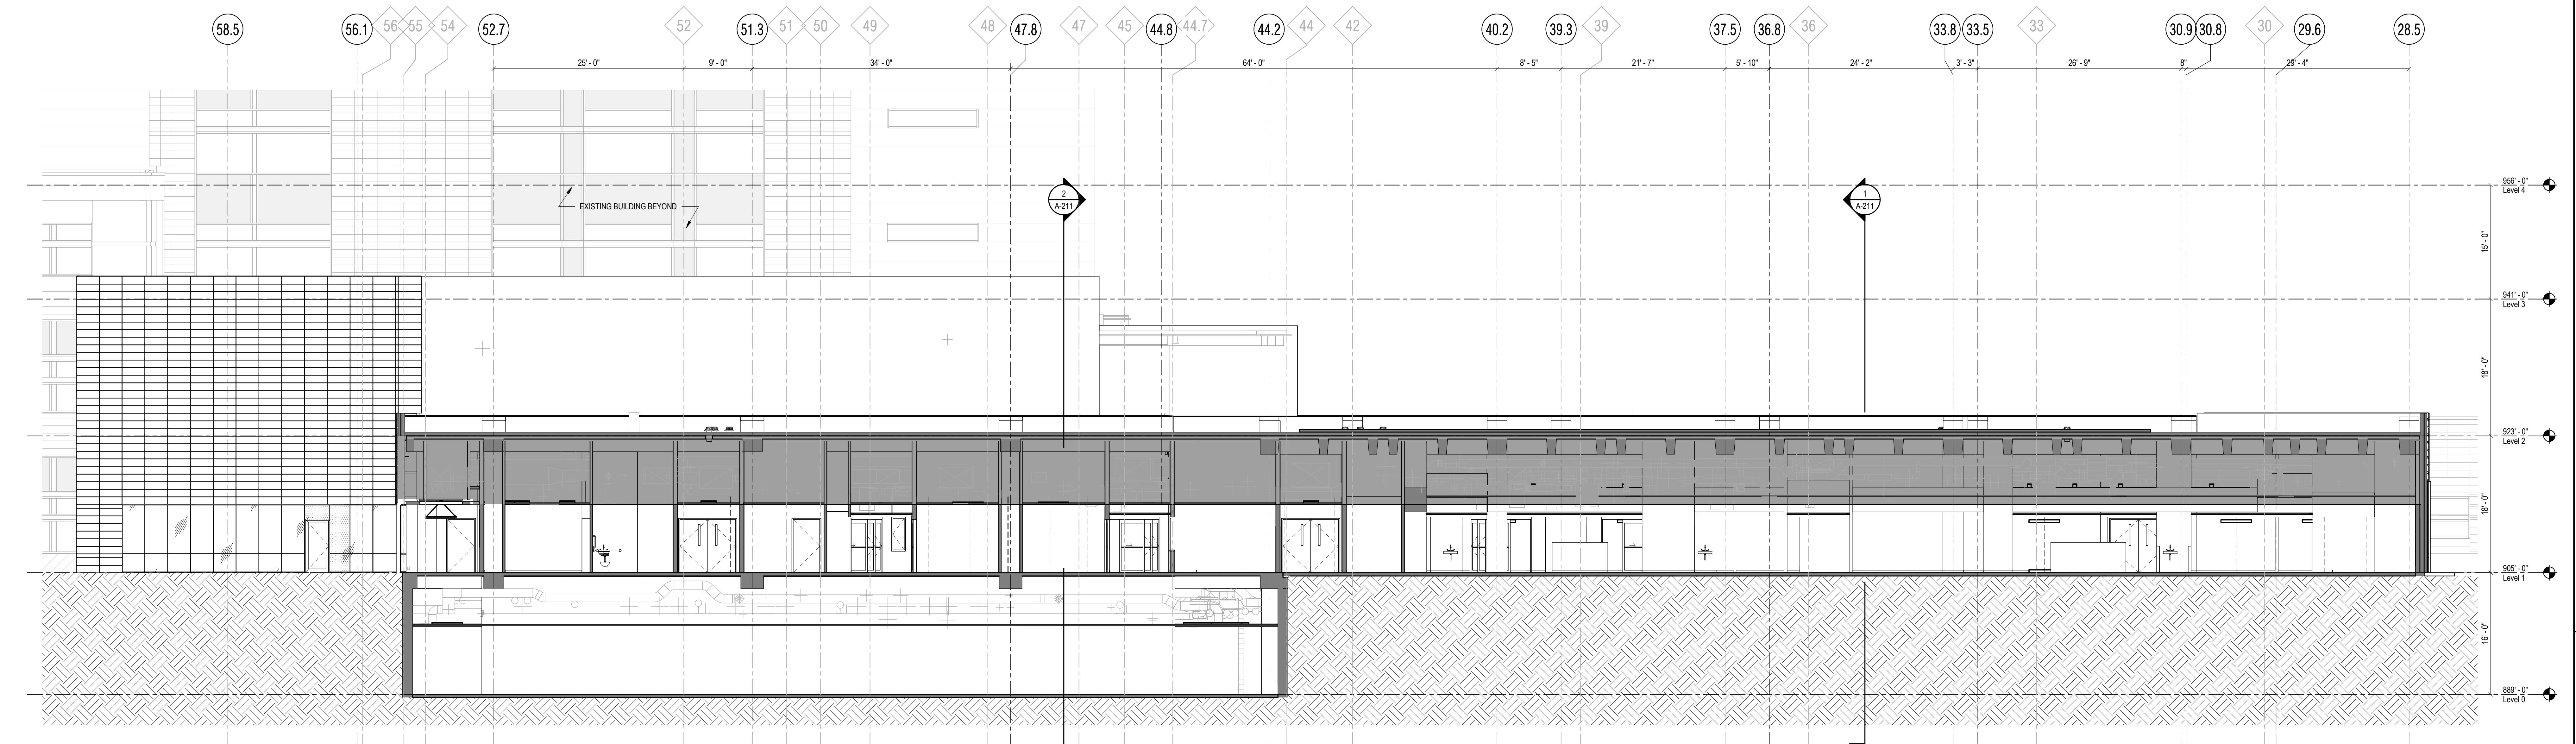

2 EW BUILDING SECTION

1/8" = 1'-0"

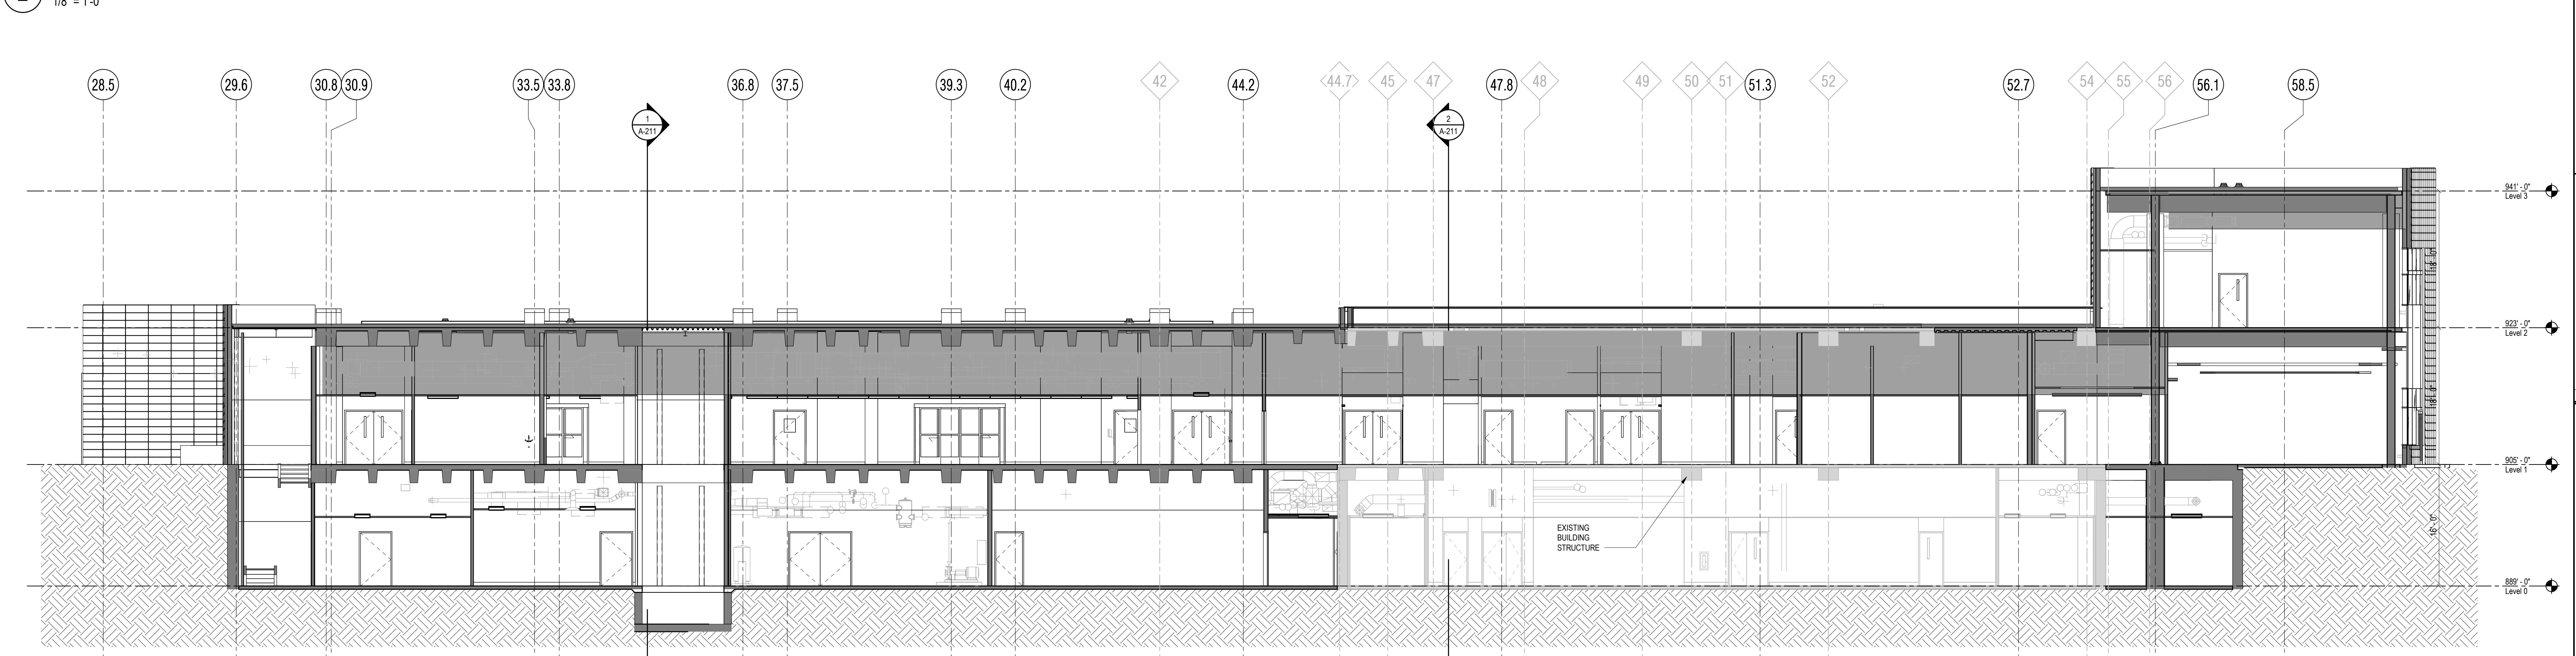

1 EW BUILDING SECTION LOOKING NORTH

1/8" = 1'-0"

GENERAL SHEET NOTES		GENERAL EXTERIOR NOTES	
1 REFER TO G-100 SERIES FOR LIFE SAFETY PLANS LOCATING RATED CONSTRUCTION, EG: SMOKE BARRIERS, FIRE BARRIERS, AND SMOKA PARTITIONS.	1 FLOOR PLAN CUT PLANS AT 1/8" OFF UNO.		
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7 REFER TO A-140 SERIES FOR FURNITURE PLANS.	7 PROVIDE INSULATED BLANK-OFF PANEL AT INACTIVE LOUVERS. COORDINATE LOCATION WITH MECHANICAL.		
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NOT FOR  
CONSTRUCTION

UWHealth

UW HEALTH:  
EAST MADISON  
HOSPITAL4602 EAST PARK BLVD.  
MADISON, WI 53718PHASE 1  
EXPANSION

Project Phase LAND USE APPLICATION	
Date	Drawn By
08/07/24	FLAD
Project Number	Checked By
24764-00	FLAD
Sheet Title	
BUILDING SECTIONS - EW	
Sheet Number	Rev. No.
A-210	





# UW HEALTH: EAST MADISON HOSPITAL PHASE 1 EXPANSION


Client Logo

Client Project Number  
**53150**

Flad Project Number  
**24764-00**

**4602 EASTPARK BLVD.  
MADISON, WI 53718**

Project Location

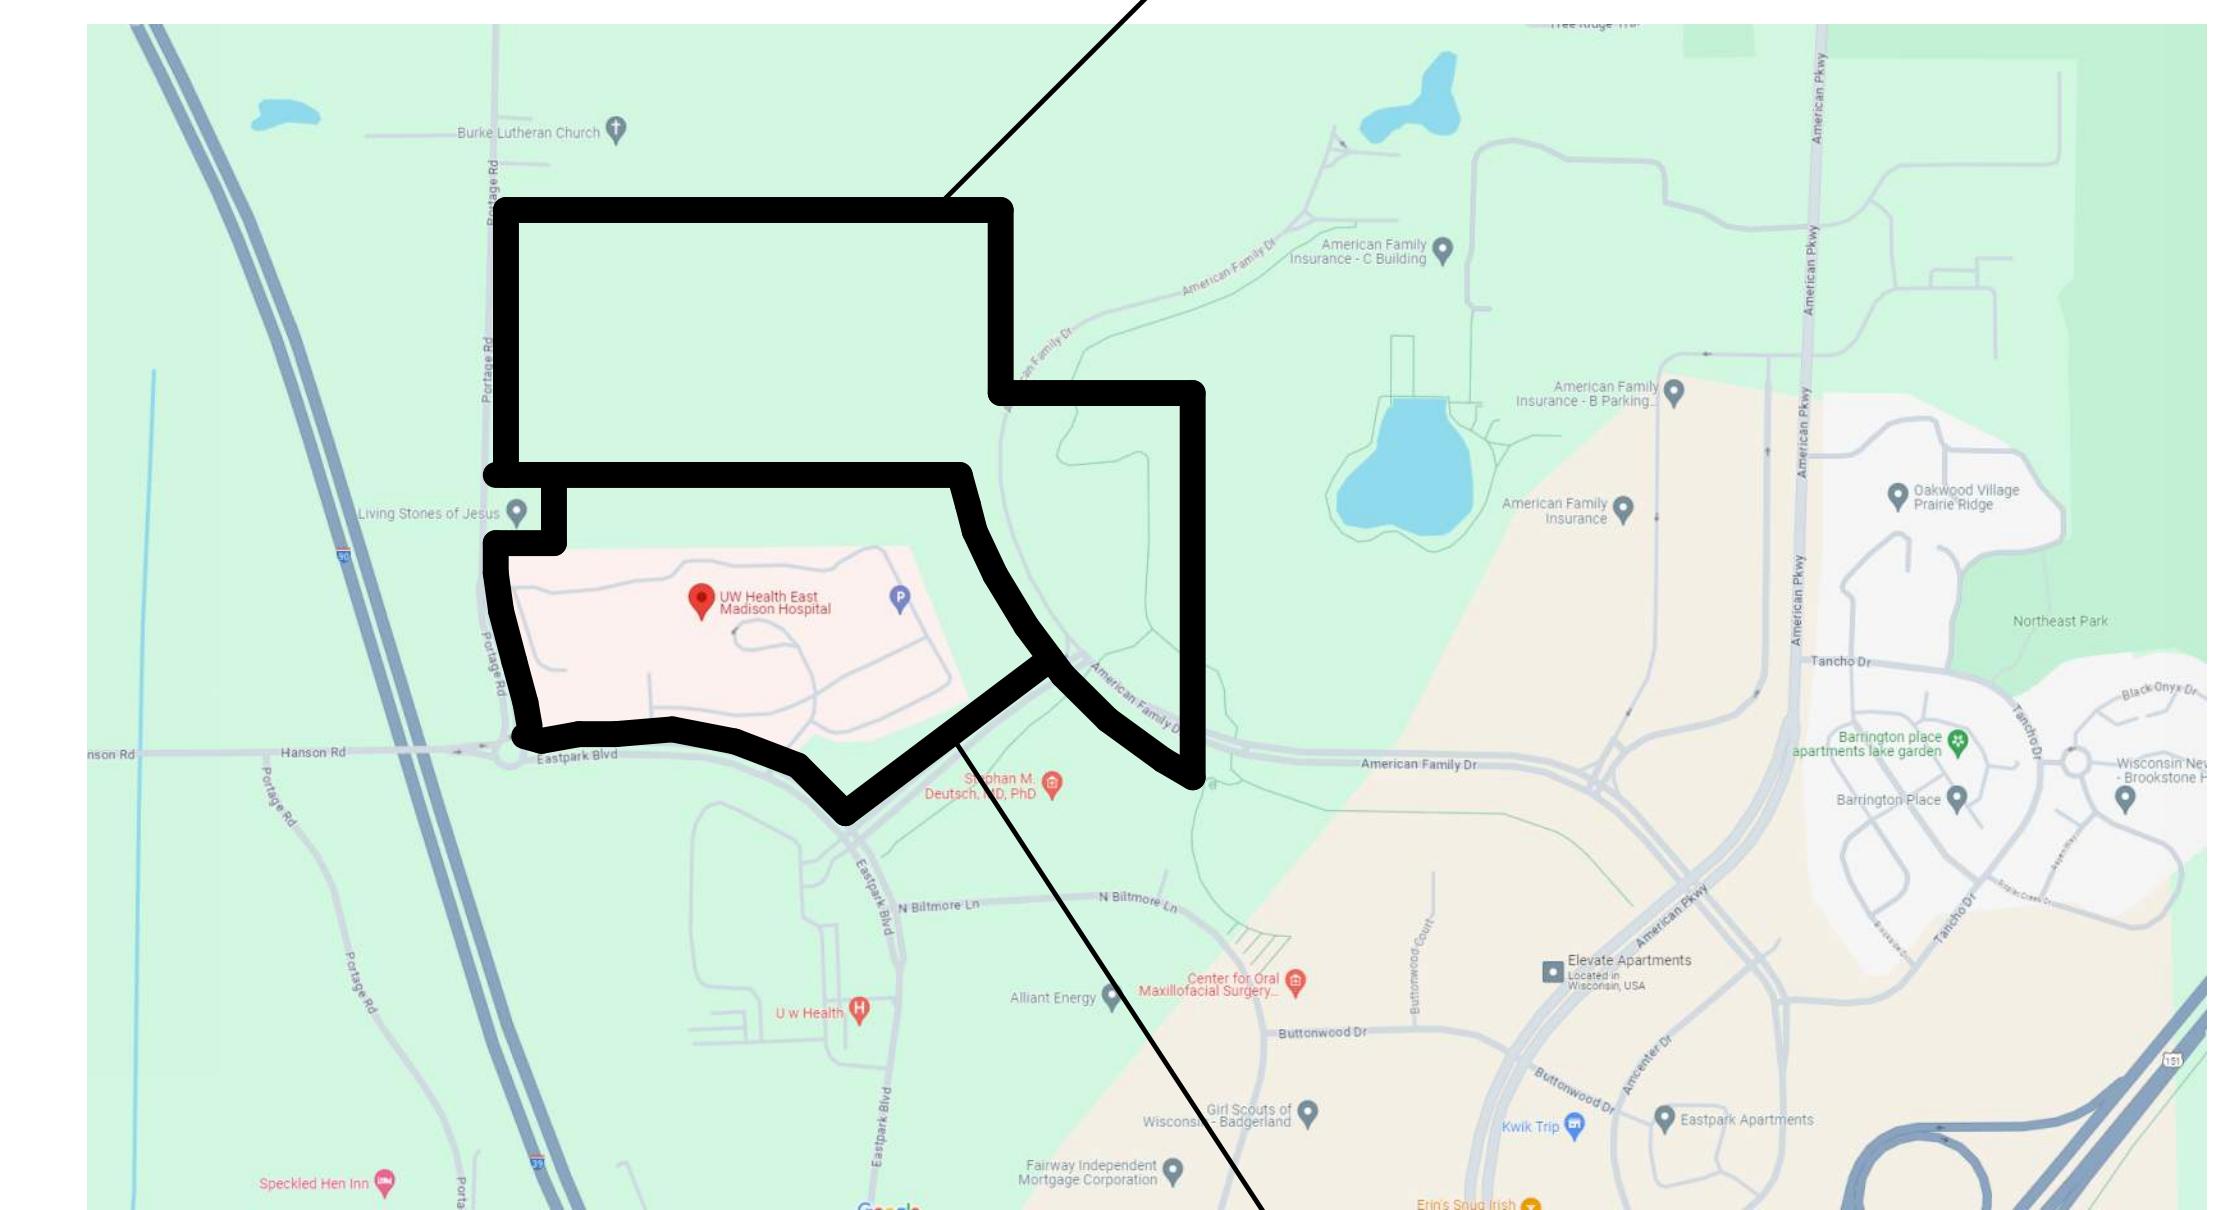

Site Key Plan - Location Plan

Description of Package  
**LAND USE APPLICATION - PLANS LANDSCAPE  
General**

Date  
**08/07/24**

Optional Project Info

Project Image - Rendering

Optional Project Info

Architect



Flad & Associates, Inc.  
644 Science Drive  
Madison, WI 53711  
Tel 608-238-2601  
Fax 608-238-6727  
Flad.com

Civil Engineer



Ruekert & Mielke, Inc.  
4630 S Blumore Lane  
Madison, WI 53718  
Tel 608-819-2600  
ruekertmielke.com/  
Flad.com

Structural Engineer



Flad & Associates, Inc.  
644 Science Drive  
Madison, WI 53711  
Tel 608-238-2601  
Fax 608-238-6727  
Flad.com

MEP Engineer



Affiliated Engineers, Inc.  
5802 Research Park Blvd.  
Madison, WI 53719  
Tel 608-238-2601  
aeieng.com

Medical Equipment Planner



Walsh Consulting Group, Inc.  
1275 Milwaukee Avenue  
Green Bay, WI 54325  
Tel 847-699-2500  
Fax 847-699-2524  
wcg-inc.com

General Contractor



Findorff  
300 S. Bedford Street  
Madison, WI 53703  
Tel 608-257-5321  
findorff.com/

Consultant

Stamps & Approvals

Project Regulatory Data

Volume Index

Project:	By Project	Building Type:	By Project
Location:	By Project	Sprinklers:	By Project
Owner:	By Project	Zoning:	By Project
Building Code:	By Project	Accessibility Requirements:	By Project
Occupancy:	By Project	Governing Agency or Authority:	By Project

Volume 1 - Civil and Landscape  
Volume 2 - Site Development  
Volume 3 - Architectural and Medical Equipment  
Volume 4 - Fire Protection, Plumbing, and Med Gas  
Volume 5 - Mechanical  
Volume 6 - Electrical and Technology

1

11

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# **SHEET INDEX - LAND USE - TITLE SHEETS**

SHEET NAME	
TITLE SHEET - LAND USE APPLICATION - PLANS	X
INDEX - LAND USE APPLICATION - PLANS	X
SECOND SAFE GLASS INFORMATION	X

## **SHEET INDEX - LAND USE - ARCHITECTURAL**

SHEET NUMBER	SHEET NAME	08/07/24 – CITY OF MADISON LAND USE APPLICATION
A-010	3D REPRESENTATION SE/NE	X
A-011	3D REPRESENTATION NW/SW	X
A-102-STG	ENCLOSURE PLAN - LEVEL 2 - AREA S / T / G	X
A-102-U	ENCLOSURE PLAN - LEVEL 2 - AREA U	X
A-103-STG	ROOF PLAN - LEVEL 3 - AREA S / T / G	X
A-103-U	ROOF PLAN - LEVEL 3 - AREA U	X
A-110	OVERALL FLOOR PLAN - LOWER LEVEL	X
A-111	OVERALL FLOOR PLAN - LEVEL 1	X
A-112	OVERALL FLOOR PLAN - LEVEL 2	X
A-200	EXTERIOR ELEVATIONS	X
A-201	EXTERIOR ELEVATIONS	X
A-210	BUILDING SECTIONS - EW	X
A-211	BUILDING SECTIONS - NS	X

# **HEET INDEX - LAND USE - CIVIL**

<b>SHEET INDEX - LAND USE - CIVIL</b>	
SHEET NAME	
EXISTING CONDITIONS	X
PROPOSED EROSION CONTROL	X
OVERALL DEMOLITION PLAN	X
OVERALL SITE PLAN	X
BUILDING EXPANSION SITE PLAN	X
PARKING LOT EXPANSION SITE PLAN	X
GREASE INTERCEPTOR AREA SITE PLAN	X
OVERALL GRADING PLAN	X
BUILDING EXPANSION GRADING PLAN	X
PARKING LOT EXPANSION GRADING PLAN	X
GREASE INTERCEPTOR AREA GRADING PLAN	X
PROPOSED OVERALL UTILITY PLAN	X
BUILDING EXPANSION UTILITY PLAN	X
PARKING LOT EXPANSION UTILITY PLAN	X
GREASE INTERCEPTOR AREA UTILITY PLAN	X
UTILITY PLAN AND PROFILES	X
CONSTRUCTION DETAILS	X
CONSTRUCTION DETAILS	X
MADISON FIRE ACCESS PLAN	X

# **HEET INDEX - LAND USE - LANDSCAPE**

SHEET NAME	
INTING PLAN (OVERALL)	
INTING PLAN (WEST)	
INTING PLAN (EAST)	
E PROTECTION AND REMOVAL PLAN	

## Stamps & Approvals

# NOT FOR CONSTRUCTION

# **UW Health**


## **UW HEALTH: EAST MADISON HOSPITAL**

# HOSPITAL

<p>Project Phase</p> <h1>LAND USE APPLICATION</h1>	
Date	Drawn By

08/07/24	FLAD
Project Number 24764-00	Checked By FLAD

Sheet Number	Rev. No.
<b>T-011</b>	

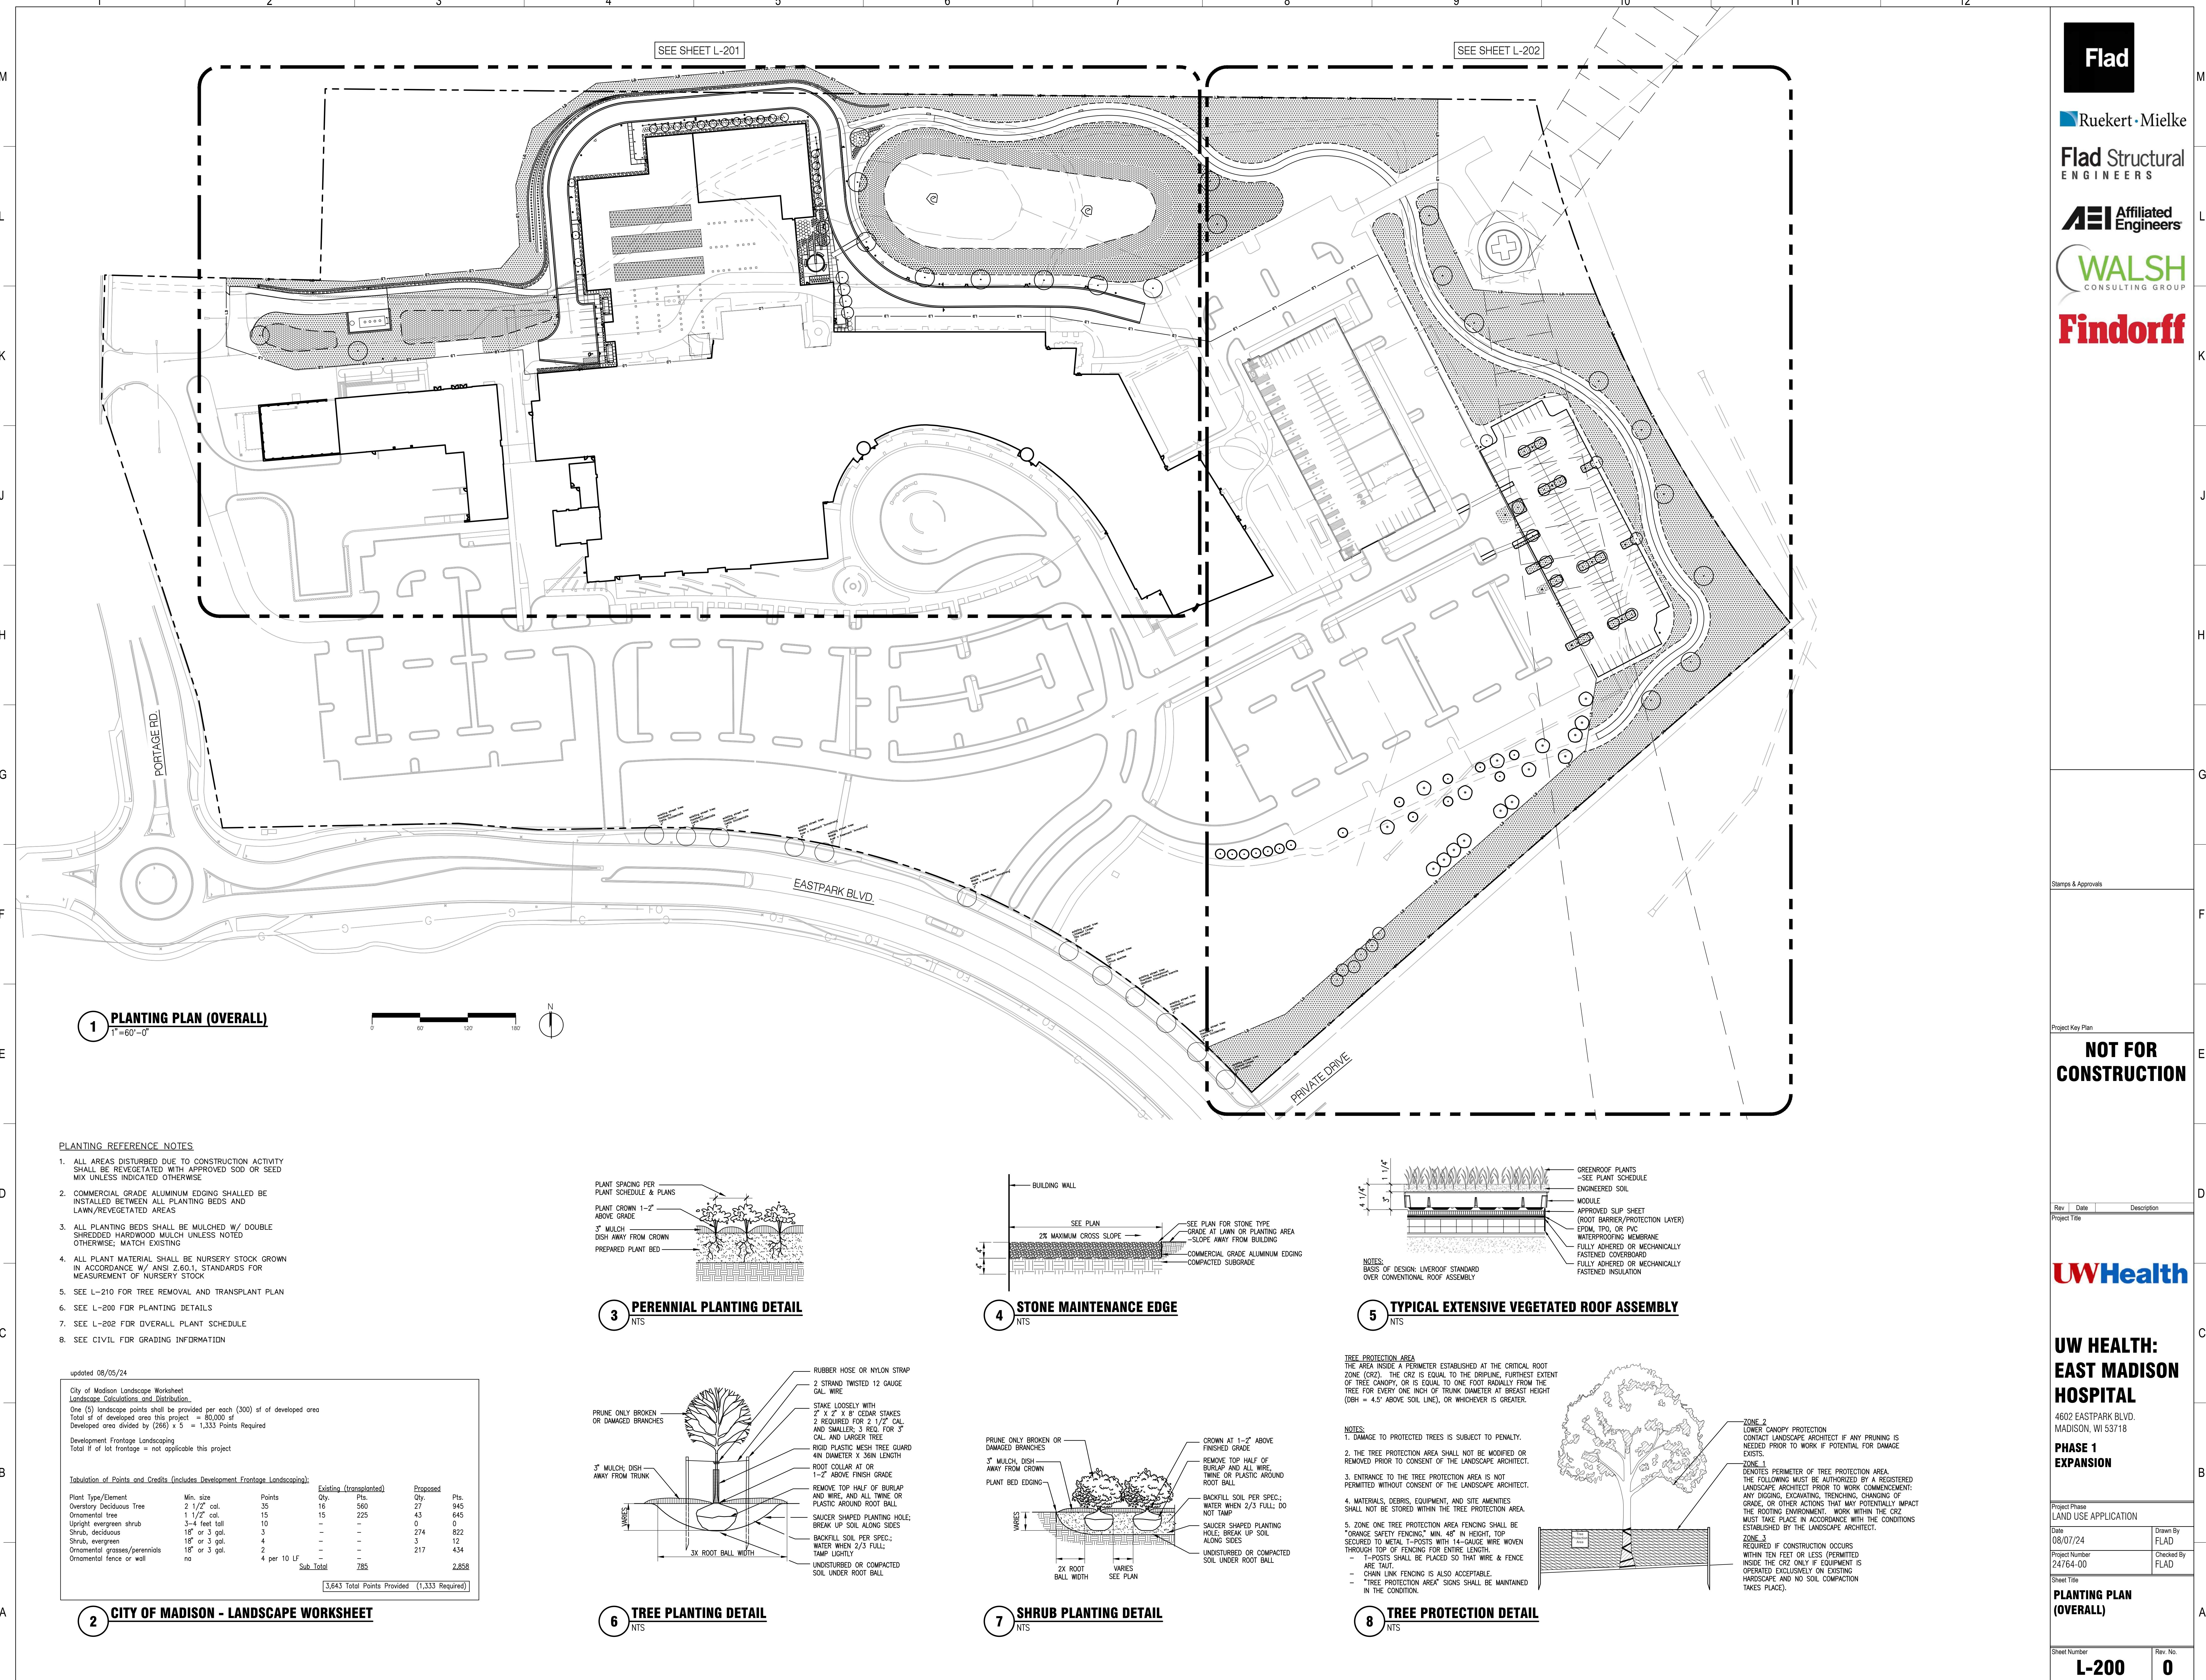

Flad

Ruekert-Mielke


Flad Structural  
ENGINEERSAEI Affiliated  
EngineersWALSH  
CONSULTING GROUP

Findorff

Stamps &amp; Approvals

Project Key Plan  
**NOT FOR  
CONSTRUCTION**

UWHealth

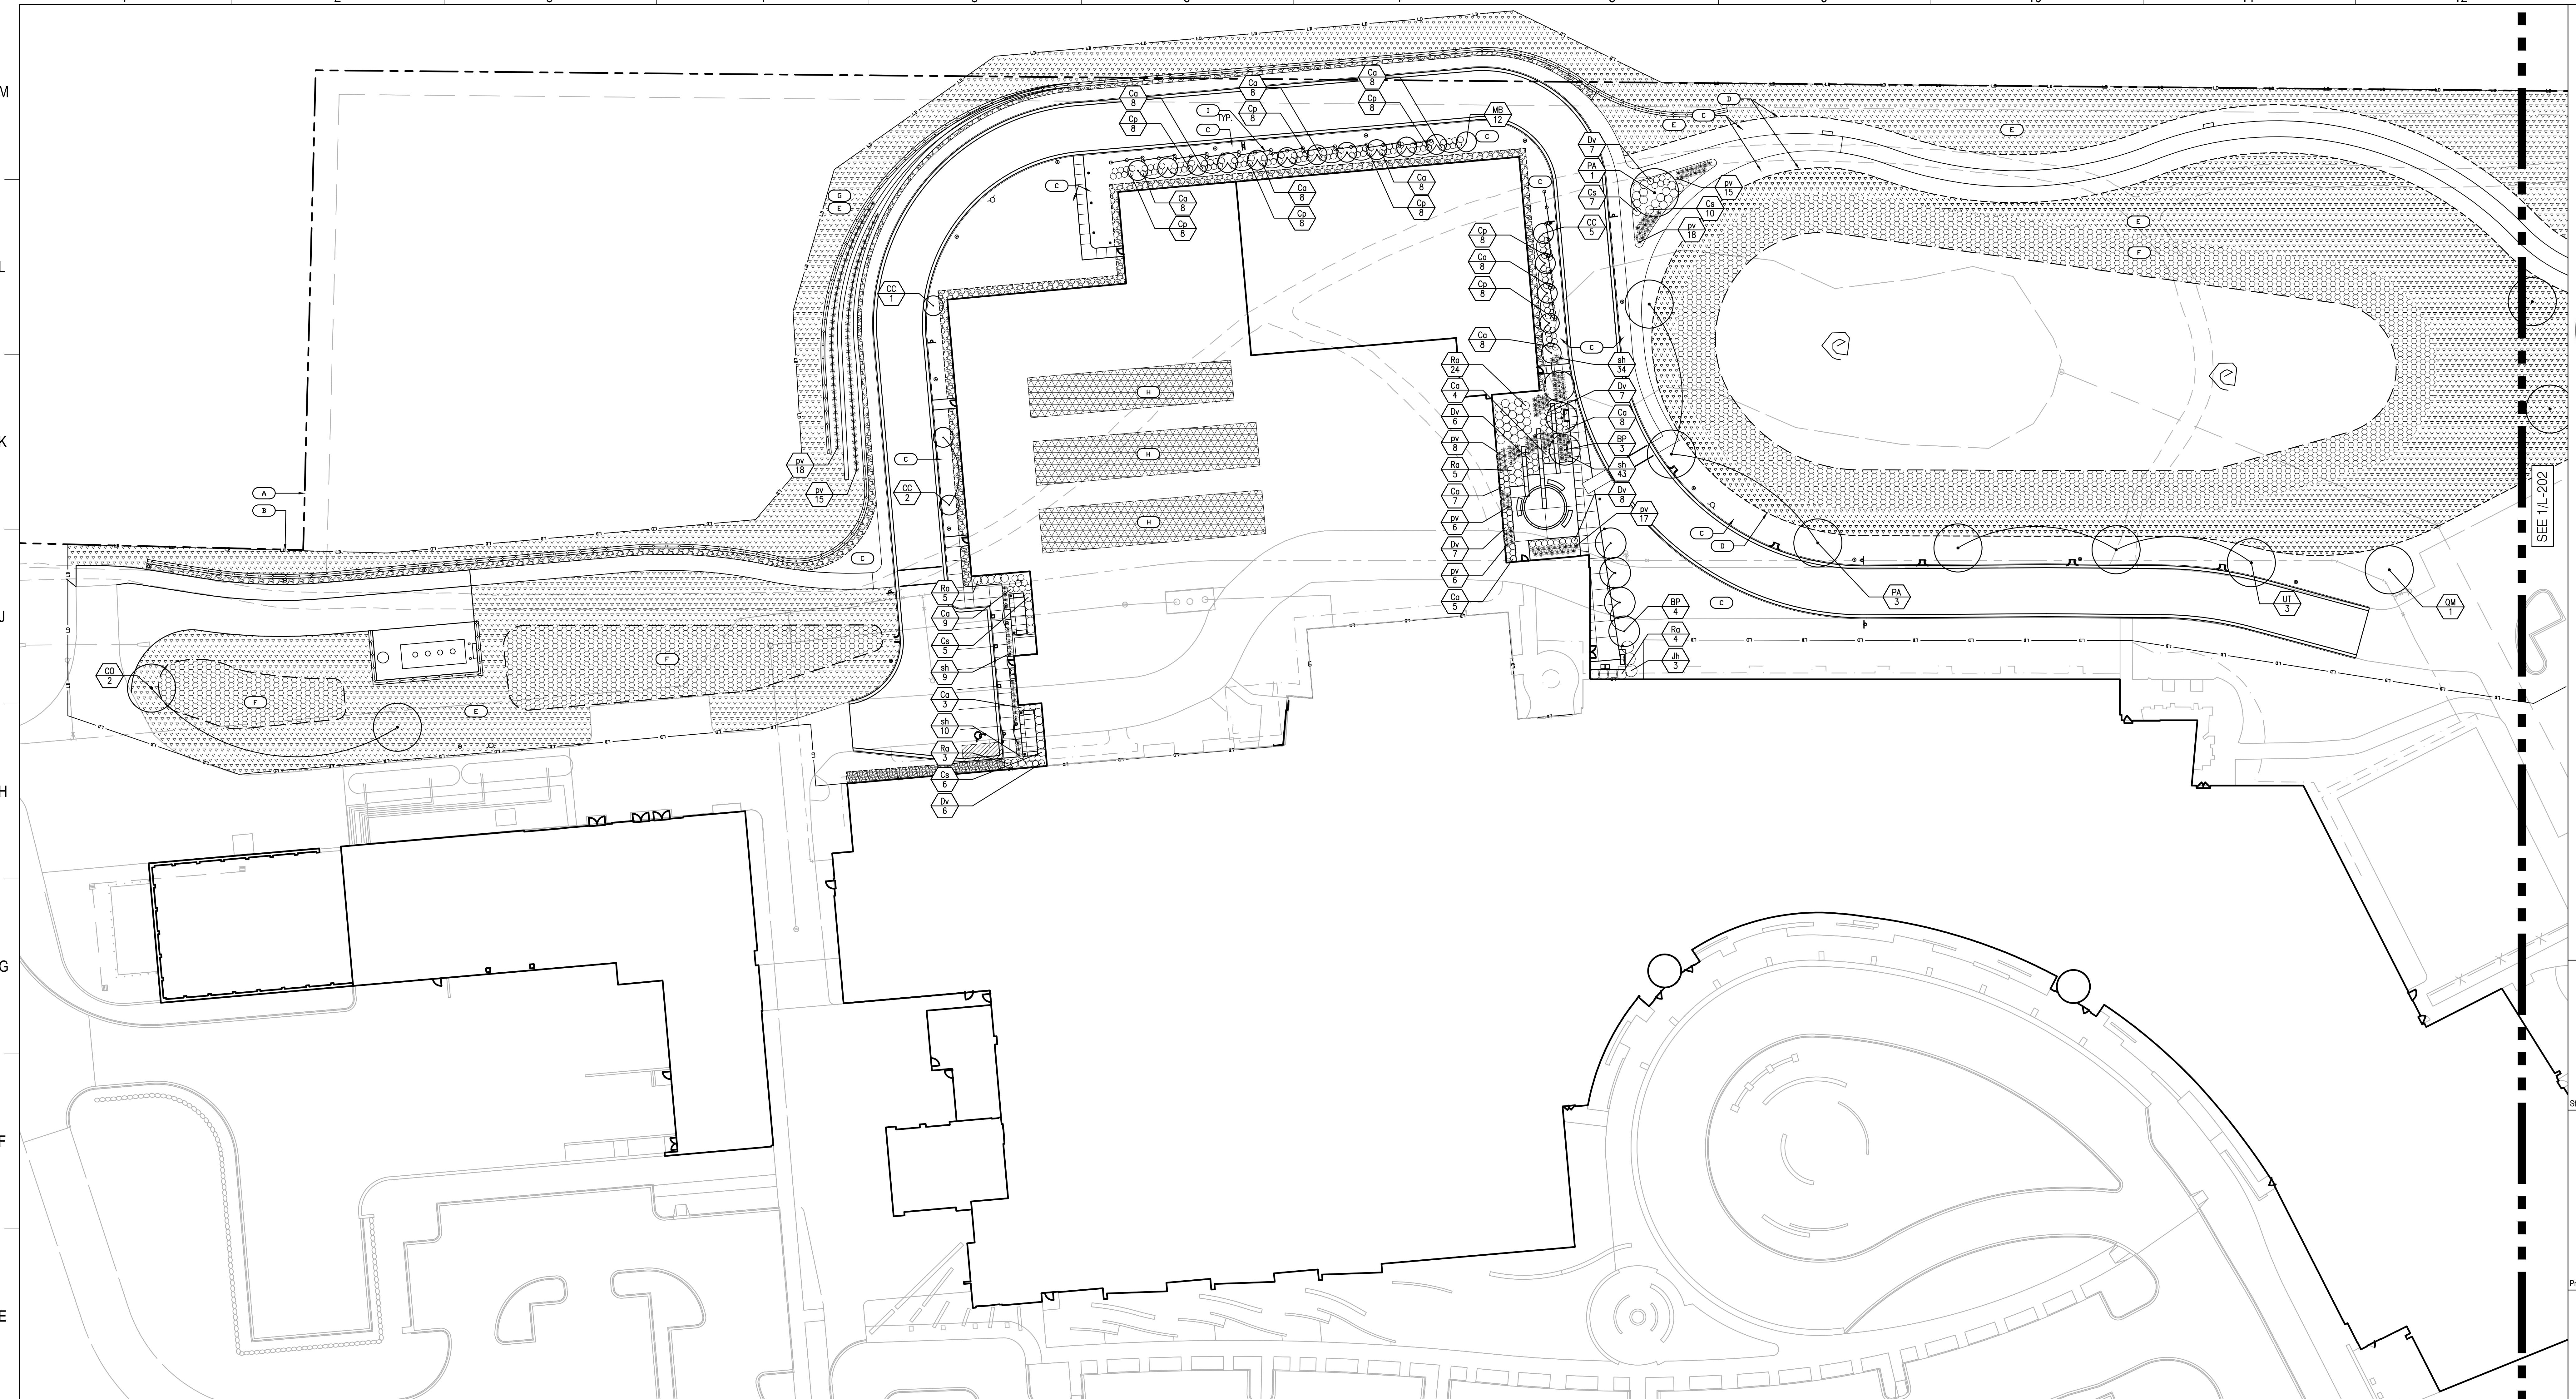UW HEALTH:  
EAST MADISON  
HOSPITAL4600 EASTPARK BLVD.  
MADISON, WI 53718PHASE 1  
EXPANSIONProject Phase  
LAND USE APPLICATIONDate  
08/07/24Drawn By  
FLADProject Number  
24764-00Checked By  
FLADSheet Title  
PLANTING PLAN  
(WEST)Sheet Number  
L-201Rev. No.  
0
**1 PLANTING PLAN (WEST)**

1'=30'-0"

N

## PLANTING PLAN LEGEND

- OVERSTORY DECIDUOUS TREE PLANTING
- ORNAMENTAL DECIDUOUS TREE PLANTING
- LARGE SHRUB PLANTING
- MEDIUM SHRUB PLANTING
- ORNAMENTAL GRASS
- PROPERTY LINE
- LIMIT OF DISTURBANCE (LD)
- LAWN
- EXTENTS OF LAWN / MOW LINE (DASHED)
- NATIVE SEED MIX TYPE 1
- NATIVE SEED MIX TYPE 2
- EXISTING WOODLOT AREA  
— SEE L-210 TREE REMOVAL AND TRANSPLANT PLAN
- GREENROOF PLANTING  
— SEE 2/L-202 GREEN ROOF PLANT MIX
- PERFORATED SCREENWALL

## PLANTING REFERENCE NOTES

1. ALL PLANTING AREAS WITHIN CONSTRUCTION ACTIVITY SHALL BE REVEGETATED WITH APPROVED SOD OR SEED MIX UNLESS INDICATED OTHERWISE.
2. COMMERCIAL GRADE ALUMINUM EDGING SHALL BE INSTALLED BETWEEN ALL PLANTING BEDS AND LAWN/REVEGETATED AREAS.
3. ALL PLANTING BEDS SHALL BE MULCHED W/ DOUBLE SHREDDED HARDWOOD MULCH UNLESS NOTED OTHERWISE; MATCH EXISTING.
4. ALL PLANT MATERIAL SHALL BE NURSERY STOCK GROWN IN ACCORDANCE W/ ANSI Z60.1, STANDARDS FOR MEASUREMENT OF NURSERY STOCK.
5. SEE L-210 FOR TREE REMOVAL AND TRANSPLANT PLAN.
6. SEE L-200 FOR PLANTING DETAILS.
7. SEE L-202 FOR OVERALL PLANT SCHEDULE.
8. SEE CIVIL FOR GRADING INFORMATION.

L-201

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Flad

Ruekert-Mielke

Flad Structural  
ENGINEERSAEI Affiliated  
EngineersWALSH  
CONSULTING GROUP

Findorff

Stamps &amp; Approvals

Project Key Plan  
**NOT FOR  
CONSTRUCTION**

UWHealth

UW HEALTH:  
EAST MADISON  
HOSPITAL4600 EASTPARK BLVD.  
MADISON, WI 53718PHASE 1  
EXPANSIONProject Phase  
LAND USE APPLICATIONDate  
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FLADProject Number  
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