

# PROPOSED COFFEE SHOP FOR: 7-BREW MADISON

## MADISON, WI

### PROJECT INFORMATION

#### SITE INFORMATION:

PROPERTY AREA: 37,979 S.F. (0.87 ACRES)  
 EXISTING ZONING: COMMERCIAL CORRIDOR - TRANSITIONAL/ URBAN DESIGN DISTRICT NO. 5  
 PROPOSED ZONING: COMMERCIAL CORRIDOR - TRANSITIONAL/ URBAN DESIGN DISTRICT NO. 5  
 PROPOSED USE: COFFEE SHOP WITH DRIVE THRU (C.U.P.)  
 SETBACKS:  
 BUILDING: FRONT(NW) = 5' (AT LEAST 30% BUILDING WIDTH WITHIN 20' OF PRIMARY STREET=14' SETBACK)  
 SIDES(N/NE) = 0'  
 REAR(S/W) = 20'  
 PAVEMENT: FRONT(NW) = NONE  
 SIDES(N/NE) = NONE  
 REAR(S/W) = NONE  
 PROPOSED BUILDING HEIGHT: 22.29' (MAX. HEIGHT ALLOWED: 78')  
 AIRPORT HEIGHT RESTRICTIONS: 938' (PROPOSED BUILDING HEIGHT: 895.29')  
 PARKING REQUIRED: NO MINIMUM PARKING REQUIRED (NOT WITHIN 300' OF ANOTHER RESTAURANT)  
 MAXIMUM 25% OF PERSONS (25% X 6 = 2 SPACES MAX)  
 PARKING PROVIDED: 10 SPACES (1 H.C. ACCESSIBLE) (C.U.P.)  
 HANDICAP STALLS REQUIRED: 1, HANDICAP STALLS PROVIDED: 1  
 LANDSCAPE REQUIREMENTS: MAXIMUM LOT COVERAGE - BUILDING ONLY: 85%




#### EXISTING SITE DATA

	AREA (AC)	AREA (SF)	RATIO
BUILDING FLOOR AREA	0.00	0	0.0%
PAVEMENT (ASP. & CONC.)	0.72	31,399	87.3%
TOTAL IMPERVIOUS	0.72	31,399	87.3%
LANDSCAPE/ OPEN SPACE	0.11	4,580	12.7%
PROJECT SITE	0.83	35,979	100.0%

#### PROPOSED SITE DATA

	AREA (AC)	AREA (SF)	RATIO
BUILDING FLOOR AREA	0.02	854	2.4%
PAVEMENT (ASP. & CONC.)	0.56	24,238	67.4%
TOTAL IMPERVIOUS	0.58	25,092	69.7%
LANDSCAPE/ OPEN SPACE	0.25	10,887	30.3%
PROJECT SITE	0.83	35,979	100.0%

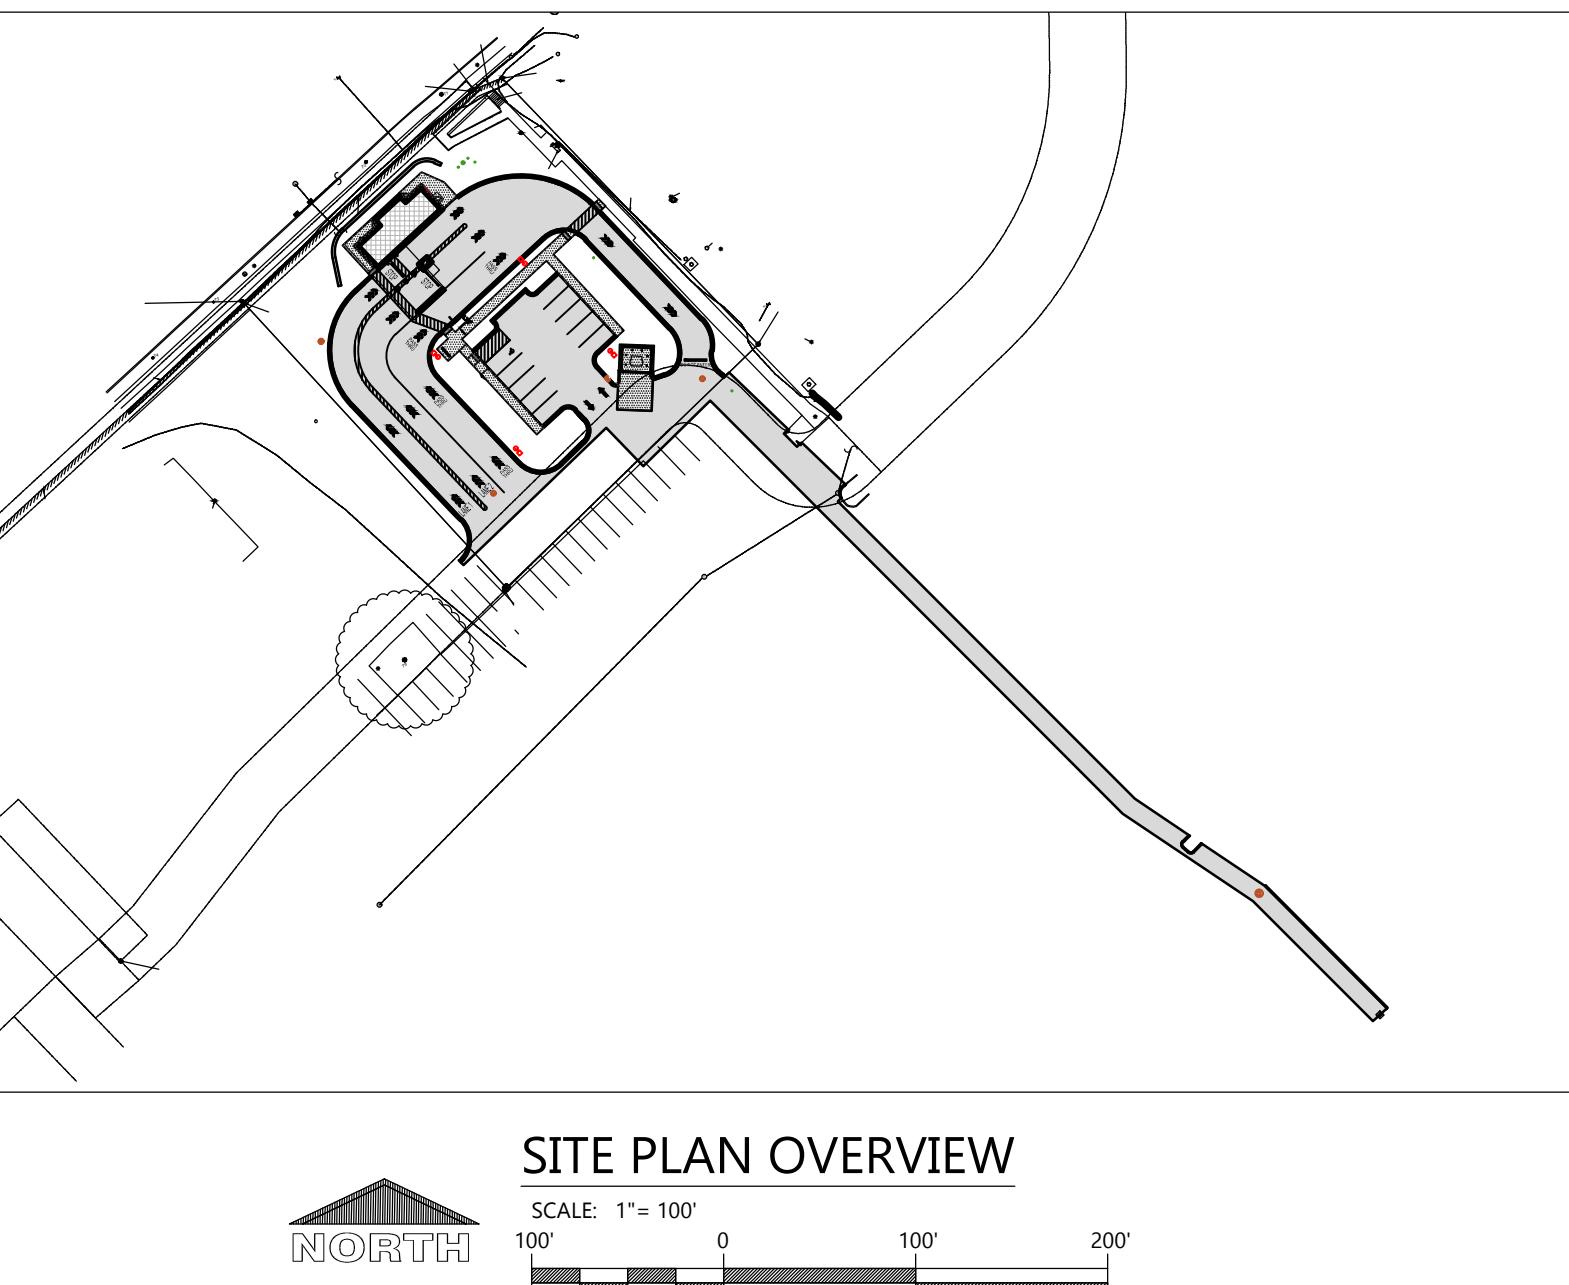

### EXCEL LEGEND

NOTE: ALL SYMBOLS SHOWN MAY NOT APPEAR ON DRAWINGS.

SYM.	IDENTIFICATION	SYM.	IDENTIFICATION
● [000.00]	PROPOSED SPOT ELEVATIONS (FLOW LINE OF CURB UNLESS OTHERWISE SPECIFIED)	● [000.00]TC	PROPOSED SPOT ELEVATIONS (TOP OF CURB, FLOWLINE)
● [000.00]EG	EXISTING GRADE SPOT ELEVATIONS	● [000.00]FL	PROPOSED SPOT ELEVATIONS (OF CURB)
● [000.00]BG	PROPOSED SPOT ELEVATIONS (REFERENCE R-WALL DETAIL BG-FINISHED SURFACE GRADE AT BACK OF WALL)	● [000.00]TW	PROPOSED SPOT ELEVATIONS (TOP OF WALK, BOTTOM OF WALK @ FLOWLINE)
● [000.00]FG	● FG-FINISHED SURFACE GRADE AT FRONT OF WALL	● [000.00]BW	
PROPOSED SITE SYMBOLS			
→	PROPOSED DRAINAGE FLOW	CO	PROPOSED CLEANOUT
●	PROPOSED WATER VALVE IN BOX	DS	PROPOSED DOWNSPOUT TO RISER
●	PROPOSED WELL	—○—	PROPOSED APRON END SECTION
○□	PROPOSED LIGHT POLE	■	SOIL BORING
●	PROPOSED STORM CATCH BASIN - ST CB	—	CENTER LINE
●	PROPOSED STORM FIELD INLET - ST FI	●	PROPOSED HANDICAP PARKING STALL
●	PROPOSED STORM CURB INLET - ST CI	—	PROPOSED SIGN
PROPOSED LINETYPES			
—	PROPOSED PROPERTY LINE	—	INTERIOR PROPERTY LINE
—ST—	PROPOSED STORM SEWER AND MANHOLE - ST MH	—■■■—	RAILROAD TRACKS
—SA—	PROPOSED SANITARY SEWER AND MANHOLE - SAN MH	—800—	EXISTING GROUND CONTOUR
—WL—	PROPOSED WATER LINE AND HYDRANT	—800—	PROPOSED GROUND CONTOUR
—	PROPOSED CURB AND GUTTER	—	POH — PROPOSED POLISH SEWER AND MANHOLE
—	GRADING/SEEDING LIMITS	—	P — PROPOSED PROCESS SEWER AND MANHOLE
—	RIGHT-OF-WAY LINE	—	CLW — PROPOSED CLEAR WATER LINE
—T—	PROPOSED UNDERGROUND TELEPHONE CABLE	—	G — PROPOSED UNDERGROUND GAS LINE
—	PROPOSED GUARD RAIL	—	E — PROPOSED UNDERGROUND ELECTRIC CABLE
—FO—	PROPOSED UNDERGROUND FIBER OPTIC LINE	—	

### SURVEY LEGEND

●	FOUND MONUMENT AS NOTED
○	SET MONUMENT AS NOTED
◆	COMPUTED POINT
▲	TEMPORARY BENCHMARK (TBM)
■	PIPE HYDRANT
●	LINE
●	SANITARY MANHOLE (SMH) SIGN
●	ELECTRIC METER
●	ELECTRIC BOX
●	MONITORING WELL
●	WATER VALVE
●	CURB INLET (CI)
●	STORM MANHOLE
●	TELEPHONE PEDESTAL
●	FIBER OPTIC VAULT
●	TELEVISION PEDESTAL
●	N.G. NATURAL GROUND (NG)
●	P.S. PARKING SPACE(S)
(M)	MEASURED/CALCULATED DIMENSION
(R)	RECORD DIMENSION
PVC	POLYVINYL CHLORIDE PIPE
CPVC	CORRUGATED PLASTIC PIPE
RCP	REINFORCED CONCRETE PIPE
BOC	BACK OF CURB
FL	FLOW LINE
TB	TOP OF BANK
BB	BOTTOM OF BANK
EA	EDGE OF ASPHALT
TA	TOP OF ASPHALT
EC	EDGE OF CONCRETE
TC	TOP OF CONCRETE
—	BOUNDARY LINE
—	ADJOINER LINE
—	EASEMENT LINE
—	RIGHT-OF-WAY LINE
—	CENTERLINE
—	GUARDRAIL LINE
—	UNDERGROUND ELECTRIC LINE
—	UNDERGROUND FIBER OPTIC LINE
—	UNDERGROUND TELEVISION LINE
—	UNKNOWN UNDERGROUND UTILITY LINE
—	UNDERGROUND WATER LINE
—	SD — SD UNDERGROUND STORM LINE
—	SS — SS UNDERGROUND SANITARY LINE

### PROJECT CONTACTS

#### OWNER INFORMATION:

Plaza Street Partners  
 Kara Condie  
 3400 College Blvd, Suite 200  
 Leawood, KS 66211  
 Phone: (913) 299-5737  
 Email: kcondie@plazastreetpartners.com

#### CIVIL:

Eric Draskowski, P.E.  
 Phone: (920)322-1678  
 E-mail: eric.draskowski@excelengineer.com

#### CITY PLANNER:

Heather Stouder  
 Phone: (608) 266-4635  
 E-mail: hstouder@cityofmadison.com

#### CITY ENGINEER:

Jim Wolfe  
 Phone: (608) 266-4099  
 E-mail: jwolfe@cityofmadison.com

#### CITY FIRE CHIEF:

Chris Carbon  
 Phone: (608) 266-4420  
 E-mail: fire@cityofmadison.com


#### CITY BUILDING INSPECTOR:

Phone: (608) 266-4551  
 E-mail: bldginspection@cityofmadison.com

#### CITY DIRECTOR OF PUBLIC WORKS:

Charles Romines  
 E-mail: publicworks@cityofmadison.com

### LOCATION MAP

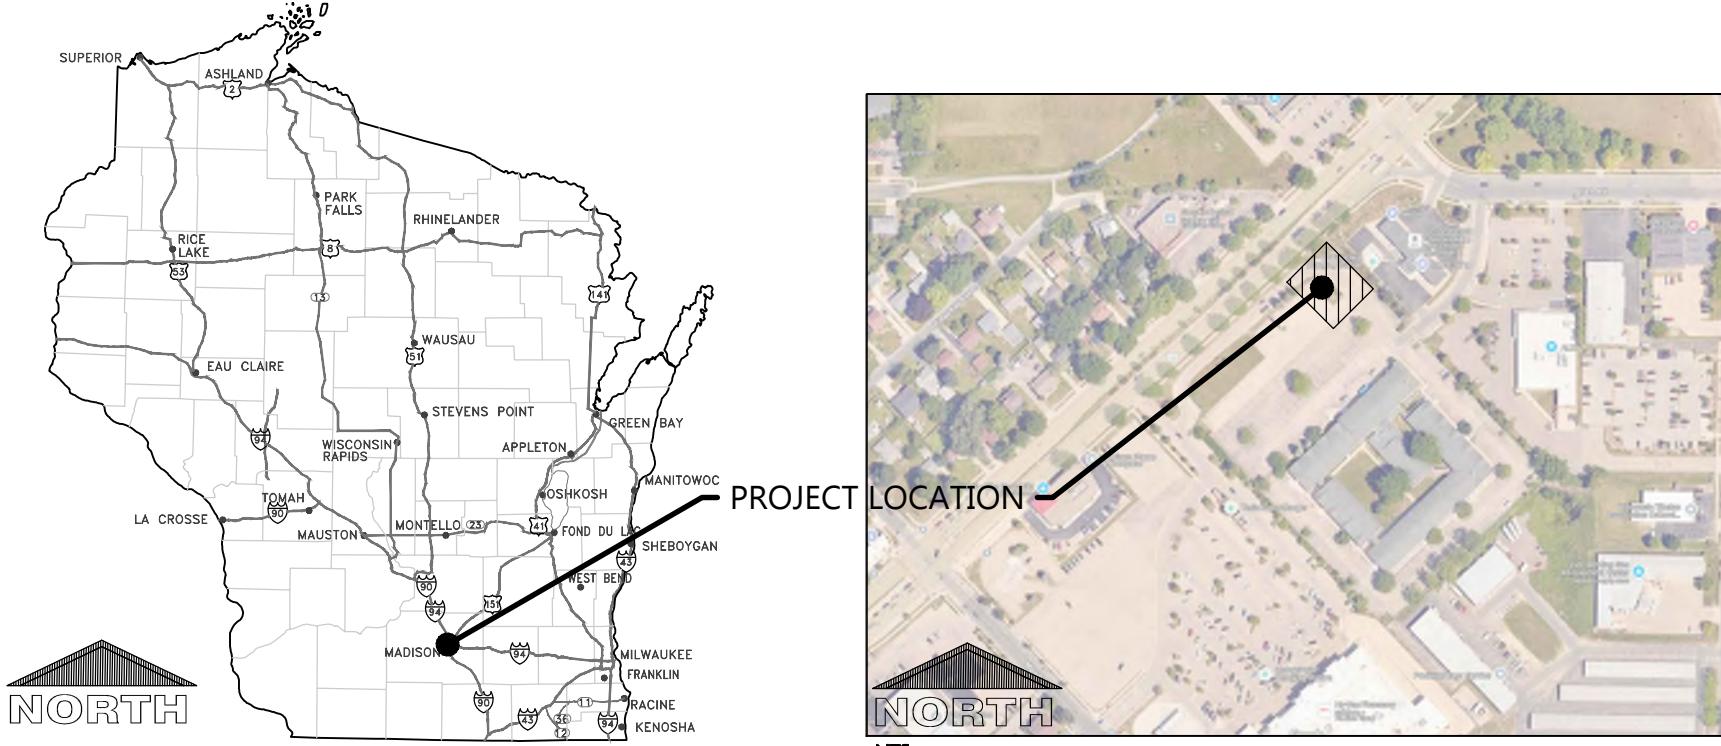

### PROJECT NOTES

#### GENERAL PROJECT NOTES




- THE CONTRACTOR IS RESPONSIBLE FOR OBTAINING ALL WORK IN ROW PERMITS.
- PRIOR TO CONSTRUCTION CONTRACTOR TO VERIFY THAT OWNER HAS OBTAINED PERMISSION TO COMPLETE WORK OFFSITE.
- FOLLOWING THE COMPLETION OF THE STORMWATER BMP'S, CONTRACTOR TO PROVIDE THE CITY OF MADISON WITH AN AS-BUILT STORMWATER MANAGEMENT/UTILITY PLAN.
- THE RIGHT-OF-WAY IS THE SOLE JURISDICTION OF THE CITY OF MADISON AND IS SUBJECT TO CHANGE AT ANY TIME PER RECOMMENDATIONS/PLAN OF TRAFFIC ENGINEERING AND CITY ENGINEERING DEPARTMENTS.

#### SURVEY NOTE

ALTA/NPS LAND TITLE SURVEY WAS COMPLETED BY BUCKLEY D. BLEW (PROJECT NUMBER 24-6247) REVISION OCTOBER 10, 2024. CONTACT BLEW AT SUVERYBLEWING.COM WITH ANY QUESTIONS REGARDING SURVEY OR EXISTING CONDITIONS INFORMATION. SEE ALTA/NPS LAND TITLE SURVEY FOR ADDITIONAL INFORMATION. PRIOR TO CONSTRUCTION, CONTRACTOR SHALL FIELD VERIFY ALL SITE IMPROVEMENTS, UTILITY LOCATIONS, INVERTS, SIZES, ETC. NOTIFY ENGINEER OF DISCREPANCIES. FAILURE TO NOTIFY ENGINEER SHALL BE THE CONTRACTOR'S RESPONSIBILITY FOR ANY DAMAGES AS A RESULT OF FAILURE TO FIELD VERIFY.

### SHEET INDEX

NUMBER	SHEET NAME / DESCRIPTION
C0.1	CIVIL COVER SHEET
C0.2	CIVIL SPECIFICATIONS
C1.0	EXISTING SITE AND DEMOLITION PLAN
C1.1A	SITE PLAN
C1.1B	STRIPING PLAN
C1.2	GRADING AND EROSION CONTROL PLAN
C1.3	UTILITY PLAN
C1.4	LANDSCAPE AND RESTORATION PLAN
C2.0	DETAILS
C2.1	DETAILS
C3.1	SITE PHOTOMETRIC PLAN & DETAILS

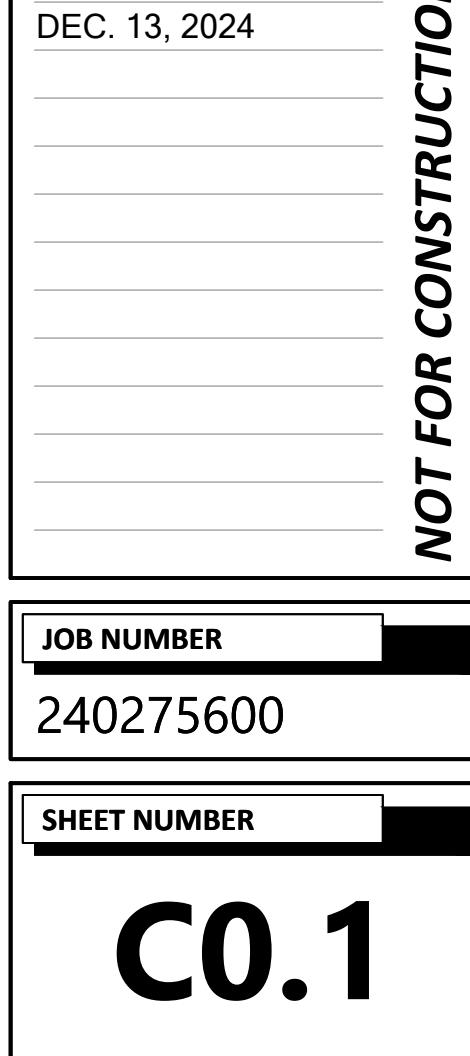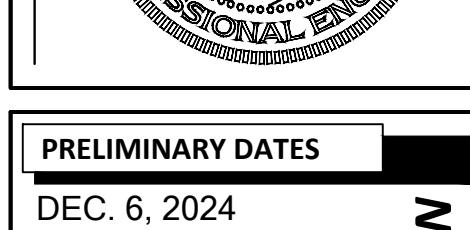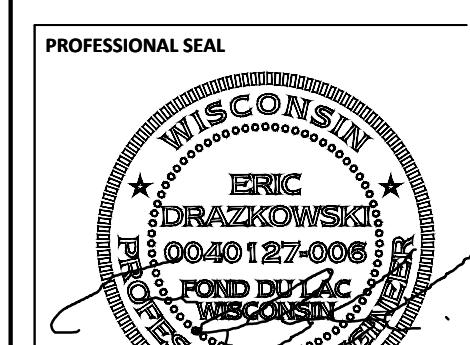



**PROPOSED COFFEE SHOP FOR:  
7-BREW MADISON**  
3915 LIEN RD. • MADISON, WI 53704

NOT FOR CONSTRUCTION

PRELIMINARY DATES  
DEC. 6, 2024  
DEC. 13, 2024

JOB NUMBER  
240275600

SHEET NUMBER  
C1.0

**GENERAL NOTES:**

- SEE SHEET C0.2 FOR PLAN SPECIFICATIONS AND REQUIREMENTS.
- THE RIGHT-OF-WAY IS THE SOLE JURISDICTION OF THE CITY OF MADISON AND IS SUBJECT TO CHANGE AT ANY TIME PER RECOMMENDATIONS/PLAN OF TRAFFIC ENGINEERING AND CITY ENGINEERING DEPARTMENTS.

**LEGEND:**

	REMOVE ON SITE FEATURES
	COORDINATE OFF SITE IMPROVEMENTS W/ OWNER AND NEIGHBOR

**SURVEY NOTE:**

ALTA/NSPS LAND TITLE SURVEY WAS COMPLETED BY BUCKLEY D. BLEW (PROJECT NUMBER 24-6247) REVISION DATED OCTOBER 10, 2024. CONTACT BLEW AT [BLEW@BLEWINC.COM](mailto:BLEW@BLEWINC.COM) WITH ANY QUESTIONS REGARDING SURVEY OR EXISTING CONDITIONS INFORMATION. SEE ALTA/NSPS LAND TITLE SURVEY FOR ADDITIONAL INFORMATION. PRIOR TO CONSTRUCTION, CONTRACTOR SHALL FIELD VERIFY ALL SITE IMPROVEMENTS, UTILITY LOCATIONS, INVERTS, SIZES, ETC. NOTIFY ENGINEER OF DISCREPANCIES. FAILURE TO NOTIFY ENGINEER SHALL BE THE CONTRACTOR'S RESPONSIBILITY FOR ANY DAMAGES AS A RESULT OF FAILURE TO FIELD VERIFY.

**SURVEY LEGEND:**

	FOUND MONUMENT AS NOTED
	SET MONUMENT AS NOTED
	COMPUTED POINT
	TEMPORARY BENCHMARK (TBM)
	FIRE HYDRANT
	LIGHT
	SANITARY MANHOLE (SMH)
	SIGN
	ELECTRIC METER
	ELECTRIC BOX
	MONITORING WELL
	WATER VALVE
	CURB INLET (CI)
	STORM DRAINABLE
	TELEPHONE PEDESTAL
	FIBER OPTIC VAULT
	TELEPHONE PEDESTAL
	NATURAL GAS PIPE (NG)
	PARKING SPACE(S)
	MEASURED/CALCULATED DIMENSION
	RECORD DIMENSION
	POLYVINYL CHLORIDE PIPE
	CORRUGATED PLASTIC PIPE
	REINFORCED CONCRETE PIPE
	BACK OF CURB
	FLOW LINE
	TOP OF BANK
	BOTTOM OF BANK
	EDGE OF ASPHALT
	TOP OF ASPHALT
	EDGE OF CONCRETE
	TOP OF CONCRETE
	BOUNDARY LINE
	ADJOINING LINE
	EASEMENT LINE
	RIGHT-OF-WAY LINE
	CENTERLINE
	GUARDRAIL LINE
	UNDERGROUND ELECTRIC LINE
	UNDERGROUND FIBER OPTIC LINE
	UNDERGROUND TELEVISION LINE
	UNKNOWN UNDERGROUND UTILITY LINE
	UNDERGROUND WATER LINE
	UNDERGROUND STORM LINE
	UNDERGROUND SANITARY LINE

**KEYNOTES**


	PROTECT EXISTING SIDEWALK & RAMP
	SAWCUT (AS NECESSARY) AND REMOVE ASPHALT AND BASE
	SAWCUT (AS NECESSARY) AND REMOVE ASPHALT FOR UTILITY INSTALLATION. VERIFY ALL UTILITIES ROUTES ARE CLEAR PRIOR TO CONSTRUCTION. SURVEY NOT COMPLETED IN THIS AREA
	SAWCUT (AS NECESSARY) AND REMOVE ASPHALT AND PROTECT BASE
	REMOVE LIGHT POLE AND DISCONNECT UNDERGROUND ELECTRIC LINE. VERIFY SOUTHWEST LIGHT POLE MAINTAINS FUNCTION AFTER DISCONNECTION
	REMOVE 52' OF WATER SERVICE. SERVICE TO REMAIN ACTIVE DURING CONSTRUCTION. COORDINATE W/ OWNER OF WATER SERVICE. FIELD VERIFY ROUTE AND LOCATION
	REMOVE CURB. SAWCUT (AS NECESSARY)
	REMOVE TREE
	CONTRACTOR TO PROTECT UNDERGROUND ELECTRICAL LINES. PROVIDE REMOVAL AND RELOCATION AS NECESSARY
	CONTRACTOR TO FIELD VERIFY STORMSEWER ROUTE PRIOR TO CONSTRUCTION. VERIFY ROUTE IS CLEAR OF IMPROVEMENTS. RELOCATE AS NECESSARY
	CONTRACTOR TO FIELD VERIFY SIZE, LOCATION AND DEPTH PRIOR TO CONSTRUCTION. NOTIFY ENGINEER IF LOCATION DOES NOT MATCH INTENDED DESIGN
	REMOVE AND RELOCATE SIGN
	REMOVE PAVEMENT STRIPING
	REMOVE CURB (IF NECESSARY)

**SURVEY NOTES:**

- SOME FEATURES SHOWN ON THIS PLAT MAY BE SHOWN OUT OF SCALE FOR CLARITY.
- DIMENSIONS ON THIS PLAT ARE EXPRESSED IN FEET AND DECIMAL PARTS THEREOF UNLESS OTHERWISE NOTED. MONUMENTS WERE FOUND AT POINTS WHERE INDICATED.
- IN REGARD TO ALTA/NSPS TABLE A ITEM 16, THERE WAS NO OBSERVABLE EVIDENCE OF RECENT EARTH MOVING WORK, BUILDING CONSTRUCTION OR ADDITIONS EXCEPT AS SHOWN HEREON.
- IN REGARD TO ALTA/NSPS TABLE A ITEM 17, THERE WERE NO KNOWN PROPOSED CHANGES IN RIGHT-OF-WAY LINES, RECENT STREET OR SIDEWALK CONSTRUCTION OR REPAIRS EXCEPT AS SHOWN HEREON.
- AT THE TIME OF THE ALTA/NSPS SURVEY, THERE WAS NO OBSERVABLE EVIDENCE OF SITE USE AS A SOLID WASTE DUMP, SUMP, OR SANITARY LANDFILL.
- AT THE TIME OF THE ALTA/NSPS SURVEY, THERE WAS NO OBSERVABLE EVIDENCE OF SITE USE AS A CEMETERY, ISOLATED GRAVE SITE OR BURIAL GROUNDS.
- COMPLETED FIELD WORK WAS SEPTEMBER 9TH, 2024.
- THE DISTANCES SHOWN HEREON ARE UNITS OF GROUND MEASUREMENT.
- THE NEAREST INTERSECTING STREET IS THE INTERSECTION OF EAST WASHINGTON AVENUE (A.K.A. U.S. HIGHWAY 151), WHICH IS APPROXIMATELY 185' FROM THE NORTHEAST CORNER OF THE SUBJECT PROPERTY.
- THE SUBJECT PROPERTY HAS INDIRECT ACCESS TO LIEN ROAD VIA CROSS ACCESS EASEMENT PER DOCUMENT NO. 5978321, BEING A PUBLICLY DEDICATED RIGHT-OF-WAY.
- EXCEPT AS SPECIFICALLY STATED OR SHOWN ON THIS PLAT, THIS SURVEY DOES NOT PURPORT TO REFLECT ANY OF THE FOLLOWING WHICH MAY BE APPLICABLE TO THE SUBJECT PROPERTY: EASEMENTS, OTHER THAN POSSIBLE EASEMENTS WHICH WERE VISIBLE AT THE TIME OF SURVEY; RESTRICTIONS; SUBDIVISION RESTRICTIONS OR OTHER LAND USE REGULATIONS; AND ANY OTHER FACTS WHICH AN ACCURATE TITLE SEARCH MAY DISCLOSE.
- NO SURVEYOR OR ANY OTHER PERSON OTHER THAN A LICENSED WISCONSIN ATTORNEY MAY PROVIDE LEGAL ADVICE CONCERNING THE STATUS OF TITLE TO THE PROPERTY DESCRIBED IN THIS SURVEY ("THE SUBJECT PROPERTY"). THE PURPOSE OF SURVEYING THE SUBJECT PROPERTY IS LIMITED TO THE SCOPES OF THE EXEMPTIONS, WHICH IS ONLY TO SHOW THE LOCATION, BOUNDARIES AND PHYSICAL OBJECTIONS IN RELATION THERETO, TO THE EXTENT THAT THE SURVEY INDICATES THAT THE LEGAL INSTRUMENT "AFFECTS" THE SUBJECT PROPERTY, SUCH STATEMENT IS ONLY INTENDED TO INDICATE THAT PROPERTY BOUNDARIES INCLUDED IN SUCH INSTRUMENT INCLUDE SOME OR ALL OF THE SUBJECT PROPERTY. THIS SURVEY DOES NOT PURPORT TO DESCRIBE HOW SUCH INSTRUMENT AFFECTS THE SUBJECT PROPERTY OR THE ENFORCEABILITY OR LEGAL CONSEQUENCES OF SUCH INSTRUMENT.
- NAMES AND ADDRESSES OF ADJOINING PROPERTY OWNERS WERE TAKEN FROM DANE COUNTY GIS.
- THE SUBJECT PROPERTY SHOWN HEREON FORMS A MATHEMATICALLY CLOSED FIGURE AND IS CONTOURLESS WITH THE ADJOINING PUBLIC RIGHT-OF-WAY AND/OR ADJOINING PARCELS WITH NO GAPS OR OVERLAPS.
- IN REGARD TO ALTA/NSPS TABLE A ITEM 10, NO VISIBLE DIVISION OR PARTY WALLS WITH RESPECT TO ADJOINING PROPERTIES WERE OBSERVED AT THE TIME THE FIELD SURVEY WAS PERFORMED, NOR WERE ANY DESIGNATED BY THE CLIENT.
- A PRIVATE UTILITY LOCATE WAS CONDUCTED ON THE SUBJECT PROPERTY BY BLEW AND ASSOCIATES ON 09/12/2024.
- ELEVATIONS ESTABLISHED WITH GPS STATIC OBSERVATIONS UTILIZING ONLINE POSITIONING USER SERVICE (OPUS) FOR POST PROCESSING. VERTICAL DATUM BASED UPON NORTH AMERICAN VERTICAL DATUM (NAVD88) IN SURVEY FEET. CONTOURS SHOWN IN 1' INTERVALS.
- THIS SURVEY WAS MADE IN ACCORDANCE WITH LAWS AND/OR MINIMUM STANDARDS OF THE STATE OF WISCONSIN.



SCALE: 1" = 30'  
0' 30' 60'  
NORTH

CIVIL EXISTING SITE AND DEMOLITION PLAN

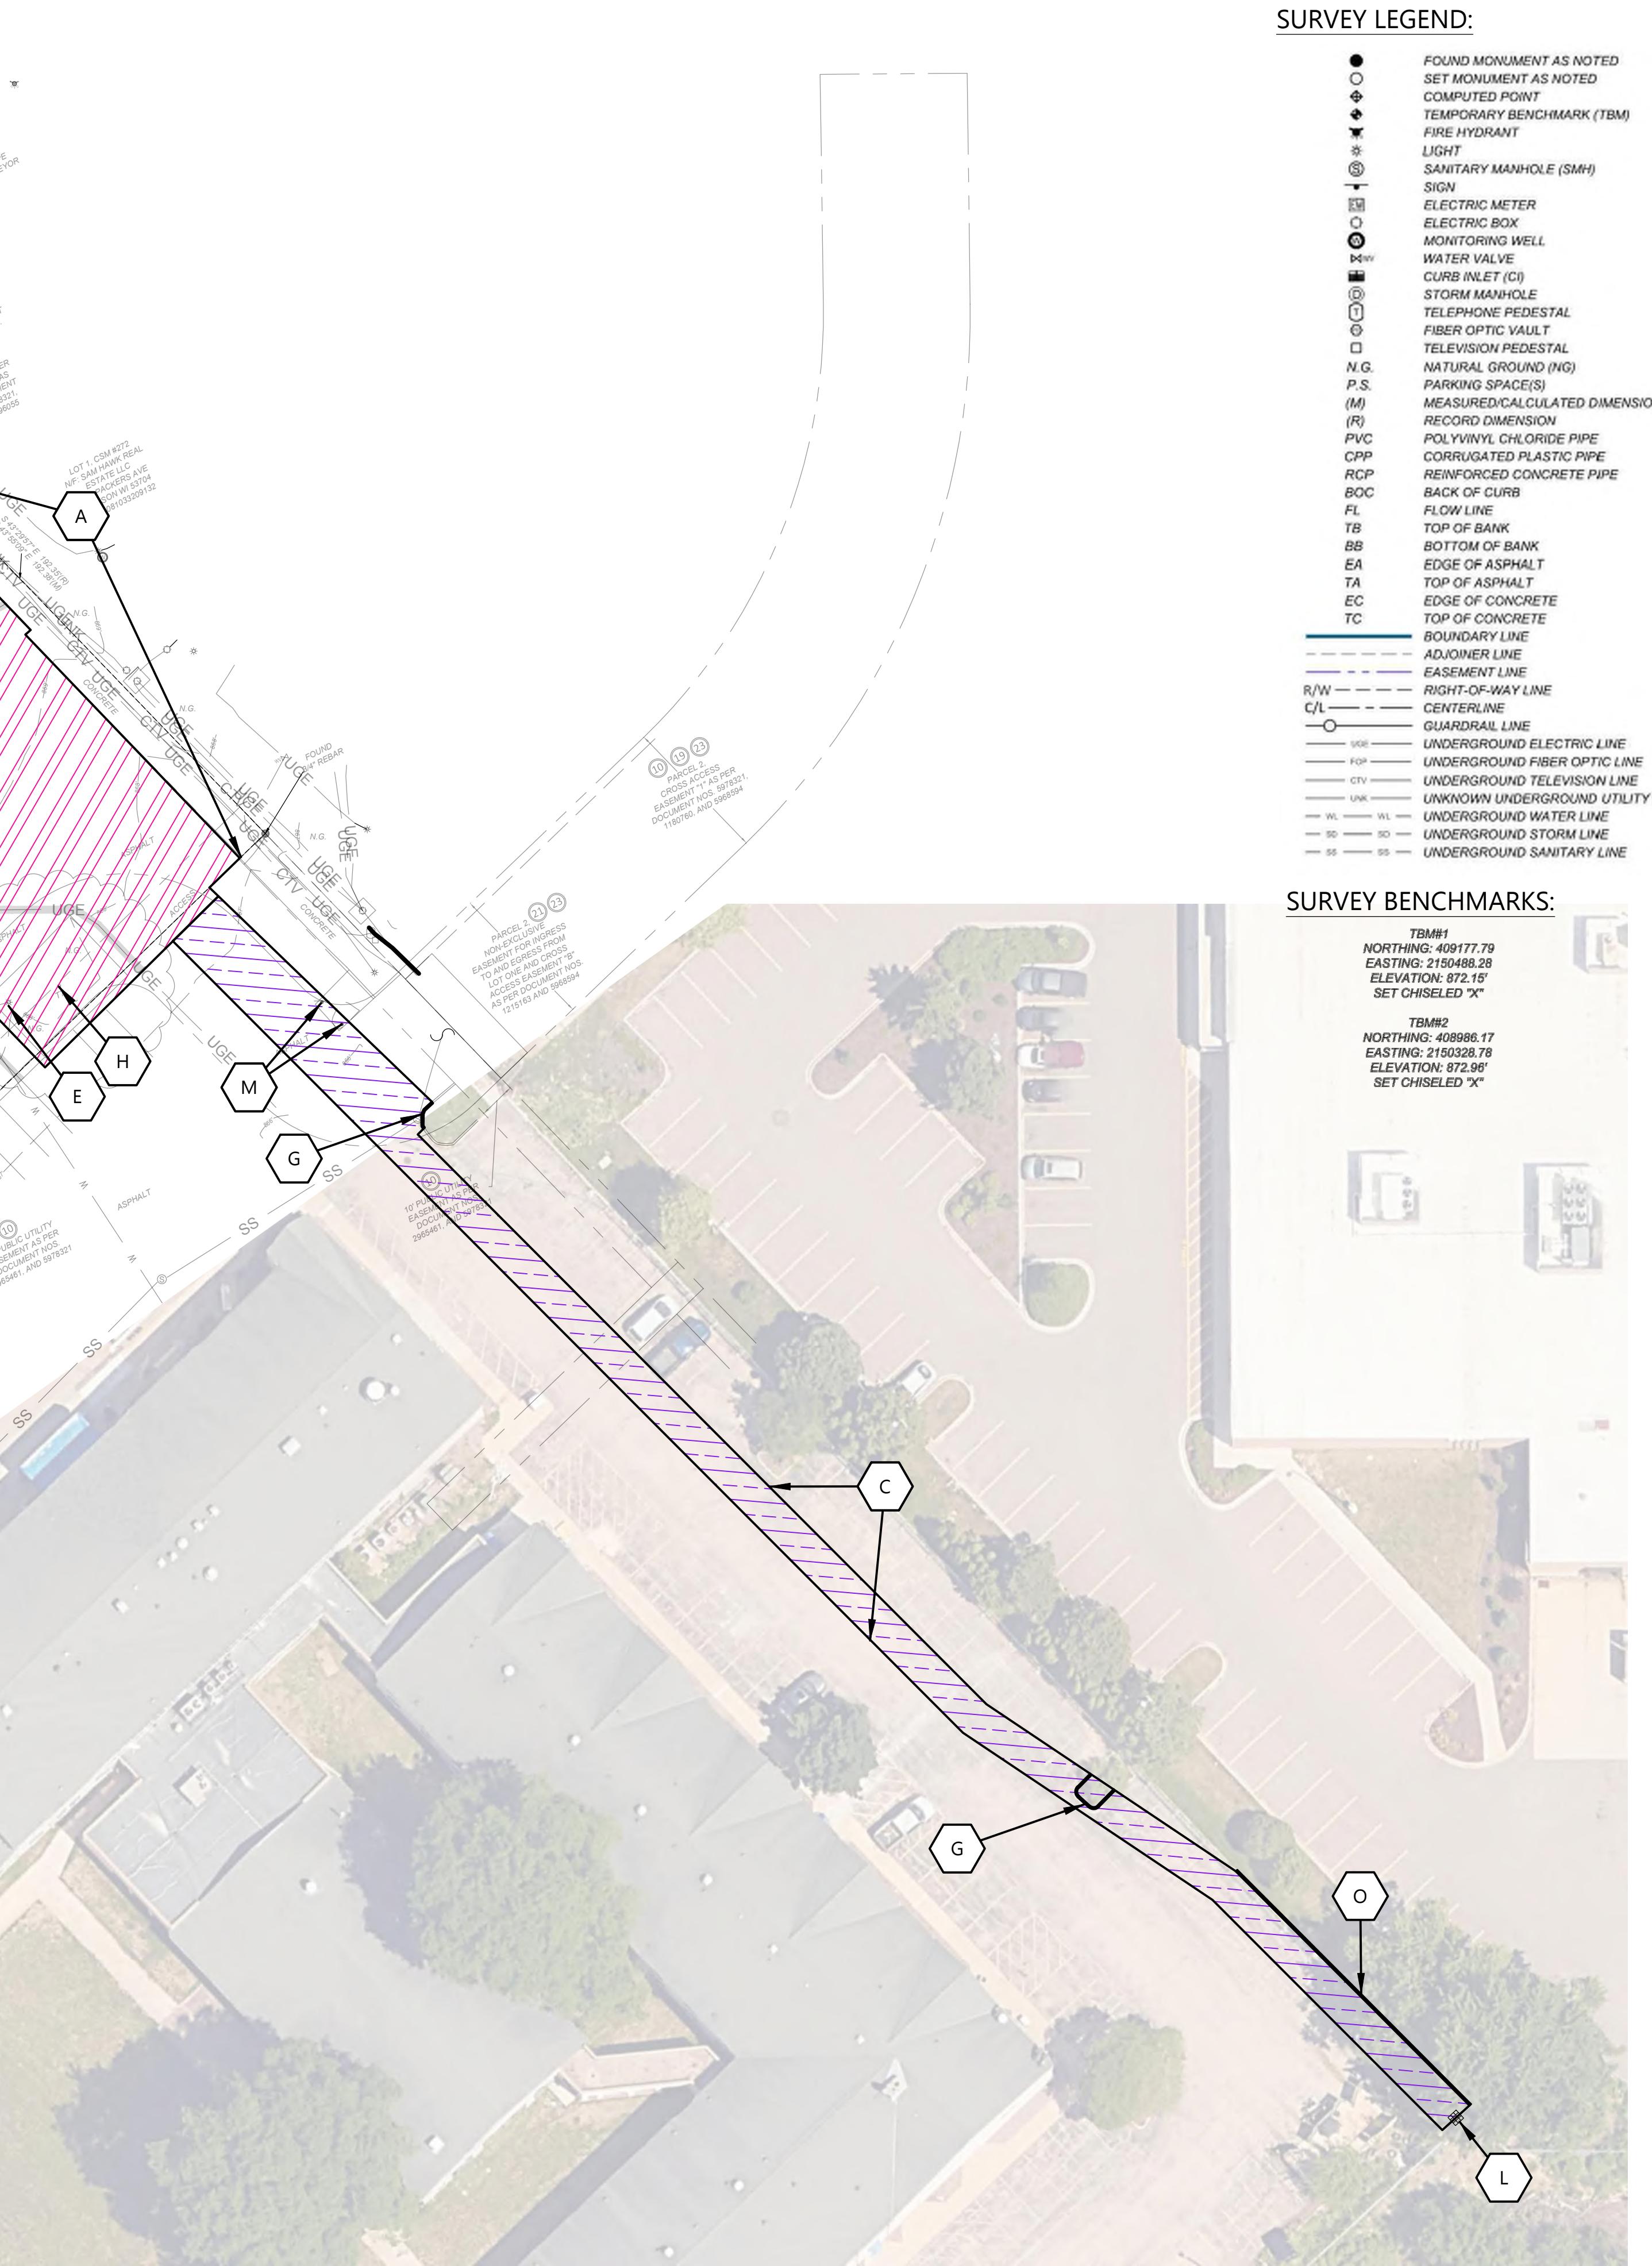

# PROPOSED COFFEE SHOP FOR: 7-BREW MADISON

3915 LIEN RD. • MADISON, WI 53704

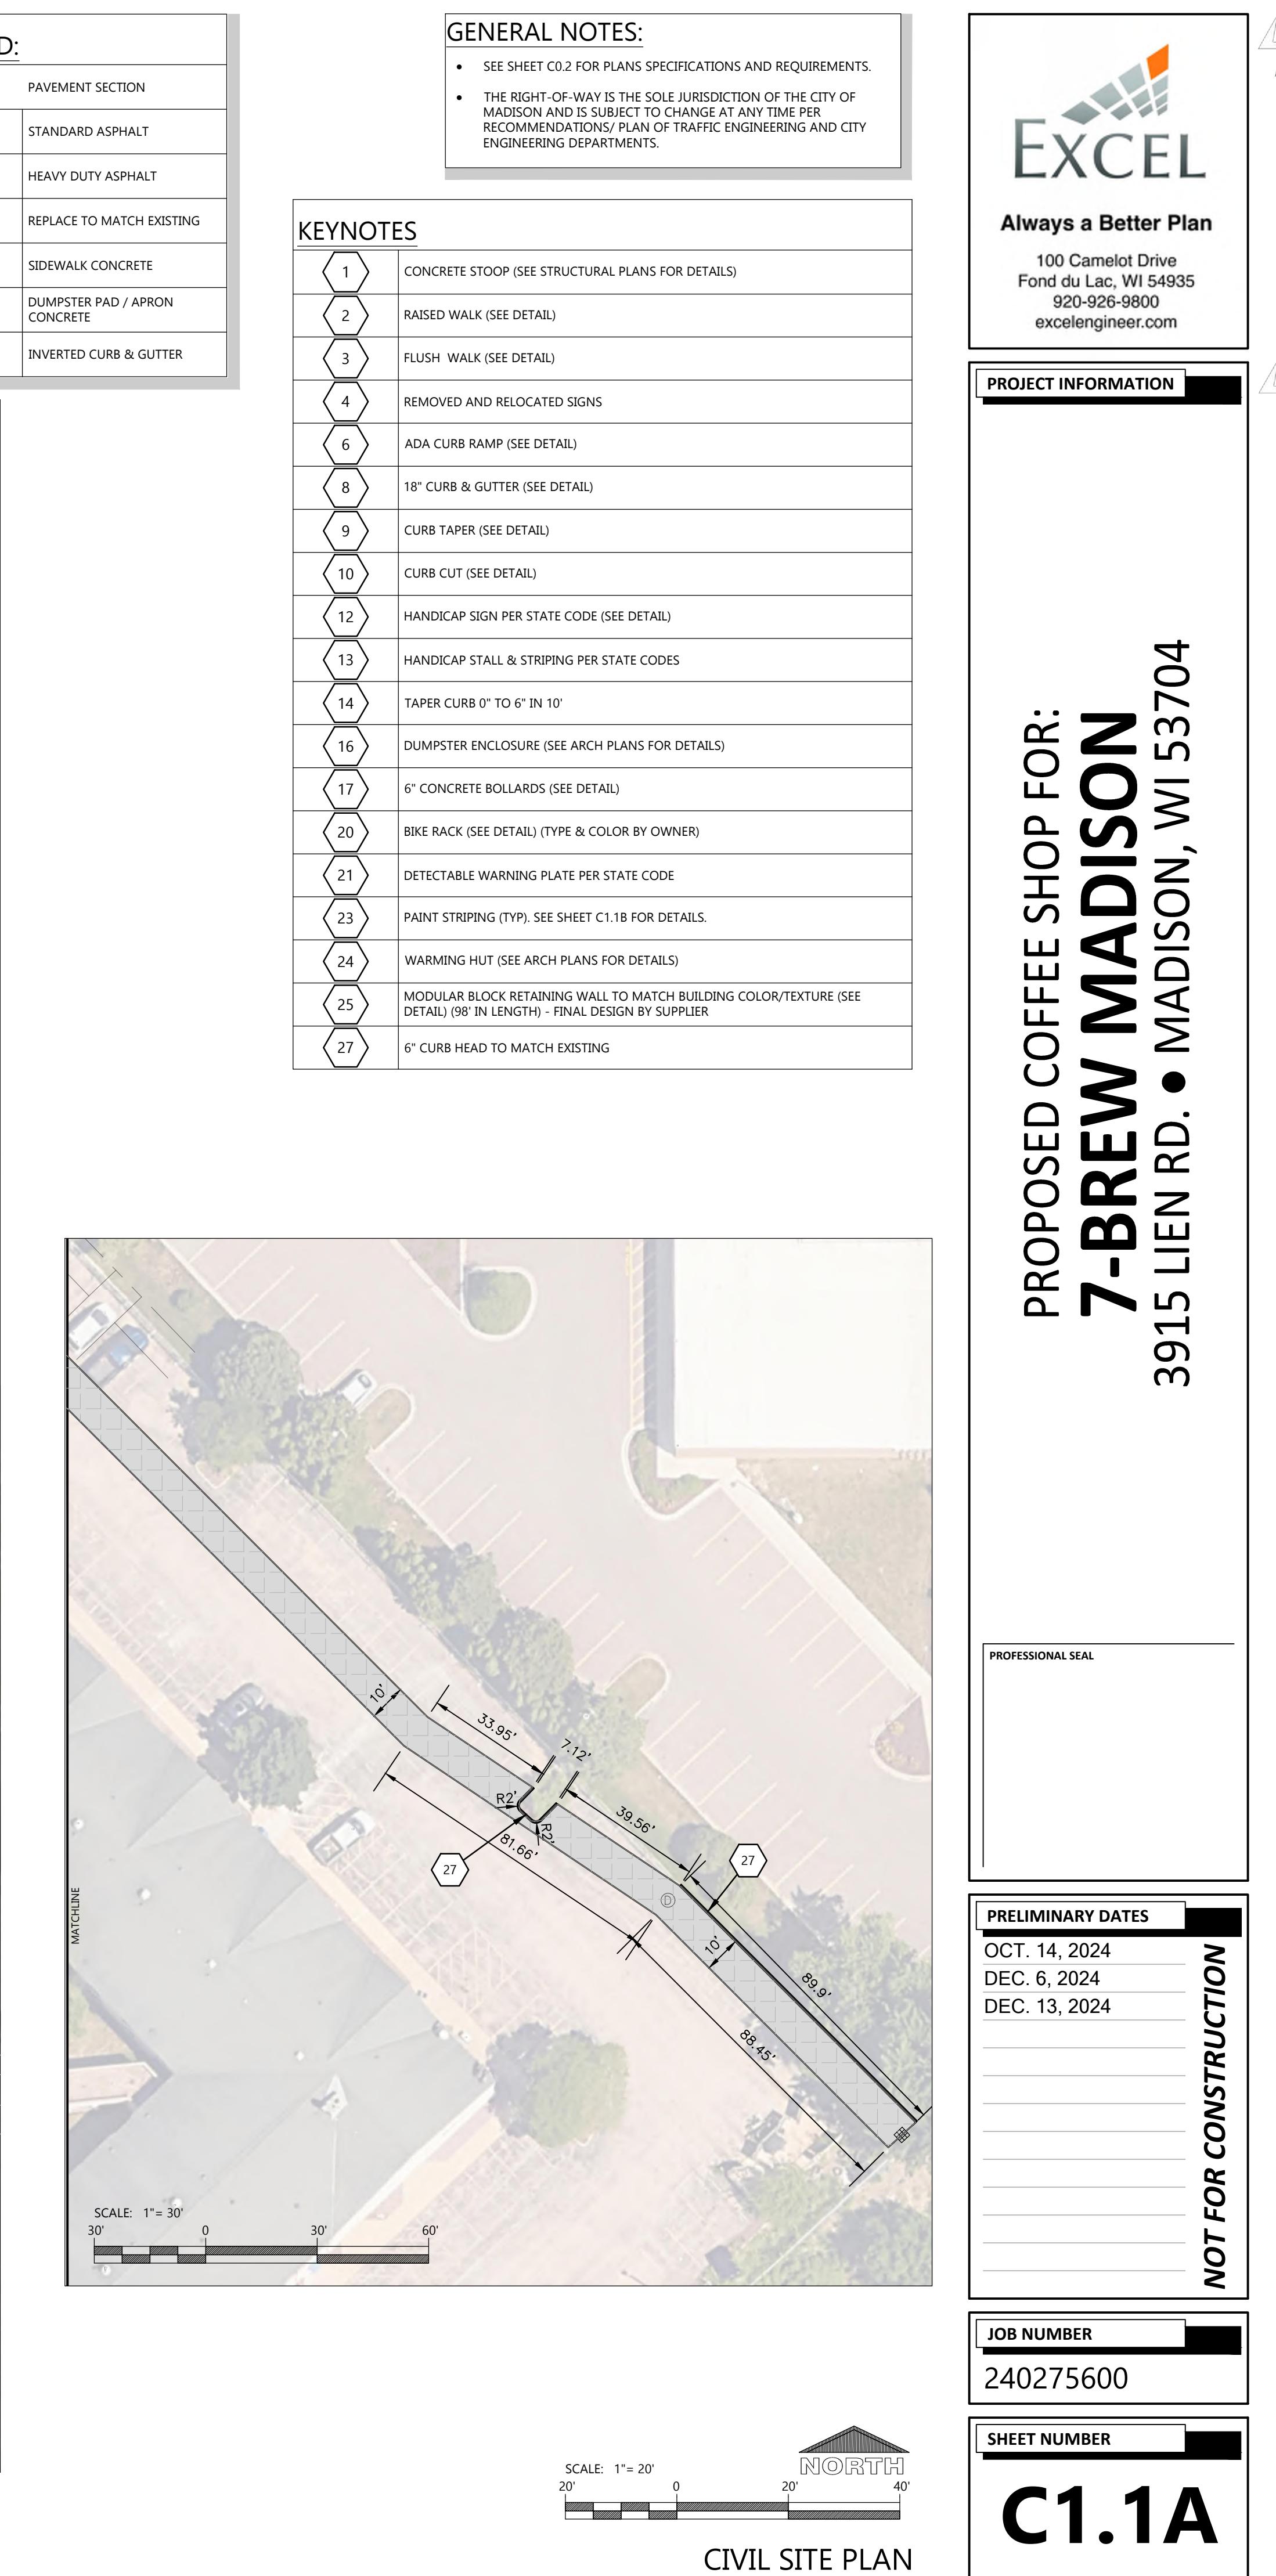
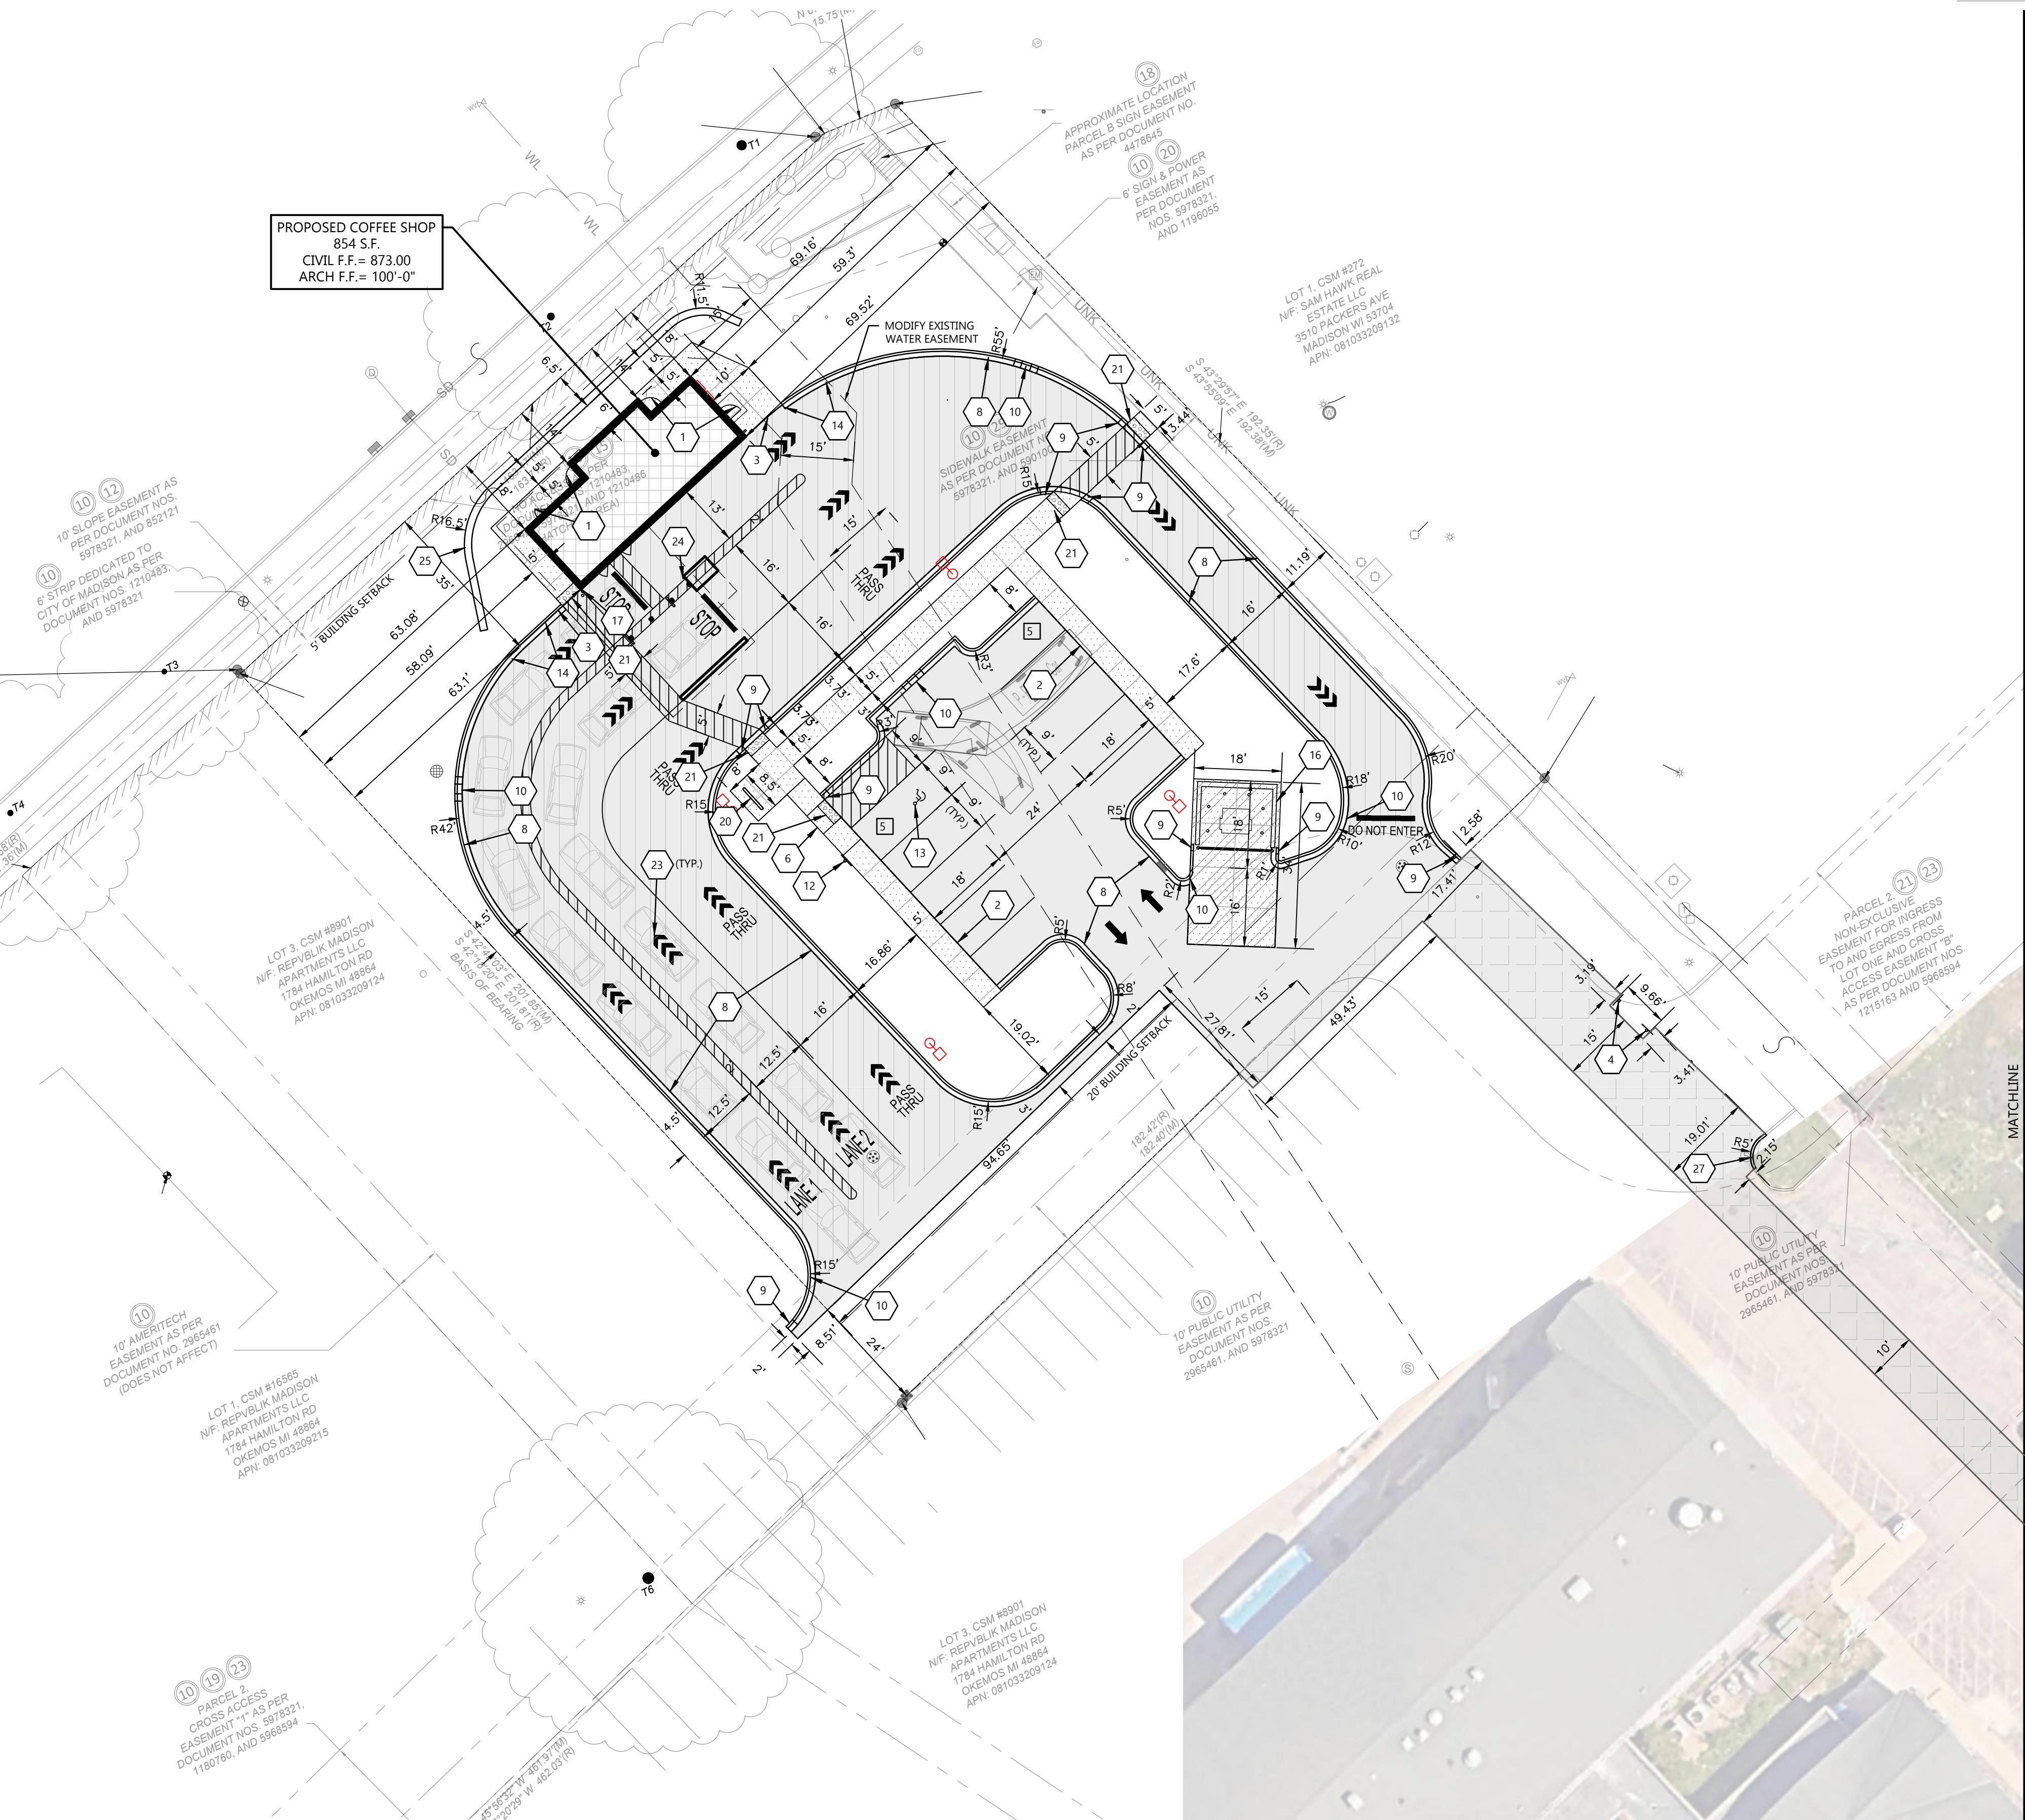


GENERAL NOTES:

- SEE SHEET C0.2 FOR PLAN SPECIFICATIONS AND REQUIREMENTS.
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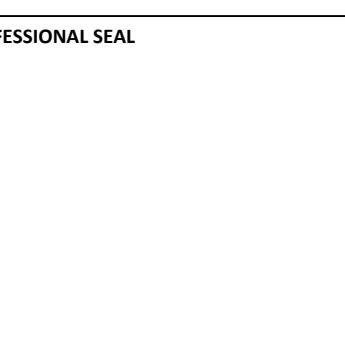
PROJECT INFORMATION

PROPOSED COFFEE SHOP FOR:  
**7-BREW MADISON**  
3915 LIEN RD. • MADISON, WI 53704

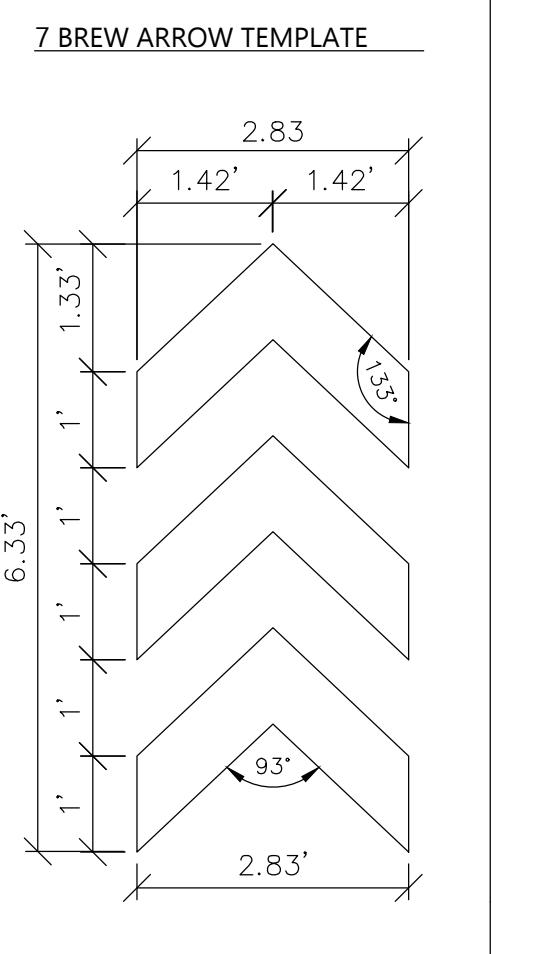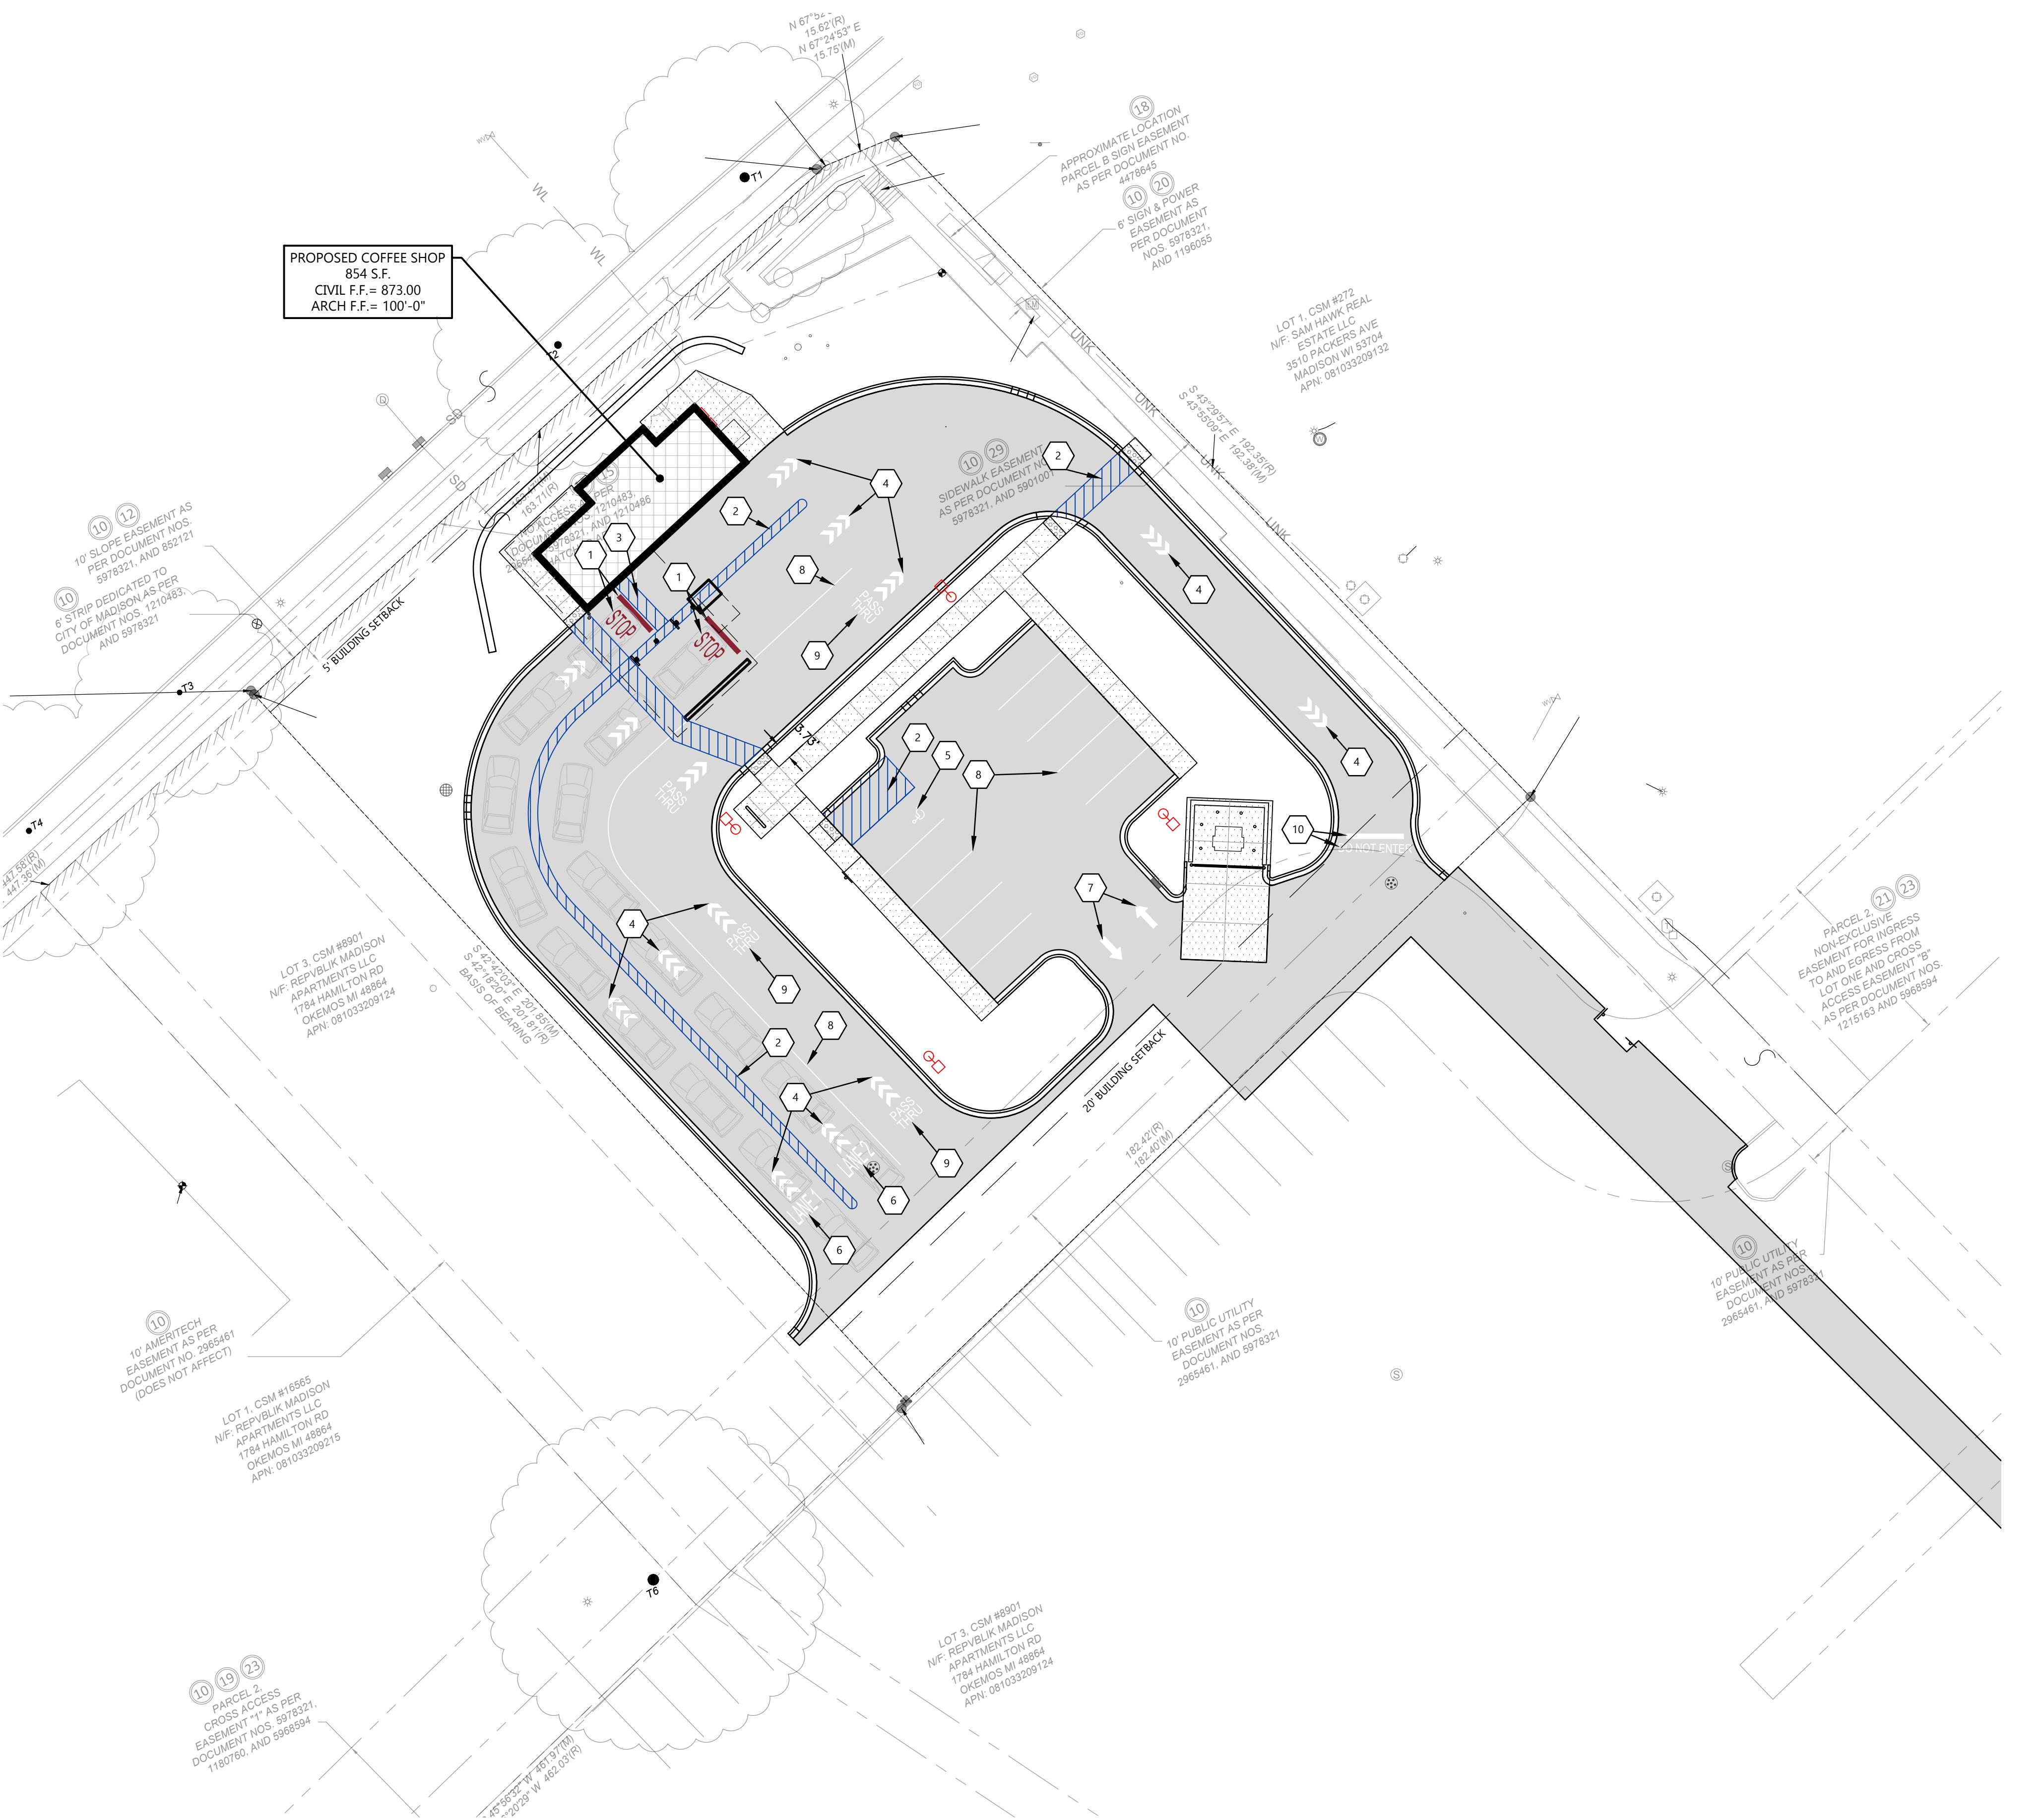

STRIPING PAINT COLORS:			
SUBSTITUTION TO COLORS MUST BE APPROVED BY 7 BREW			
PMS 000C	WHITE	C: 0% M: 0% Y: 0% K: 0%	
R: 255		G: 255	B: 255
HEX: FFFFFF			
PMS 293	BLUE	C: 100% M: 63% Y: 0% K: 35%	
R: 0		G: 61	B: 165
HEX: 003DAD			
PMS 202	RED	C: 29.54% M: 95.11% Y: 74.72% K: 29.59%	
R: 138		G: 36	B: 50
HEX: 8A2432			
PAINT TYPE:			
SHERWIN- WILLIAMS PRO PARK, SETFAST, HOTLINE OR AN APPROVED EQUAL.			

STRIPING PLAN KEYNOTES	
	12" TALL RED STOP BAR WITH 48-INCH TALL "STOP" TEXT PAINTED IN RED
	4" SOLID BLUE PAVEMENT MARKER, TYPICAL MIDLINES SPACED AT 24' O.C.
	ALIGN 4" SOLID BLUE CROSS WALK MARKER WITH SLIDING DOOR PANEL AT FRONT OPENING
	SOLID WHITE TRIPLE ARROW PAVEMENT MARKER (SEE DETAIL)
	WHITE PAINTED ADA ACCESSIBLE PARKING SYMBOL
	48-INCH TALL "LANE #" PAINTED IN WHITE
	SOLID WHITE DIRECTIONAL ARROW PAVEMENT MARKING
	4" SOLID WHITE PAVEMENT MARKER, TYPICAL
	24-INCH TALL "PASS THRU" PAINTED IN WHITE
	12" TALL WHITE STOP BAR WITH 48-INCH TALL "DO NOT ENTER" TEXT PAINTED IN WHITE



PRELIMINARY DATES

DEC. 6, 2024

DEC. 13, 2024


NOT FOR CONSTRUCTION

JOB NUMBER

240275600

SHEET NUMBER

C1.1B

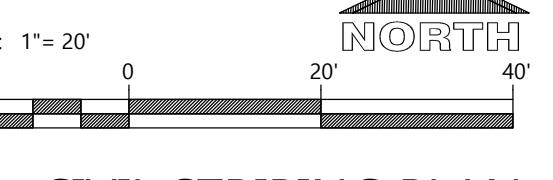

NORTH

20' 0' 20' 40'

CIVIL STRIPING PLAN

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**PROPOSED COFFEE SHOP FOR:  
7-BREW MADISON**  
3915 LIEN RD. • MADISON, WI 53704

**NOT FOR CONSTRUCTION**
**PRELIMINARY DATES**

DEC. 6, 2024

**JOB NUMBER**  
240275600

**SHEET NUMBER**  
C1.2




EXISTING R.O.W. TREES			
COMMON NAME	BOTANICAL NAME	SIZE	QUANTITY
HONEYLOCUST	GLEIDITISIA TRIANCANTHOS SPP.	24" DIA	1
HONEYLOCUST	GLEIDITISIA TRIANCANTHOS SPP.	18" DIA	1
HONEYLOCUST	GLEIDITISIA TRIANCANTHOS SPP.	14" DIA	1
ELM	ULMUS	13" DIA	1

**GENERAL NOTES:**

- HANDICAP STALL AND ACCESS AISLES SHALL NOT EXCEED A SLOPE OF 1.50% IN ANY DIRECTION. HANDICAP STALL & ACCESS AISLES SHALL CONFORM TO ADA REQUIREMENTS (CURRENT EDITION).
- ALL SIDEWALKS SHALL NOT EXCEED A MAXIMUM CROSS SLOPE OF 1.50% AND RUNNING SLOPE OF 4.50% UNLESS OTHERWISE SPECIFIED.
- CONTRACTOR SHALL PROVIDE STABILIZED CONSTRUCTION ENTRANCE AT CONSTRUCTION ENTRANCE FOR PROPOSED IMPROVEMENTS AS REQUIRED PER CODE.
- CONTRACTOR SHALL PROVIDE CONCRETE WASHDOWN AS REQUIRED PER CODE. FINAL LOCATION TBD BY CONTRACTOR.
- CONTRACTOR SHALL PROVIDE TEMPORARY INLET PROTECTION FOR ALL CURB INLETS & CATCH BASINS ON SITE & OFF SITE IMMEDIATELY DOWNSTREAM OF THE PROJECT SITE PER LOCAL CODE.
- THE RIGHT-OF-WAY IS THE SOLE JURISDICTION OF THE CITY OF MADISON AND IS SUBJECT TO CHANGE AT ANY TIME PER RECOMMENDATIONS/ PLAN OF TRAFFIC ENGINEERING AND CITY ENGINEERING DEPARTMENTS.

**PROJECT INFORMATION**

KEYNOTES	
EC 1	SILT FENCE
EC 2	STABILIZED CONSTRUCTION ENTRANCE
EC 3	INLET PROTECTION
EC 4	SEDIMENT LOG

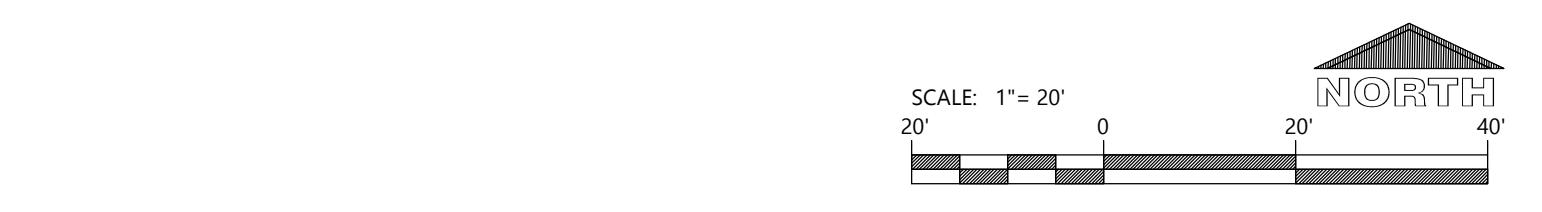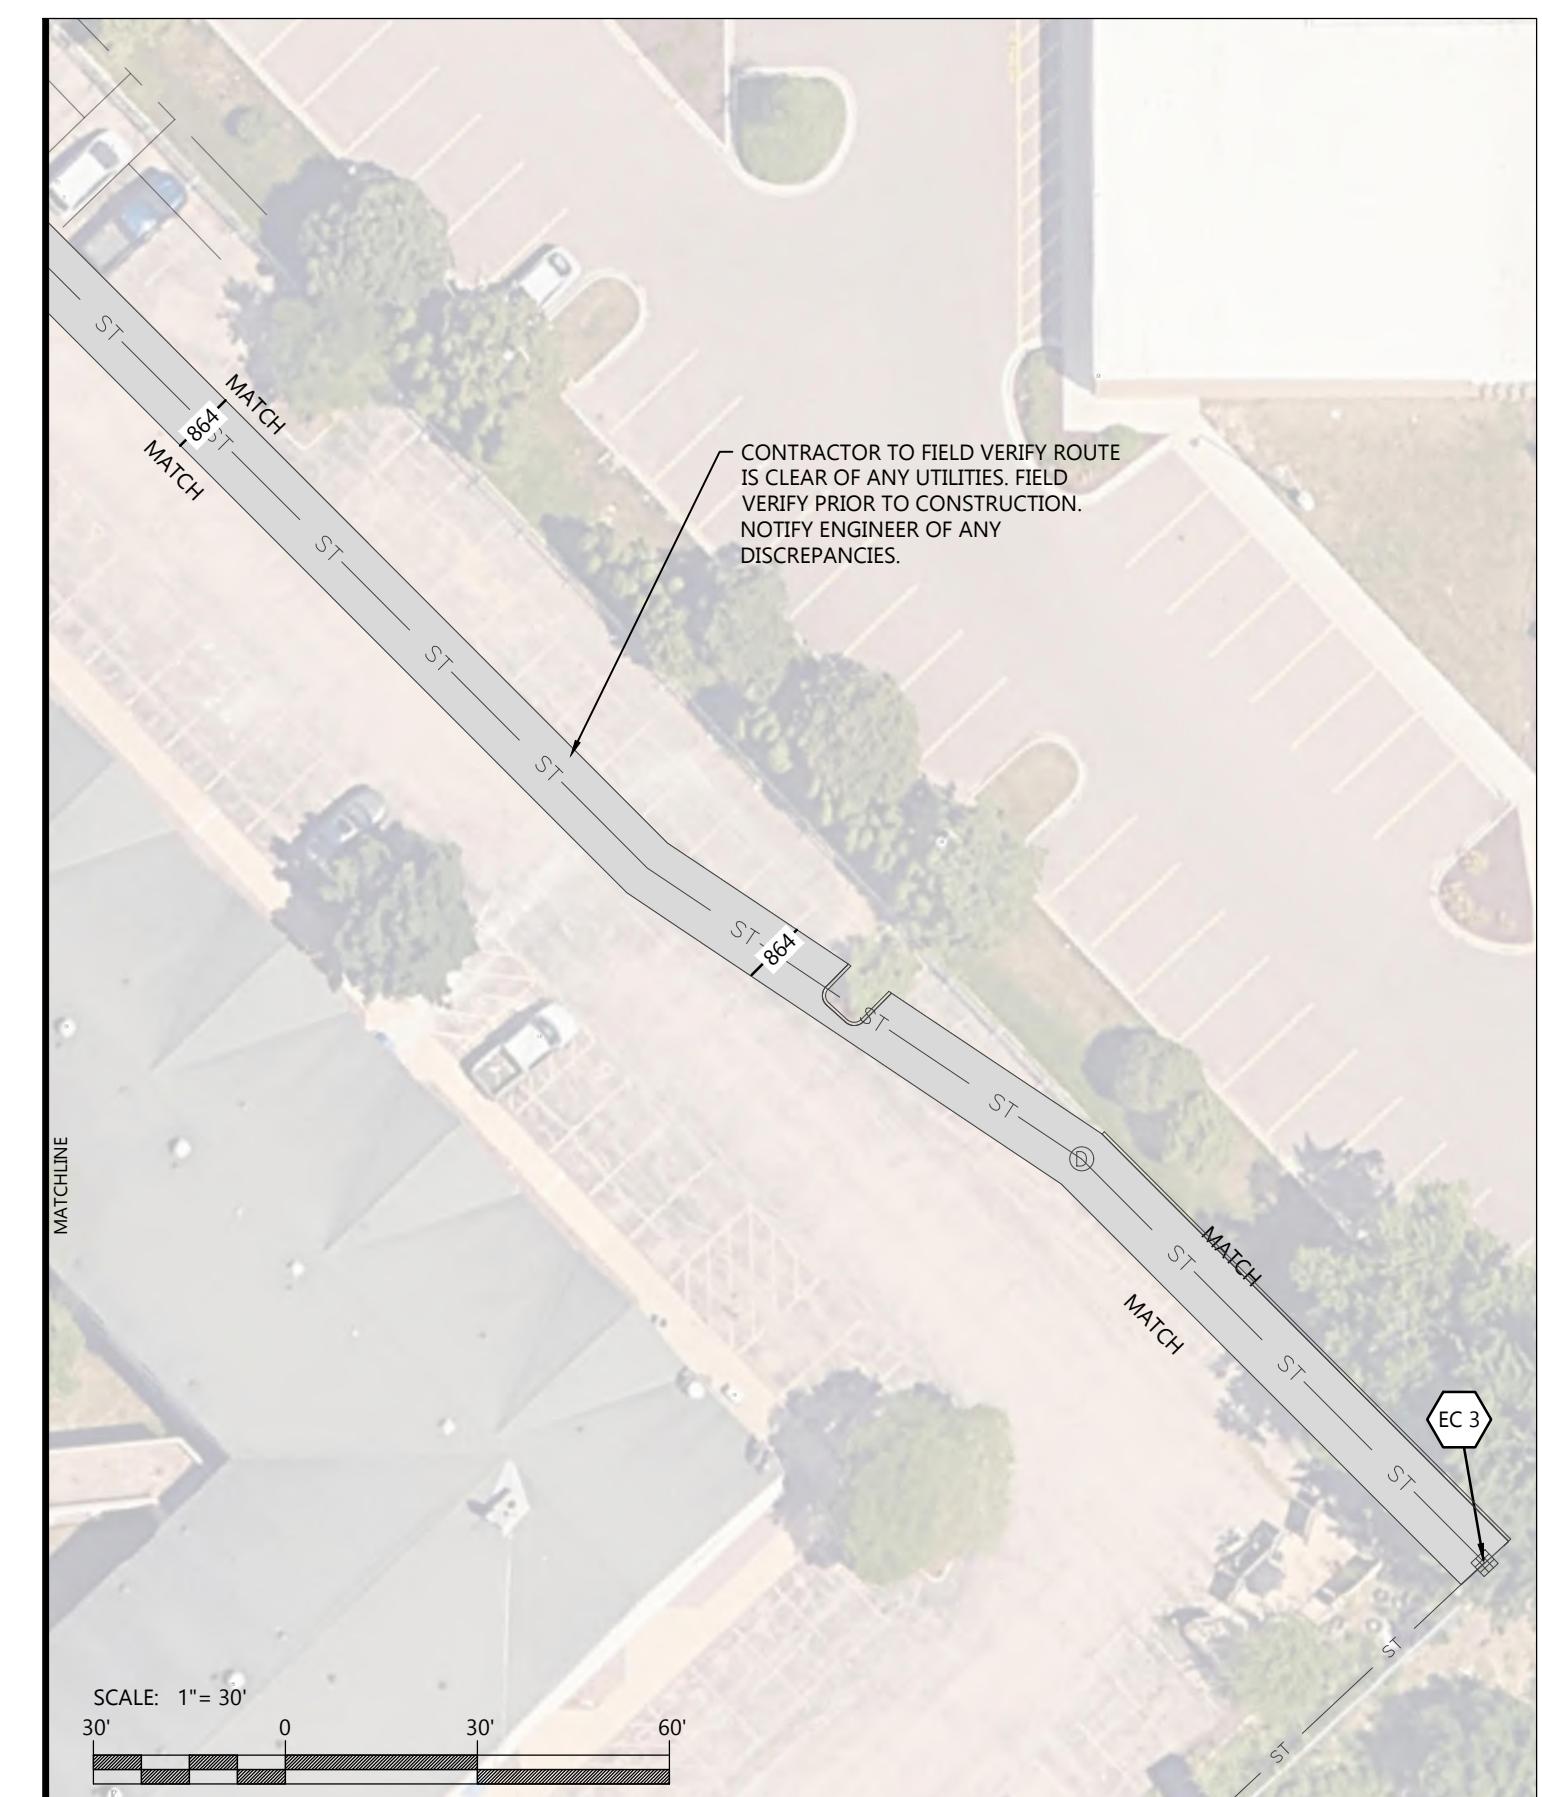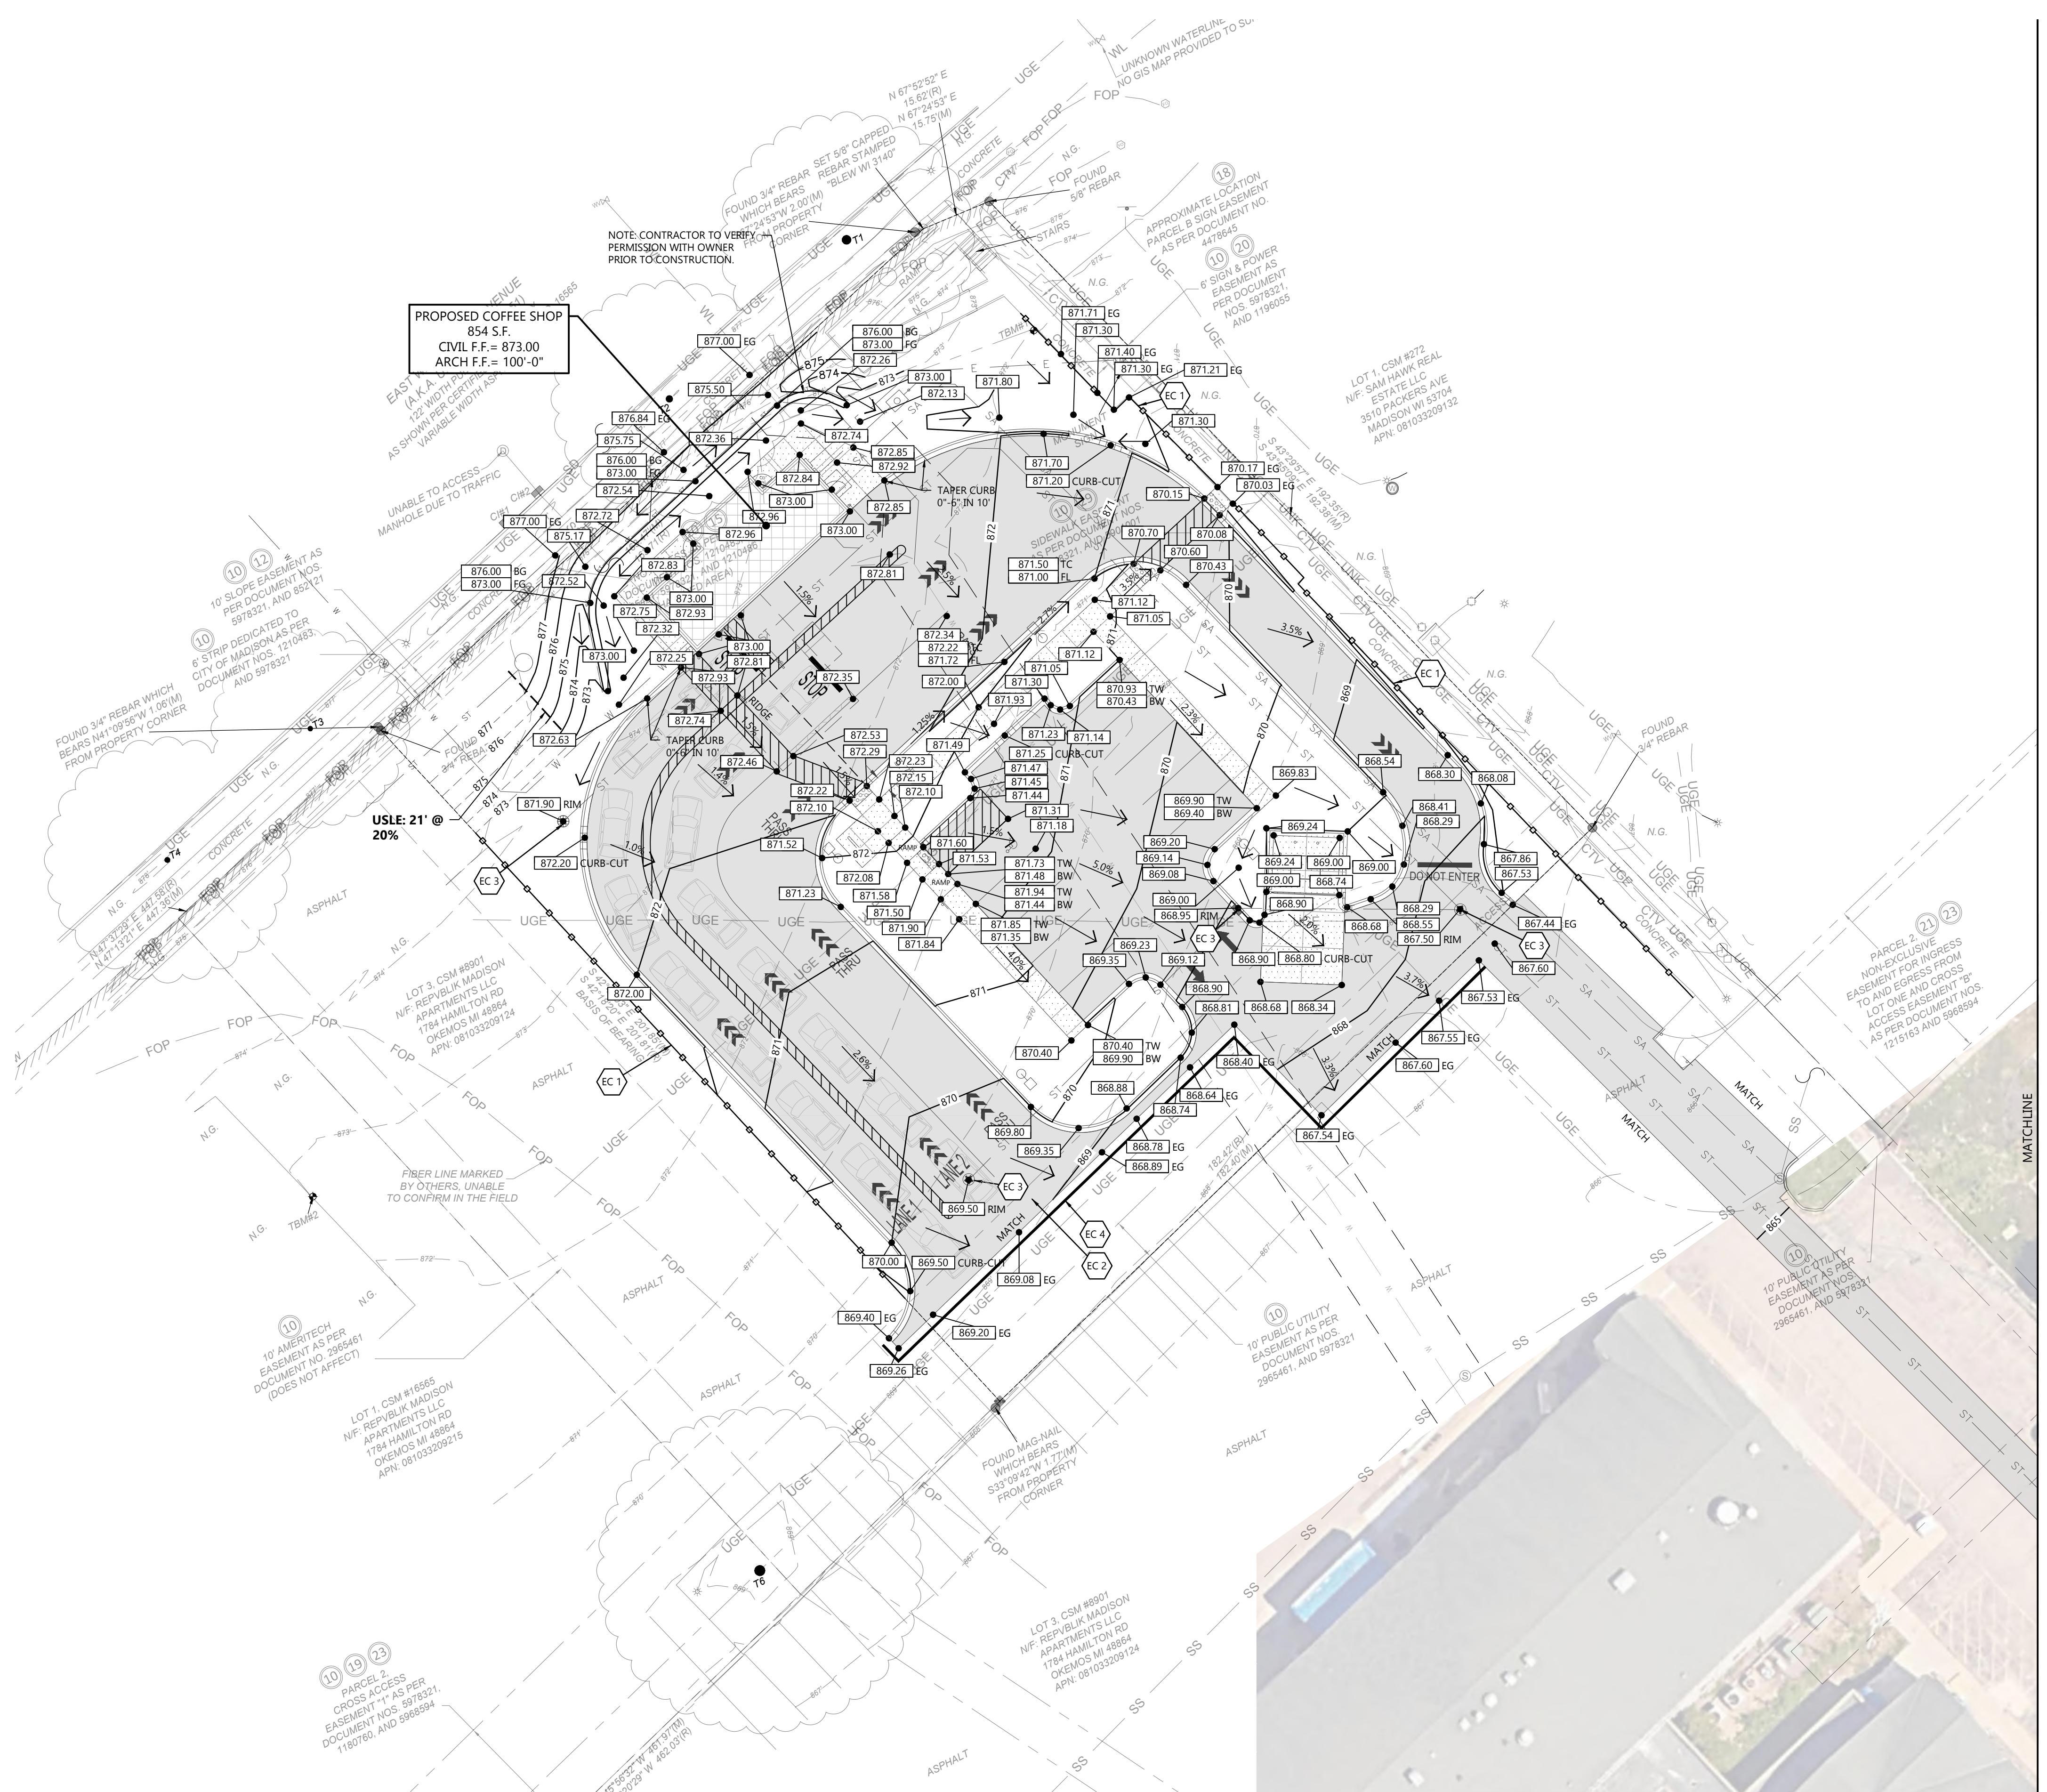
**CIVIL GRADING AND EROSION CONTROL PLAN**

## Always a Better Plan

100 Camelot Drive  
Fond du Lac, WI 54935  
920-926-9800  
[excelengineer.com](http://excelengineer.com)

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**7-BREW MADISON**  
3915 LIEN RD. • MADISON, WI 53704

## ERAL NOTES:

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ADISON AND IS SUBJECT TO CHANGE AT ANY TIME PER  
COMMENDATIONS/ PLAN OF TRAFFIC ENGINEERING AND CITY  
ENGINEERING DEPARTMENTS.

## SURVEY NOTE:

ALTA/NSPS LAND TITLE SURVEY WAS COMPLETED BY BUCKLEY D. BLEW  
PROJECT NUMBER 24-6247) REVISION DATED OCTOBER 10, 2024. CONTACT  
BLEW AT SUVERT@BLEWINC.COM WITH ANY QUESTIONS REGARDING  
SURVEY OR EXISTING CONDITIONS INFORMATION. SEE ALTA/NSPS LAND  
TITLE SURVEY FOR ADDITIONAL INFORMATION. PRIOR TO CONSTRUCTION,  
CONTRACTOR SHALL FIELD VERIFY ALL SITE IMPROVEMENTS, UTILITY  
LOCATIONS, INVERTS, SIZES, ETC. NOTIFY ENGINEER OF DISCREPANCIES.  
FAILURE TO NOTIFY ENGINEER SHALL BE THE CONTRACTOR'S  
RESPONSIBILITY FOR ANY DAMAGES AS A RESULT OF FAILURE TO FIELD  
VERIFY.

## PROJECT INFORMATION

100 Camelot Drive  
Fond du Lac, WI 54935  
920-926-9800  
[excelengineer.com](http://excelengineer.com)

## PROFESSIONAL SEAL

## RELIMINARY DATES


JOB NUMBER

**HEET NUMBER**

212

C1.5

EXISTING R.O.W. TREES			
COMMON NAME	BOTANICAL NAME	SIZE	QUANTITY
HONEYLOCUST	GLEDITISIA TRIANCANTHOS SPP.	24" DIA	1
HONEYLOCUST	GLEDITISIA TRIANCANTHOS SPP.	18" DIA	1
HONEYLOCUST	GLEDITISIA TRIANCANTHOS SPP.	14" DIA	1
ELM	ULMUS	13" DIA	1

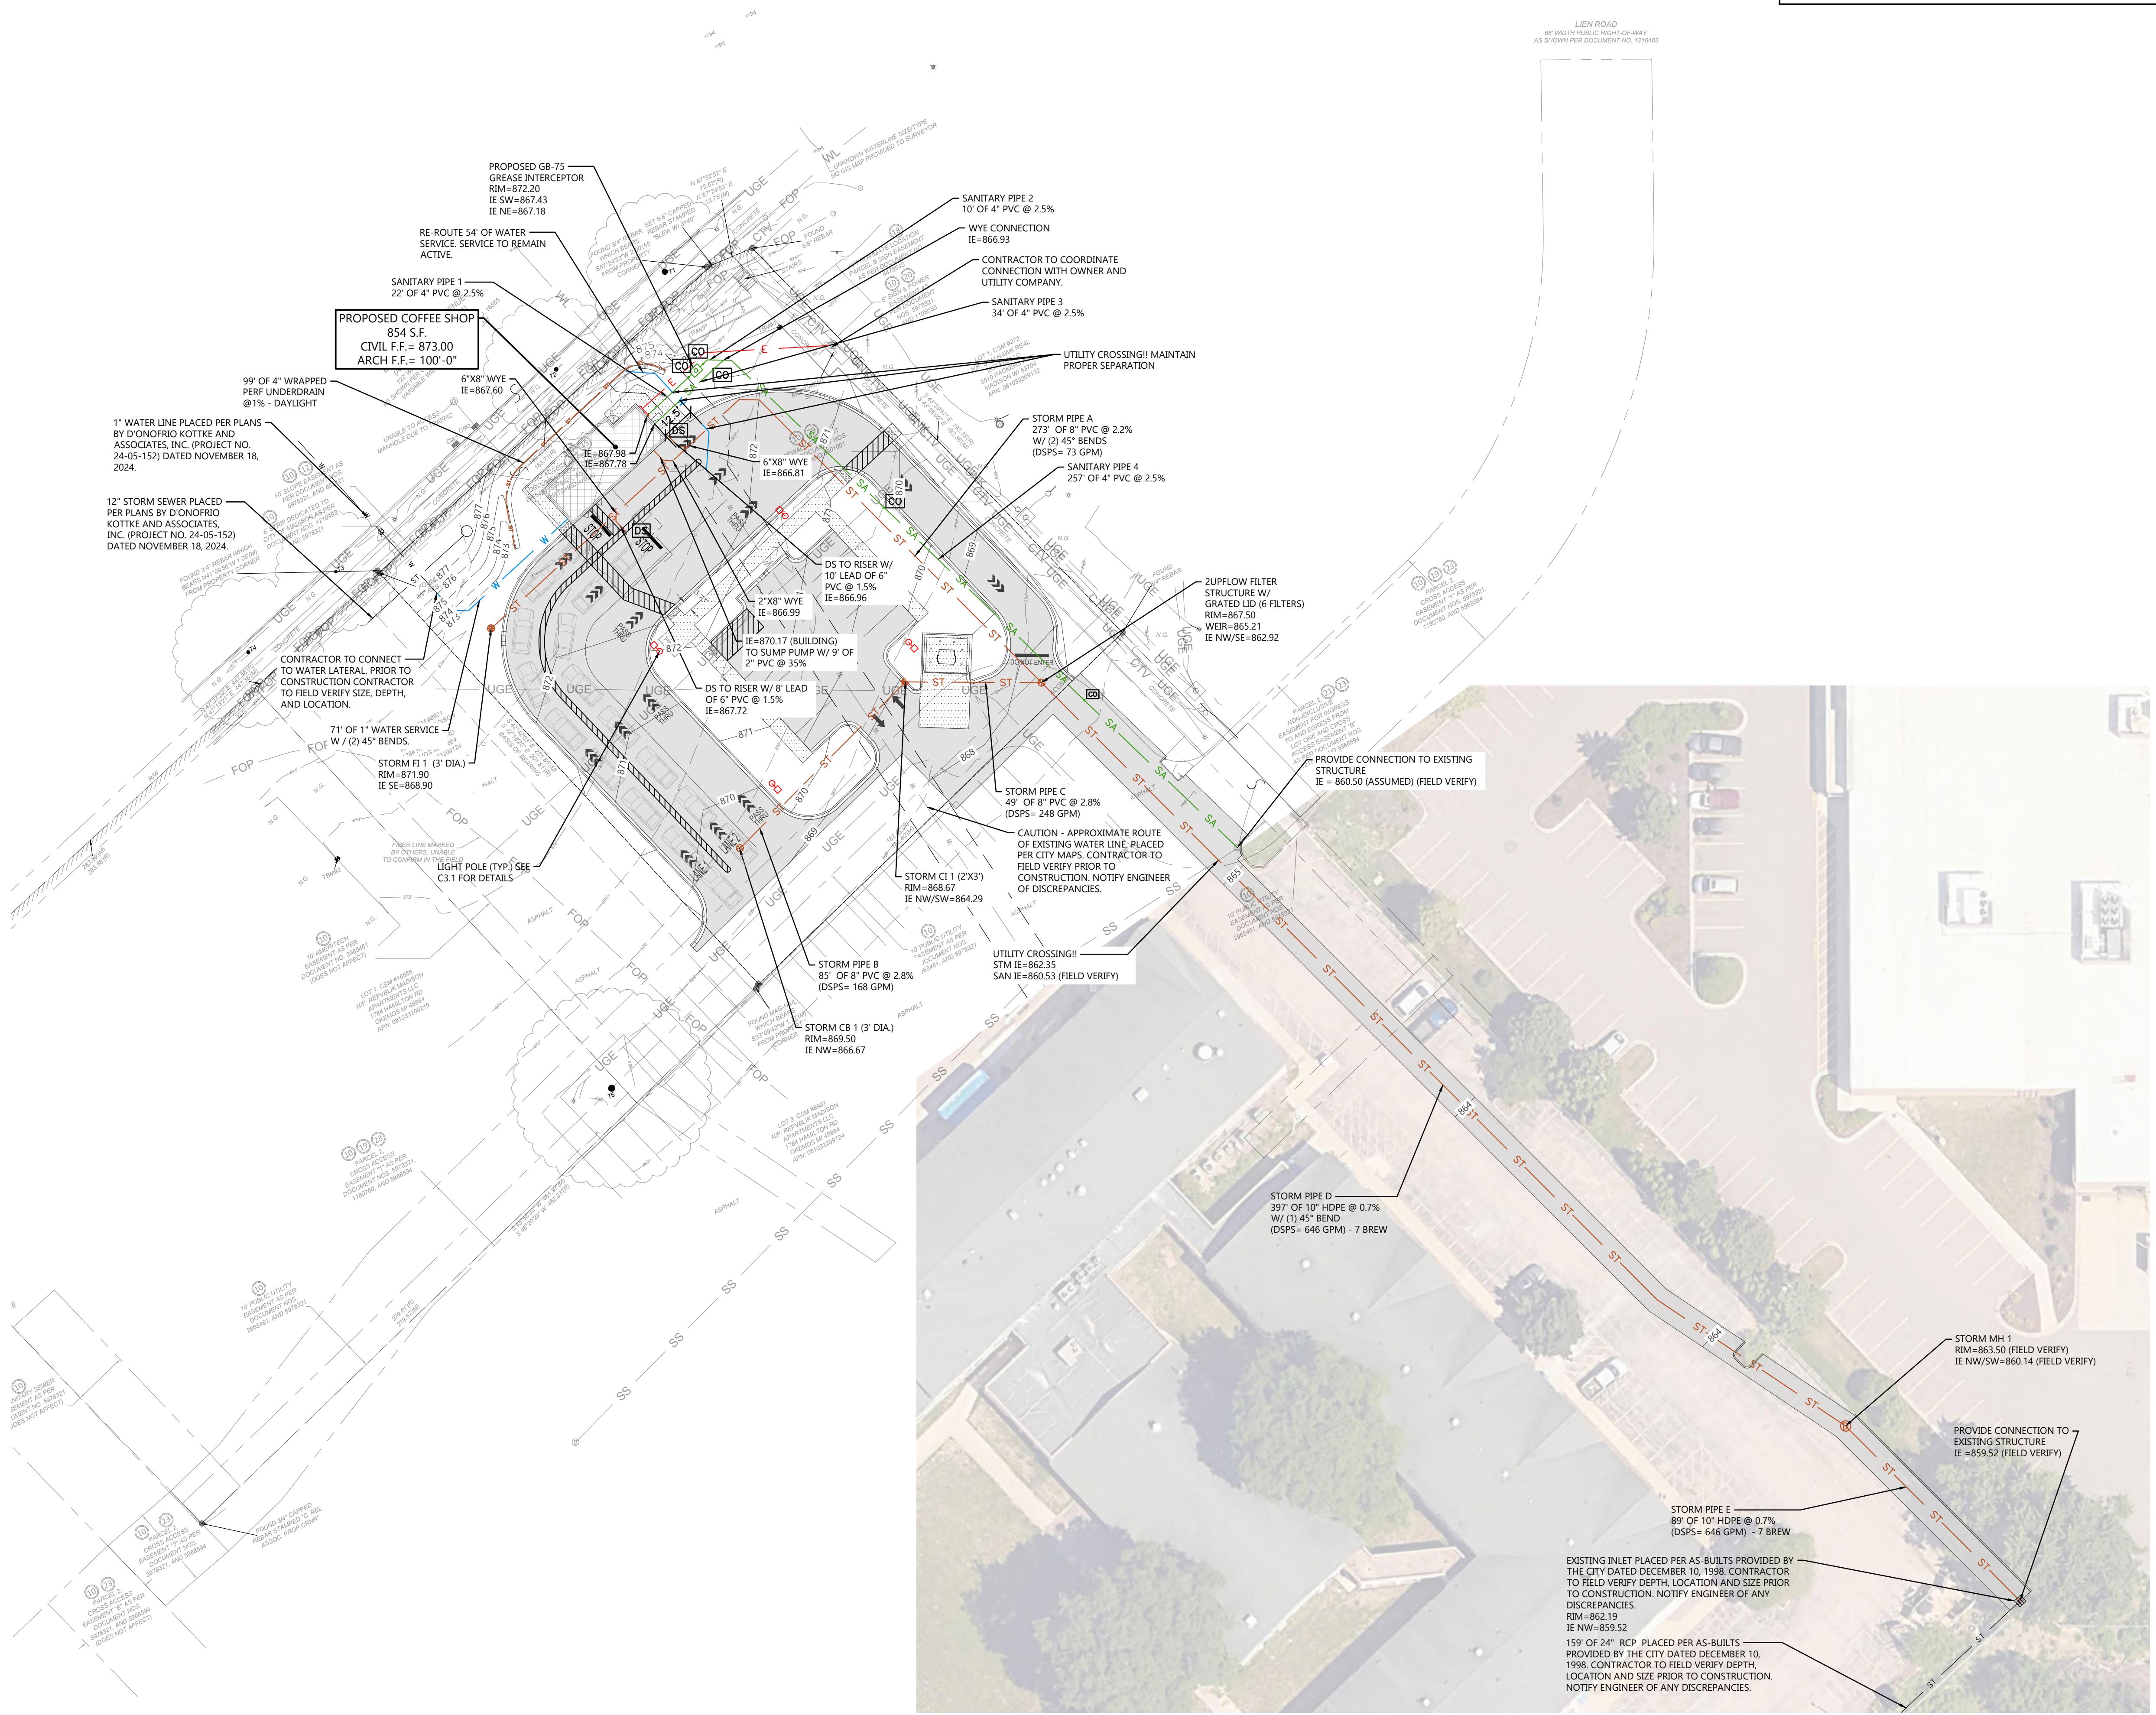

## LANDSCAPE PLANT SCHEDULE

SYMBOL	COMMON NAME	BOTANICAL NAME	PLANTED SIZE	ROOT	HEIGHT	SPREAD	QUANTITY	POINTS
<u>OVERSTORY TREES</u>								
	Green Column Black Maple	<i>Acer saccharum</i> ssp. <i>nigrum</i> 'Green Column'	2 1/2" CAL.	B&B	50-70'	20-30'	4	35
	Autumn Gold Ginkgo	<i>Ginkgo biloba</i> 'Autumn Gold'	2 1/2" CAL.	B&B	40-50'	25-30'	4	35
	Espresso Kentucky Coffeetree	<i>Gymnocladus dioicus</i> 'Espresso-JFS'	2 1/2" CAL.	B&B	50'	35'	3	35
	Redmond Linden	<i>Tilia americana</i> 'Redmond'	2 1/2" CAL.	B&B	40-60'	25'	3	35
							POINTS IN THIS SECTION	490
<u>EVERGREEN TREES</u>								
	White Spruce	<i>Picea glauca</i>	5' HT.	B&B	40-60'	10-20'	2	35
							POINTS IN THIS SECTION	70
<u>DECIDUOUS SHRUBS</u>								
	Low Scape Mound Chokeberry	<i>Aronia melanocarpa</i> 'UCONNAM165'	12" HT.	CONT.	1-2'	2-3'	15	3
	Yuki Cherry Blossom Deutzia	<i>Deutzia x 'NCDX2'</i>	12" HT.	CONT.	1-2'	1-2'	15	3
							POINTS IN THIS SECTION	90

## TREE REMOVAL LIST

COMMON NAME	BOTANICAL NAME	SIZE	QUANTITY
<u>OVERSTORY TREES</u>			
HONEYLOCUST	GLEDTISIA TRIACANTHOS SPP.	20" DIA.	1
<u>EVERGREEN TREES</u>			
BLUE SPRUCE	PICEA PUNGENS	10-13" DIA.	4

## LANDSCAPING CALCULATIONS



ZONE	REQUIRED PLANTS	PLANTS PROVIDED
FRONTAGE	178' OF FRONTAGE 1 OVERSTORY TREE AND 5 SHRUBS PER 30' REQUIRED: 6 OVERSTORY TREES / 30 SHRUBS	PROVIDED: 6 OVERSTORY TREES / 30 SHRUBS POINTS: 300
INTERIOR PARKING LOT LANDSCAPE	16,988 SF x 5% = 869 SF REQ. LANDSCAPE AREA 1 TREE PER 160 SF OF REQ. LANDSCAPE AREA REQUIRED: 849.4 SF/160 SF = 5.3 TREES	PROVIDED: 5 OVERSTORY TREES POINTS: 175
DISPLACED LANDSCAPE REQUIREMENTS	5 EXISTING TREES REMOVED FROM SITE REQUIRED: REPLACE WITH 5 NEW TREES	PROVIDED: 5 TREES POINTS: 175
LANDSCAPE POINT CALCULATIONS	24,238 SF OF DEVELOPED AREA 5 LANDSCAPE POINTS REQ. PER 300 SF 24,238 SF/300 SF X 5 POINTS REQUIRED: 403.97 POINTS	TOTAL PROVIDED: 650 POINTS

#### GENERAL NOTES:

- PLANTS ARE SHOWN AT 60% MATURITY

#### HATCH KEY:

HATCH	LANDSCAPE MATERIAL
	MINERAL MULCH
	SEEDED LAWN

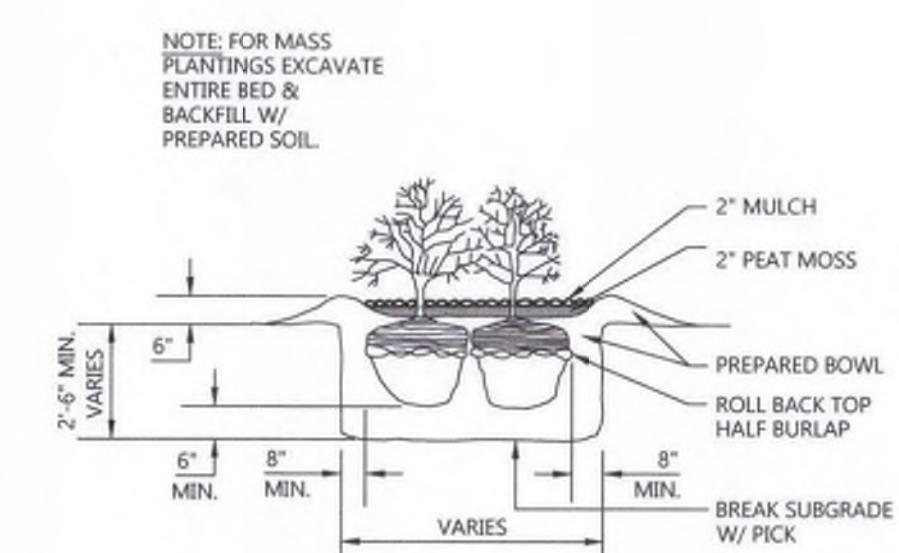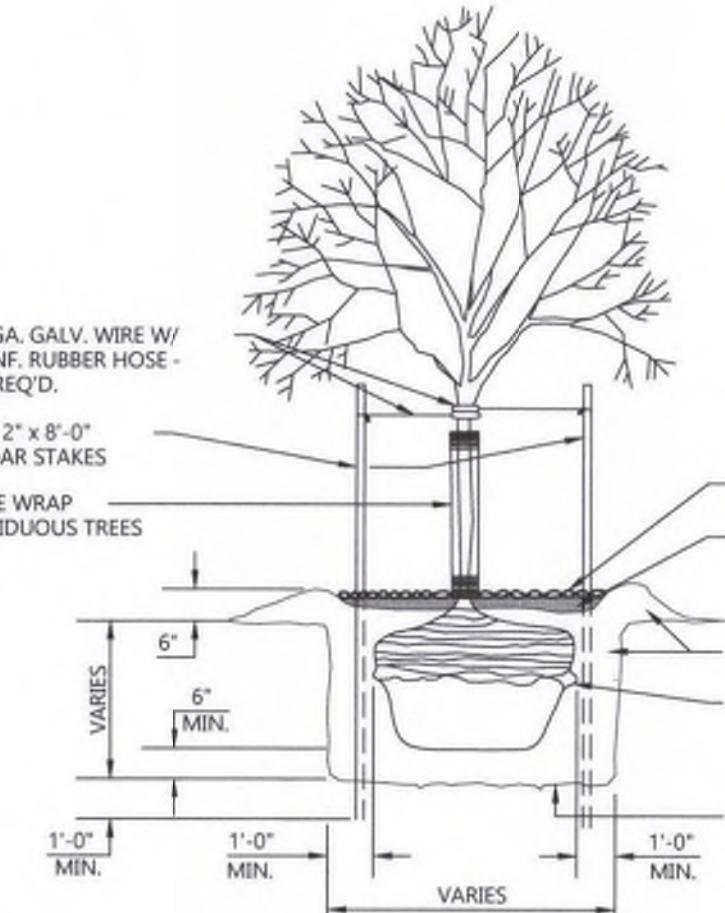


#### TREE PLANTING DETAILS

NOT TO SCALE

#### SHRUB PLANTING DETAILS

NOT TO SCALE

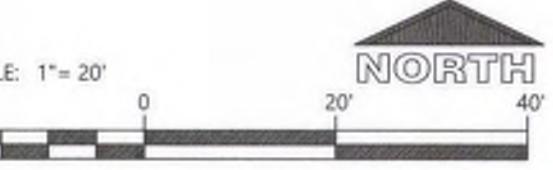

PROPOSED COFFEE SHOP FOR:  
**7-BREW MADISON**  
3915 LIEN RD. • MADISON, WI 53704

## PROFESSIONAL SEAL

90275600

**HEET NUMBER**

# C1.4



LANDSCAPE PLANT SCHEDULE								
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							POINTS IN THIS SECTION	70
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							POINTS IN THIS SECTION	90

TREE REMOVAL LIST			
COMMON NAME	BOTANICAL NAME	SIZE	QUANTITY
<u>OVERSTORY TREES</u>			
HONEYLOCUST	GLEBITSIA TRIACANTHOS SPP.	20" DIA.	1
<u>EVERGREEN TREES</u>			
BLUE SPRUCE	PICEA PUNGENS	10-13" DIA.	4

LANDSCAPING CALCULATIONS		
ZONE	REQUIRED PLANTS	PLANTS PROVIDED
FRONTAGE	178' OF FRONTAGE 1 OVERSTORY TREE AND 5 SHRUBS PER 30' REQUIRED: 6 OVERSTORY TREES / 30 SHRUBS	PROVIDED: 6 OVERSTORY TREES / 30 SHRUBS POINTS: 300
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## GENERAL NOTES:

<u>ATCH KEY:</u>	
HATCH	LANDSCAPE MATERIAL
	MINERAL MULCH
	SEEDED LAWN

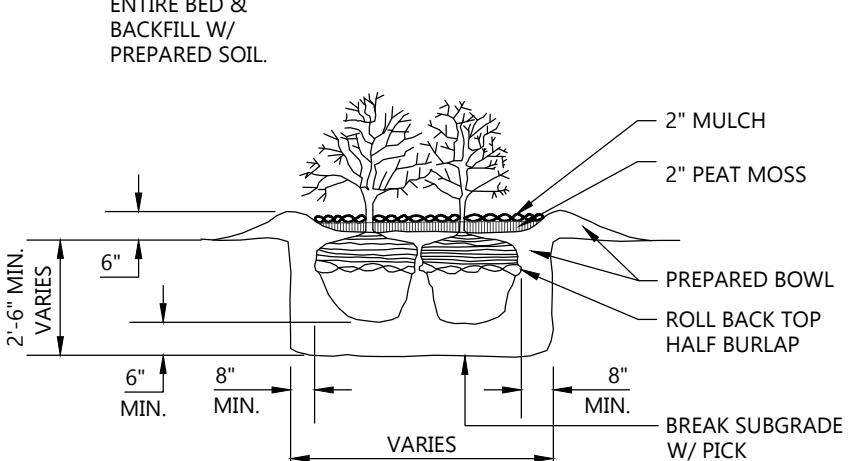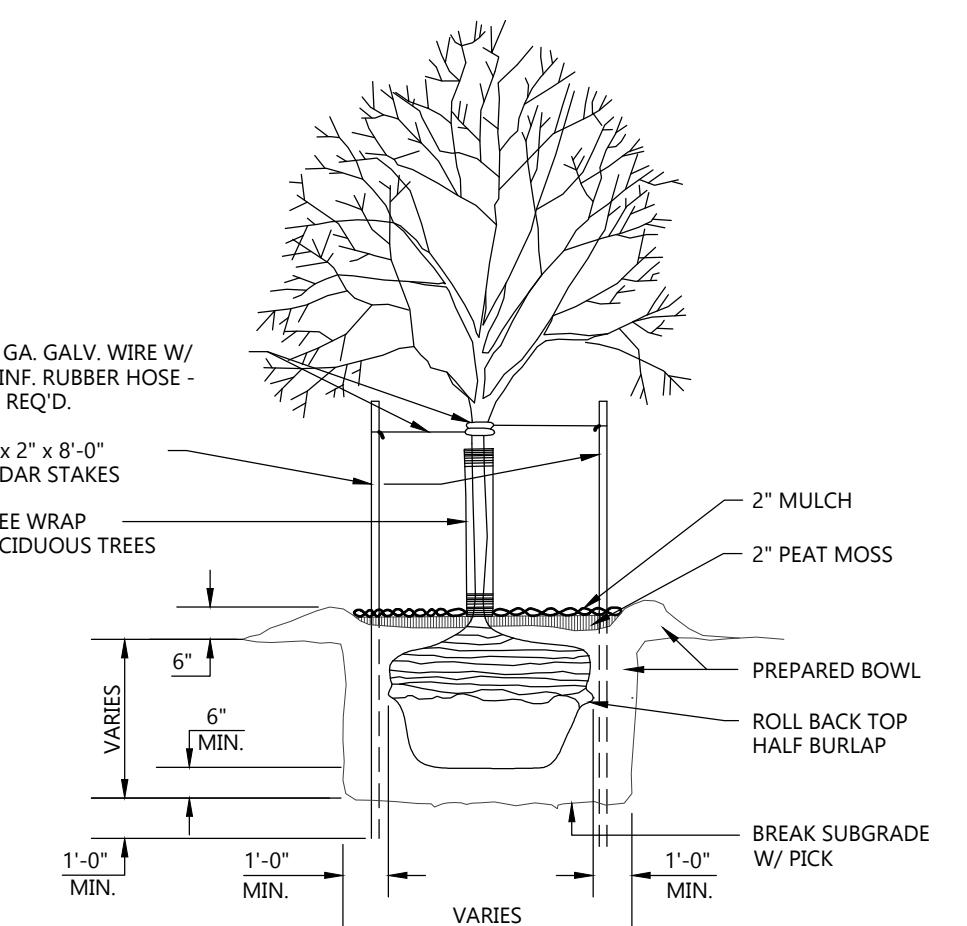

## TREE PLANTING DETAIL


## **SHRUB PLANTING DETAIL**

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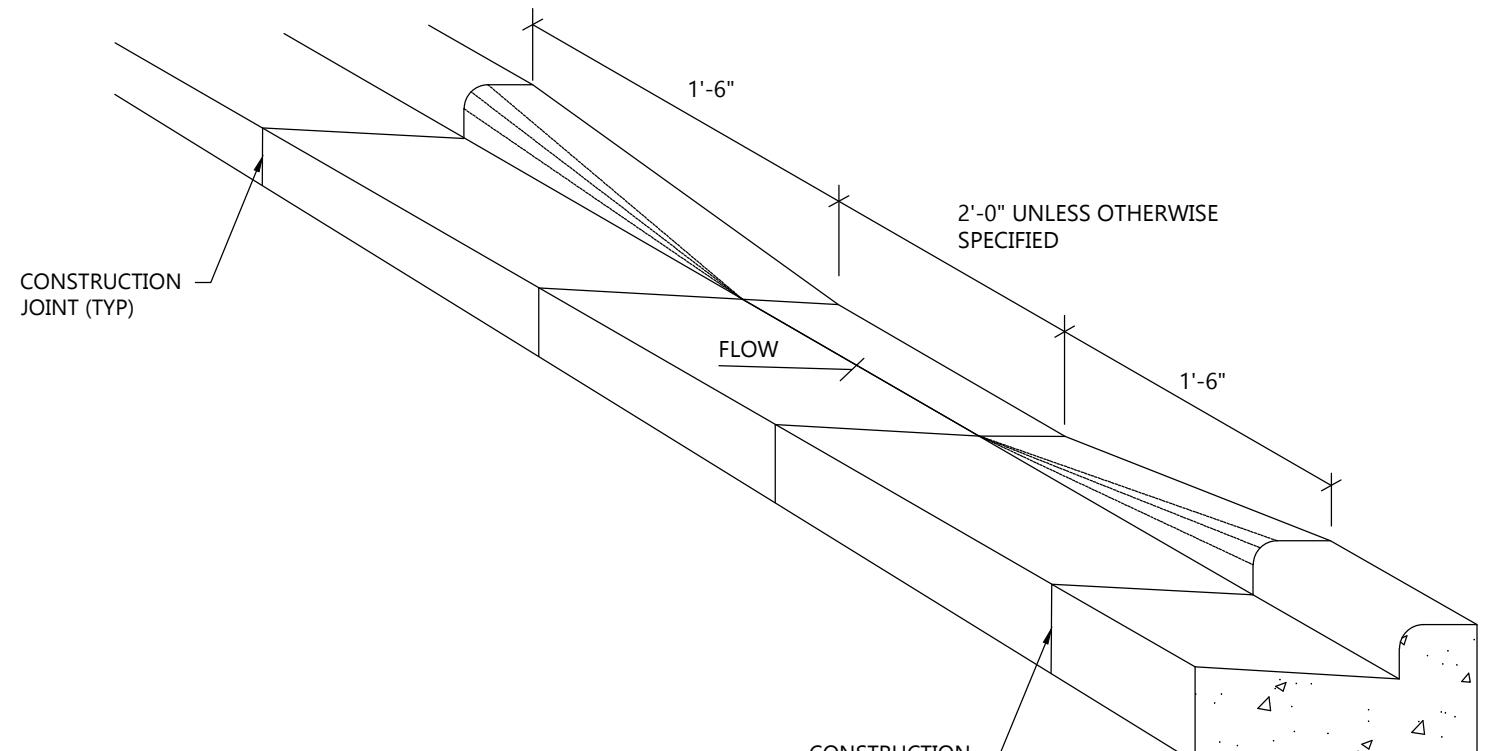
# CIVIL LANDSCAPE AND RESTORATION PLAN

**PROJECT INFORMATION**


**PROPOSED COFFEE SHOP FOR:  
7-BREW MADISON**  
3915 LIEN RD. • MADISON, WI 53704

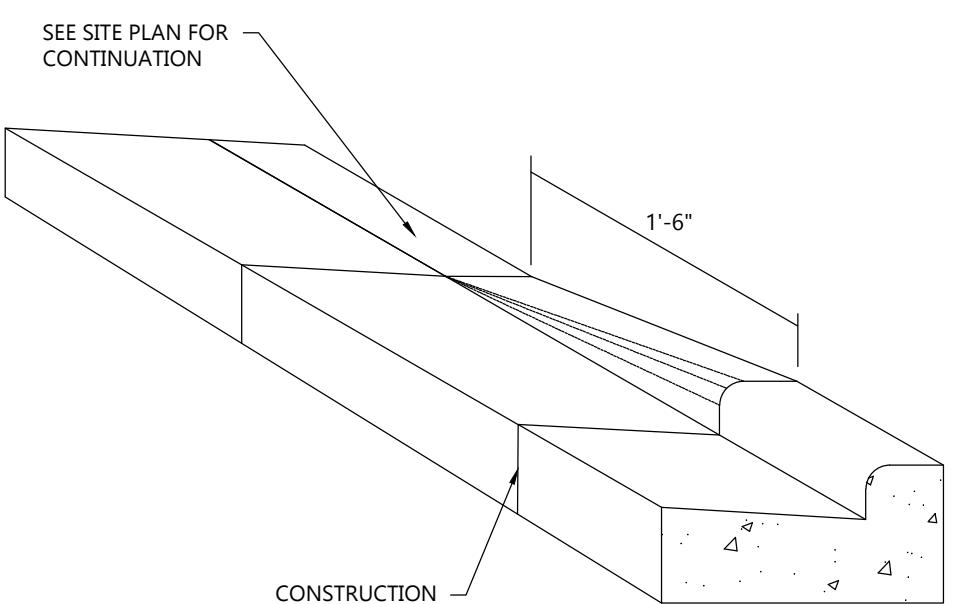


**CURB TAPER DETAIL**  
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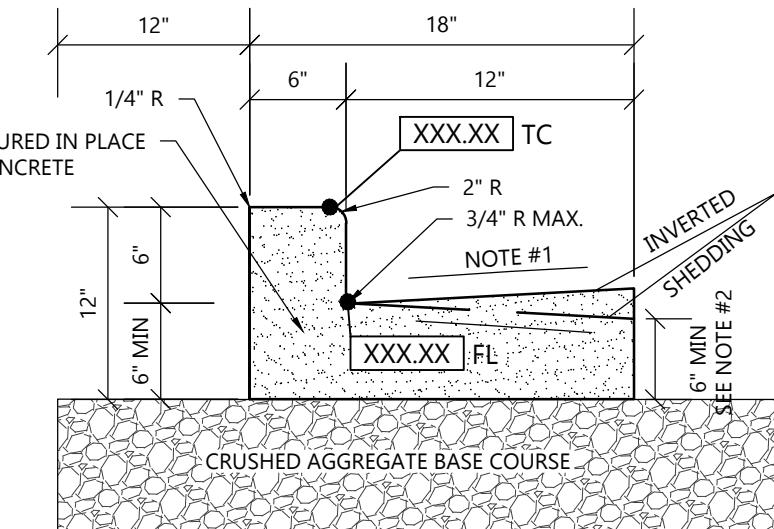
**CURB CUT DETAIL**  
NOT TO SCALE




**FLUSH WALK DETAIL**  
NOT TO SCALE

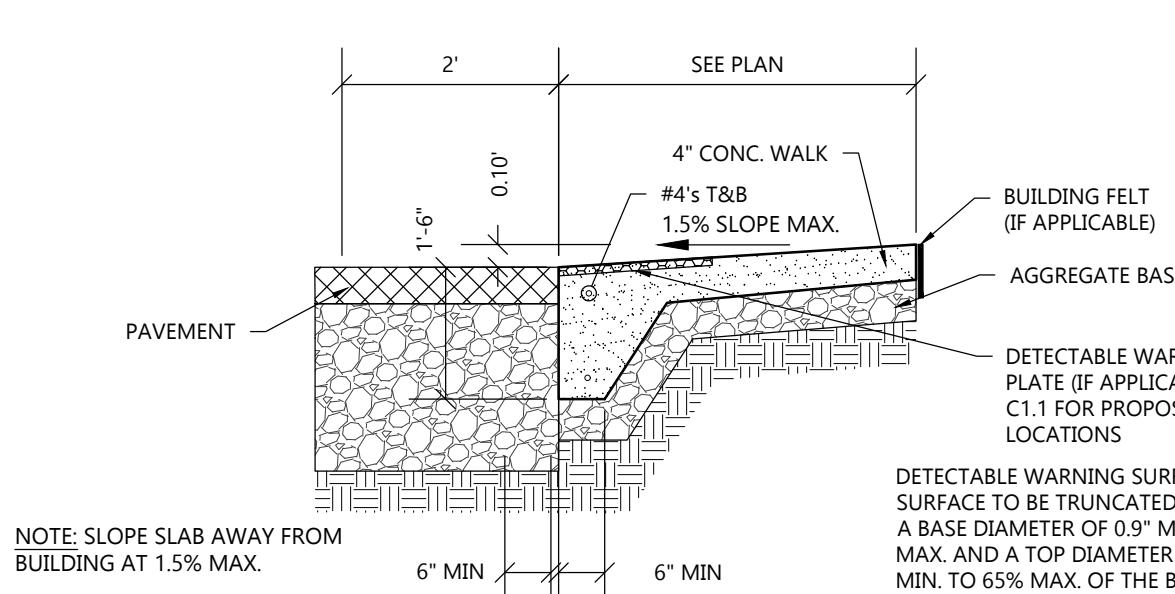


**RAISED WALK DETAIL**  
NOT TO SCALE

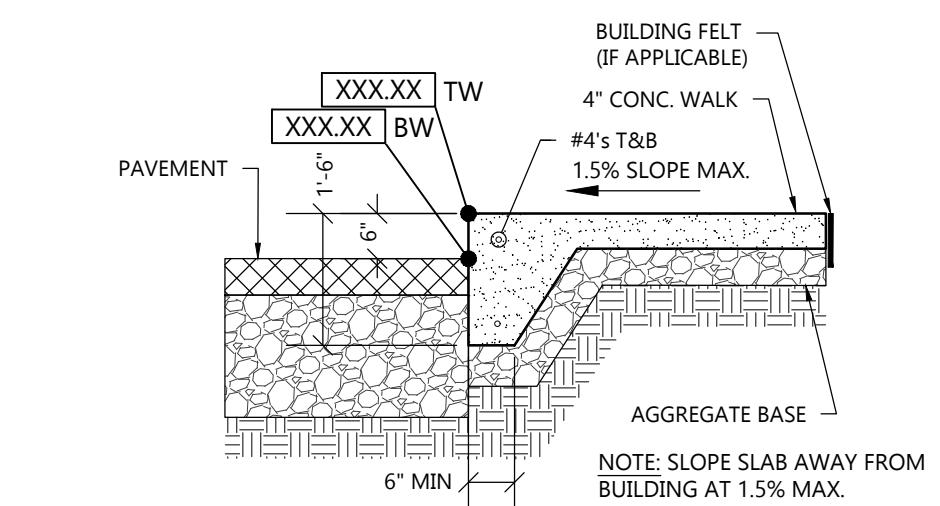


**18" CONCRETE CURB & GUTTER DETAIL**  
NOT TO SCALE

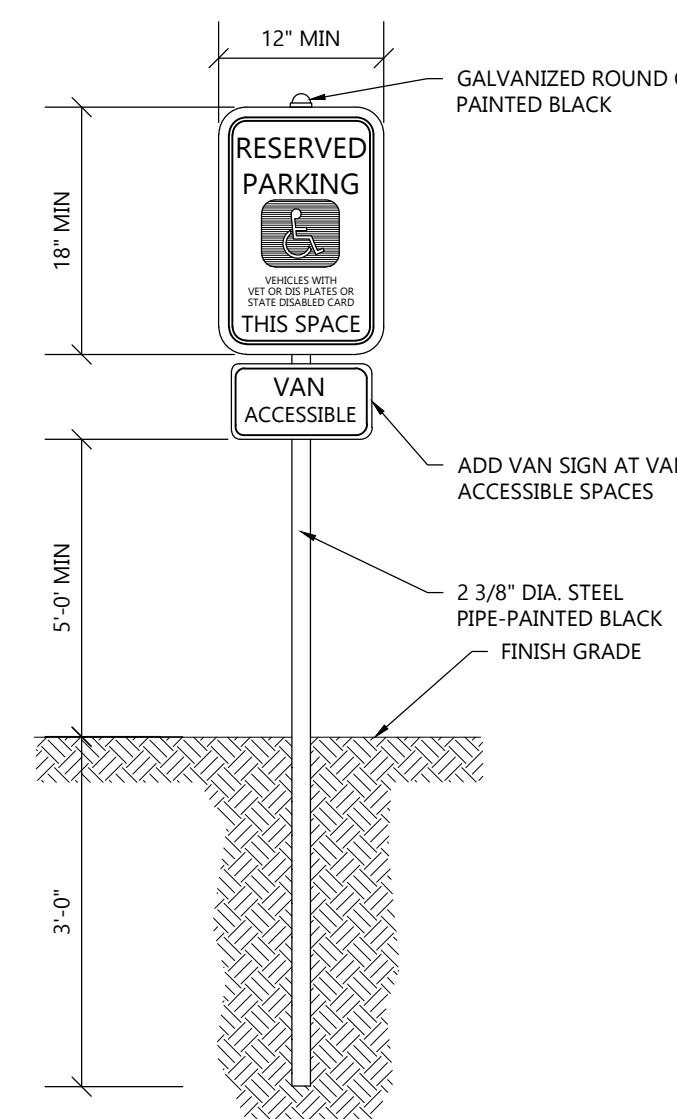


**HANDICAP SIGNAGE WITHOUT CONCRETE BASE DETAIL**  
NOT TO SCALE

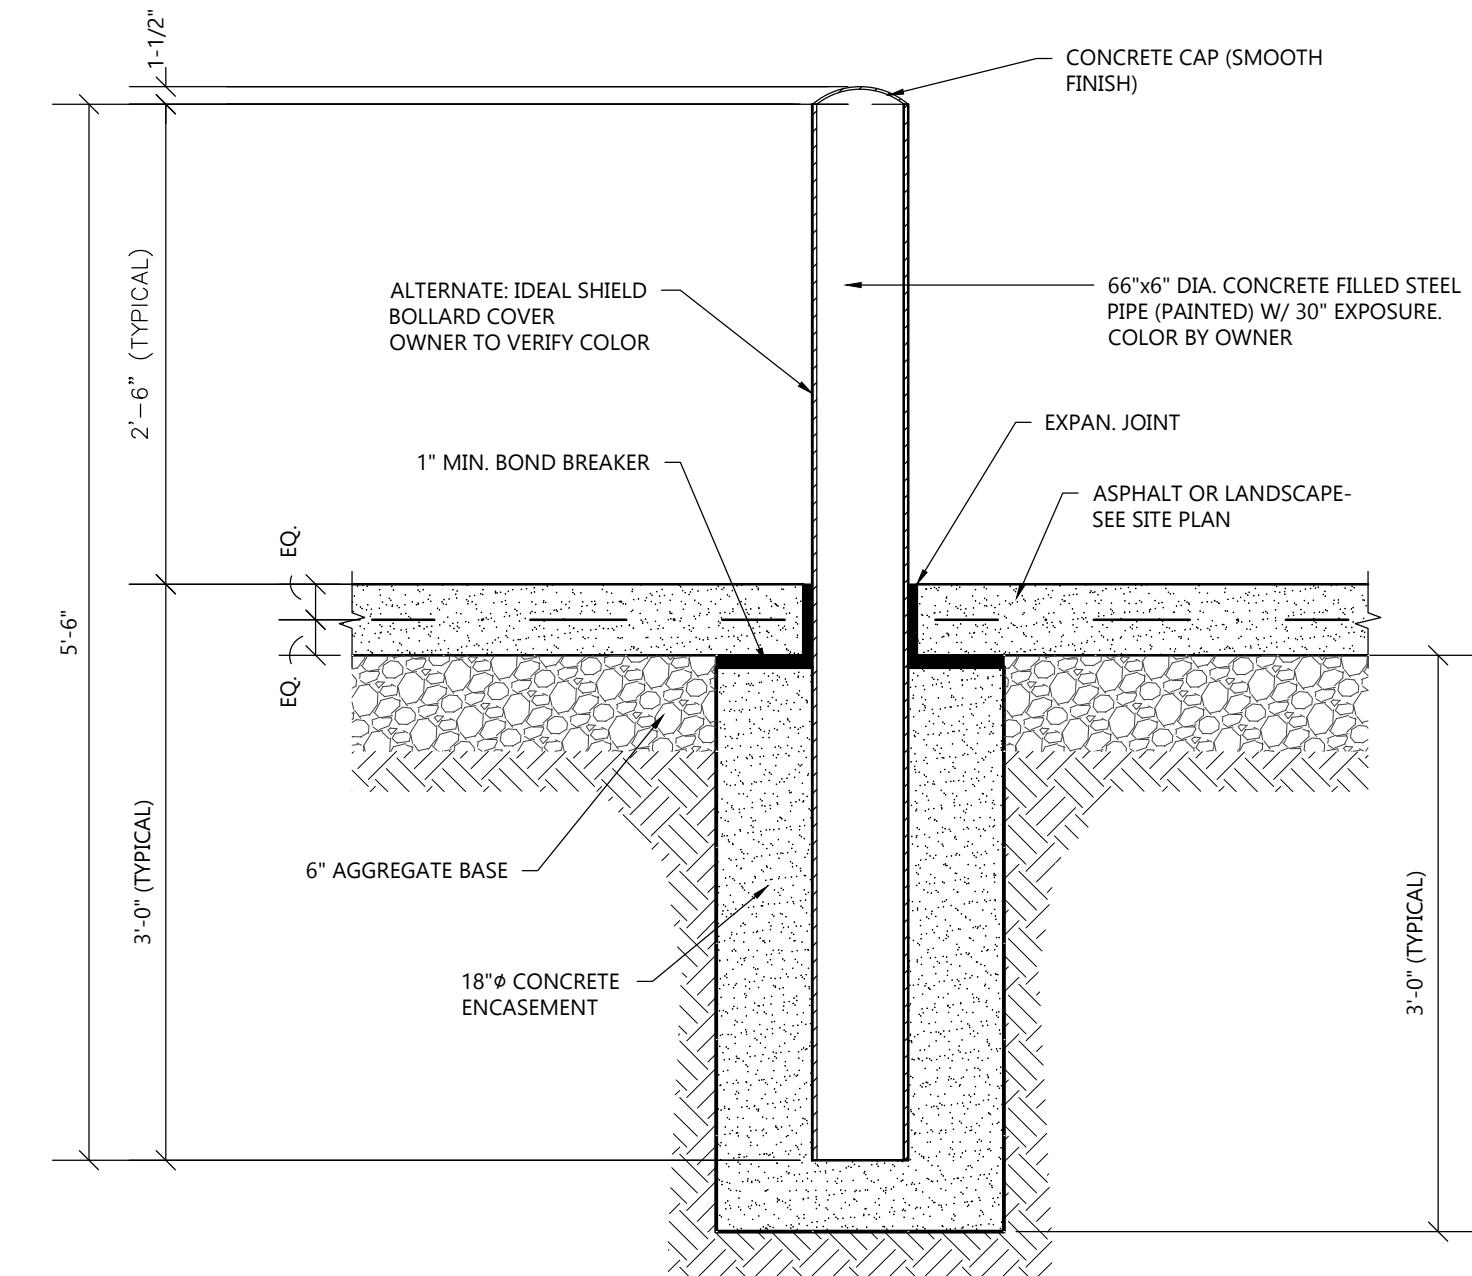


**6" PIPE BOLLARD DETAIL**

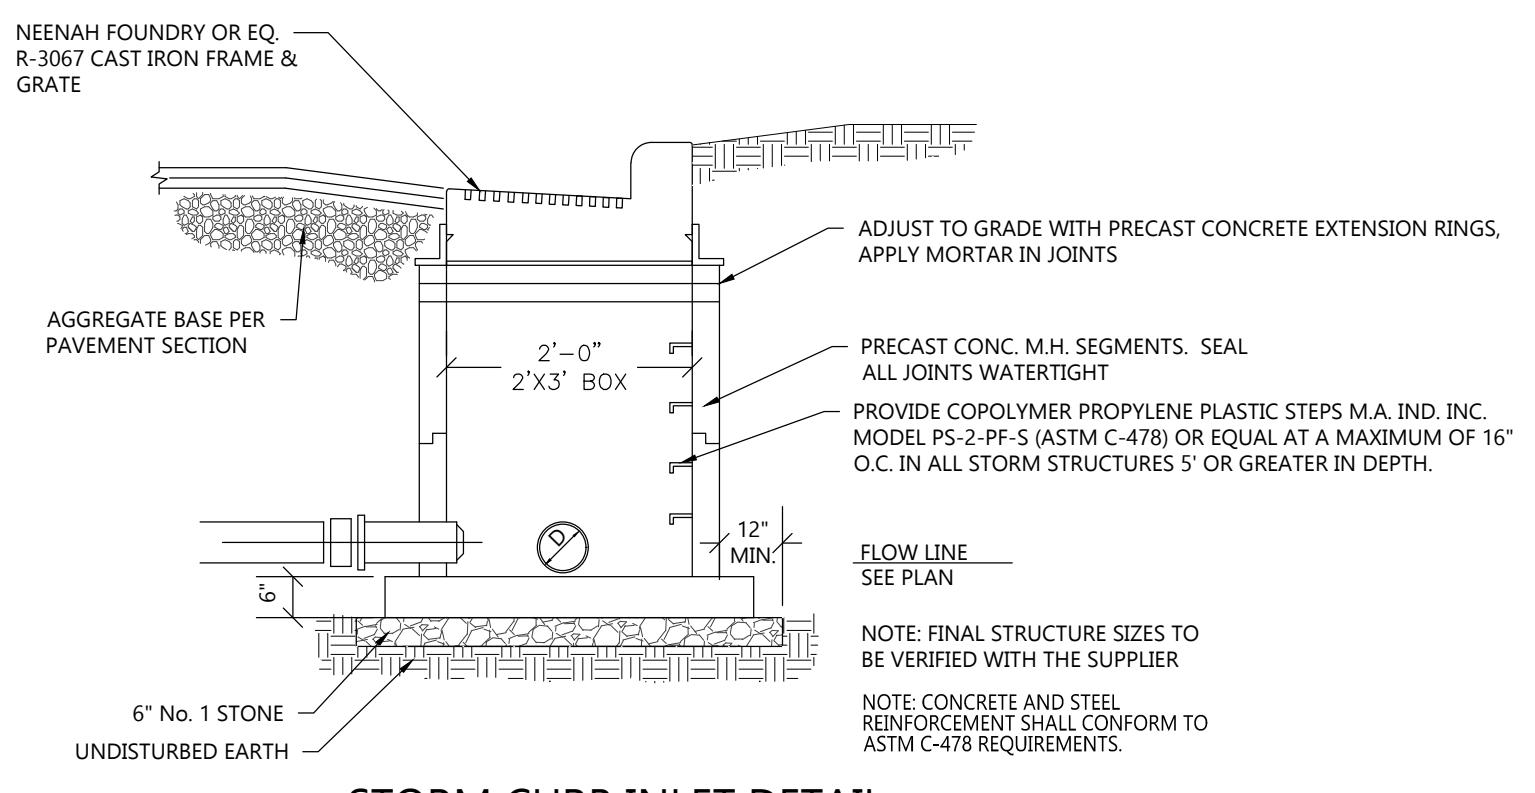


**STORM CURB INLET DETAIL**  
NOT TO SCALE

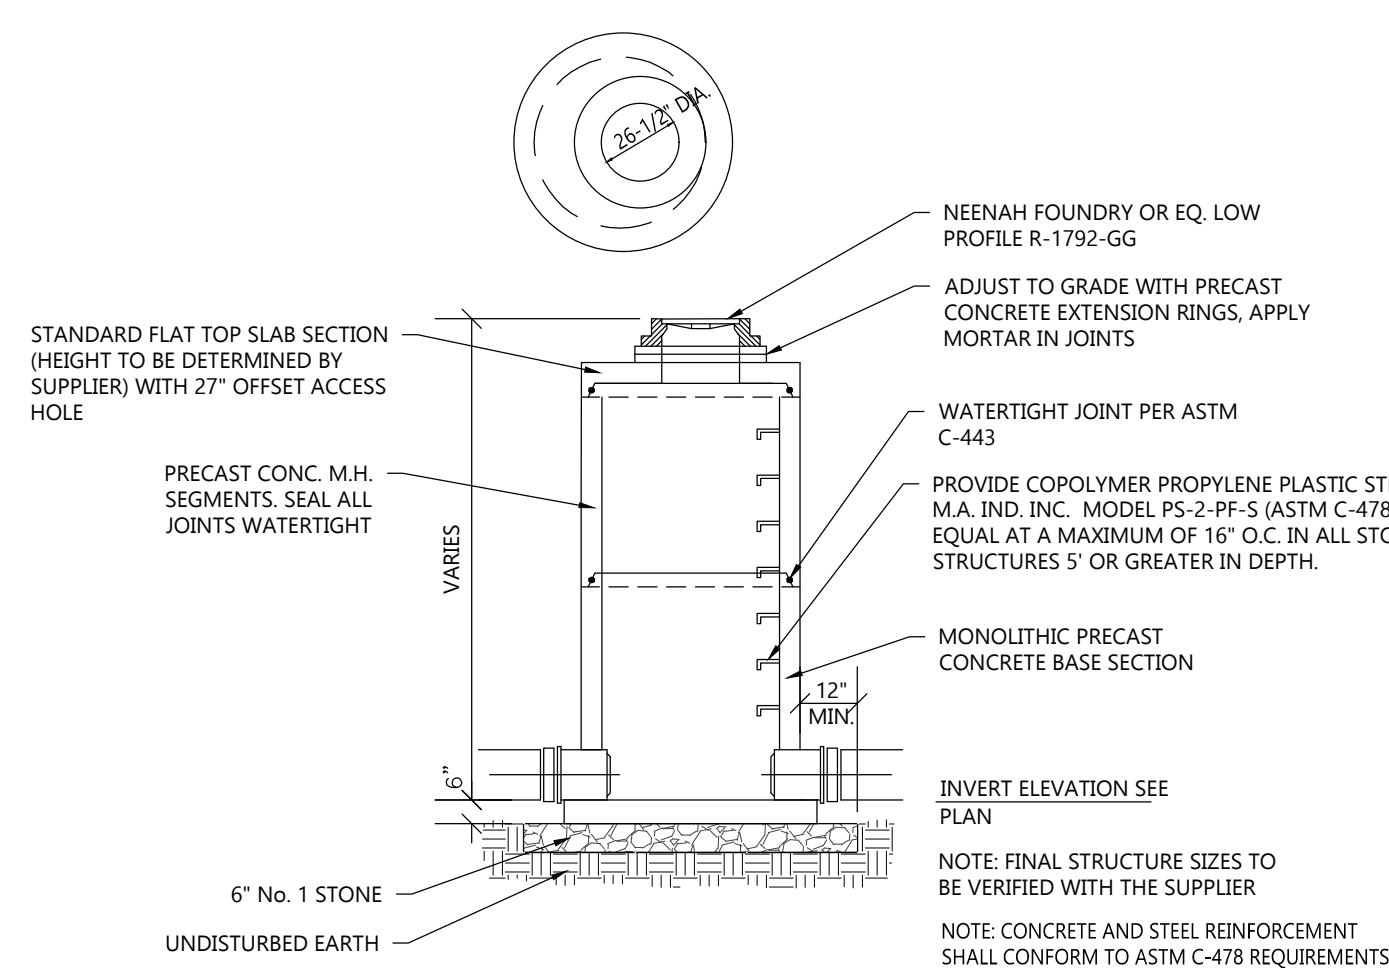


**STORM CATCH BASIN DETAIL**  
NOT TO SCALE

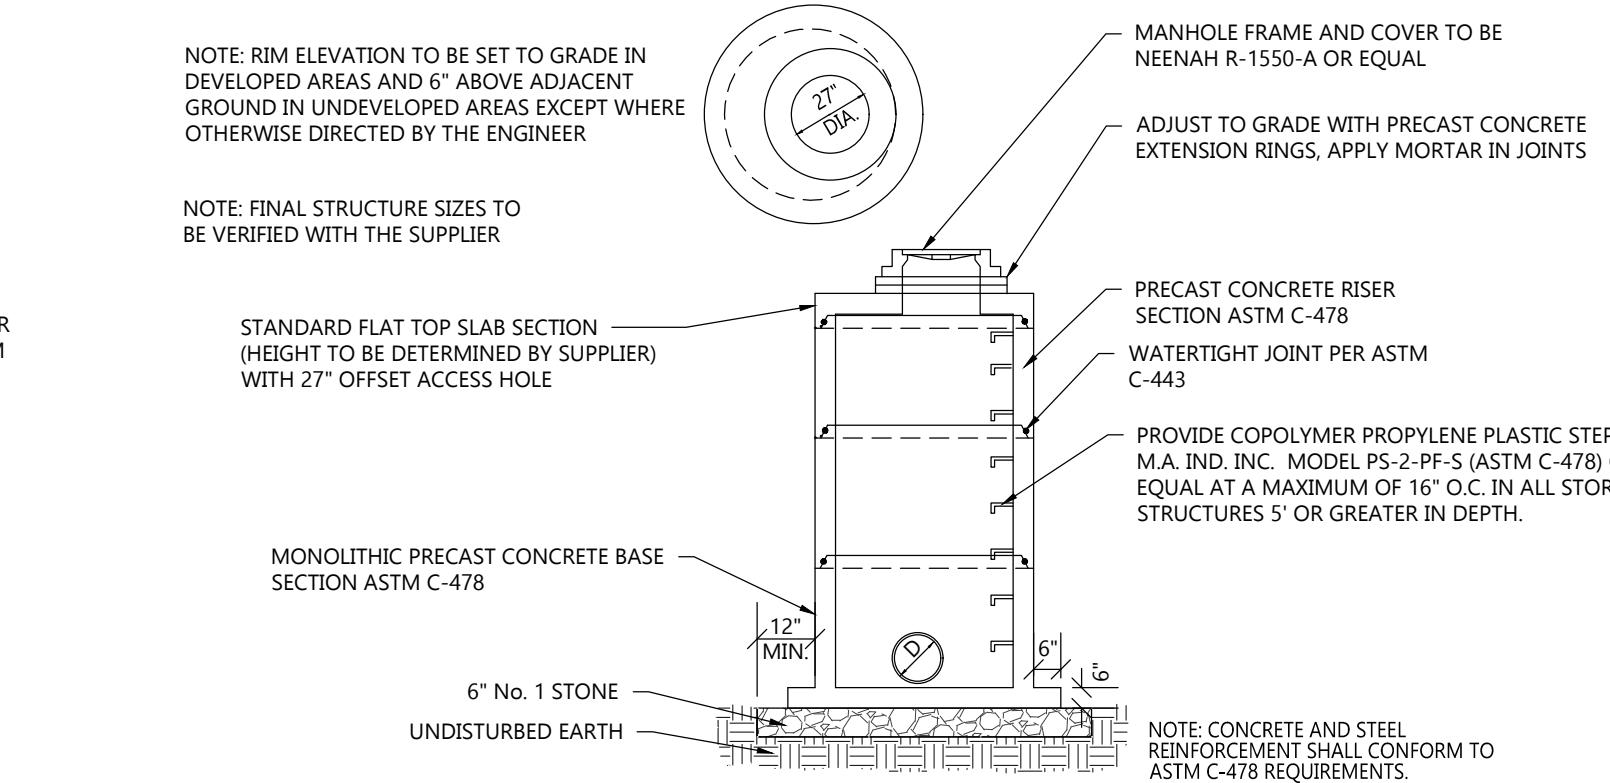


**STORM MANHOLE DETAIL**  
NOT TO SCALE

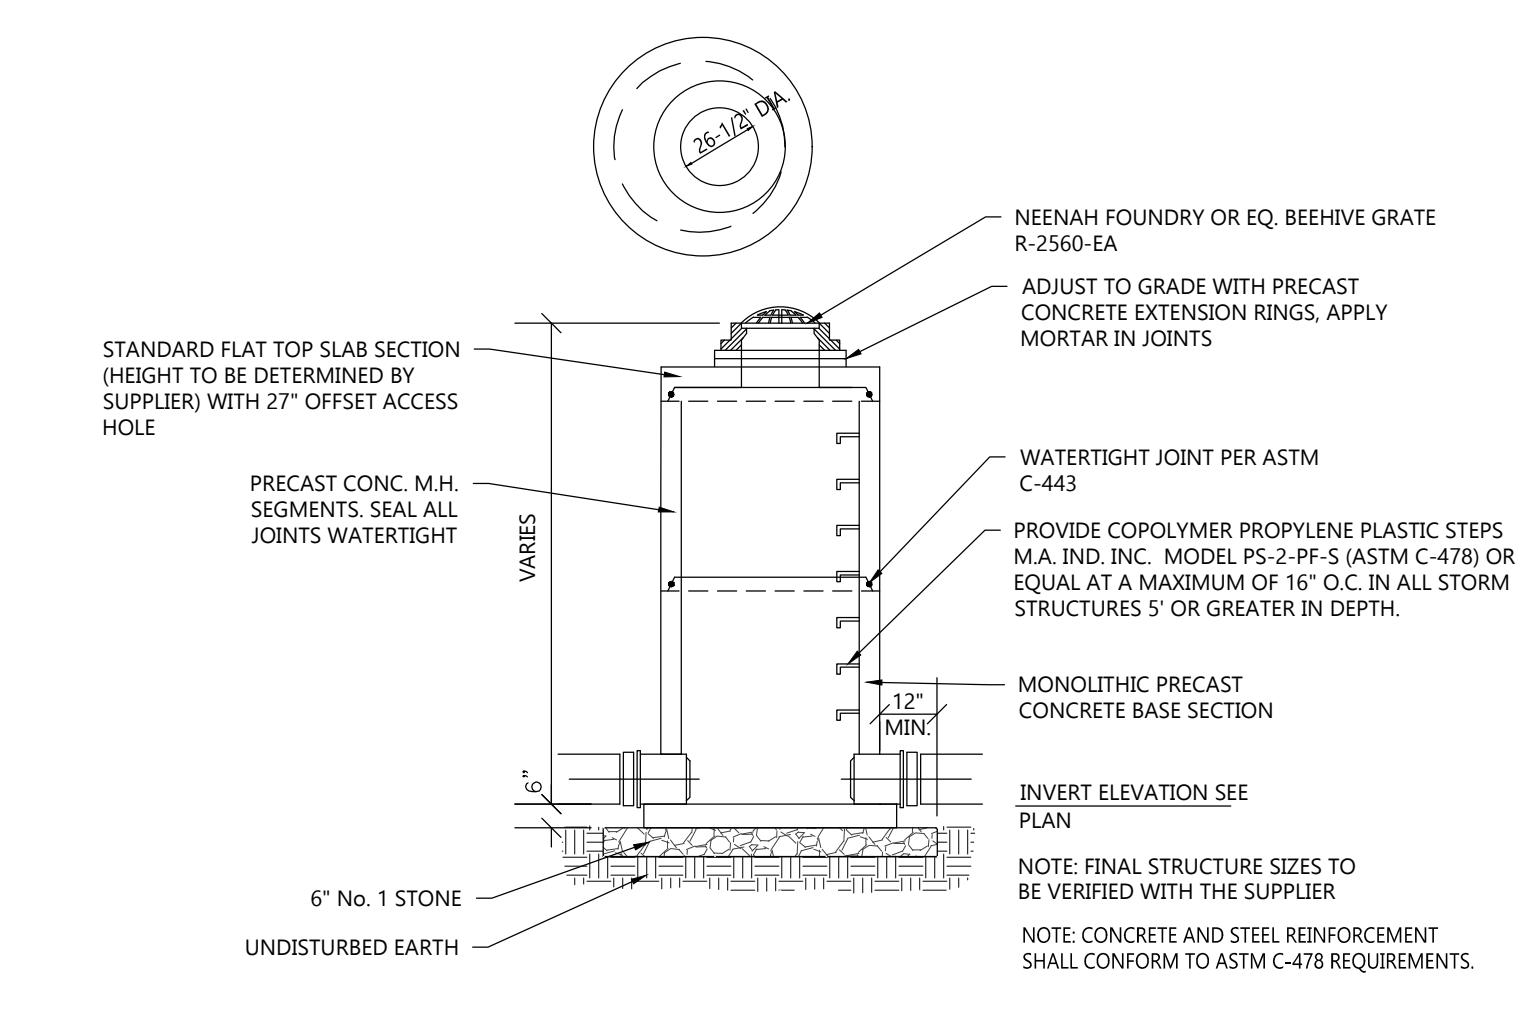

**STORM FIELD INLET W/  
DOME GRATE DETAIL**  
NOT TO SCALE

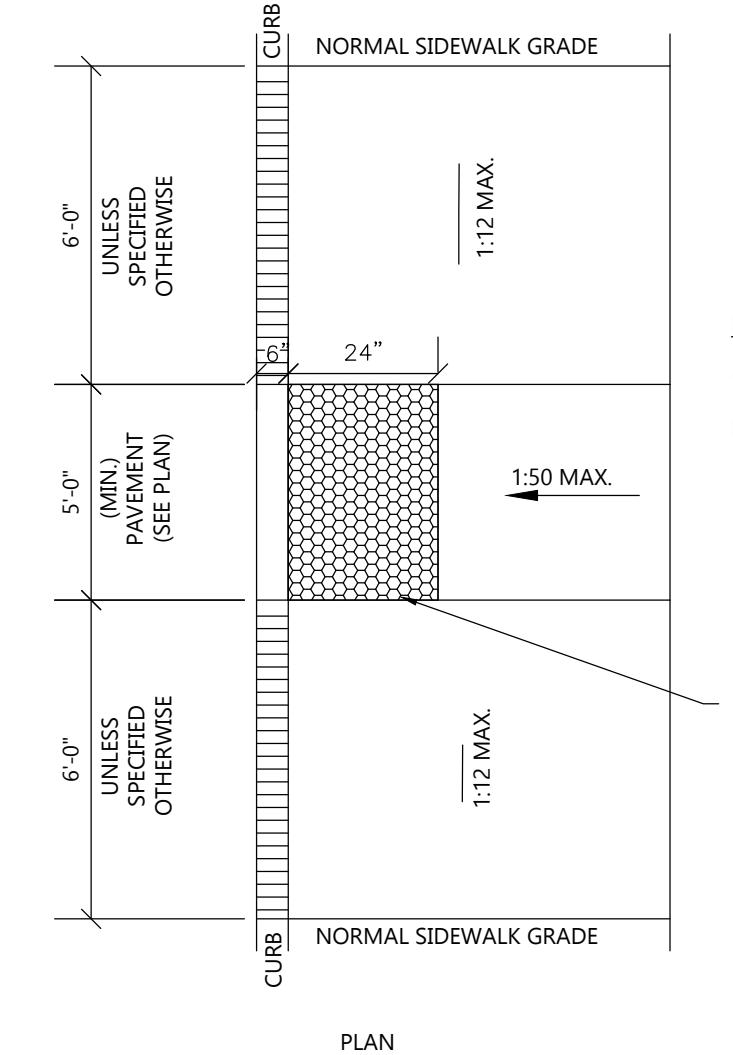

**ADA SIDEWALK RAMP DETAIL**  
NOT TO SCALE

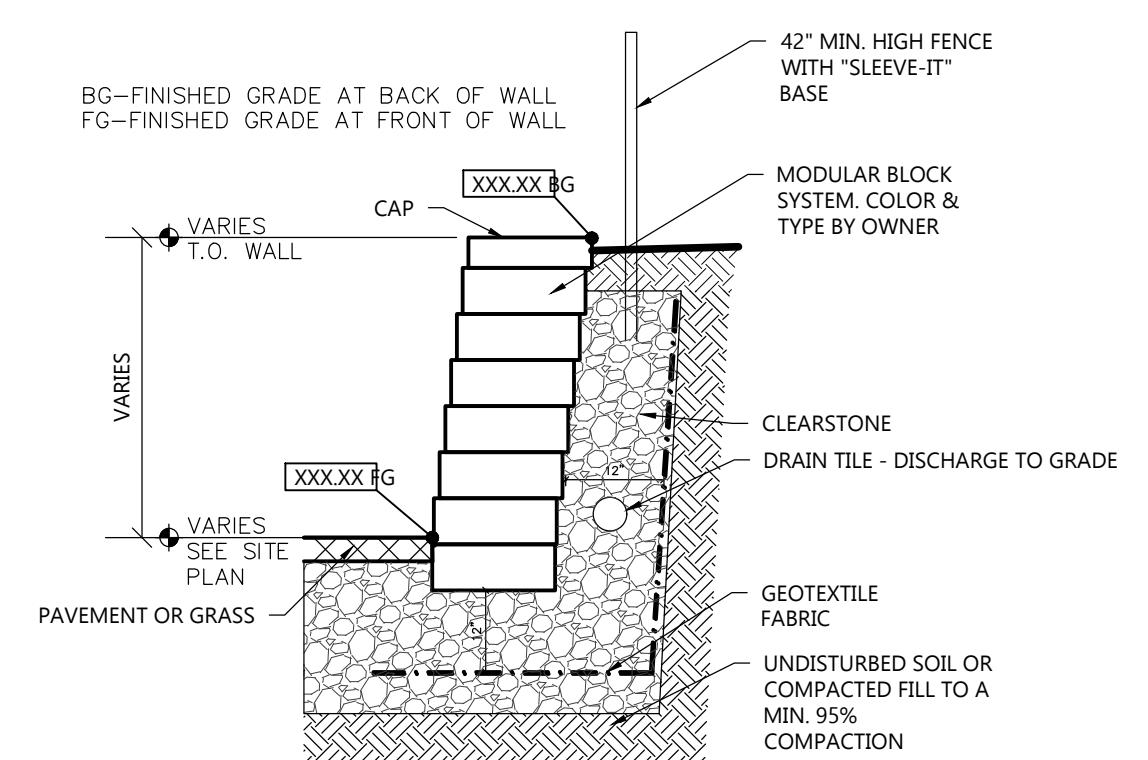

**RETAINING WALL DETAIL**  
NOT TO SCALE

<b>PRELIMINARY DATES</b>	
DEC. 6, 2024	
DEC. 13, 2024	


**JOB NUMBER**  
240275600

**SHEET NUMBER**

**C2.0**

**PROJECT INFORMATION**



**PROPOSED COFFEE SHOP FOR:  
7-BREW MADISON**  
3915 LIEN RD. • MADISON, WI 53704

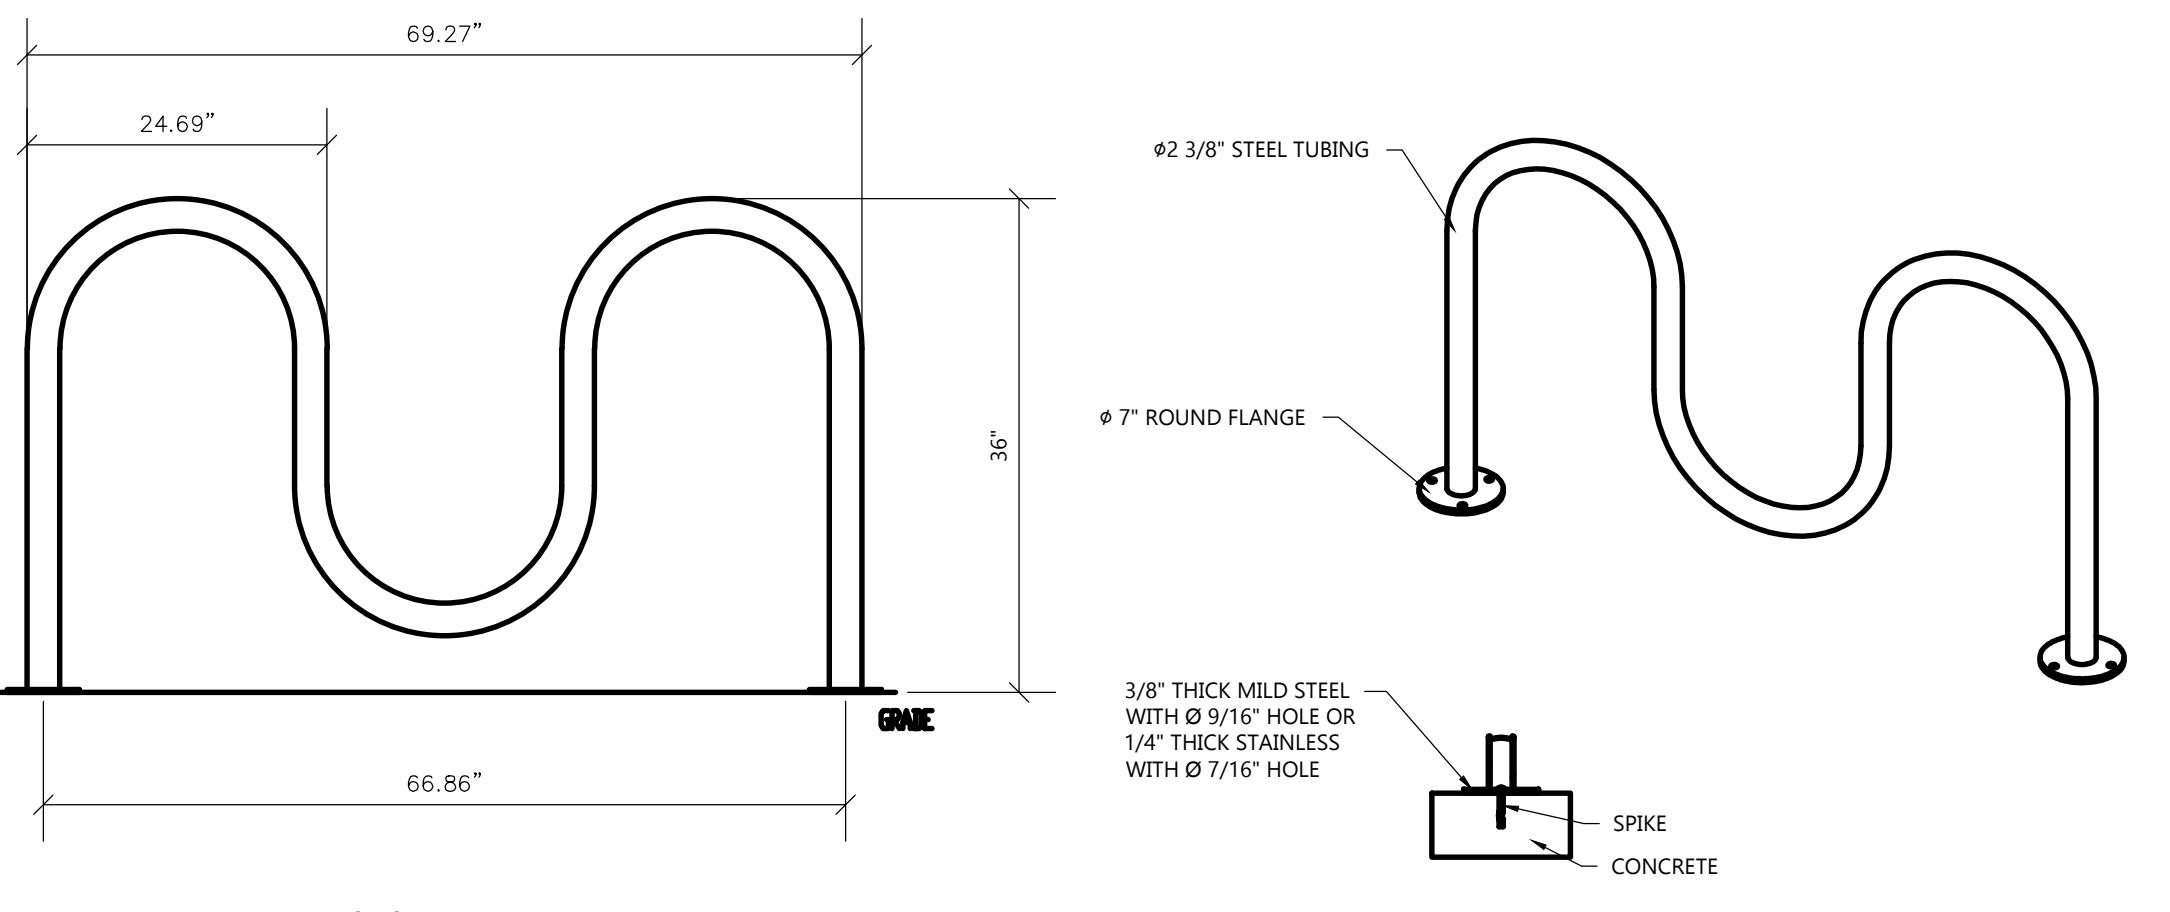

NOTES:  
1. INSTALL BIKE RACKS ACCORDING TO MANUFACTURER'S SPECIFICATIONS.  
2. OWNER SHALL SELECT COLOR & FINISH.  
3. SEE SITE PLAN FOR APPROX. LOCATION. COORDINATE W/ OWNER PRIOR TO CONSTRUCTION.  
4. MANUFACTURED BY MADIRAX; PRODUCT: CS200-5-IG(SF); DESCRIPTION: CAPITAL SQUARE BIKE RAKE 5 BIKE


**5 BIKE RACK DETAIL-WAVE TYPE**

NOT TO SCALE

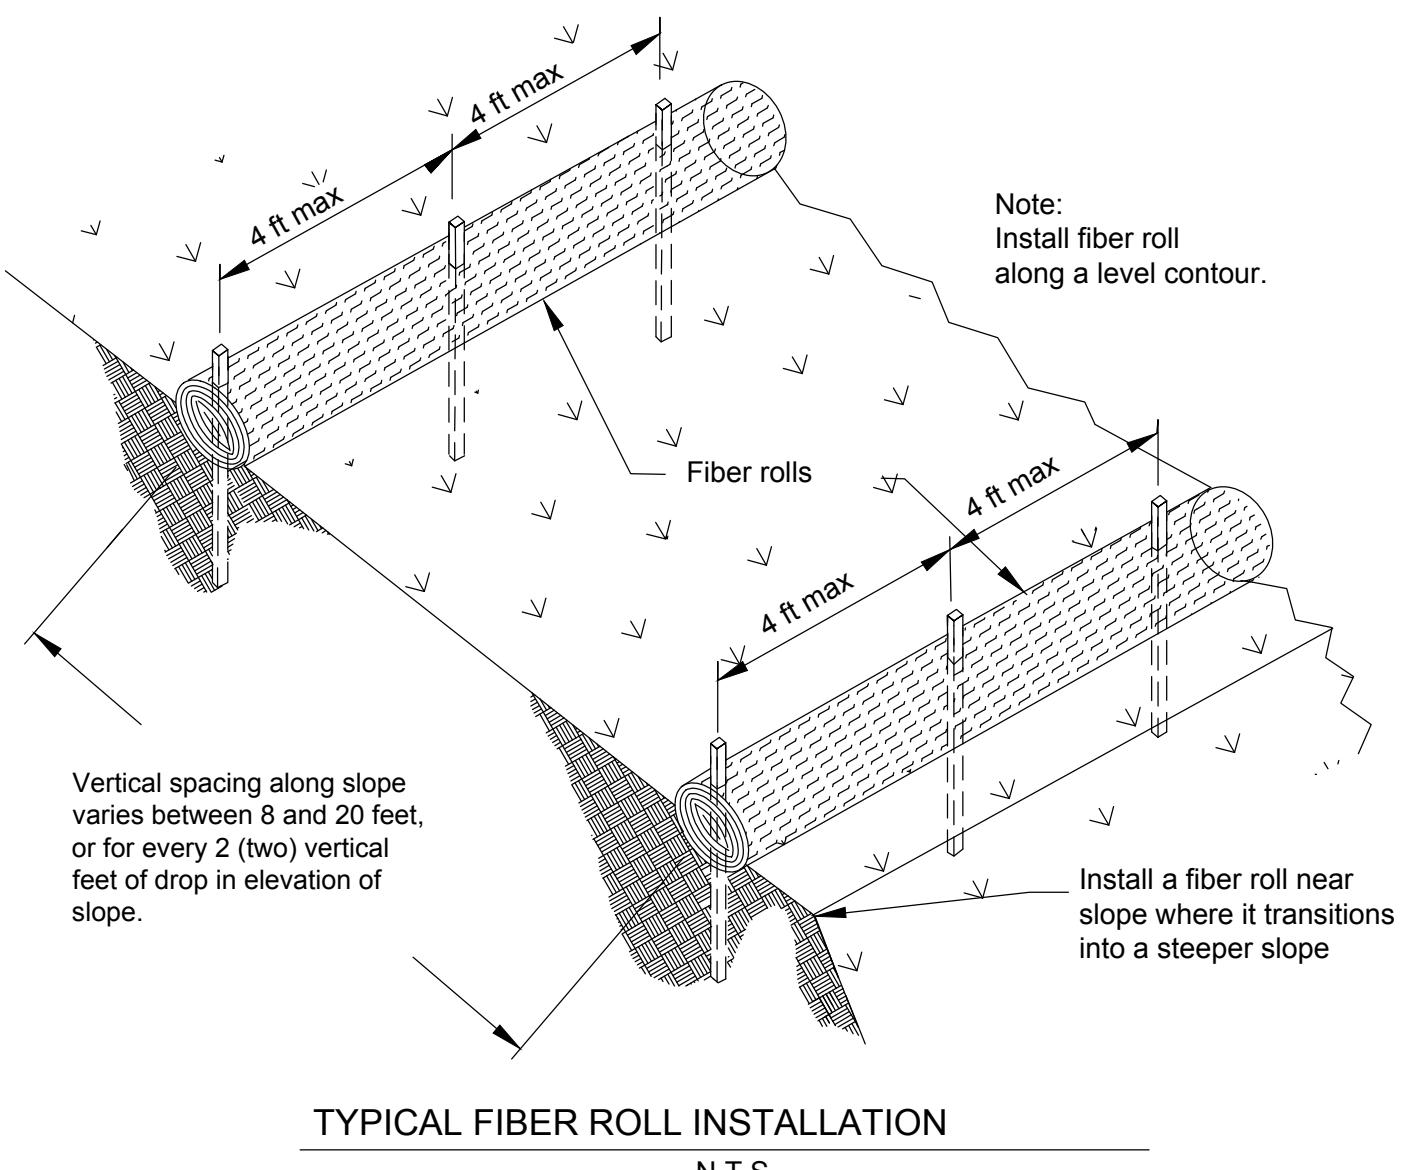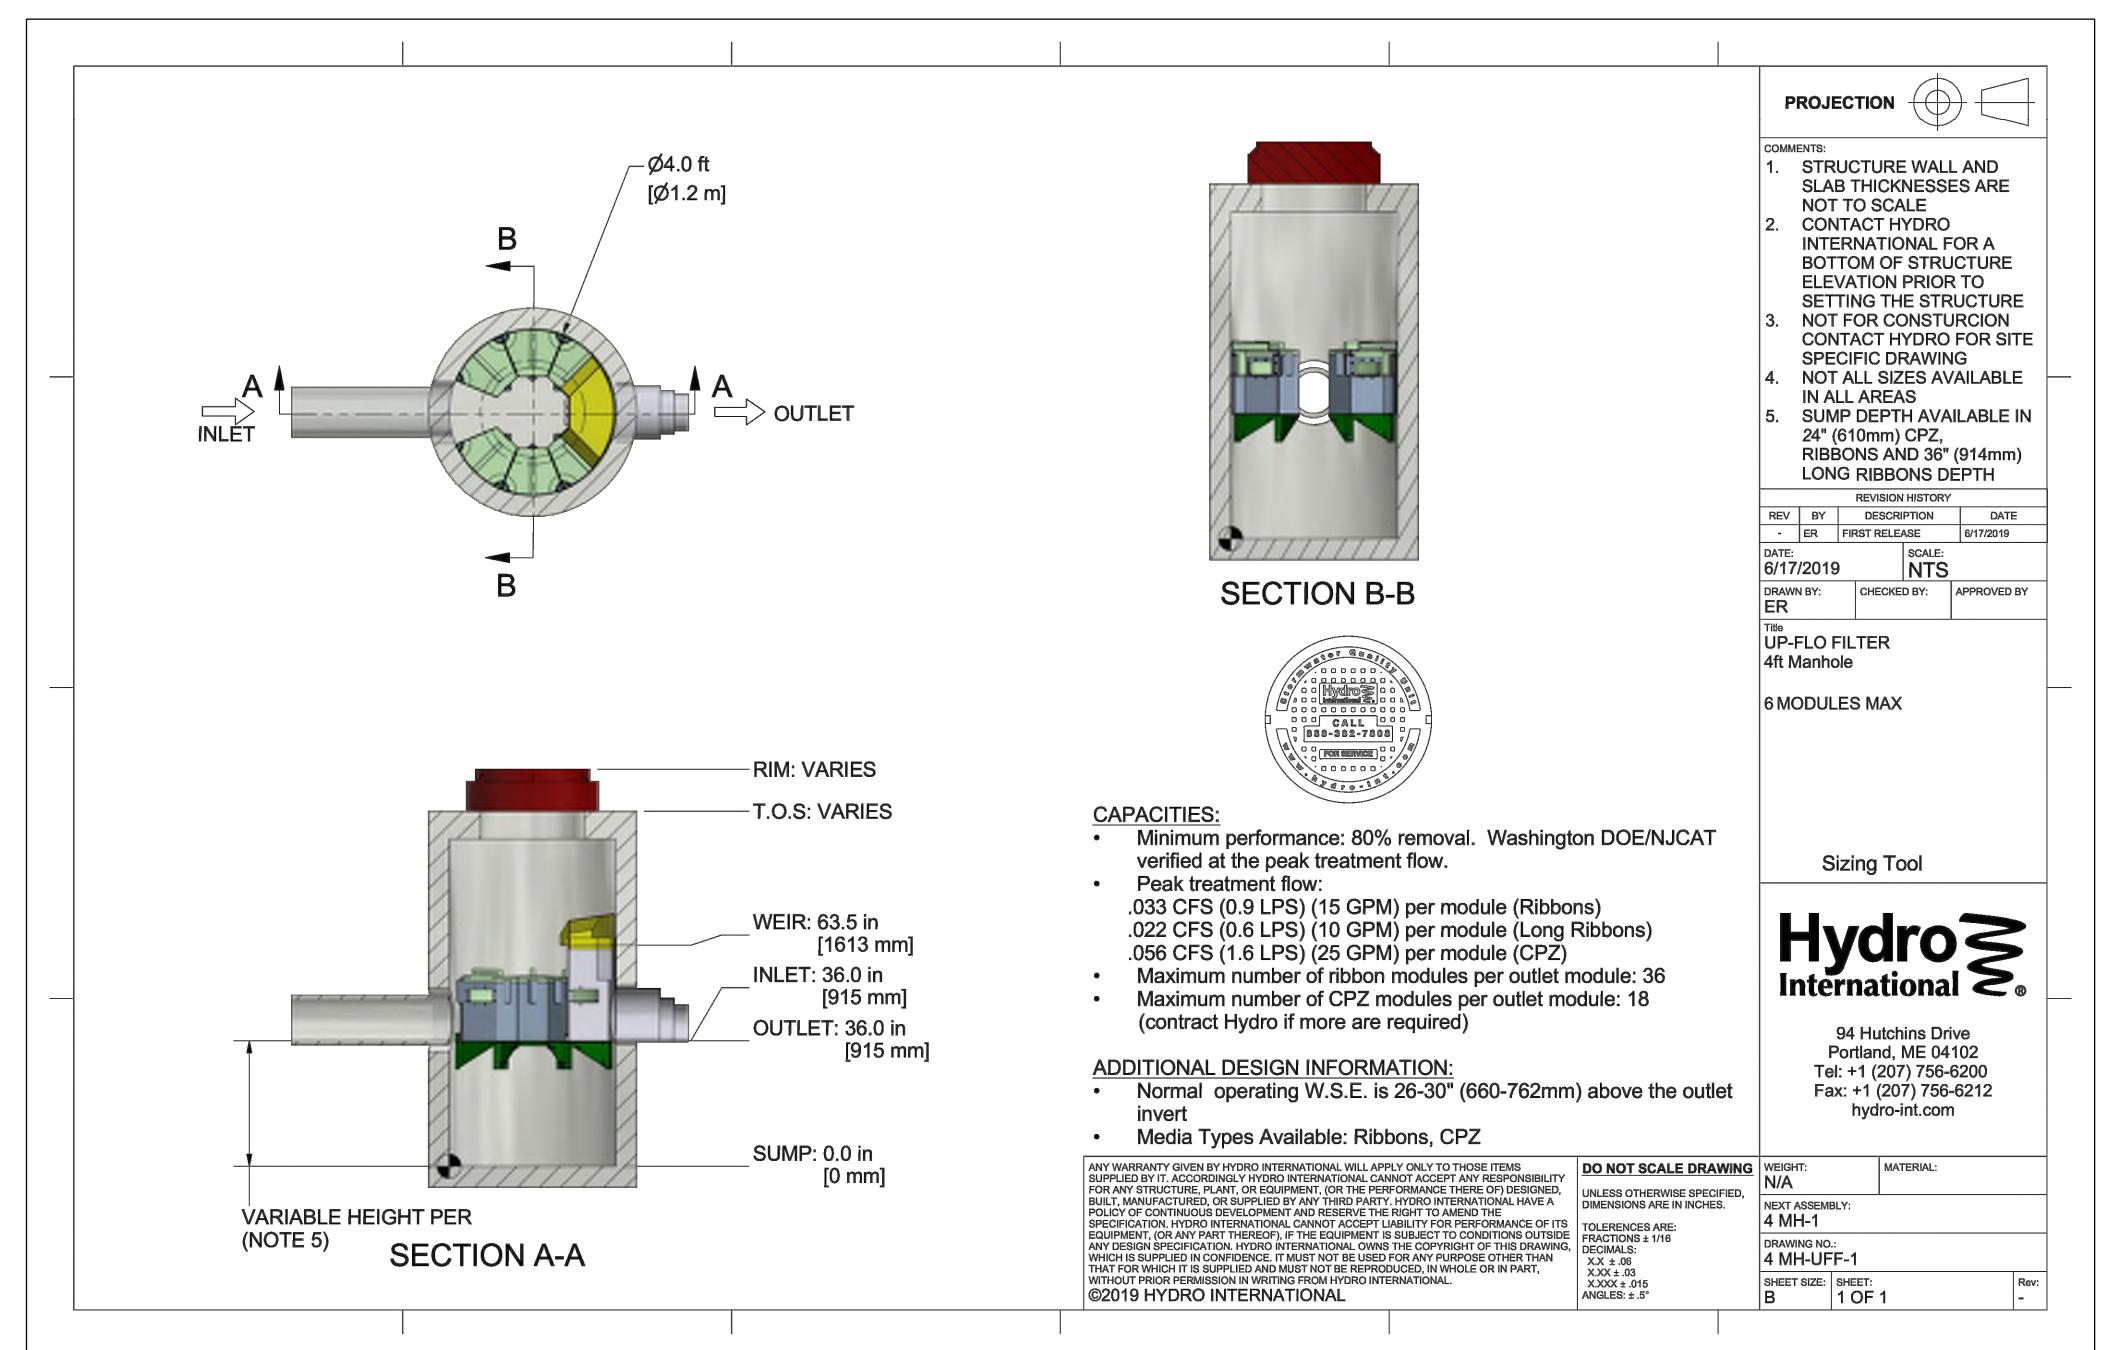


**TYPICAL FIBER ROLL INSTALLATION**

N.T.S.

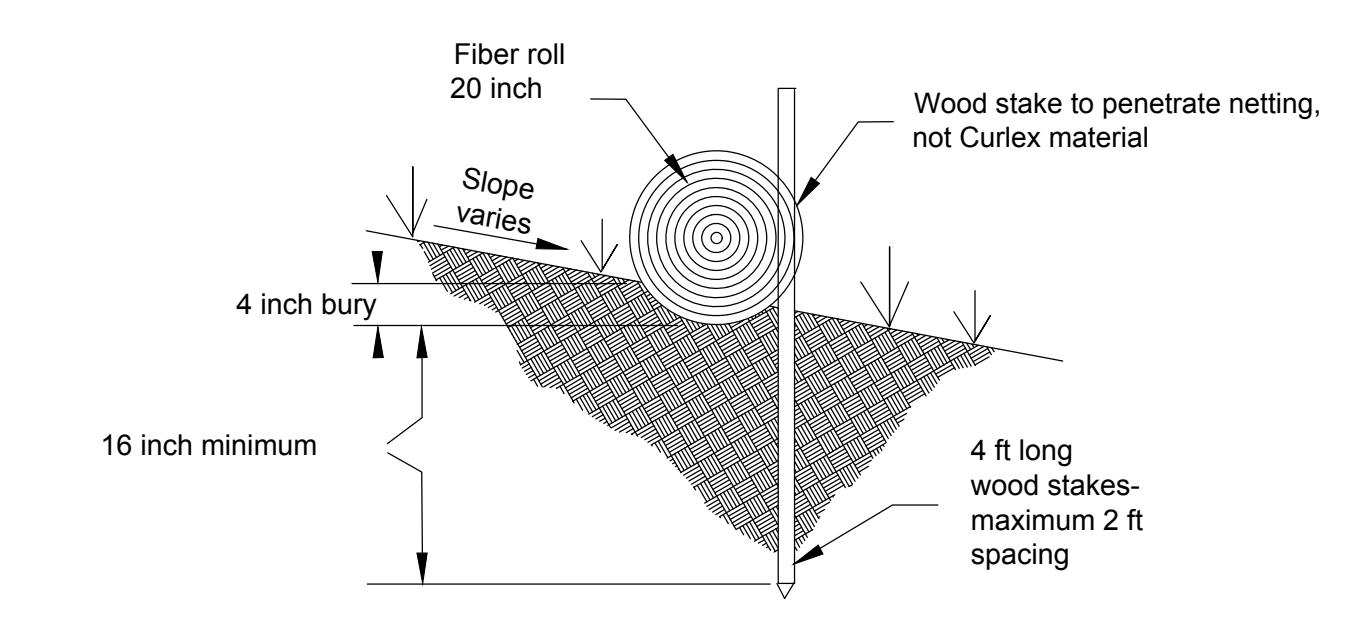


**SEDIMENT LOG INSTALLATION**

NOT TO SCALE

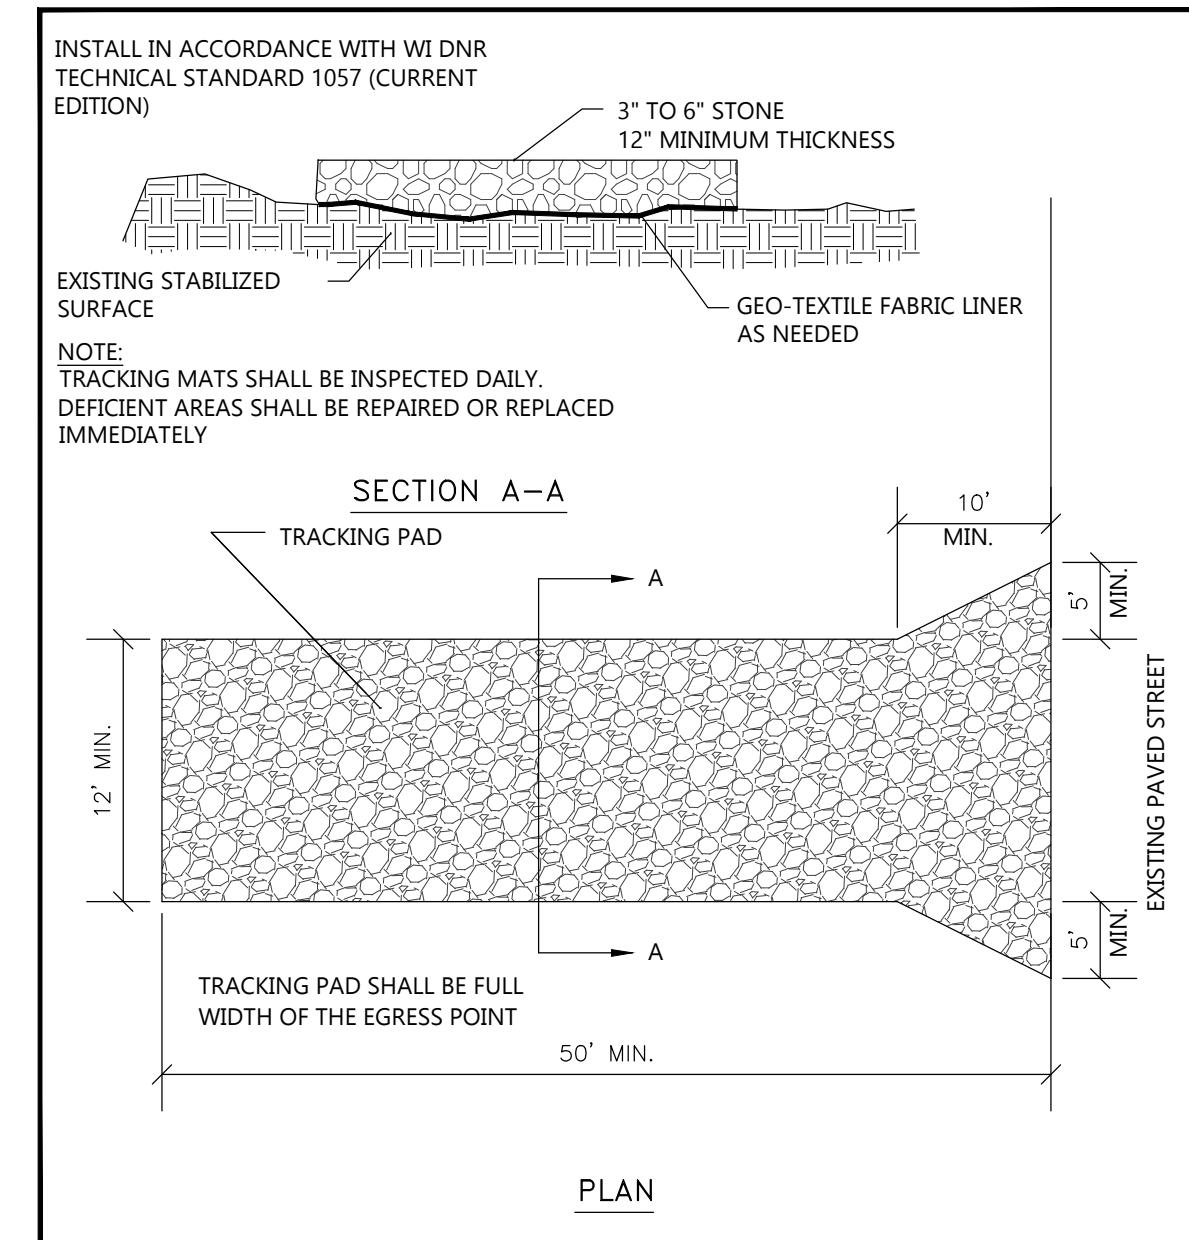


**TRACKPAD DETAILS**

NOT TO SCALE

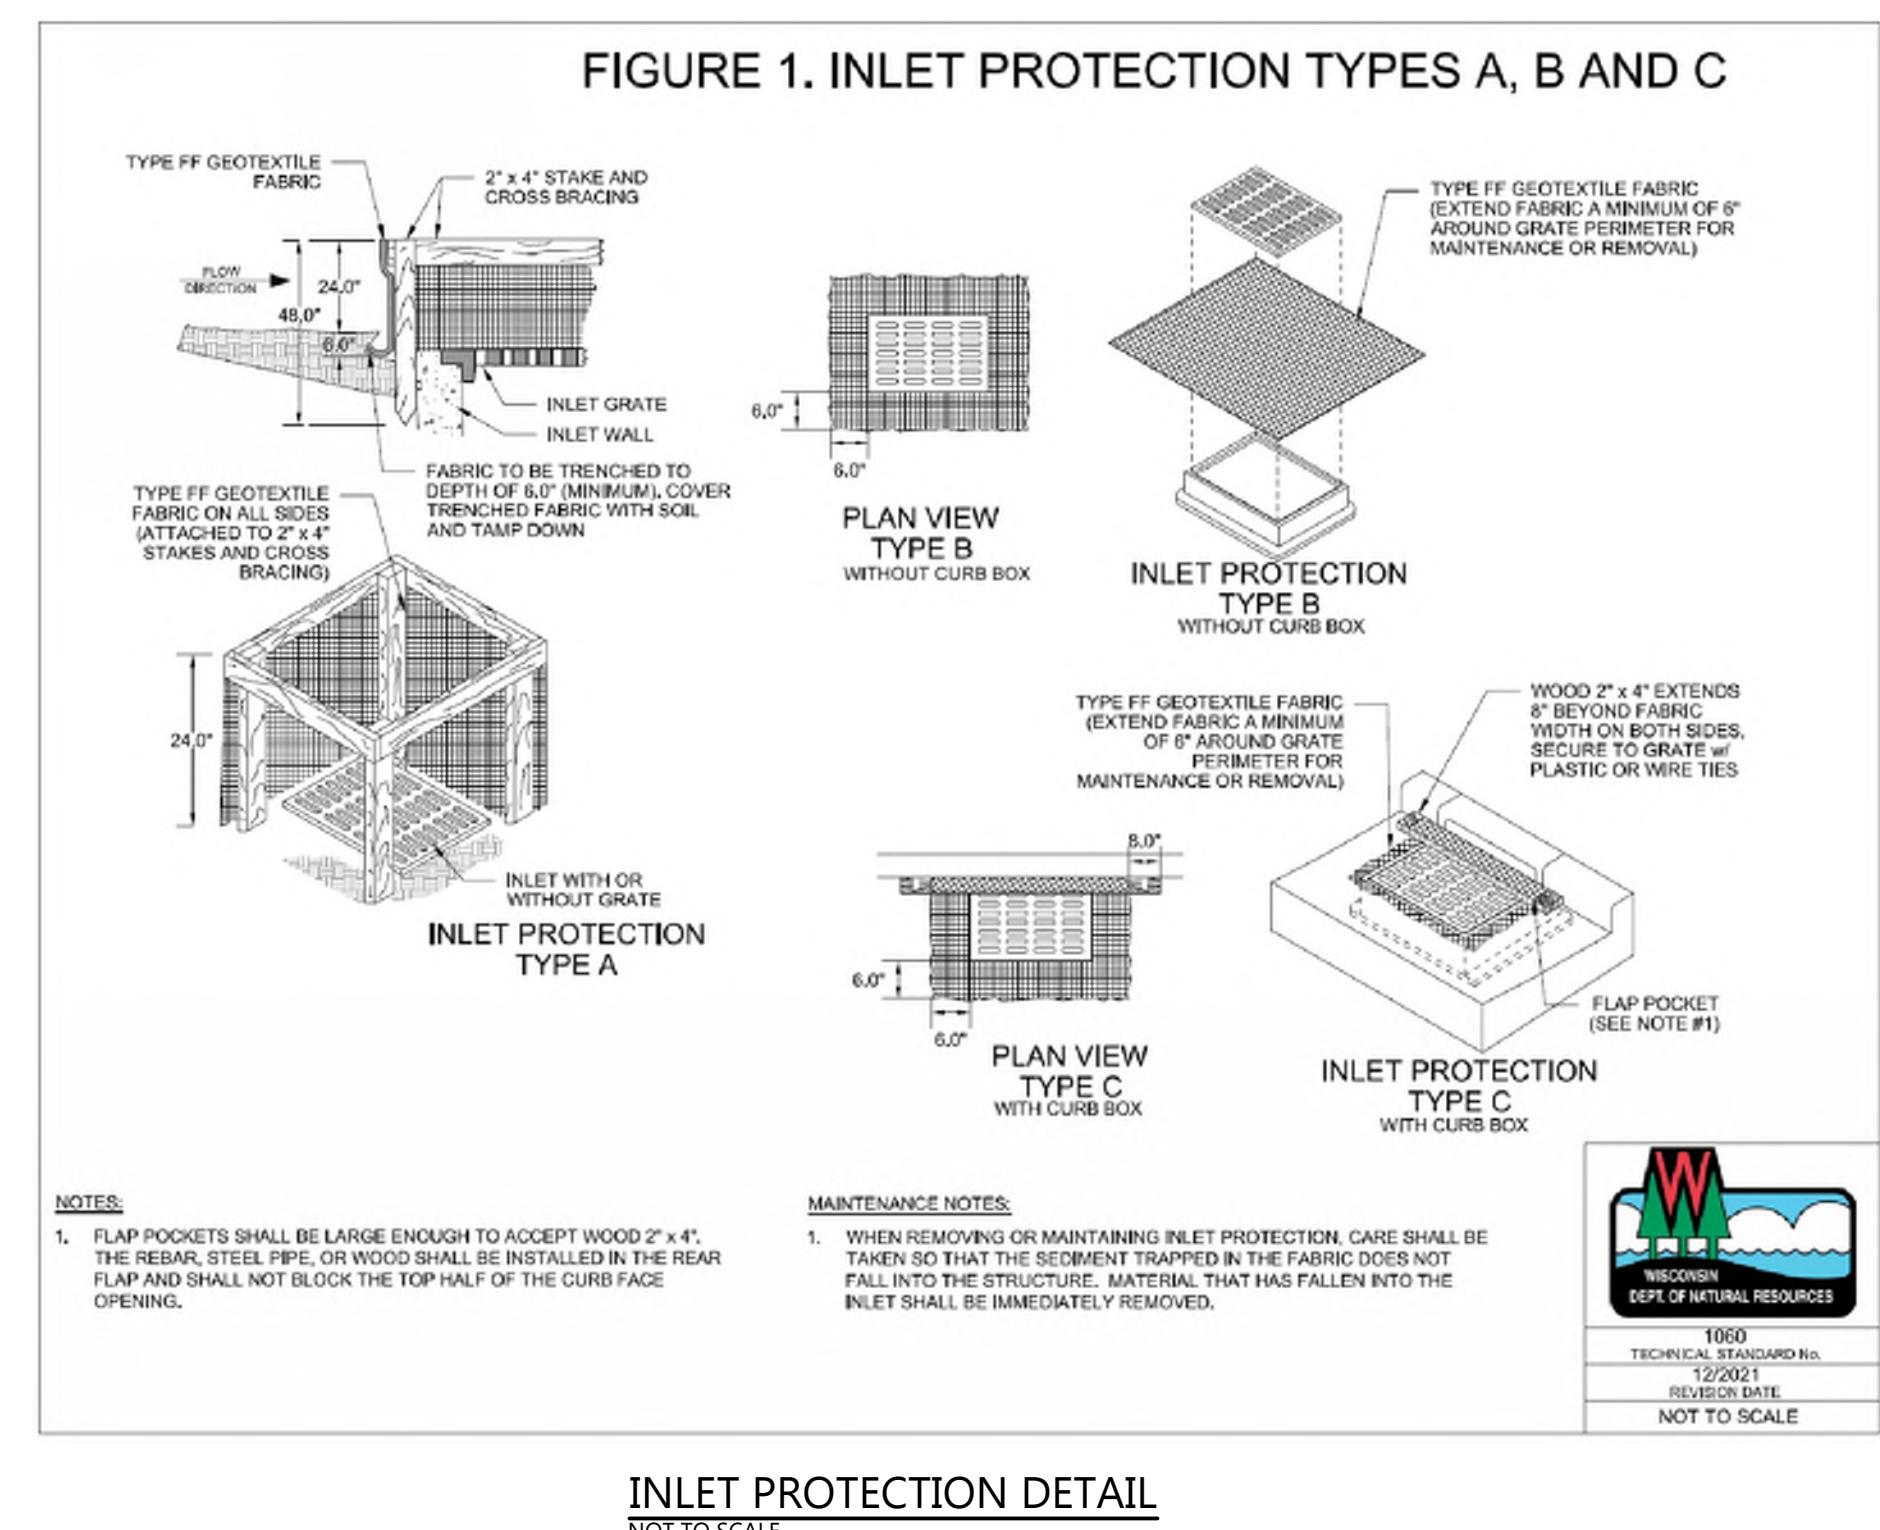

**INLET PROTECTION DETAIL**  
NOT TO SCALE

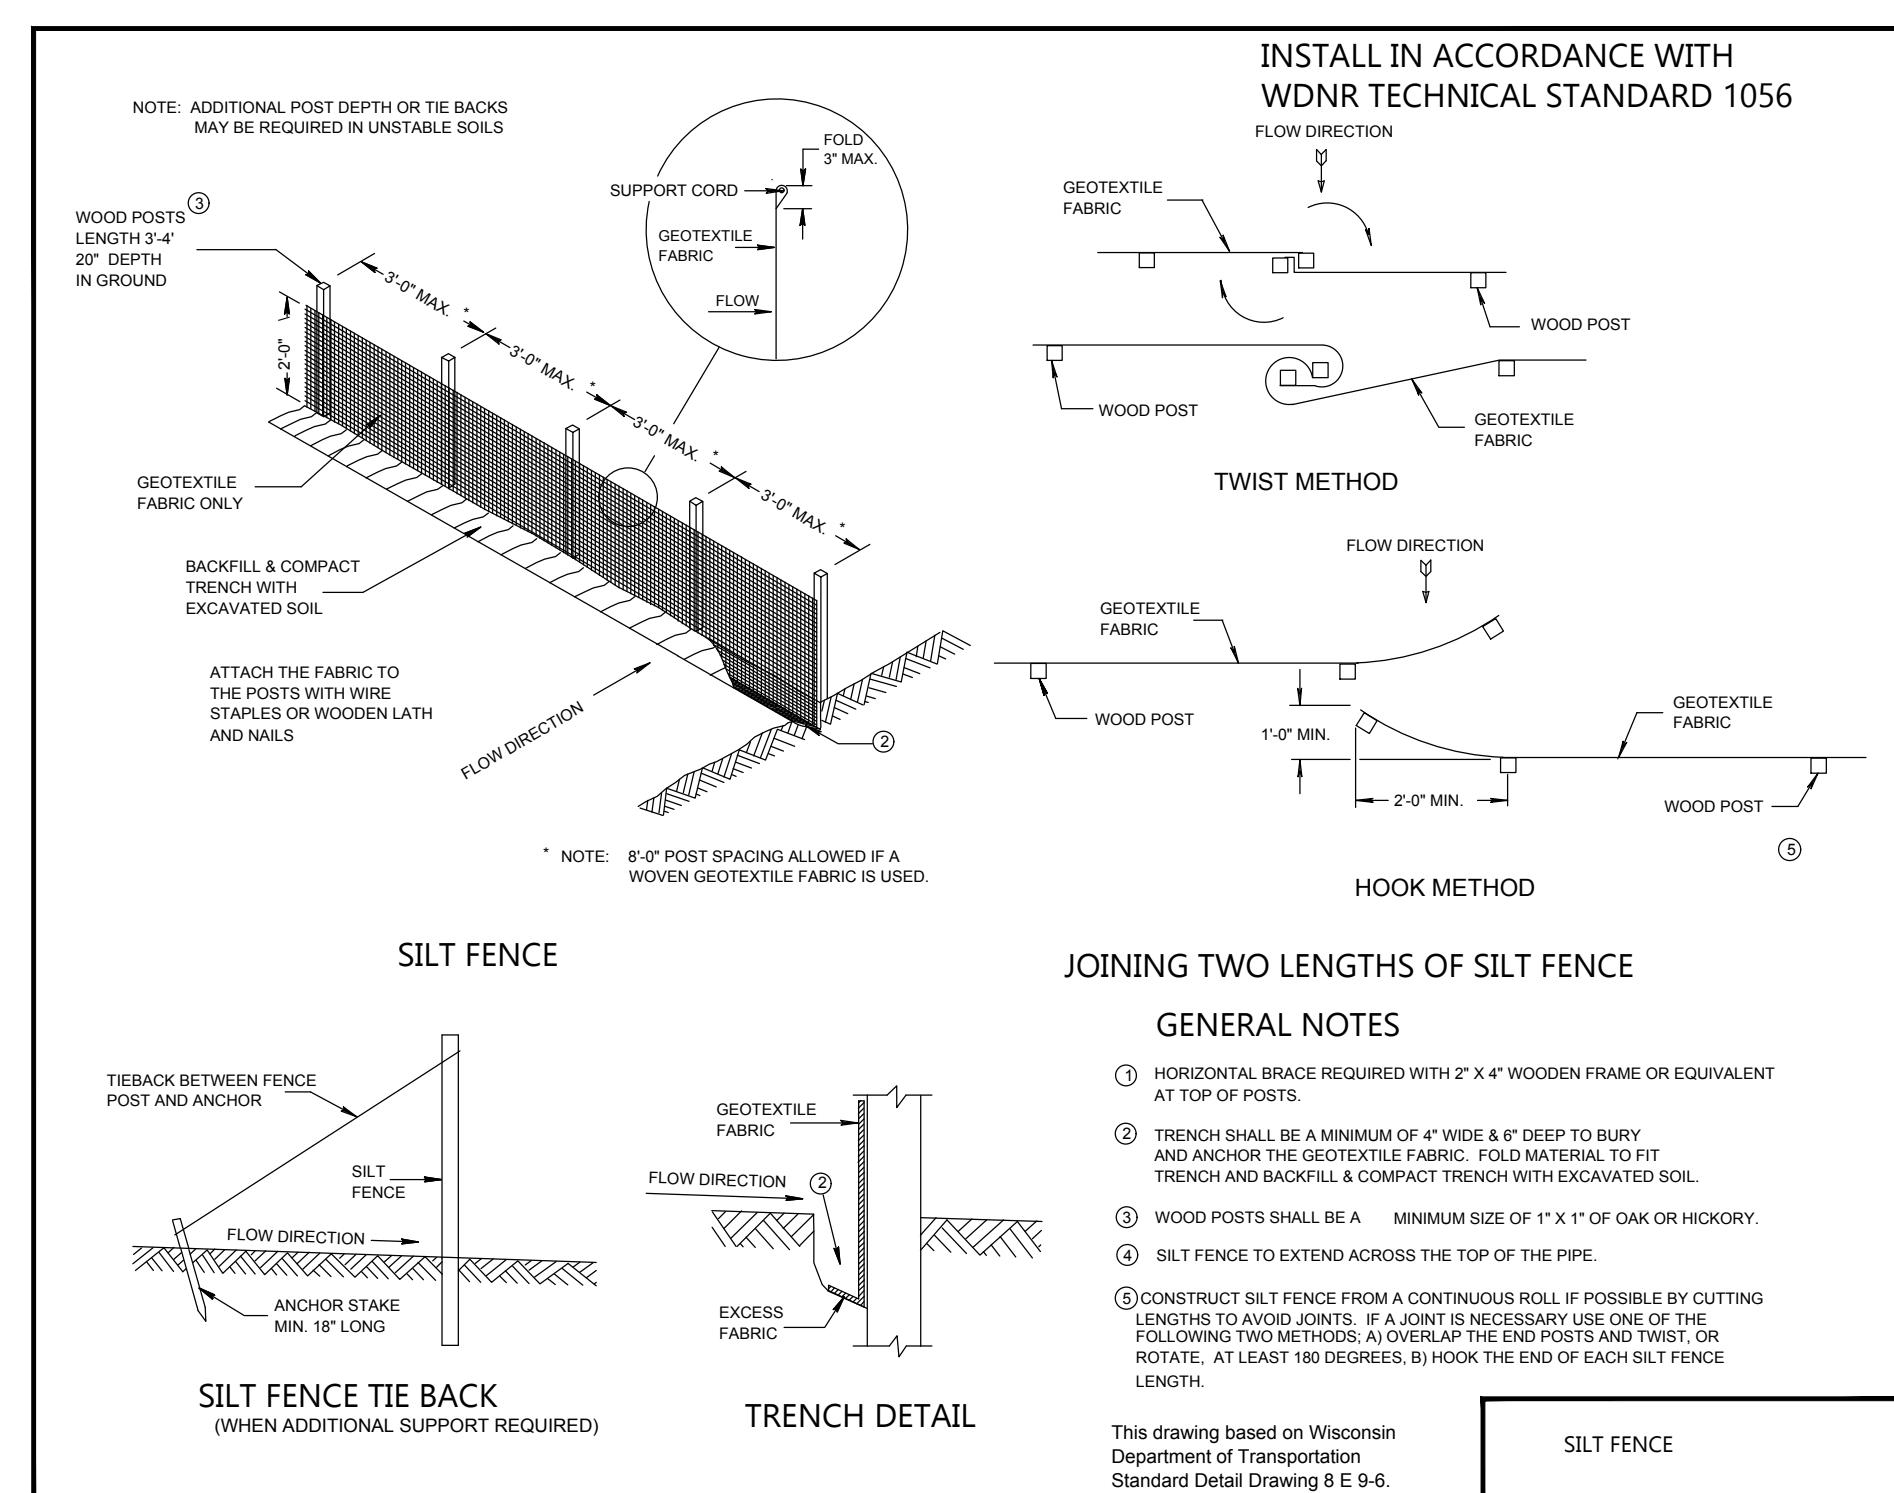

**SILT FENCE - INSTALLATION DETAIL**  
NOT TO SCALE



**PRELIMINARY DATES**  
DEC. 6, 2024  
DEC. 13, 2024



**JOB NUMBER**  
240275600

**SHEET NUMBER**

**C2.1**

**CIVIL DETAILS**

PROJECT INFORMATION

PROPOSED COFFEE SHOP FOR:  
**7-BREW MADISON**  
3915 LIEN RD. • MADISON, WI 53704

PROFESSIONAL SEAL


PRELIMINARY DATES  
DEC. 6, 2024  
DEC. 13, 2024

NOT FOR CONSTRUCTION


JOB NUMBER  
240275600

SHEET NUMBER

**C3.1**

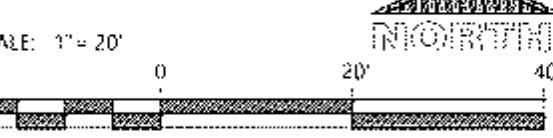

CIVIL SITE PHOTOMETRIC PLAN & DETAILS

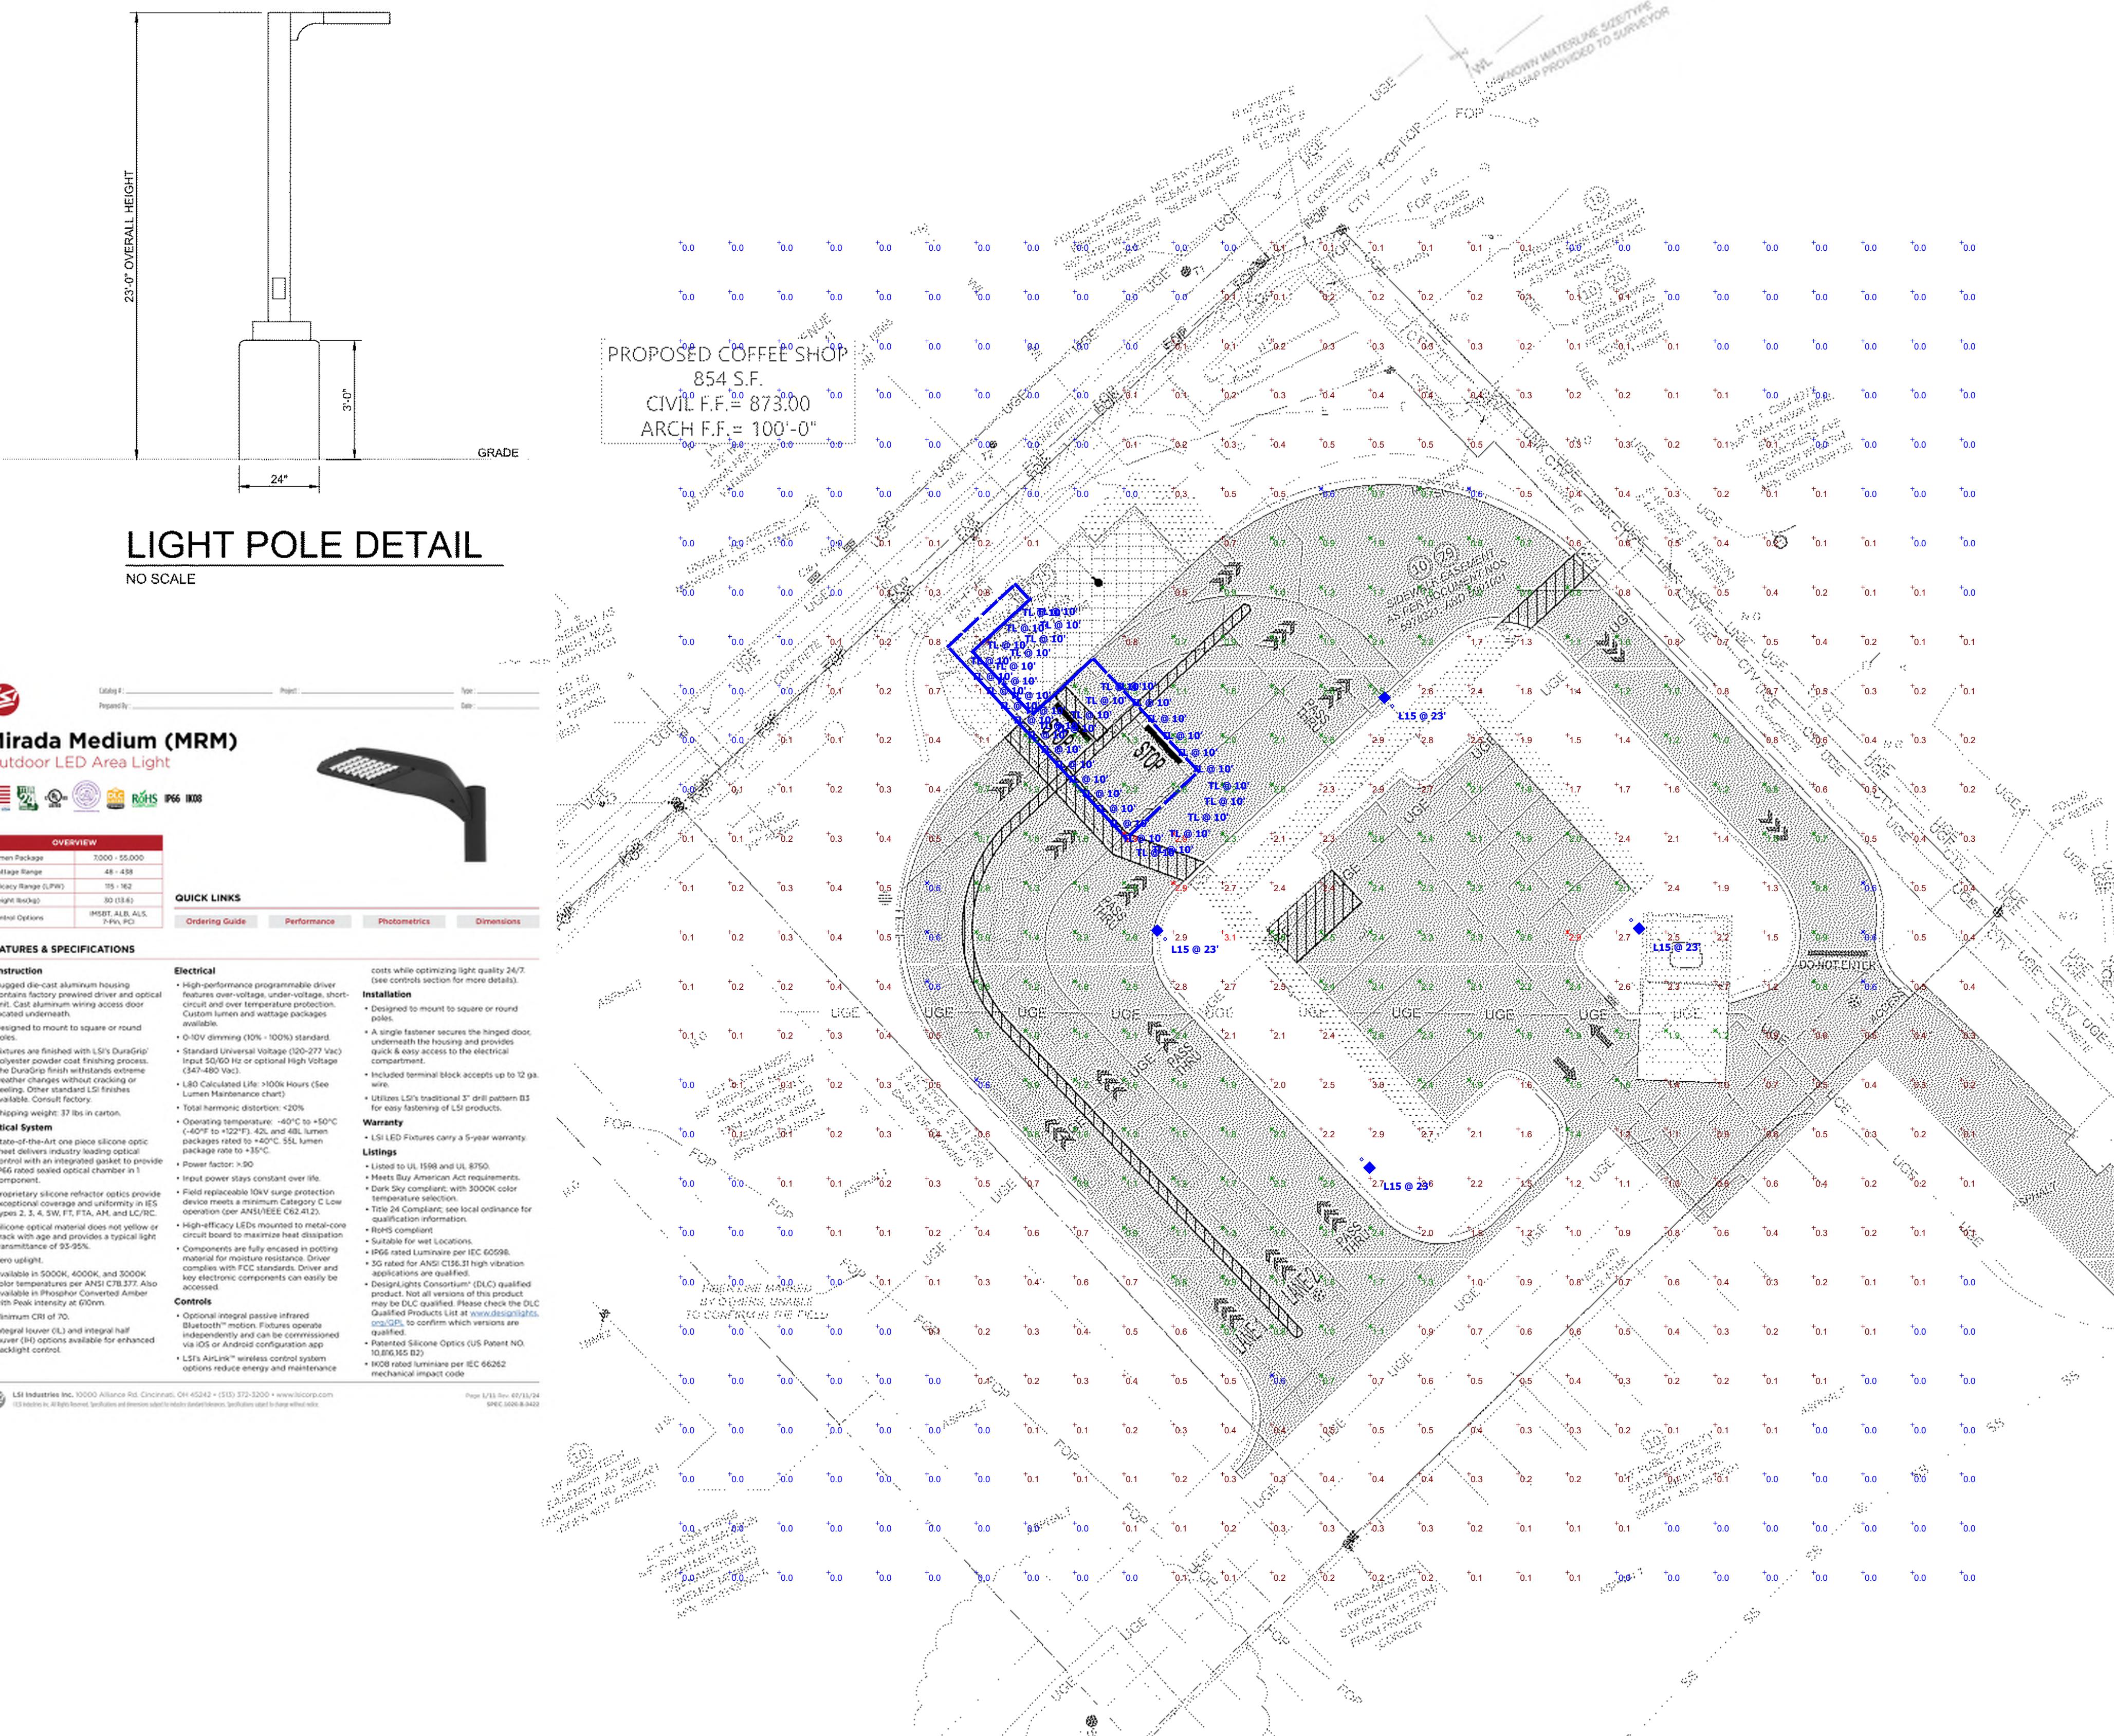

**LIGHT POLE DETAIL**

NO SCALE



Schedule					
Symbol	Label	Quantity	Manufacturer	Catalog Number	Number Lamps
	TL	41			1 400
	L14	0	LSI INDUSTRIES, INC.	MRM-LED-18L-SIL-FT-30-70CRI	1 19332
	L15	4	LSI INDUSTRIES, INC.	MRM-LED-12L-SIL-5W-30-70CRI	1 12672

Statistics					
Description	Symbol	Avg	Max	Min	Max/Min Avg/Min
PARKING LOT		1.6 fc	2.9 fc	0.6 fc	4.8:1 2.7:1
Calc Zone #2		0.7 fc	3.1 fc	0.0 fc	N/A N/A

FEATURES & SPECIFICATIONS

**Construction**

- Rugged die-cast aluminum housing contains factory prewired driver and optical unit. Cast aluminum wiring access door included.
- Designed to mount to square or round poles.
- Features are finished with LSI's Durafinish polyester powder coat finishing process. The Durafinish finish withstands extreme weathering and is scratch and impact resistant. Other standard LSI finishes available. Consult factory.
- Shipping weight: 37 lbs in carton.

**Optical System**

- State-of-the-Art one piece silicone optical sheet delivers industry leading optical control and uniformity. The optical system is IP66 rated sealed optical chamber in a compact housing.
- Input power stays constant over life.
- Field replaceable 16kV surge protection device meets a minimum Category C Luminous Intensity requirement.

**Control**

- Optional integrated infrared Bluetooth® control. Features sounds independently and can be commissioned via iOS or Android configuration app.
- L2i3 AURIC™ wireless control system options reduce energy and maintenance.

LSI Industries Inc. 10000 Allstate Rd. Cincinnati, OH 45242 • (513) 372-3200 • [www.lisicorp.com](http://www.lisicorp.com)

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Page 1/13 Rev. 4/9/23/24

Sheet 300-8-4403

Printed on 4/9/23/24

## FLOOR PLAN KEYNOTES

Note Number	Note Text
1	ACCESS DOOR FOR CRAWLSPACE ACCESS
2	MOP SINK; REF PLUMBING
3	STEP, CENTER ON DOOR
4	PREFABRICATED COMPLIANT MECHANICAL SERVICE GUARDRAIL PER IBC SECTION 1015 - EACH SIDE
5	PREFABRICATED COOLER BY NATIONAL MODULAR MANUFACTURING; COORD LOCATION & SPECS WITH CIVIL & STRUCT
6	SLIDING DOOR IS ADA AUTO/MANUAL EGRESS CAPABLE
7	ELECTRICAL EQUIPMENT, PAINTED TO MATCH BUILDING; REF ELECTRICAL
8	STOREFRONT SIGNS - SUPPLIED AND INSTALLED BY SIGN CONTRACTOR
9	DOWNSPOUT CONNECTION TO STORMWATER SYSTEM; REF CIVIL
10	DOWNSPOUT SCUPPER TO GRADE; REF CIVIL
11	SITE CONTRACTOR TO COORDINATE CIVIL AND STRUCTURAL DRAWINGS TO ENSURE ALL CANOPY COLUMN FOUNDATION PLATES AND BOLTS ARE CONSTRUCTED IN A MANNER THAT CONCEALS THEIR CONNECTIONS COMPLETELY BELOW GRADE; TYP.
12	DOWNSPOUT OUTLET - STORMWATER CONNECTION; REF CIVIL

A large, stylized letter 'V' composed of two dark gray triangles pointing downwards, with a white gap between them.

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architecture + design

707 n. 6th street  
kansas city, ks 66101  
[www.veritas-ad.com](http://www.veritas-ad.com)  
913.308.1460

consulting engineer:

7 BREW DRIVE THRU - MADISON WI - WASHINGTON

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PLAZA STREET PARTNERS, LLC

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3909 EAST WASHINGTON AVE

## REVISIONS

**No. Description Date**

sheet issue date:  
12/13/2024


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23.26.05


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sheet no.:





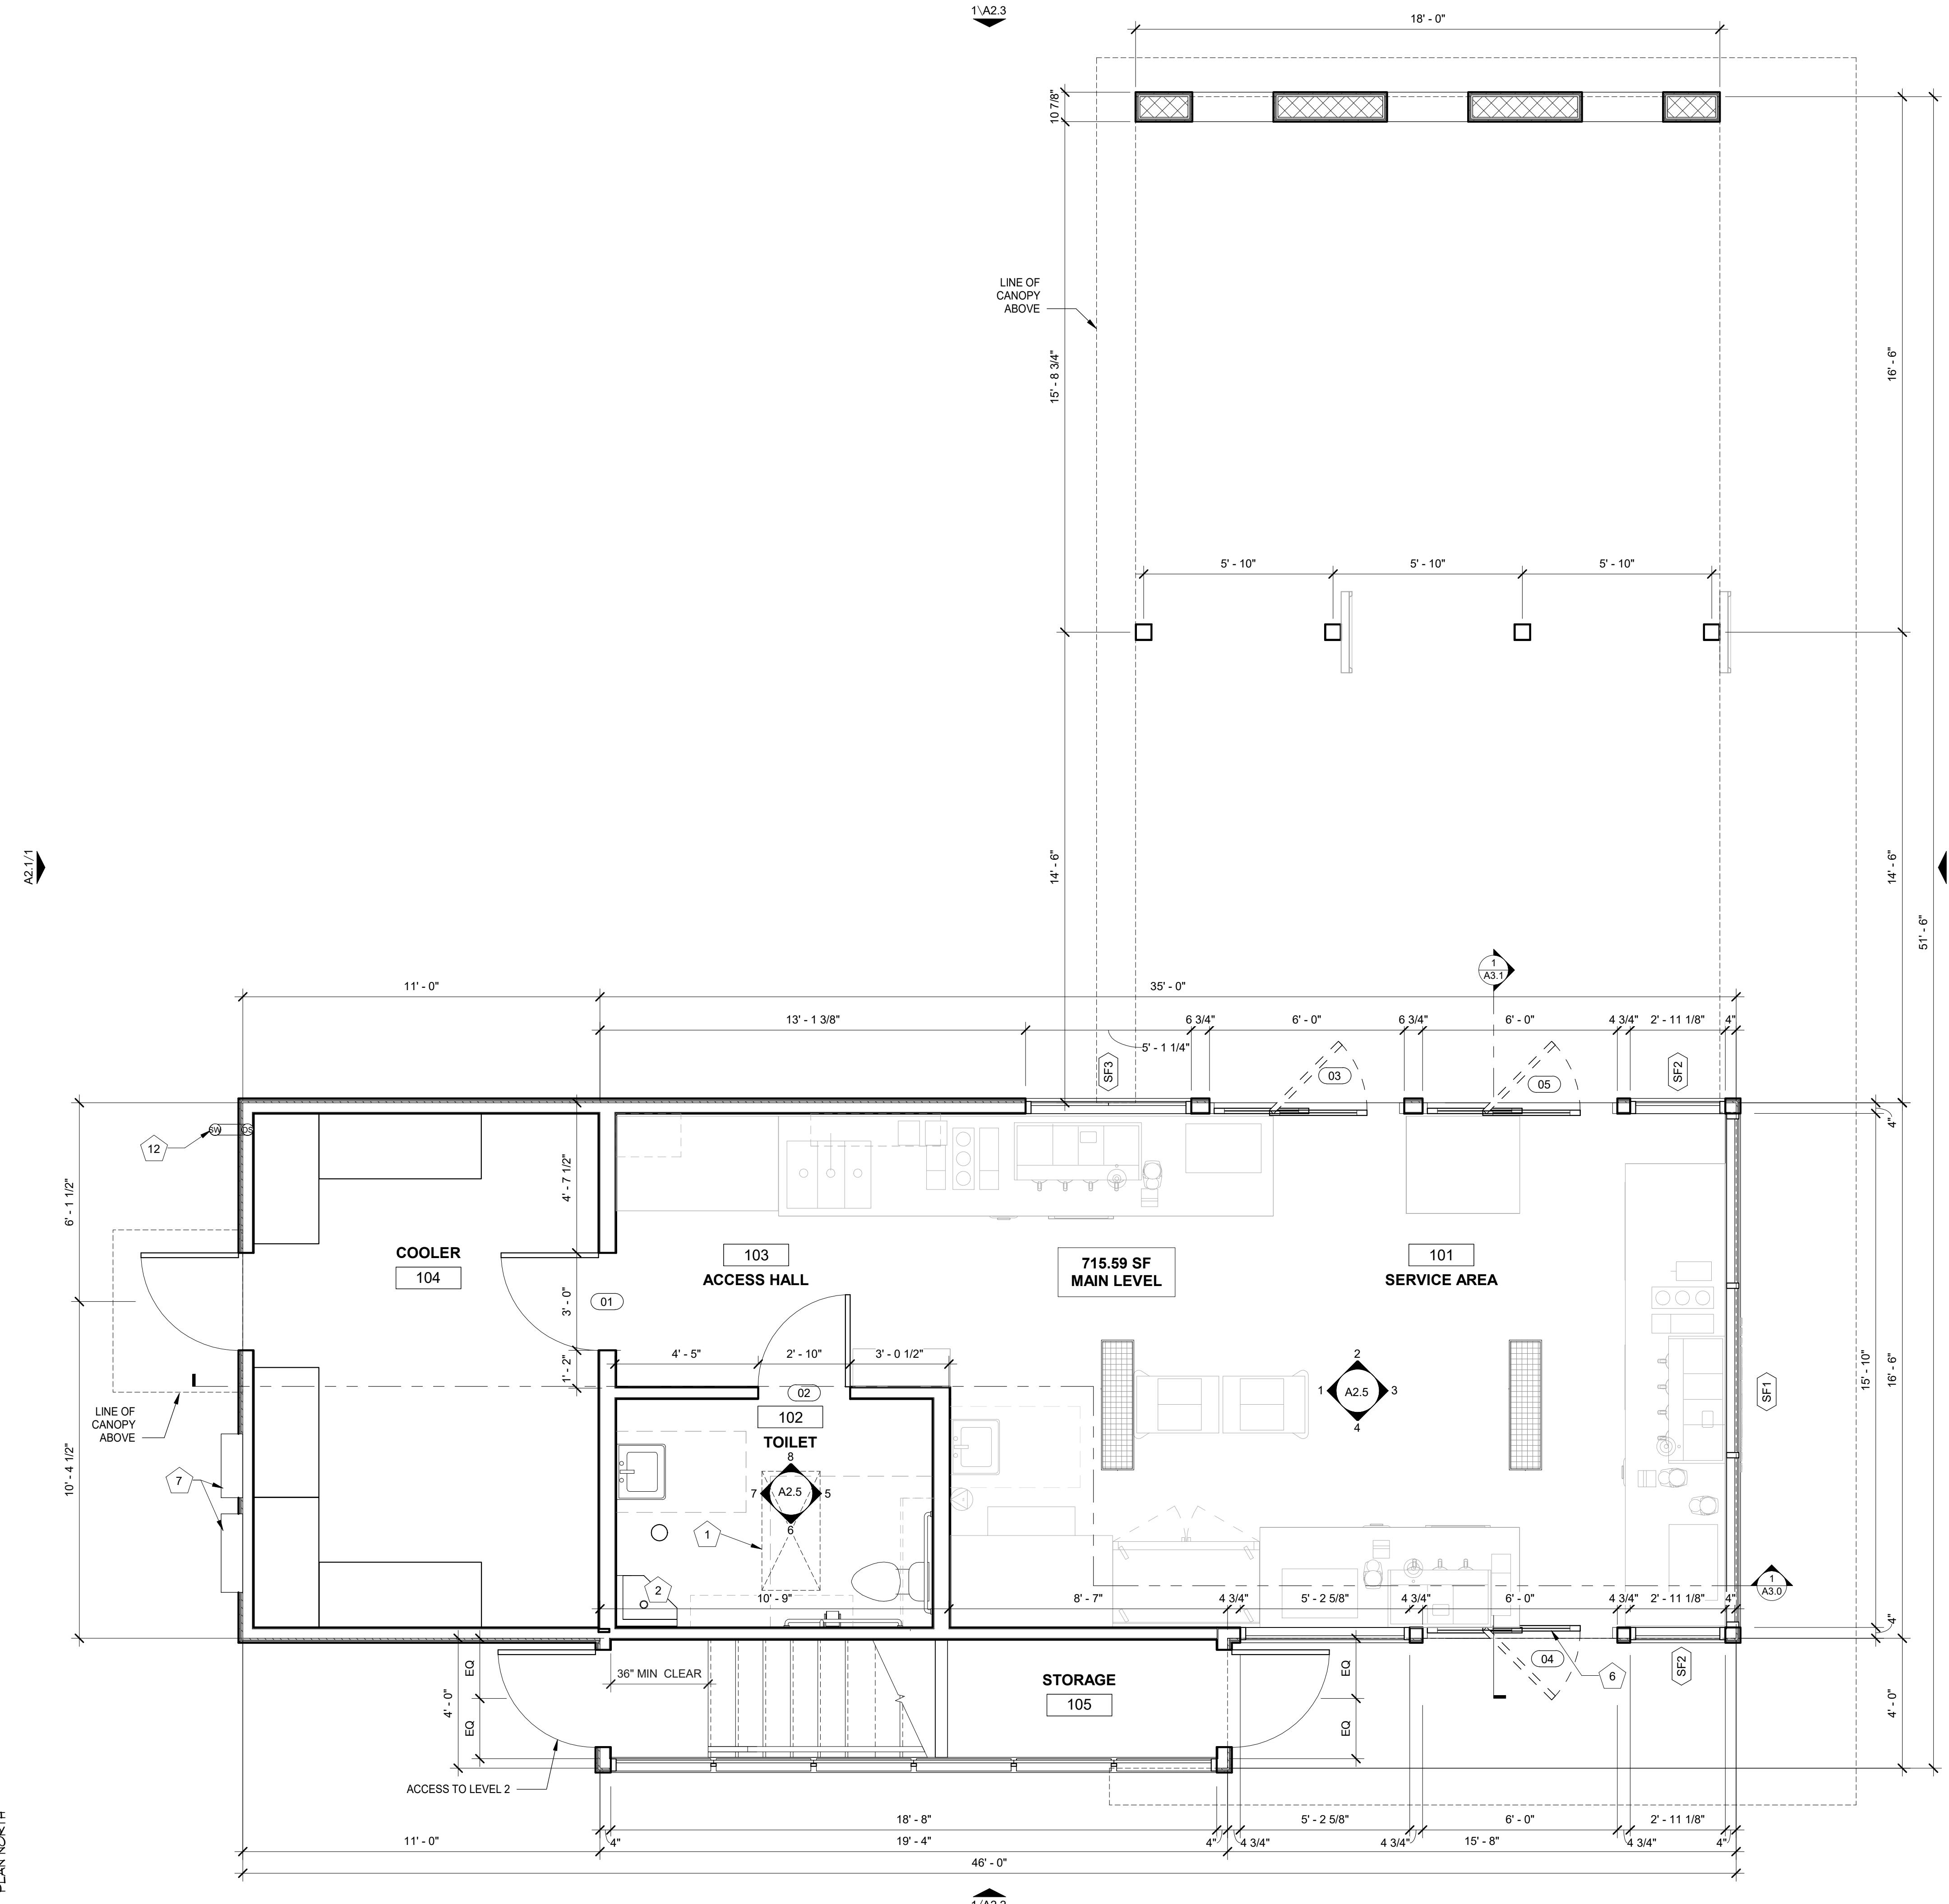

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kansas city, ks 66101

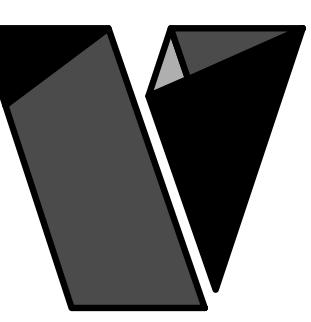www.veritas-ad.com

913.308.1460

consulting engineer:

## 7 BREW DRIVE THRU - MADISON WI - WASHINGTON

PLAZA STREET PARTNERS, LLC

3909 EAST WASHINGTON AVENUE, MADISON, WISCONSIN 53704

## REVISIONS

No. Description Date

sheet issue date:

12/13/2024

project no.:

23.26.05

sheet contents:

ROOF PLAN

sheet no.:

A1.6


## ROOF PLAN KEYNOTES


Note Number	Note Text
1	PRE-ENGINEERED CANOPY AND FRAMING; REF CANOPY SHOP DRAWINGS
2	TPO ROOFING ON 5/8" CDX ROOF SHEATHING
3	CORRUGATED ARK METAL ROOF ON #15 FELT ON PLYWOOD ROOF SHEATHING
4	TPO ROOFING ON 5/8" CDX ROOF SHEATHING ON BUILT-UP 2x CRICKET FRAMING
5	8" WIDE X 4" HIGH TPO ROOF SCUPPER WITH SHEET METAL UNDERLAYMENT
6	BRAKE METAL CAP; REF ELEVATIONS
7	3' - 6" GUARDRAIL
8	ROOF DRAIN WITHIN STRUCTURAL COLUMN; CONNECT TO STORMWATER COLLECTION SYSTEM; REF CIVIL
9	ROOF DRAIN WITHIN STRUCTURAL COLUMN; DOWNSPOUT SCUPPER TO GRADE; REF CIVIL
10	ROOF DRAIN; DOWNSPOUT TO BE GALVANIZED, PAINTED, STEEL; CONNECT TO STORMWATER COLLECTION SYSTEM; REF CIVIL
11	OVERFLOW ROOF DRAIN
12	HVAC EQUIPMENT
13	ROOFING PER COOLER MANUF
14	MODULAR BUILDING PICK POINTS WITH ROOFING COLLAR; REF STRUCT
15	ICE MACHINE CONDENSERS; SITE CONTRACTOR TO DETERMINE FINAL LOCATION
16	OVERFLOW SCUPPER TO GRADE
17	IN-WALL ROOF DRAIN W/ ABOVE-GRADE OUTLET (BEYOND) CONNECTED TO SUB-GRADE STORMWATER COLLECTION SYSTEM; REF CIVIL

## 1 ROOF PLAN

3/8" = 1'0"

PLAN NORTH

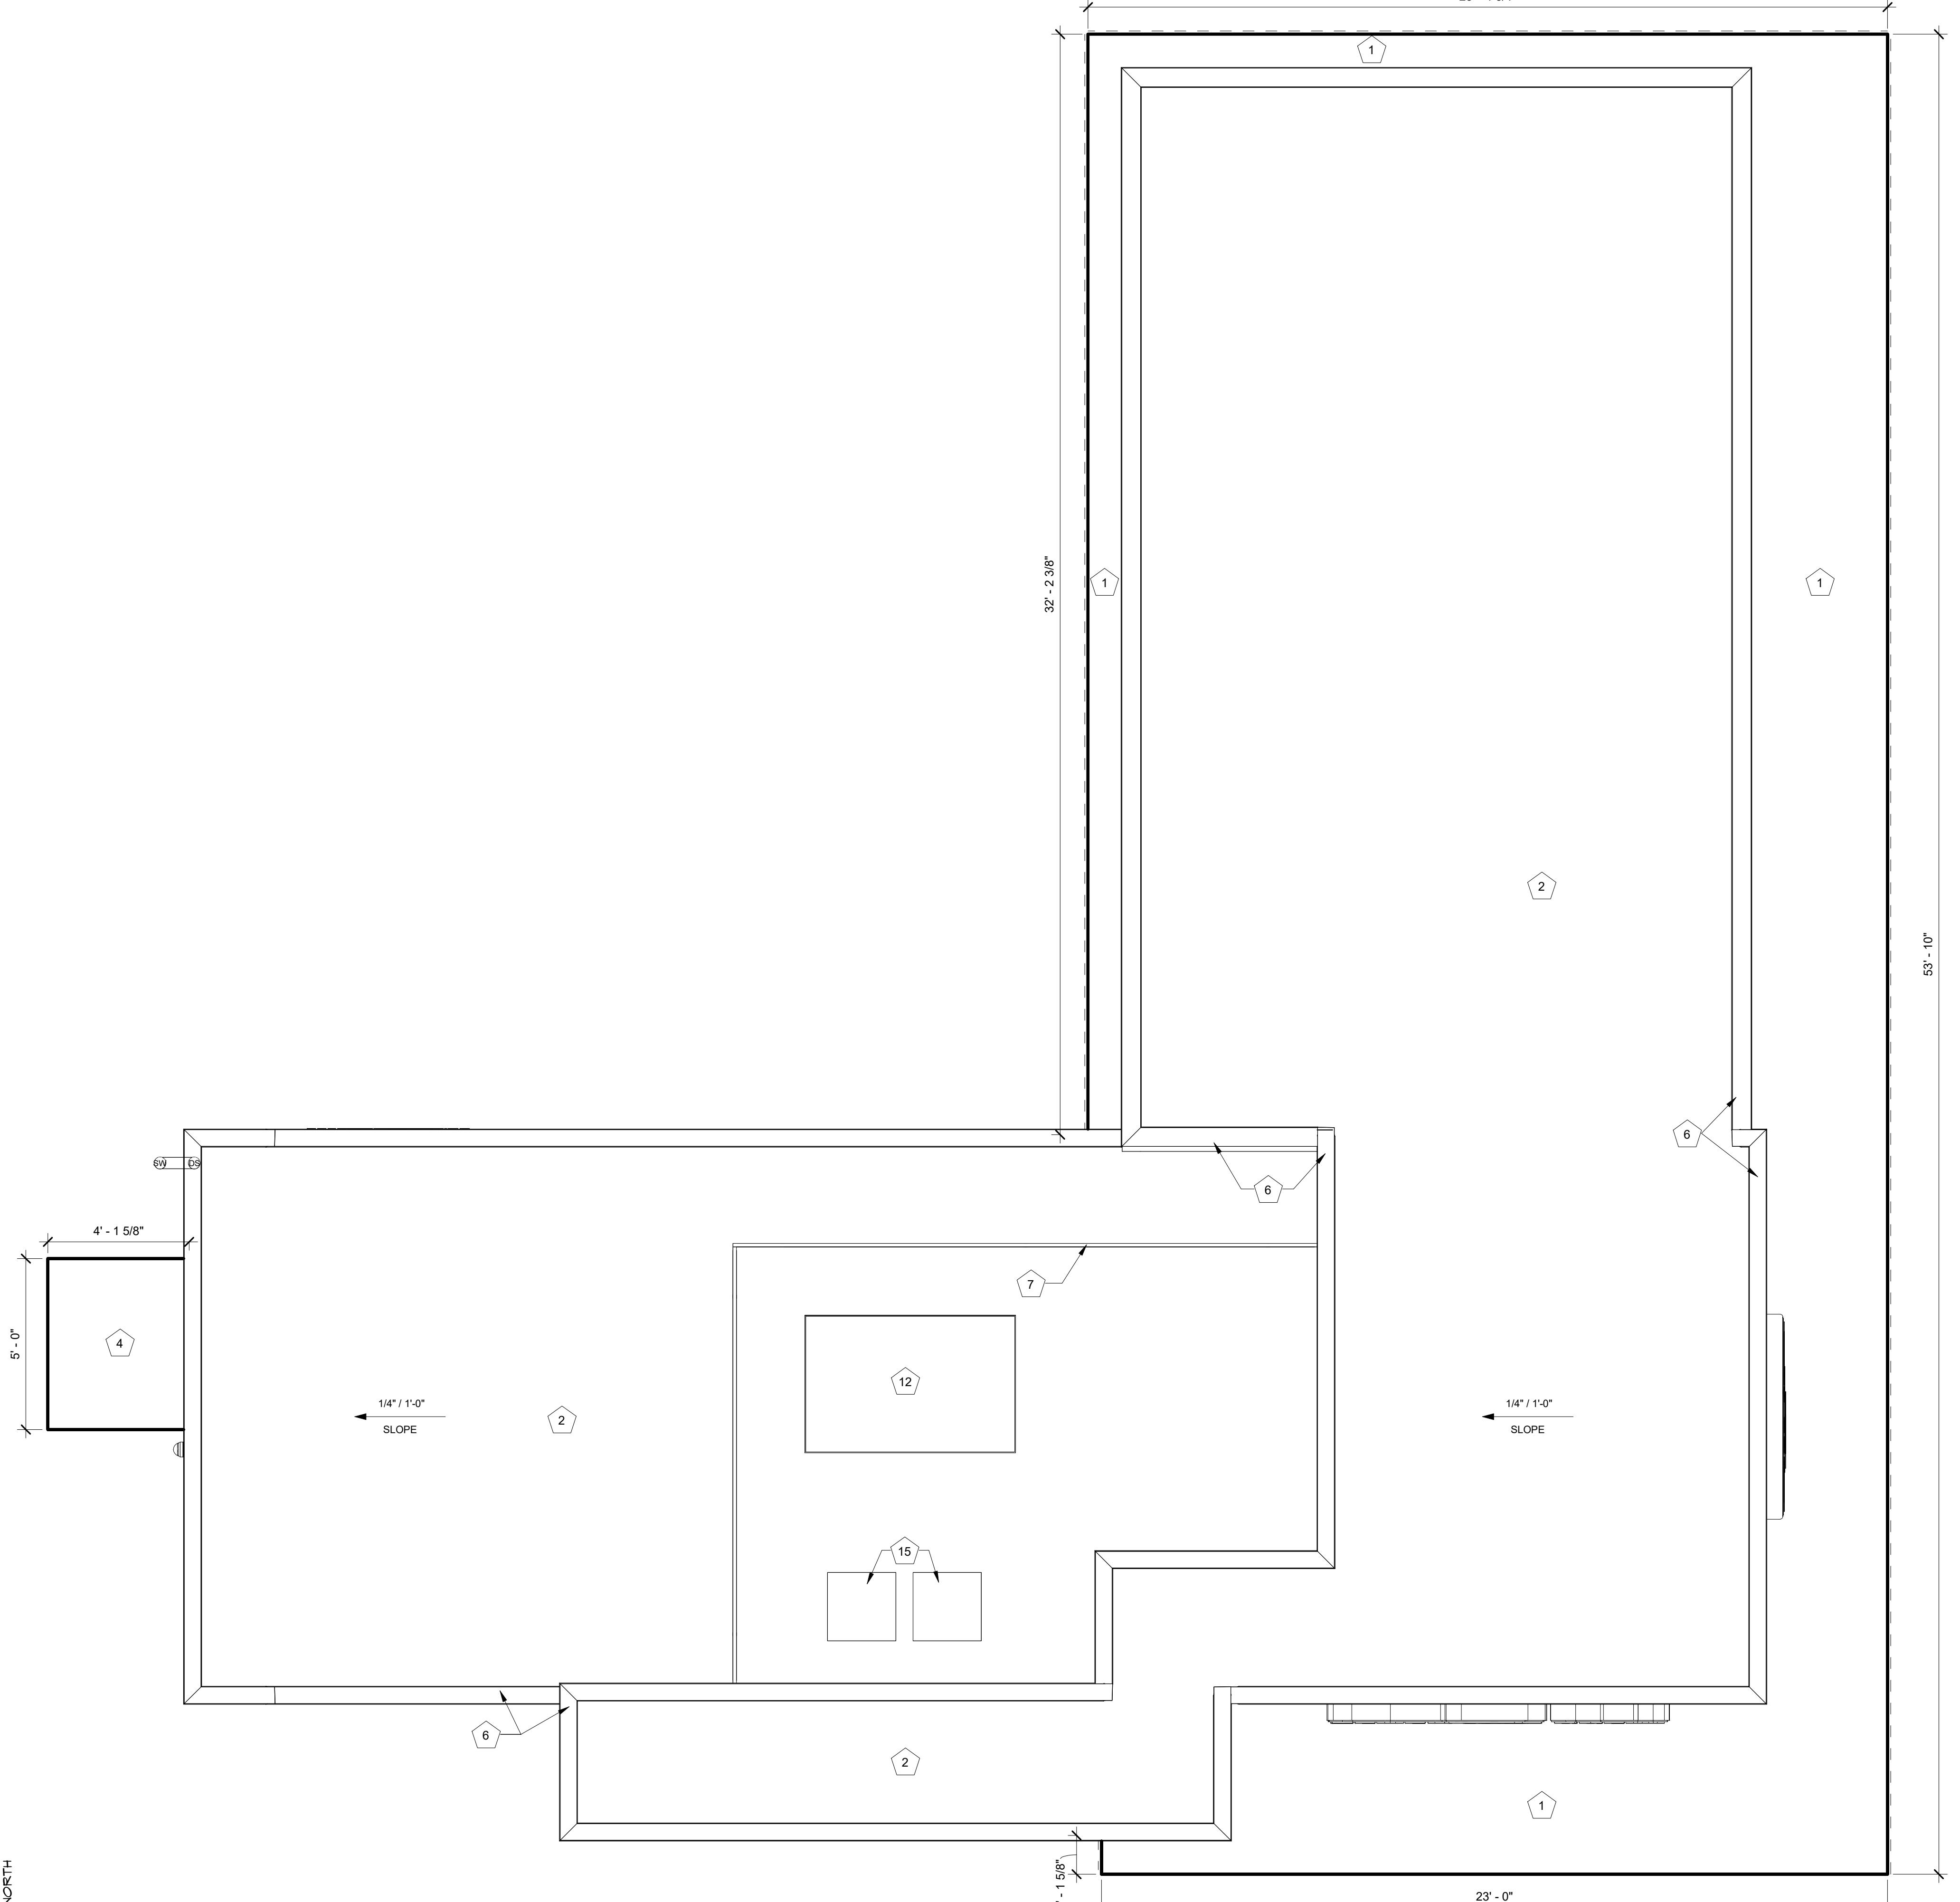

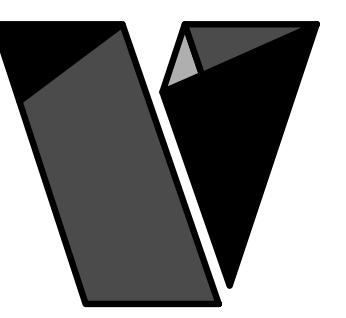

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913.308.1460

consulting engineer:

## 7 BREW DRIVE THRU - MADISON WI - WASHINGTON

PLAZA STREET PARTNERS, LLC

3909 EAST WASHINGTON AVENUE, MADISON, WISCONSIN 53704

## REVISIONS

No. Description Date

sheet issue date:

12/13/2024

project no.:

23.26.05

sheet contents:

EXTERIOR ELEVATIONS

sheet no.:

A2.0

## EXTERIOR ELEVATION KEYNOTES

Note Number	Note Text
1	PRE-ENGINEERED ALUMINUM CANOPY BY OTHERS; REF STRUCTURAL
2	SURFACE-MOUNTED LED NEON FLEX LIGHTING AS INDICATED (SHOWN DASHED); TYP; REF ELECTRICAL
3	MOUNTED SPEAKER SYSTEM; SEE SYSTEMS PLAN
4	ADDRESS NUMBERS TO BE 8" TALL x 2" BRUSH STROKE
5	ELECTRICAL EQUIPMENT, PAINTED TO MATCH BUILDING; REF ELECTRICAL
6	FROST-PROOF FLUSH HOSE BIB
7	EXTERIOR WEATHER-PROOF OUTLET; REF ELECTRICAL
8	THROUGH-WALL ROOF SCUPPER; TYP
9	SURFACE MOUNTED LIGHTED SIGN BOX
10	SAMSUNG DIGITAL DISPLAYS-INSTALLED IN FIELD BY IT PROVIDER; CHASE FOR DATA CABLE INSTALLED AT BUILDING MANUFACTURING FACILITY
11	GUARDRAIL; 3'-6" ABOVE ATTIC FLOOR
12	HVAC EQUIPMENT
13	OUTLINE OF MECHANICAL UNIT BEYOND
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15	CANOPY HEATER
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19	EXTERIOR STAIRWELL W/ SCREEN WALLS; COORD W/ CIVIL
20	DOWNSPOUT OUTLET; CONNECT TO SUBGRADE STORMWATER CONNECTION; REF CIVIL


## EXTERIOR ELEVATION MATERIALS LEGEND

Note Number	Note Text
A	ARCHITECTURAL CEMENT BOARD SIDING (BRK-2)
B	ARCHITECTURAL CEMENT BOARD SIDING (BRK-1)
C	BRAKE METAL FASCIA (MP-2)
D	STANDING SEAM ROOF PANELS (MP-2)
E	METAL BRAKE CAP (MP-3)
F	ROUND STOREFRONT SIGN, SUPPLIED AND INSTALLED BY SIGN CONTRACTOR
G	1/4" THICK ACRYLIC SIGNAGE APPLIED TO SIDING WITH VH DOUBLE SIDE TAPE
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N	EXPOSED DOWNSPOUT, GALVANIZED, PAINTED; DRAIN TO MAIN LVL ROOF; REF CIVIL
P	SCREEN WALL CLAD TO MATCH BUILDING, STRUCTURAL COLUMNS WITHIN; REF CIVIL & STRUCT



1 EXTERIOR ELEVATION - SOUTH

3/8" = 1'-0"

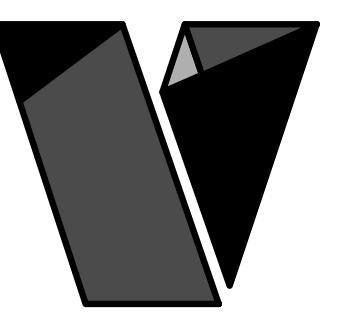

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PLAZA STREET PARTNERS, LLC


3909 EAST WASHINGTON AVENUE, MADISON, WISCONSIN 53704

### EXTERIOR ELEVATION KEYNOTES

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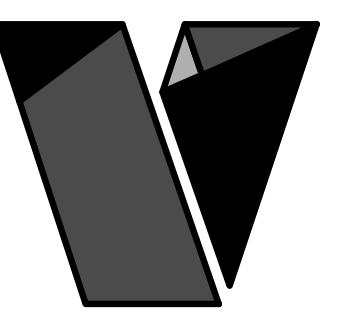


1 EXTERIOR ELEVATION - NORTH

3/8" = 1'-0"

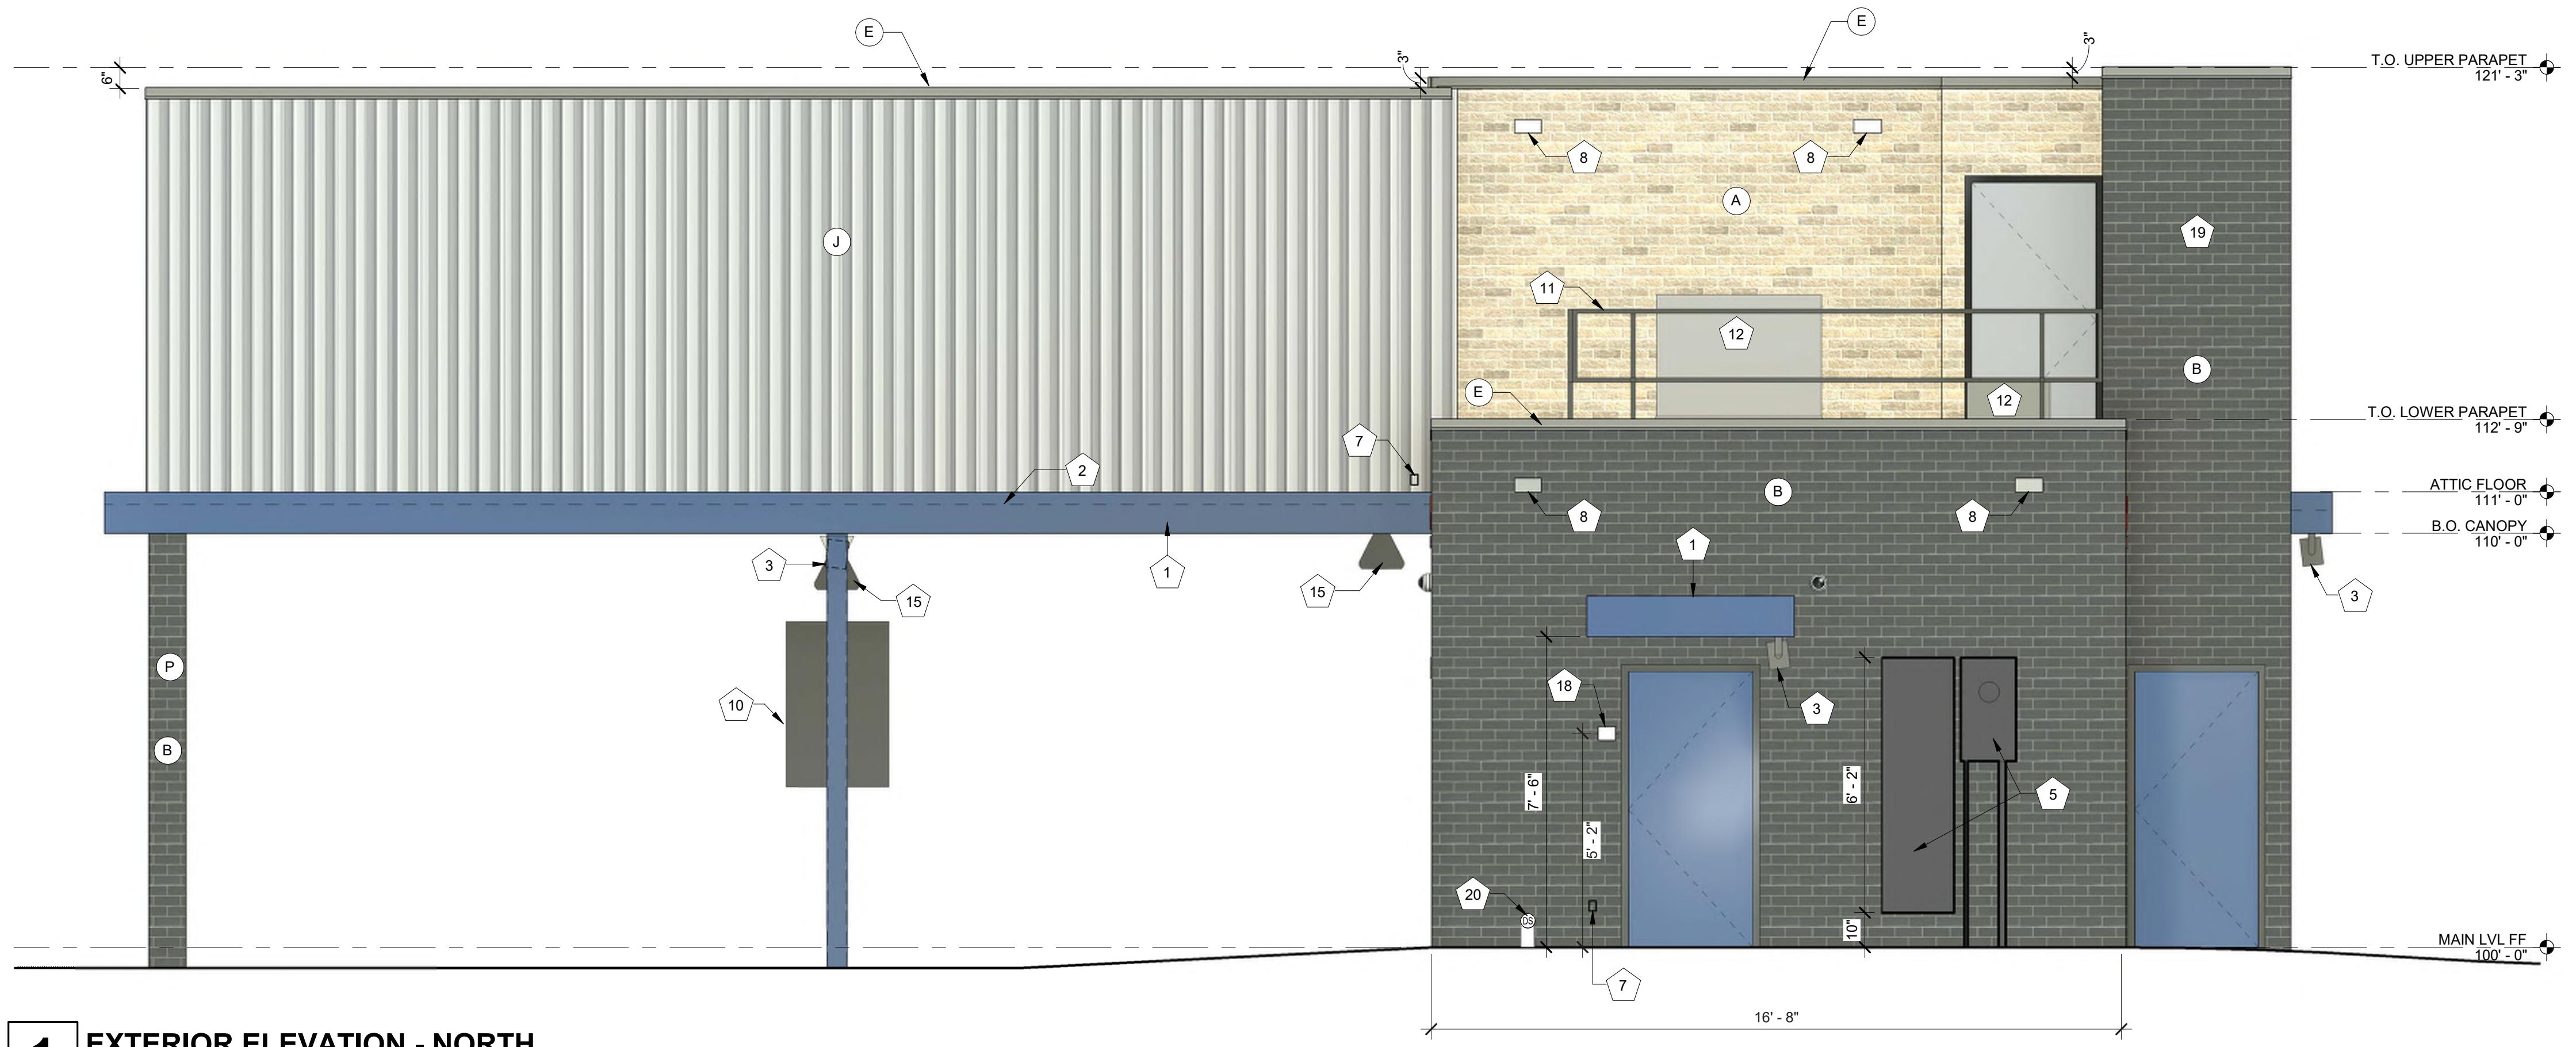A2.1





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## 7 BREW DRIVE THRU - MADISON WI - WASHINGTON

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## REVISIONS

No. Description Date

sheet issue date:

12/13/2024

project no.:

23.26.05

sheet contents:

EXTERIOR ELEVATIONS

sheet no.:

A2.3

## EXTERIOR ELEVATION KEYNOTES


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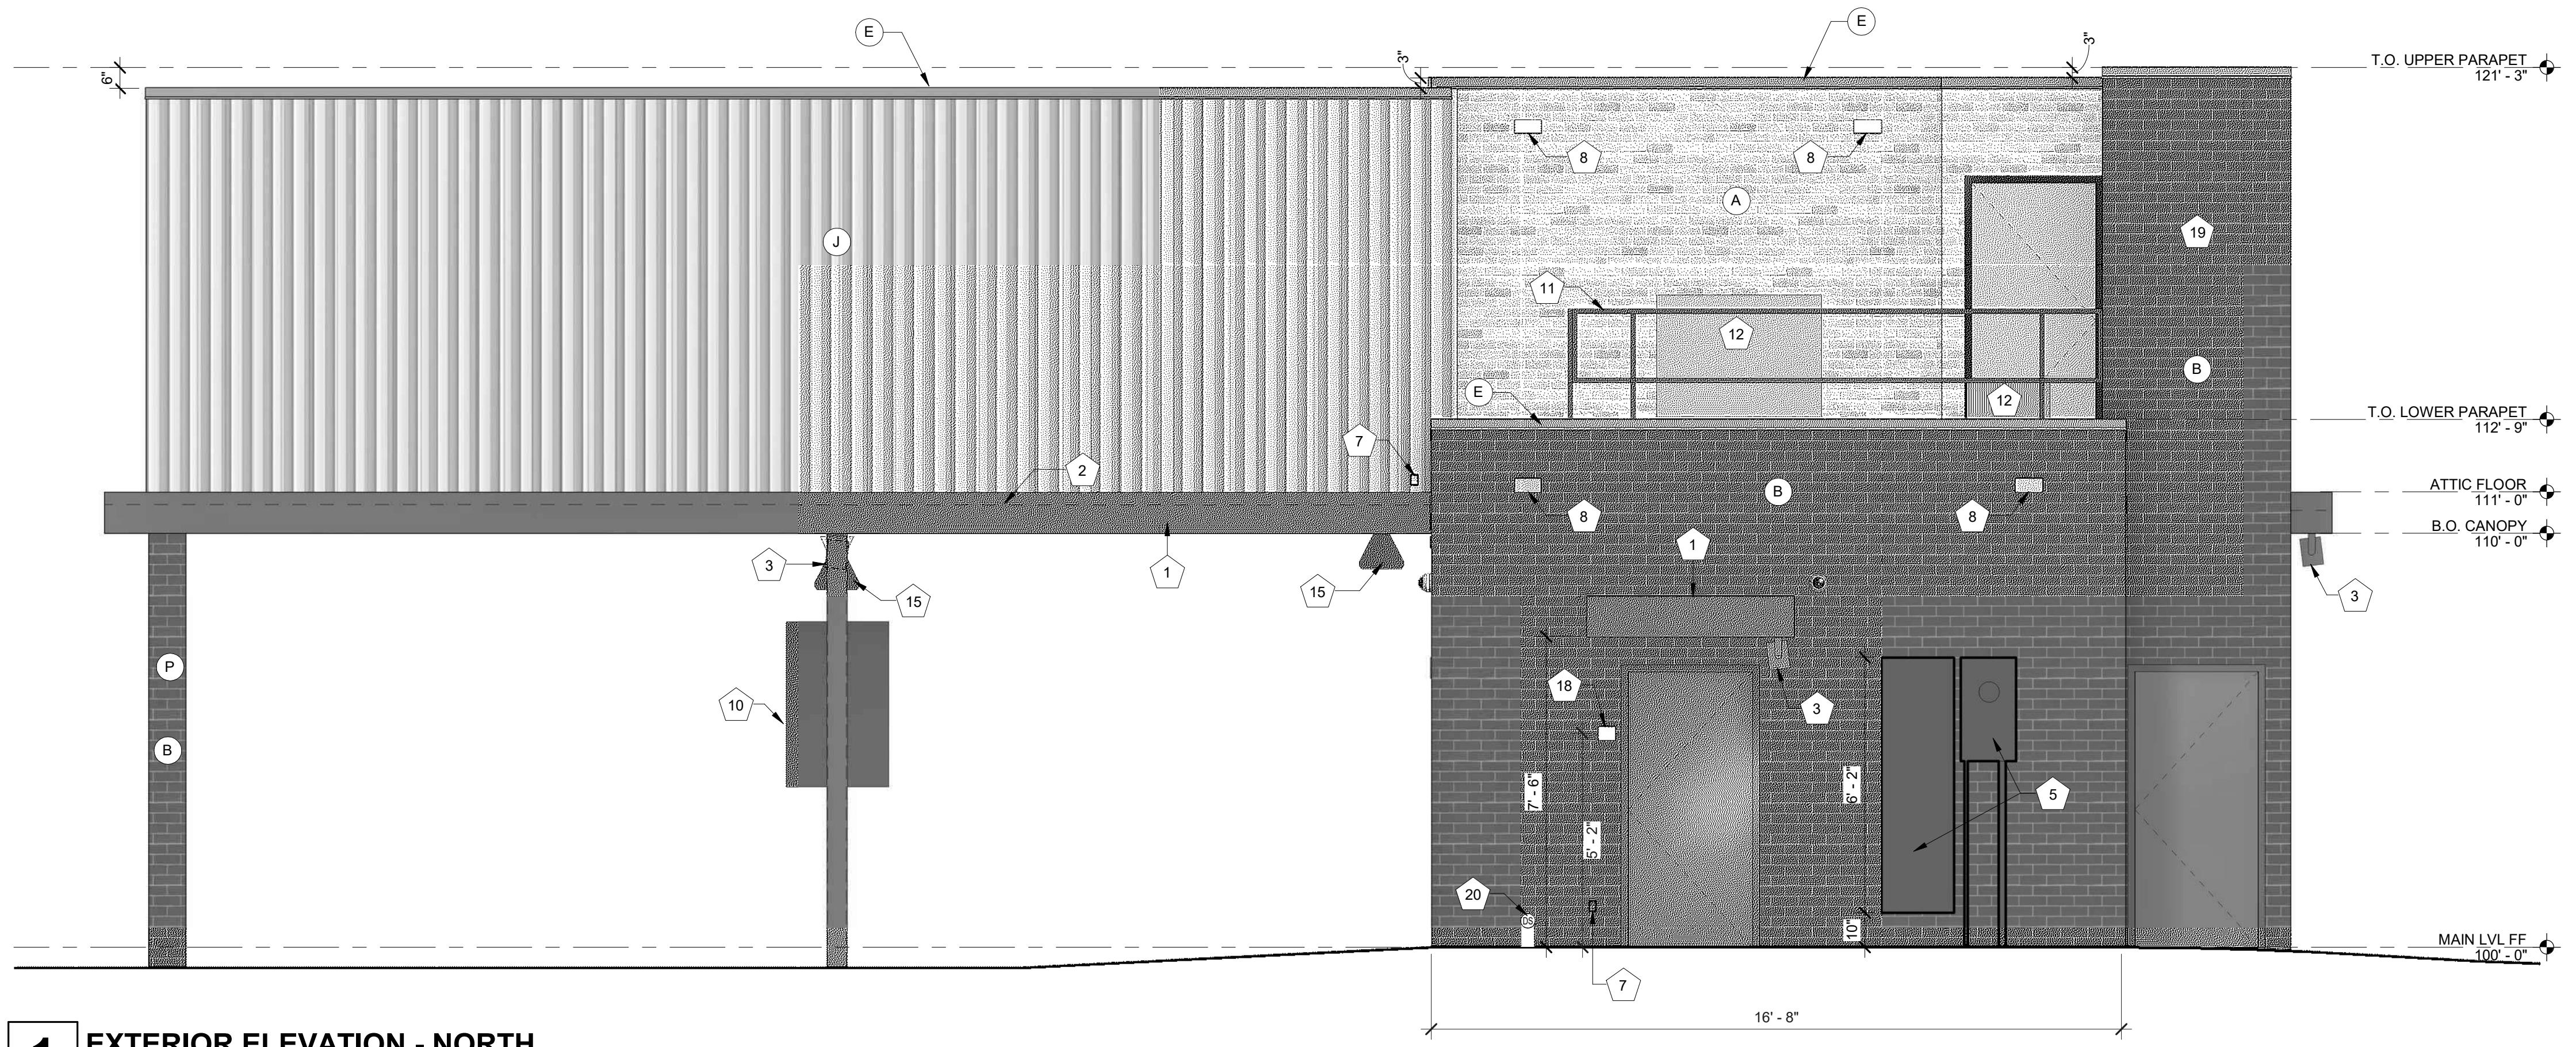
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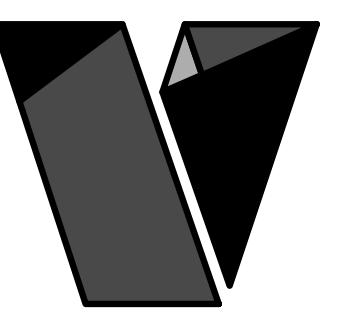
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1 EXTERIOR ELEVATION - NORTH

3/8" = 1'-0"

REVISIONS  
No. Description Date  
  
sheet issue date: 12/13/2024  
project no.: 23.26.05  
sheet contents: EXTERIOR ELEVATIONS  
sheet no.: A2.1



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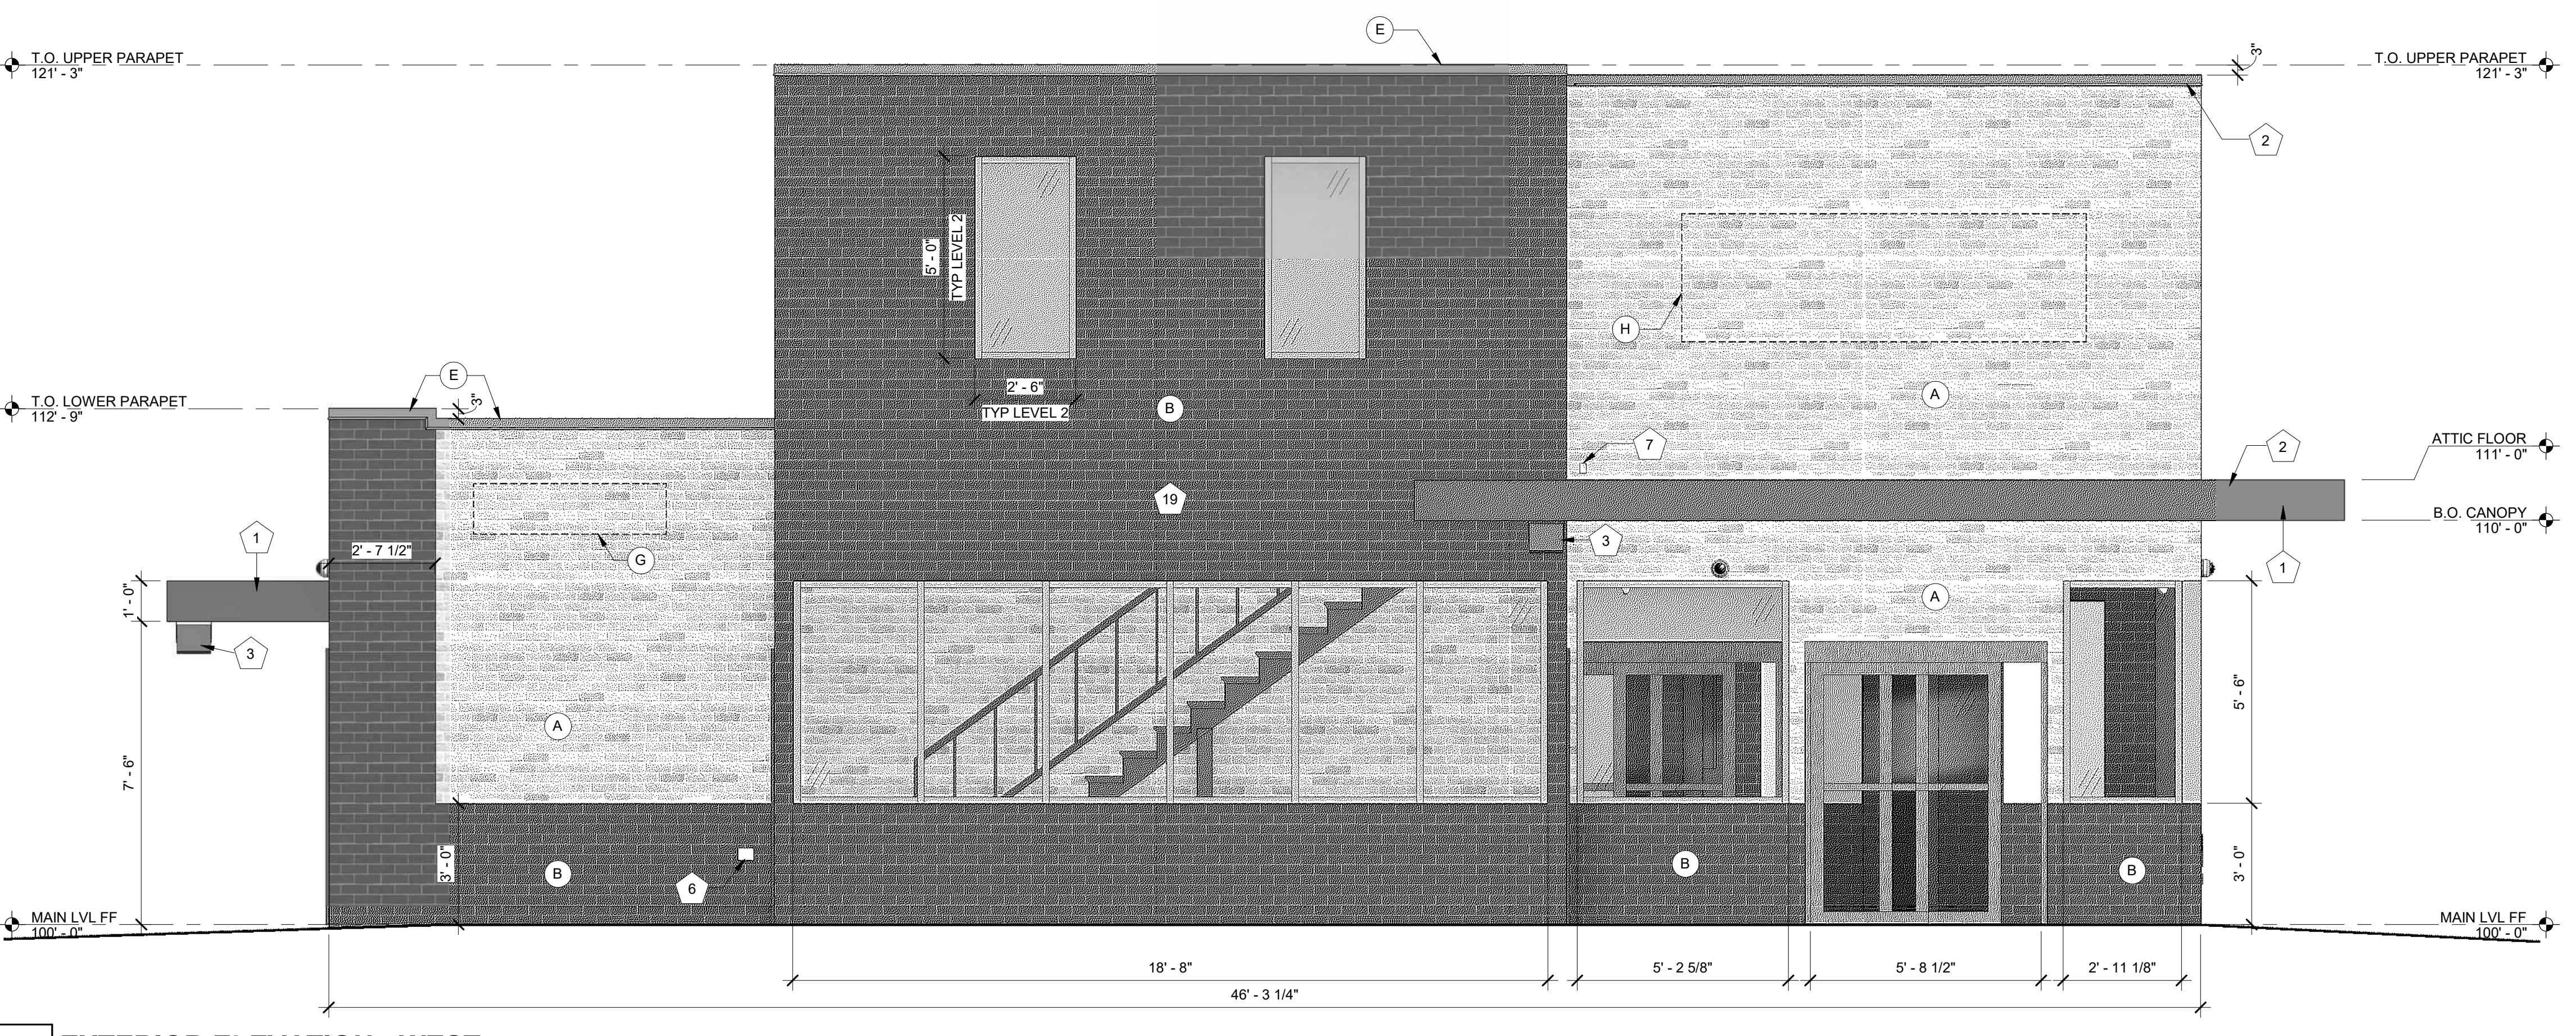
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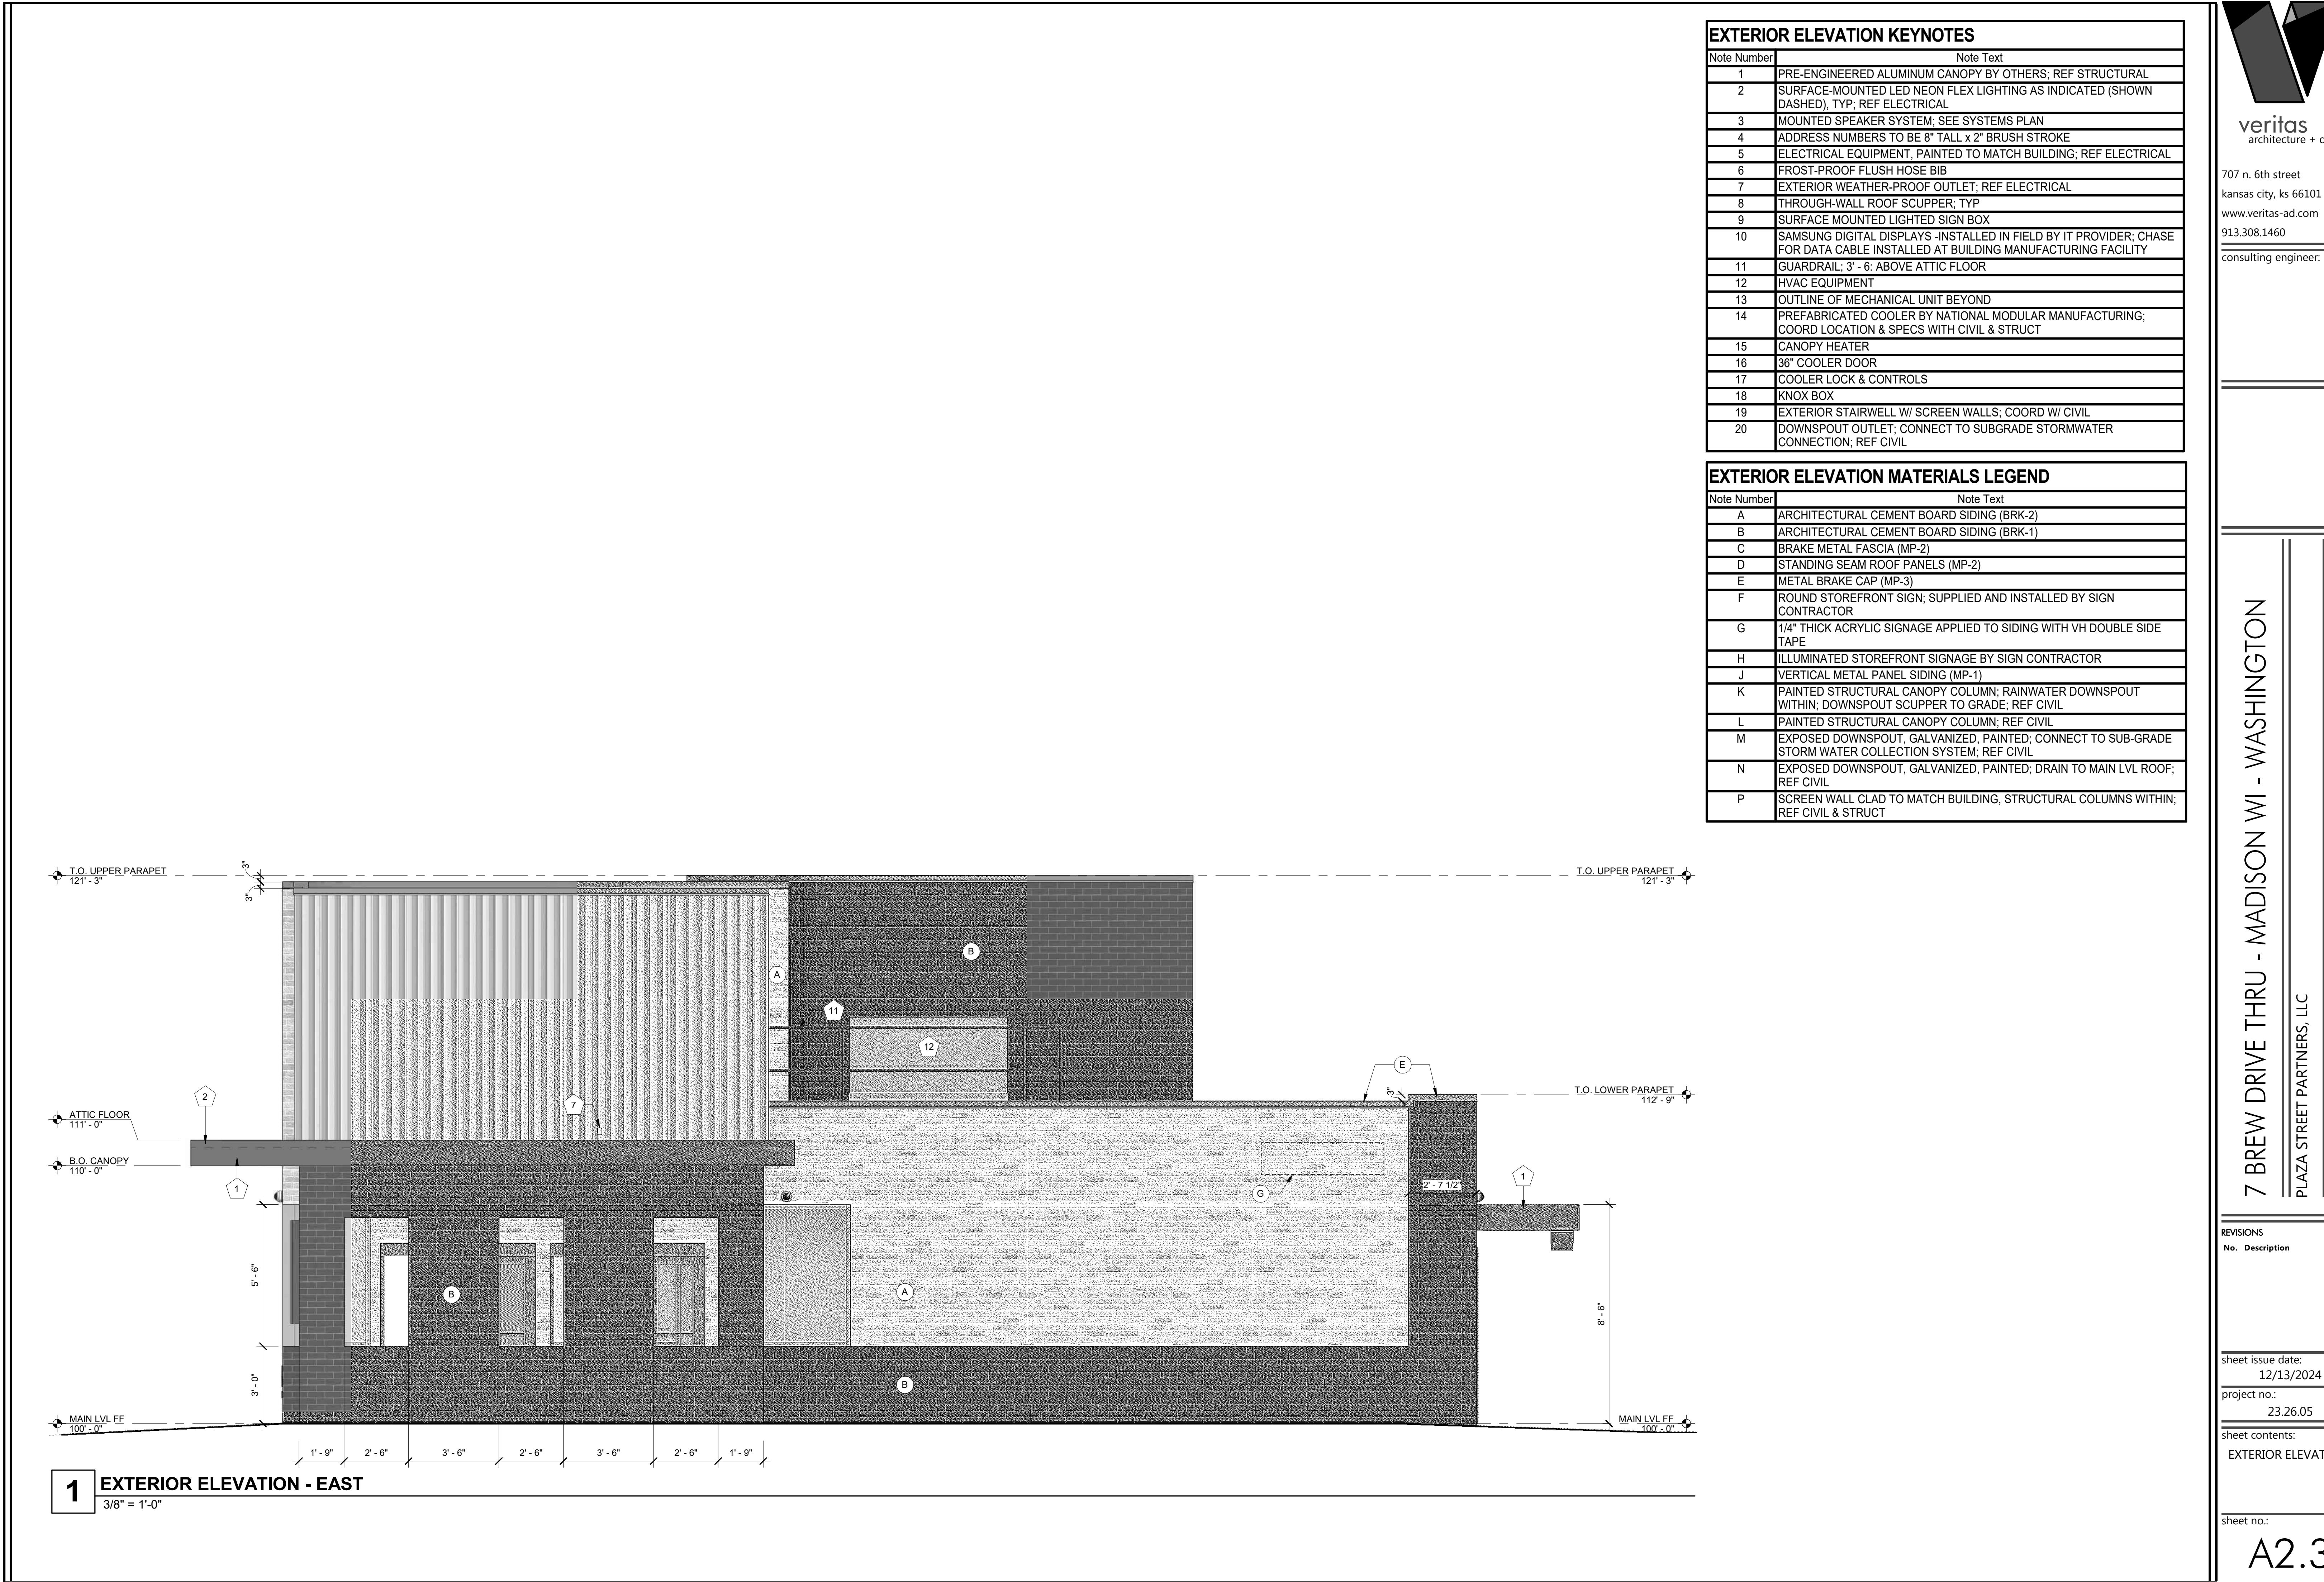
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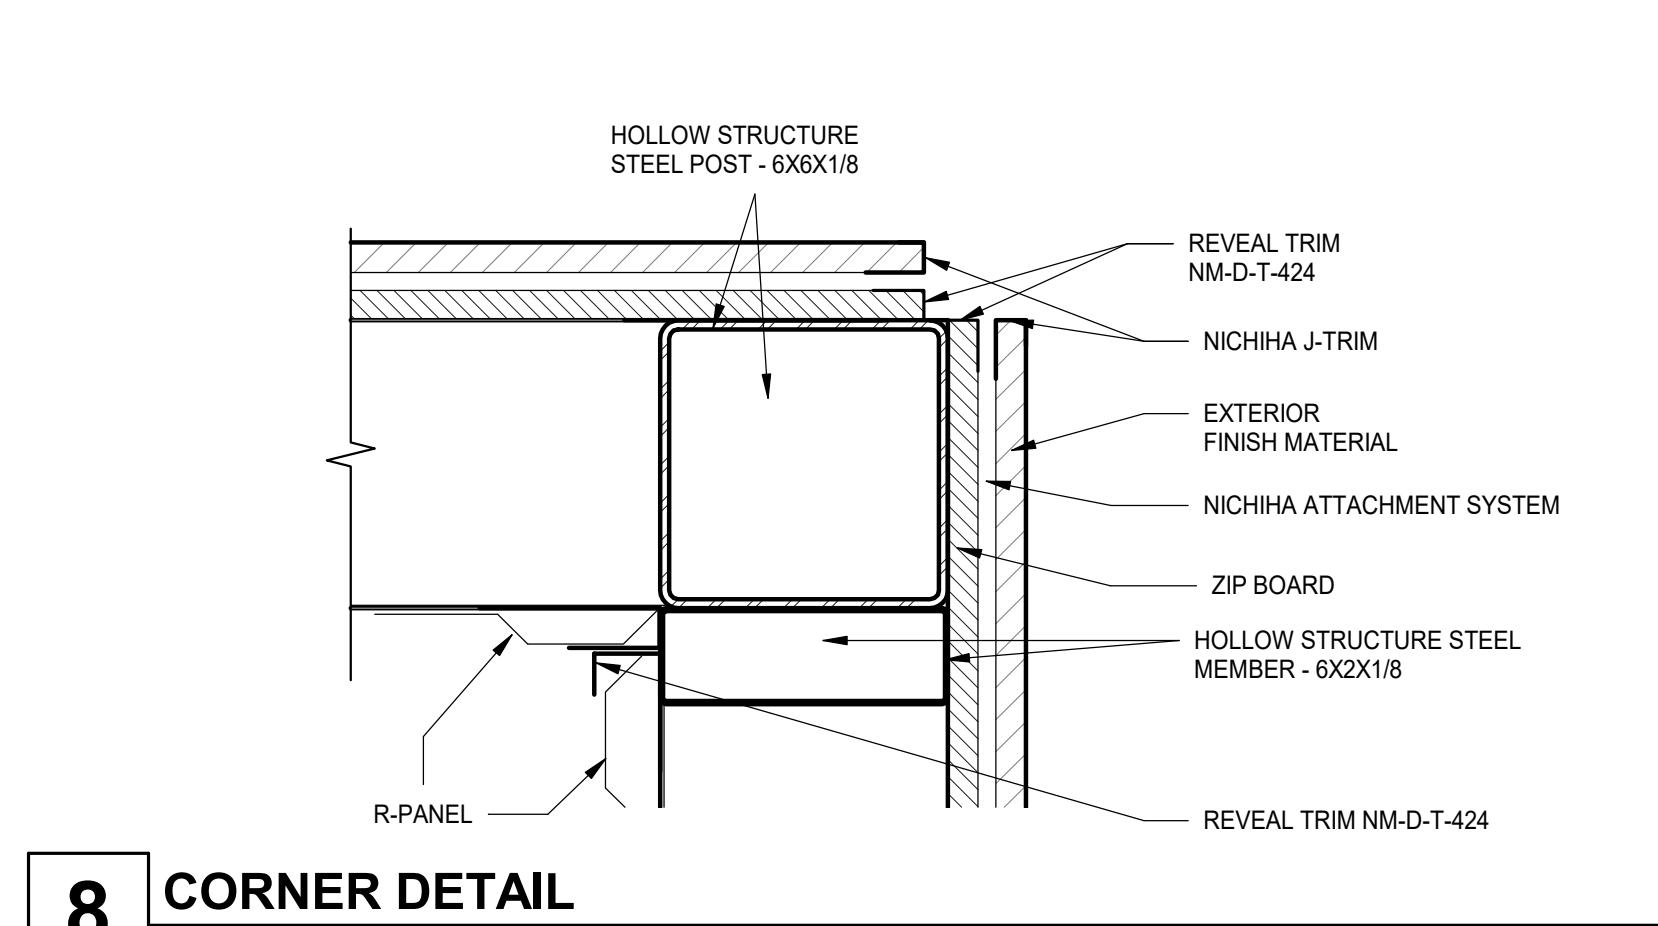


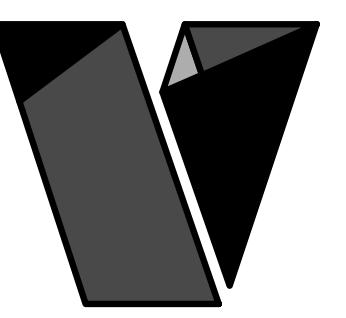

**7 TOP COPING DETAIL**

**8 CORNER DETAIL**

3" = 1'-0"




**5 DUMPSTER ELEVATION - RIGHT**

3/8" = 1'-0"





**3 DUMPSTER ELEVATION - LEFT**

3/8" = 1'-0"

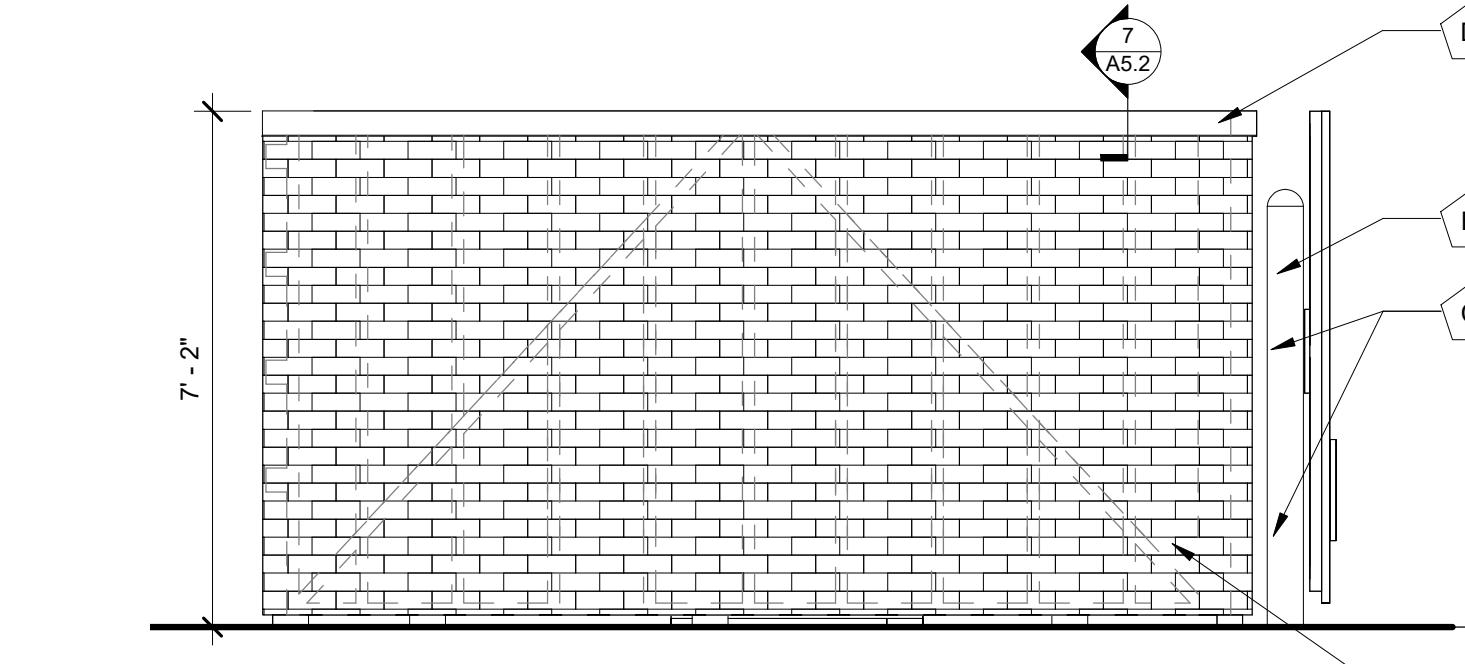

**2 DUMPSTER ELEVATION - FRONT**

3/8" = 1'-0"

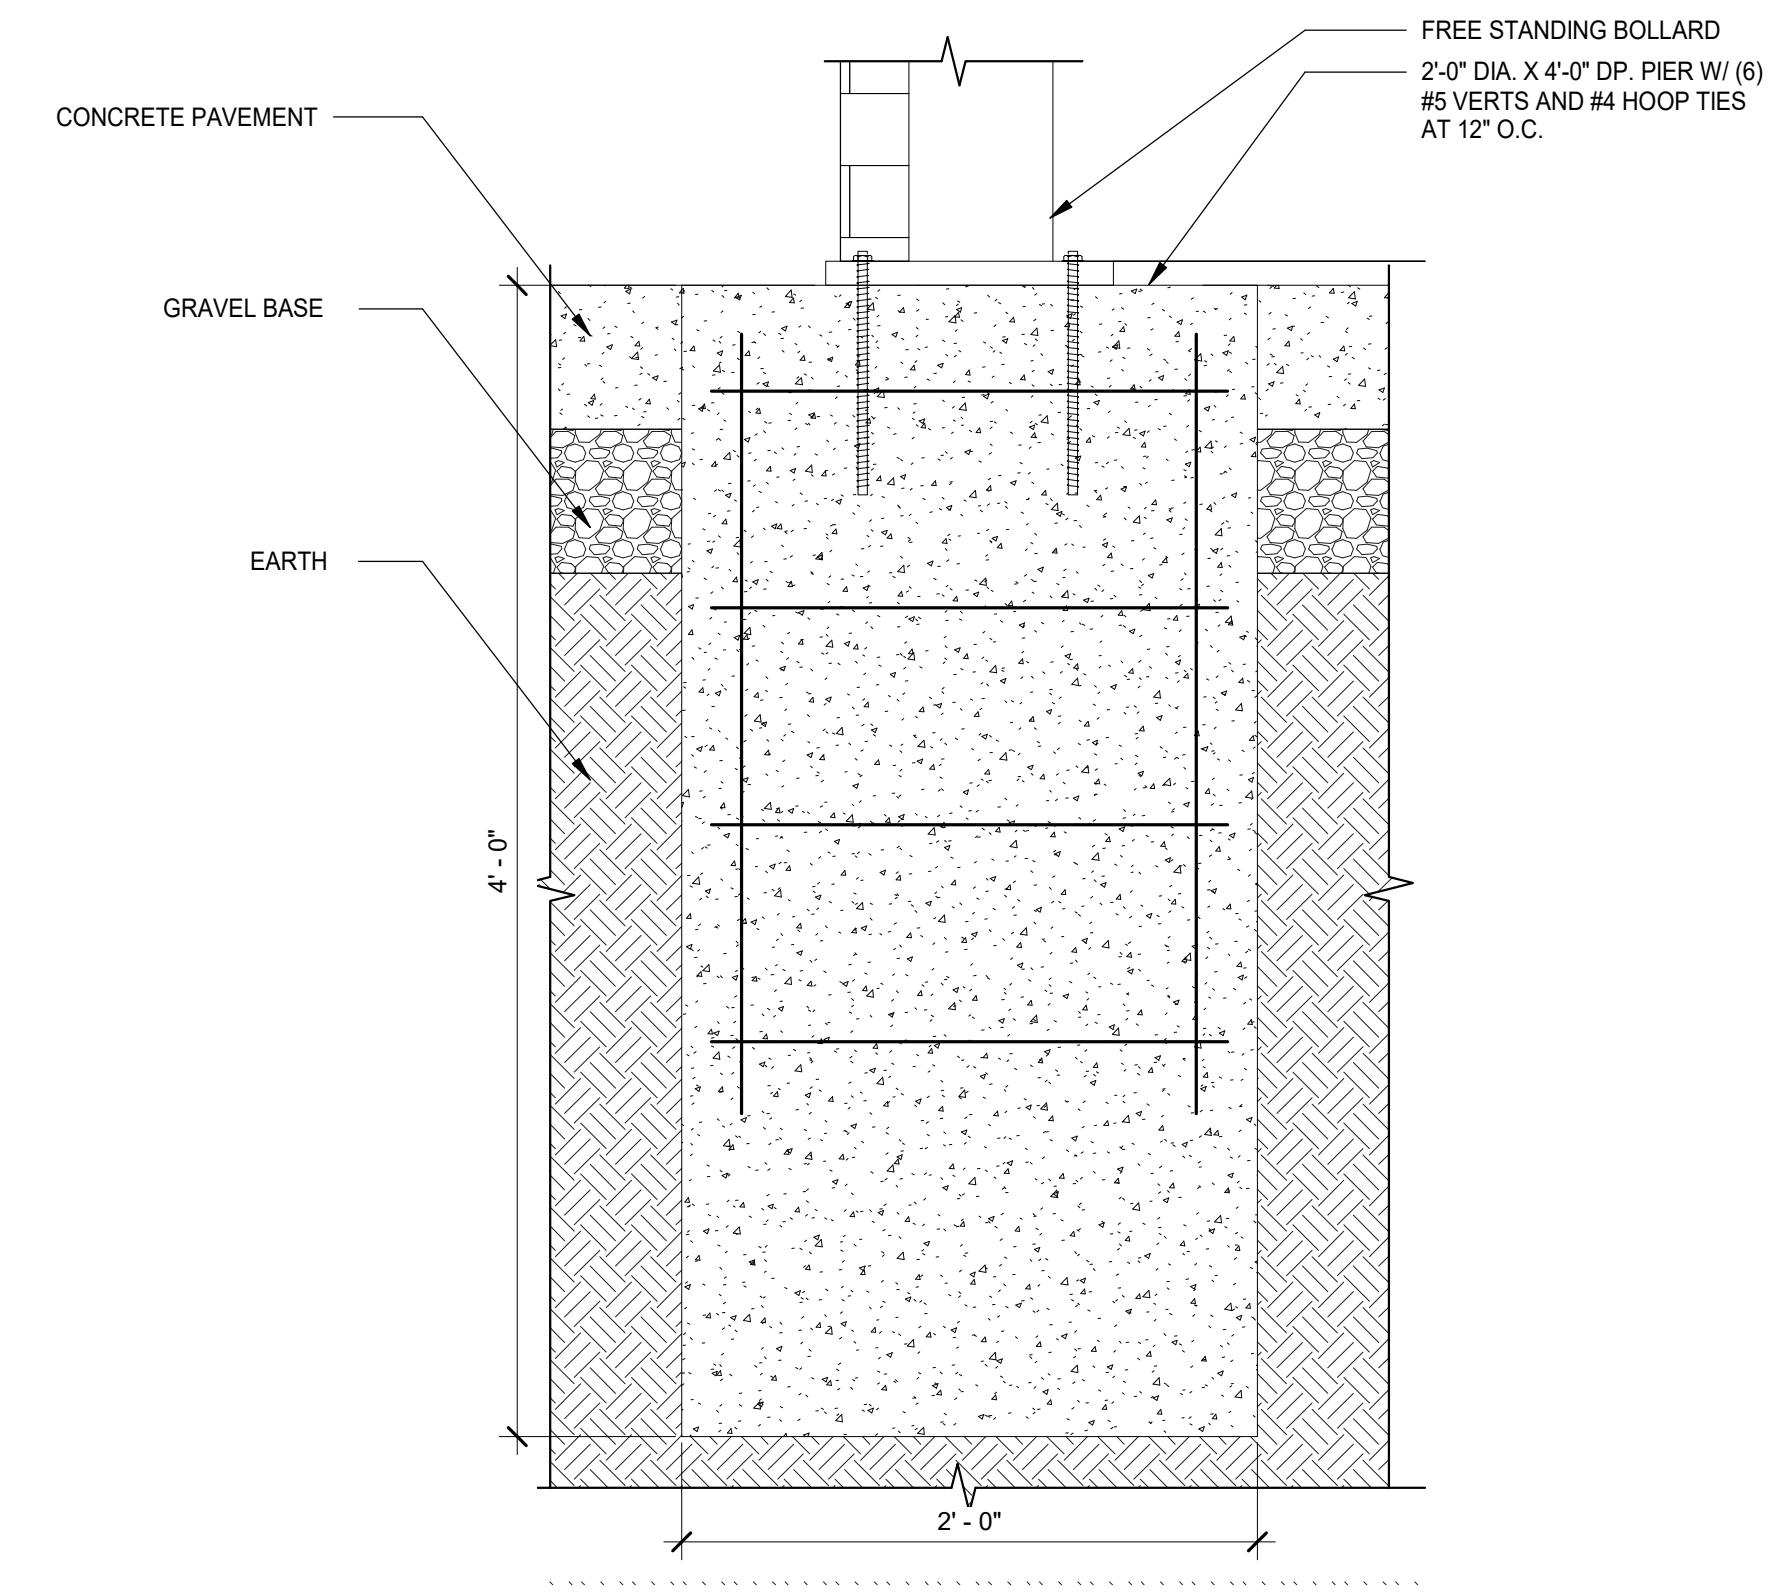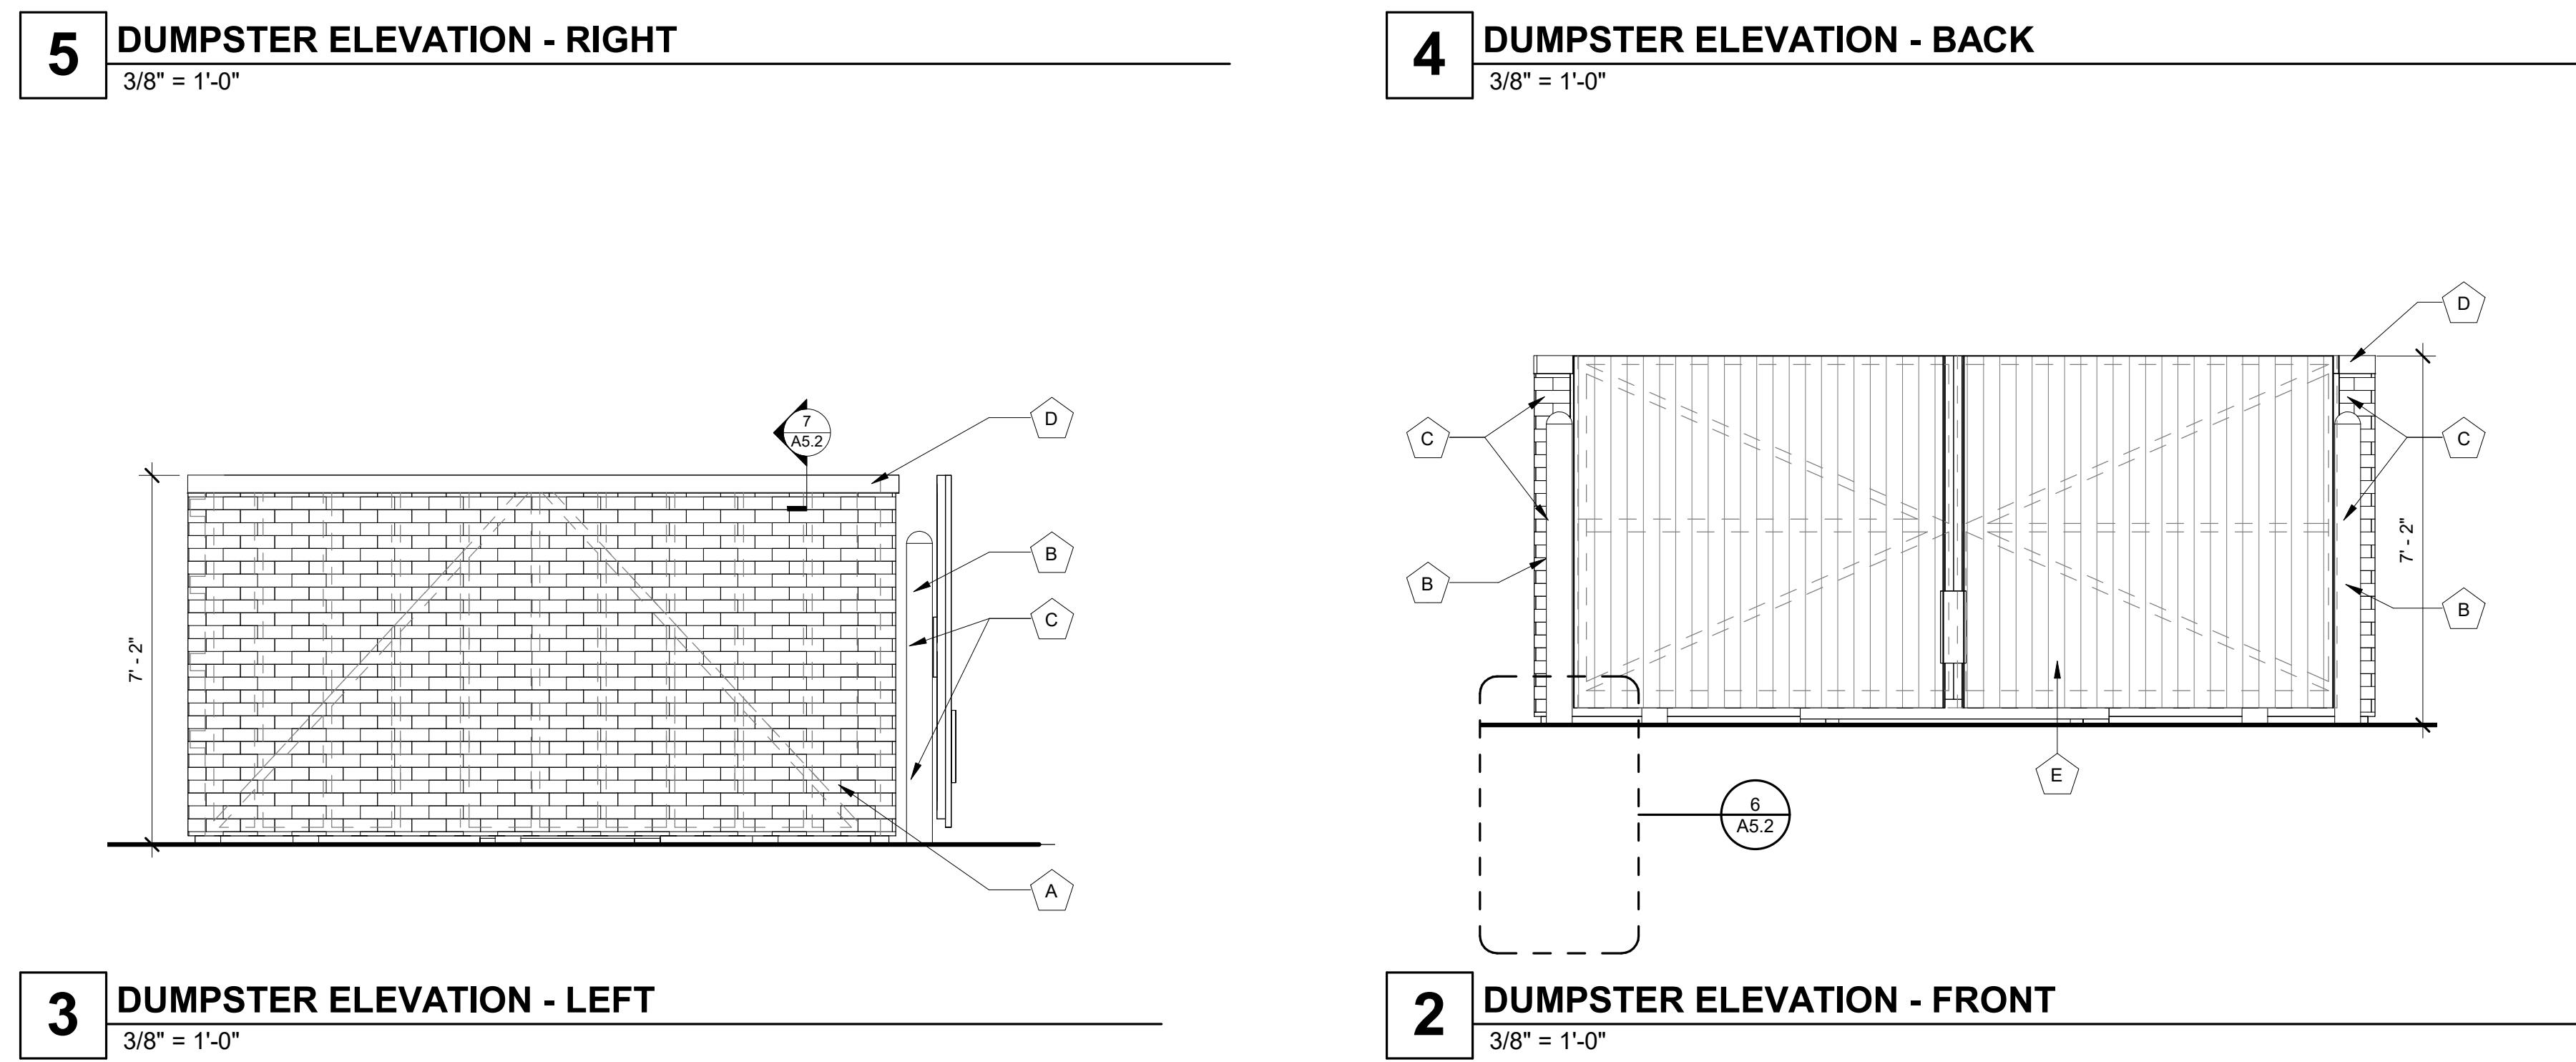


**6 BOLLARD FOUNDATION DETAIL**

1 1/2" = 1'-0"

DUMPSTER ELEVATION KEYNOTES	
NOTE NO.	NOTE TEXT
A	NICHIAH FIBER CEMENT SIDING - MIDNIGHT MODERN BRICK
B	PAINT ALL EXPOSED STEEL AND BOLLARDS WITH PT-10- SHERWIN WILLIAMS SW-9177 "SALTY DOG"
C	PAINT HINGES AND TERMINATION COPINGS PT-11- SHERWIN WILLIAMS SW-6258 "TRICORN BLACK"
D	BERRIDGE ZINC GREY COPING
E	1X6 VERTICAL CLEAR SEALED CEDAR PLANK GATE DOOR CLADDING

GENERAL NOTES:

- a. SITE WORK AND PREPARATION TO BE PERFORMED BY SITE CONTRACTOR. COORDINATE SCOPE OF WORK WITH PREFABRICATOR.
- b. COMPLETE NICHIAH SYSTEM AND ACCESSORIES INCLUDING MATCHING MANUFACTURED CORNERS, FLASHINGS AND TRIMS. INSTALL PER MANUF. INSTALLATION INSTRUCTIONS.
- c. STRUCTURE DASHED BEYOND FOR REFERENCE.

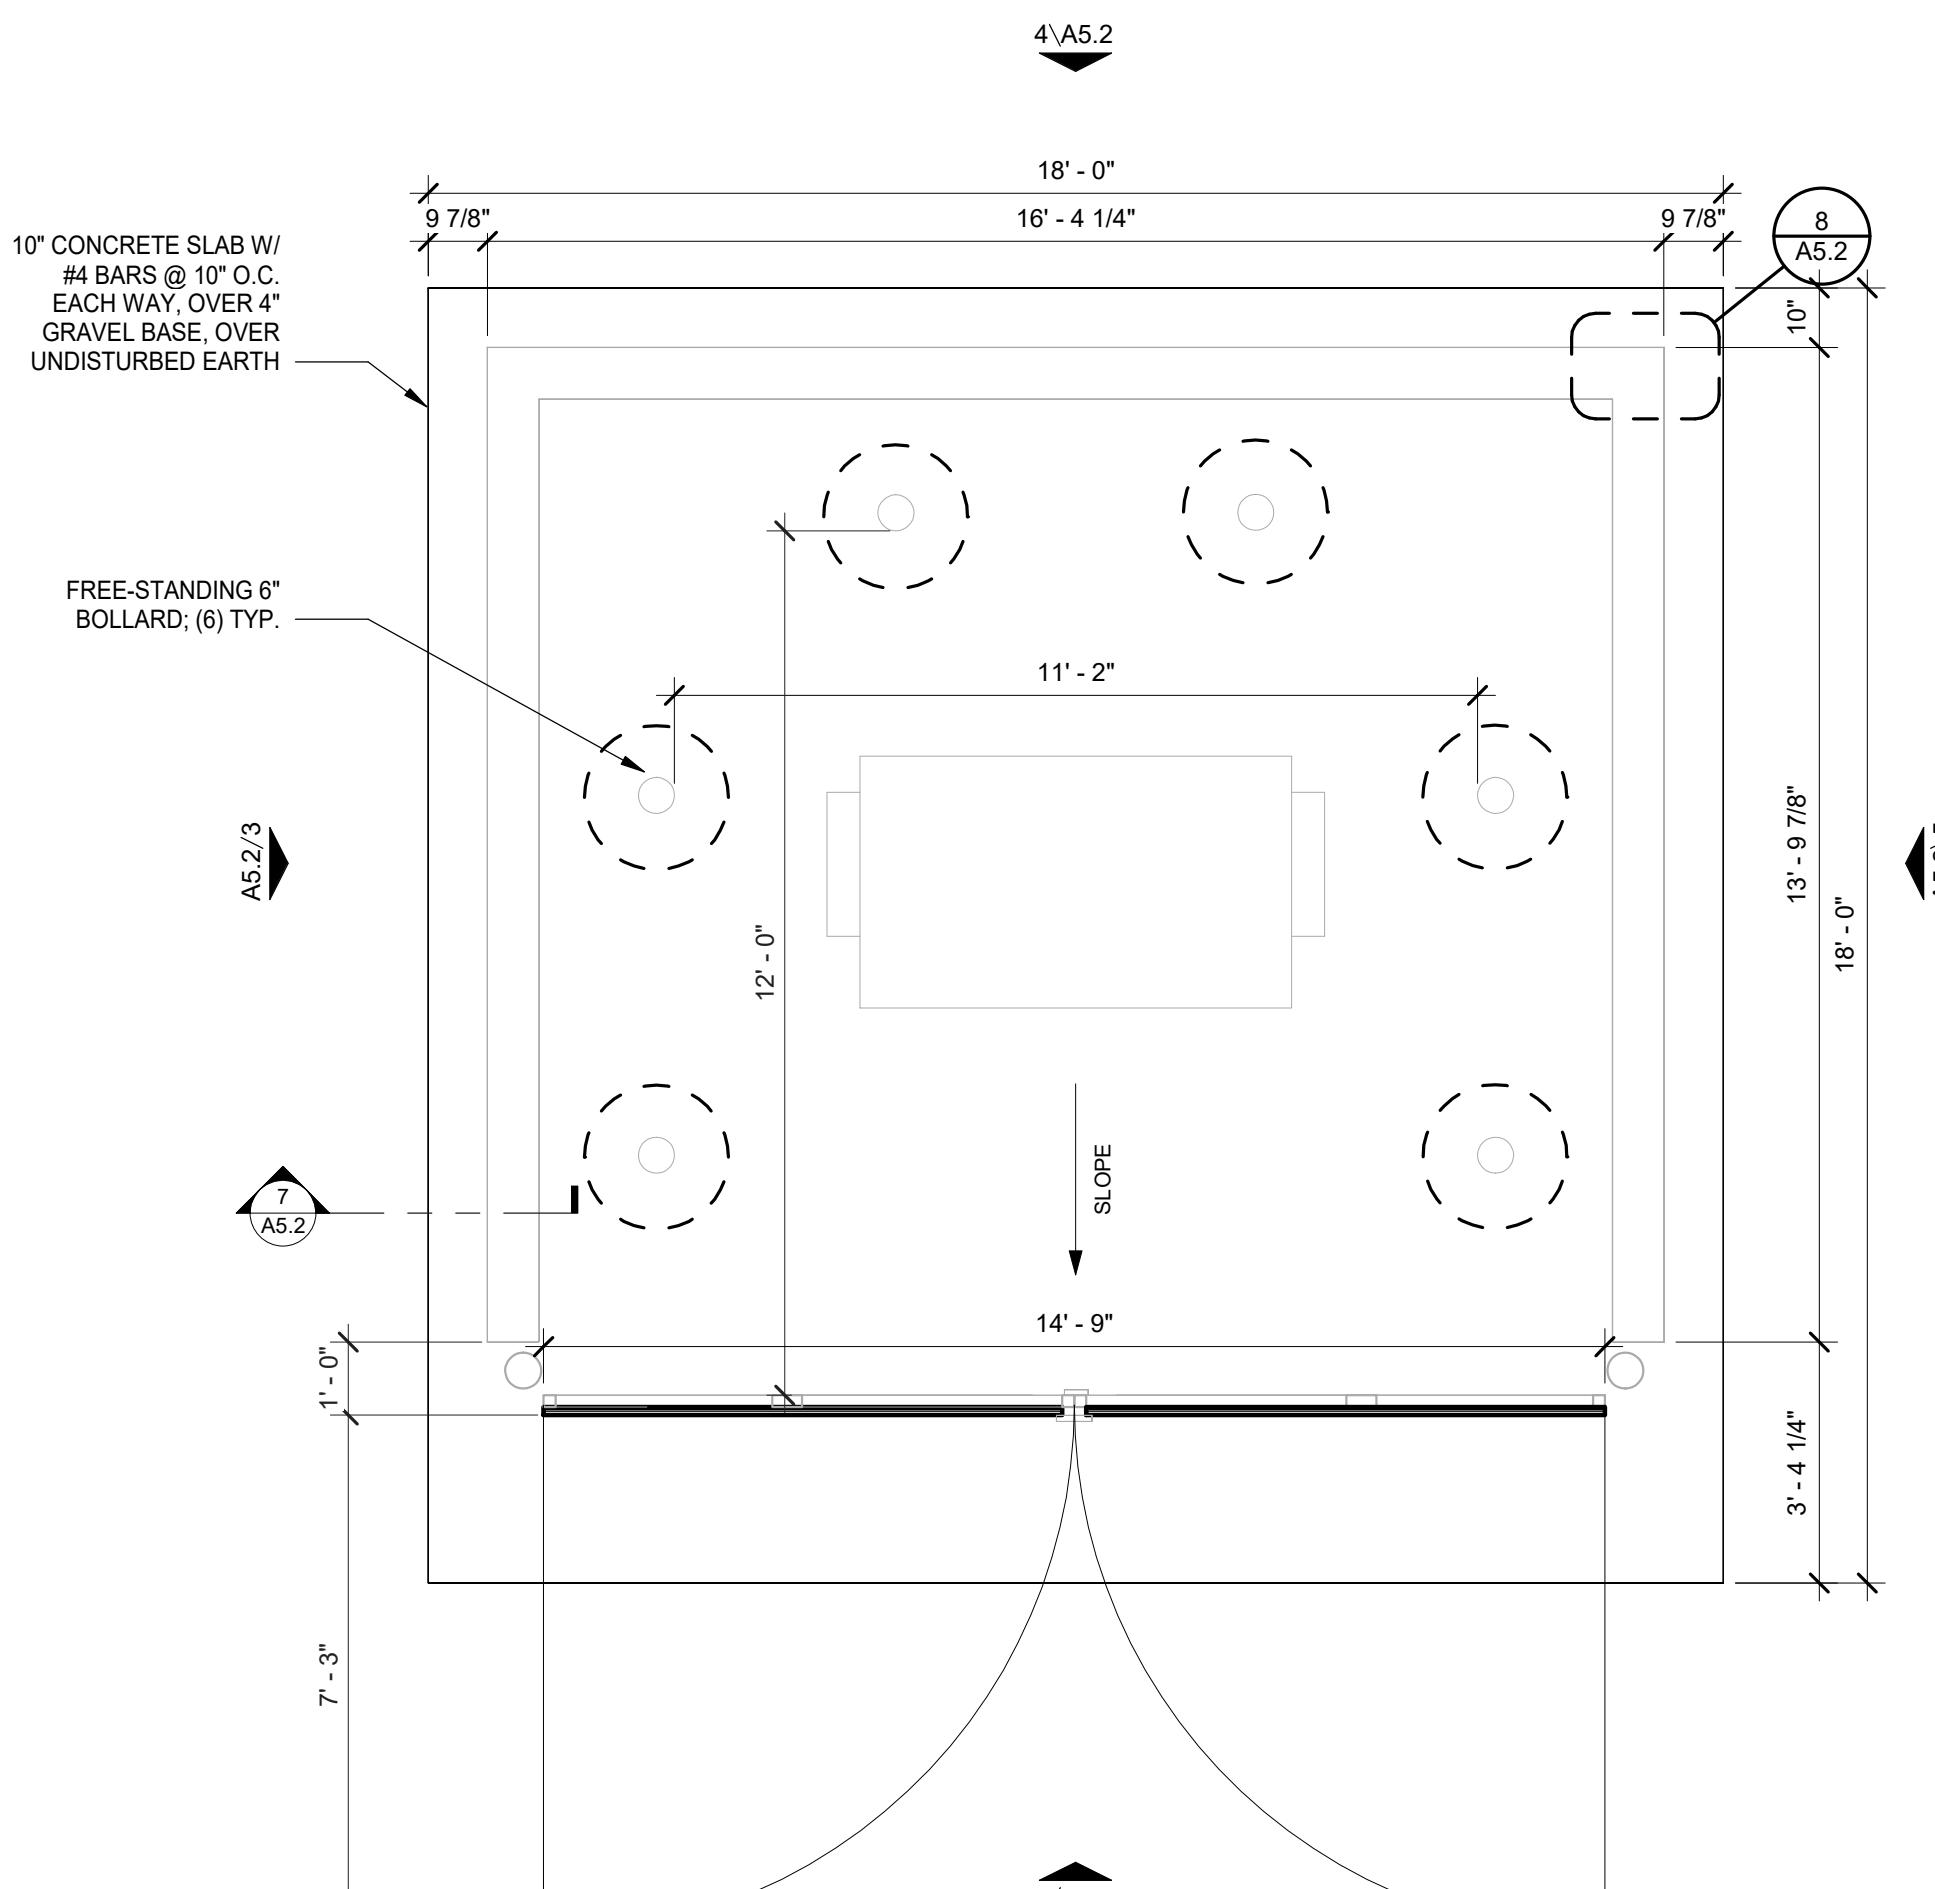

**1 DUMPSTER FLOOR PLAN**

3/8" = 1'-0"

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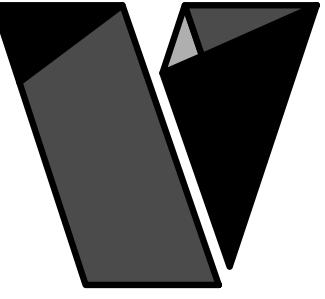
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23.26.05

sheet contents:  
TRASH ENCLOSURE

sheet no.:


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**VERTICAL METAL PANEL MP-1**

BRAND: BERRIDGE  
COLOR: ZINC GREY  
FINISH: BR-12



**BLUE METAL PANEL MP-2**

BRAND: BERRIDGE  
COLOR: ROYAL BLUE  
FINISH: LOW SHEEN SMOOTH - REFLECTIVITY .26

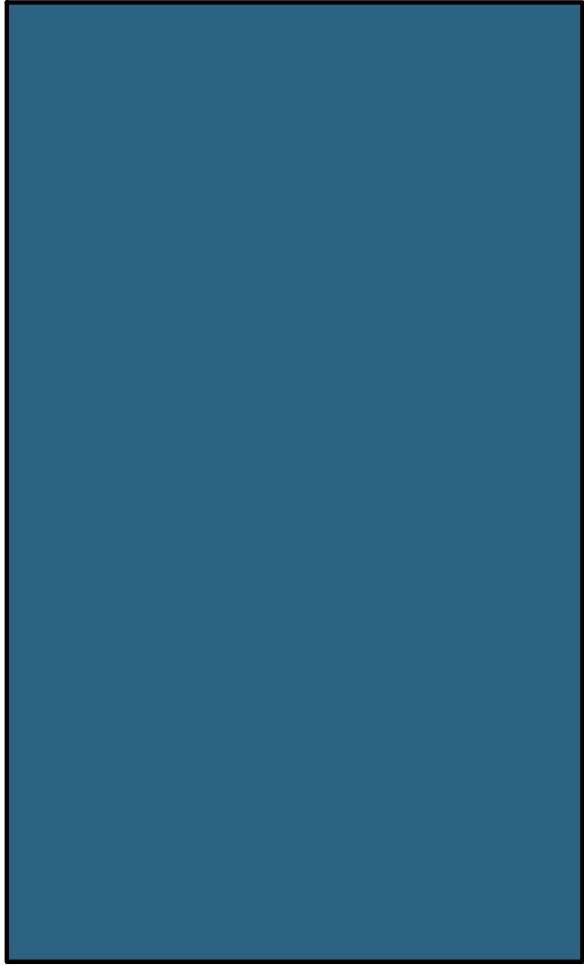

**COPING TRIM METAL MP-3**

BRAND: BERRIDGE  
COLOR: ZINC GREY  
FINISH: LOW SHEEN SMOOTH - REFLECTIVITY .39



**FIBER CEMENT PANEL SIDING - BRK-2**

BRAND: NICHIA  
COLOR: SHALE BROWN  
FINISH: CANYON BRICK



**FIBER CEMENT PANEL SIDING - BRK-1**

BRAND: NICHIA  
COLOR: MIDNIGHT  
FINISH: MODERN BRICK

23.26.05  
7 BREW DRIVE THRU -  
MADISON WI -  
WASHINGTON  
12/13/2024

MATERIAL COLOR  
BOARD



23.26.05  
7 BREW DRIVE THRU -  
MADISON WI -  
WASHINGTON

12/13/2024

RENDERS



# City of Madison Fire Department

314 W Dayton Street, Madison, WI 53703

Phone: 608-266-4420 • Fax: 608-267-1100 • E-mail: [fire@cityofmadison.com](mailto:fire@cityofmadison.com)

**Project Address:** 3915 Lien Rd, Madison, WI 53704

**Contact Name & Phone #:** Mylena Oliveria - (816) 406-2667

## FIRE APPARATUS ACCESS AND FIRE HYDRANT WORKSHEET

1. Is the building completely protected by an NFPA 13 or 13R automatic fire sprinkler system?	<input type="checkbox"/> Yes	<input checked="" type="checkbox"/> No	<input type="checkbox"/> N/A
<b>If non-sprinklered</b> , fire lanes extend to within 150-feet of all portions of the exterior wall?	<input checked="" type="checkbox"/> Yes	<input type="checkbox"/> No	<input type="checkbox"/> N/A
<b>If sprinklered</b> , fire lanes are within 250-feet of all portions of the exterior wall?	<input type="checkbox"/> Yes	<input type="checkbox"/> No	<input checked="" type="checkbox"/> N/A
2. Is the fire lane constructed of concrete or asphalt, designed to support a minimum load of 85,000 lbs?	<input type="checkbox"/> Yes	<input type="checkbox"/> No	<input checked="" type="checkbox"/> N/A
a) Is the fire lane a minimum unobstructed width of at least 20-feet?	<input type="checkbox"/> Yes	<input type="checkbox"/> No	<input checked="" type="checkbox"/> N/A
b) Is the fire lane unobstructed with a vertical clearance of at least 13½-feet?	<input type="checkbox"/> Yes	<input type="checkbox"/> No	<input checked="" type="checkbox"/> N/A
c) Is the minimum inside turning radius of the fire lane at least 28-feet?	<input type="checkbox"/> Yes	<input type="checkbox"/> No	<input checked="" type="checkbox"/> N/A
d) Is the grade of the fire lane not more than a slope of 8%?	<input type="checkbox"/> Yes	<input type="checkbox"/> No	<input checked="" type="checkbox"/> N/A
e) Is the fire lane posted as fire lane? (Provide detail of signage.)	<input type="checkbox"/> Yes	<input type="checkbox"/> No	<input checked="" type="checkbox"/> N/A
f) Is a roll-able curb used as part of the fire lane? (Provide detail of curb.)	<input type="checkbox"/> Yes	<input type="checkbox"/> No	<input checked="" type="checkbox"/> N/A
g) Is part of a sidewalk used as part of the required fire lane? (Must support +85,000 lbs.)	<input type="checkbox"/> Yes	<input type="checkbox"/> No	<input checked="" type="checkbox"/> N/A
3. Is the fire lane obstructed by security gates or barricades? If yes:	<input type="checkbox"/> Yes	<input checked="" type="checkbox"/> No	<input type="checkbox"/> N/A
a) Is the gate a minimum of 20-feet clear opening?	<input type="checkbox"/> Yes	<input type="checkbox"/> No	<input type="checkbox"/> N/A
b) Is an approved means of emergency operations installed, key vault, padlock or key switch?	<input type="checkbox"/> Yes	<input type="checkbox"/> No	<input type="checkbox"/> N/A
4. Is the Fire lane dead-ended with a length greater than 150-feet?	<input type="checkbox"/> Yes	<input type="checkbox"/> No	<input type="checkbox"/> N/A
If yes, does the area for turning around fire apparatus comply with IFC D103?	<input type="checkbox"/> Yes	<input type="checkbox"/> No	<input type="checkbox"/> N/A
5. Is any portion of the building to be used for high-piled storage in accordance with IFC Chapter 3206.6	<input type="checkbox"/> Yes	<input checked="" type="checkbox"/> No	<input type="checkbox"/> N/A
If yes, see IFC 3206.6 for further requirements.			
6. Is any part of the building <u>greater than 30-feet</u> above the grade plane?	<input type="checkbox"/> Yes	<input checked="" type="checkbox"/> No	<input type="checkbox"/> N/A
If yes, answer the following questions:			
a) Is the aerial apparatus fire lane parallel to one entire side of the building and covering at least 25% of the perimeter?	<input type="checkbox"/> Yes	<input type="checkbox"/> No	<input type="checkbox"/> N/A
b) Is the near edge of the aerial apparatus fire lane between 15' and 30' from the building?	<input type="checkbox"/> Yes	<input type="checkbox"/> No	<input type="checkbox"/> N/A
c) Are there any overhead power or utility lines located across the aerial apparatus fire lane?	<input type="checkbox"/> Yes	<input type="checkbox"/> No	<input type="checkbox"/> N/A
d) Are there any tree canopies expected to grow across the aerial fire lane? (Based on mature canopy width of tree species)	<input type="checkbox"/> Yes	<input type="checkbox"/> No	<input type="checkbox"/> N/A
e) Does the aerial apparatus fire lane have a minimum unobstructed width of 26-feet?	<input type="checkbox"/> Yes	<input type="checkbox"/> No	<input type="checkbox"/> N/A
f) Is the space between the aerial lane and the building free of trees exceeding 20' in heights?	<input type="checkbox"/> Yes	<input type="checkbox"/> No	<input type="checkbox"/> N/A
7. Are all portions of the required fire lanes within 500-feet of at least (2) hydrants?	<input type="checkbox"/> Yes	<input type="checkbox"/> No	<input checked="" type="checkbox"/> N/A
<i>Note: Distances shall be measured along the path of the hose lay as it comes off the fire apparatus.</i>			
a) Is the fire lane at least 26' wide for at least 20-feet on each side of the hydrants?	<input type="checkbox"/> Yes	<input type="checkbox"/> No	<input checked="" type="checkbox"/> N/A
b) Is there at least 40' between a hydrant and the building?	<input type="checkbox"/> Yes	<input type="checkbox"/> No	<input checked="" type="checkbox"/> N/A
c) Are the hydrant(s) setback no less than 5-feet nor more than 10-feet from the curb or edge of the street or fire lane?	<input type="checkbox"/> Yes	<input type="checkbox"/> No	<input checked="" type="checkbox"/> N/A
d) Are hydrants located in parking lot islands a minimum of 3½-feet from the hydrant to the curb?	<input type="checkbox"/> Yes	<input type="checkbox"/> No	<input checked="" type="checkbox"/> N/A
e) Are there no obstructions, including but not limited to: power poles, trees, bushes, fences, posts located, or grade changes exceeding 1½-feet, within 5-feet of a fire hydrant?	<input type="checkbox"/> Yes	<input type="checkbox"/> No	<input checked="" type="checkbox"/> N/A
<i>Note: Hydrants shall be installed and in-service prior to combustible construction on the project site.</i>			

Attach an additional sheet if further explanation is required for any answers.

This worksheet is based on **MGO 34.503** and **IFC 2021 Edition Chapter 5 and Appendix D**; please see the codes for further information.

**\*NOTE:** No fire lanes are proposed. Existing fire lane on E. Washington Avenue.

Revised 06/2022



# CITY OF MADISON LANDSCAPE WORKSHEET

Section 28.142 Madison General Ordinance

Project Location / Address 3915 Lien Rd, Madison, WI 53704

Name of Project Seven Brew Coffee (Lien Rd)

Owner / Contact Mylena Oliveira

Contact Phone (816) 406-2667 Contact Email moliveira@plazastreetpartners.com

**\*\* Landscape plans for zoning lots greater than ten thousand (10,000) square feet in size  
MUST be prepared by a registered landscape architect. \*\***

## Applicability

The following standards apply to all exterior construction and development activity, including the expansion of existing buildings, structures and parking lots, except the construction of detached single-family and two-family dwellings and their accessory structures. The entire development site must be brought up to compliance with this section unless **all** of the following conditions apply, in which case only the affected areas need to be brought up to compliance:

- (a) The area of site disturbance is less than ten percent (10%) of the entire development site during any ten-(10) year period.
- (b) Gross floor area is only increased by ten percent (10%) during any ten-(10) year period.
- (c) No demolition of a principal building is involved.
- (d) Any displaced landscaping elements must be replaced on the site and shown on a revised landscaping plan.

## Landscape Calculations and Distribution

Required landscaped areas shall be calculated based upon the total developed area of the property. Developed area is defined as that area within a single contiguous boundary which is made up of structures, parking, driveways and docking/loading facilities, but excluding the area of any building footprint at grade, land designated for open space uses such as athletic fields, and undeveloped land area on the same zoning lot. There are three methods for calculating landscape points depending on the size of the lot and Zoning District.

- (a) For all lots except those described in (b) and (c) below, five (5) landscape points shall be provided for each three hundred (300) square feet of developed area.

Total square footage of developed area 24,238

Total landscape points required 403.97

- (b) **For lots larger than five (5) acres**, points shall be provided at five (5) points per three hundred (300) square feet for the first five (5) developed acres, and one (1) point per one hundred (100) square feet for all additional acres.

Total square footage of developed area \_\_\_\_\_

Five (5) acres = 217,800 square feet

First five (5) developed acres = 3,630 points

Remainder of developed area \_\_\_\_\_

Total landscape points required \_\_\_\_\_

- (c) **For the Industrial – Limited (IL) and Industrial – General (IG) districts**, one (1) point shall be provided per one hundred (100) square feet of developed area.

Total square footage of developed area \_\_\_\_\_

Total landscape points required \_\_\_\_\_

## Tabulation of Points and Credits

Use the table to indicate the quantity and points for all existing and proposed landscape elements.

Plant Type/ Element	Minimum Size at Installation	Points	Credits/ Existing Landscaping		New/ Proposed Landscaping	
			Quantity	Points Achieved	Quantity	Points Achieved
Overstory deciduous tree	2½ inch caliper measured diameter at breast height (dbh)	35			14	490
Tall evergreen tree (i.e. pine, spruce)	5-6 feet tall	35			2	70
Ornamental tree	1 1/2 inch caliper	15				
Upright evergreen shrub (i.e. arborvitae)	3-4 feet tall	10				
Shrub, deciduous	#3 gallon container size, Min. 12"-24"	3			30	90
Shrub, evergreen	#3 gallon container size, Min. 12"-24"	4				
Ornamental grasses/ perennials	#1 gallon container size, Min. 8"-18"	2				
Ornamental/ decorative fencing or wall	n/a	4 per 10 lineal ft.				
Existing significant specimen tree	Minimum size: 2 ½ inch caliper dbh. *Trees must be within developed area and cannot comprise more than 30% of total required points.	14 per caliper inch dbh. Maximum points per tree: 200				
Landscape furniture for public seating and/or transit connections	* Furniture must be within developed area, publically accessible, and cannot comprise more than 5% of total required points.	5 points per "seat"				
<b>Sub Totals</b>						650

**Total Number of Points Provided** 650

\* As determined by ANSI, ANLA- American standards for nursery stock. For each size, minimum plant sizes shall conform to the specifications as stated in the current American Standard for Nursery Stock.

Landscaping shall be distributed throughout the property along street frontages, within parking lot interiors, as foundation plantings, or as general site landscaping. The total number of landscape points provided shall be distributed on the property as follows.

### **Total Developed Area**

Required landscaped areas shall be calculated based upon the total developed area of the property. Developed area is defined as that area within a single contiguous boundary which is made up of structures, parking, driveways and docking/loading facilities, but excluding the area of any building footprint at grade, land designated for open space uses such as athletic fields, and undeveloped land area on the same zoning lot.

### **Development Frontage Landscaping**

Landscaping and/or ornamental fencing shall be provided between buildings or parking areas and the adjacent street(s), except where buildings are placed at the sidewalk. Landscape material shall include a mix of plant materials.

### **Interior Parking Lot Landscaping**

The purpose of interior parking lot landscaping is to improve the appearance of parking lots, provide shade, and improve stormwater infiltration. **All parking lots with twenty (20) or more parking spaces** shall be landscaped in accordance with the interior parking lot standards.

### **Foundation Plantings**

Foundation plantings shall be installed along building facades, except where building facades directly abut the sidewalk, plaza, or other hardscape features. Foundation plantings shall consist primarily of shrubs, perennials, and native grasses.


### **Screening Along District Boundaries**

Screening shall be provided along side and rear property boundaries between commercial, mixed use or industrial districts and residential districts.

### **Screening of Other Site Elements**

The following site elements shall be screened in compatibility with the design elements, materials and colors used elsewhere on the site: refuse disposal areas, outdoor storage areas, loading areas, and mechanical equipment.

### **Example Landscape Plan**

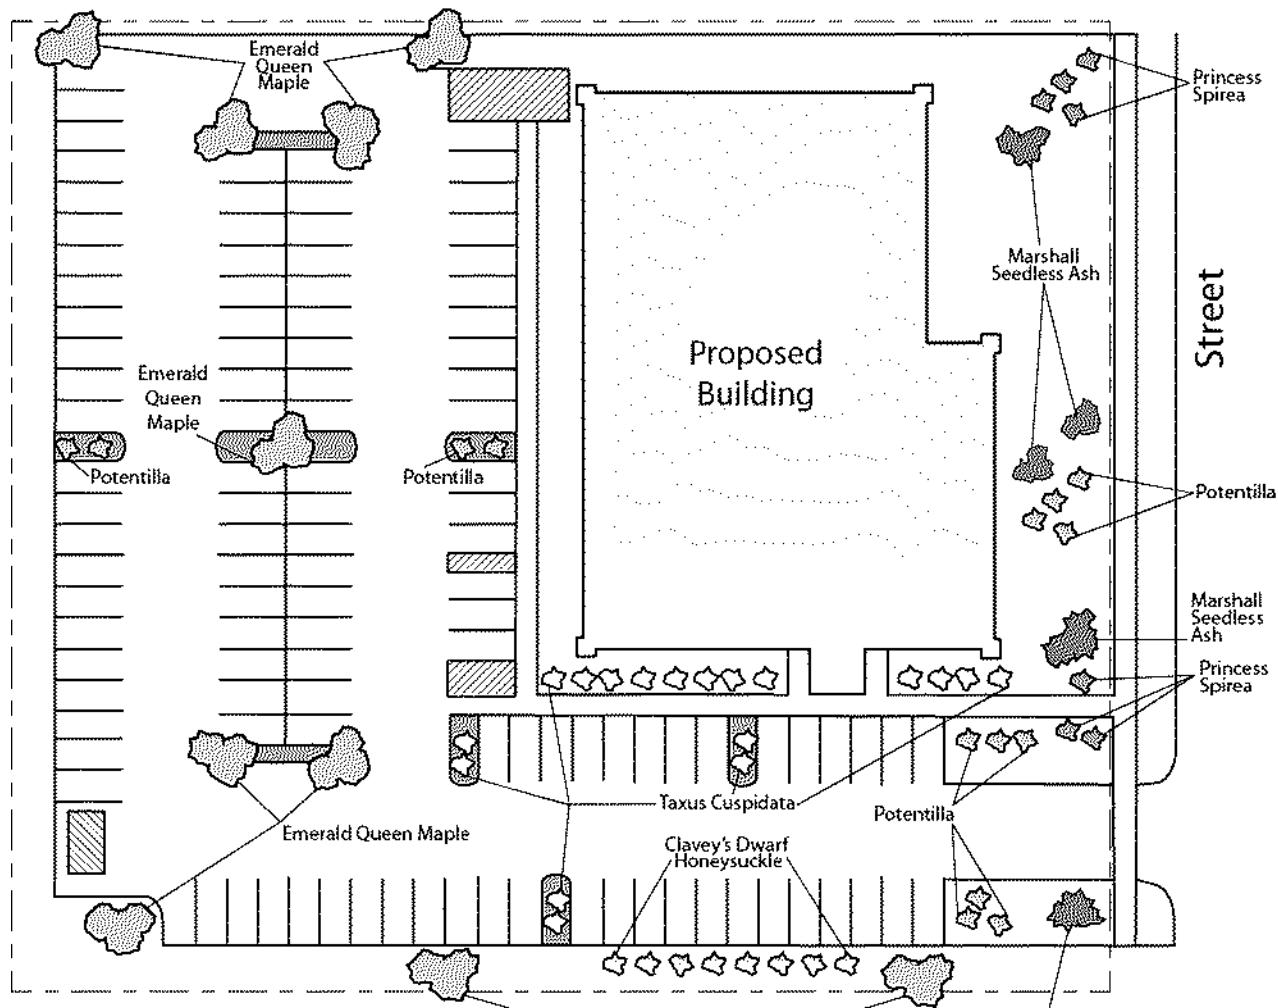

Plant Name	Size	Qty.	Pnts.
Emerald Queen Maple	2-2.5"	9	-
Marshall Seedless Ash	2-2.5"	4	450
Clavey's Dwarf Honeysuckle	1 Gal	8	24
Princess Spirea	1 Gal	7	21
Potentilla	1 Gal	10	30
Taxus Cuspidata	2 Gal	12	60
			TOTAL 585

Call City Zoning, 266-4551, with your questions about this type of plan

## LANDSCAPE PLAN AND LANDSCAPE WORKSHEET INSTRUCTIONS

Refer to Zoning Code Section 28.142 LANDSCAPING AND SCREENING REQUIREMENTS for the complete requirements for preparing and submitting a Landscape Plan and Landscape Worksheet.

### Applicability.

The following standards apply to all exterior construction and development activity, including the expansion of existing buildings, structures and parking lots, except the construction of detached single-family and two-family dwellings and their accessory structures. The entire development site must be brought up to compliance with this section unless all of the following conditions apply, in which case only the affected areas need to be brought up to compliance:

- (a) The area of site disturbance is less than ten percent (10%) of the entire development site during any ten-(10) year period.
- (b) Gross floor area is only increased by ten percent (10%) during any ten-(10) year period.
- (c) No demolition of a principal building is involved.
- (d) Any displaced landscaping elements must be replaced on the site and shown on a revised landscaping plan.

### Landscape Plan and Design Standards.

Landscape plans shall be submitted as a component of a site plan, where required, or as a component of applications for other actions, including zoning permits, where applicable. Landscape plans for zoning lots greater than ten thousand (10,000) square feet in size must be prepared by a registered landscape architect.

- (a) Elements of the landscape plan shall include the following:
  1. Plant list including common and Latin names, size and root condition (i.e. container or ball & burlap).
  2. Site amenities, including bike racks, benches, trash receptacles, etc.
  3. Storage areas including trash and loading.
  4. Lighting (landscape, pedestrian or parking area).
  5. Irrigation.
  6. Hard surface materials.
  7. Labeling of mulching, edging and curbing.
  8. Areas of seeding or sodding.
  9. Areas to remain undisturbed and limits of land disturbance.
  10. Plants shall be depicted at their size at sixty percent (60%) of growth.
  11. Existing trees eight (8) inches or more in diameter.
  12. Site grading plan, including stormwater management, if applicable.
- (b) Plant Selection. Plant materials provided in conformance with the provisions of this section shall be nursery quality and tolerant of individual site microclimates.
- (c) Mulch shall consist of shredded bark, chipped wood or other organic material installed at a minimum depth of two (2) inches.

### Landscape Calculations and Distribution.

Required landscaped areas shall be calculated based upon the total developed area of the property. Developed area, for the purpose of this requirement, is defined as that area within a single contiguous boundary which is made up of structures, parking driveways and docking/loading facilities, but **excluding** the area of any building footprint at grade, land designated for open space uses such as athletic fields, and undeveloped land area on the same zoning lot.

- (a) Landscaping shall be distributed throughout the property along street frontages, within parking lot interiors, and as foundation plantings, or as general site landscaping.
- (b) Planting beds or planted areas must have at least seventy-five percent (75%) vegetative cover.
- (c) Canopy tree diversity requirements for new trees:
  1. If the development site has fewer than 5 canopy trees, no tree diversity is required.
  2. If the development site has between 5 and 50 canopy trees, no single species may comprise more than 33% of trees.
  3. If the development site has more than 50 canopy trees, no single species may comprise more than 20% of trees.

### Development Frontage Landscaping.

Landscaping and/or ornamental fencing shall be provided between buildings or parking areas and the adjacent street(s), except where buildings are placed at the sidewalk. Landscape material shall include a mix of plant material meeting the following minimum requirements:

- (a) One (1) overstory deciduous tree and five (5) shrubs shall be planted for each thirty (30) lineal feet of lot frontage. Two (2) ornamental trees or two (2) evergreen trees may be used in place of one (1) overstory deciduous tree.
- (b) In cases where building facades directly abut the sidewalk, required frontage landscaping shall be deducted from the required point total.
- (c) In cases where development frontage landscaping cannot be provided due to site constraints, the zoning administrator may waive the requirement or substitute alternative screening methods for the required landscaping.
- (d) Fencing shall be a minimum of three (3) feet in height, and shall be constructed of metal, masonry, stone or equivalent material. Chain link or temporary fencing is prohibited.

### **Interior Parking Lot Landscaping.**

The purpose of interior parking lot landscaping is to improve the appearance of parking lots, provide shade, and improve stormwater infiltration. **All parking lots with twenty (20) or more parking spaces** shall be landscaped in accordance with the following interior parking lot standards.

- (a) For new development on sites previously undeveloped or where all improvements have been removed, a minimum of eight percent (8%) of the asphalt or concrete area of the parking lot shall be devoted to interior planting islands, peninsulas, or landscaped strips. For changes to a developed site, a minimum of five percent (5%) of the asphalt or concrete area shall be interior planting islands, peninsulas, or landscaped strips. A planting island shall be located at least every twelve (12) contiguous stalls with no break or alternatively, landscaped strips at least seven (7) feet wide between parking bays.
- (b) The primary plant materials shall be shade trees with at least one (1) deciduous canopy tree for every one hundred sixty (160) square feet of required landscaped area. Two (2) ornamental deciduous trees may be substituted for one (1) canopy tree, but ornamental trees shall constitute no more than twenty-five percent (25%) of the required trees. No light poles shall be located within the area of sixty percent (60%) of mature growth from the center of any tree.
- (c) Islands may be curbed or may be designed as uncurbed bio-retention areas as part of an approved low impact stormwater management design approved by the Director of Public Works. The ability to maintain these areas over time must be demonstrated. (See Chapter 37, Madison General Ordinances, Erosion and Stormwater Runoff Control.)

### **Foundation Plantings.**

Foundation plantings shall be installed along building facades, except where building facades directly abut the sidewalk, plaza, or other hardscape features. Foundation plantings shall consist primarily of shrubs, perennials, and native grasses. The Zoning Administrator may modify this requirement for development existing prior to the effective date of this ordinance, as long as improvements achieve an equivalent or greater level of landscaping for the site.

### **Screening Along District Boundaries.**

Screening shall be provided along side and rear property boundaries between commercial, mixed use or industrial districts and residential districts. Screening shall consist of a solid wall, solid fence, or hedge with year-round foliage, between six (6) and eight (8) feet in height, except that within the front yard setback area, screening shall not exceed four (4) feet in height. Height of screening shall be measured from natural or approved grade. Berms and retaining walls shall not be used to increase grade relative to screening height.

### **Screening of Other Site Elements.**

The following site elements shall be screened in compatibility with the design elements, materials and colors used elsewhere on the site, as follows:

- (a) **Refuse Disposal Areas.** All developments, except single family and two family developments, shall provide a refuse disposal area. Such area shall be screened on four (4) sides (including a gate for access) by a solid, commercial-grade wood fence, wall, or equivalent material with a minimum height of six (6) feet and not greater than seven (7) feet.
- (b) **Outdoor Storage Areas.** Outdoor storage areas shall be screened from abutting residential uses with a by a building wall or solid, commercial-grade wood fence, wall, year-round hedge, or equivalent material, with a minimum height of six (6) feet and not greater than seven (7) feet. Screening along district boundaries, where present, may provide all or part of the required screening.
- (c) **Loading Areas.** Loading areas shall be screened from abutting residential uses and from street view to the extent feasible by a building wall or solid, commercial-grade wood fence, or equivalent material, with a minimum height of six (6) feet and not greater than seven (7) feet. Screening along district boundaries, where present, may provide all or part of the required screening.
- (d) **Mechanical Equipment.** All rooftop and ground level mechanical equipment and utilities shall be fully screened from view from any street or residential district, as viewed from six (6) feet above ground level. Screening may consist of a building wall or fence and/or landscaping as approved by the Zoning Administrator.

### **Maintenance.**

The owner of the premises is responsible for the watering, maintenance, repair and replacement of all landscaping, fences, and other landscape architectural features on the site. All planting beds shall be kept weed free. Plant material that has died shall be replaced no later than the upcoming June 1.



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December 6<sup>th</sup>, 2024

City of Madison  
Planning Division  
Madison Municipal Building, Suite 017  
215 Martin Luther King, Jr. Blvd.  
P.O. Box 2985  
Madison, WI 53701-2985  
(608) 266-4635

**RE: 7-Brew – 3915 Lien Rd, Madison, WI 53704 (Parcel # 081033209257)**

To whom it may concern:

I, Colin M. Hooper, as Authorized Representative of Repvblik Madison Outparcels LLC, authorize Brew 4 You, LLC and their development team, Plaza Street Partners, LLC, Plaza Street Fund 350, LLC, Excel Engineering and Veritas Architecture and Design to act as Applicant and submit for any necessary governmental approvals for the proposed 7 Brew development at 3915 Lien Rd, Madison, WI 53704 (Parcel # 081033209257).

Sincerely,

Colin M. Hooper

12/11/2024

Signature

Date

Colin M. Hooper

Name, Title

Repvblik Madison Outparcels LLC  
1784 Hamilton Road  
Okemos, MI 48864