URBAN DESIGN COMMISSION APPLICATION

City of Madison **Planning Division** 126 S. Hamilton St. P.O. Box 2985 Madison, WI 53701-2985 (608) 266-4635



Complete all sections of this application, including the desired meeting date and the action requested.

If you need an interpreter, translator, materials in alternate formats or other accommodations to access these forms, please call the phone number above immediately.

FOR OFFICE USE ONLY:

Paid	Receipt #
Date received	
Received by	
Aldermanic District	
Zoning District	
Urban Design District	
Submittal reviewed by	

1. Project Information

	Add	ress:	222 N. Charte	er St	reet			
	Title	2:						
	•••				apply) and Requested Da	ate		
	UDC	Cmeeting	date requested		January 24, 2018			
🖾 New development 🛛 Alte			Alteration to an existing	Alteration to an existing or previously-approved development				
		Informat	ional		Initial approval	X	Final ap	pproval
3.	Proj	ject Type						
		Project ir	n an Urban Desig	n Dis	strict	Sig	nage	
	Project in the Downtown Core Mixed-Use District (UMX), or Mix					Compre	ehensive Design Review (CDR)	
				. ,			e Variance (i.e. modification of signage height,	
					yment Center District (SEC), CI), or Employment Campus			nd setback)
		District (E				Ot		
	X	Planned I	Development (P	D)			Please	specify
			eral Developme		. ,			
	_	•	cific Implementa					
		Planned I	Multi-Use Site o	Res	idential Building Complex			
4.	Арр	licant, Ag	gent, and Prop	erty	Owner Information			
	Арр	licant nar	me <u>Randy</u>	Bru	се	_Comp	any <u>K</u> ı	nothe & Bruce Architects, LLC
	Stre	et addres	s <u>7601 (</u>	Jniv	ersity Avenue, Suite 201	_City/S	tate/Zip	Middleton, WI 53562
	Tele	phone	608-8	36-3	3690	_Email	rbruc	e@knothebruce.com
	Proj	ject conta	ct person _sar	ne a	s applicant	Comp	any	
		et addres						
	Tele							
	Pro	perty own			Stopple Revocable			
		et addres	4000		gent Street			Madison, WI 53715
		phone		-25	1-8777			madisonproperty.com

Urban Design Commission Application (continued)

5. Required Submittal Materials

- Application Form
- Letter of Intent
 - If the project is within an Urban Design District, a summary of how the development proposal addresses the district criteria is required
 - For signage applications, a summary of how the proposed signage is consistent with the applicable CDR or Signage Variance review criteria is required.
- Development plans (Refer to checklist provided below for plan details)
- Filing fee

Electronic Submittal*

Both the paper copies and electronic copies <u>must</u> be submitted prior to the application deadline before an application will be scheduled for a UDC meeting. Late materials will not be accepted. A completed application form is required for each UDC appearance.

For projects also requiring Plan Commission approval, applicants must also have submitted an accepted application for Plan Commission consideration prior to obtaining any formal action (initial or final approval) from the UDC. All plans must be legible when reduced.

*Electronic copies of all items submitted in hard copy are required. Individual PDF files of each item submitted should be compiled on a CD or flash drive, or submitted via email to <u>udcapplications@cityofmadison.com</u>. The email must include the project address, project name, and applicant name. Electronic submittals via file hosting services (such as Dropbox.com) are not allowed. Applicants who are unable to provide the materials electronically should contact the Planning Division at (608) 266-4635 for assistance.

6. Applicant Declarations

- Prior to submitting this application, the applicant is required to discuss the proposed project with Urban Design Commission staff. This application was discussed with Chris Wells, Kevin Firchow on 9/13/2017
- The applicant attests that all required materials are included in this submittal and understands that if any required information is not provided by the application deadline, the application will not be placed on an Urban Design Commission agenda for consideration.

Applicant name Randy Bruce	Relationship	to property Architect
Authorized signature of Property Owner	1-	Date 12-01-2016
	JAMES STOPPLE	- MANAGING PAUTNE

7. Application Filing Fees

Fees are required to be paid with the first application for either initial or final approval of a project, unless the project is part of the combined application process involving the Urban Design Commission in conjunction with Plan Commission and/or Common Council consideration. Make checks payable to City Treasurer. Credit cards may be used for application fees of less than \$1,000.

Please consult the schedule below for the appropriate fee for your request:

- Urban Design Districts: \$350 (per §35.24(6) MGO).
- Minor Alteration in the Downtown Core District (DC) or Urban Mixed-Use District (UMX) : \$150 (per §33.24(6)(b) MGO)
- Comprehensive Design Review: \$500 (per §31.041(3)(d)(1)(a) MGO)
- Minor Alteration to a Comprehensive Sign Plan: \$100 (per §31.041(3)(d)(1)(c) MGO)
- All other sign requests to the Urban Design Commission, including, but not limited to: appeals from the decisions of the Zoning Administrator, requests for signage variances (i.e. modifications of signage height, area, and setback), and additional sign code approvals: \$300 (per §31.041(3)(d)(2) MGO)

A filing fee is not required for the following project applications if part of the combined application process involving both Urban Design Commission and Plan Commission:

- Project in the Downtown Core District (DC), Urban Mixed-Use District (UMX), or Mixed-Use Center District (MXC)
- Project in the Suburban Employment Center District (SEC), Campus Institutional District (CI), or Employment Campus District (EC)
- Planned Development (PD): General Development
 Plan (GDP) and/or Specific Implementation Plan (SIP)
- Planned Multi-Use Site or Residential Building Complex

Each submittal must include fourteen (14) 11" x 17" collated paper copies. Landscape and Lighting plans (if required) must be full-sized. Please refrain from using plastic covers or spiral binding.

F:\PLCOMMON\UDC\UDC APPLICATION MATERIALS - JULY 2017

The City of Madison's Urban Design Commission (UDC) has been created to:

- Encourage and promote high quality in the design of new buildings, developments, remodeling, and additions so as to maintain and improve the established standards of property values within the City.
- Foster civic pride in the beauty and nobler assets of the City, and in all other ways possible assure a functionally efficient and visually attractive City in the future.

Types of Approvals

There are three types of requests considered by the UDC:

- <u>Informational Presentation</u>. Applicants may, at their discretion, request to make an Informational Presentation to the UDC prior to seeking any approvals to obtain early feedback and direction before undertaking detailed design. Applicants should provide details on the context of the site, design concept, site and building plans, and other relevant information to help the UDC understand the proposal and provide feedback. (Does not apply to CDR's or Signage Variance requests)
- <u>Initial Approval</u>. Applicants may, at their discretion, request initial approval of a proposal by presenting preliminary design information. As part of their review, the Commission will provide feedback on the design information what should be addressed at Final Approval stage.
- <u>Final Approval</u>. Applicants may request Final Approval of a proposal by presenting all final project details. Recommendations or concerns expressed by the UDC in the initial approval must be addressed at this time.

Presentations to the Commission

Primarily, the UDC is interested in the appearance and design quality of projects. Emphasis should be given to the site plan, landscape plan, lighting plan, building elevations, exterior building materials, color scheme, and graphics.

When presenting projects to the UDC, applicants must fill out a registration slip provided in the meeting room and present it to the Secretary. Presentations should generally be limited to 5 minutes or as extended by motion by consent of the Commission. The Commission will withhold questions until the end of the presentation.

Applicants are encouraged to consider the use of various graphic presentation material including a locator map, photographs, renderings/model, scale drawings of the proposal in context with adjacent buildings/uses/signs, etc., as may be deemed appropriate to describe the project and its surroundings. Graphics should be mounted on rigid boards so that they may be easily displayed. Applicants/presenters are responsible for all presentation materials, AV equipment and easels.

URBAN DESIGN DEVELOPMENT PLANS CHECKLIST

The items listed below are minimal application requirements for the type of approval indicated. Please note that the UDC and/ or staff may require additional information in order to have a complete understanding of the project.

1. Informational Presentation

				neq	uneme	ents for All Plan Sheets
X	Locator Map	١		1.	Title	block
X	Letter of Intent (If the project is within a Urban Design District, a summary of <u>how</u>					t number h arrow
	the development proposal addresses the district criteria is required)		Providing additional information beyond these	-		e, both written and graphic
X	Contextual site information, including	>	minimums may generate	5.	Date	
	photographs and layout of adjacent buildings/structures		a greater level of feedback from the Commission.	6.	•	dimensioned plans, scaled = 40' or larger
X	Site Plan			** /	All plan	ns must be legible, including
X	Two-dimensional (2D) images of proposed buildings or structures.)			-	red landscape and lighting quired)
itial Ap	pproval					
	Locator Map)	
	Letter of Intent (If the project is within a L how the development proposal addresses		-	•		
	Contextual site information, including pho buildings/structures	oto	ographs and layout of adjace	nt		Providing additional

- □ Site Plan showing location of existing and proposed buildings, walks, drives, bike lanes, bike parking, and existing trees over 18" diameter
- □ Landscape Plan and Plant List (*must be legible*)
- Building Elevations in both black & white and color for all building sides (include material callouts)
- D PD text and Letter of Intent (if applicable)

3. Final Approval

2. In

All the requirements of the Initial Approval (see above), plus:

- Grading Plan
- □ Proposed Signage (if applicable)
- Lighting Plan, including fixture cut sheets and photometrics plan (*must be legible*)
- Utility/HVAC equipment location and screening details (with a rooftop plan if roof-mounted)
- D text and Letter of Intent (if applicable)
- Samples of the exterior building materials (presented at the UDC meeting)

4. Comprehensive Design Review (CDR) and Variance Requests (Signage applications only)

- □ Locator Map
- □ Letter of Intent (a summary of <u>how</u> the proposed signage is consistent with the CDR or Signage Variance criteria is required)
- □ Contextual site information, including photographs of existing signage both on site and within proximity to the project site
- □ Site Plan showing the location of existing signage and proposed signage, dimensioned signage setbacks, sidewalks, driveways, and right-of-ways
- □ Proposed signage graphics (fully dimensioned, scaled drawings, including materials and colors, and night view)
- D Perspective renderings (emphasis on pedestrian/automobile scale viewsheds)
- $\hfill\square$ Graphic of the proposed signage as it relates to what the Ch. 31, MGO would permit

Providing additional information beyond these minimums may generate a greater level of feedback from the Commission.



December 6, 2017

Ms. Heather Stouder Department of Planning & Development City of Madison 146 S. Hamilton Street PO Box 2985 Madison, Wisconsin 53701

Re: Letter of Intent 222 N. Charter St. KBA Project # 1304

Ms. Heather Stouder:

The following is submitted together with the plans for Plan Commission and staff review.

Organizational structure:

Owner:	Stopple Revocable Trust 1202 Regent St. Madison, WI 53715 608-268-4912 Contact: Jim Stopple jim@madisonproperty.com	Landscape Design:	Olson Toon Landscaping 4387 Schwartz Rd. Middleton, WI 53562 (608) 827-9401 Contact: Rich Carlson rich@olsontoon.com
Engineer:	Vierbicher Associates, Inc. 999 Fourier Drive, Suite 201 Madison, WI 53717 (608) 826-0532 Contact: Joe Doyle jdoy@vierbicher.com	Architect:	Knothe & Bruce Architects, LLC 7601 University Avenue, Ste 201 Middleton, WI 53562 608-836-3690 Contact: Randy Bruce <u>rbruce@knothebruce.com</u>

Introduction:

The subject property is located at 222 N. Charter St. This proposal requests a rezoning from TR-U2 zoning to Planned Development zoning to allow the development of a student housing building consistent with the Regent Street - South Campus Neighborhood Plan. The building will bring additional high-quality housing for the UW students to the edge of the UW campus and further reduce the impacts of student housing on the Vilas and Capitol neighborhoods.

An analysis of the neighborhood plan and the rationale for Planned Development zoning is included as an attachment to this letter of intent.

Project Description:

The proposed project is a 12-story student housing building located on Charter Street between W. Johnson St. and W. Dayton St. The location is ideally located to serve the UW students and allows students to walk to most of their destinations.



Letter of Intent 222 N. Charter, Madison, WI December 6, 2017 Page 2 of 3

The small site is efficiently utilized. To lighten the buildings footprint, the first floor is smaller than the upper levels and an arcade surrounds most of the west, south and east elevations. At the northeast corner of the building the arcade provides for the main pedestrians entry. At the southern face of the building the arcade forms a covered porch for the residents use taking advantage of the southern exposure and open space that the rail corridor provides. Based on feedback from the Urban Design commission, the current design brings the all-glass wall of the common room to the Charter Street face of the building and interrupting the arcade along Charter Street.

The building has a clearly defined three and four-story base defined by the smooth cast stone masonry with expansive windows. The mid-levels use an exterior of brick, architectural composite metal panels and the break from the building base is further defined along Charter Street with a one-foot offset. The top of the building is also clearly defined and covered in the architectural metal panel. The building steps back at the 12th floor to provide a common room for study and social gatherings that opens onto a generous rooftop terrace. In addition to the open space provided at the rooftop terrace and ground floor level arcade, usable balconies are provided for most apartments.

Bicycle parking is predominately located in the basement with access obtained either from the elevator or a bike ramp along the south stairway. Guest bike and moped parking is also provided under the arcade on the front and rear of the building as is a short-term loading zone on the southeast corner.

<u>Densities:</u>	
Total Lot Area	5,812 S.F. / .1334 Acres
Dwelling Units	43 units
Bedrooms	96 bedrooms
Density	322 units/acre
	719 bedrooms/acre
Lot Coverage	5,206 S.F. (89.5%)
Usable Open Space	2,772 S.F.
	,
Building Height	12 stories
5 5	
<u>Dwelling Unit Mix:</u>	
One Bedroom	11
Two Bedroom	21
Three Bedroom	I
Four Bedroom	<u>10</u>
Total Dwelling Units	43
C C	
Bicycle & Moped Parking:	
Bike Surface	4 stalls
Bike Surface Guest	4 stalls
Moped Surface	20 stalls
Bike Underground Garage – Wall Hung	42 stalls
Bike Underground Garage STD. 2'x6'	<u>40 stalls</u>
Total	110 stall

Site Development Data:

Letter of Intent 222 N. Charter, Madison, WI December 6, 2017 Page 3 of 3

Project Schedule:

It is anticipated to begin construction in Summer 2018 with completion scheduled for summer 2019.

Thank you for your time reviewing our proposal.

Sincerely,

m J. Randy Bruce, AIA Managing Member

Analysis of the Regent Street/South Campus Plan relating to a proposed development at 222 N. Charter St.

December 6, 2017 Prepared by WhiteFish Partners and Knothe & Bruce Architects for Madison Property Management


The property located on 222 N. Charter is a five bedroom house built in 1901. It is situated on a 5,800 square foot lot and is owned by Madison Property Management (MPM).



The property is currently zoned TR-U2. The current zoning, and especially the setback requirements, would limit redevelopment of that site to a three to four story building with either 6 three-bedroom units or 9 two-bedroom units; consequently, this limitation makes new construction on this site inconsistent with the goals of the neighborhood plan. In order for a project to move forward with a density that meets the goal of providing high-density housing adjacent to the UW campus, we believe a planned development zoning is necessary.

Working with Knothe & Bruce Architects, we have studied the 2007 Regent Street/South Campus plan and met with city staff, Vierbicher Consultants (who developed the plan), and Alder Wood to discuss options for the redevelopment of the site.

A fundamental strategy of the plan is the development of high density apartments north of Regent St. to provide more walkable residential choices closer to campus buildings for students. The report indicates "increasing the density of student housing north of Regent St. should serve to attract students currently living south of Regent St. which could open up the area south of Regent St. for more owneroccupancy". It also notes that "the planning area, which is one of the most convenient off-campus locations, is currently capturing less than 10% of the 35,000 students who seek offcampus housing each year." Our location is within two blocks of more than 25 different campus buildings including Union South, the Institutes for Discovery, Chemistry, the Education complex, part of the Medical School, Engineering and Computer Science. The plan also points out that, "the South Campus' main problems were incompatible land uses, underutilized land, and blighted conditions produced by dilapidated buildings...." Our project situated between Dayton and Johnson Streets responds to those issues. It is also why the plan establishes a 12 story maximum height for our zone north of Dayton Street.

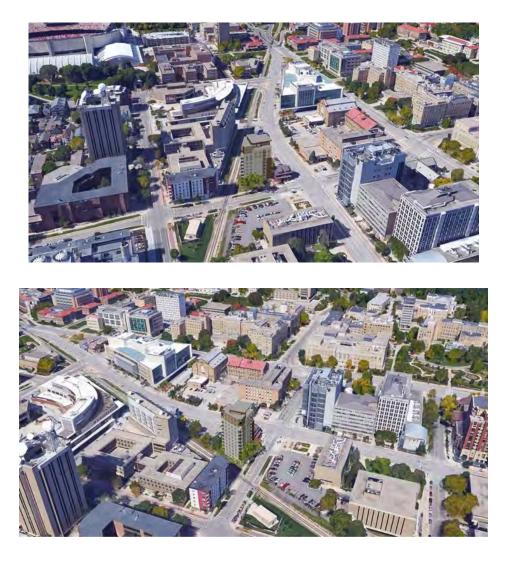


The project design incorporates the concepts of the setback and step back requirements for Charter St. in the neighborhood plan: The Charter St. profile is located on Charter St. at Spring St. That zone has an 8 story maximum height with a 10' setback and a 10' step back on the 4th floor. The Dayton St. profile has a 12 story maximum and a 10' setback with no required step back.

This project incorporates the 12 story maximum height described in the plan for this zone. It also creates a covered arcade on most of the west, south and Charter Street facades. The neighborhood plan guidelines include the 10-foot set backs for the entire building to provide for a better pedestrian experience. Our design reflects that same outcome on the first floor and then resumes the larger footprint above the ground floor. The Charter Street frontage includes a 9-foot terrace, an 8-foot sidewalk, a 3-foot setback and a 10-foot covered arcade pulling the majority of the building back 30 feet from the curb. The rail corridor arcade also creates space between the building and any eventual uses within the right of way.


These covered arcades are activated as covered building entries, plaza space for outdoor seating on the south side and as moped and bike parking on the east side. The ground floor arcade has extra height to accentuate the space created, 14 feet on the south end above the covered porch area adjacent to the rail corridor and 10 ½ feet on the north corner. The interior space will be open for a lobby and fitness area with clear views. We believe this design reflects the intent of the plan to create a high quality pedestrian experience both on Charter Street and along the rail corridor.

We have incorporated comments from the plan commission and Urban Design Commission into our proposed plan. Based on the UDC comments we have reduced the extent of the arcade along Charter Street. Attached is an alternative first floor plan that keeps the arcade along the entire Charter Street façade if the City staff and commissions prefer the full arcade.

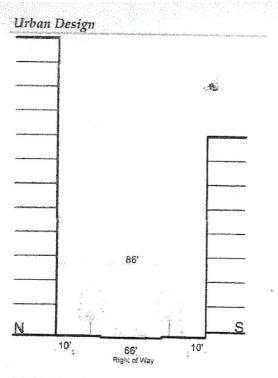


12: Dayton Street


Maximum Stories:	North side:(12
	South side: 8
Maximum Building Height:	North side: 172 feet
	South side: 116 feet
Minimum Stories:	3
Building Stepback:	None required
Building Setback:	10 feet
1997 - 19	

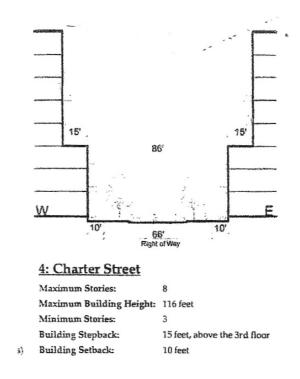

The neighborhood plan also identifies Dayton St. as the northern perceived edge between the campus and the mixed use area to the south. This is also why the area north of Dayton St., including 222 N. Charter St. is given a higher, 12 story height maximum.

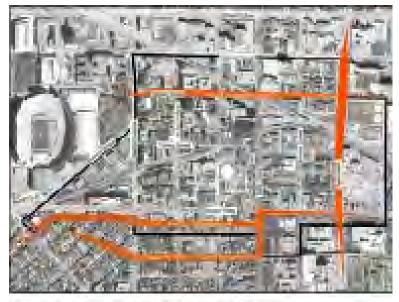

Perceived edges in the planning area.

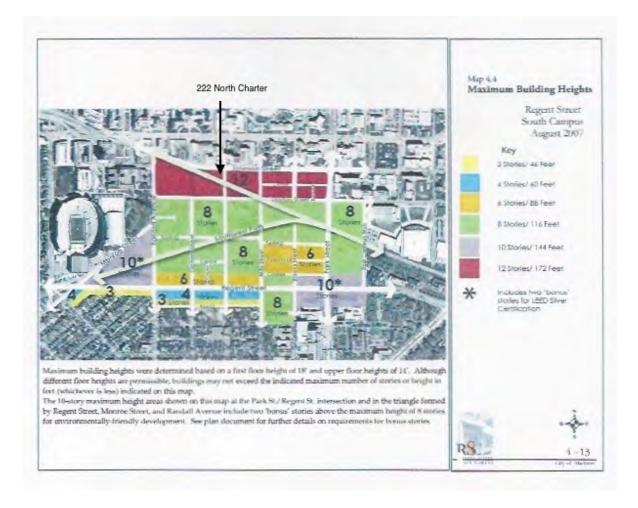

We believe that using Planned Development zoning is justified by meeting 28.098 (b) promotion of integrated land uses allowing for a mixture of residential, commercial and public facilities along corridors and in transitional areas, with enhanced pedestrian, bicycle and transit connections and (f): facilitation of high quality development that is consistent with the goals, objectives, policies and recommendations of the Comprehensive Plan and adopted neighborhood plans.

The base zoning would not allow for a replacement of the converted house built in 1901 and now a five bedroom rental property; furthermore, it meets the standard for approval of a


zoning map amendment cited in 28.098 (2) (a) 2. redevelopment of an existing area or use of an infill site that could not be reasonably developed under base zoning requirements. It significantly adds to the city tax base and, as student housing, does not create new traffic and parking demands. The extra height is compatible with the existing character of the surrounding area with the taller UW buildings of Chemistry, Computer Science, Space Science, Geology, and the Charter St. Heating Plant all within one block of the site. Private high rise student apartments also are nearby on Johnson Street.

The 2017 City Housing Strategies report supports additional high density student housing in this district.


The report recommends that the city "provide options for all students who want to live near campus to have access to well maintained housing at a variety of price points". It also "allow(s) for the development of student focused rental housing at greater density to increase affordability and the number of units in prime locations close to campus". The analysis also specifically states, "the combination of limited parking and low rates of student car ownership increase the importance of proximity to allow for walking, biking or transit for their commute." The proposed project is similar in density to the Faust project approved by the city at 311 – 313 N. Frances St. that had a density of 343 du/ac and 764 br/ac. We propose a 12 story, 130 foot tall building with 43 units and 96 bedrooms.

This site and planned project is ideally located to meet the objectives in this year's report.



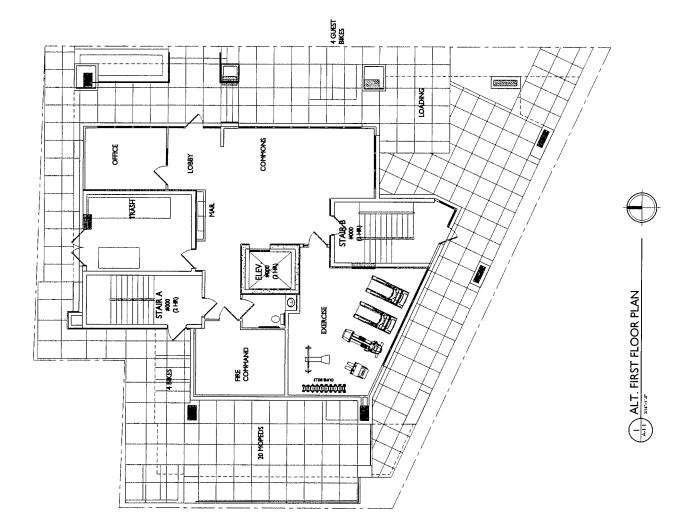




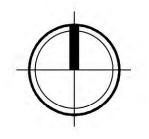



Aerial Site Plan N. Charter Street




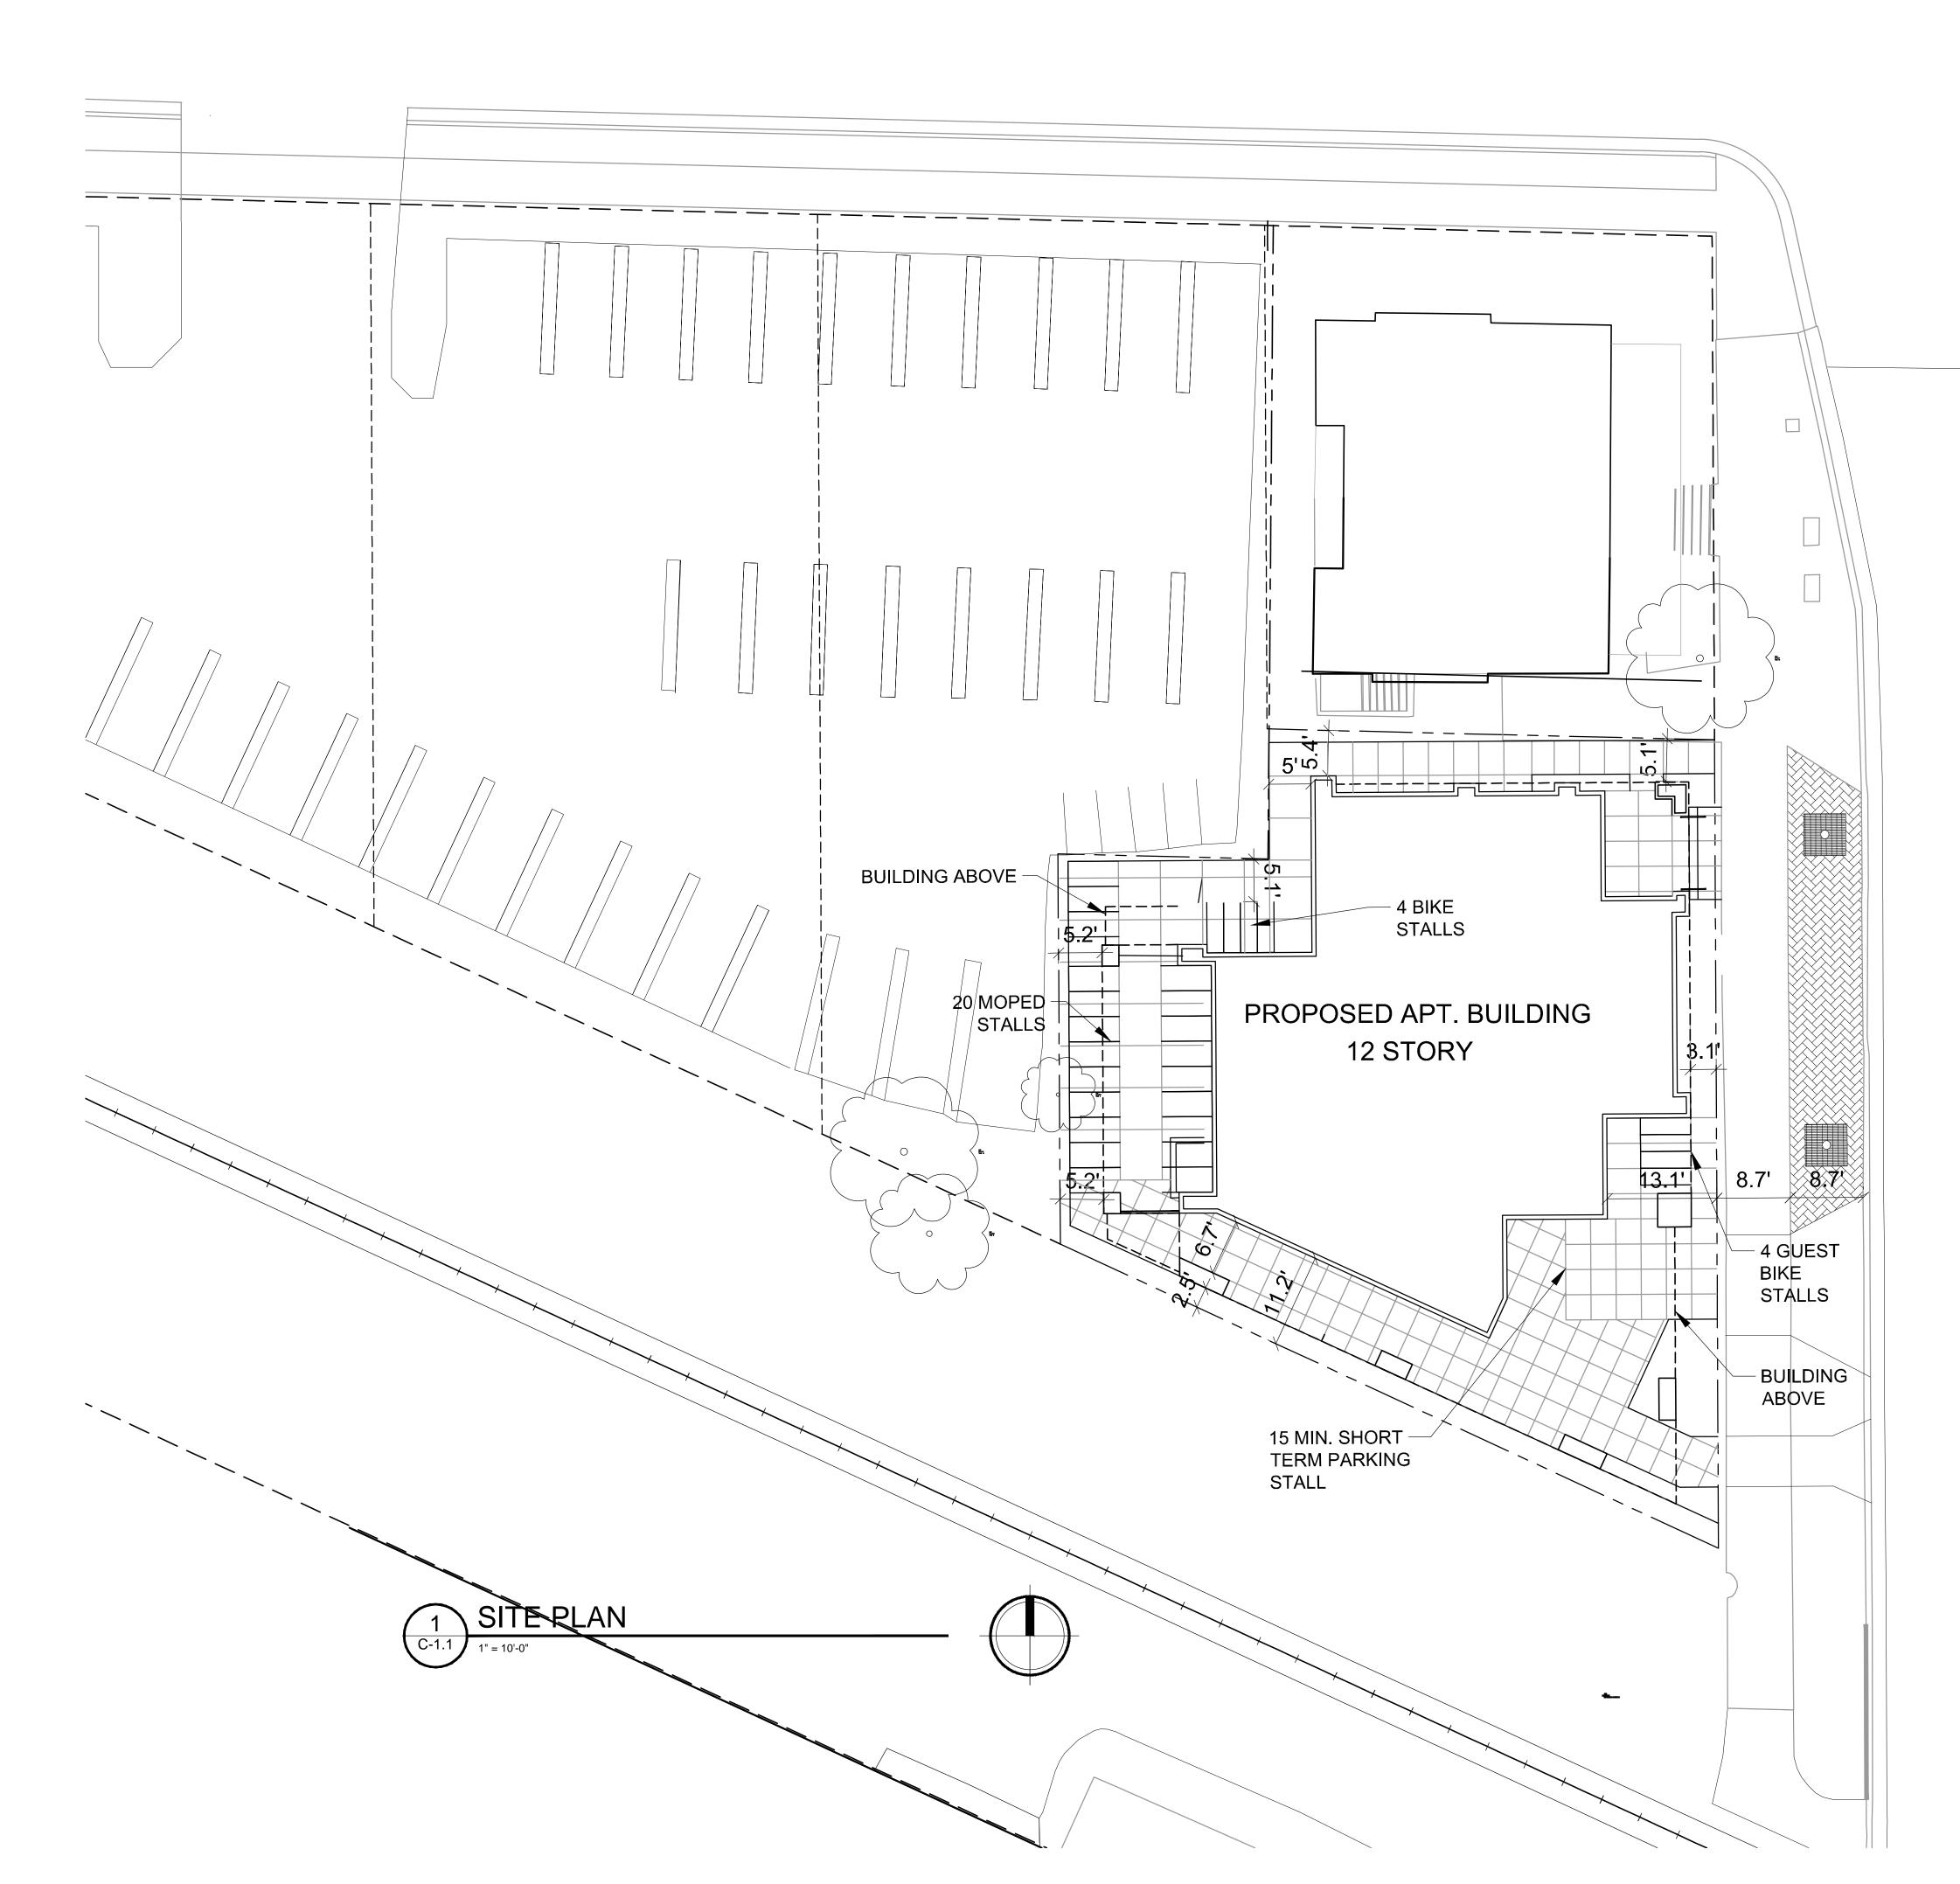

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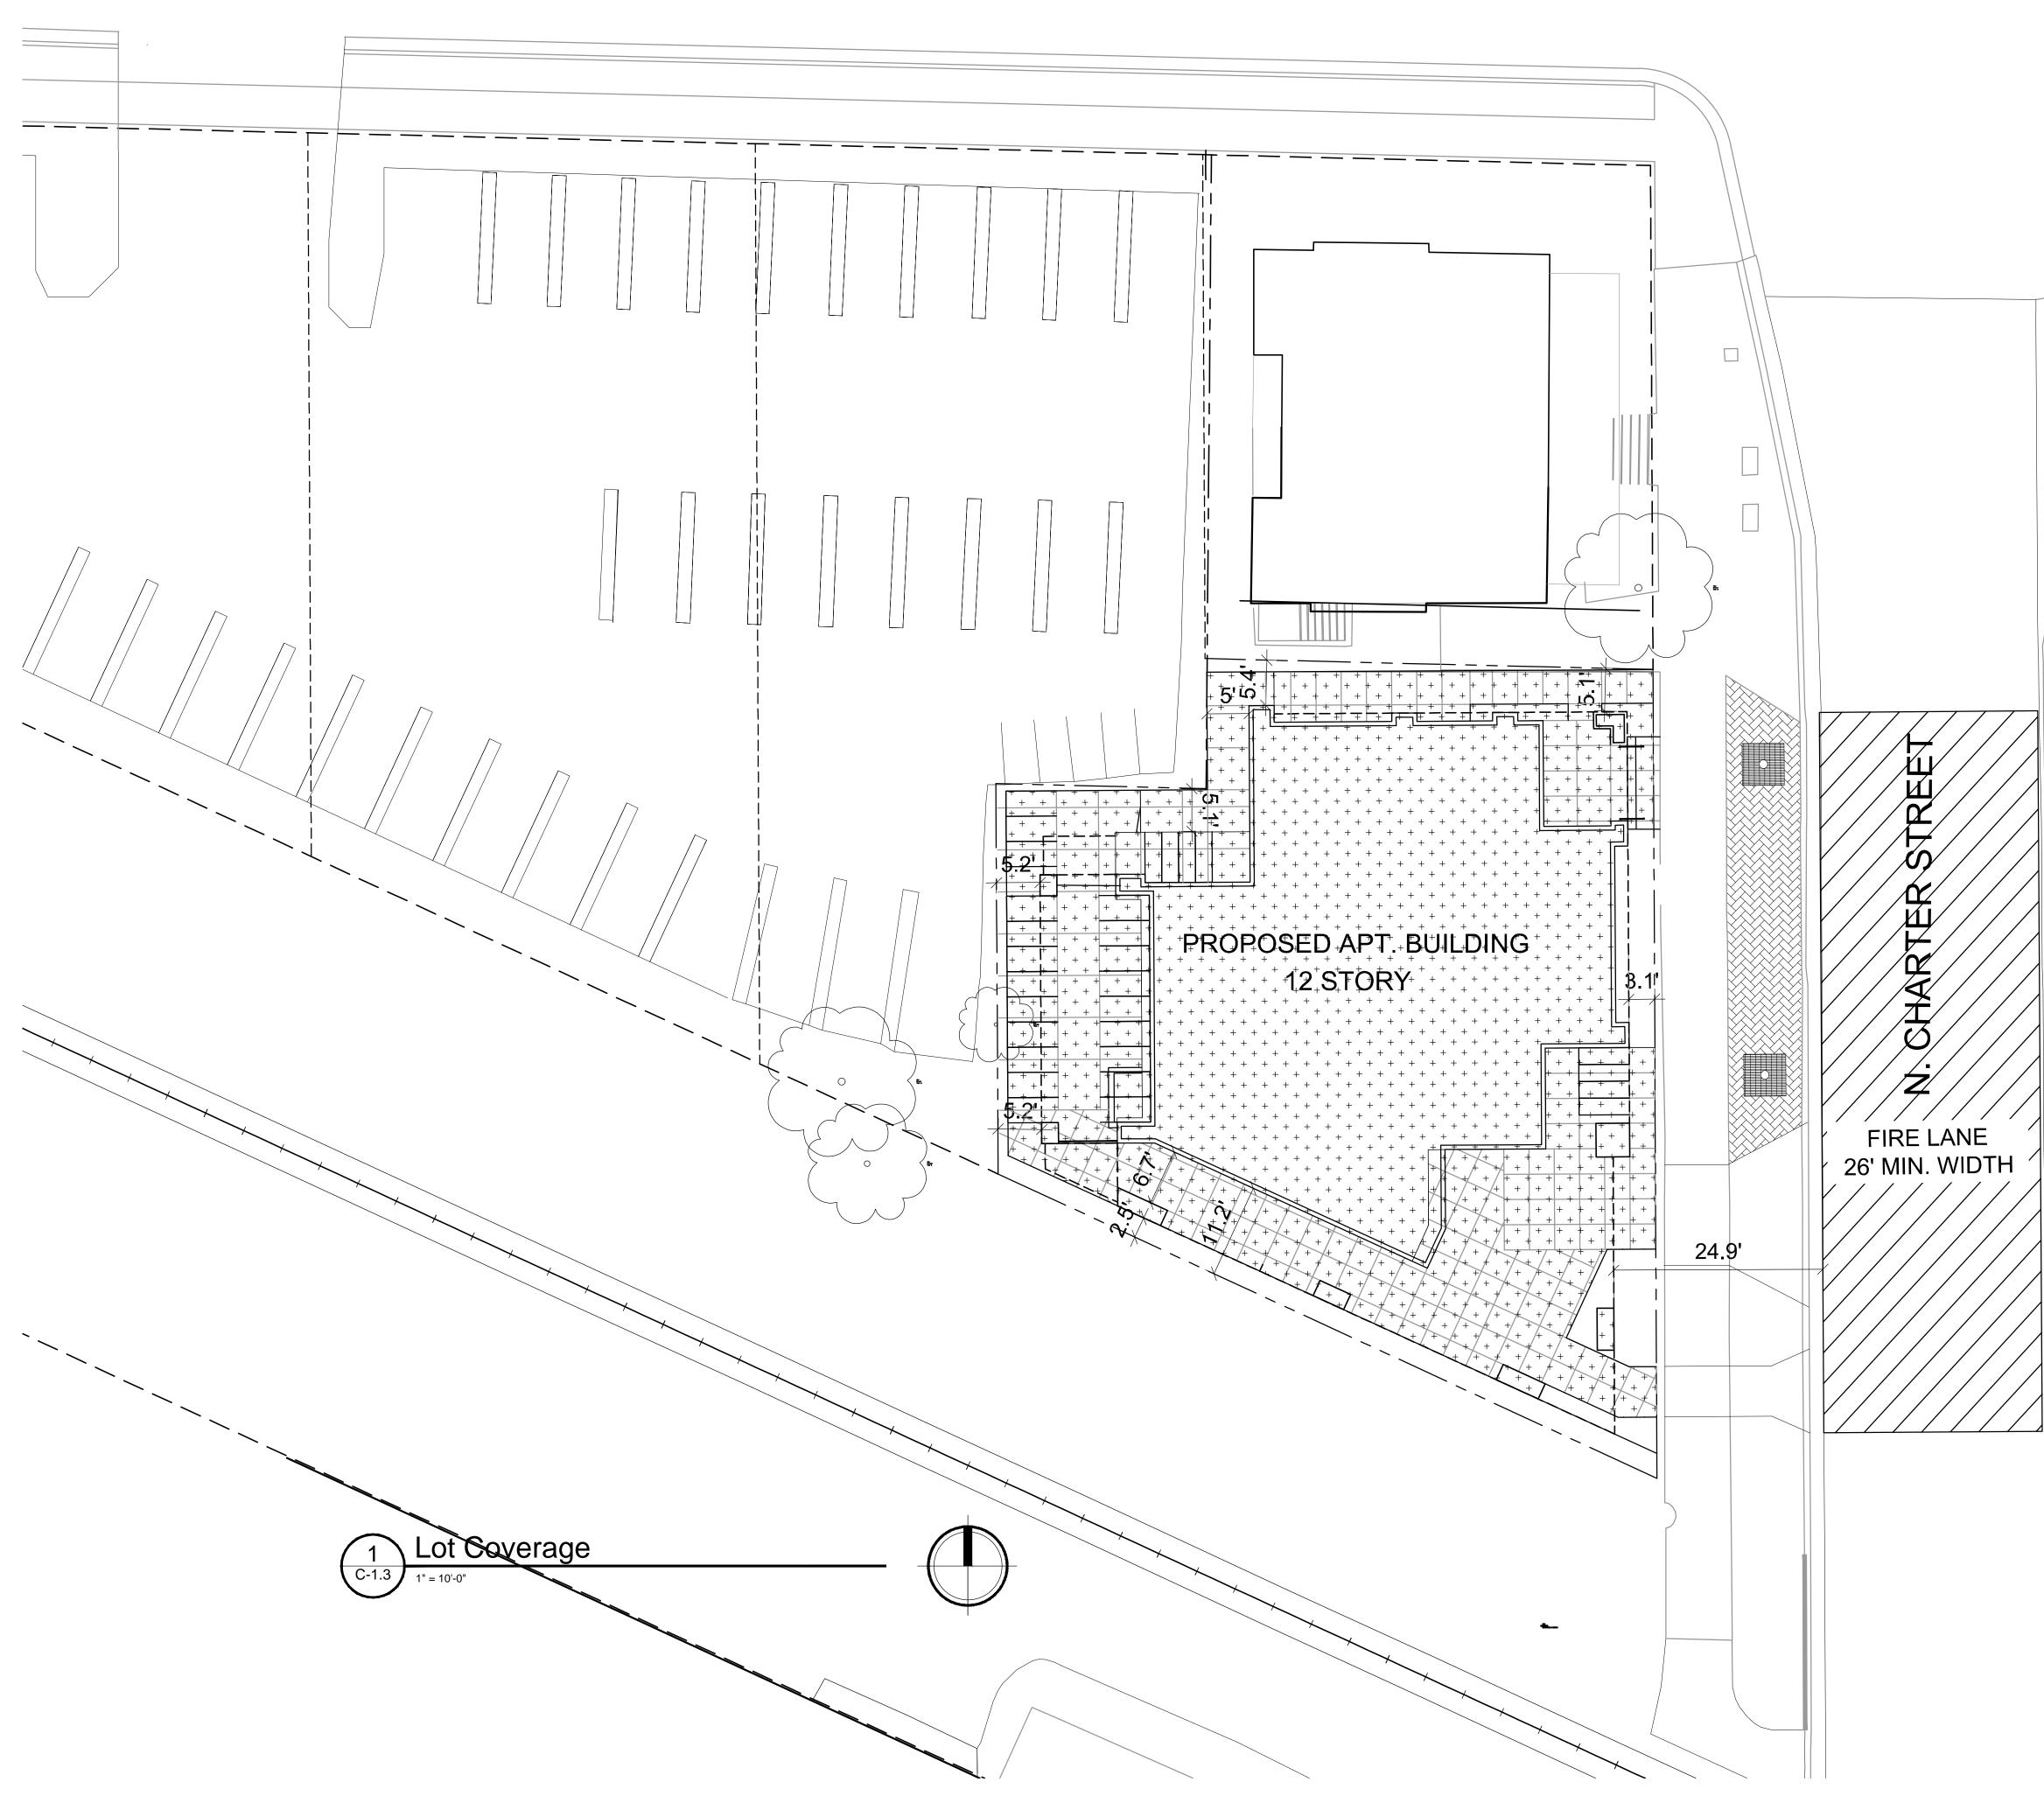
ISSUED Issued Land Use Submittal - Dec. 6, 2017

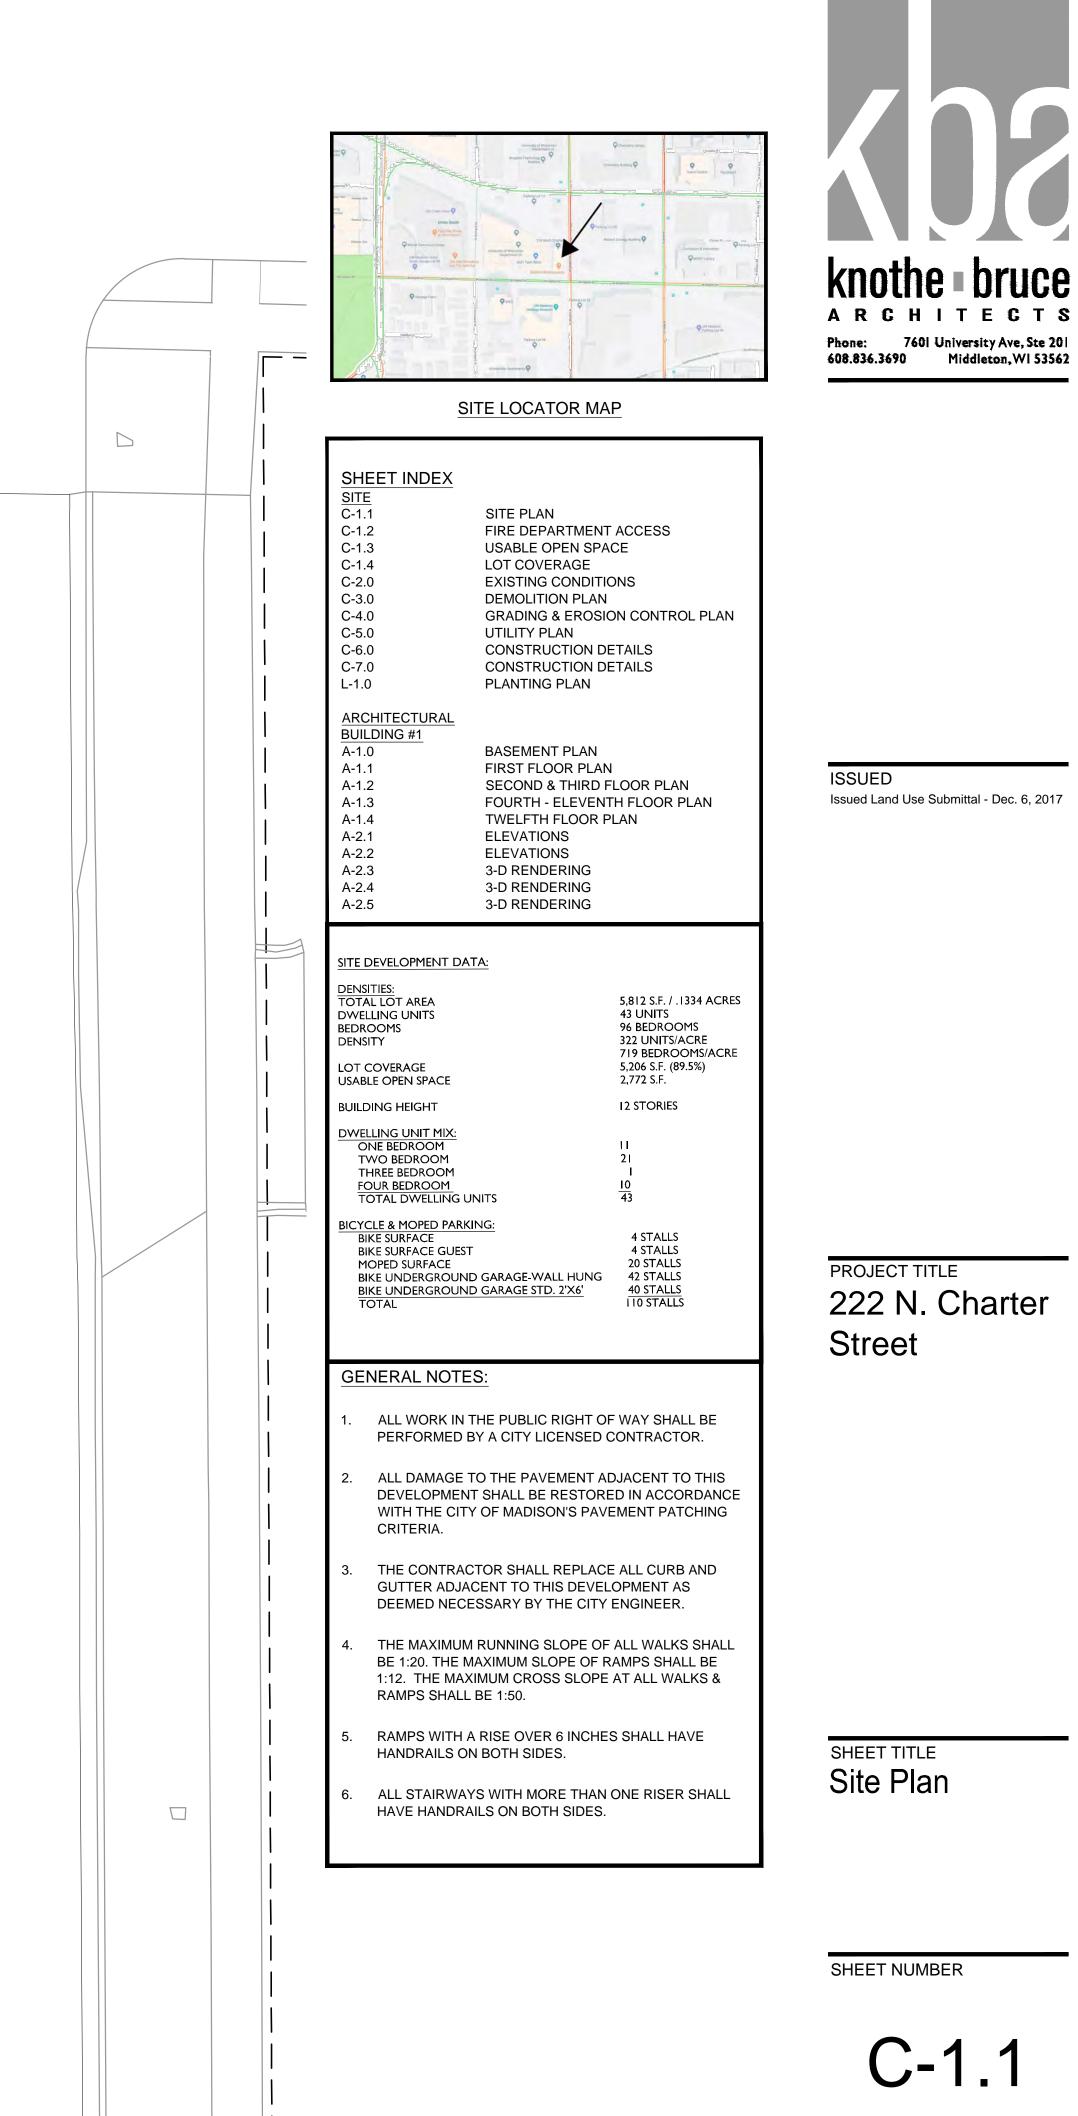PROJECT TITLE 222 N. Charter Street

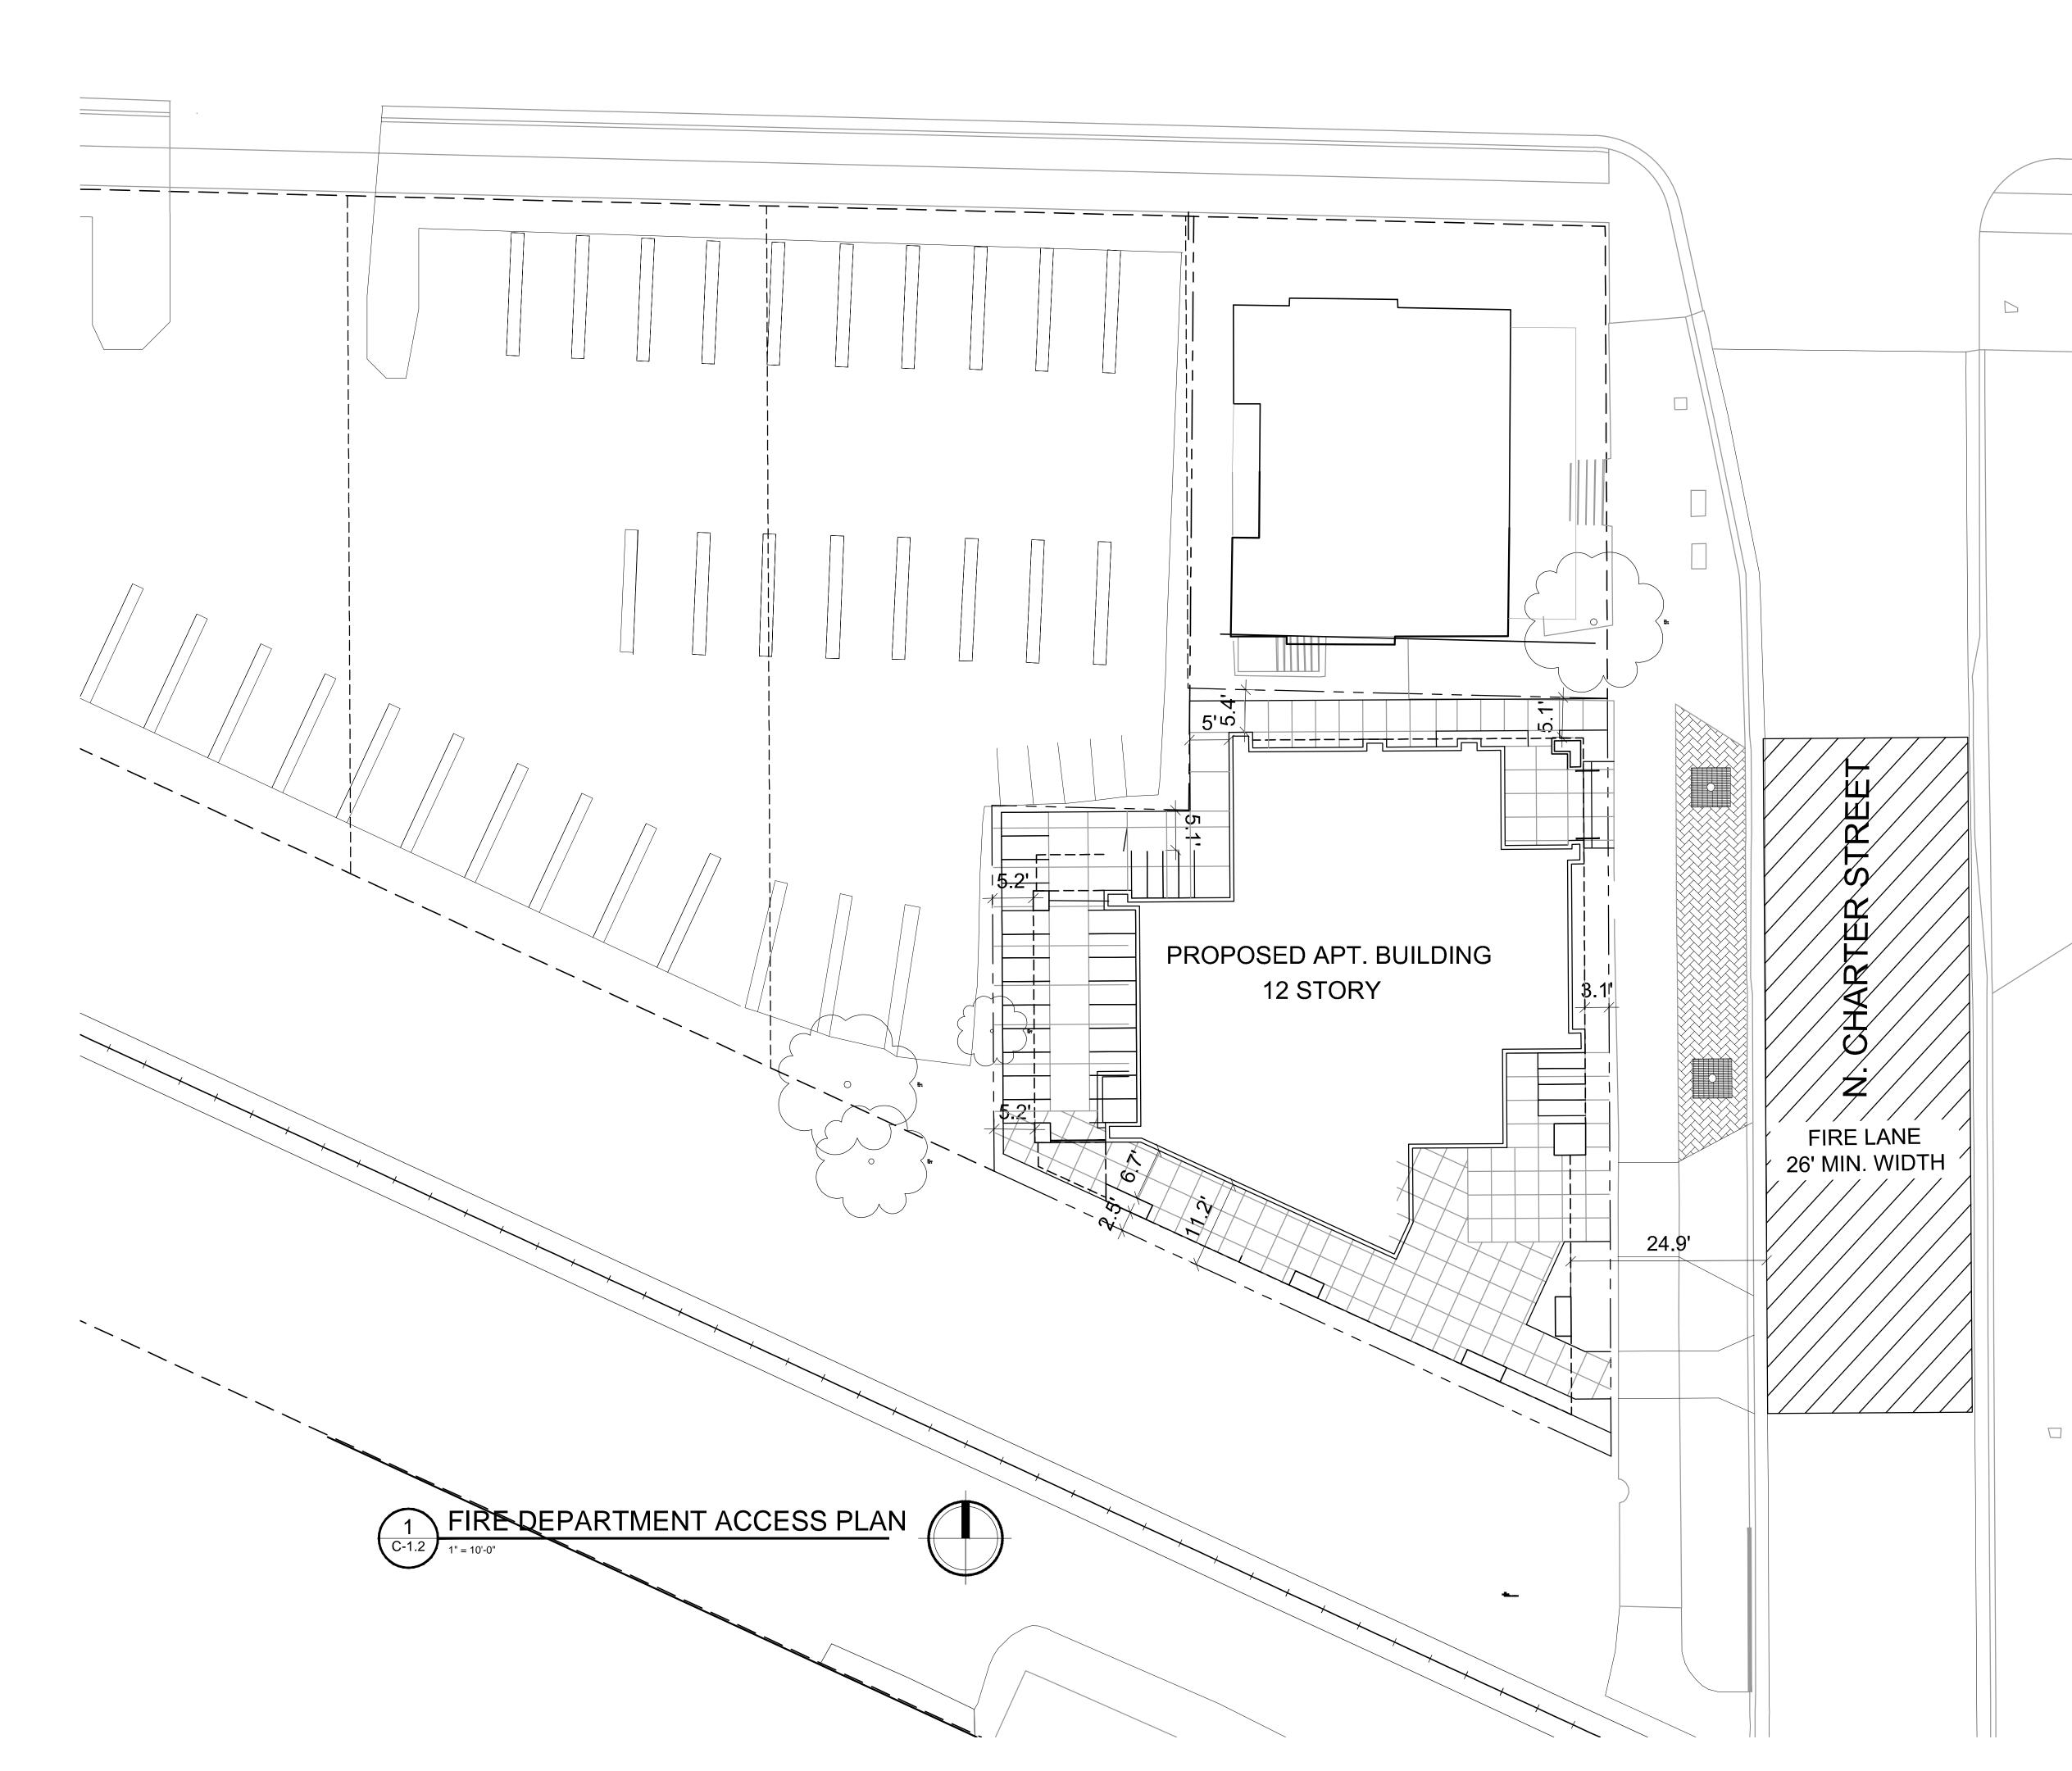SHEET TITLE Fire Department Access Plan

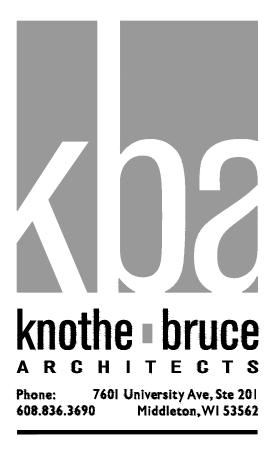
SHEET NUMBER


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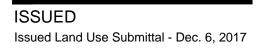


LOT COVERAGE

TOTAL LOT AREA = 5,812 SF LOT COVERAGE = 5,206 SF (89.5%)



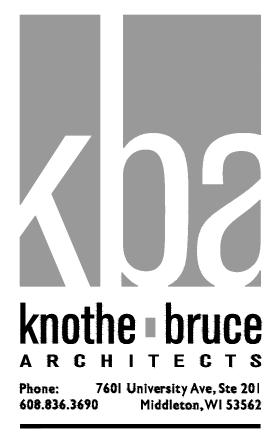

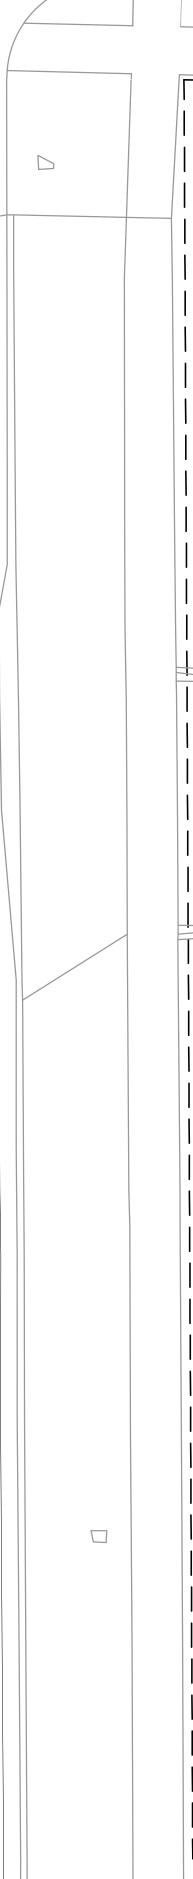



PROJECT TITLE 222 N. Charter Street

SHEET TITLE
Lot Coverage

SHEET NUMBER

C-1.3

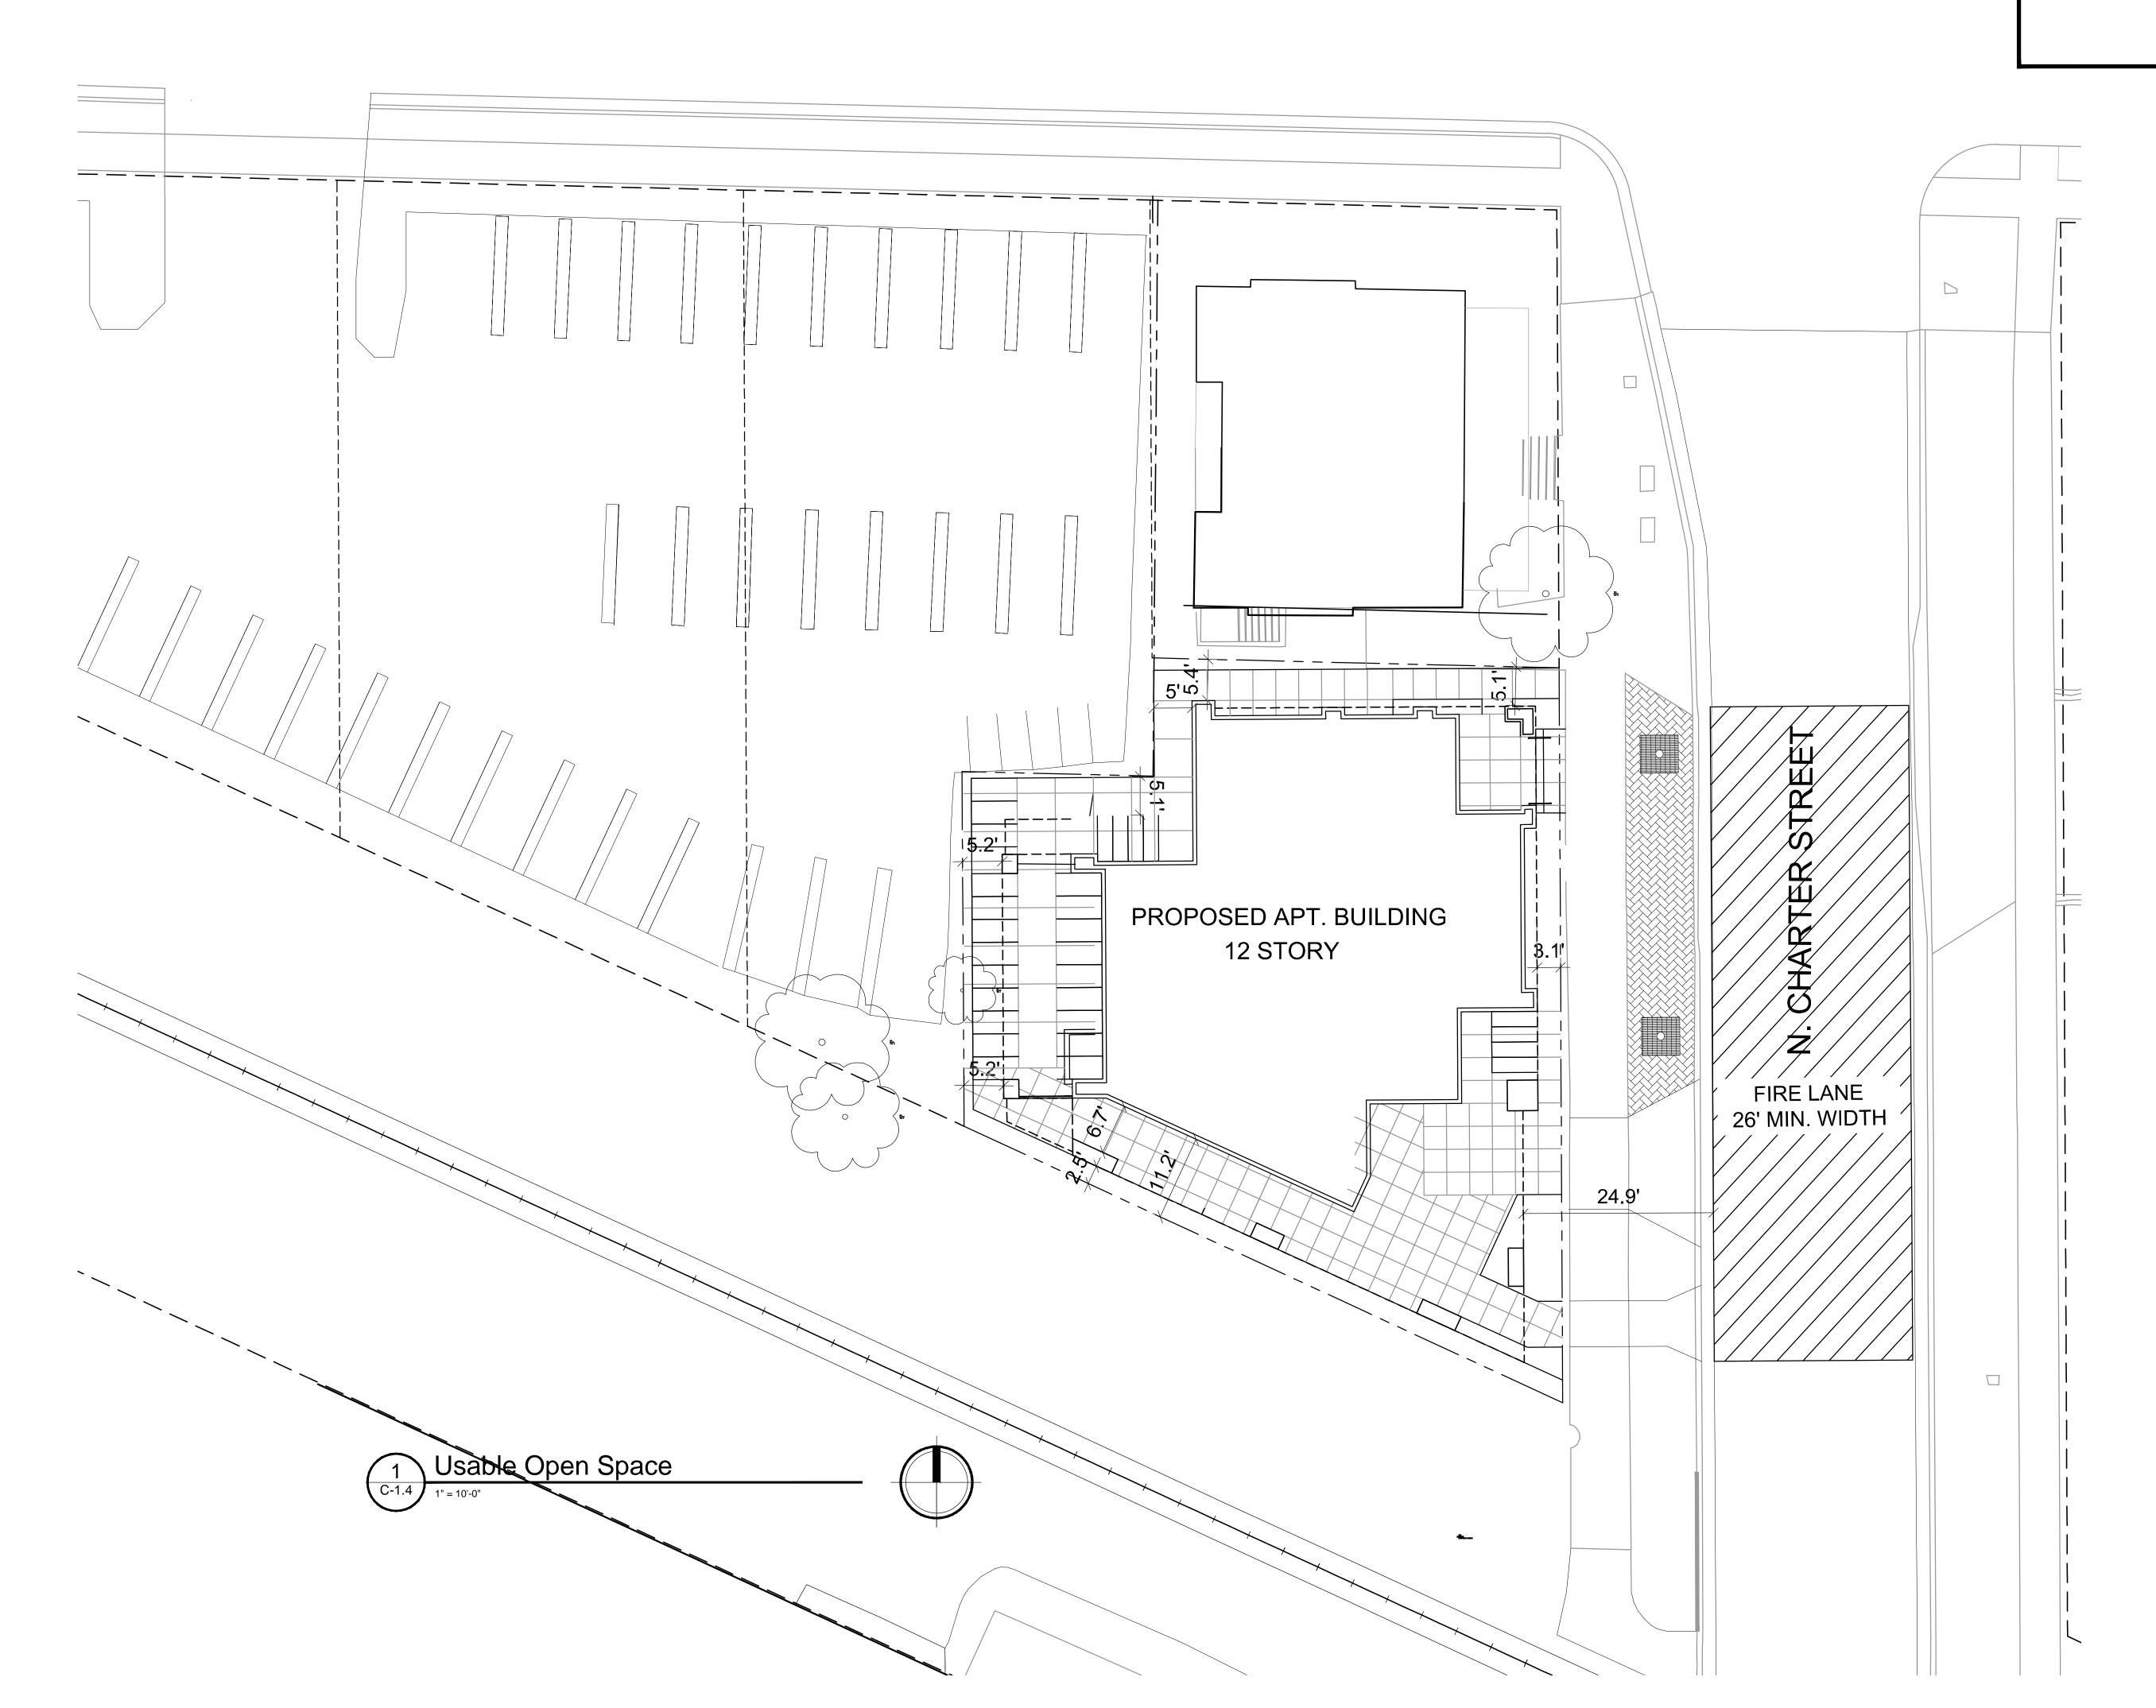

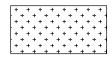

USABLE OPEN SPACE

DECKS & BALCONIES, ROOF TERRACE = 2,772 SF




ISSUED Issued Land Use Submittal - Dec. 6, 2017

PROJECT TITLE 222 N. Charter Street


sheet title Usable Open Space

SHEET NUMBER

C-1.4

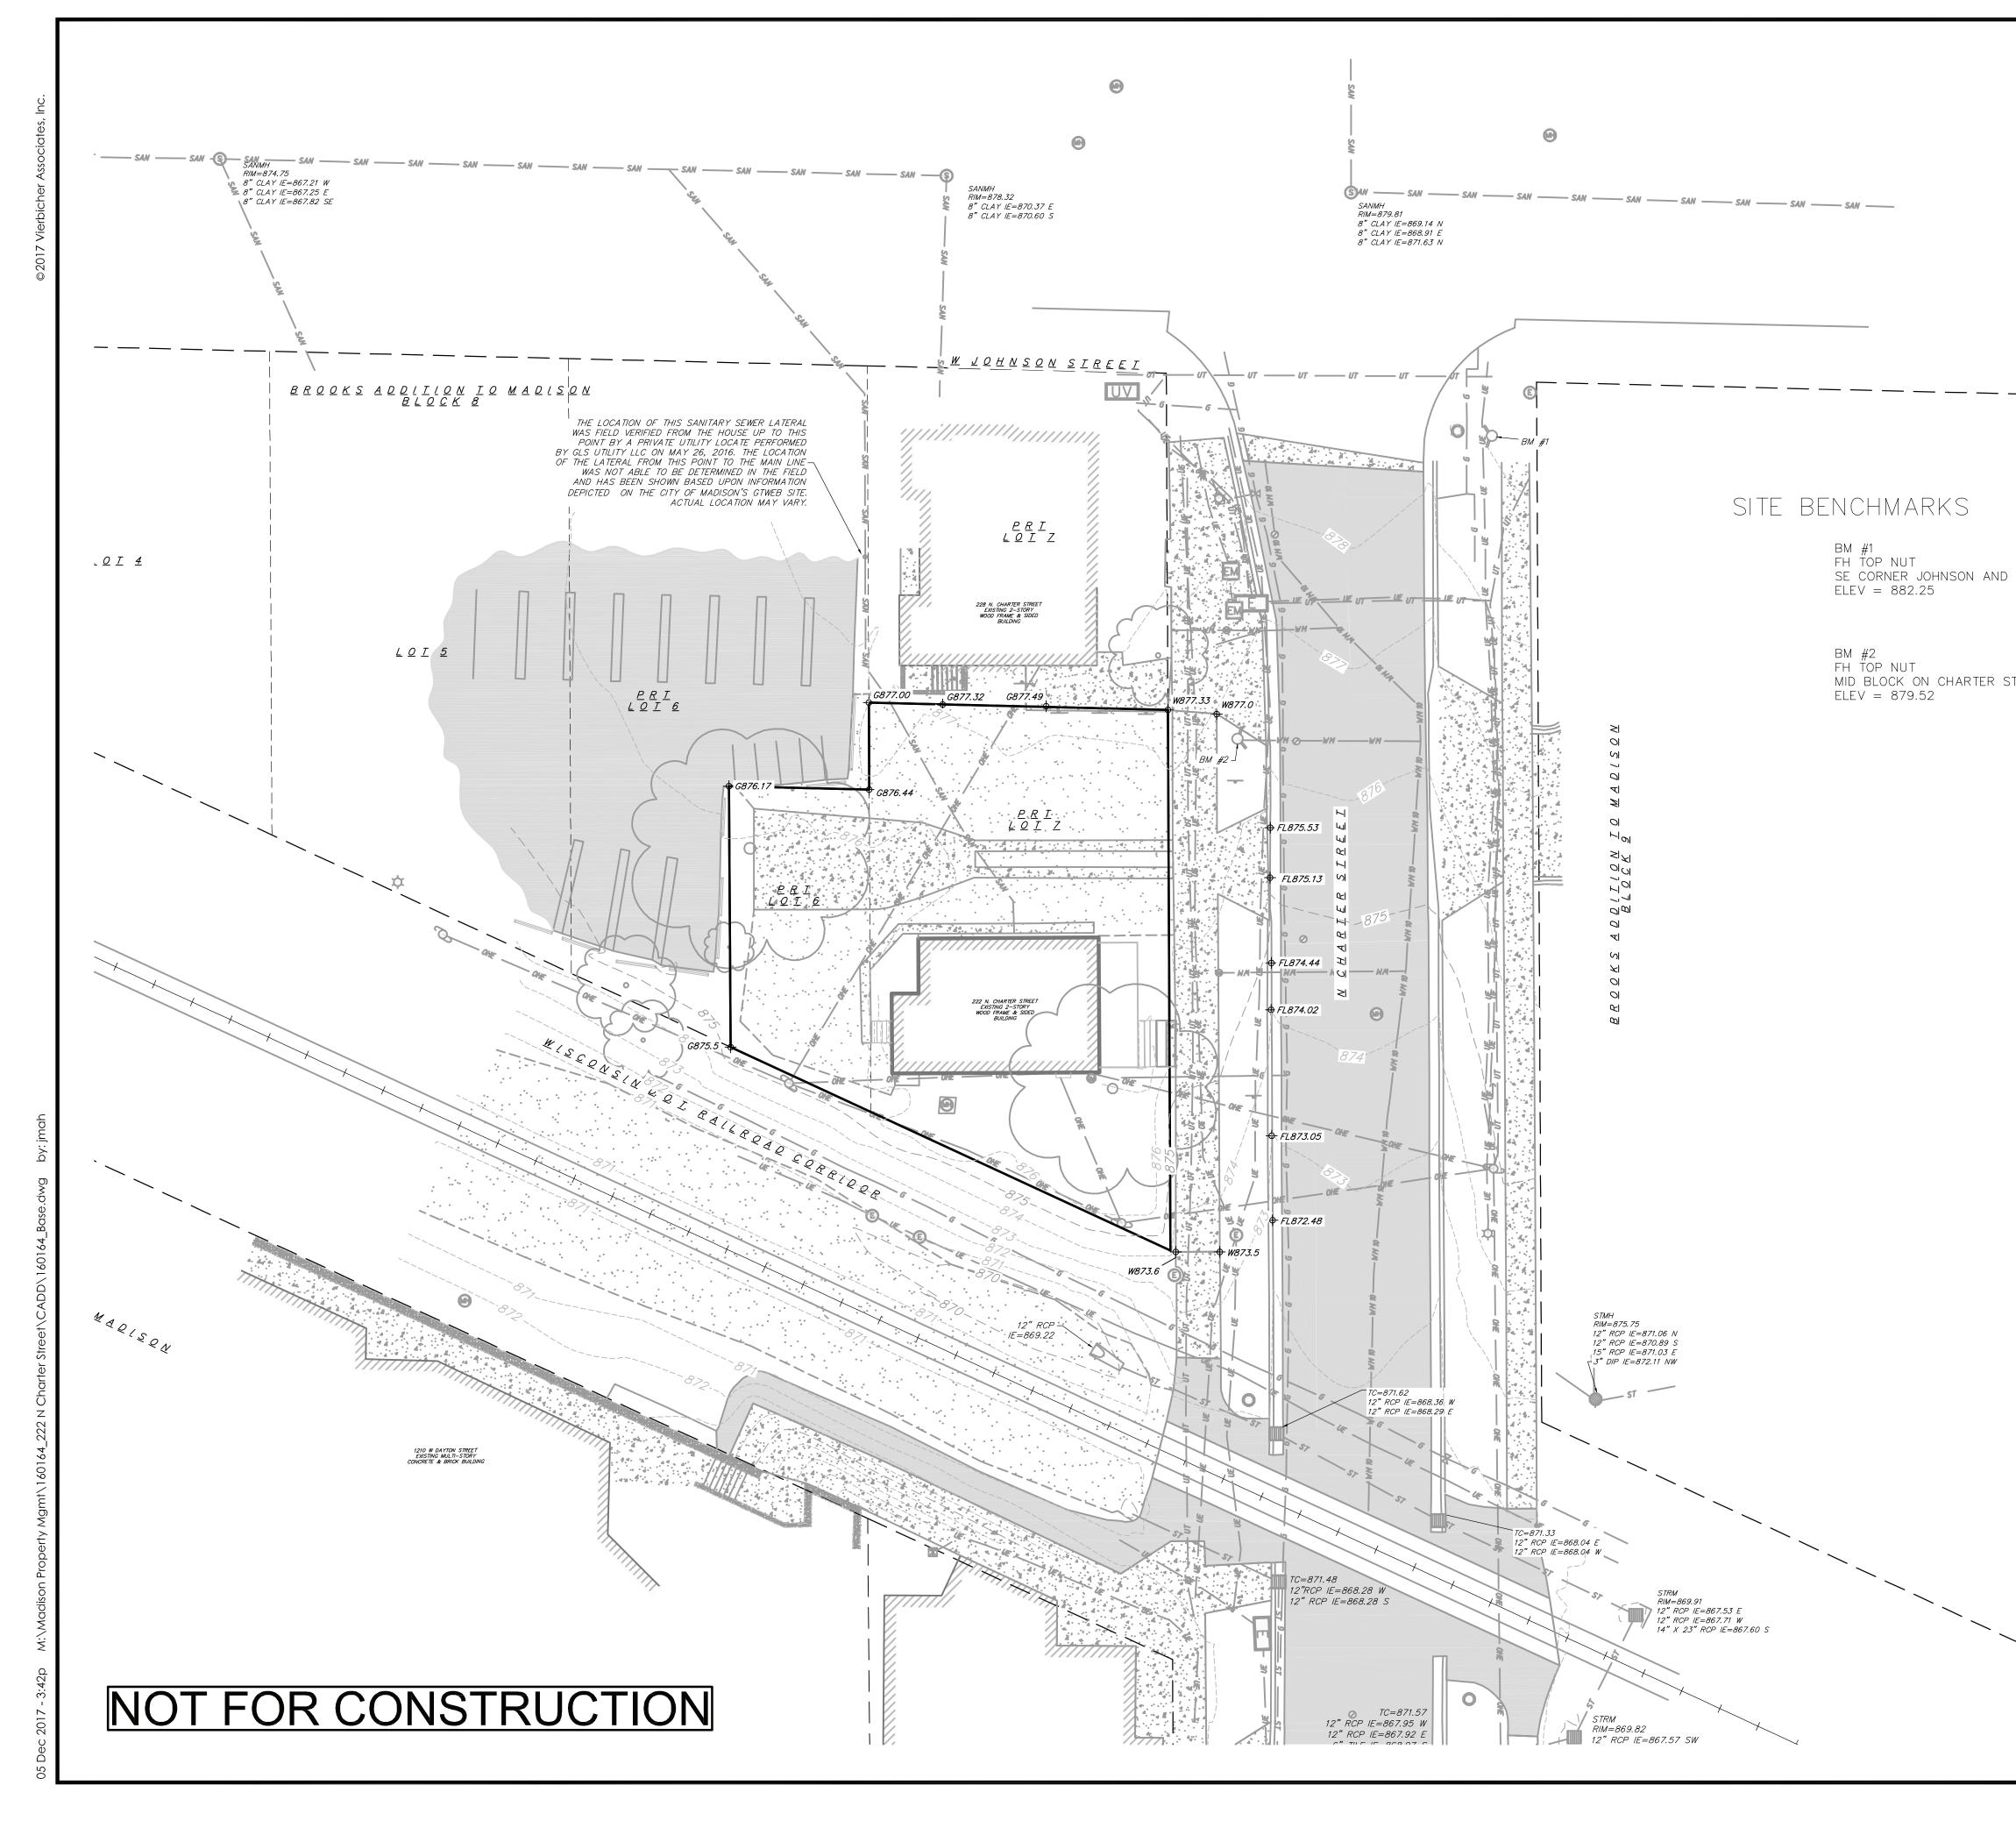

	GRA TOPOGRAPHIC SYMBOL LE EXISTING SIGN EXISTING CURB INLET EXISTING ENDWALL EXISTING FIELD INLET RECTA		Vierbicher planners engineers advisors Phone: (800) 261-3898
ND CHARTER 2 STREET	 EXISTING FIELD INLET EXISTING STORM MANHOLE EXISTING SANITARY CLEANOU EXISTING SANITARY MANHOL EXISTING SANITARY MANHOL EXISTING FIRE HYDRANT EXISTING WATER MAIN VALVE EXISTING WATER MANHOLE EXISTING CURB STOP EXISTING CURB STOP EXISTING GAS METER EXISTING GAS METER EXISTING GAS VALVE EXISTING BLECTRIC MANHOLE EXISTING ELECTRIC RECTANG EXISTING ELECTRIC METER EXISTING ELECTRIC METER EXISTING ELECTRIC METER EXISTING LIGHT POLE EXISTING UNIDENTIFIED MANH EXISTING UNIDENTIFIED UTILIT EXISTING TRAFFIC SIGNAL EXISTING UNIDENTIFIED MANH EXISTING UNIDENTIFIED MANH EXISTING UNIDENTIFIED MANH 	E E GULAR MANHOLE HOLE TY VAULT	Conditions Plan ter Street dison nty, WI
	TOPOGRAPHIC LINEWORK L	JND TELEPHONE JND ELECTRIC LINE ELECTRIC LINE SEWER LINE VER LINE VER LINE N (SIZE NOTED) NTOUR ITOUR TRACK CENTERLINE NE WAY LINE PROPERTY DAD EDGE	REVISIONS REVISIONS Existing Constants No. Date REMARKS NO. Date REMARKS 222 N Char 222 N Char 222 N Char City of Mac Cour
	 EXISTING INTERIOR PI EXISTING ASPHALT EXISTING GRAVEL EXISTING CONCRETE 41048.61 EXISTING SPOT ELEVA 		$\begin{array}{c c} & \underline{H} \\ & \underline{J} \\ & \underline$

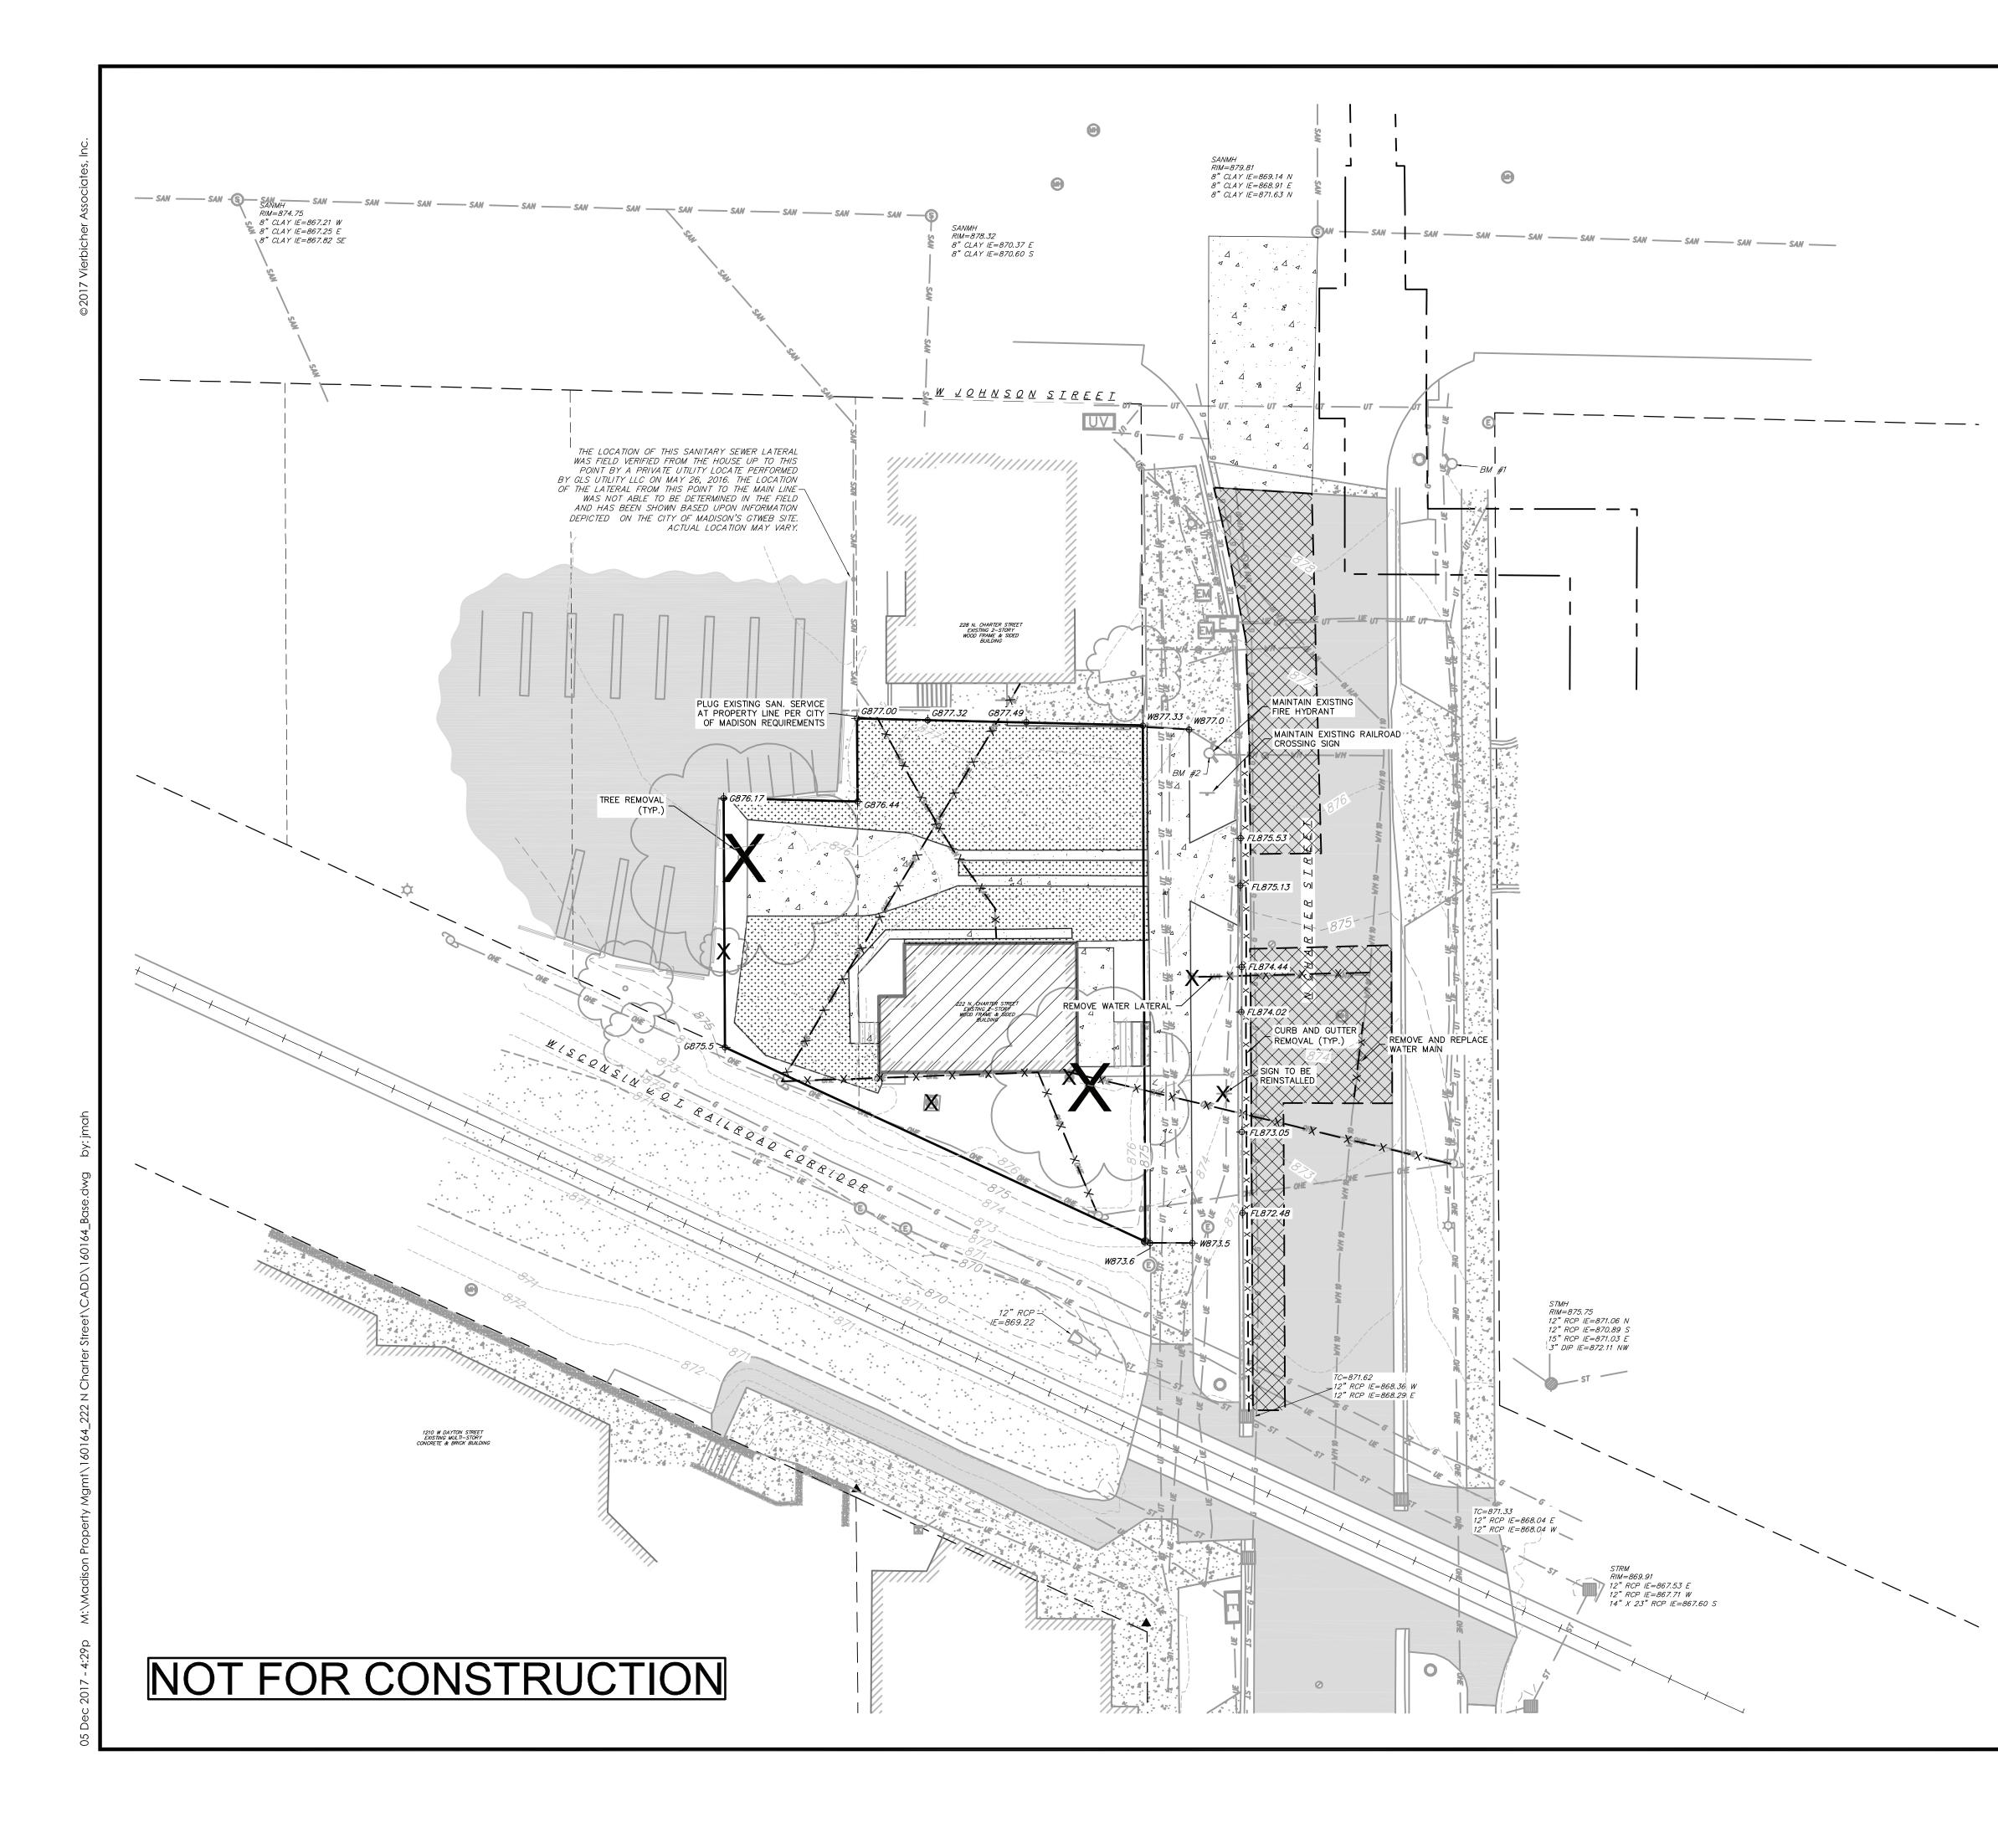

DEMOLITION PLAN LEGEND	
ASPHALT REMOVAL	
CONCRETE REMOVAL	
GRAVEL PARKING LOT REMOVAL	advisors ⁸⁹⁸
BUILDING REMOVAL 0 7.5 15 30	61-3898
TREE REMOVAL	Phone: (800) 261-3898
— — — SAWCUT	
UTILITY STRUCTURE REMOVAL	
	<u> </u>
<u> </u>	
EXISTING CONDITIONS LEGEND	REVISIONS Demolition Plan NO. DATE REMARKS NO. DATE REMARKS 222 N Charter Street City of Madison Dane County, WI
GENERAL NOTES: 1. THE LOCATION OF EXISTING UNDERGROUND UTILITIES AS SHOWN ON THE PLANS HAS BEEN DETERMINED FROM THE BEST AVAILABLE INFORMATION AND IS GIVEN FOR THE CONVENIENCE OF THE CONTRACTOR. THE OWNER AND THE ENGINEER DO NOT ASSUME RESPONSIBILITY IN THE EVENT THAT DURING CONSTRUCTION, UTILITIES OTHER THAN THOSE SHOWN MAY BE ENCOUNTERED, AND THAT THE ACTUAL LOCATION OF THOSE WHICH ARE SHOWN MAY BE DIFFERENT FROM THE LOCATION AS SHOWN ON THE PLANS.	O. DATE REMARKS
2. CONTRACTOR SHALL KEEP ALL STREETS FREE AND CLEAR OF CONSTRUCTION	SCALE AS SHOWN
RELATED DIRT/DUST/DEBRIS. 3. ALL CURB AND GUTTER TO BE FULLY REMOVED SHALL HAVE A FULL DEPTH	DATE
SAWCUT AT THE NEAREST JOINT.	12-06-2017

4. CONTRACTOR SHALL REMOVE AND REPLACE ANY PUBLIC IMPROVEMENTS THAT ARE DAMAGED DURING CONSTRUCTION AT THE CONTRACTOR'S EXPENSE DRAFTER

JMAH CHECKED

KJEN

PROJECT NO.

3 OF 7


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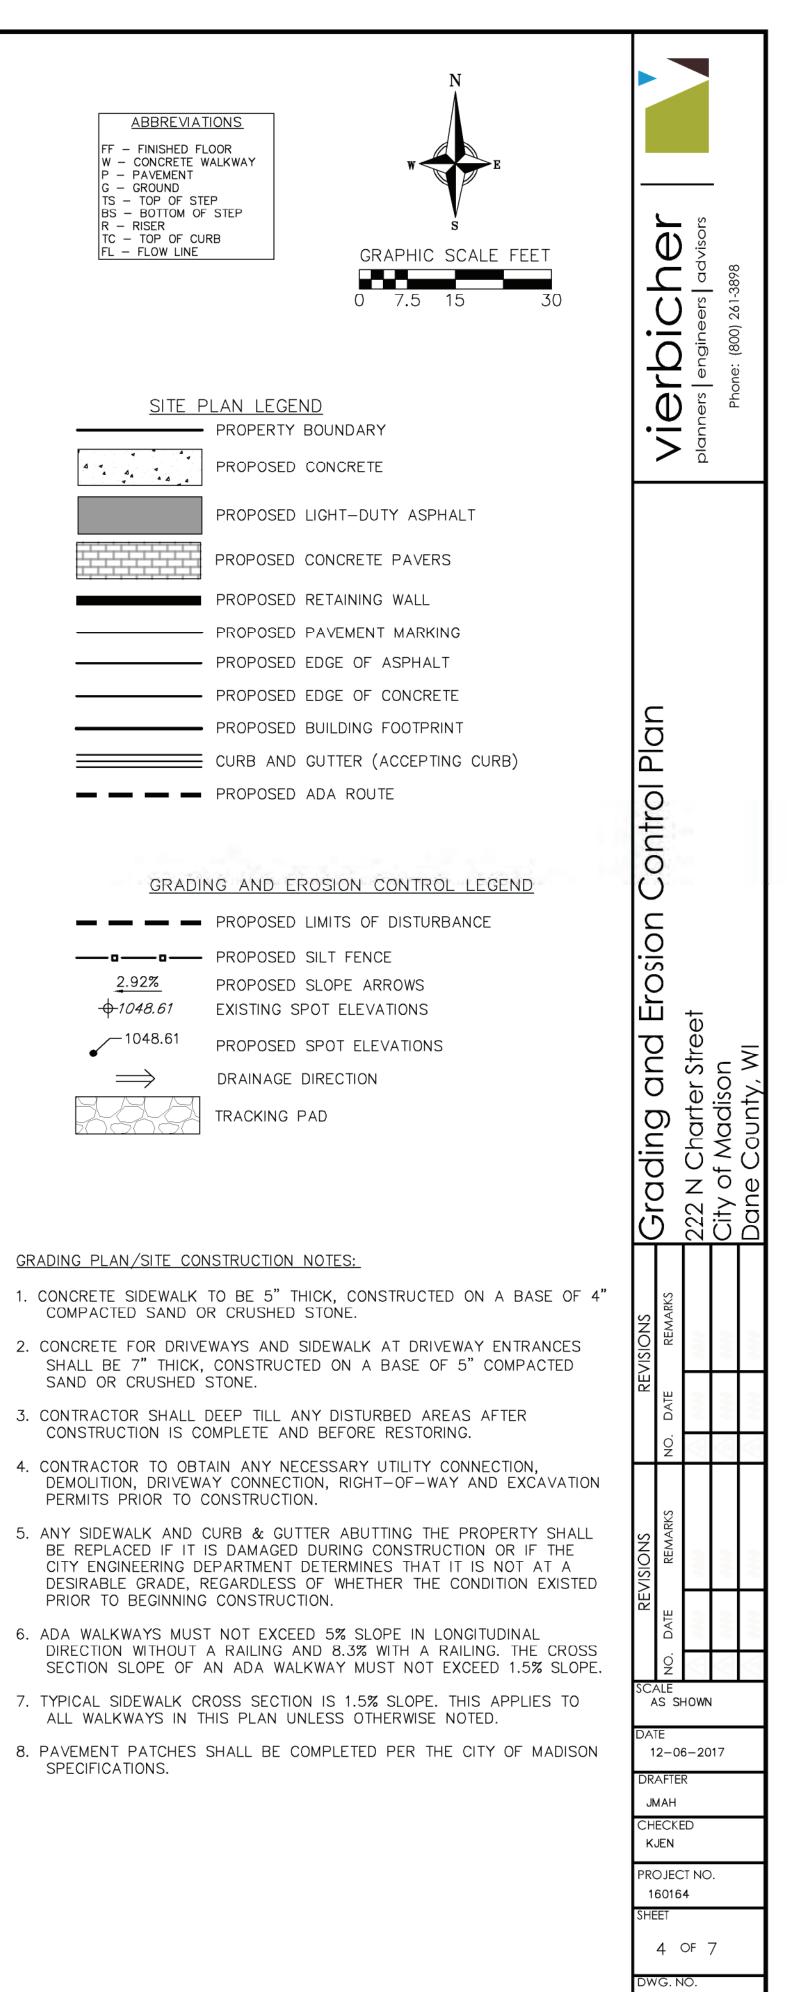
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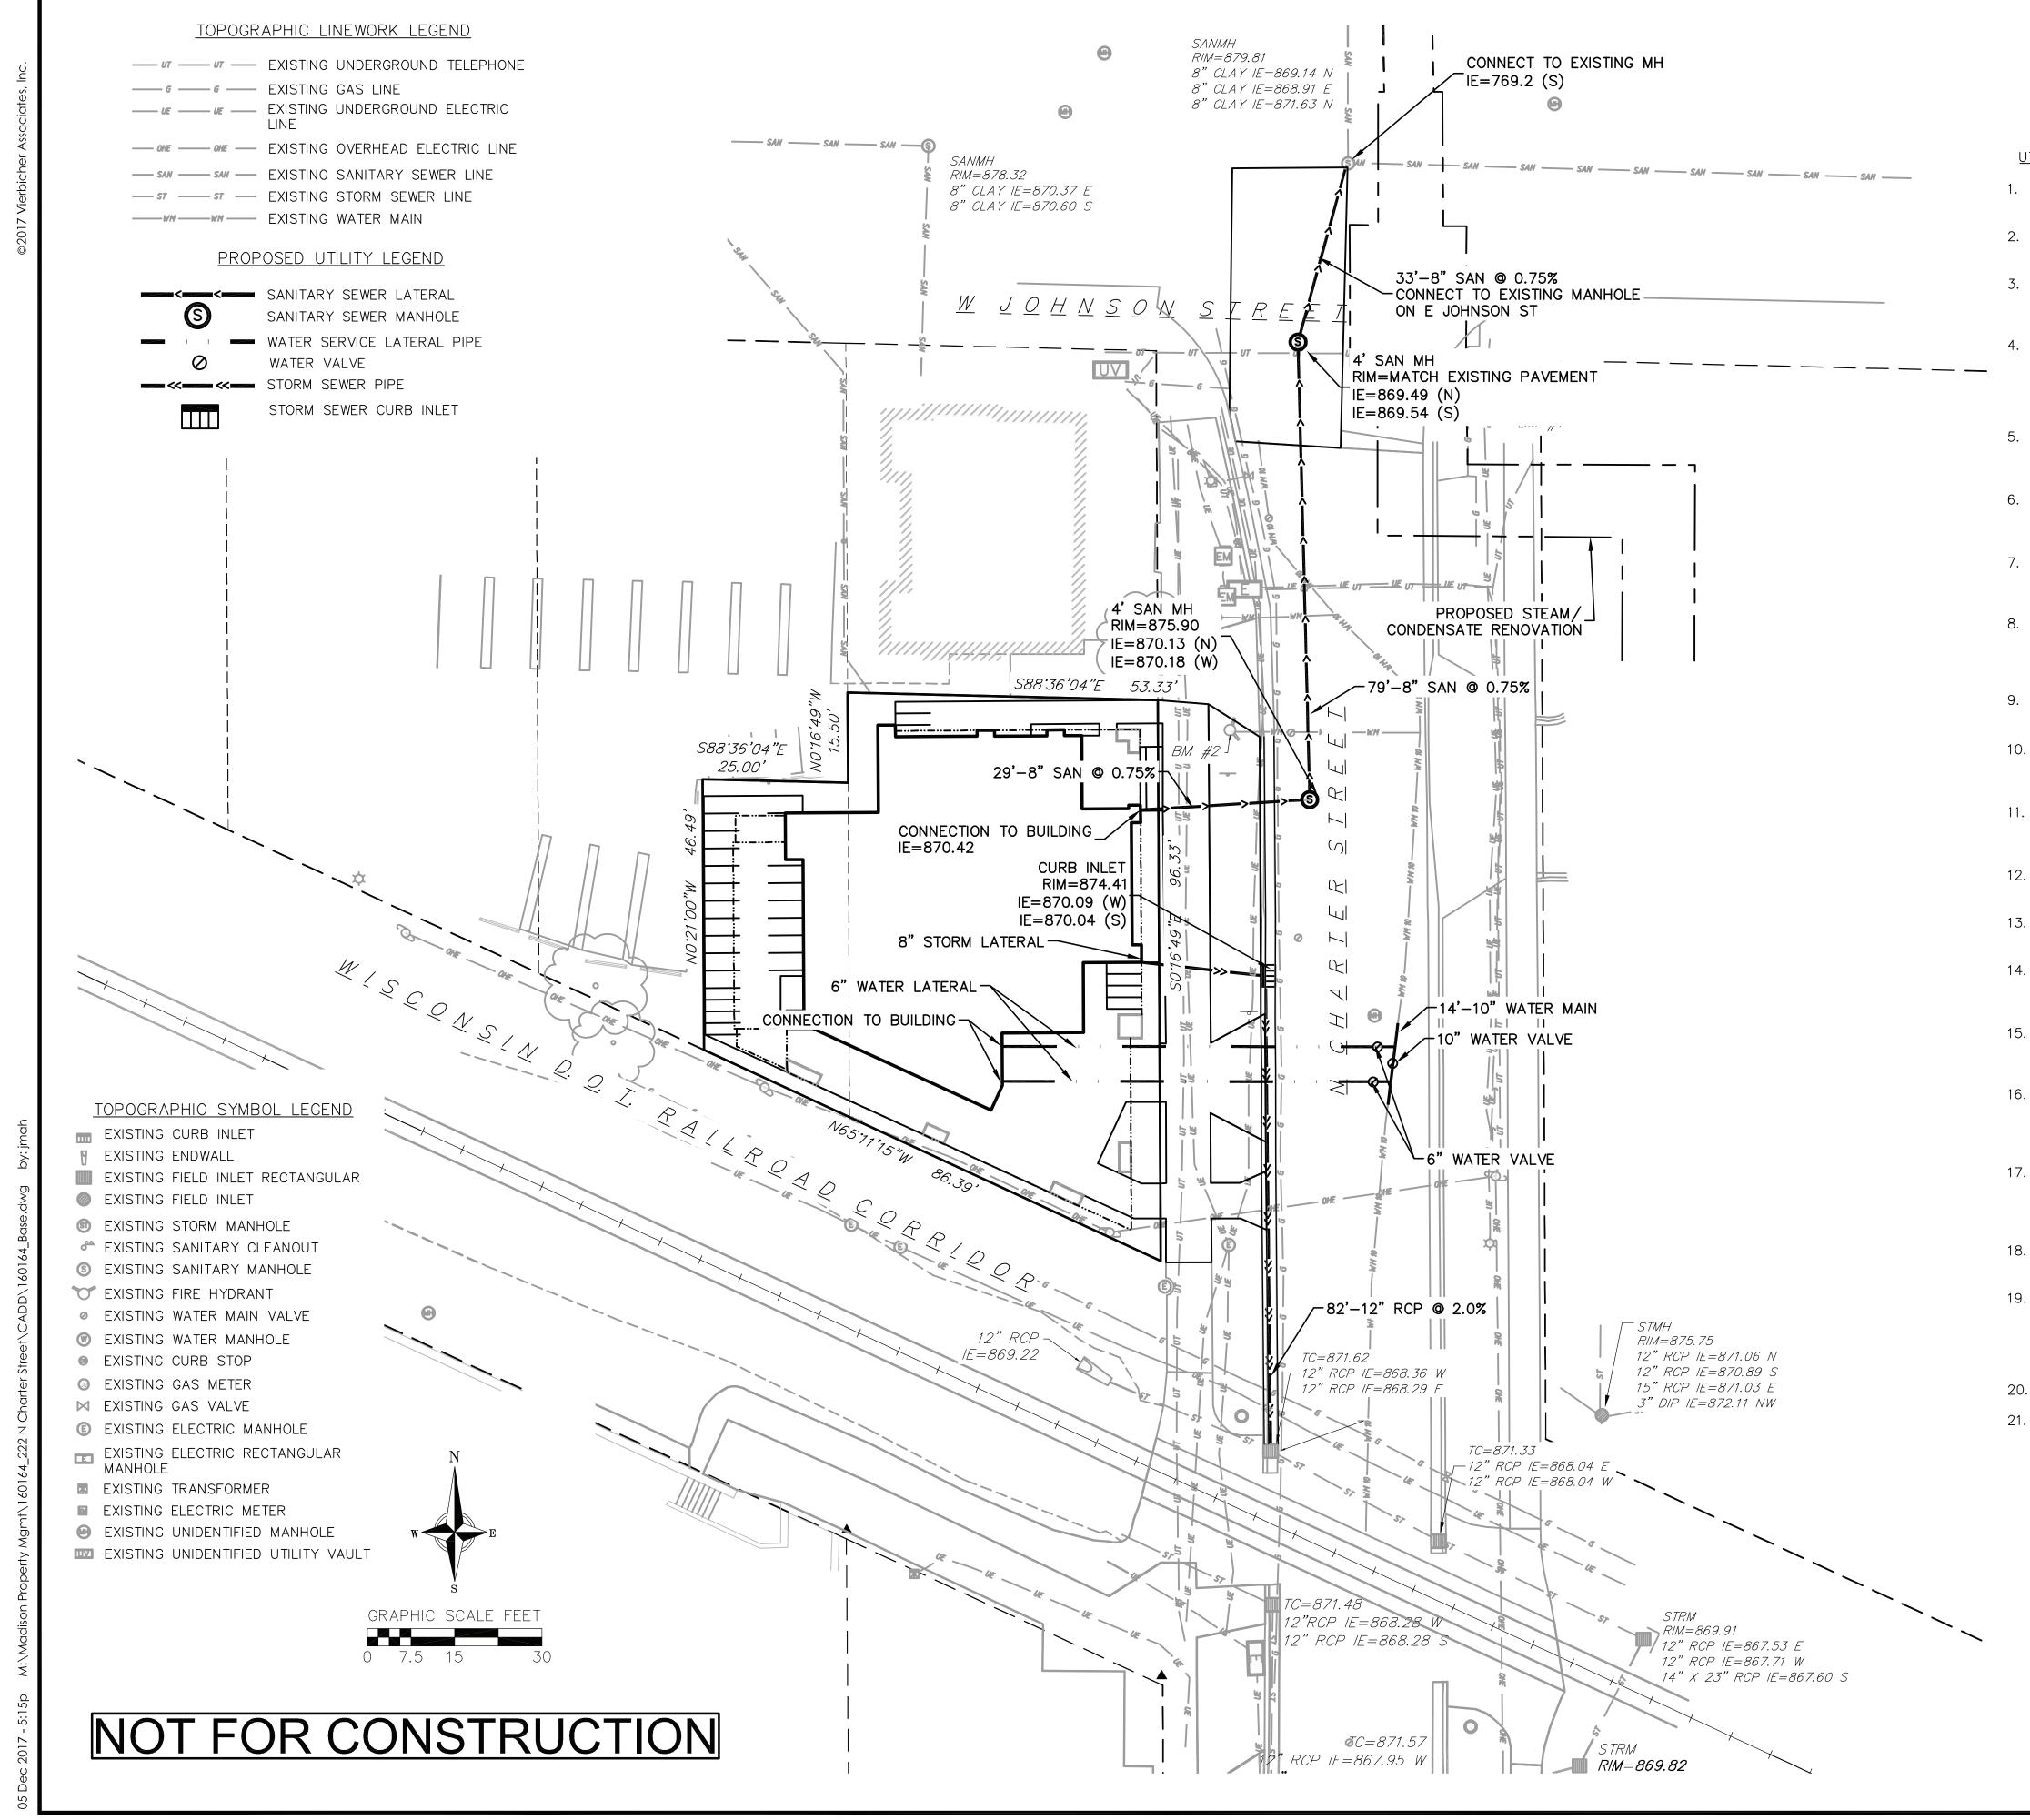
- 5. BRUSH AND MINOR TREES NOT SHOWN. CONTRACTOR ONLY TO REMOVE VEGETATION THAT CONFLICTS WITH PROPOSED WORK
- REMOVAL OF THE WATER LATERAL SHALL BE COMPLETED PER THE REQUIREMENTS OF THE CITY OF MADISON.
- 7. CONCRETE SAWCUTS SHALL BE COMPLETED AT THE NEAREST JOINT.
- 8. COORDINATE GAS AND ELECTRICAL DISCONNECTION AND REMOVAL WITH MADISON GAS & ELECTRIC.





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UTILITY NOTES:

1. CONTRACTOR SHALL INVESTIGATE ALL UTILITY CROSSINGS PRIOR TO CONSTRUCTION AND NOTIFY ENGINEER OF ANY CONFLICTS.

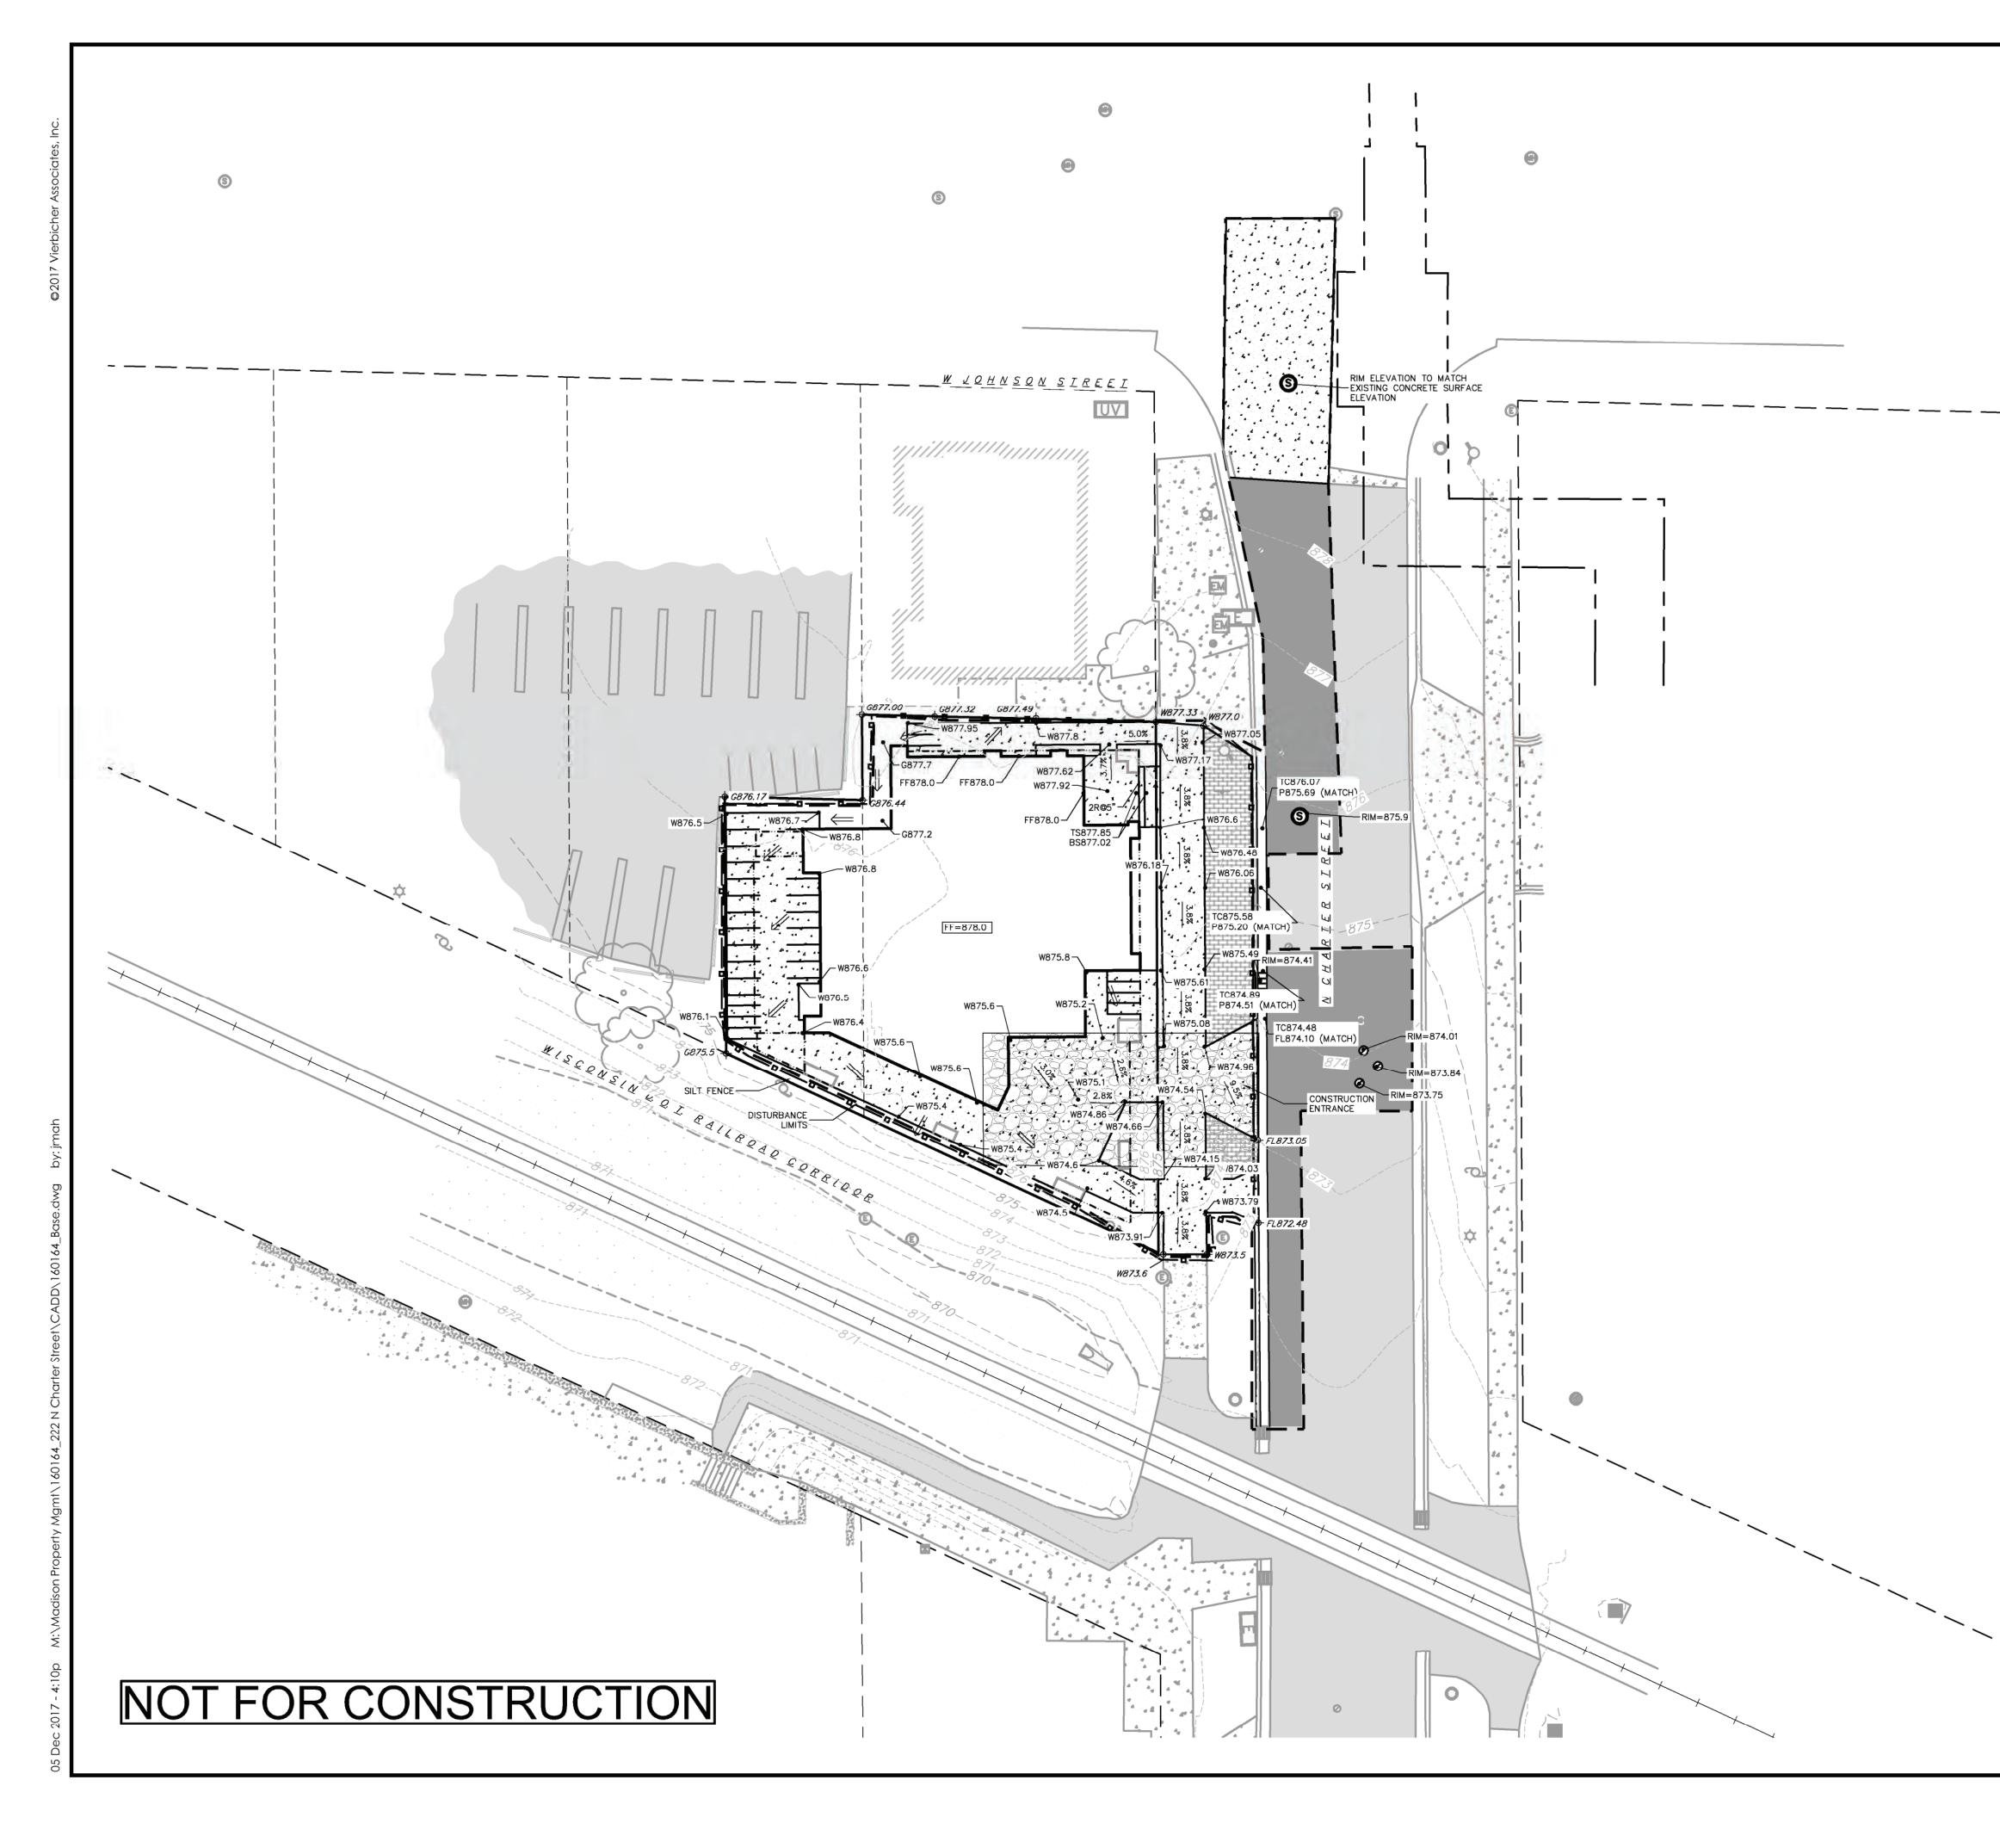2. CONTRACTOR SHALL BE RESPONSIBLE FOR ADJUSTING ALL UTILITY STRUCTURES (MANHOLE RIMS, WATER VALVES, AND CURB STOPS), IF NECESSARY.

3. UTILITY STRUCTURE RIM AND TOP OF CURB ELEVATIONS ON PLANS ARE APPROXIMATE. UTILITY STRUCTURES SHALL BE SET TO FINAL ELEVATIONS AFTER THE CURB & GUTTER AND BASE COURSE HAVE BEEN INSTALLED.

4. THE LOCATIONS OF EXISTING UTILITY INSTALLATIONS AS SHOWN ON THE PLAN ARE APPROXIMATE. THERE MAY BE OTHER UTILITY INSTALLATIONS WITHIN THE PROJECT AREA THAT ARE NOT SHOWN. CONTRACTOR SHALL BE RESPONSIBLE FOR CONTACTING DIGGERS HOTLINE AND LOCATING ALL EXISTING UTILITIES AND ENSURE PROPER CLEARANCE OF NEW UTILITIES.

5. CONTRACTOR SHALL OBTAIN ANY NECESSARY WORK IN RIGHT-OF WAY, EXCAVATION, UTILITY CONNECTION, PLUGGING, ABANDONMENT, AND DRIVEWAY CONNECTION PERMITS PRIOR TO CONSTRUCTION.

6. FOR ALL SEWER AND WATER MAIN CROSSINGS: PROVIDE MINIMUM 18" SEPARATION WHEN WATER MAIN CROSSES BELOW SEWER AND MINIMUM 6" SEPARATION WHEN WATER MAIN CROSSES ABOVE SEWER.

7. IF DEWATERING OPERATIONS EXCEED 70 GALLONS PER MINUTE OF PUMPING CAPACITY, A DEWATERING WELL PERMIT SHALL BE OBTAINED FROM THE DEPARTMENT PRIOR TO STARTING ANY DEWATERING ACTIVITIES.

8. A COPY OF THE APPROVED UTILITY PLANS, SPECIFICATIONS AND PLUMBING PERMIT APPROVAL LETTER SHALL BE ON-SITE DURING CONSTRUCTION AND OPEN TO INSPECTION BY AUTHORIZED REPRESENTATIVES OF THE DEPARTMENT OF SAFETY AND PROFESSIONAL SERVICES AND OTHER LOCAL INSPECTORS.

9. PRIVATE WATER SERVICES SHALL CONFORM TO ONE OF THE STANDARDS LISTED IN TABLE 384.30-7 OF SPS 384.30(4)(d).

10. PRIVATE SANITARY LATERALS SHALL BE POLYVINYL CHLORIDE (PVC) ASTM D3034 - SDR 35 OR APPROVED EQUAL MATERIAL THAT CONFORMS TO ONE OF THE STANDARDS LISTED IN TABLE 384.30-3 OF SPS 384.30(2)(c).

11. A MEANS TO LOCATE BURIED UNDERGROUND EXTERIOR NON METALLIC SEWERS AND WATER SERVICES MUST BE PROVIDED WITH TRACER WIRE OR OTHER METHODS IN ORDER TO BE LOCATED PER SPS 382.10(11)(h) AND SPS 382.40(8)(k).

12. EXTERIOR WATER SUPPLY PIPING SETBACKS AND CROSSINGS SHALL BE IN ACCORDANCE WITH SPS 382.40(8)(b.).

13. NO PERSON MAY ENGAGE IN PLUMBING WORK IN THE STATE UNLESS LICENSED TO DO SO BY THE DEPARTMENT OF SAFETY AND PROFESSIONAL SERVICES PER S.145.06.

14. SITE CONTRACTOR SHALL LEAVE SANITARY AND WATER LATERALS FIVE (5) FEET SHORT (HORIZONTALLY) FROM THE BUILDING. BUILDING PLUMBER SHALL VERIFY SIZE, LOCATION, AND INVERT ELEVATION OF PROPOSED SANITARY AND WATER LATERALS.

15. CONTRACTOR SHALL FIELD VERIFY THE SIZE, TYPE, LOCATION, AND ELEVATION OF EXISTING UTILITIES PRIOR TO INSTALLING ANY ON-SITE UTILITIES OR STRUCTURES. CONTACT ENGINEER PRIOR TO INSTALLATION IF DISCREPANCY EXISTS WITHIN THESE PLANS.

16. PROPOSED UTILITY SERVICE LINES SHOWN ARE APPROXIMATE. COORDINATE THE EXACT LOCATIONS WITH THE PLUMBING DRAWINGS. COORDINATE THE LOCATIONS WITH THE PLUMBING CONTRACTOR AND/OR OWNER'S CONSTRUCTION REPRESENTATIVE PRIOR TO INSTALLATION OF ANY NEW UTILITIES.

17. CONTRACTOR SHALL BE RESPONSIBLE FOR COORDINATING THE RELOCATION OF ANY UTILITIES ENCOUNTERED AND REPLACEMENT OF ANY UTILITIES DAMAGED WITHIN INFLUENCE ZONE OF NEW CONSTRUCTION. CONTACT ENGINEER IF THE EXISTING UTILITIES VARY APPRECIABLY FROM THE PLANS.

18. ALL WATER MAIN AND SERVICES SHALL BE INSTALLED AT A MINIMUM DEPTH OF 6.0' FROM TOP OF FINISHED GROUND ELEVATION TO TOP OF MAIN.

19. IT IS THE CONTRACTOR'S RESPONSIBILITY TO VERIFY THAT THE EXISTING VALVES WILL HOLD THE PRESSURE TEST PRIOR TO CONNECTION. THE CITY IS NOT RESPONSIBLE FOR ANY COSTS INCURRED DUE TO THE CONTRACTOR NOT VERIFYING THAT THE EXISTING VALVE WILL HOLD THE PRESSURE TEST PRIOR TO CONNECTION. IF A NEW VALVE IS REQUIRED, THE APPLICANT WILL BE REQUIRED TO INSTALL ONE AT THEIR EXPENSE, AT THE POINT OF CONNECTION.

20. CLEAN OUT ALL STORM INLETS AND CATCH BASINS AT THE COMPLETION OF CONSTRUCTION. 21. SANITARY AND WATER LATERAL LOCATIONS SHALL BE VERIFIED BY THE ARCHITECT FOR

CONNECTION LOCATIONS TO THE BUILDINGS.

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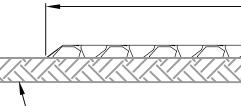
EROSION CONTROL MEASURES 1. EROSION CONTROL SHALL BE IN ACCORDANCE WITH THE CITY OF MADISON EROSION CONTROL ORDINANCE AND CHAPTER NR 216 OF THE WISCONSIN ADMINISTRATIVE CODE. 2. CONSTRUCT AND MAINTAIN ALL EROSION AND SEDIMENT CONTROL MEASURES IN ACCORDANCE WITH WISCONSIN DNR TECHNICAL STANDARDS (http://dnr.wi.gov/runoff/stormwater/techstds.htm) AND WISCONSIN CONSTRUCTION SITE BEST MANAGEMENT PRACTICE HANDBOOK. 3. INSTALL SEDIMENT CONTROL PRACTICES (TRACKING PAD, PERIMETER SILT FENCE, SEDIMENT BASINS, ETC.) PRIOR TO INITIATING OTHER LAND DISTURBING CONSTRUCTION ACTIVITIES. 4. THE CONTRACTOR IS REQUIRED TO MAKE EROSION CONTROL INSPECTIONS AT THE END OF EACH WEEK AND WHEN 0.5 INCHES OF RAIN FALLS WITHIN 24 HOURS. INSPECTION REPORTS SHALL BE PREPARED AND FILED AS REQUIRED BY THE DNR AND/OR CITY. ALL MAINTENANCE WILL FOLLOW AN INSPECTION WITHIN 24 HOURS. 5. EROSION CONTROL IS THE RESPONSIBILITY OF THE CONTRACTOR UNTIL ACCEPTANCE OF THIS PROJECT. EROSION CONTROL MEASURES AS SHOWN SHALL BE THE MINIMUM PRECAUTIONS THAT WILL BE ALLOWED. ADDITIONAL EROSION CONTROL MEASURES, AS REQUESTED IN WRITING BY THE STATE OR LOCAL INSPECTORS, OR THE DEVELOPER'S ENGINEER, SHALL BE INSTALLED WITHIN 24 HOURS. 6. A 3" CLEAR STONE TRACKING PAD SHALL BE INSTALLED AT THE END OF ROAD CONSTRUCTION LIMITS TO PREVENT SEDIMENT FROM BEING TRACKED ONTO THE ADJACENT PAVED PUBLIC ROADWAY. SEDIMENT TRACKING PAD SHALL CONFORM TO WISDNR TECHNICAL STANDARD 1057. SEDIMENT REACHING THE PUBLIC ROAD SHALL BE REMOVED BY STREET CLEANING (NOT HYDRAULIC FLUSHING) BEFORE THE END OF EACH WORK DAY. 7. CHANNELIZED RUNOFF: FROM ADJACENT AREAS PASSING THROUGH THE SITE SHALL BE DIVERTED AROUND DISTURBED AREAS. 8. STABILIZED DISTURBED GROUND: ANY SOIL OR DIRT PILES WHICH WILL REMAIN IN EXISTENCE FOR MORE THAN 7-CONSECUTIVE DAYS, WHETHER TO BE WORKED DURING THAT PERIOD OR NOT, SHALL NOT BE LOCATED WITHIN 25-FEET OF ANY ROADWAY, PARKING LOT, PAVED AREA, OR DRAINAGE STRUCTURE OR CHANNEL (UNLESS INTENDED TO BE USED AS PART OF THE EROSION CONTROL MEASURES). TEMPORARY STABILIZATION AND CONTROL MEASURES (SEEDING, MULCHING, TARPING, EROSION MATTING, BARRIER FENCING, ETC.) ARE REQUIRED FOR THE PROTECTION OF DISTURBED AREAS AND SOIL PILES, WHICH WILL REMAIN UN-WORKED FOR A PERIOD OF MORE THAN 14-CONSECUTIVE CALENDAR DAYS. THESE MEASURES SHALL REMAIN IN PLACE UNTIL SITE HAS STABILIZED. 9. SITE DE-WATERING: WATER PUMPED FROM THE SITE SHALL BE TREATED BY TEMPORARY SEDIMENTATION BASINS OR OTHER APPROPRIATE CONTROL MEASURES. SEDIMENTATION BASINS SHALL HAVE A DEPTH OF AT LEAST 3 FEET, BE SURROUNDED BY SNOWFENCE OR EQUIVALENT BARRIER AND HAVE SUFFICIENT SURFACE AREA TO PROVIDE A SURFACE SETTLING RATE OF NO MORE THAN 750 GALLONS PER SQUARE FOOT PER DAY AT THE HIGHEST DEWATERING PUMPING RATE. WATER MAY NOT BE DISCHARGED IN A MANNER THAT CAUSES EROSION OF THE SITE, A NEIGHBORING SITE, OR THE BED OR BANKS OF THE RECEIVING WATER. POLYMERS MAY BE USED AS DIRECTED BY DNR TECHNICAL STANDARD 1061 (DE-WATERING). 10. RESTORATION (SEED, FERTILIZE AND MULCH) SHALL BE PER SPECIFICATIONS ON THIS SHEET UNLESS SPECIAL RESTORATION IS CALLED FOR ON THE LANDSCAPE PLAN OR THE DETENTION BASIN DETAIL SHEET. 11. TERRACES SHALL BE RESTORED WITH 6" TOPSOIL, PERMANENT SEED, FERTILIZER AND MULCH. LOTS SHALL BE RESTORED WITH 6" TOPSOIL, TEMPORARY SEED, FERTILIZER AND MULCH. 12. SEED, FERTILIZER AND MULCH SHALL BE APPLIED WITHIN 7 DAYS AFTER FINAL GRADE HAS BEEN ESTABLISHED. IF DISTURBED AREAS WILL NOT BE RESTORED IMMEDIATELY AFTER ROUGH GRADING, TEMPORARY SEED SHALL BE PLACED. 13. FOR THE FIRST SIX WEEKS AFTER RESTORATION (E.G. SEED & MULCH, EROSION MAT, SOD) OF A DISTURBED AREA, INCLUDE SUMMER WATERING PROVISIONS OF ALL NEWLY SEEDED AND MULCHED AREAS WHENEVER 7 DAYS ELAPSE WITHOUT A RAIN EVENT. 14. EROSION MAT (CLASS I, TYPE A URBAN PER WISCONSIN D.O.T. P.A.L.) SHALL BE INSTALLED ON ALL SLOPES 3:1 OR GREATER BUT LESS THAN 1:1. 15. SOIL STABILIZERS SHALL BE APPLIED TO DISTURBED AREAS WITH SLOPES BETWEEN 10% AND 3:1 (DO NOT USE IN CHANNELS). SOIL STABILIZERS SHALL BE TYPE B, PER WISCONSIN D.O.T. P.A.L. (PRODUCT ACCEPTABILITY LIST), OR EQUAL. APPLY AT RATES AND METHODS SPECIFIED PER THIS SHEET. SOIL STABILIZERS SHALL BE RE-APPLIED WHENEVER VEHICLES OR OTHER EQUIPMENT TRACK ON THE AREA. 16. SILT FENCE OR EROSION MAT SHALL BE INSTALLED ALONG THE CONTOURS AT 100 FOOT INTERVALS DOWN THE SLOPE ON THE DISTURBED SLOPES STEEPER THAN 5% AND MORE THAN 100 FEET LONG THAT SHEET FLOW TO THE ROADWAY UNLESS SOIL STABILIZERS ARE USED. 17. INSTALL MINIMUM 6'-7' WIDE EROSION MAT ALONG THE BACK OF CURB AFTER TOPSOIL HAS BEEN PLACED IN THE TERRACE IF THIS AREA WILL NOT BE SEEDED AND MULCHED WITHIN 48 HOURS OF PLACING TOPSOIL. 18. SILT FENCE TO BE USED ACROSS AREAS OF THE LOT THAT SLOPE TOWARDS A PUBLIC STREET OR WATERWAY. SEE DETAILS. 19. SEDIMENT SHALL BE CLEANED FROM CURB AND GUTTER AFTER EACH RAINFALL AND PRIOR TO PROJECT ACCEPTANCE. 20. ALL CONSTRUCTION ENTRANCES SHALL HAVE TEMPORARY ROAD CLOSED SIGNS THAT WILL BE IN PLACE WHEN THE ENTRANCE IS NOT IN USE AND AT THE END OF EACH DAY. 21. ANY PROPOSED CHANGES TO THE EROSION CONTROL PLAN MUST BE SUBMITTED AND APPROVED BY DANE COUNTY LAND CONSERVATION OR PERMITTING MUNICIPALITY. 22. THE CITY, OWNER AND/OR ENGINEER MAY REQUIRE ADDITIONAL EROSION CONTROL MEASURES AT ANY TIME DURING CONSTRUCTION. **NOT FOR CONSTRUCTION**

CONSTRUCTION SEQUENCE:

- 1. INSTALL SILT FENCE AND TRACKING PAD
- 2. STRIP TOPSOIL
- 3. ROUGH GRADE LOT
- 4. CONSTRUCT UNDERGROUND UTILITIES
- 5. CONSTRUCT BUILDING AND SURFACE
- 6. RESTORE TERRACES

LOT IMPROVEMENTS

7. REMOVE SILT FENCE



- EXISTING GROUND

SEEDING RATES:

TEMPORARY:

- 1. USE ANNUAL OATS AT 3.0 LB./1,000 S.F. FOR SPRING AND SUMMER PLANTINGS. 2. USE WINTER WHEAT OR RYE AT 3.0 LB./1,000 SF FOR
- FALL PLANTINGS STARTED
- AFTER SEPTEMBER 15.


PERMANENT: 1. USE WISCONSIN D.O.T. SEED MIX #40 AT 2 LB./1,000 S.F.

FERTILIZING RATES:

TEMPORARY AND PERMANENT: USE WISCONSIN D.O.T. TYPE A OR B AT 7 LB./1,000 S.F.

MULCHING RATES:


TEMPORARY AND PERMANENT: USE $\frac{1}{2}$ " to $1-\frac{1}{2}$ " STRAW OR HAY MULCH. CRIMPED PER SECTION 607.3.2.3, OR OTHER RATE AND METHOD PER SECTION 627, WISCONSIN D.O.T. STANDARD SPECIFICATIONS FOR HIGHWAY AND STRUCTURE CONSTRUCTION

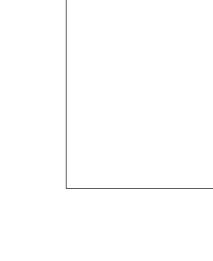


- 1. FOLLOW WISCONSIN DNR TECHNICAL STANDARD 10
- 2. LENGTH MINIMUM OF 50'
- 3. WIDTH 24' MINIMUM, SHOULD BE FLARED AT THI
- 4. ON SITES WITH A HIGH GROUND WATER TABLE OR OVER EXISTING GROUND PRIOR TO PLACING STONE
- 5. STONE CRUSHED 3" CLEAR STONE SHALL BE PI
- 6. SURFACE WATER ALL SURFACE WATER FLOWING THROUGH THE ENTRANCE. MAINTAINING POSITIVE D SHALL BE PROTECTED WITH A MOUNTABLE BERM SIZED ACCORDING TO THE DRAINAGE REQUIREMENT TO CONVEY A PIPE SHALL NOT BE NECESSARY. TH FOR THE MAINTENANCE OF SAID PIPE.
- 7. LOCATION A STABILIZED CONSTRUCTION ENTRAN THE CONSTRUCTION SITE. VEHICLES LEAVING THE



- MOUNTABLE BERM	Vierbicher advisors planners engineers advisors Phone: (800) 261-3898
down we begin with the statustic shall be placed of the statustic shall be provide a turning radius. Re where saturated conditions exist, deditation existence shall be placed of the prepion of the pre	REVISIONS REVISIONS REVISIONS D. DATE REMARKS NO. DATE REMARKS Description NO. DATE REMARKS Semarks Description Description Semarks Semarks Description Description Description
NTS. WHEN THE ENTRANCE IS LOCATED AT A HIGH SPOT AND HAS NO DRAINAGE THE MINIMUM PIPE DIAMETER SHALL BE 6". CONTRACTOR SHALL BE RESPONSIBLE ANCE SHALL BE LOCATED WHERE CONSTRUCTION TRAFFIC ENTERS AND/OR LEAVES SITE MUST TRAVEL OVER THE ENTIRE LENGTH OF THE TRACKING PAD.	$\begin{array}{c c} & & & \\ & & \\ & & \\ & & \\ & & \\ & & \\$

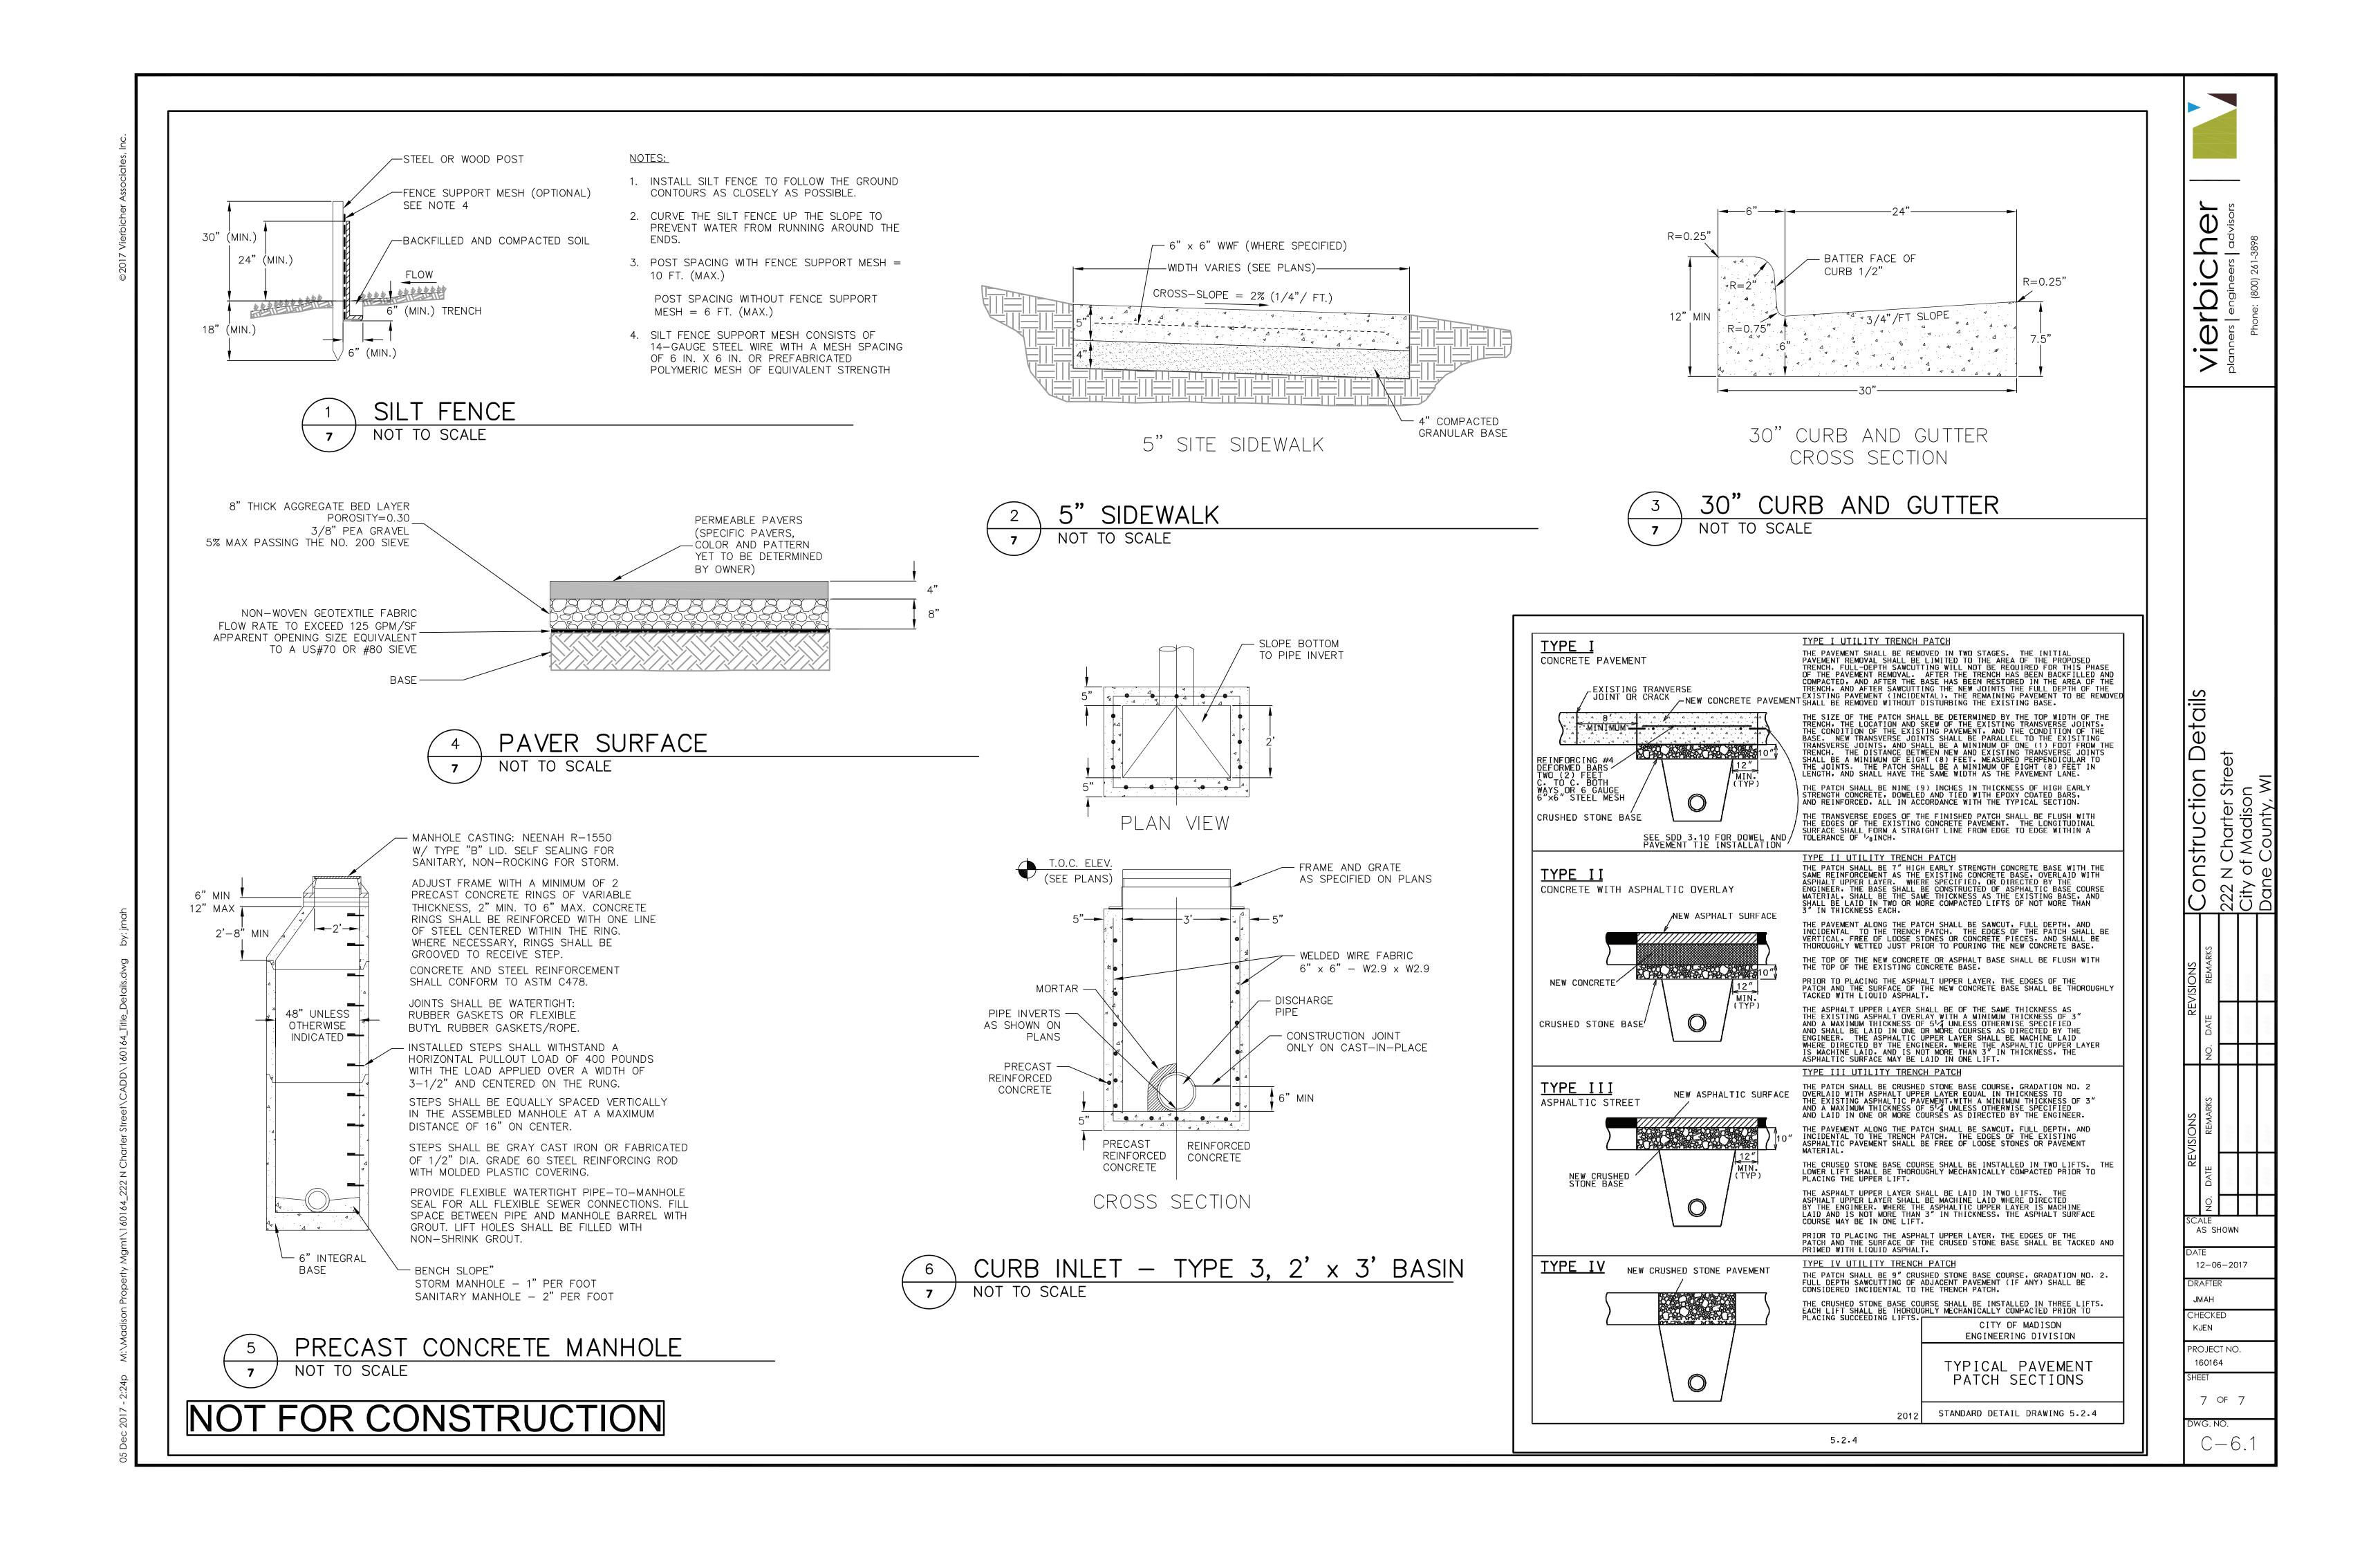

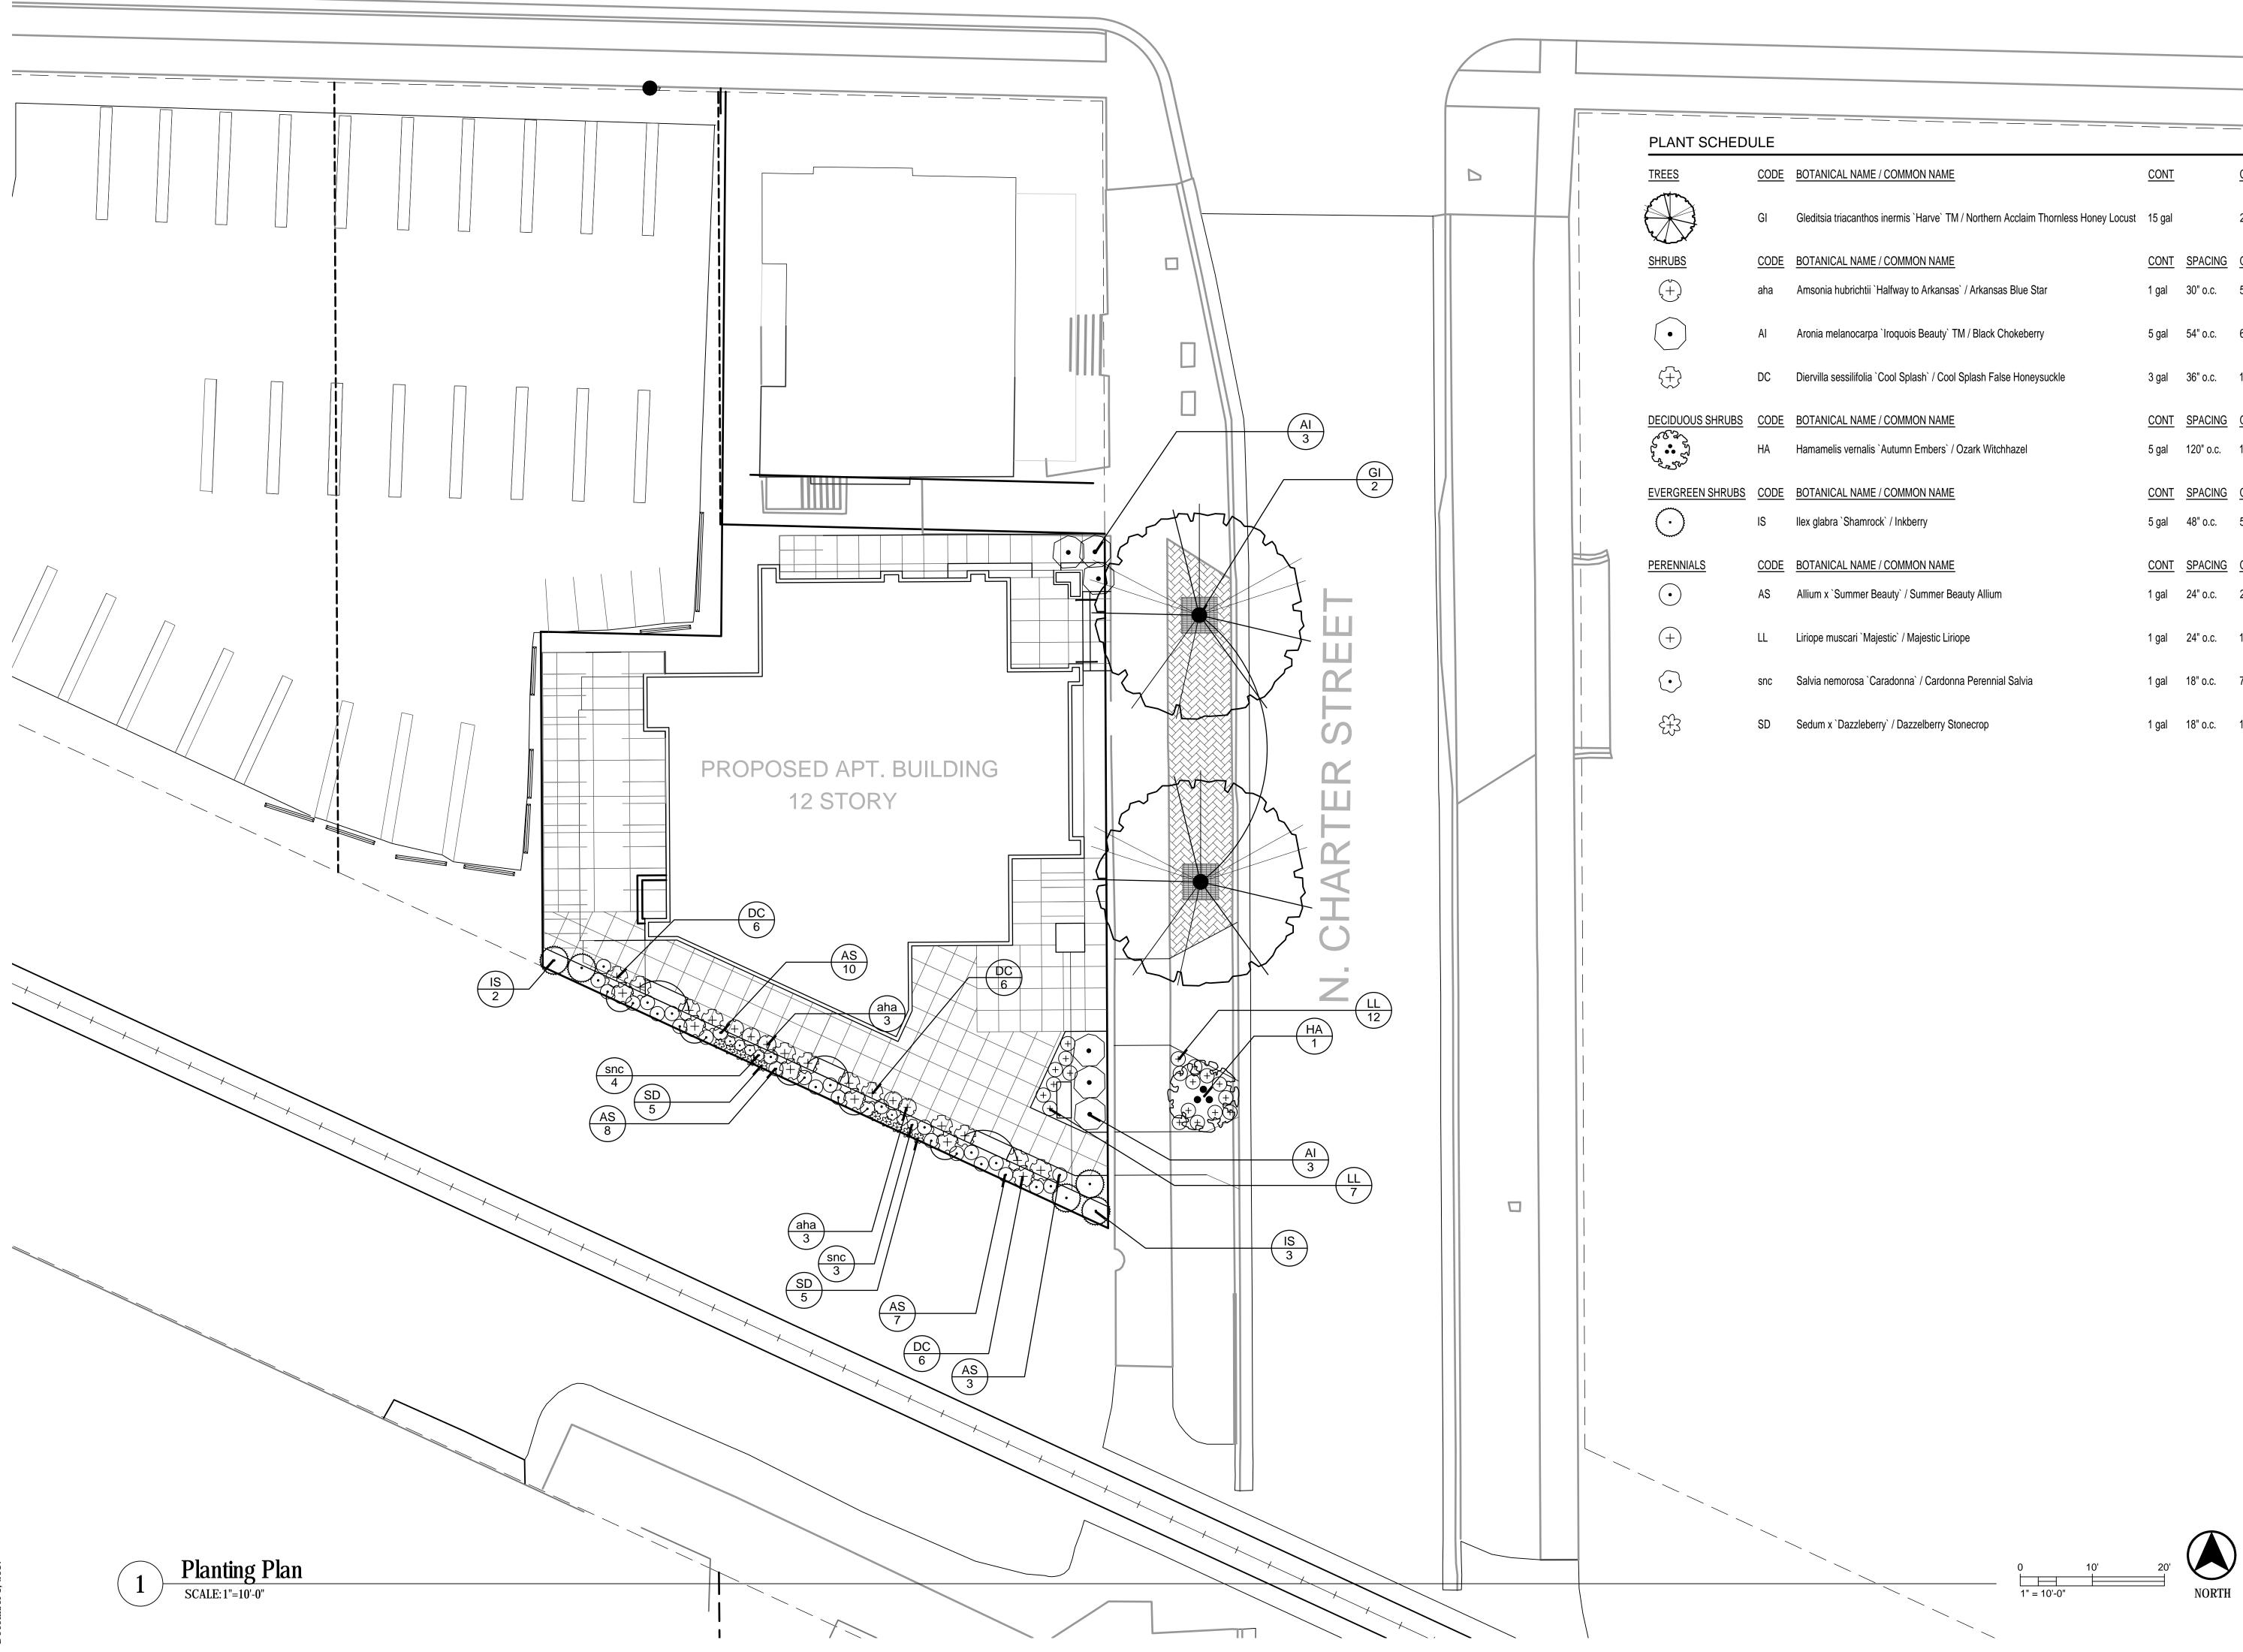

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DE	BOTANICAL NAME / COMMON NAME	<u>CONT</u>		QTY
	Gleditsia triacanthos inermis `Harve` TM / Northern Acclaim Thornless Honey Locust	15 gal		2
DE	BOTANICAL NAME / COMMON NAME	CONT	SPACING	<u>QTY</u>
a	Amsonia hubrichtii `Halfway to Arkansas` / Arkansas Blue Star	1 gal	30" o.c.	5
	Aronia melanocarpa `Iroquois Beauty` TM / Black Chokeberry	5 gal	54" o.c.	6
	Diervilla sessilifolia `Cool Splash` / Cool Splash False Honeysuckle	3 gal	36" o.c.	18
DE	BOTANICAL NAME / COMMON NAME	<u>CONT</u>	SPACING	<u>QTY</u>
	Hamamelis vernalis `Autumn Embers` / Ozark Witchhazel	5 gal	120" o.c.	1
DE	BOTANICAL NAME / COMMON NAME	<u>CONT</u>	SPACING	<u>QTY</u>
	Ilex glabra `Shamrock` / Inkberry	5 gal	48" o.c.	5
DE	BOTANICAL NAME / COMMON NAME	<u>CONT</u>	SPACING	<u>QTY</u>
	Allium x `Summer Beauty` / Summer Beauty Allium	1 gal	24" o.c.	28
	Liriope muscari `Majestic` / Majestic Liriope	1 gal	24" o.c.	19
)	Salvia nemorosa `Caradonna` / Cardonna Perennial Salvia	1 gal	18" o.c.	7
	Sedum x `Dazzleberry` / Dazzelberry Stonecrop	1 gal	18" o.c.	10



ISSUED Issued UDC Info Submittal— August 2, 2017 Issued UDC Info Submittal— November 1, 2017

PROJECT TITLE 222 N. Charter Street

Planting Plan SHEET TITLE


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42 WALL HUNGS _____ -----____ STAIR A #000 (2 HR) -0' _____ 3'-6" 5'-0" 3'-6" 5'-0" 40 FLOOR BIKES 8'-0" ∞ "0'2ا 5'-0" ELEV, #000 (2'HR) _____ _____ _____ _____ _____ 6'-0" 6'-0" 5'-11" \sim STAIR B #000 (2 HR) FIRE

A-1.0 BASEMENT PLAN




ISSUED Land Use Submittal - December 6, 2017

PROJECT TITLE
222 N. Charter Street

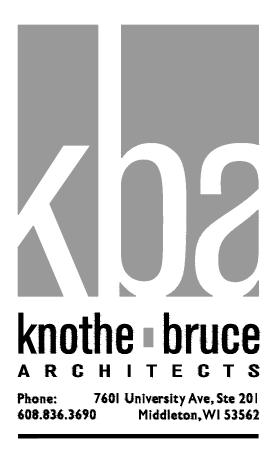sheet title Basement Plan


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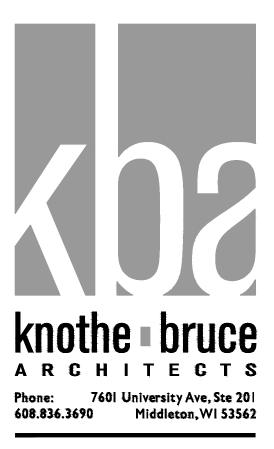
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I FIRST FLOOR PLAN



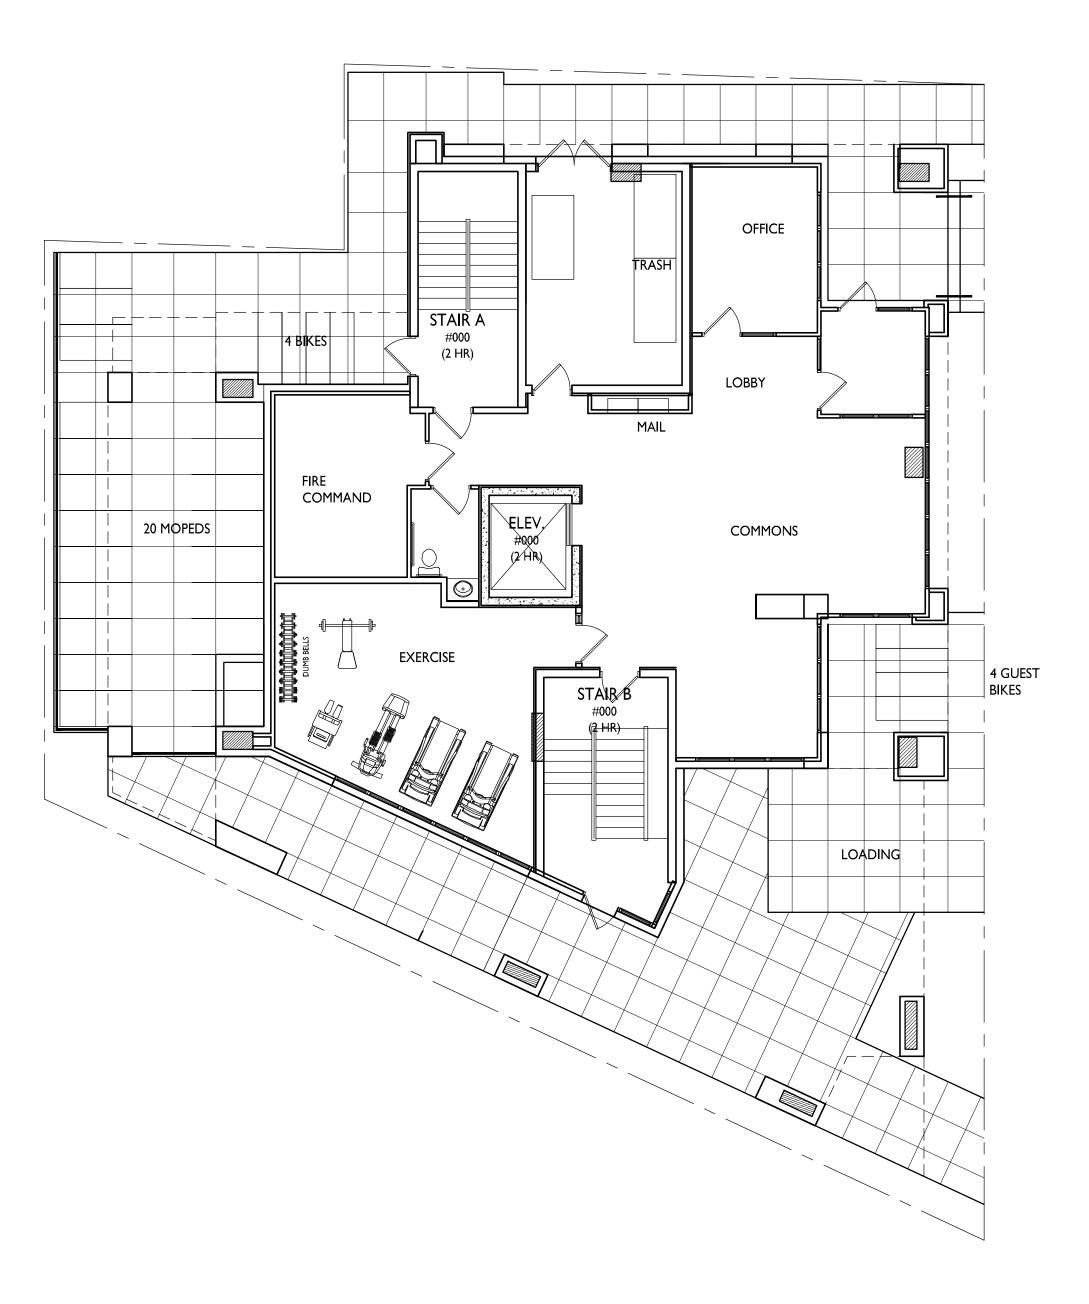


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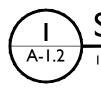
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222 N. Charter Street

sheet title First Floor Plan

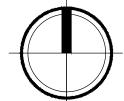
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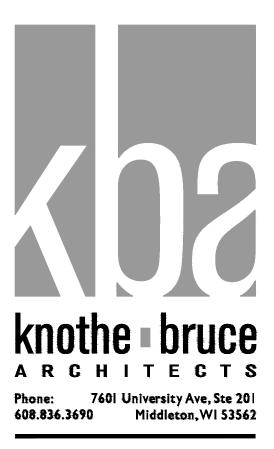
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I SECOND & THIRD FLOOR PLAN



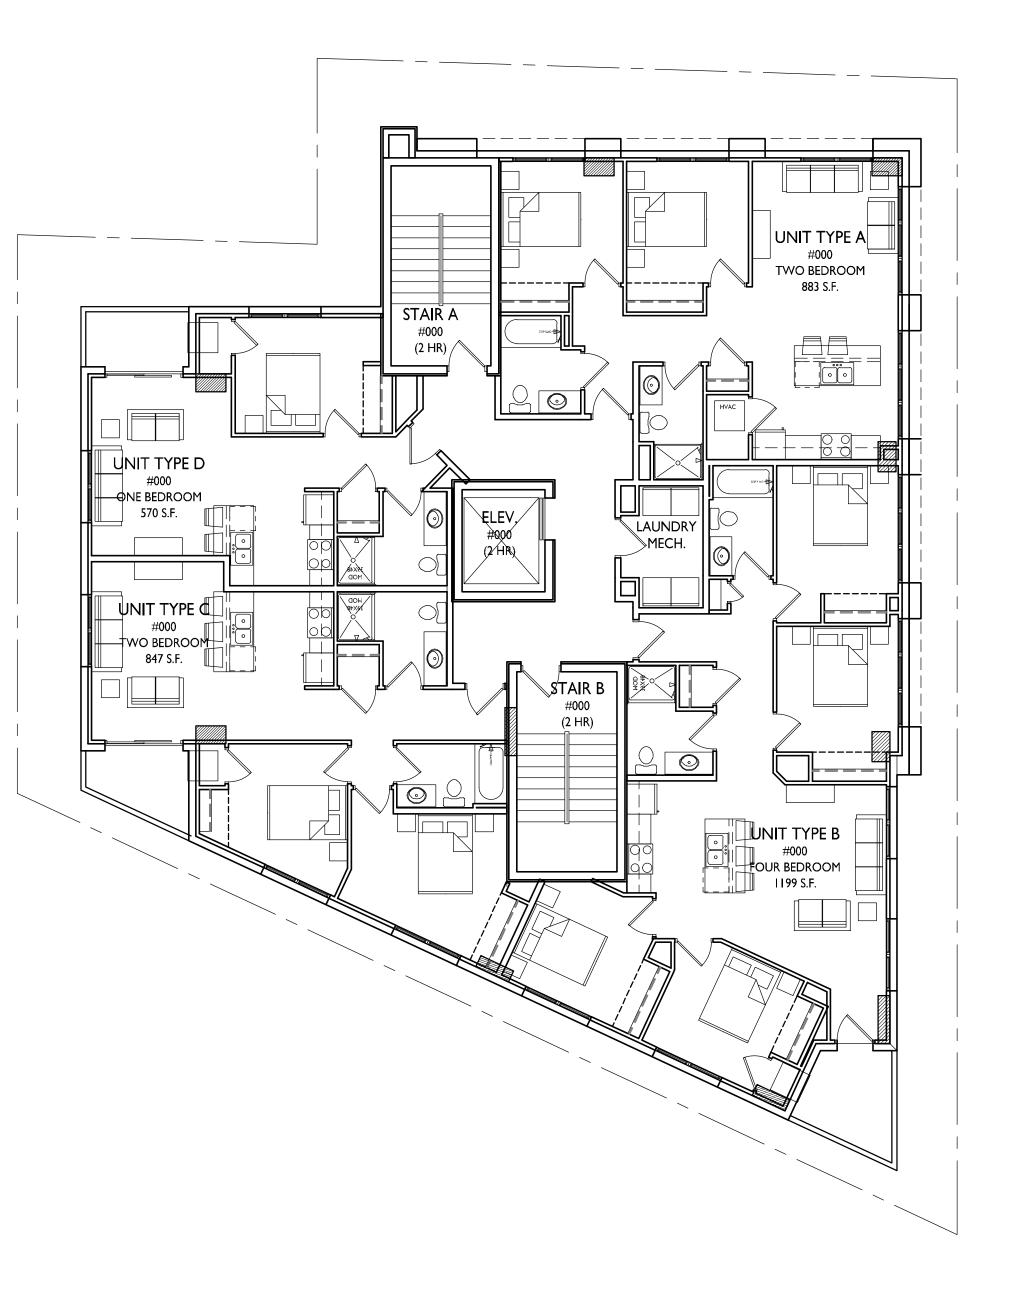


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PROJECT TITLE
222 N. Charter Street

SHEET TITLE
Second & Third Floor Plan

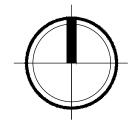
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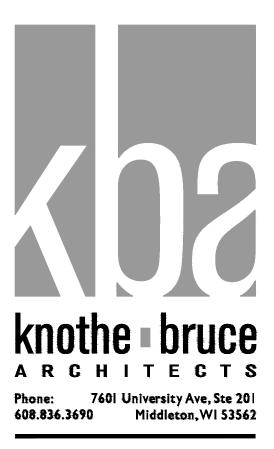
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I FOURTH-ELEVENTH FLOOR PLAN



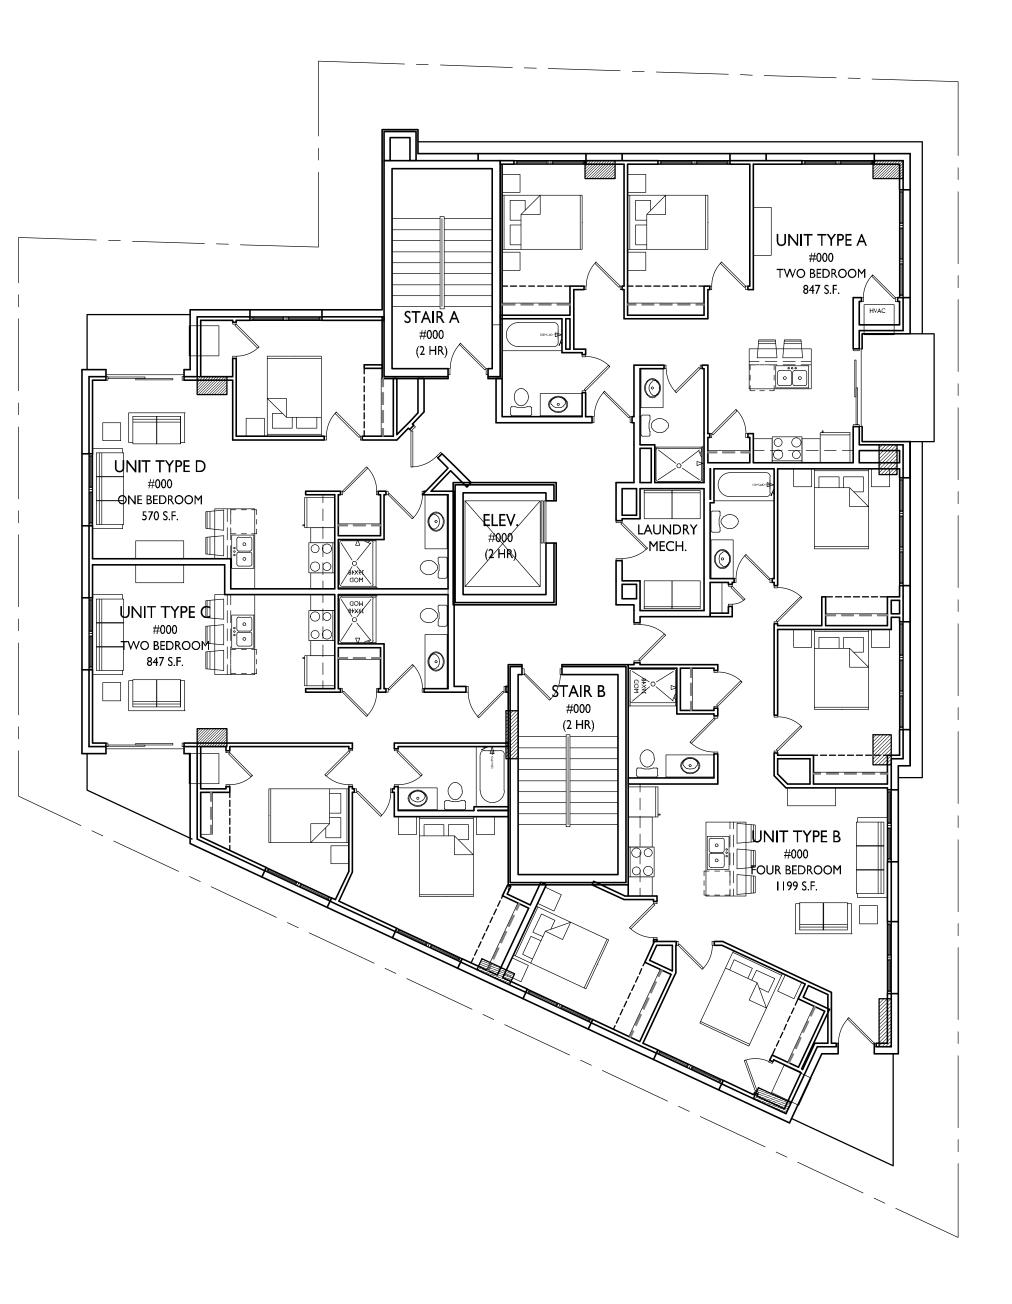


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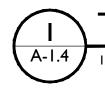
PROJECT TITLE
222 N. Charter Street

sheet title Fourth-Eleventh Floor Plan

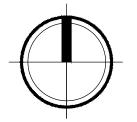
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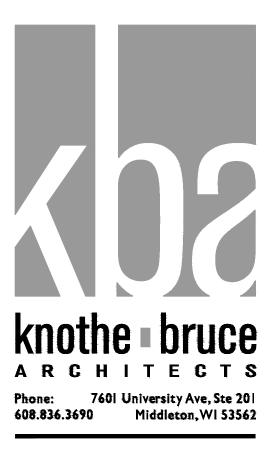
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I TWELFTH FLOOR PLAN



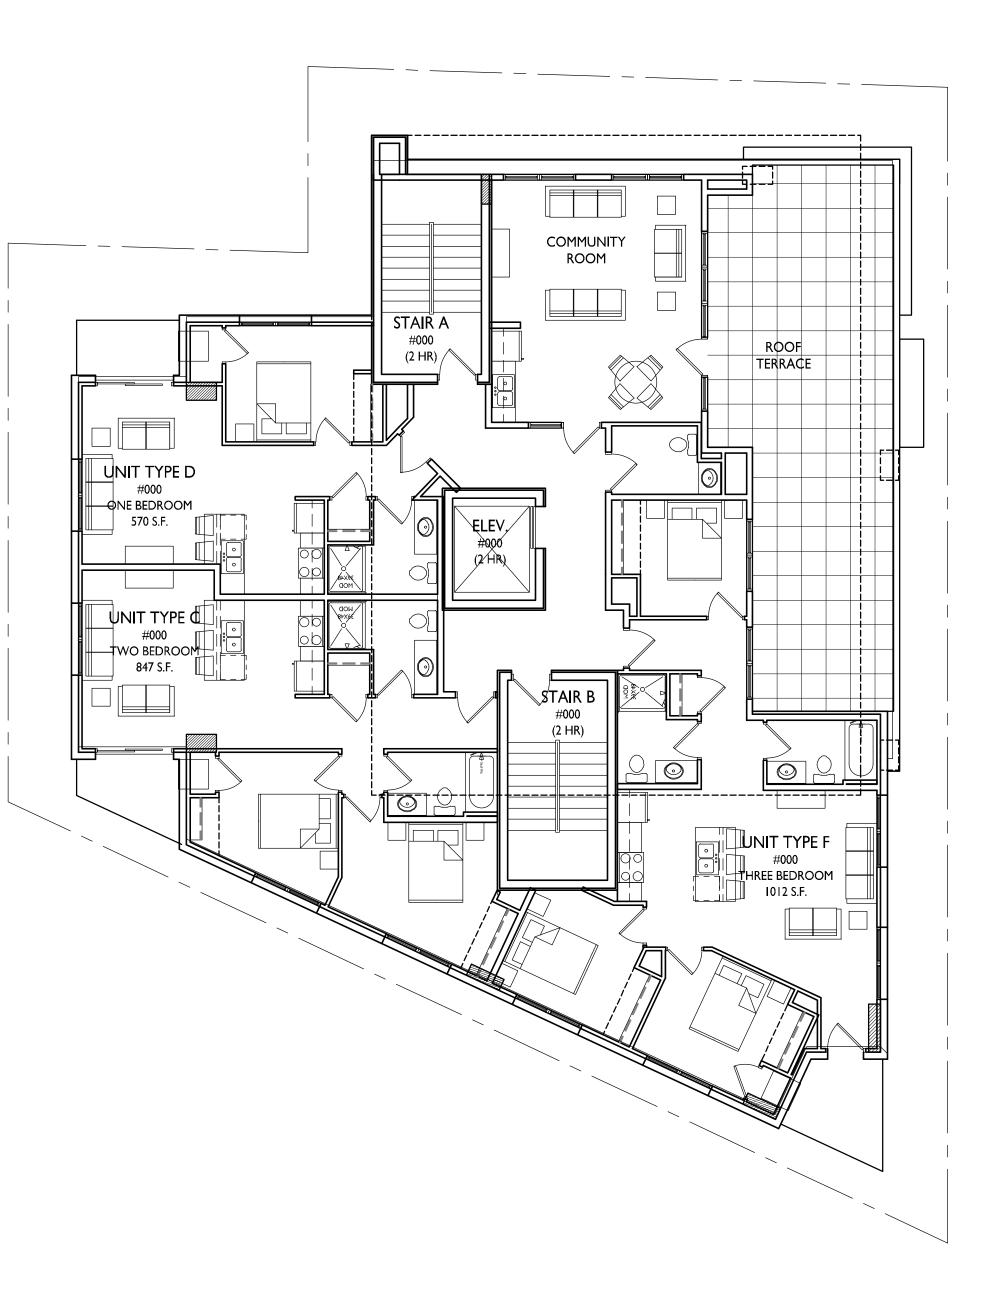


ISSUED Land Use Submittal - December 6, 2017

PROJECT TITLE
222 N. Charter Street

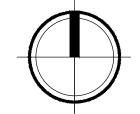sheet title **Twelfth Floor Plan**


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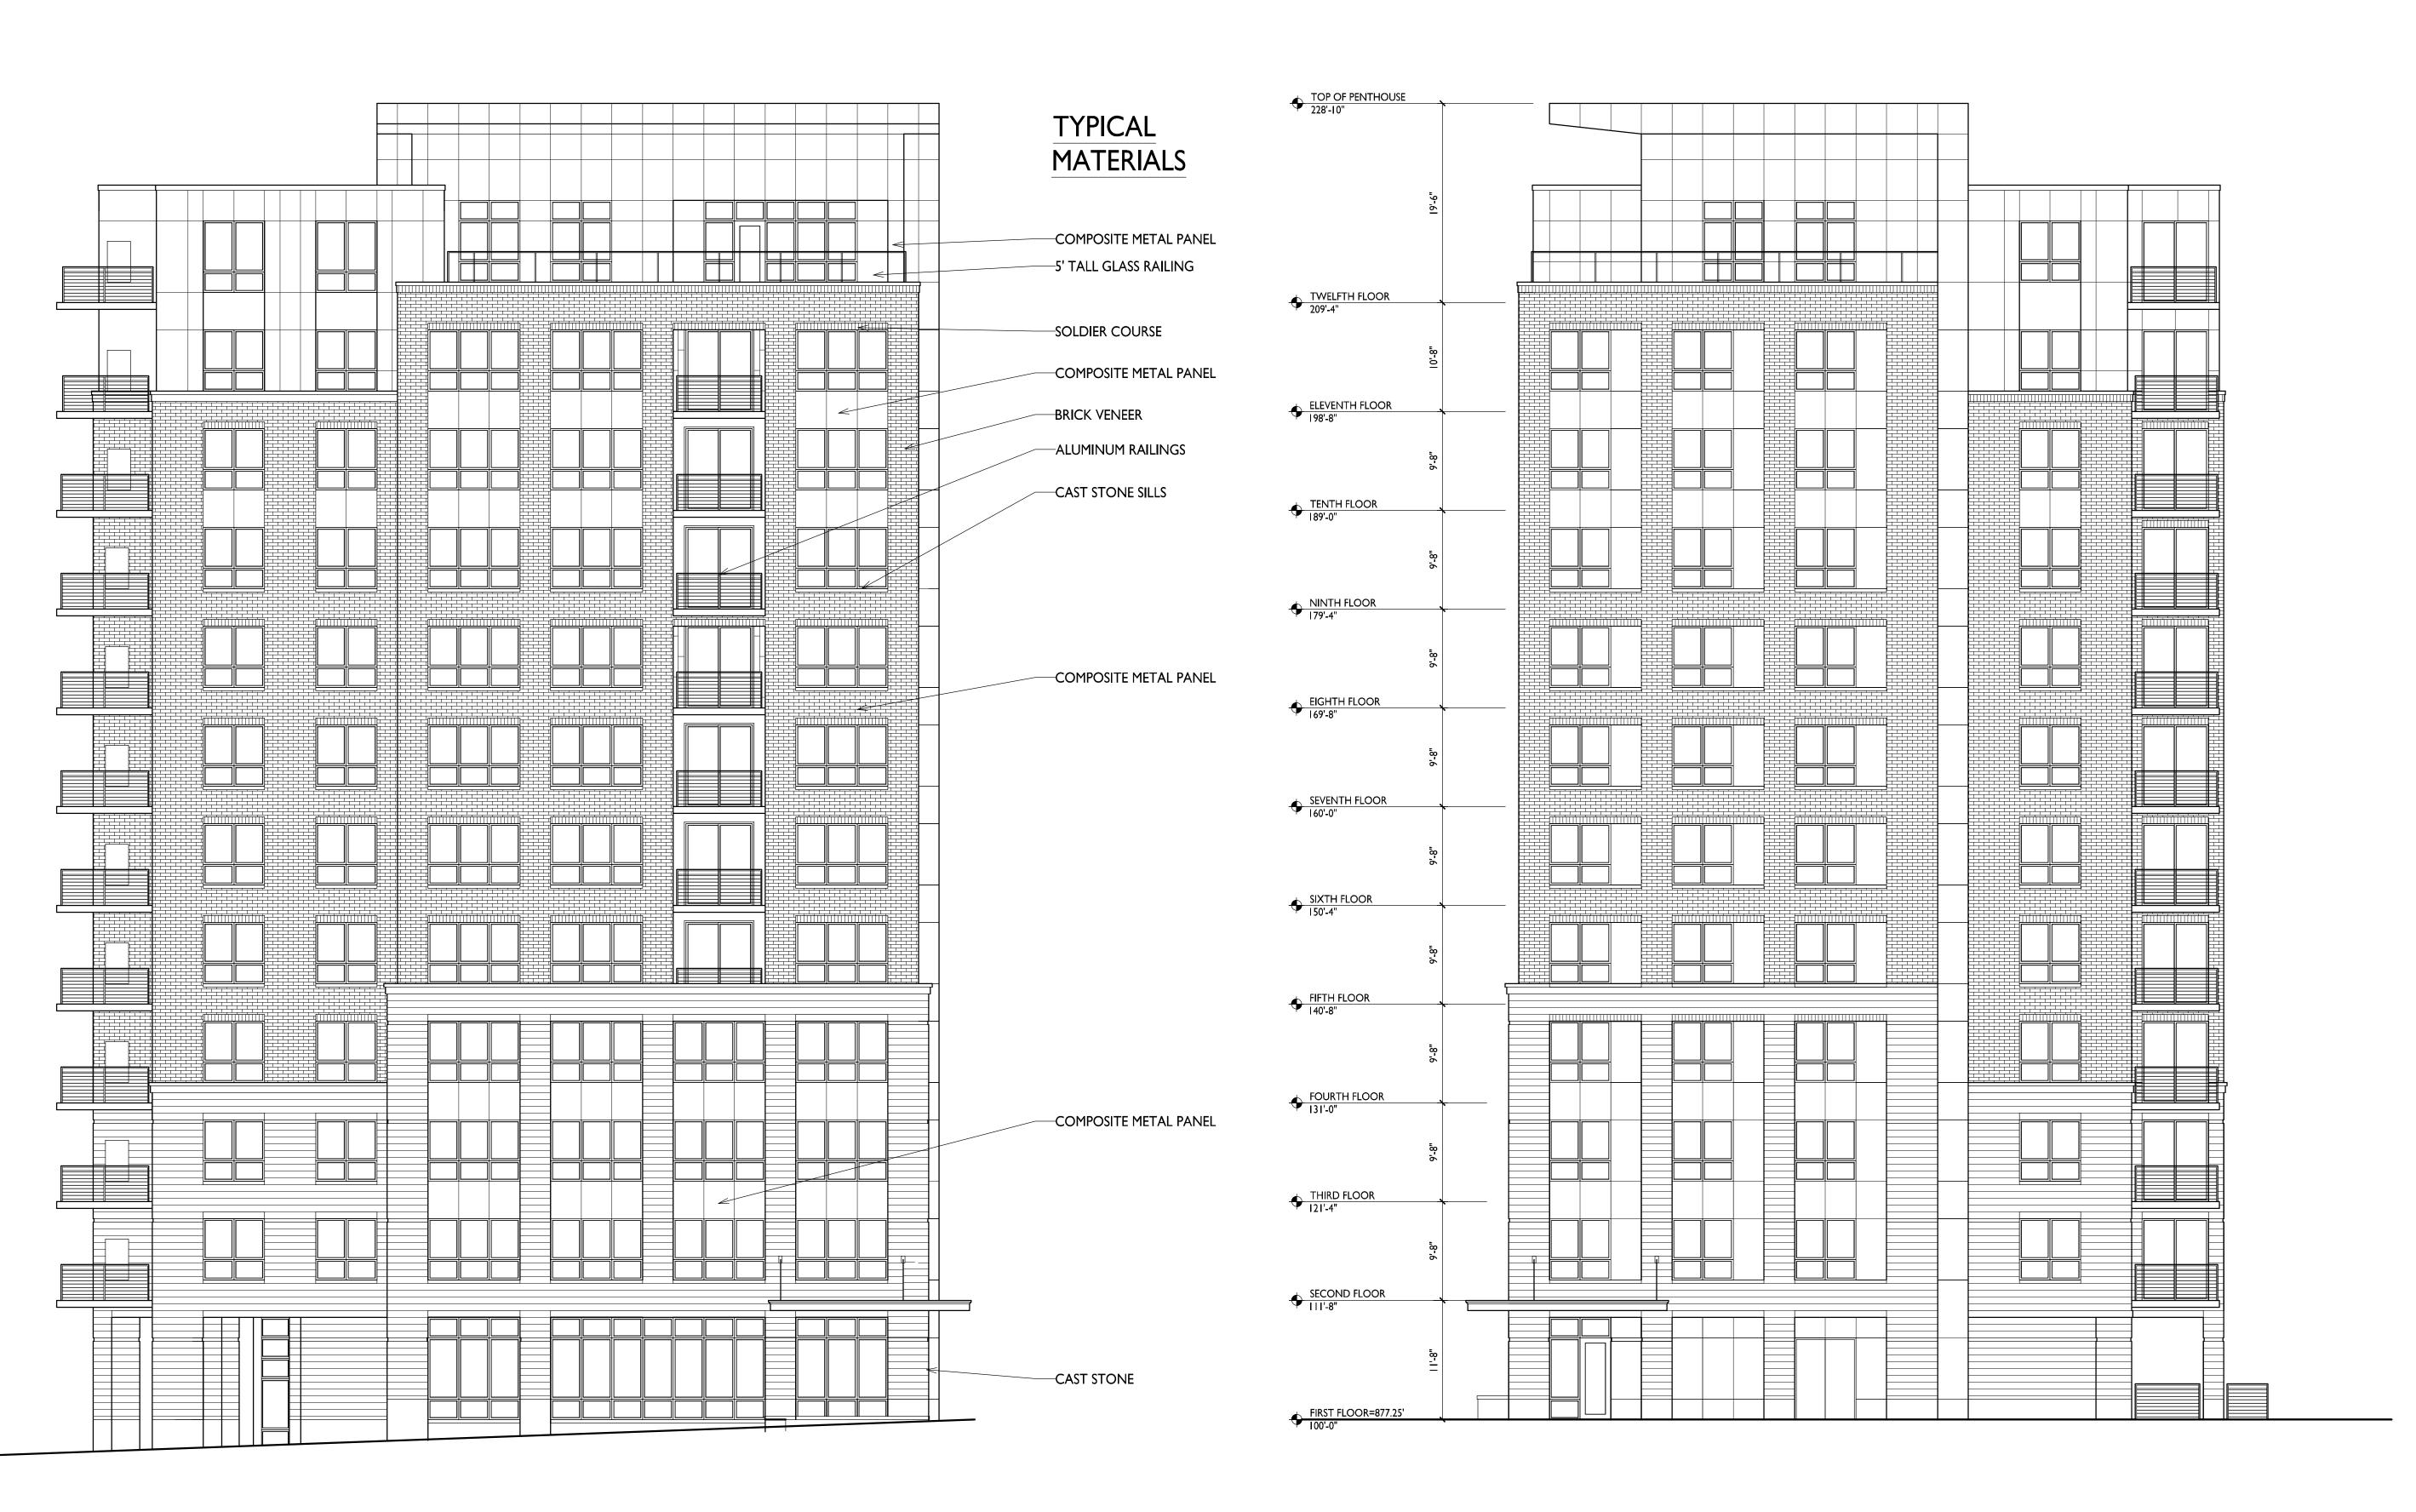
ISSUED Land Use Submittal - December 6, 2017

PROJECT TITLE
222 N. Charter Street

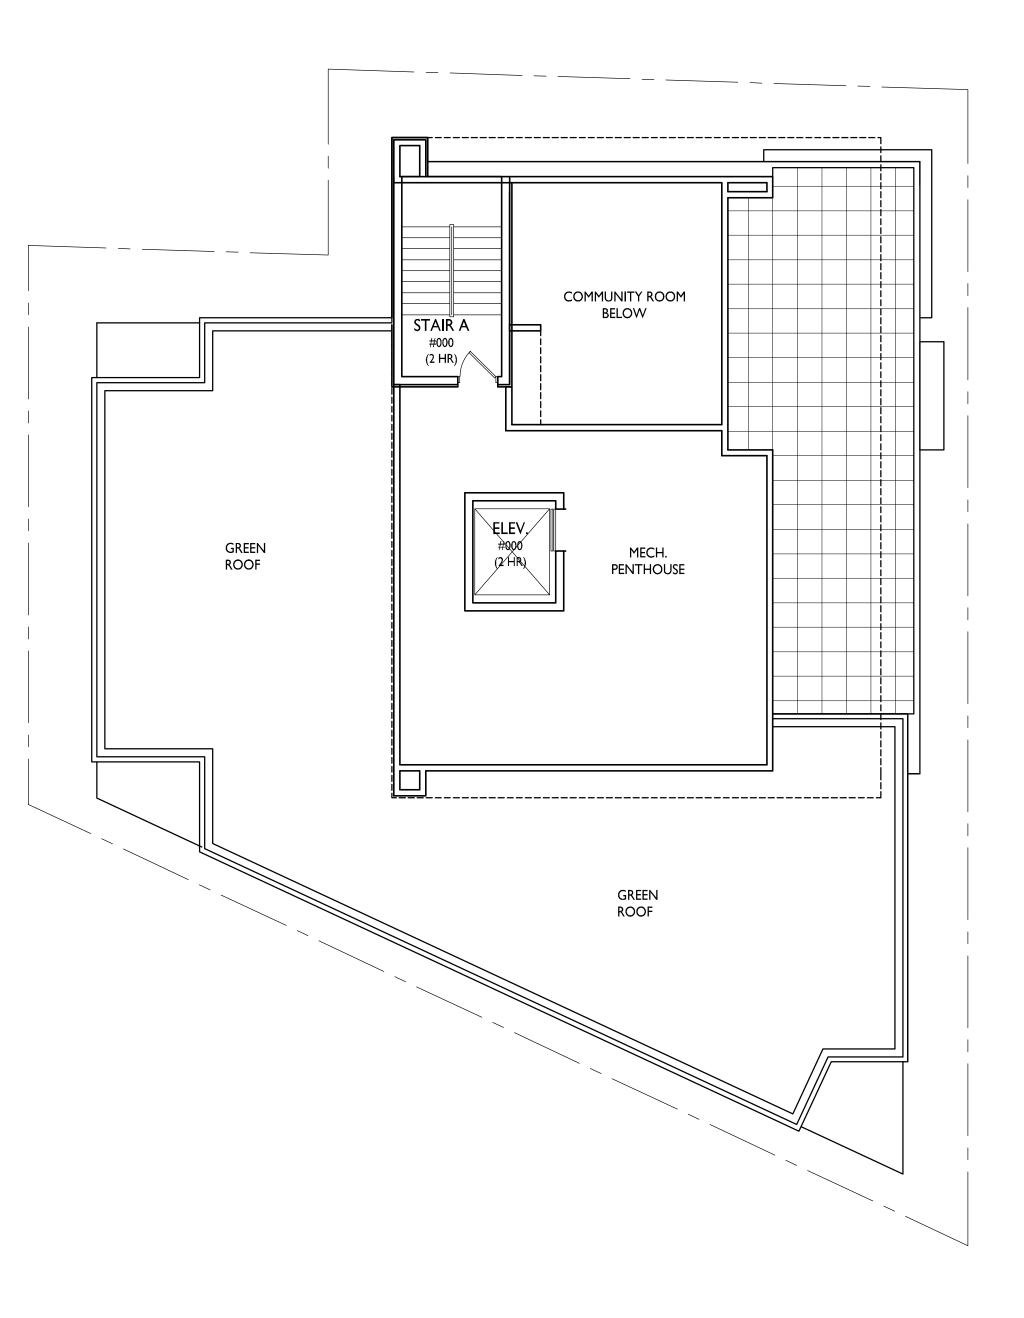sheet title Roof Plan


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2 A-2.1 NORTH ELEVATION

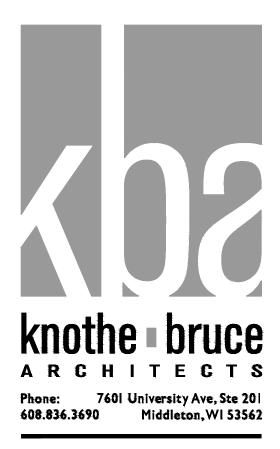


ISSUED Land Use Submittal - December 6, 2017

PROJECT TITLE 222 N. Charter Street

SHEET TITLE Elevations

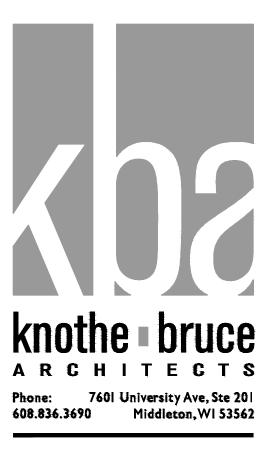SHEET NUMBER


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ISSUED Land Use Submittal - December 6, 2017

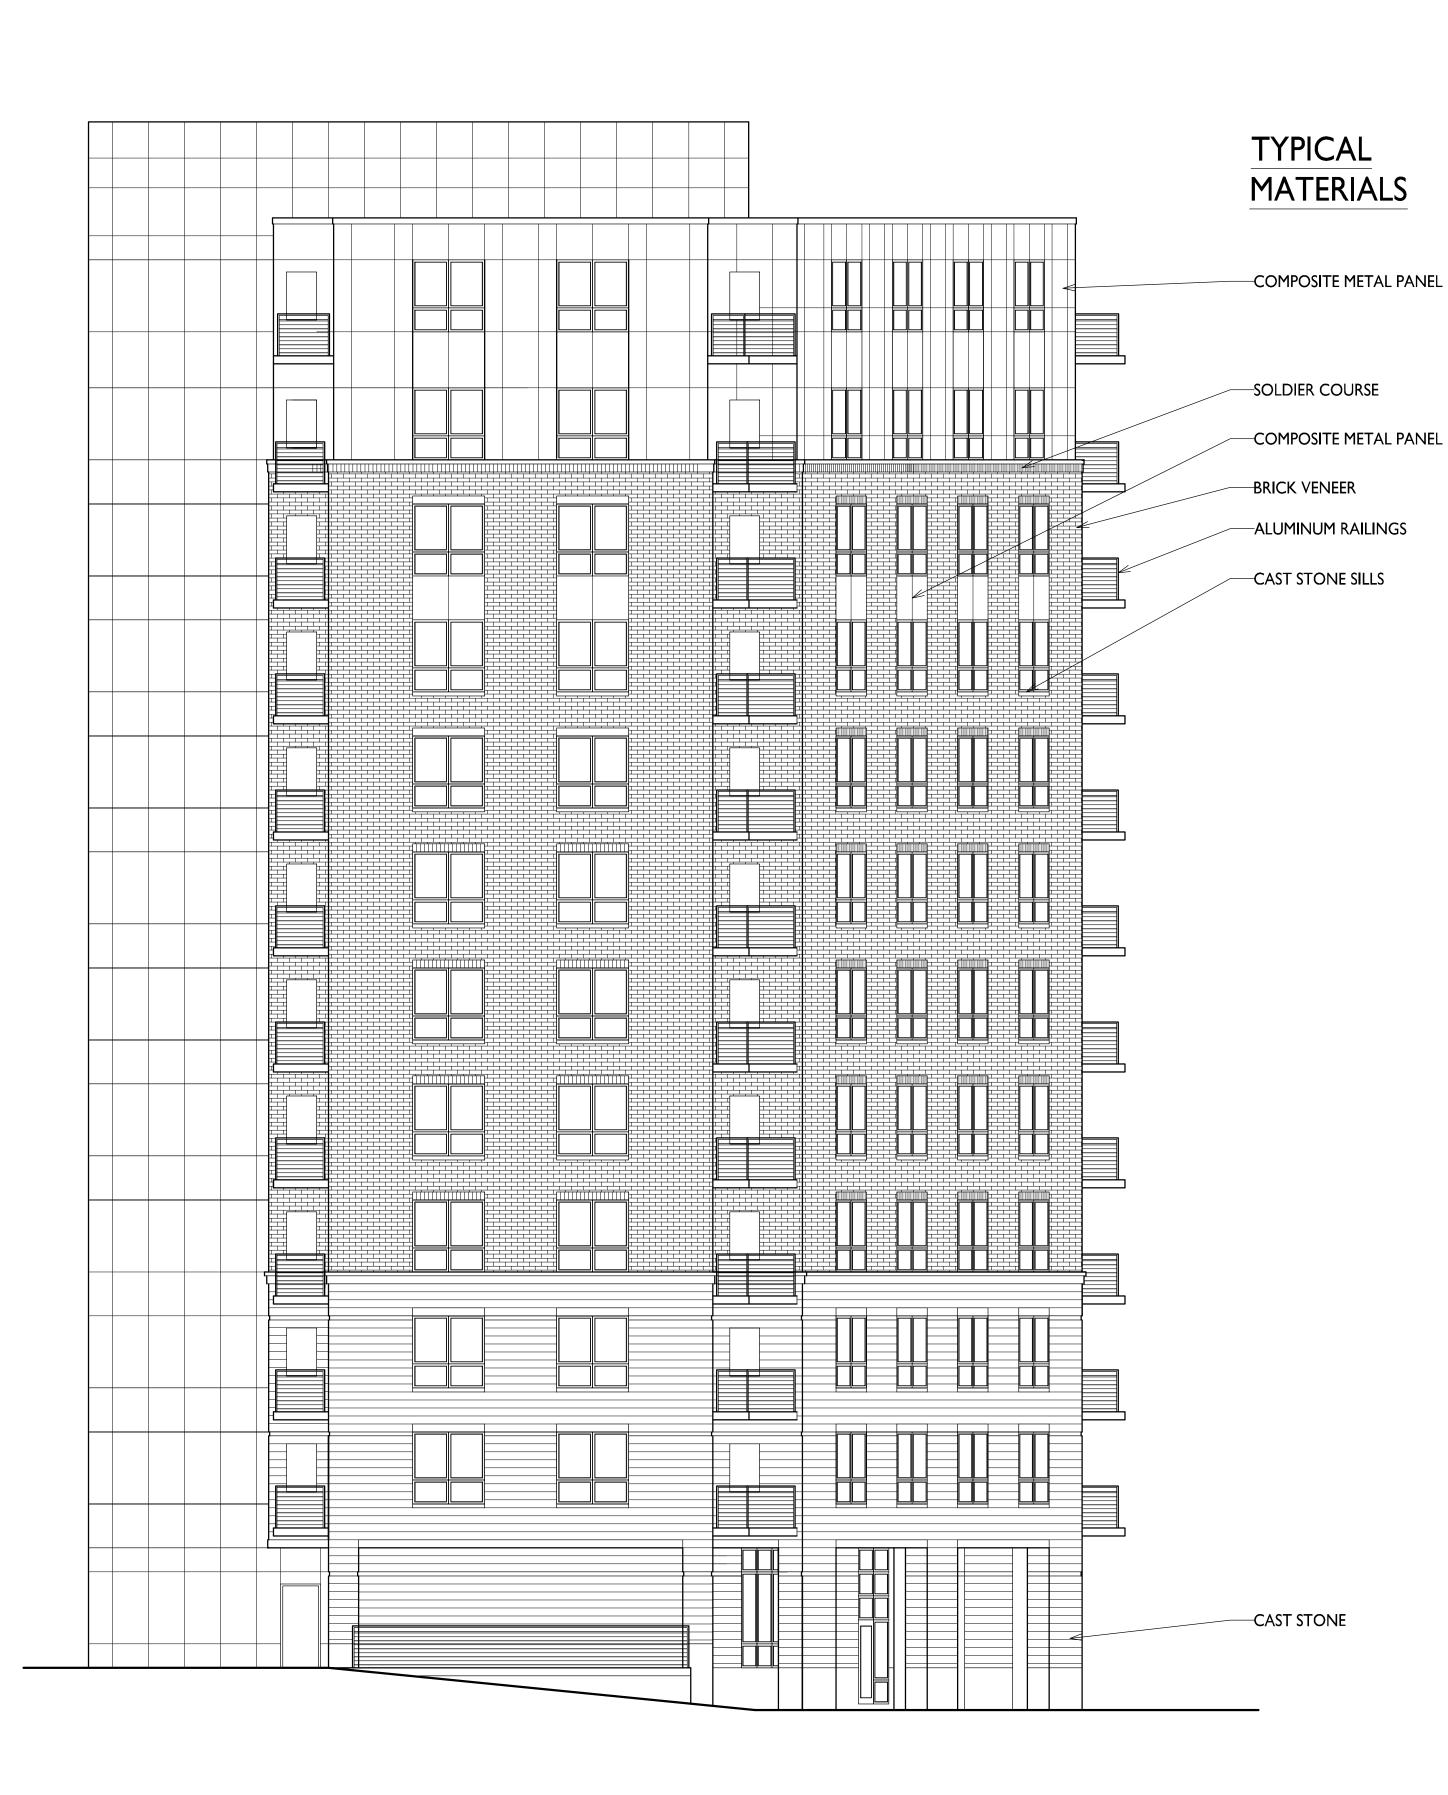PROJECT TITLE 222 N. Charter Street

SHEET TITLE Elevations

SHEET NUMBER

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A-2.3 222 N. Charter Street Madison, WI December 6, 2017

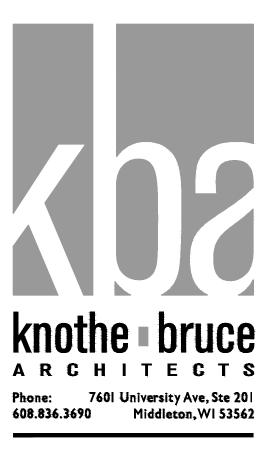



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A-2.4 222 N. Charter Street Madison, WI December 6, 2017

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A-2.5 222 N. Charter Street Madison, WI December 6, 2017

