

URBAN DESIGN COMMISSION APPLICATION CITY OF MADISON

This form may also be completed online at: http://www.cityofmadison.com/planning/documents/UDCapplication.pdf

215 Martin Luther King Jr. Blvd; Room LL-100 PO Box 2985; Madison, Wisconsin 53701-2985 Phone: 608.266.4635 | Facsimile: 608.267.8739

Please complete all sections of the application, including the desired meeting date and the type of action requested.

Date Submitted: November 16, 2016				
UDC Meeting Date: November 30, 2016		Initial Approval		
Combined Schedule Plan Commission Date (if applicable):		☐ Final Approval		
 Project Address: 4601 Frey Street Project Title (if any): Frey Street Mixed Use This is an application for (Check all that apply to this UDC application New Development Alteration to an Existing or Material Project Type: Project in an Urban Design District* (public hearing-\$300 for Project in the Downtown Core District (DC) or Urban 	Previously-Approved Dev			
 □ Suburban Employment Center (SEC) or Campus Instit □ Planned Development (PD) □ General Development Plan (GDP) □ Specific Implementation Plan (SIP) □ Planned Multi-Use Site or Planned Residential Comp 	tutional District (CI) or En			
B. Signage: Comprehensive Design Review* (public hearing-\$300 fee) Signage Exception(s) in an Urban Design District (public C. Other: Please specify:		ariance* (public hearing-\$300 fee)		
3. Applicant, Agent & Property Owner Information: Applicant Name: Frey Street Lodging Associates, LLC	Campany Raymond Ma	nagement Company		
Applicant Name: They Street Edging 73330dates, EE0 Street Address: 8333 Greenway Blvd., Suite 200	Company:	Zip: <u>53562</u>		
Telephone: (608-662-8334) Fax:()	Email: perkel@raymondte	eam.com		
Ducinet Contact Dayson, Josh Wilcox	Company: Gary Brink & A			
Street Address: 7780 Elmwood Avenue, Suite 204	City/State: Middleton/WI	Zip:		
Telephone: (608-829-1750) Fax: (608-829-3056)	crty/state josh.wilcox@garyb Email:	orink.com		
Project Owner (if not applicant) :	_			
Street Address:	City/State:	Zip:		
Telephone:() Fax:()	Email:			
 4. Applicant Declarations: A. Prior to submitting this application, the applicant is required to discuss application was discussed with Al Martin o 	n	n Design Commission staff. This		
(name of staff person) B. The applicant attests that all required materials are included in this sub the application deadline, the application will not be placed on an Urban D	(date of meeting) mittal and understands that if a esign Commission agenda for co	any required information is not provided by onsideration.		
Name of Applicant Josh Wilcox	Relationship to Property _	Architect		
Authorized Signature	Date11/16/16			



November 16, 2016

Al Martin City of Madison Urban Design Commission 215 Martin Luther King Jr. Blvd. Madison, WI 53717

Re: Frey Street Mixed Use

4601 Frey Street

UDC-Informational Submittal

Dear Al:

Enclosed, please find 14 sets of plans for the UDC meeting to be held on November 30, 2016. The proposed project, located at 4601 Frey Street, is a 12-story, 275,542 sf mixed use project with a 178 guest room hotel & office tenant. There will be 245 parking stalls (237 standard and 8 accessible).

Please feel free to contact me if you have further questions or need any additional information.

Sincerely,

Josh Wilcox Vice-President



FREY STREET - MIXED USE DEVELOPMENT

4601 FREY STREET MADISON, WISCONSIN

DESIGN REVIEW NOVEMBER 16, 2016

JOB #201525

PROJECT ROOM MATRIX

Bike 5talls

Total Site 5quare footage

	Double Queens		Kings			T-1-1	F
Floor	Standard D/Q	ACC D/Q	5tandard King	ACC KING	King "A"	Total	5quareFootage
G	0	0	0	0	0	0	34843
1	0	0	0	0	0	0	34843
2	0	0	0	0	0	0	35059
3	0	0	0	0	0	0	35059
4	0	0	0	0	0	0	30269
5	6	0	12	0	4	22	14999
6	9	1	12	0	4	26	14999
7	9	1	12	0	4	26	14999
8	9	1	12	0	4	26	14999
9	9	1	12	0	4	26	14999
10	9	1	12	0	4	26	14999
11	9	1	12	0	4	26	14999
Totals	60	6	84	0	28	170	
	66		112			178	275066
	379	%		63%		100%	<u> </u>

Bike 5talls

5ite Information

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Raymond

Company

DEVELOPER:

FREY STREET LODGING ASSOCIATES, LLC C/O RAYMOND MANAGEMENT COMPANY 8333 GREENWAY BLVD., SUITE 200 MIDDLETON. WISCONSIN 53562 PHONE: (608) 662-8334 Management

perkel@raymondteam.com, steinhauer@raymondteam.com PRINCIPAL CONTACT: BARY PERKEL, LISA STEINHAUER

ARCHITECTS GARY BRINK. & ASSOCIATES, INC.

ARCHITECT:

CIVIL ENGINEER

GARY BRINK & ASSOCIATES, INC. 7780 ELMWOOD AVENUE, SUITE 204 MIDDLETON, WISCONSIN 53562 PHONE: (608) 829-1750 josh.wilcox@garybrink.com PRINCIPAL CONTACT: JOSH WILCOX

20

43,549

LANDSCAPE ARCHITECT

KEN SAIKI DESIGN, INC. 303 S. PATTERSON, SUITE ONE MADISON, WISCONSIN 53703 PHONE: (608) 251-3600 EMAIL: amoilien@ksd-la.com PRINCIPAL CONTACT: ABBIE MOILIEN

STRUCTURAL ENGINEER

ONEIDA TOTAL INTEGRATED ENTERPRISES (OTIE) 5100 EASTPARK BLVD., SUITE 300 MADISON, WI 53718

PHONE: (608) 241-6717 jhall@otie.com

PRINCIPAL CONTACT: JAMES J. HALL


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999 FOURIER DRIVE, #201 MADISON, WISCONSIN 53717 PHONE: (608) 826-0532 tsch@vierbicher.com PRINCIPAL CONTACT: TIMOTHY SCHLEEPER

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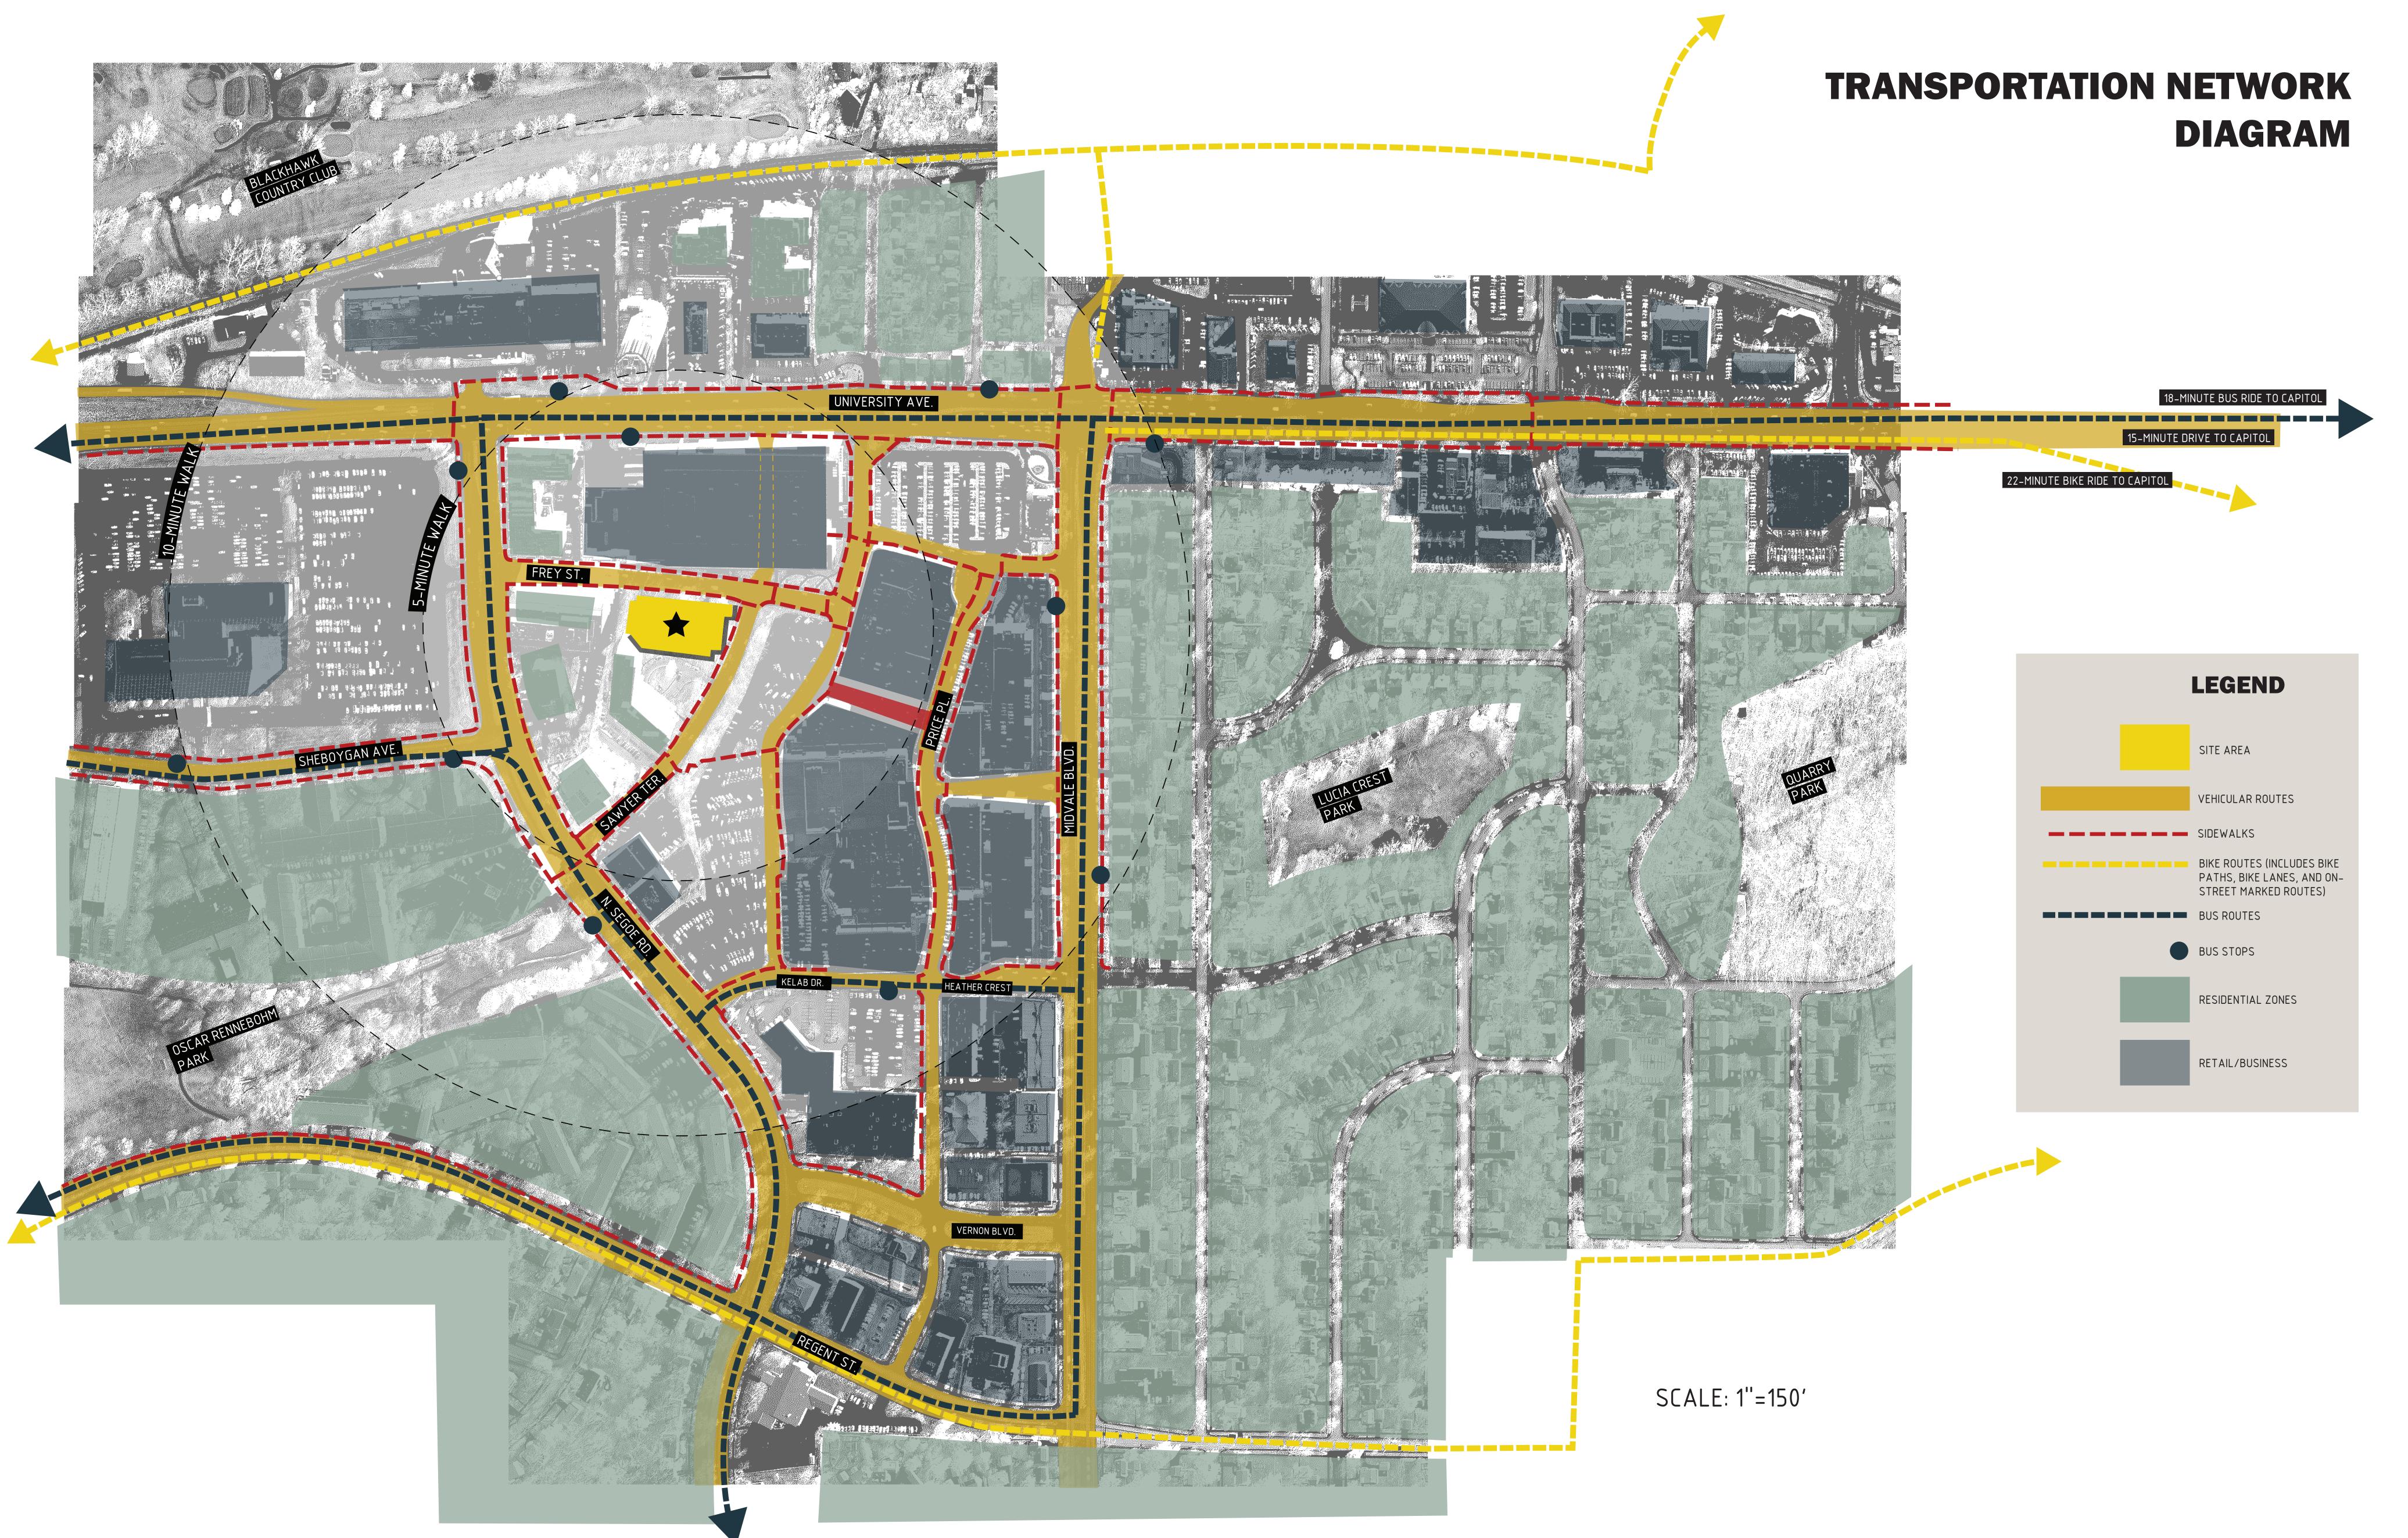






UDC #1

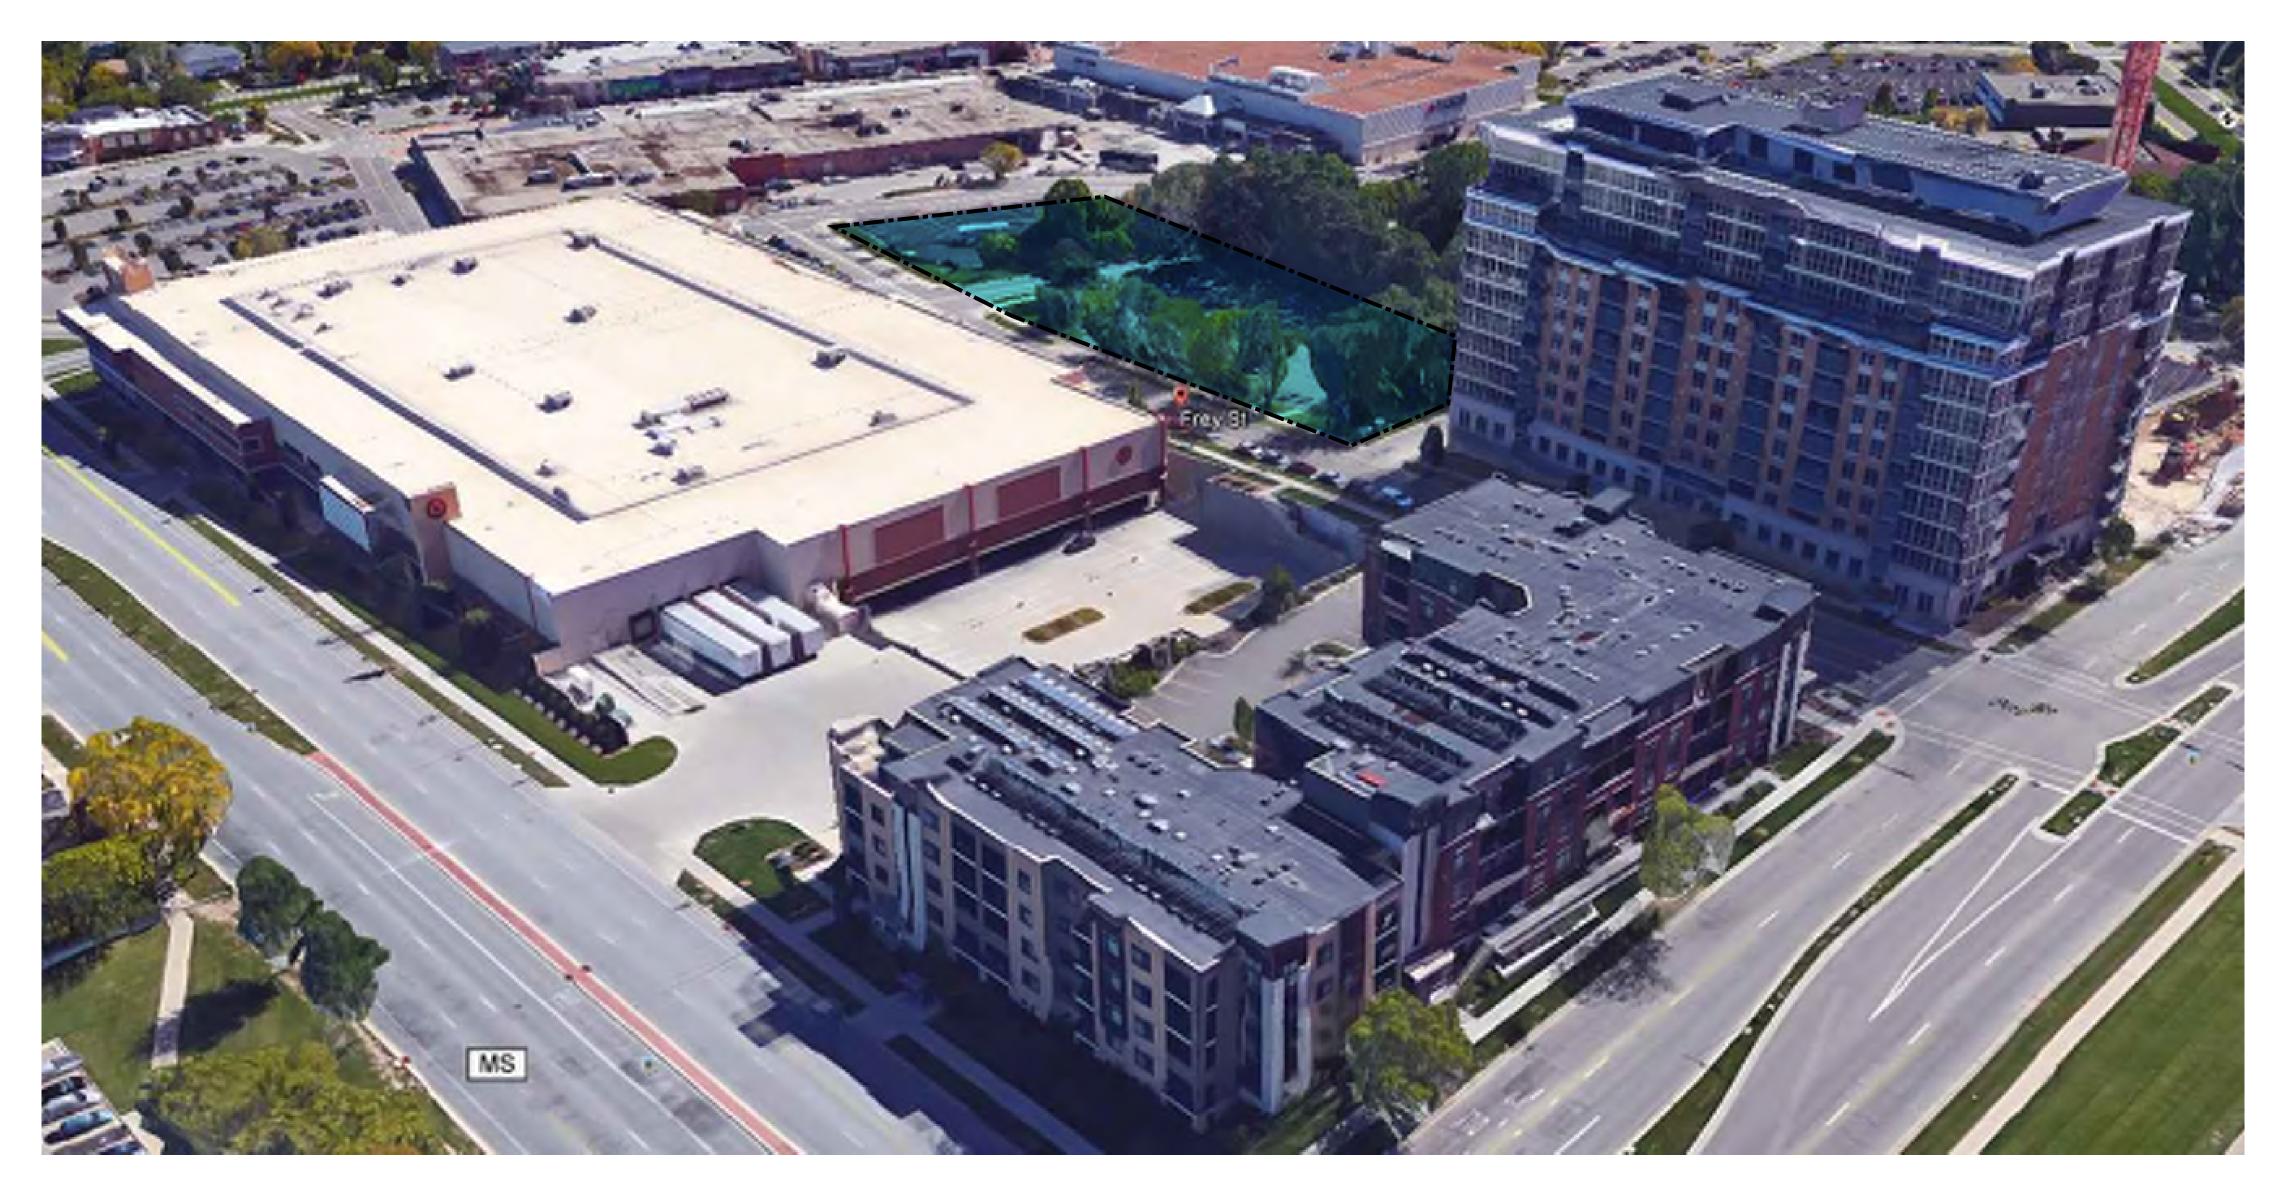



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DEMOLITION KEY:

1. CLEAR AND GRUB EXISTING TREE/BRUSH.

5. REMOVE EXISTING DRIVEWAY APRONS.

3. REMOVE EXISTING CURB & GUTTER (SEE DEMOLITION LEGEND).

6. REMOVE EXISTING PAVEMENT (SEE DEMOLITION LEGEND).

4. REMOVE EXISTING CONCRETE SIDEWALK (SEE DEMOLITION LEGEND).

2. COORDINATE THE REMOVAL/BURY OF THE EXISTING OVERHEAD POWER LINE/POLE WITH

GARY BRINK & ASSOCIATES
ARCHITECTS

7780 ELMWOOD AVE. STE. 204 MIDDLETON, WI 53562 608-829-1750 608-829-3056 (FAX)

DEMOLITION PLAN LEGEND ___x__x__ CURB AND GUTTER REMOVAL

BUILDING REMOVAL

UTILITY STRUCTURE REMOVAL

TREE REMOVAL

ASPHALT REMOVAL

CONCRETE REMOVAL

CLIENT:
FREY STREET LODGING A
C/O RAYMOND MANAGEN
8333 GREENWAY BOULEVARD
MIDDLETON, WI 53562

11-16-2016

C0.0

IE=910.14 SE

SITE CONSTRUCTION NOTES:

- 1. CONCRETE SIDEWALK TO BE 5" THICK, CONSTRUCTED ON A BASE OF 4" COMPACTED SAND OR CRUSHED STONE.
- 2. CONCRETE FOR DRIVEWAYS AND SIDEWALK AT DRIVEWAY ENTRANCES SHALL BE 7" THICK, CONSTRUCTED ON A BASE OF 5" COMPACTED SAND OR CRUSHED STONE.
- 3. CURB FACE HEIGHT IN DRIVEWAYS SHALL BE 6 INCHES. CURB FACE IN PARKING LOTS SHALL BE 4 INCHES.

4. CONTRACTOR SHALL DEEP TILL ANY DISTURBED AREAS AFTER CONSTRUCTION IS COMPLETE AND BEFORE RESTORING.

- 5. CONTRACTOR TO OBTAIN ANY NECESSARY UTILITY CONNECTION, DEMOLITION, DRIVEWAY CONNECTION, RIGHT-OF-WAY AND EXCAVATION PERMITS PRIOR TO CONSTRUCTION.
- 6. ALL ABANDONED DRIVEWAYS ADJACENT TO THE SITE SHALL BE REPLACED WITH CURB AND THE TERRACE SHALL BE RESTORED WITH
- 7. ANY SIDEWALK AND CURB & GUTTER ABUTTING THE PROPERTY SHALL BE REPLACED IF IT IS DAMAGED DURING CONSTRUCTION OR IF THE CITY ENGINEERING DEPARTMENT DETERMINES THAT IT IS NOT AT A DESIRABLE GRADE, REGARDLESS OF WHETHER THE CONDITION EXISTED PRIOR TO BEGINNING CONSTRUCTION.

DEMOLITION/EROSION CONTROL NOTES:

- 1. CONTRACTOR SHALL KEEP ALL CITY STREETS FREE AND CLEAR OF CONSTRUCTION RELATED DIRT/DUST/DEBRIS.
- 2. COORDINATE EXISTING UTILITY REMOVAL/ABANDONMENT WITH LOCAL AUTHORITIES AND UTILITY COMPANIES HAVING JURISDICTION.
- 3. ALL SAWCUTTING SHALL BE FULL DEPTH TO PROVIDE A CLEAN EDGE TO MATCH NEW CONSTRUCTION. MATCH EXISTING ELEVATIONS AT POINTS OF CONNECTION FOR NEW AND EXISTING PAVEMENT, CURB, SIDEWALKS, ETC. ALL SAWCUT LOCATIONS SHOWN ARE APPROXIMATE AND MAY BE FIELD ADJUSTED TO ACCOMMODATE CONDITIONS, JOINTS, MATERIAL TYPE, ETC. REMOVE MINIMUM AMOUNT NECESSARY FOR INSTALLATION OF PROPOSED IMPROVEMENTS.
- 4. CONTRACTOR SHALL PROVIDE AND SHALL BE RESPONSIBLE FOR ANY NECESSARY TRAFFIC CONTROL SIGNAGE AND SAFETY MEASURES DURING DEMOLITION AND CONSTRUCTION OPERATIONS WITHIN OR NEAR THE PUBLIC ROADWAY.
- 5. COORDINATE TREE REMOVAL WITH LANDSCAPE ARCHITECT. ALL TREES TO BE REMOVED SHALL BE REMOVED IN THEIR ENTIRETY AND STUMPS SHALL BE GROUND TO 12" BELOW PROPOSED SUBGRADE.
- 6. IF APPLICABLE, PROVIDE TREE PROTECTION FENCING PRIOR TO CONSTRUCTION OPERATIONS. MAINTAIN THROUGHOUT CONSTRUCTION.
- 7. ALL LIGHT POLES TO BE REMOVED FROM PRIVATE PROPERTY SHALL BE REMOVED IN THEIR ENTIRETY, INCLUDING BASE AND ALL APPURTENANCES. COORDINATE
- ABANDONMENT OF ELECTRICAL LINES WITH ELECTRICAL ENGINEER AND OWNER PRIOR TO DEMOLITION. 8. CONTRACTOR SHALL CLOSE ALL ABANDONED DRIVEWAYS BY REPLACING THE CURB IN FRONT OF THE DRIVEWAYS AND RESTORING THE TERRACE WITH GRASS.
- 9. CONTRACTOR SHALL OBTAIN ANY NECESSARY DEMOLITION AND UTILITY PLUGGING PERMITS.
- 10. THE LOCATION OF EXISTING UNDERGROUND UTILITIES AS SHOWN ON THE PLANS HAS BEEN DETERMINED FROM THE BEST AVAILABLE INFORMATION AND IS GIVEN FOR THE CONVENIENCE OF THE CONTRACTOR. THE OWNER AND THE ENGINEER DO NOT ASSUME RESPONSIBILITY IN THE EVENT THAT DURING CONSTRUCTION, UTILITIES OTHER THAN THOSE SHOWN MAY BE ENCOUNTERED, AND THAT THE ACTUAL LOCATION OF THOSE WHICH ARE SHOWN MAY BE DIFFERENT FROM THE LOCATION AS SHOWN ON THE PLANS.
- 11. ANY DAMAGE TO THE CITY PAVEMENT, INCLUDING DAMAGE RESULTING FROM CURB REPLACEMENT, WILL REQUIRE RESTORATION IN ACCORDANCE WITH THE CITY ENGINEERING PATCHING CRITERIA.

SITE PLAN LEGEND PROPERTY BOUNDARY CURB AND GUTTER (REVERSE CURB HATCHED)

PROPOSED CONCRETE PROPOSED SIGN PROPOSED LIGHT POLE





GARY BRINK & ASSOCIATES


ARCHITECTS

7780 ELMWOOD AVE. STE. 204

MIDDLETON, WI 53562

608-829-3056 (FAX)

608-829-1750

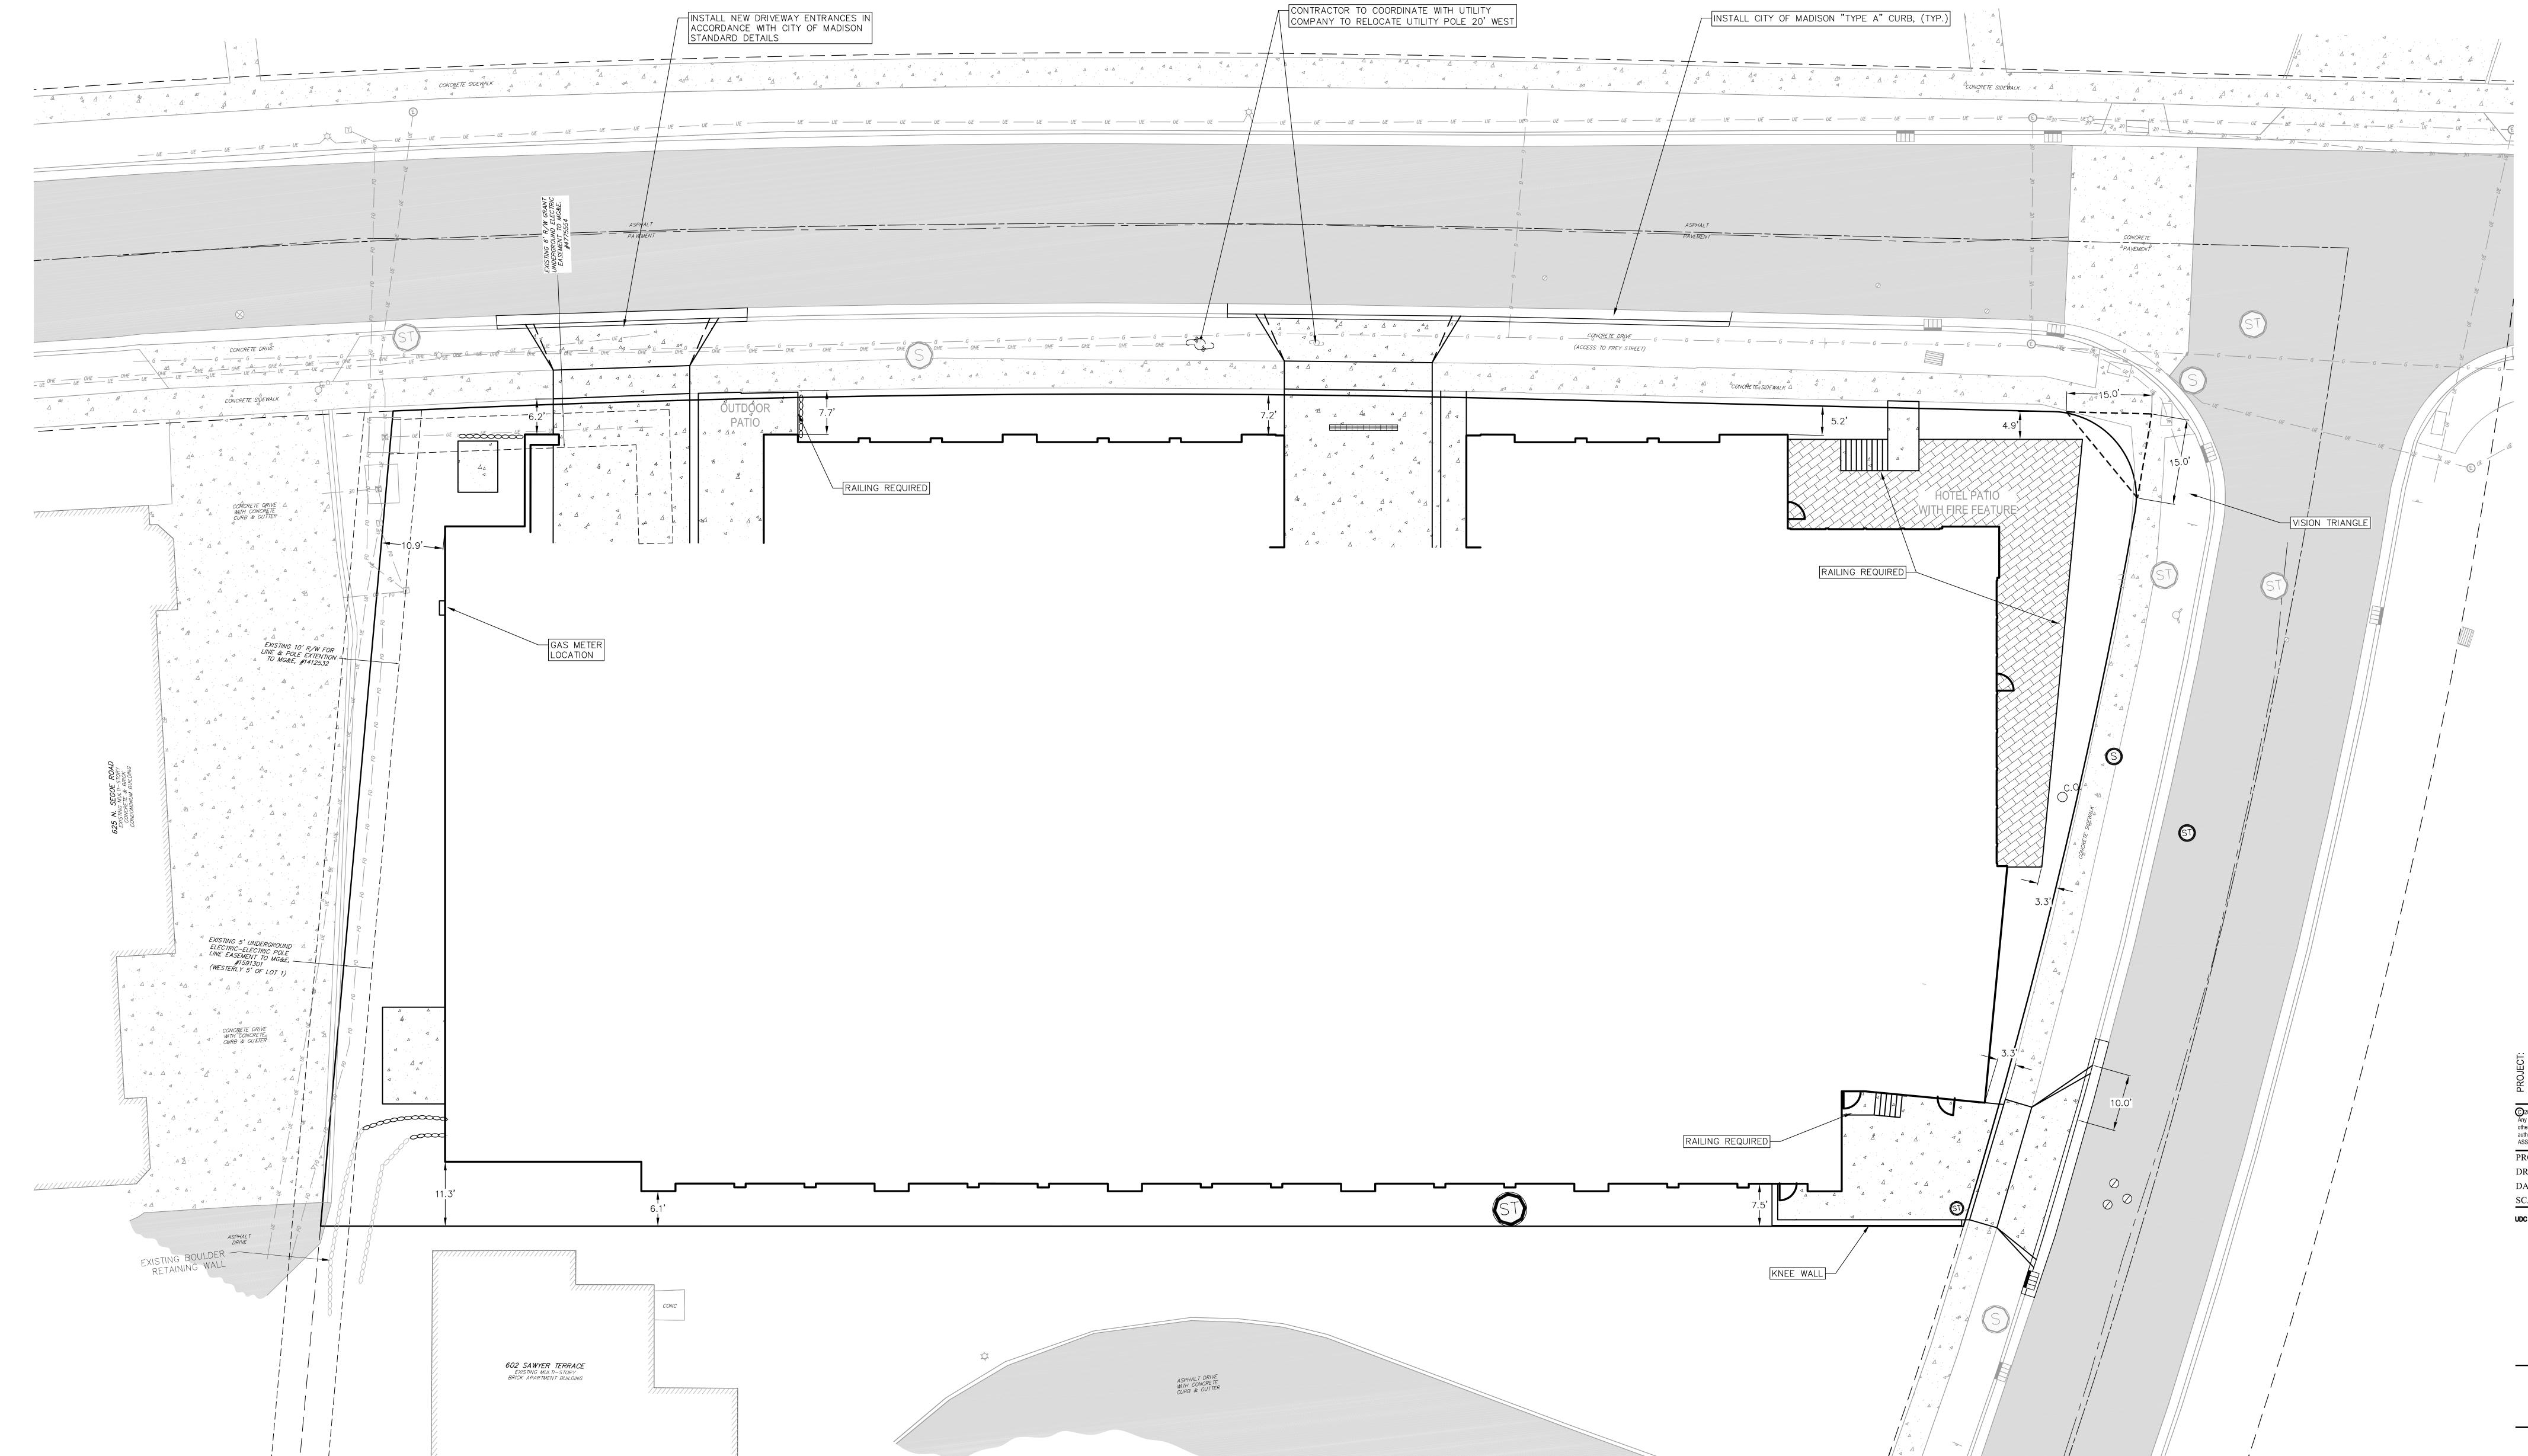

SITE PLAN

GRADING NOTES:


- 1. CONTOURS ARE SHOWN FOR PURPOSES OF INDICATING ROUGH GRADING. FINAL GRADE SHALL BE ESTABLISHED ON PAVED SURFACES BY USING SPOT GRADES ONLY.
- 2. SEE DETAIL SHEETS FOR EROSION CONTROL NOTES AND CONSTRUCTION SEQUENCE.
- 3. INSTALL A 50'L X 20'W X 1.5'D TRACKING PAD AT THE SITE ENTRANCE. THE TRACKING PAD SHALL BE MAINTAINED/REPAIRED 16. LONGITUDINAL GRADE OF SIDEWALK RAMPS SHALL NOT EXCEED 8.33% (1:12) AND SHALL BE IN ACCORDANCE WITH ADA AS NECESSARY TO ACCOMMODATE CONSTRUCTION.
- 4. THE CONTRACTOR IS REQUIRED TO MAKE EROSION CONTROL INSPECTIONS AT THE END OF EACH WEEK AND WHEN 0.5 INCHES 17. LONGITUDINAL GRADE OF SIDEWALK SHALL NOT EXCEED 5.0% OR THE ADJACENT STREET GRADE WHICHEVER IS GREATER. OF RAIN FALLS WITHIN 24 HOURS. INSPECTION REPORTS SHALL BE PREPARED AND FILED AS REQUIRED BY THE DNR. ALL MAINTENANCE/REPAIR WILL FOLLOW AN INSPECTION WITHIN 24 HOURS.
- 5. INSTALL WI DOT TYPE D INLET PROTECTION IN EXISTING CURB INLETS AND WI DOT TYPE A IN FIELD INLETS.
- 6. THE CONTRACTOR IS RESPONSIBLE FOR ANY DAMAGE CAUSED DURING CONSTRUCTION TO PUBLIC PROPERTY, PRIVATE PROPERTY OR UTILITIES.
- 7. THE CONTRACTOR SHALL SUBMIT SHOP DRAWINGS FOR REVIEW BY THE ENGINEER, PRIOR TO PLACING AN ORDER OF ANY SUCH ITEM.
- SHALL VERIFY TOPOGRAPHIC INFORMATION PRIOR TO STARTING CONSTRUCTION. 9. CONTRACTOR SHALL FIELD VERIFY LOCATION OF EXISTING SANITARY SEWER, STORM SEWER AND WATER MAIN PRIOR TO

8. EXISTING TOPOGRAPHIC INFORMATION IS BASED ON FIELD OBSERVATIONS AND/OR PLAN OF RECORD DRAWINGS. CONTRACTOR

- CONSTRUCTION TO ENSURE PROPER CLEARANCE OF THE NEW UTILITIES. CONTRACTOR MUST TAKE ALL NECESSARY PRECAUTIONS TO PROTECT THE EXISTING UTILITIES DURING CONSTRUCTION. ANY DAMAGE TO THE EXISTING UTILITIES AND ANY REPAIRS NEEDED AS A RESULT OF THE DAMAGE SHALL BE AT THE EXPENSE OF THE CONTRACTOR REGARDLESS OF THE LOCATION MARKED IN THE FIELD OR SHOWN ON THE PLANS.
- 10. THE LOCATIONS OF EXISTING UTILITY INSTALLATIONS AS SHOWN ON THE PLAN ARE APPROXIMATE. THERE MAY BE OTHER UTILITY INSTALLATIONS WITHIN THE PROJECT AREA THAT ARE NOT SHOWN. CONTRACTOR SHALL BE RESPONSIBLE FOR CONTACTING DIGGERS HOTLINE AND LOCATING ALL EXISTING UTILITIES AND ENSURE PROPER CLEARANCE OF NEW UTILITIES.
- 11. SEE DETAIL SHEETS FOR EROSION CONTROL NOTES AND CONSTRUCTION SEQUENCE.
- 12. THE CONTRACTOR SHALL REMOVE ANY SEDIMENT TRACKED ONTO ADJACENT ROADS BY MEANS OF STREET SWEEPING (NOT FLUSHING) AT A MINIMUM OF THE END OF EACH WORK DAY OR MORE AS NEEDED.
- 13. RIGHT OF WAY (ROW) AND PROPERTY LINES ARE APPROXIMATE. CONTRACTOR SHALL BE RESPONSIBLE FOR PROTECTING EXISTING PROPERTY CORNER MONUMENTATION. ANY MONUMENTS DISTURBED BY CONTRACTOR SHALL BE REPLACED AT THE CONTRACTORS EXPENSE.

- 14. CONTRACTOR SHALL COORDINATE WITH DRY UTILITY COMPANY'S REGARDING ANY POTENTIAL CONFLICTS AND COORDINATE RELOCATIONS AS MAY BE REQUIRED. CONTRACTOR SHALL ALSO COORDINATE THE PROPOSED INSTALLATION OF NEW FACILITIES
- 15. CROSS-SLOPE OF SIDEWALKS SHALL BE 2% UNLESS OTHERWISE NOTED.
- REQUIREMENTS.
- 18. ACCESSIBLE ROUTES SHALL BE 5% MAX LONGITUDINAL SLOPE AND 2% MAX CROSS SLOPE. ACCESSIBLE LOADING AREAS OR
- LANDINGS SHALL BE 2% MAX SLOPE IN ANY DIRECTION. RAMPS SHALL BE 8.33% MAX SLOPE.

GRADING LEGEND — -820 — EXISTING MAJOR CONTOURS ---818--- EXISTING MINOR CONTOURS PROPOSED MAJOR CONTOURS DRAINAGE DIRECTION PROPOSED SLOPE ARROWS ++1048.61 EXISTING SPOT ELEVATIONS PROPOSED SPOT ELEVATIONS INLET PROTECTION EROSION MAT CLASS____ TRACKING PAD

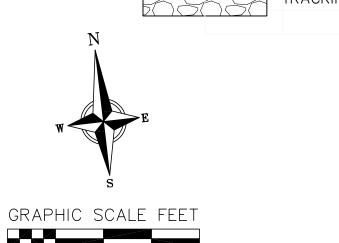



GARY BRINK & ASSOCIATES


ARCHITECTS

7780 ELMWOOD AVE. STE. 204

MIDDLETON, WI 53562

608-829-3056 (FAX)

608-829-1750

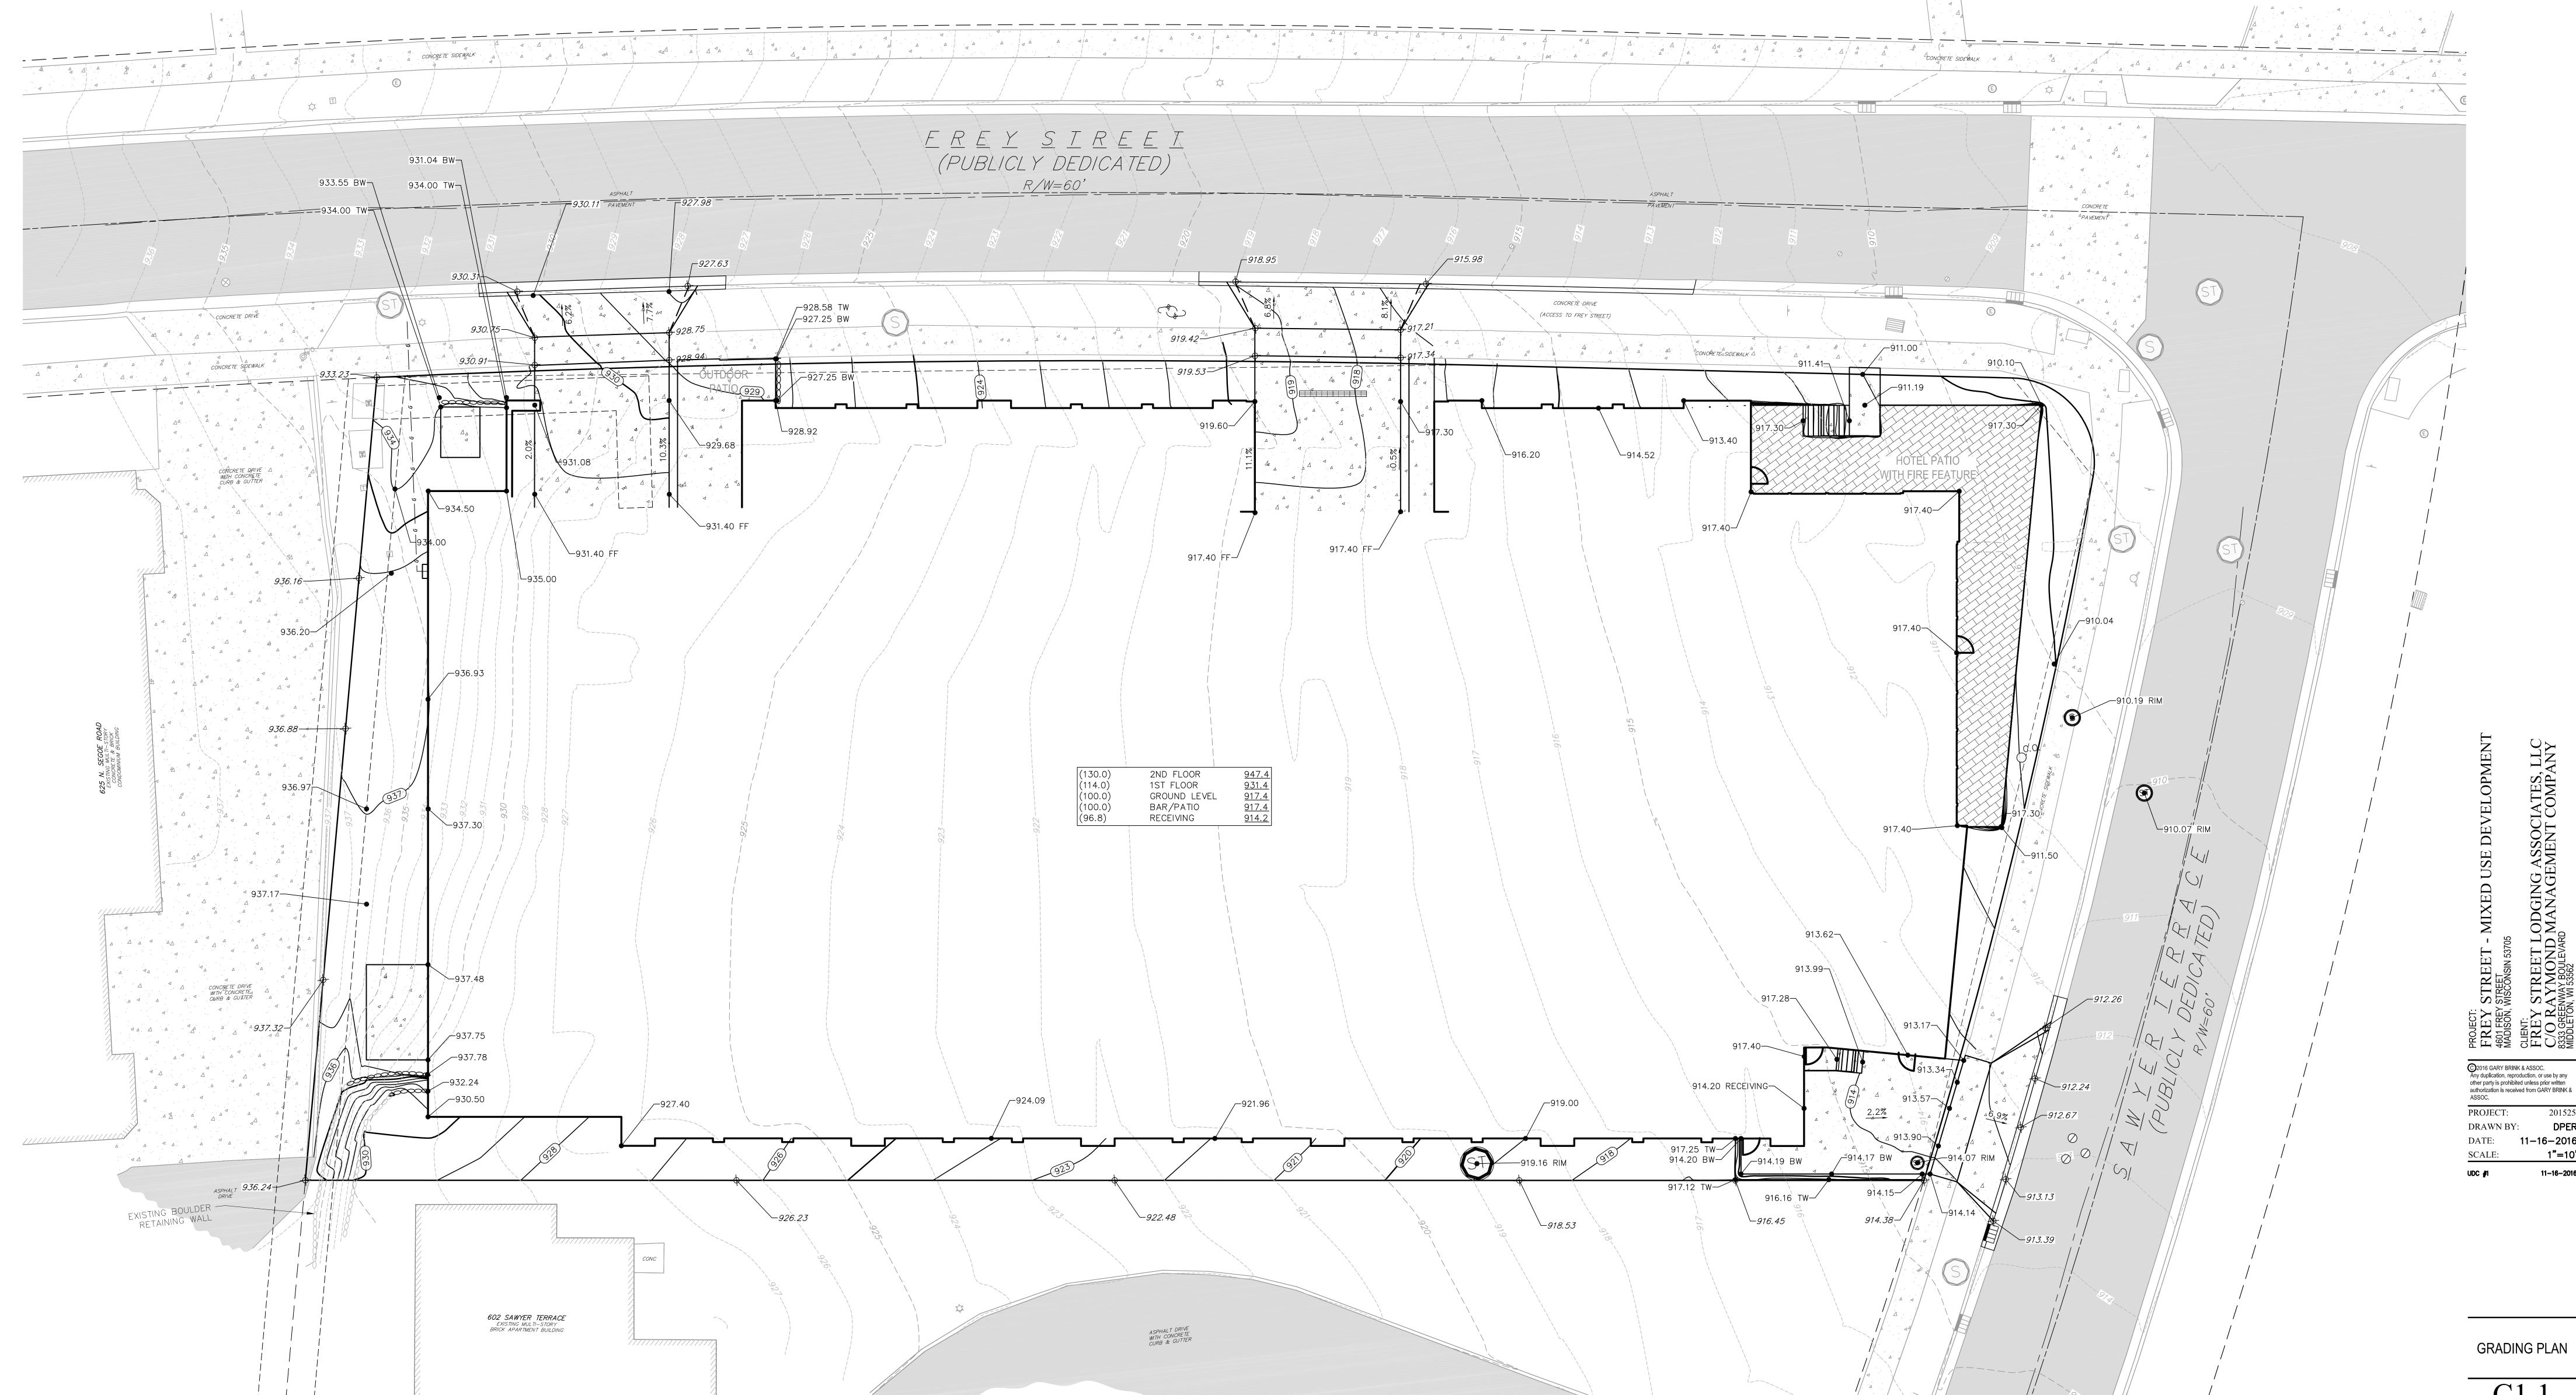

UTILITY NOTES:

ACTIVITIES.

- 1. SANITARY & STORM SEWER LENGTHS SHOWN ARE FROM CENTER OF STRUCTURE TO CENTER OF STRUCTURE. STORM SEWER END SECTIONS ARE INCLUDED IN THE LENGTH AND SLOPE OF THE PIPE.
- 2. CONTRACTOR SHALL INVESTIGATE ALL UTILITY CROSSINGS PRIOR TO CONSTRUCTION AND NOTIFY ENGINEER OF ANY CONFLICTS.
- 3. CONTRACTOR SHALL BE RESPONSIBLE FOR ADJUSTING ALL UTILITY STRUCTURES (MANHOLE RIMS, WATER VALVES, AND CURB STOPS), IF NECESSARY.
- 4. CONTRACTOR SHALL OBTAIN ANY NECESSARY WORK IN RIGHT-OF WAY, EXCAVATION, UTILITY CONNECTION, PLUGGING, ABANDONMENT, AND DRIVEWAY CONNECTION PERMITS PRIOR TO CONSTRUCTION.
- 5. FOR ALL SEWER AND WATER MAIN CROSSINGS: PROVIDE MINIMUM 18" SEPARATION WHEN WATER MAIN CROSSES BELOW SEWER AND MINIMUM 6" SEPARATION WHEN WATER MAIN CROSSES ABOVE SEWER.
- 6. IF DEWATERING OPERATIONS EXCEED 70 GALLONS PER MINUTE OF PUMPING CAPACITY, A DEWATERING


WELL PERMIT SHALL BE OBTAINED FROM THE DEPARTMENT PRIOR TO STARTING ANY DEWATERING

- 7. A COPY OF THE APPROVED UTILITY PLANS, SPECIFICATIONS AND PLUMBING PERMIT APPROVAL LETTER SHALL BE ON—SITE DURING CONSTRUCTION AND OPEN TO INSPECTION BY AUTHORIZED REPRESENTATIVES
- OF THE DEPARTMENT OF SAFETY AND PROFESSIONAL SERVICES AND OTHER LOCAL INSPECTORS.

 8. STORM BUILDING SEWER PIPE SHALL CONFORM TO ONE OF THE STANDARDS LISTED IN TABLE 384.30-6 OF SPS 384.30(3)(c).
- 9. PRIVATE WATER SERVICES AND PRIVATE WATER MAINS SHALL CONFORM TO ONE OF THE STANDARDS LISTED IN TABLE 384.30-7 OF SPS 384.30(4)(d).
- 10. PRIVATE WATER HYDRANTS SHALL BE YELLOW IN COLOR.
- 11. PRIVATE SANITARY SEWER AND LATERALS SHALL BE POLYVINYL CHLORIDE (PVC) ASTM D3034 SDR 35 OR APPROVED EQUAL MATERIAL THAT CONFORMS TO ONE OF THE STANDARDS LISTED IN TABLE 384.30-3 OF SPS 384.30(2)(c).

- 12. A MEANS TO LOCATE BURIED UNDERGROUND EXTERIOR NON METALLIC SEWERS/MAINS AND WATER SERVICES/MAINS MUST BE PROVIDED WITH TRACER WIRE OR OTHER METHODS IN ORDER TO BE LOCATED PER SPS 382.10(11)(h) AND SPS 382.40(8)(k).
- 13. EXTERIOR WATER SUPPLY PIPING SETBACKS AND CROSSINGS SHALL BE IN ACCORDANCE WITH SPS 382.40(8)(b.).
- 14. NO PERSON MAY ENGAGE IN PLUMBING WORK IN THE STATE UNLESS LICENSED TO DO SO BY THE DEPARTMENT OF SAFETY AND PROFESSIONAL SERVICES PER S.145.06.
- 15. SITE CONTRACTOR SHALL LEAVE SANITARY AND WATER LATERALS FIVE (5) FEET SHORT (HORIZONTALLY) FROM THE BUILDING. BUILDING PLUMBER SHALL VERIFY SIZE, LOCATION, AND INVERT ELEVATION OF PROPOSED SANITARY AND WATER LATERALS.
- 16. CONTRACTOR SHALL FIELD VERIFY THE SIZE, TYPE, LOCATION, AND ELEVATION OF EXISTING UTILITIES PRIOR TO INSTALLING ANY ON—SITE UTILITIES OR STRUCTURES. CONTACT ENGINEER PRIOR TO INSTALLATION IF DISCREPANCY EXISTS WITHIN THESE PLANS.
- 17. PROPOSED UTILITY SERVICE LINES SHOWN ARE APPROXIMATE. COORDINATE THE EXACT LOCATIONS WITH THE PLUMBING DRAWINGS. COORDINATE THE LOCATIONS WITH THE PLUMBING CONTRACTOR AND/OR OWNER'S CONSTRUCTION REPRESENTATIVE PRIOR TO INSTALLATION OF ANY NEW UTILITIES.
- 18. CONTRACTOR SHALL BE RESPONSIBLE FOR COORDINATING THE RELOCATION OF ANY UTILITIES ENCOUNTERED AND REPLACEMENT OF ANY UTILITIES DAMAGED WITHIN INFLUENCE ZONE OF NEW CONSTRUCTION. CONTACT ENGINEER IF THE EXISTING UTILITIES VARY APPRECIABLY FROM THE PLANS.
- 19. ALL WATER MAIN AND SERVICES SHALL BE INSTALLED AT A MINIMUM DEPTH OF 6.5' FROM TOP OF FINISHED GROUND ELEVATION TO TOP OF MAIN.
- 20. IT IS THE CONTRACTOR'S RESPONSIBILITY TO VERIFY THAT THE EXISTING VALVES WILL HOLD THE PRESSURE TEST PRIOR TO CONNECTION. THE CITY IS NOT RESPONSIBLE FOR ANY COSTS INCURRED DUE TO THE CONTRACTOR NOT VERIFYING THAT THE EXISTING VALVE WILL HOLD THE PRESSURE TEST PRIOR TO CONNECTION. IF A NEW VALVE IS REQUIRED, THE APPLICANT WILL BE REQUIRED TO INSTALL ONE AT THEIR EXPENSE, AT THE POINT OF CONNECTION.
- 21. CLEAN OUT ALL EXISTING AND PROPOSED STORM INLETS AND CATCH BASINS AT THE COMPLETION OF CONSTRUCTION.

REMOVE EXISTING SANITARY STUB TO SOUTH

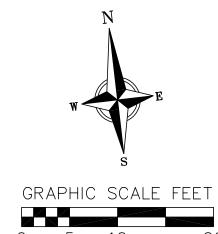


EX. SANITARY SEWER CHART

P1 - 8" @ 4.57% - CAPACITY=1,150 GPM

P2 - 8" @ 7.10% - CAPACITY=1,440 GPM

P3 - 8" @ 4.87% - CAPACITY=2,169 GPM

PROP. BUILDING 1200 DFU (PRELIMINARY ESTIMATE)= 240 GPM

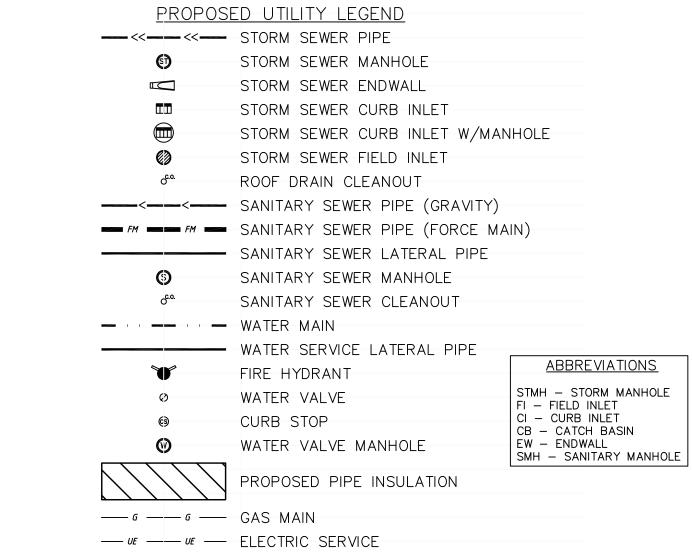



GARY BRINK & ASSOCIATES


ARCHITECTS

7780 ELMWOOD AVE. STE. 204

MIDDLETON, WI 53562

608-829-1750

608-829-3056 (FAX)

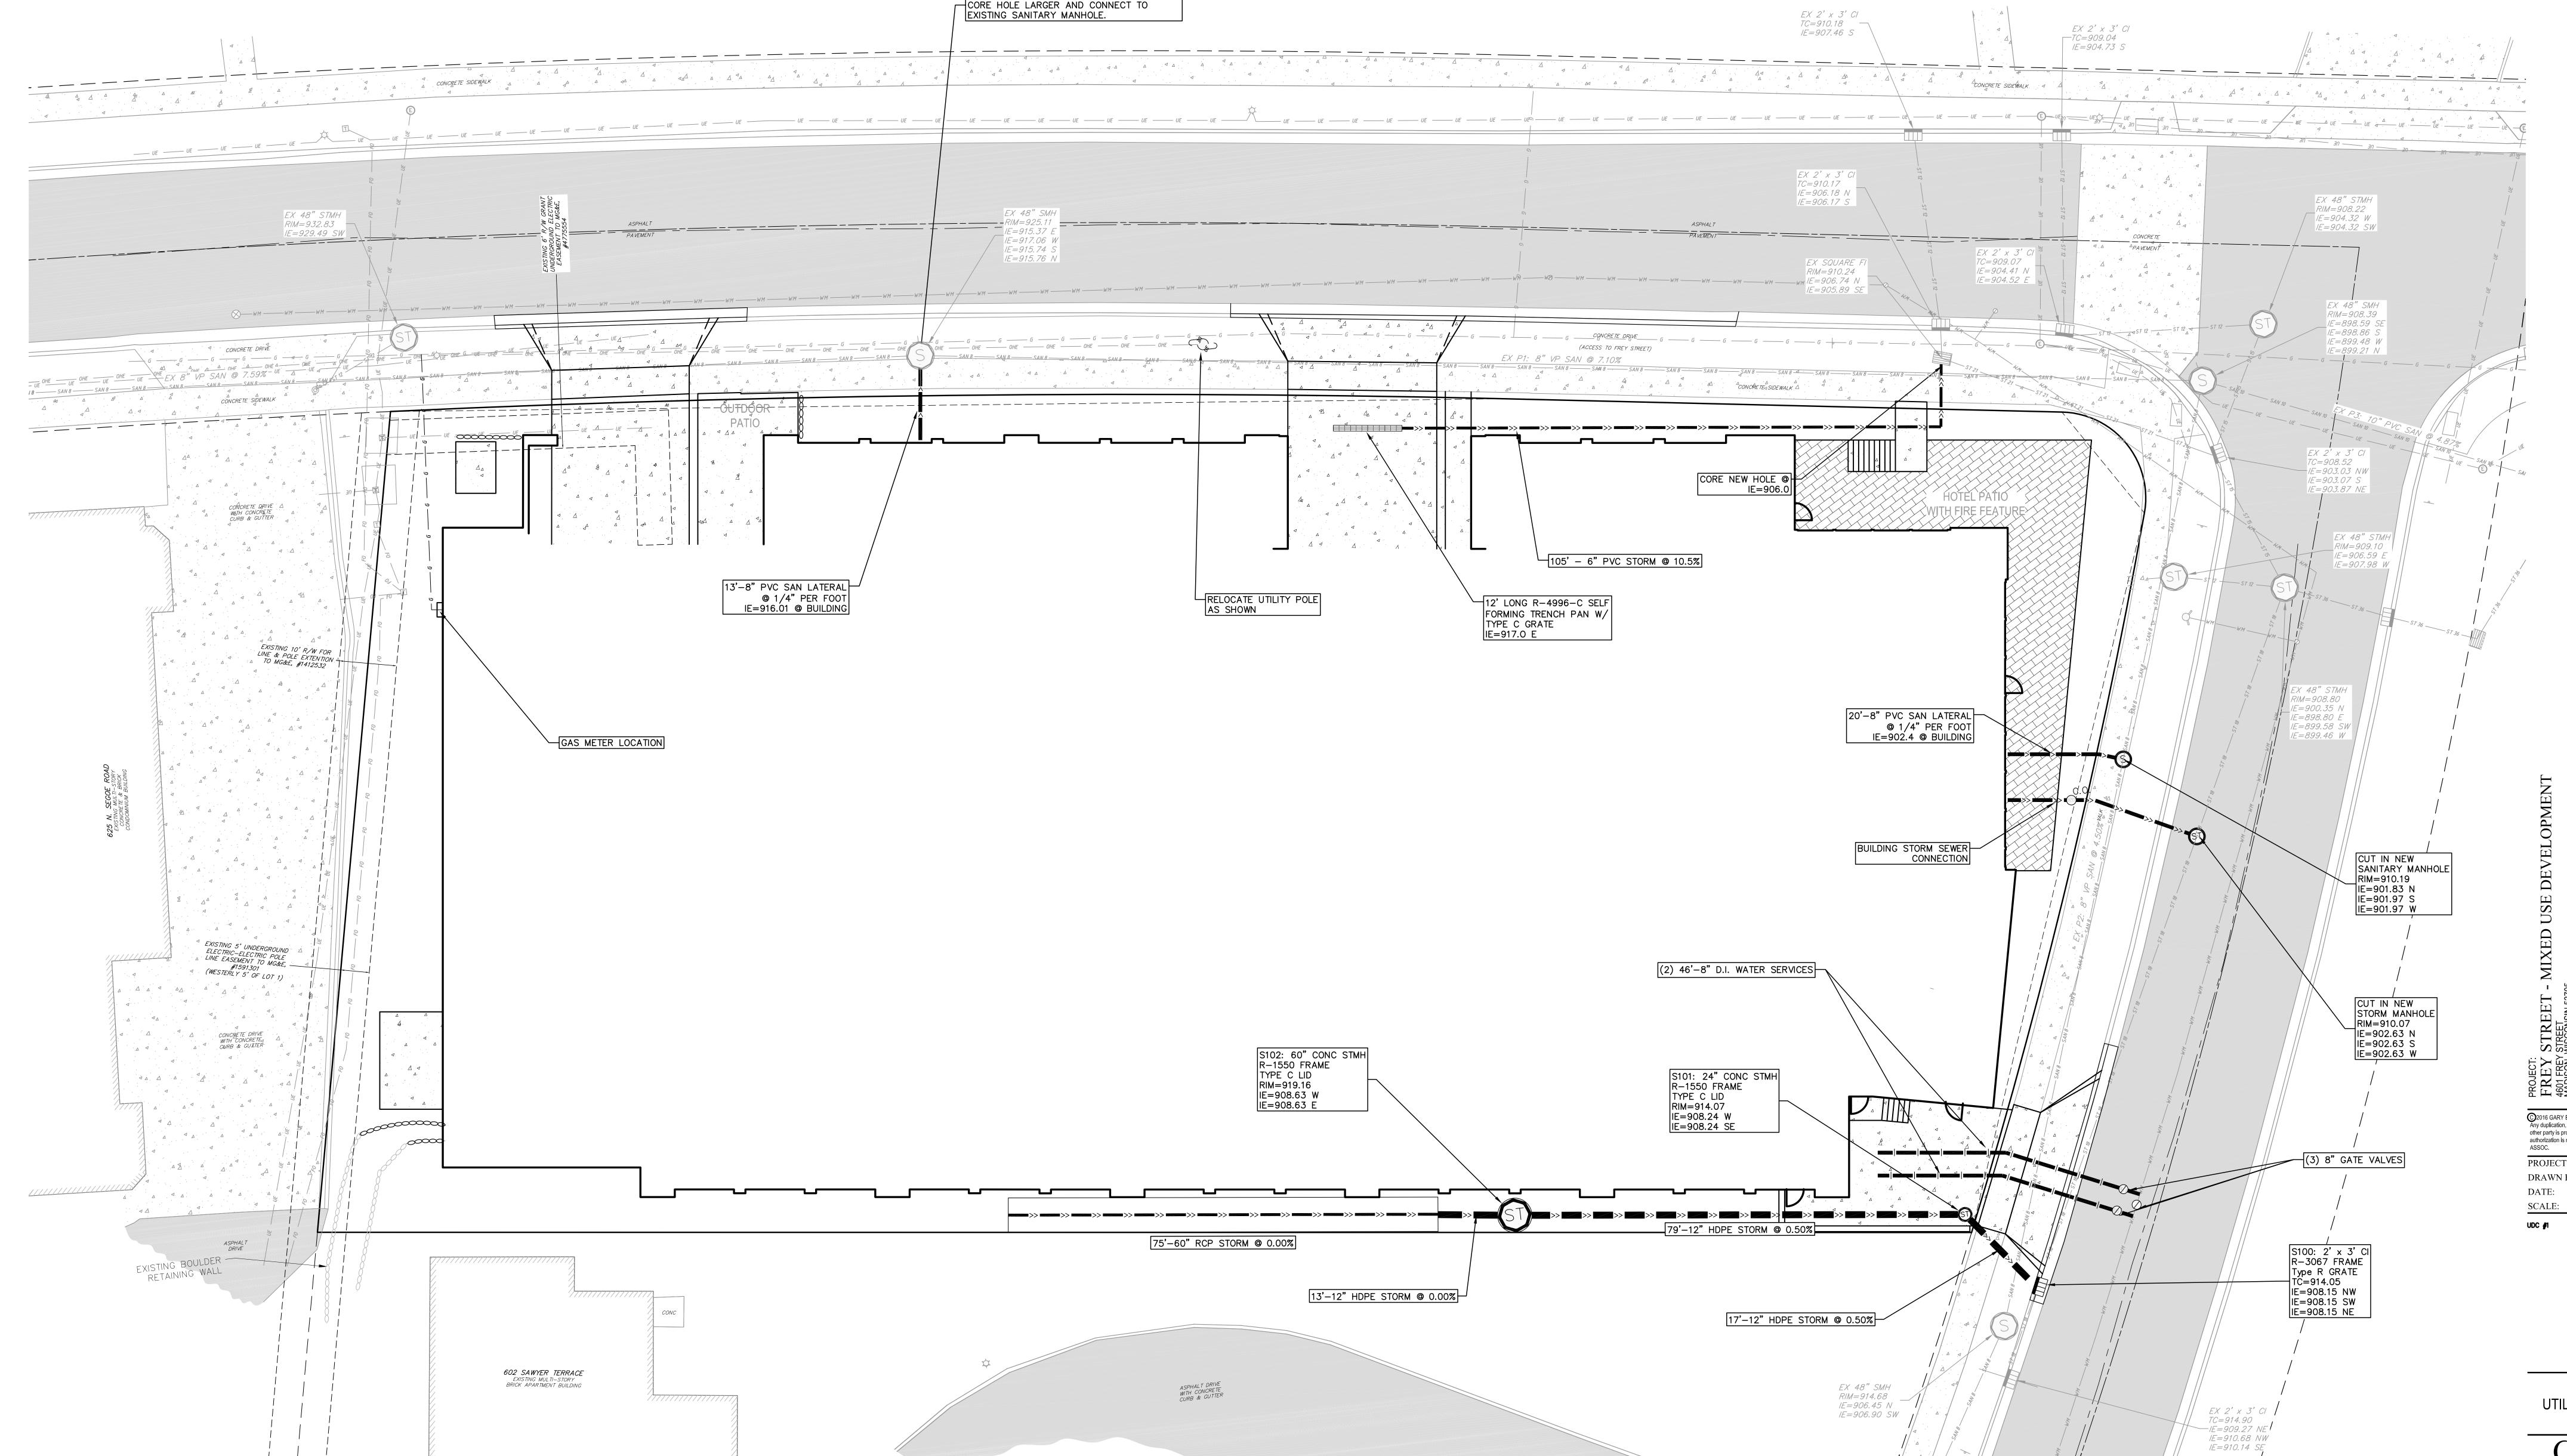

PROJECT:
FREY STREET - MIXED USE DEVELOR
4601 FREY STREET
4601 FREY STREET
MADISON, WISCONSIN 53705
CLIENT:
FREY STREET LODGING ASSOCIATES
C/O RAYMOND MANAGEMENT COMI
8333 GREENWAY BOULEVARD
MIDDLETON, WI 53562

authorization is received from GARY BRINK & ASSOC.

PROJECT: 201525

DRAWN BY: DPER

DATE: 11-16-2016

SCALE: 1"=10'

UDC #1 11-16-2016

UTILITY PLAN

 $\overline{C12}$

GARY BRINK & ASSOCIATES ARCHITECTS 7780 ELMWOOD AVE. STE. 204 MIDDLETON, WI 53562 608-829-1750 608-829-3056 (FAX)

LANDS CAPE ARCHITECTS 303 S. PATERSON S U I T E O N E MADISON, WI 53703 Phone: 608 251-3600

TERRACE W/ DECORATIVE PAVING STREET TREES T.B.D. -BY CITY FORESTRY ORNAMENTAL SIDEWALK -DECORATIVE TREE -LIMESTONE **PAVING** DECORATIVE PAVING -ASSORTED POTS WITH RETAINING WALL **PLANTINGS** ~~LIMESTONE BENCH / RETAINING WALL -– LAWN PERENNIAL AND ORNAMENTAL GRASS PLANTING VEGETATED SWALE DECORATIVE PAVING BANDS DECORATIVE PAVING STREET TREES T.B.D. BY CITY FORESTRY CONTRASTING DECORATIVE-PAVING BANDS -PLANTING -VEGETATED SWALE DECORATIVE CONCRETE PAVING BANDS – LAWN -PLANTING DECORATIVE CONCRETE **PAVING** CONTRASTING DECORATIVE CONCRETE PAVING BANDS -(5) CANOPY PERENNIAL AND ORNAMENTAL GRASS **PLANTING** 2 YD 2 YD DUMPSTER

2 YD 2 YD DUMPSTER

2 YD DUMPSTER DUMPSTER CANOPY TREE —— - (2) CANOPY TREES - NATIVE UNDERSTORY


SHRUB PLANTING

TERRACED LIMESTONE RETAINING WALL


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AS SHOWN SCALE:




FREYSIREEI (PUBLICLY DEDICATED)

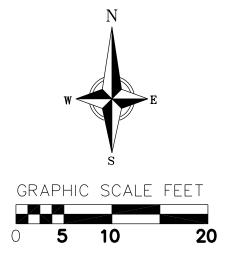


GROUND FLOOR PLAN

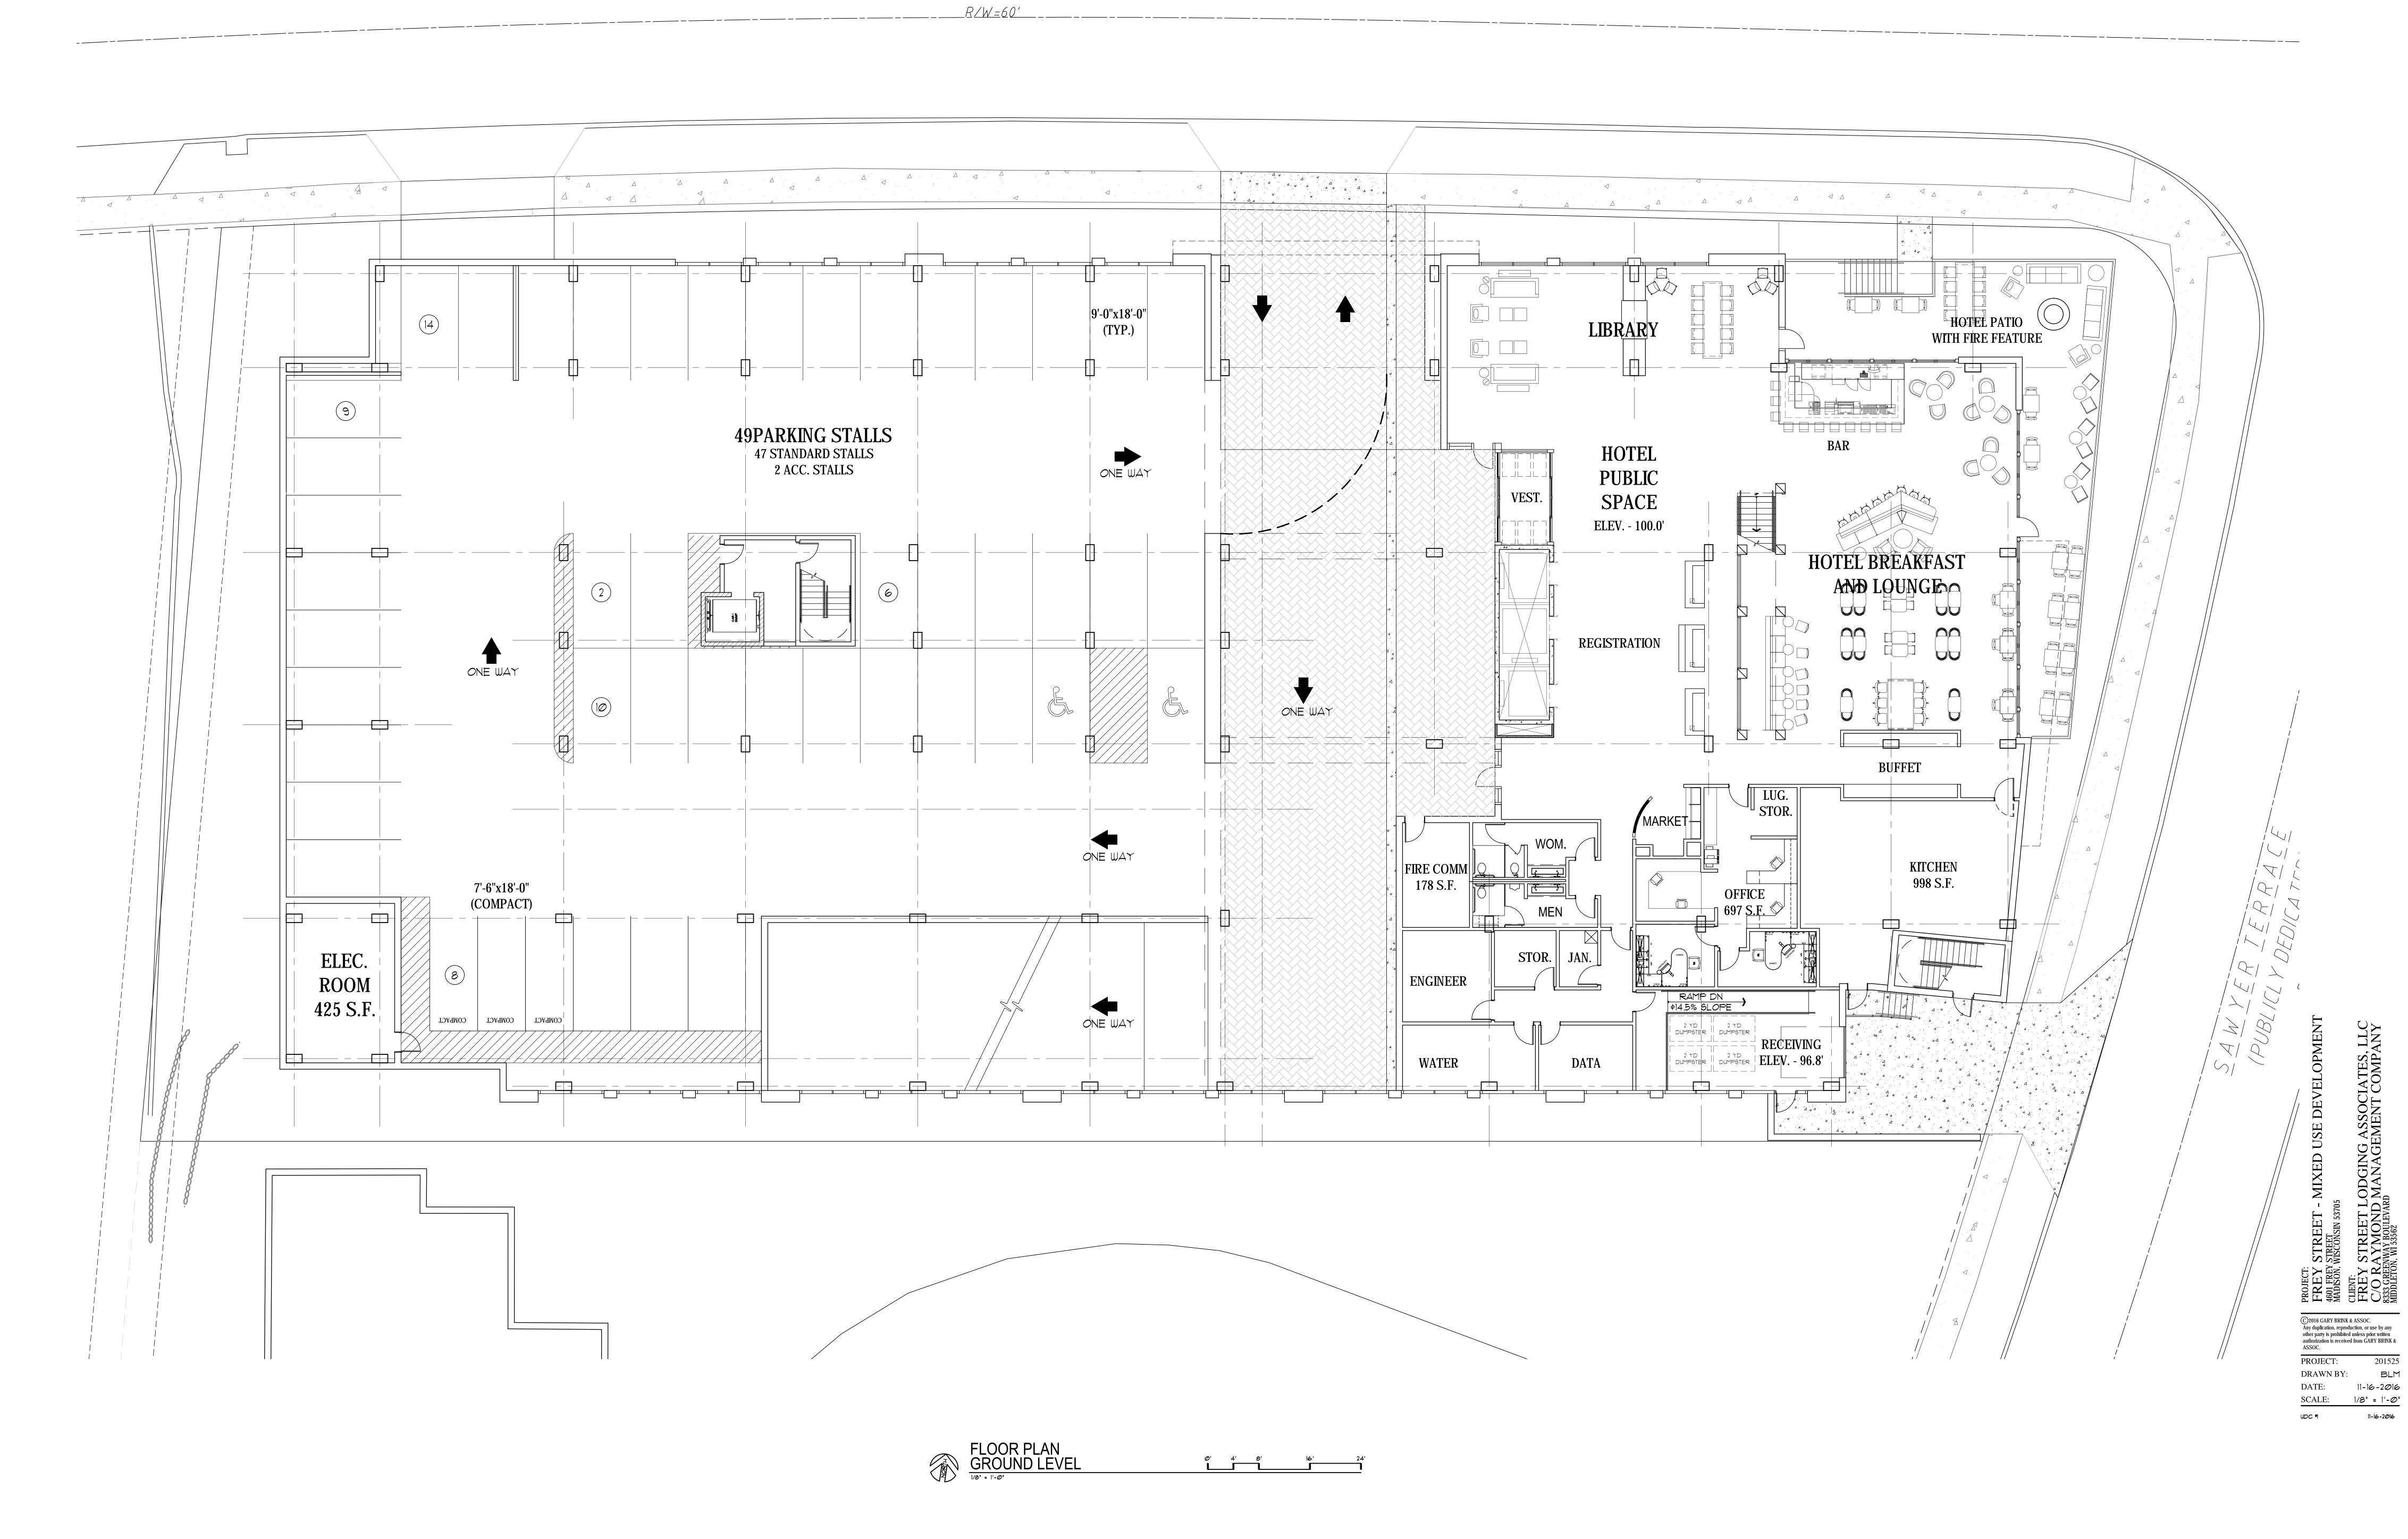A2.01

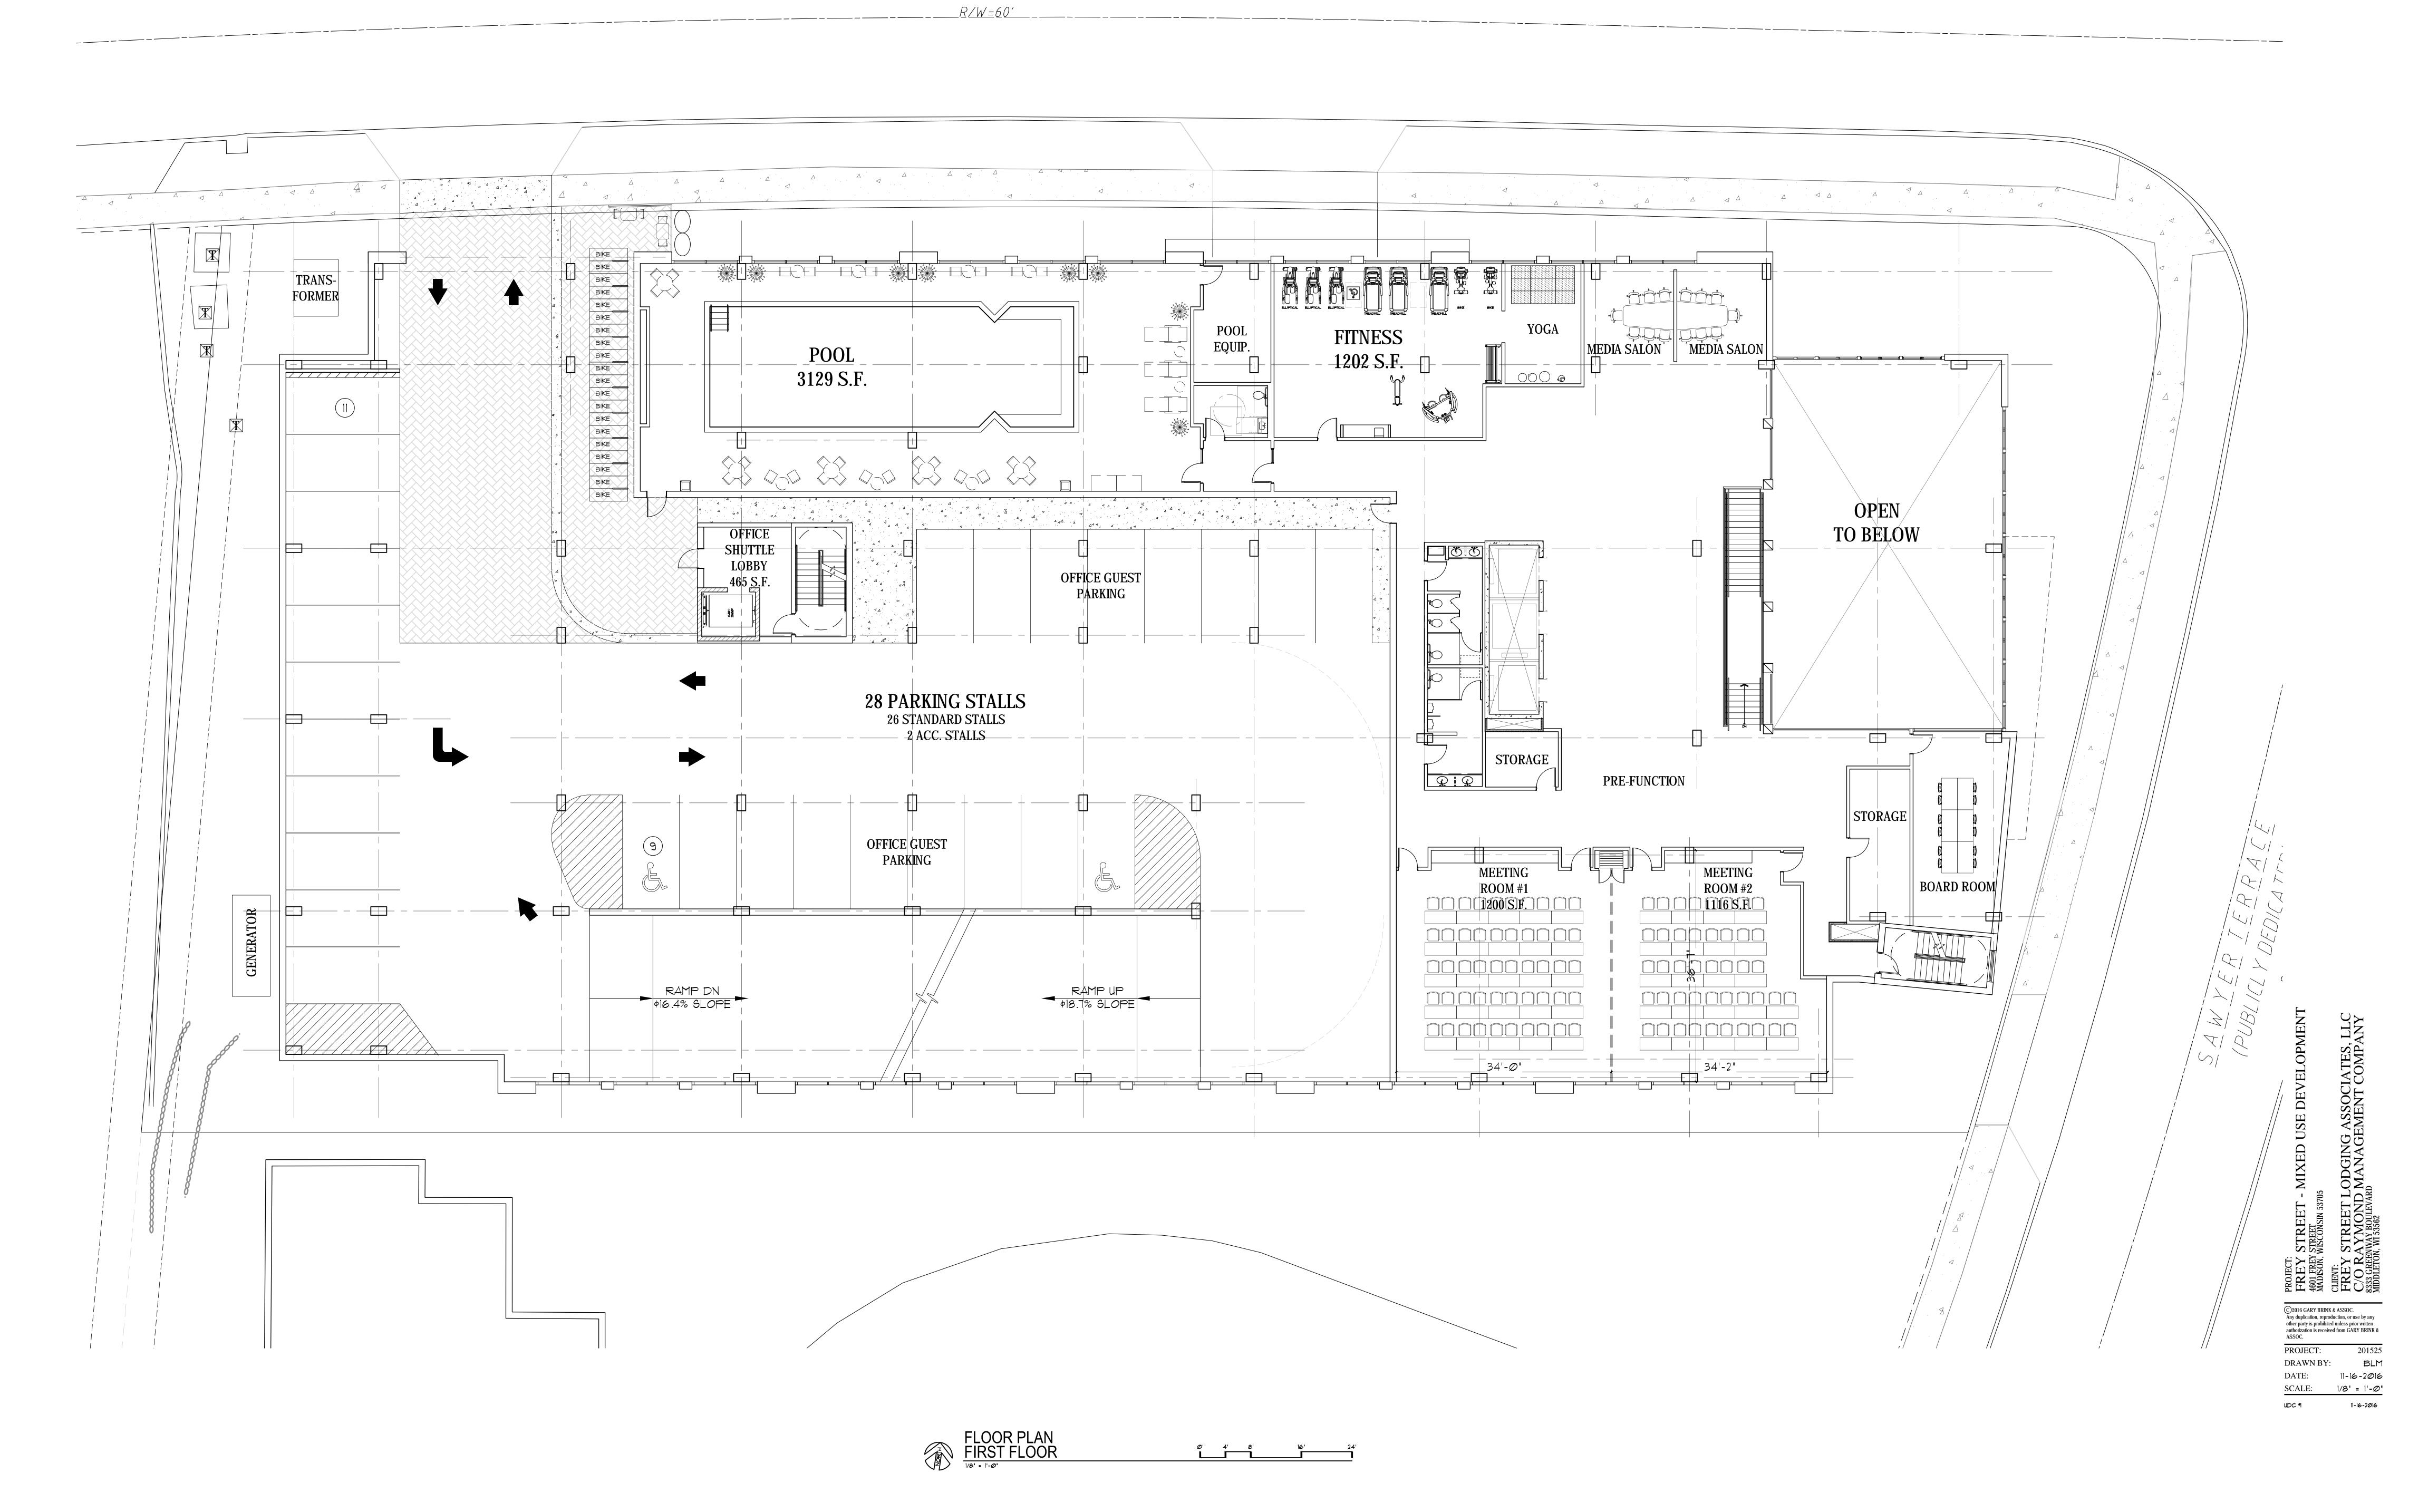

FIRST FLOOR PLAN

A2.02

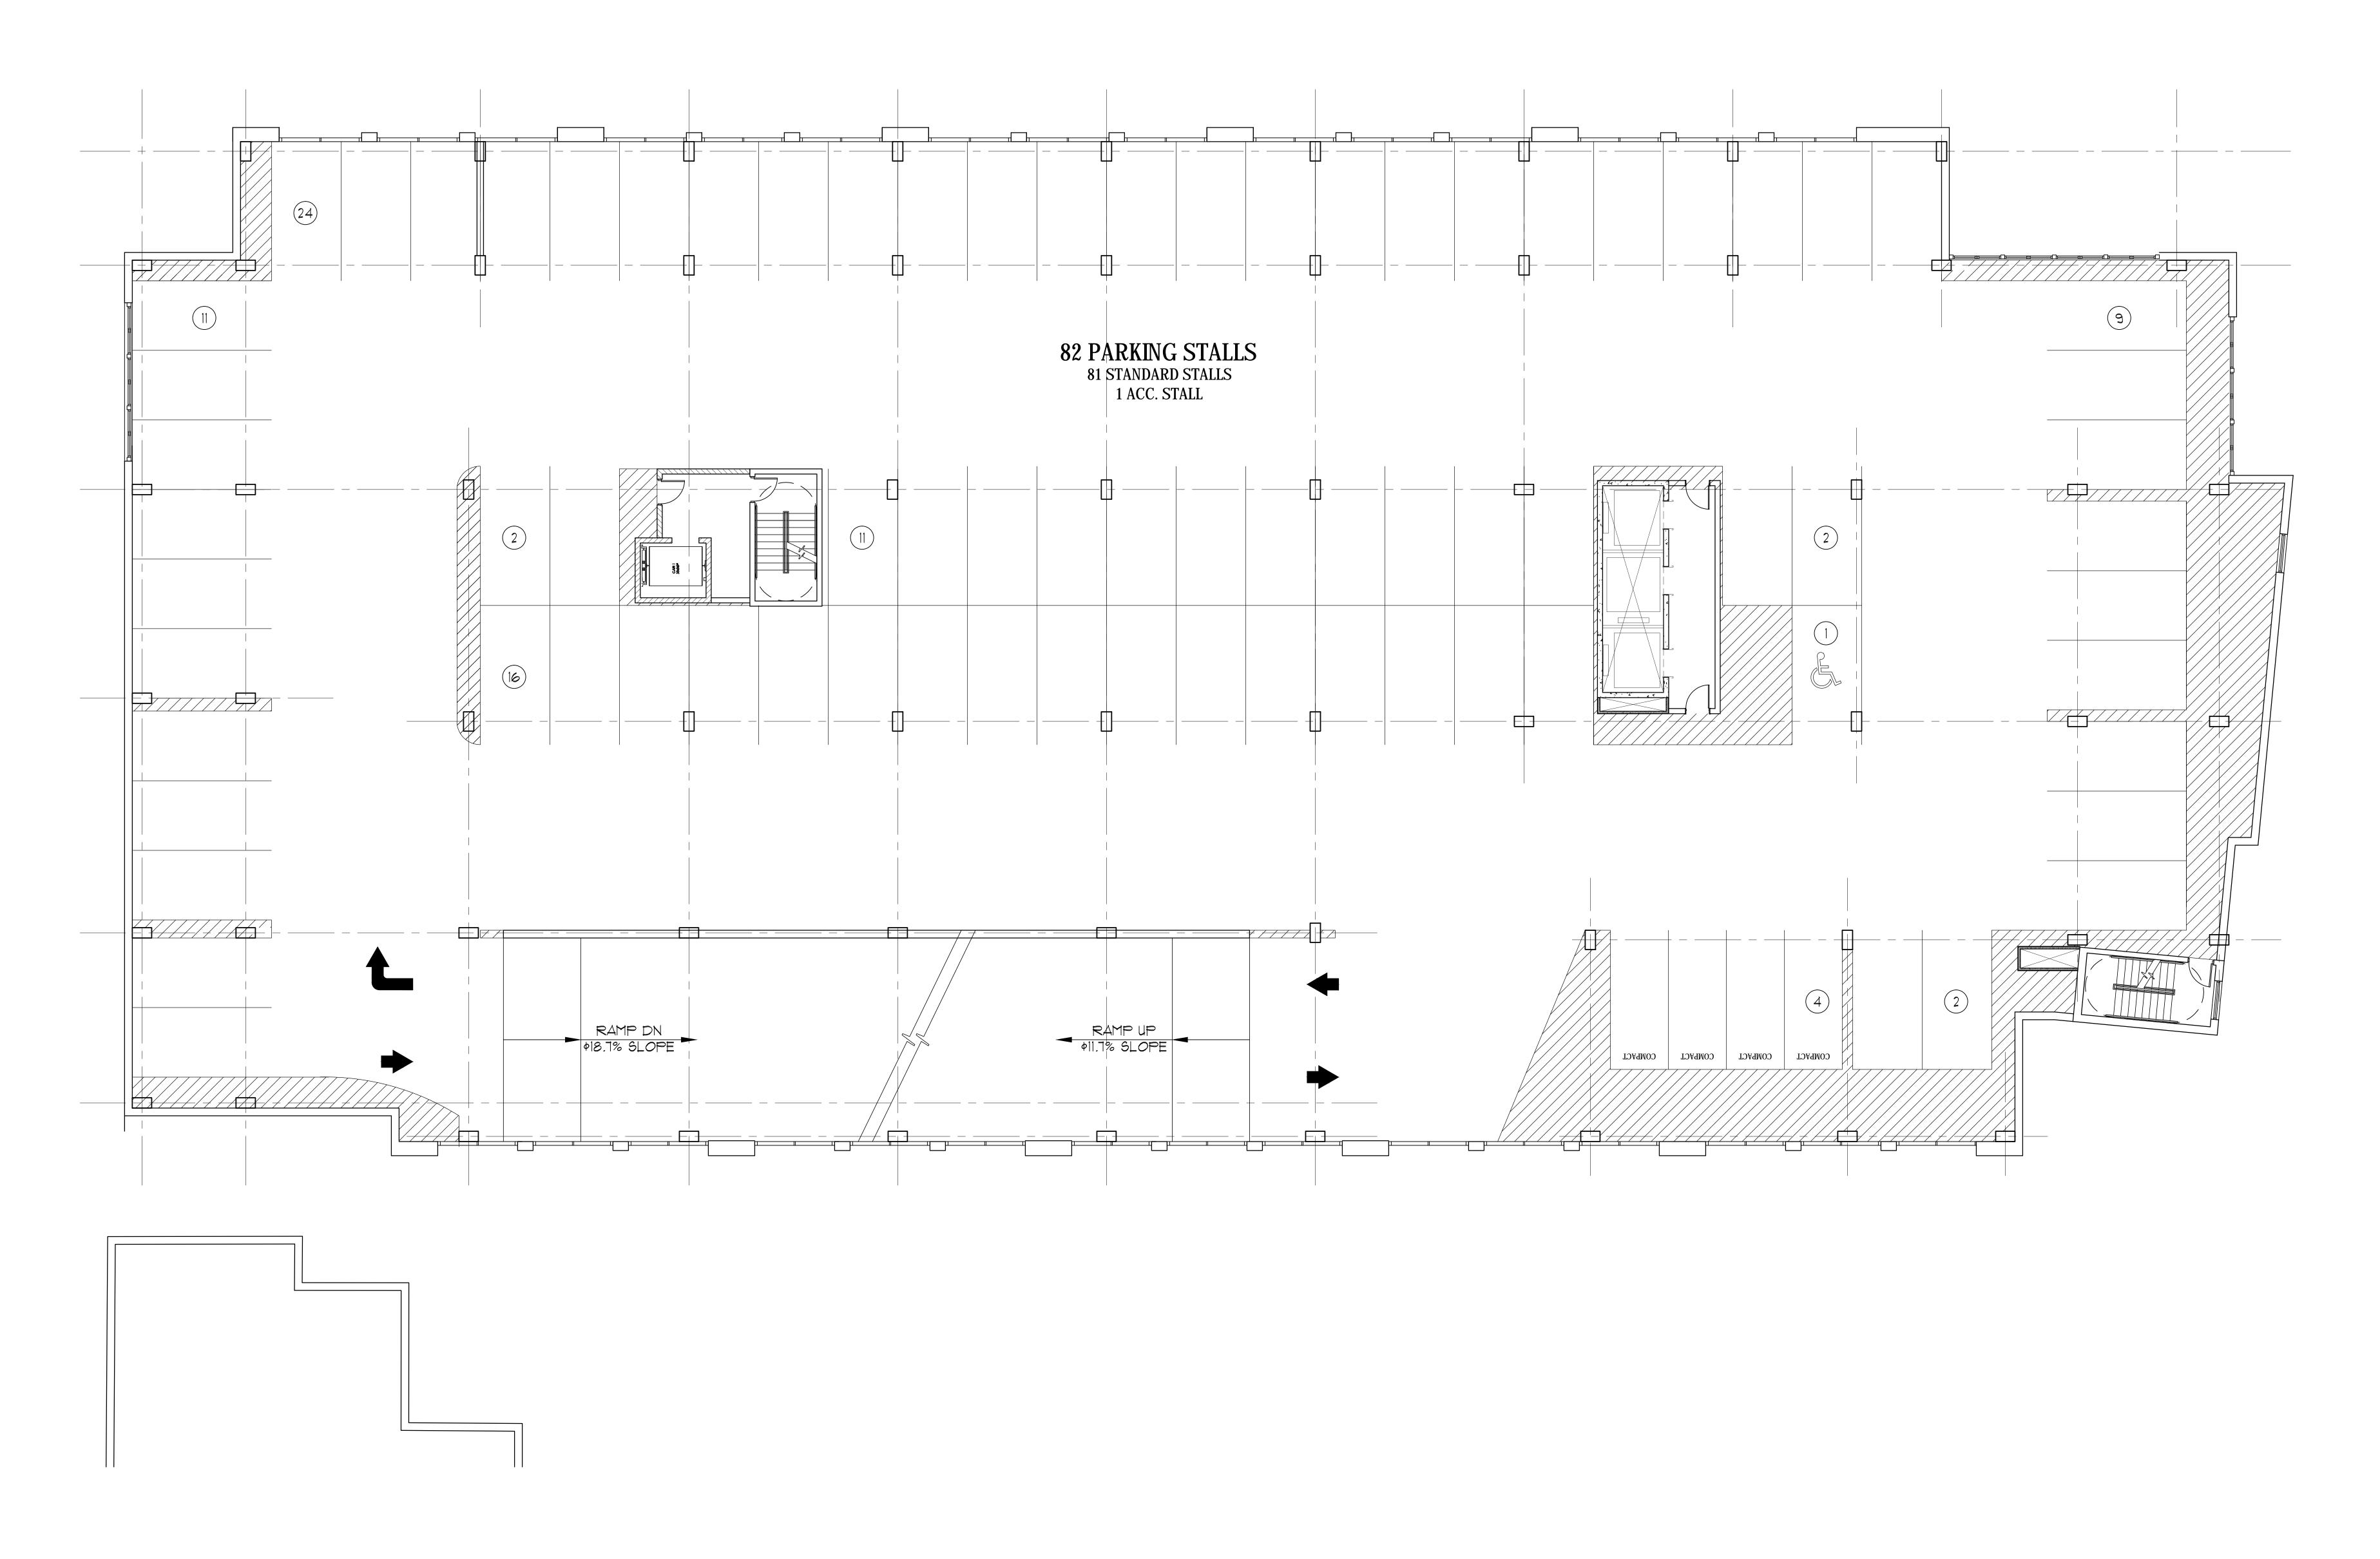

PROJECT:

FREY STREET - MIXED USE DEVELO
4601 FREY STREET

MADISON, WISCONSIN 53705

CLIENT:

FREY STREET LODGING ASSOCIATE

C/O RAYMOND MANAGEMENT COM
8333 GREENWAY BOULEVARD
MIDDLETON, WI 53562

DRAWN BY: BLM


DATE: 11-16-2016

SCALE: 1/8" = 1'-0"

UDC *1 11-16-2016

FLOOR PLAN
SECOND FLOOR

| 1/8' = 1'-@'

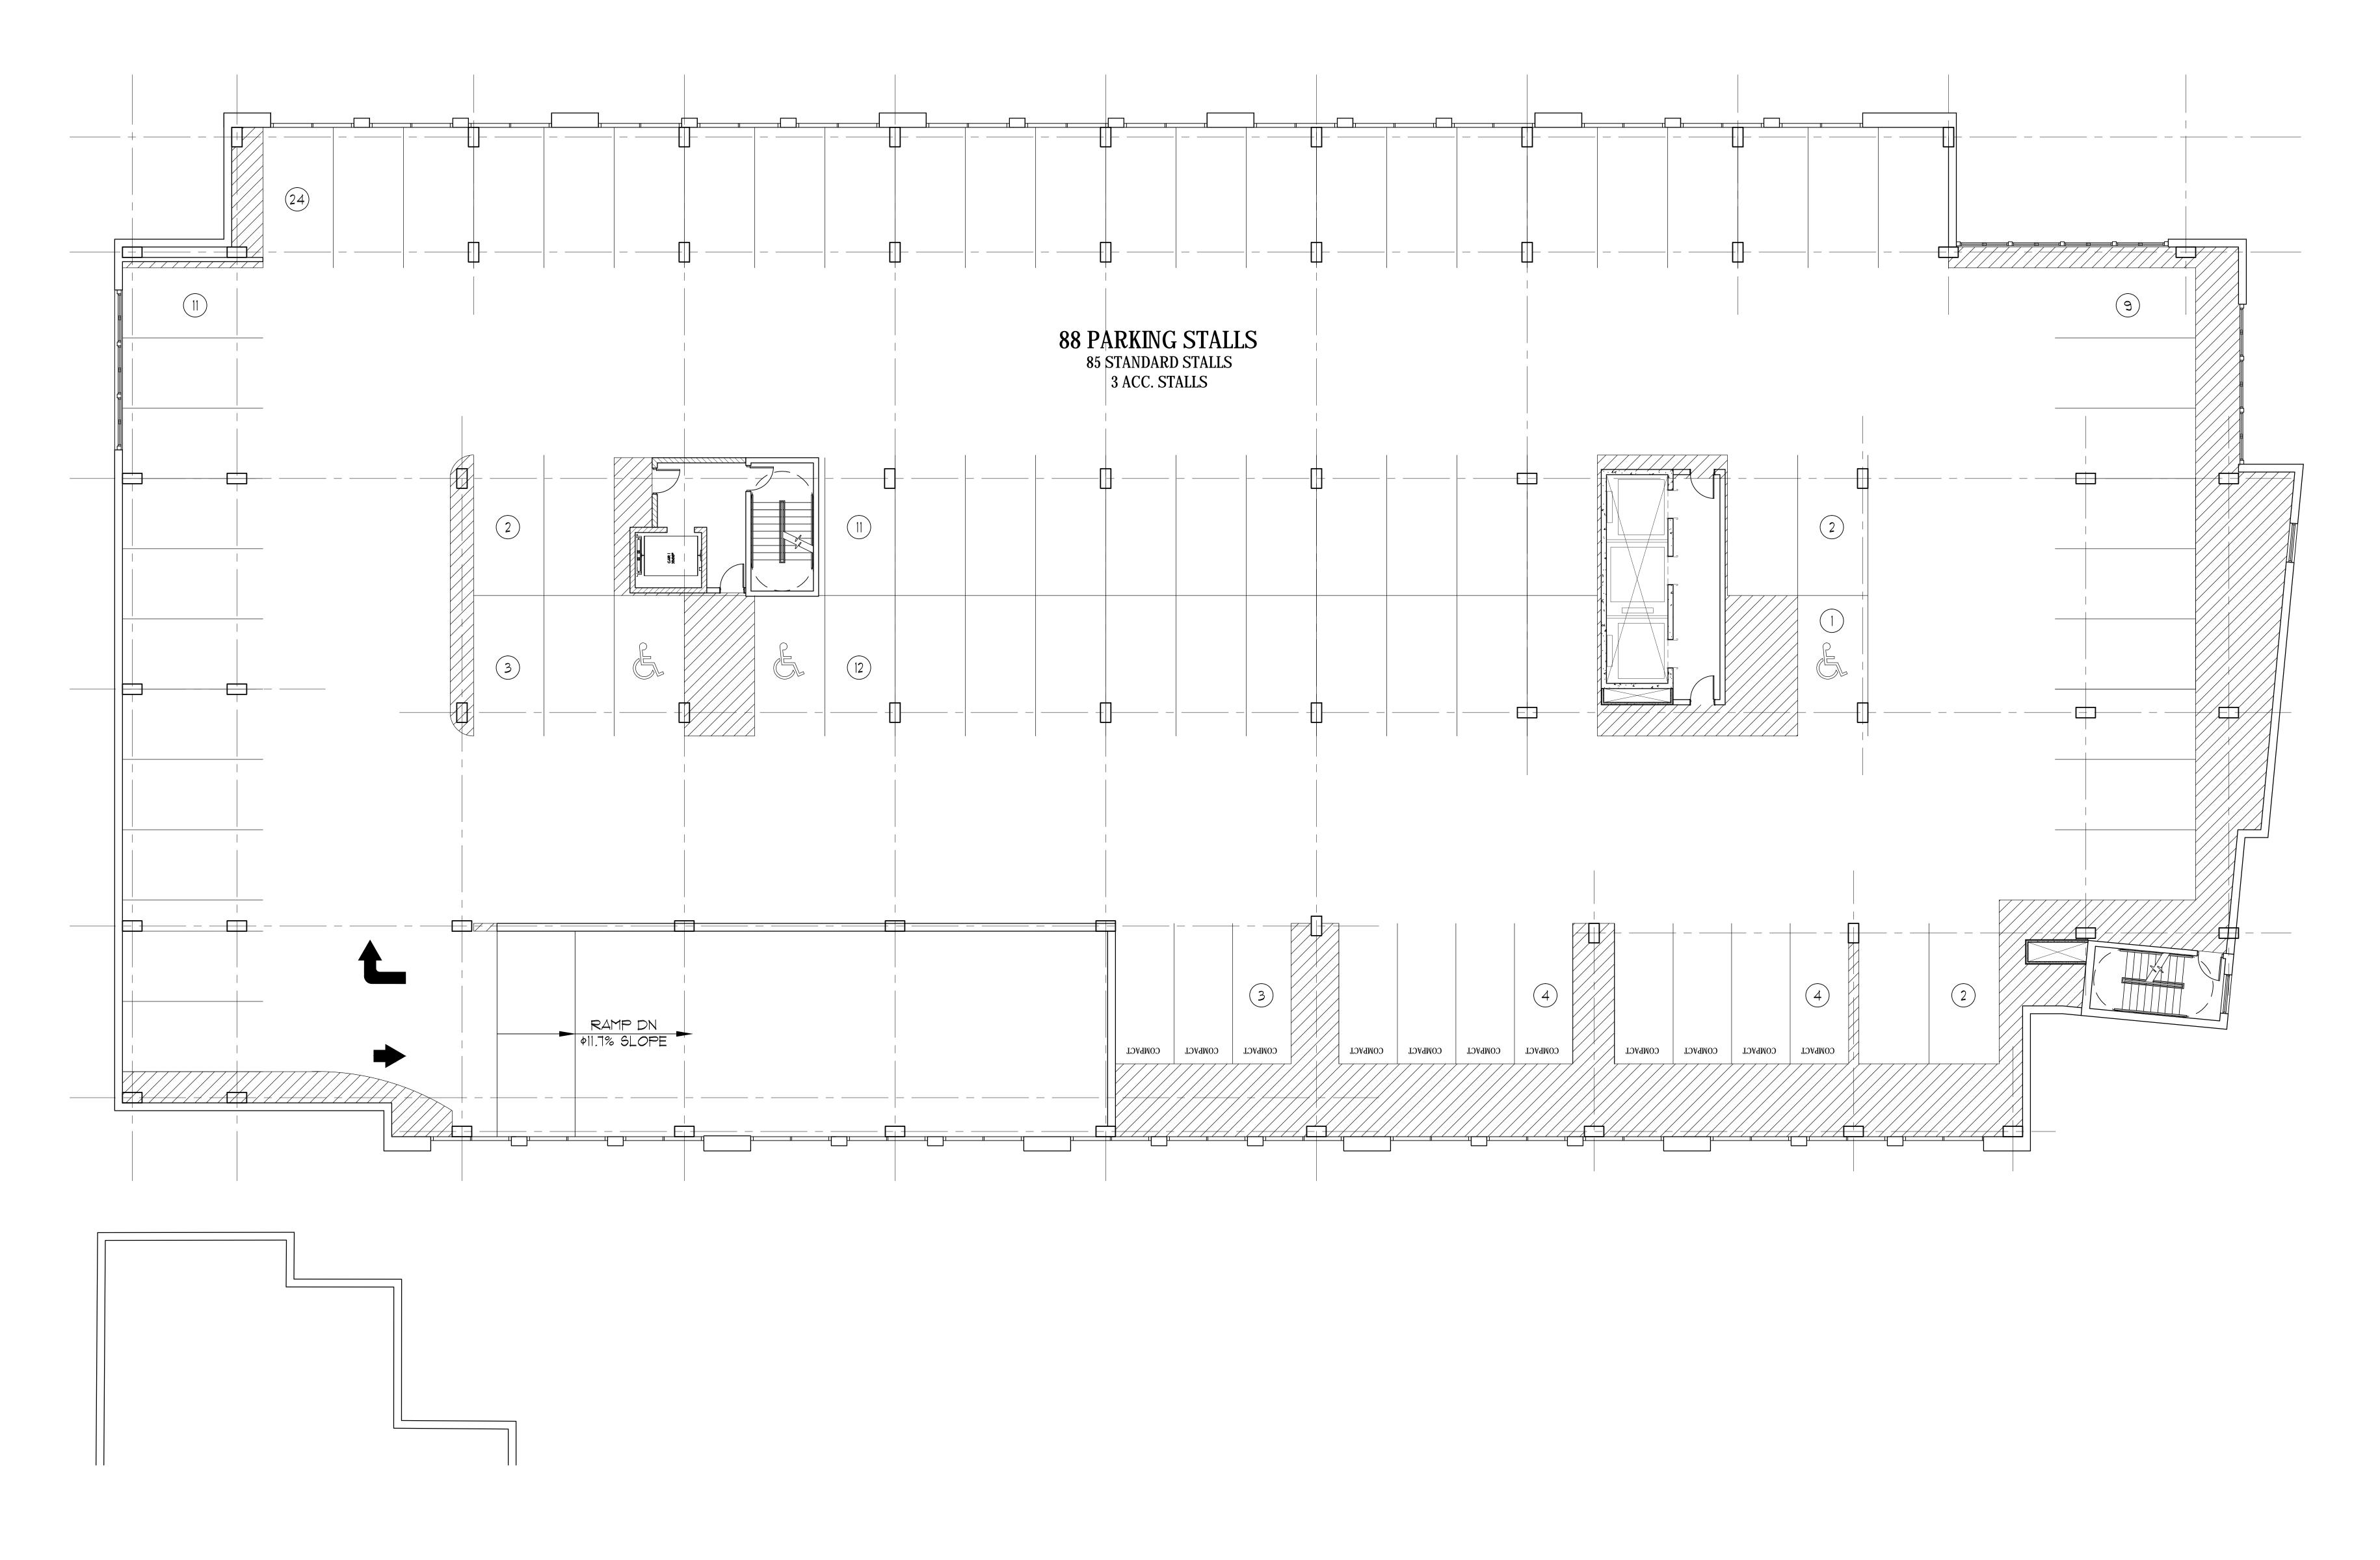

PROJECT:
FREY STREET - MIXED USE DEVELOPMENT
4601 FREY STREET
MADISON, WISCONSIN 53705
CLIENT:
FREY STREET
MADISON, WISCONSIN 53705
CLIENT:
FREY STREET LODGING ASSOCIATES, LLC
C/O RAYMOND MANAGEMENT COMPANY
8333 GREENWAY BOULEVARD
MIDDLETON, WI 53562

ASSOC.

PROJECT: 201525


DRAWN BY: BLM

DATE: 11-16-2016

SCALE: 1/8" = 1'-0"

FLOOR PLAN
THIRD FLOOR

| Column | Colu

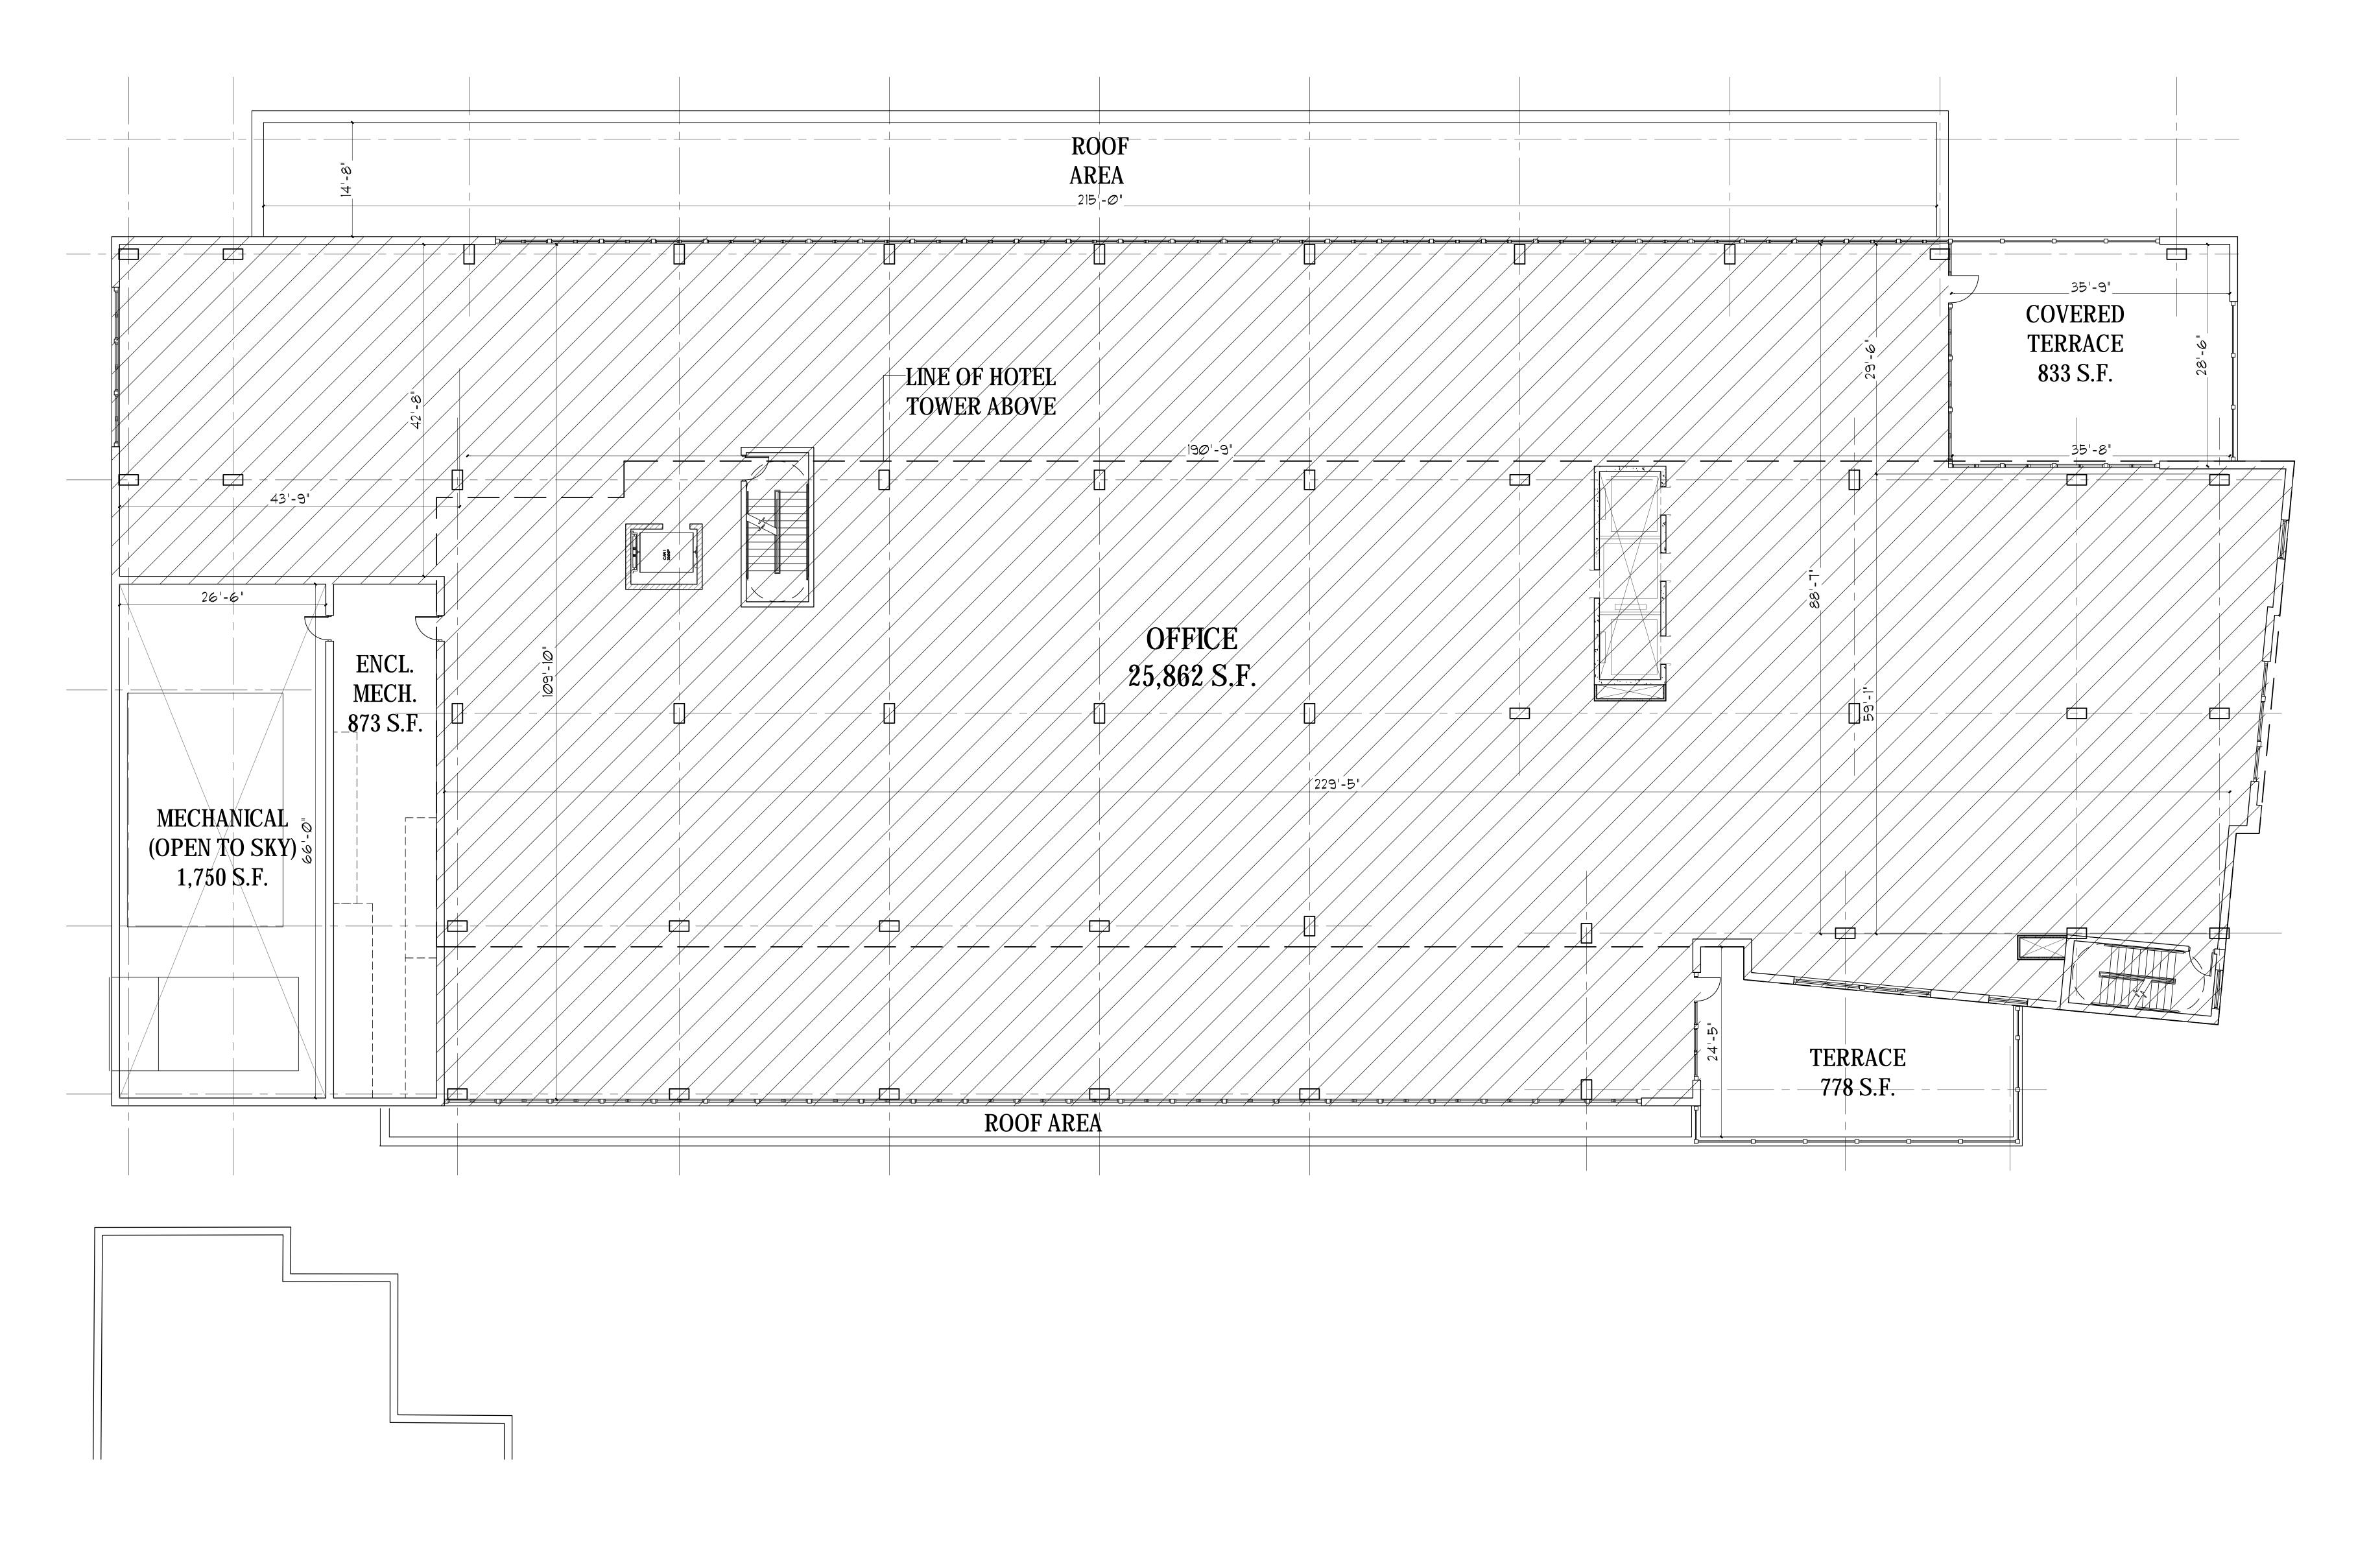

PROJECT:
FREY STREET - MIXED USE DEVELOPMENT
4601 FREY STREET
MADISON, WISCONSIN 53705

CLIENT:
FREY STREET
MADISON, WISCONSIN 53705

CLIENT:
FREY STREET LODGING ASSOCIATES, LLC
C/O RAYMOND MANAGEMENT COMPANY
8333 GREENWAY BOULEVARD
MIDDLETON, WI 53562

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PROJECT: 201525


DRAWN BY: BLM

DATE: 11-16-2016

SCALE: 1/8" = 1'-0"

FLOOR PLAN
FOURTH FLOOR

| 1/8' = 1'-@'

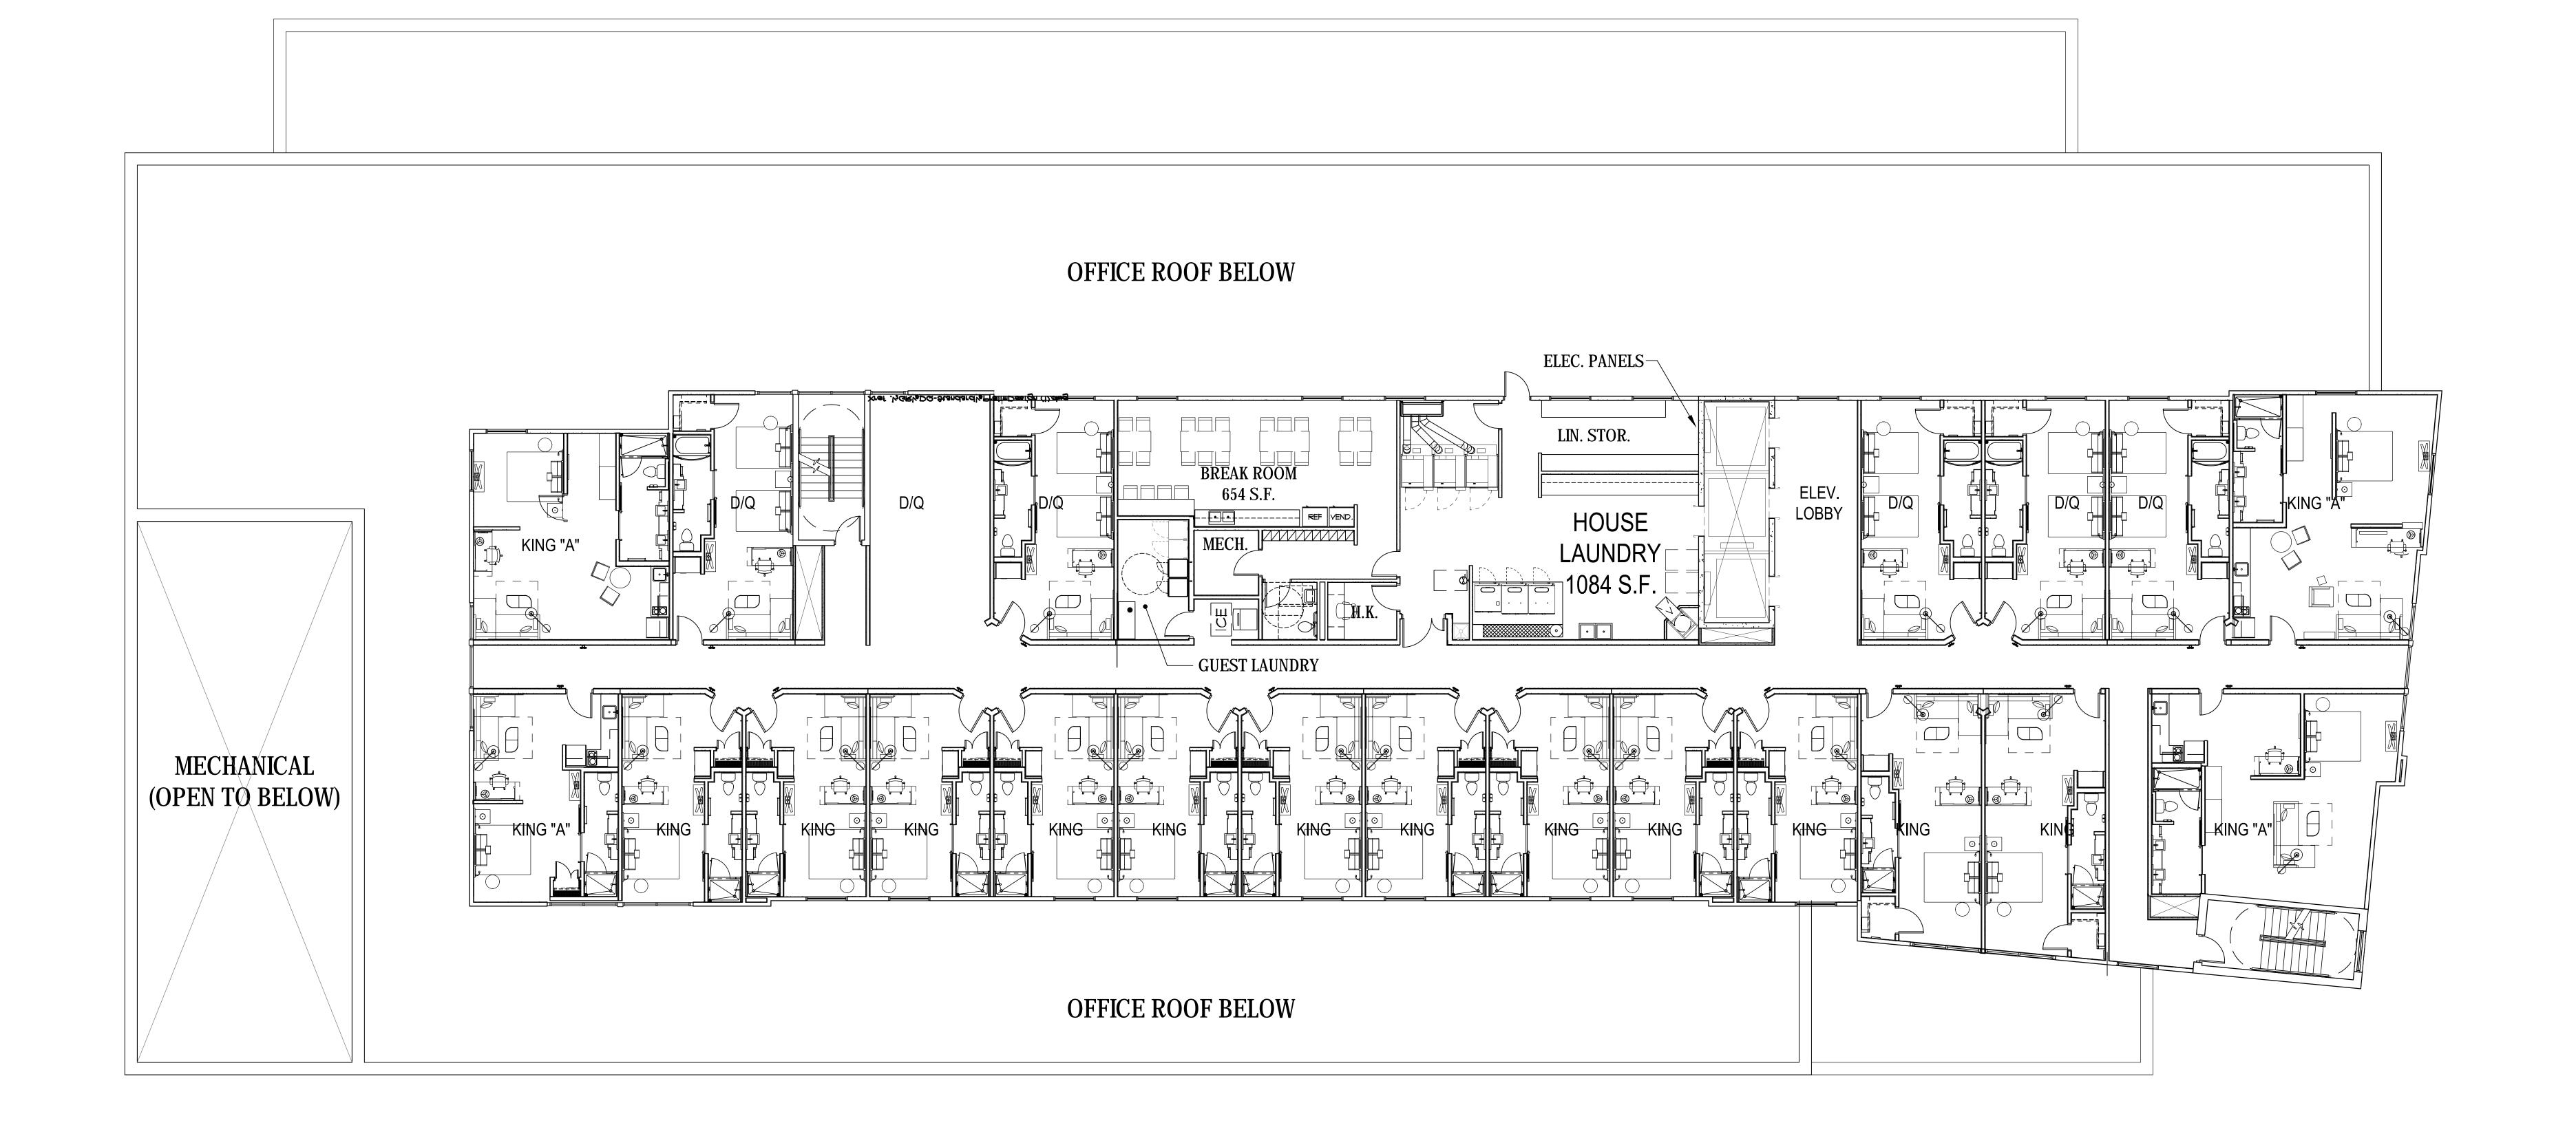

FLOOR PLAN FIFTH FLOOR 0' 4' 8' 16' 24'

PROJECT:
FREY STREET - MIXED USE DEVELOPMENT
4601 FREY STREET
MADISON, WISCONSIN 53705
CLENT:
FREY STREET LODGING ASSOCIATES, LLC
C/O RAYMOND MANAGEMENT COMPANY
8333 GREENWAY BOULEVARD
MIDDLETON, WI 53562 © 2016 GARY BRINK & ASSOC.

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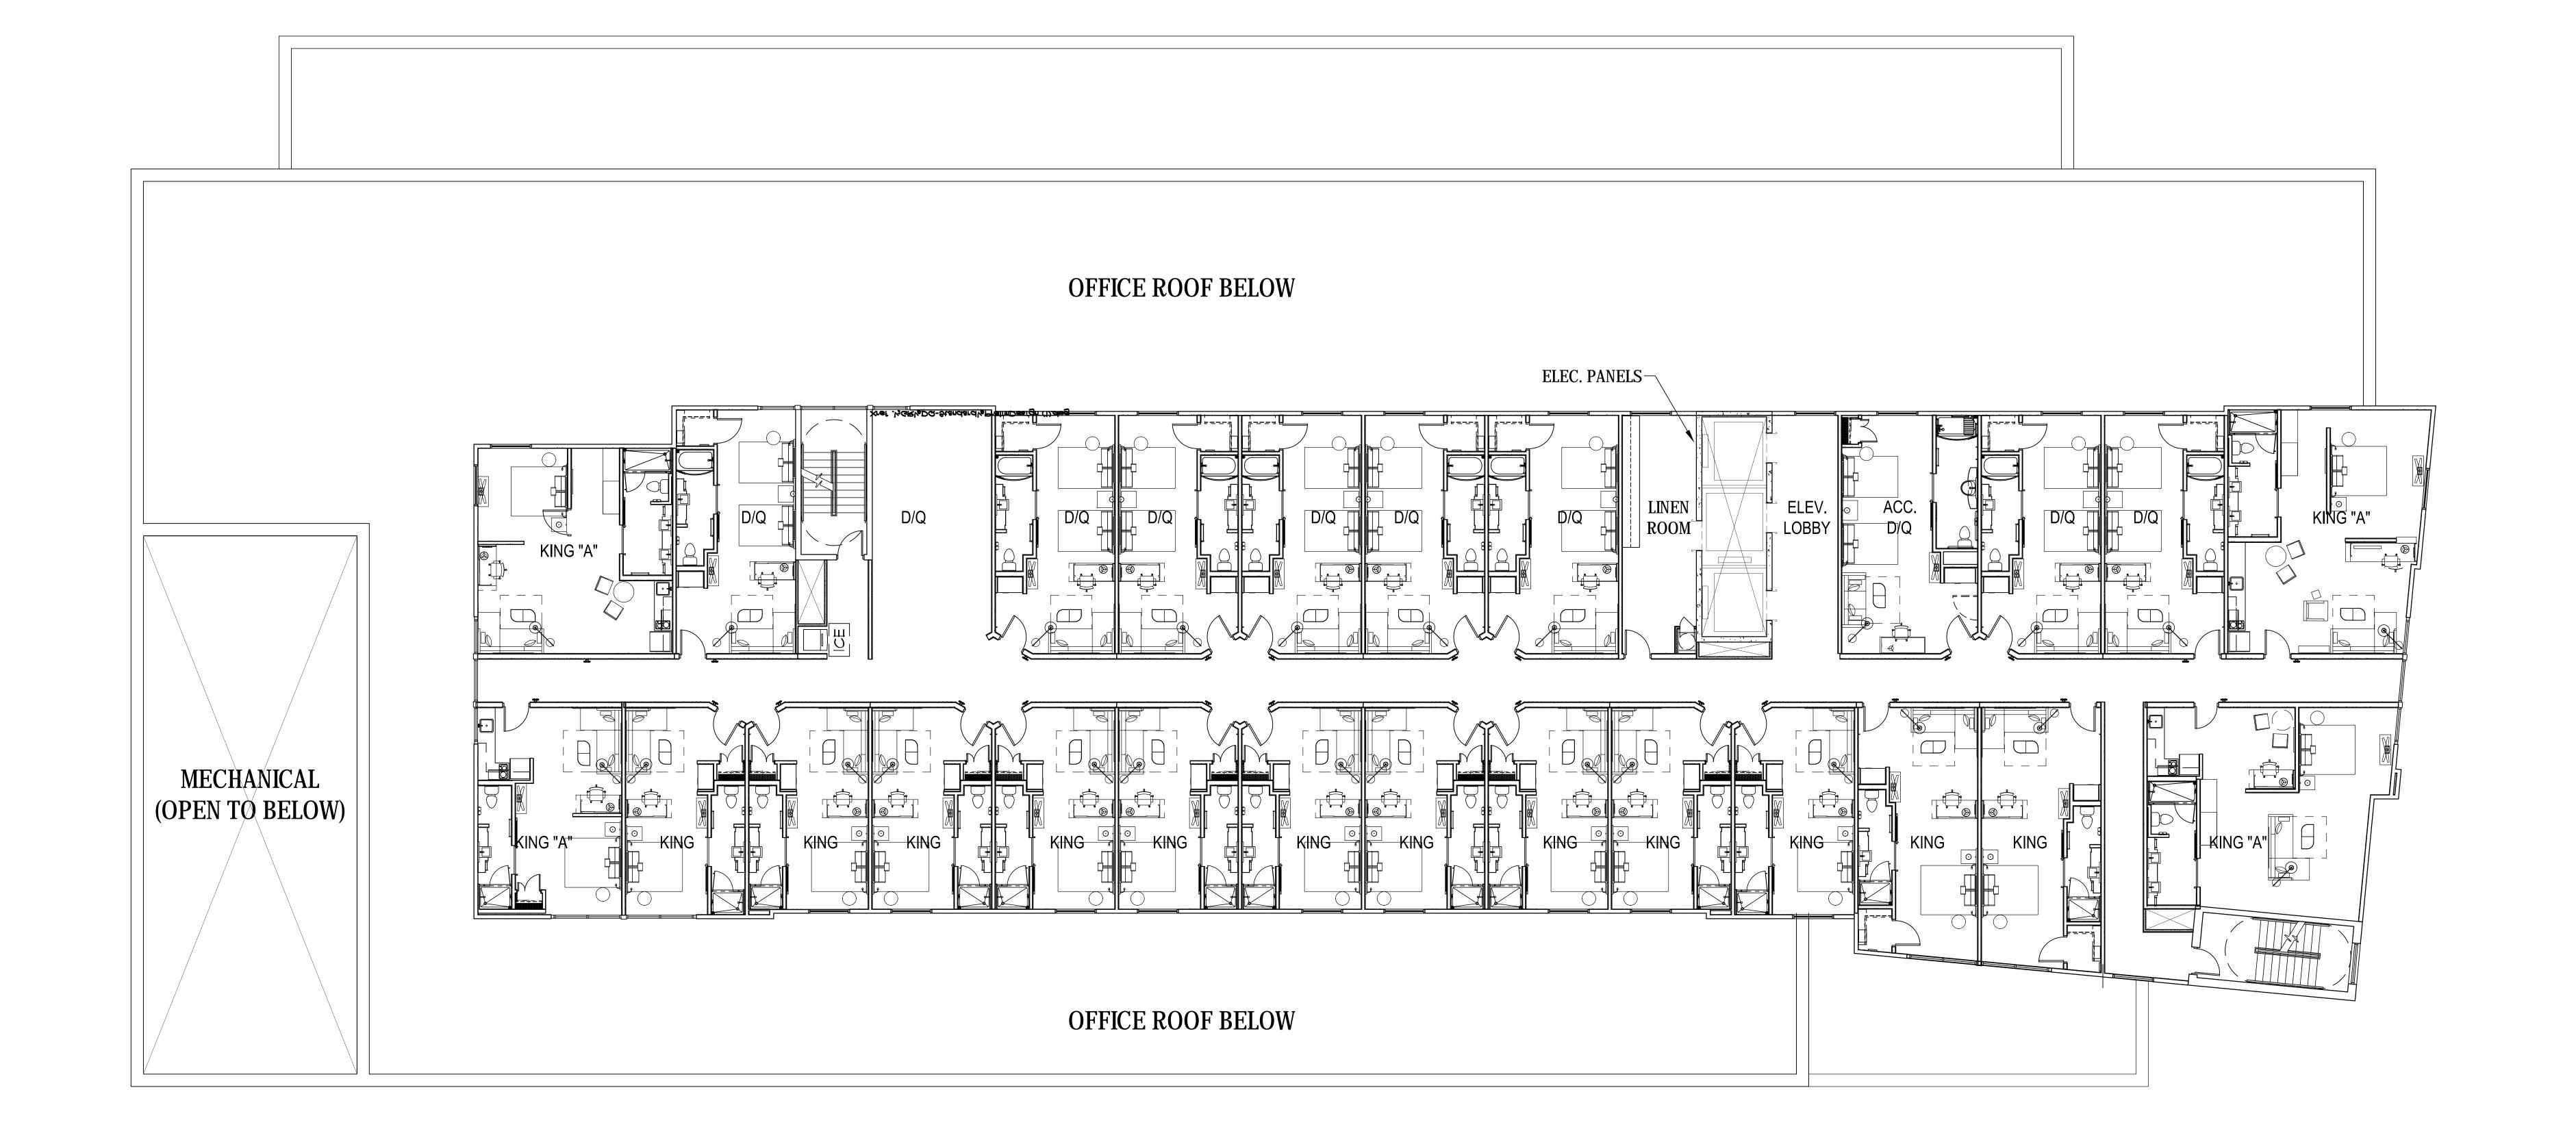
BY: BLM

DATE: 11-16-2016

SCALE: 1/8" = 1'-0"

upc *1 11-16-2016

DRAWN BY:



FLOOR PLAN
6th - 11th FLOOR

| 1/8' = 1'-0'

PROJECT:
FREY STREET - MIXED USE DEVELOPMENT
4601 FREY STREET
MADISON, WISCONSIN 53705
CLIENT:
FREY STREET LODGING ASSOCIATES, LLC
C/O RAYMOND MANAGEMENT COMPANY
8333 GREENWAY BOULEVARD
MIDDLETON, WI 53562

PROJECT:

DRAWN BY: BLM

DATE: 11-16-2016

SCALE: 1/8" = 1'-0"

UDC *1 11-16-2016





PROJECT:

HREY STREET - MIXED USE DEVELOPMENT

4601 FREY STREET - MIXED USE DEVELOPMENT

4601 FREY STREET

MADISON, WISCONSIN 53705

CLIENT:

FREY STREET LODGING ASSOCIATES, LLC

C/O RAYMOND MANAGEMENT COMPANY


BY S333 GREENWAY BOULEVARD


MIDDIETON, WI 53562

II-16-5016

II-16-5016



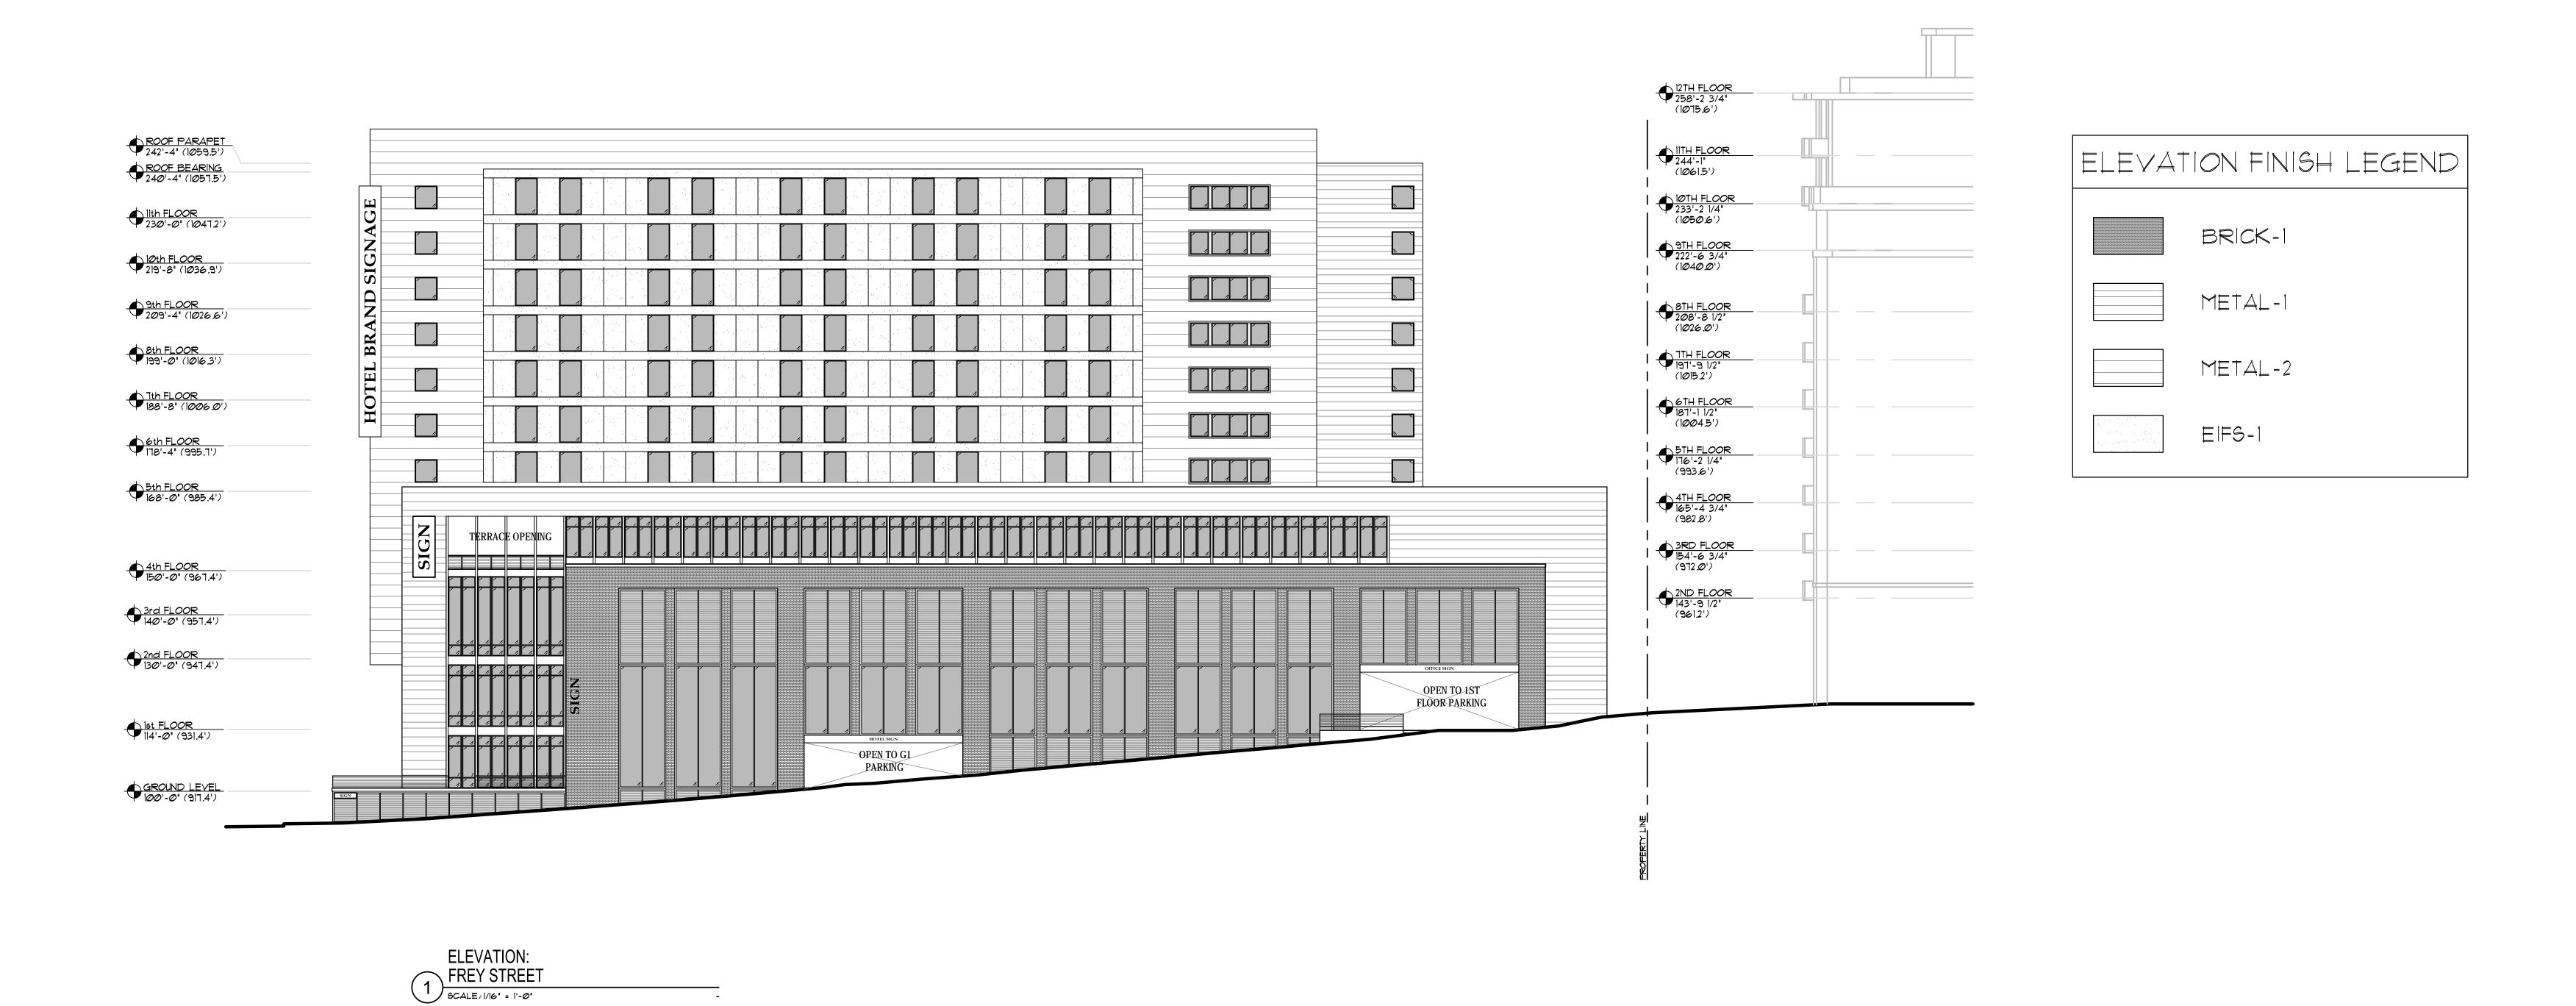

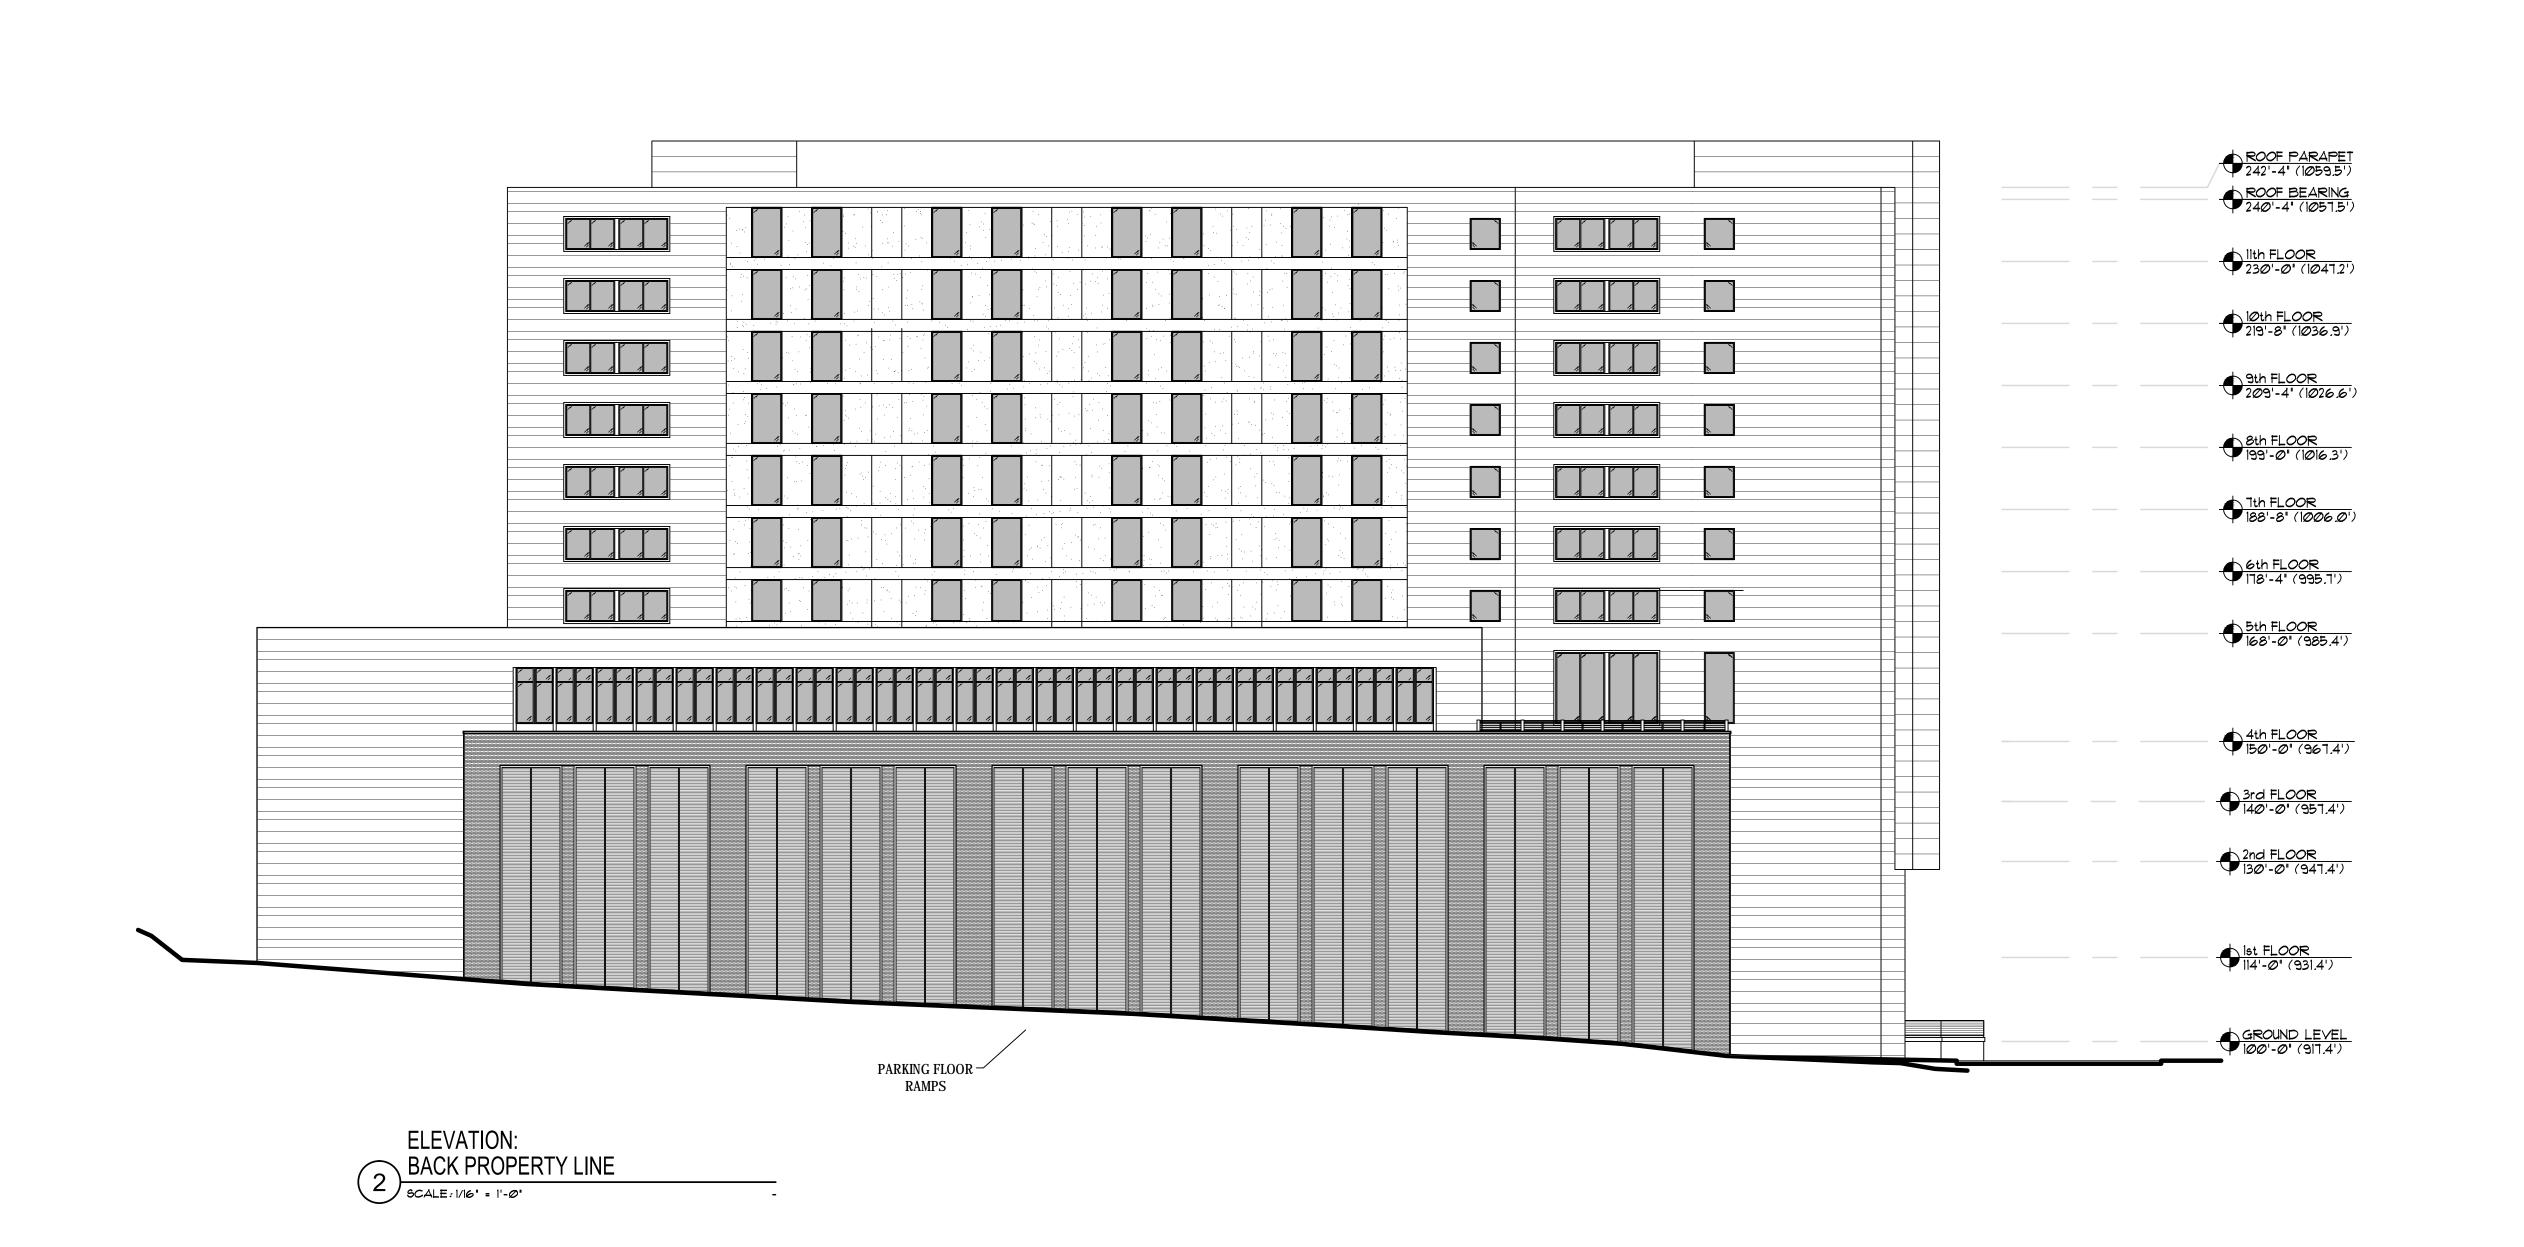

PROJECT:

CLIENT:

HREY STREET - MIXED USE DEVELOPMENT

4601 FREY STREET

MADISON, WISCONSIN 53705

CLIENT:

FREY STREET

MADISON, WISCONSIN 53706

CLIENT:

FREY STREET

MADISON, MISCONSIN 53706

CLIENT:

FREY STREET

A601 FREY STREET

MADISON, WISCONSIN 53706

CLIENT:

FREY STREET

COMPANY

S333 GREENWAY BOULEVARD


MIDDLETON, WI 53562

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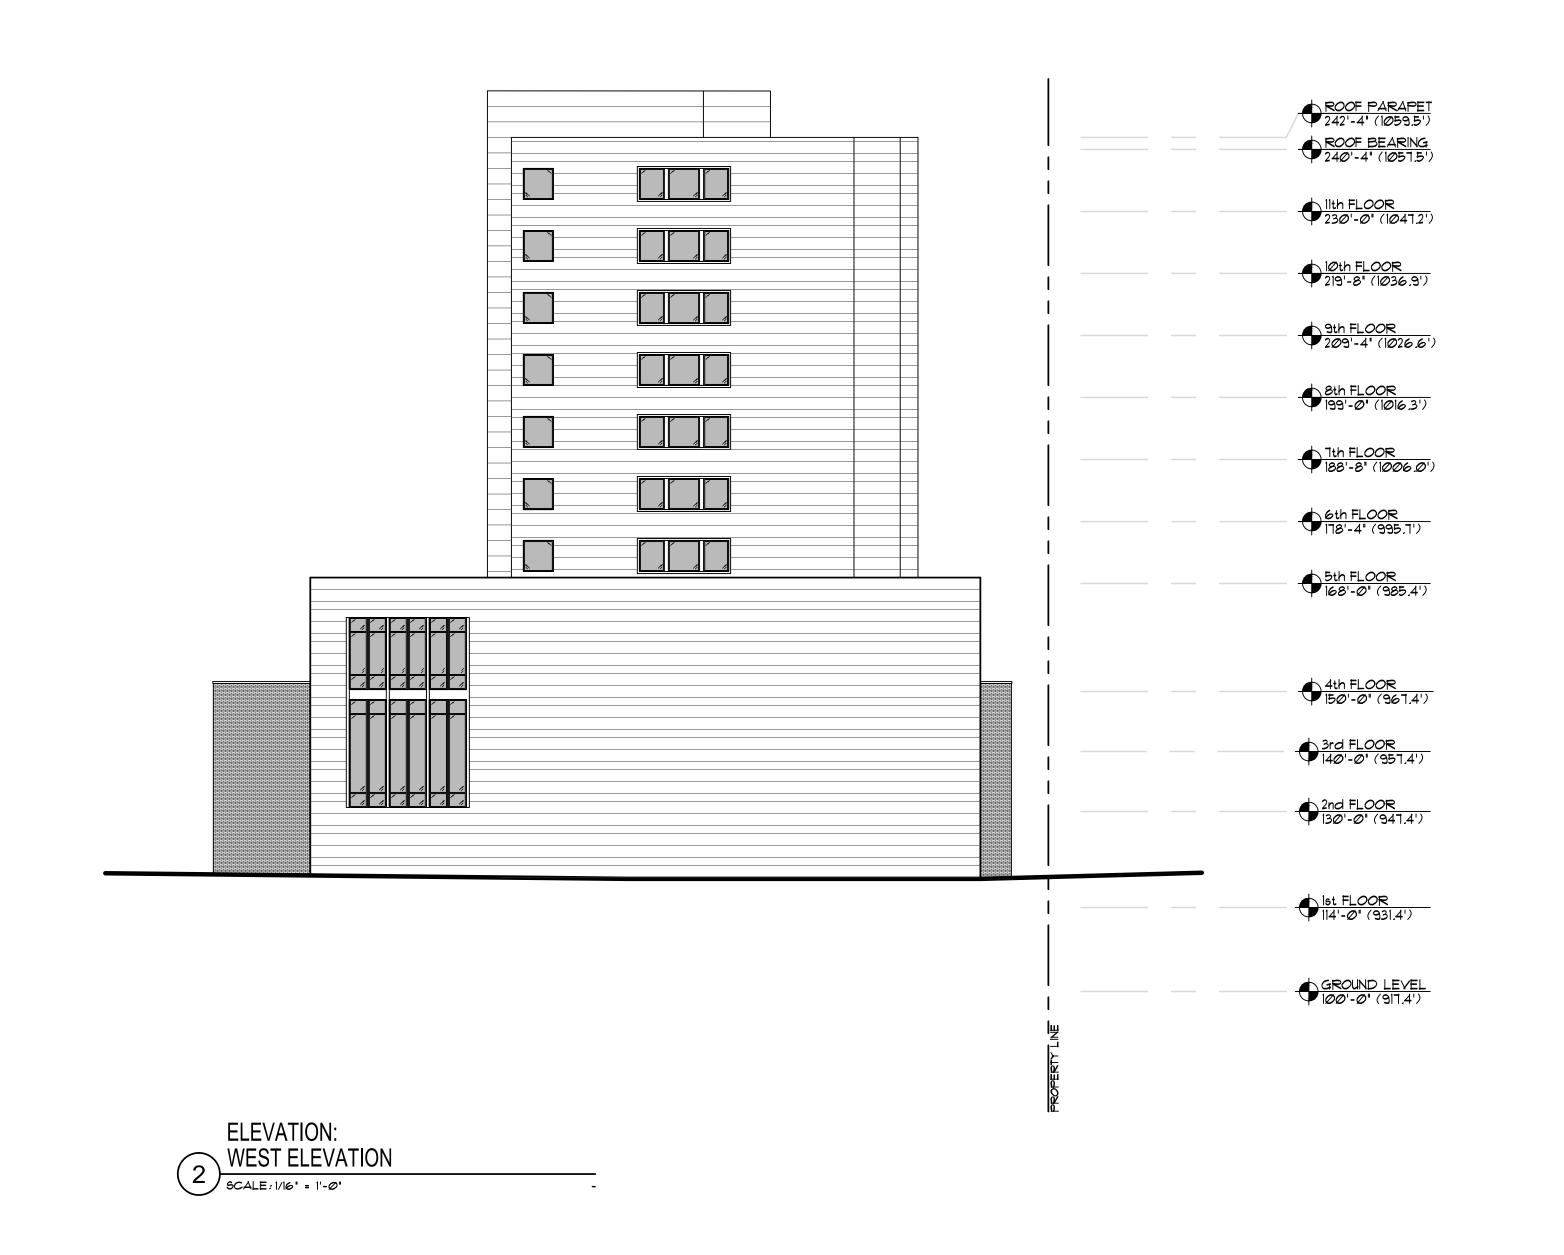
11-16-2016







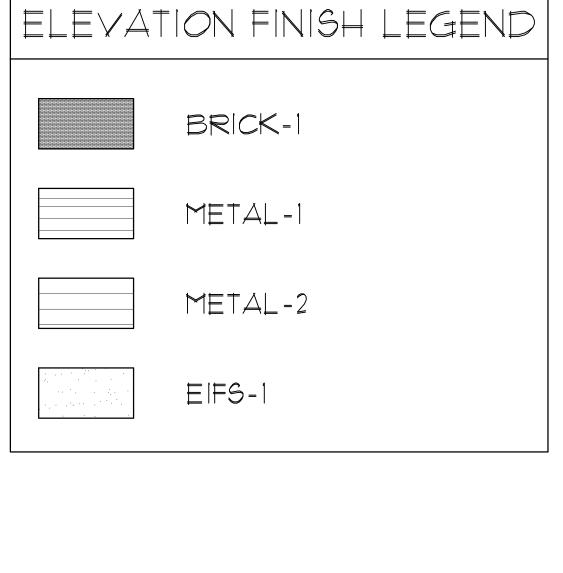




PROJECT:


HEEY STREET

A601 FREY STREET

A601 FR



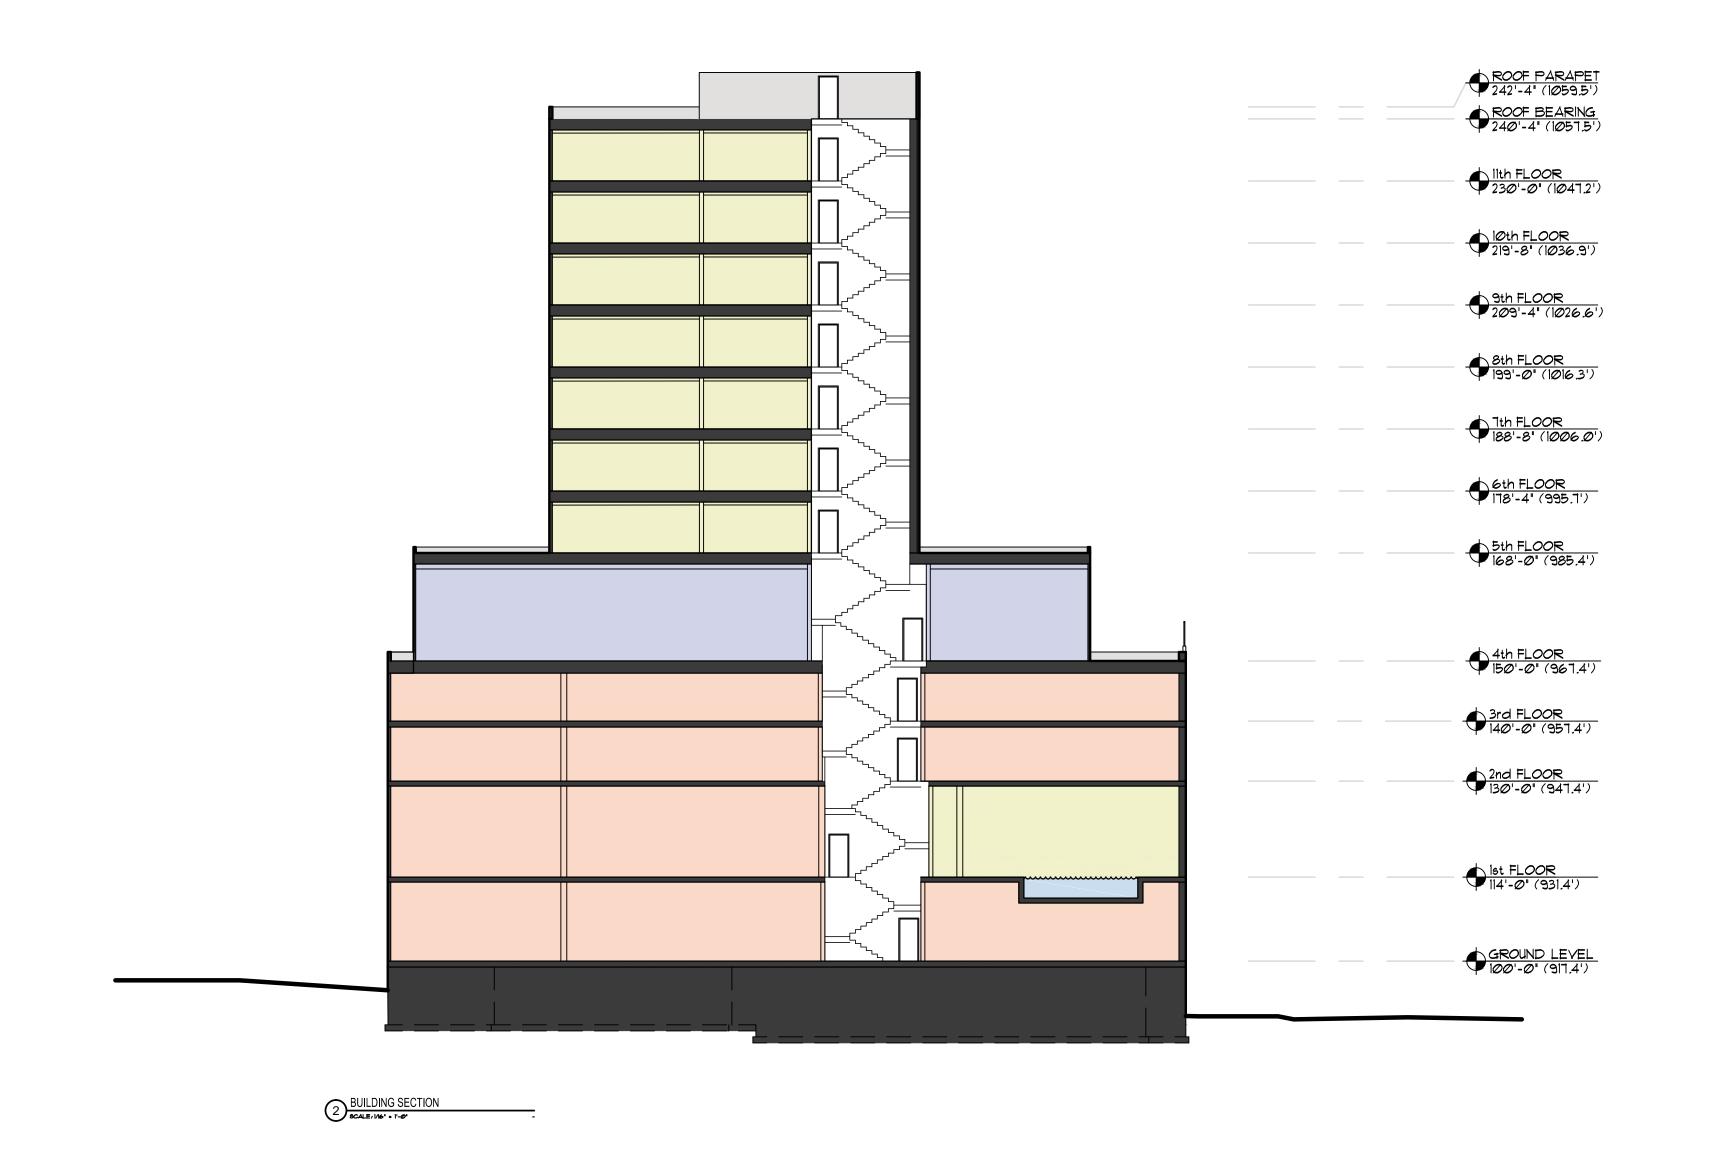

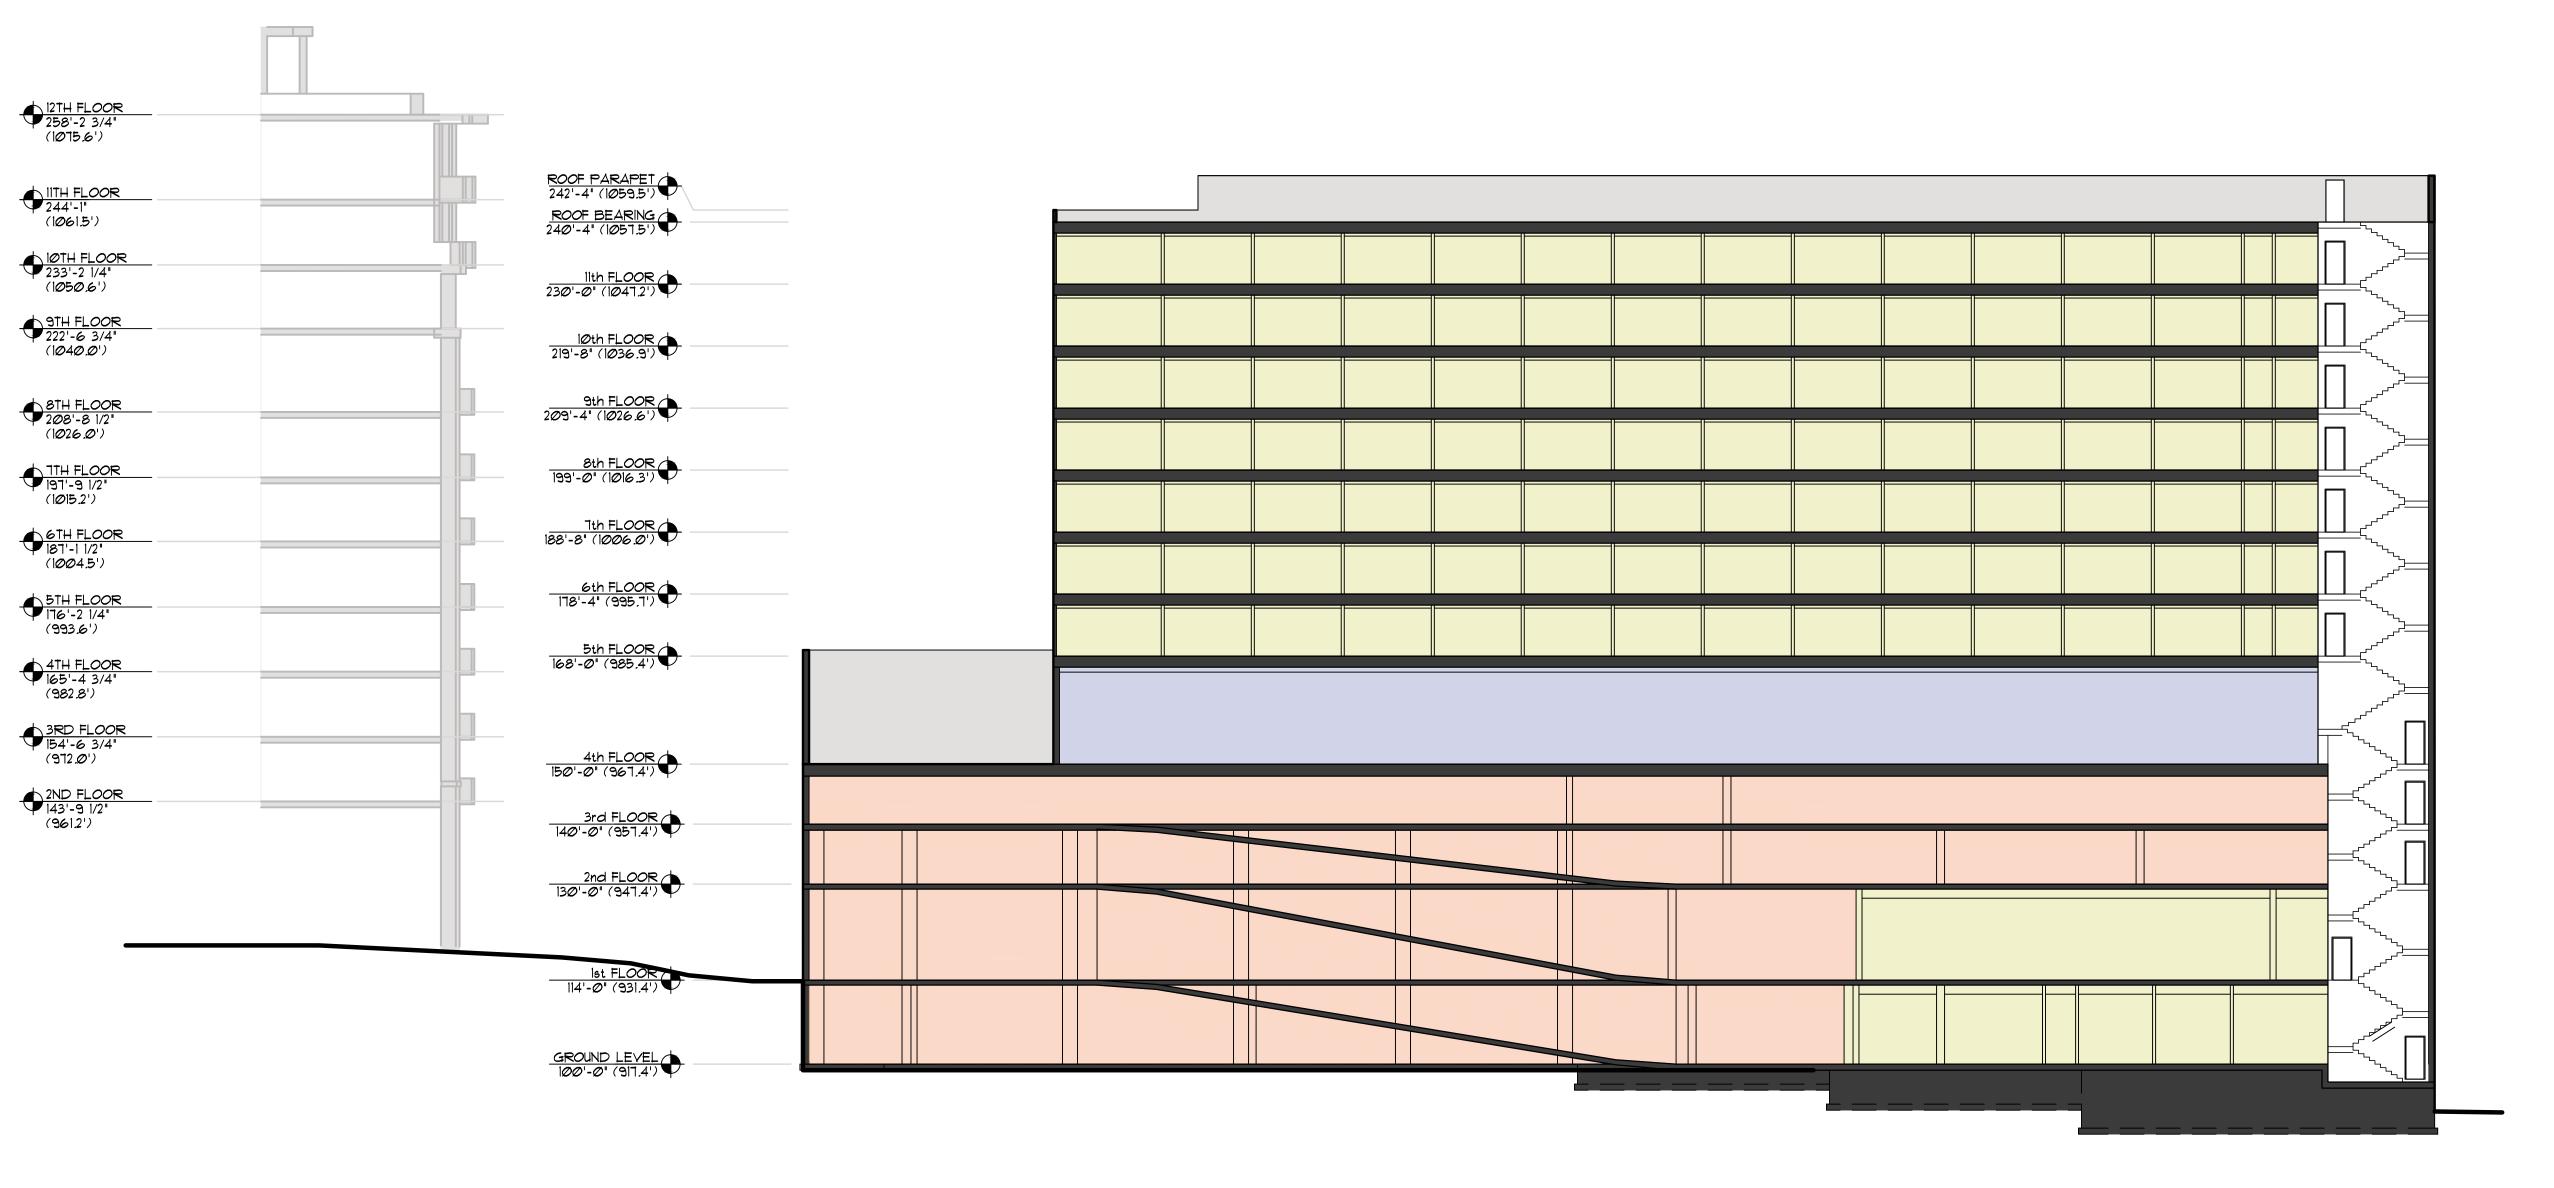

BUILDING SECTION

SCALE, 1/16* • 1'-0'

PROJECT:
FREY STREET - MIXED USE DEVELOPMENT
4601 FREY STREET
MADISON, WISCONSIN 53705
CLIENT:
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PROJECT: 201525

DRAWN BY: GJA

DATE:

11-16-2016

SCALE: