

Location

489 Commerce Drive

Applicant

Fred Rouse – Rouse Management Co Randy Bruce – Knothe & Bruce Architects, LLC


From:PD(GDP) To: Amended PD(GDP-SIP)

Existing Use Vacant


Proposed Use

Construct 80-unit apartment building

Public Hearing Date Plan Commission 21 November 2016 Common Council 06 December 2016

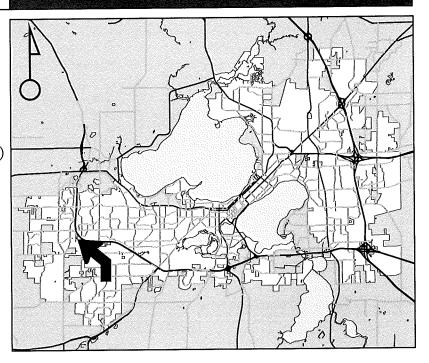

For Questions Contact: Jessica Vaughn at: 267-8733 or jvaughn@cityofmadison.com or City Planning at 266-4635

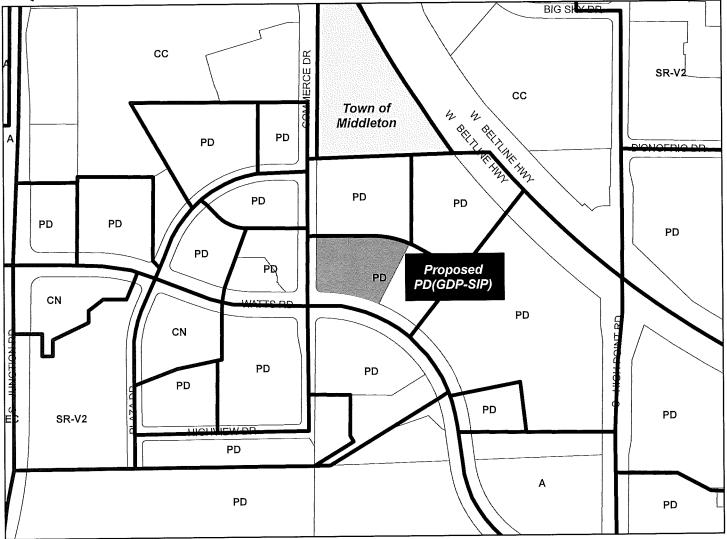

Scale: 1" = 400' City of Madison, Planning Division: PPE: Date: 15 November 2016





489 Commerce Drive



Date of Aerial Photography : Spring 2016

CITY OF MADISON



LAND USE APPLICATION

(G	FOR OFFICE USE ONLY:
215 Martin Luther King Jr. Blvd; Room LL-100	Amt. Paid \$1700 Receipt No. () 20529-00
PO Box 2985; Madison, Wisconsin 53701-2985	Date Received 9/7/16
Phone: 608.266.4635 Facsimile: 608.267.8739	Received By
 All Land Use Applications should be filed with the Zoning Administrator at the above address. 	Parcel No. 6708-262-0907-9 Aldermanic District 9- Skidmere
• The following information is required for all applications for Plan Commission review except subdivisions or land divisions, which should be filed using the <u>Subdivision Application</u> .	Zoning District PD Special Requirements Cy - Hold Review Required By:
This form may also be completed online at: <u>www.cityofmadison.com/developmentcenter/landdevelopment</u>	Urban Design Commission Plan Commission Common Council Other: Form Effective: February 21, 2013
1. Project Address: 489 Commerce Drive	LNDUSE-2016-00101
Project Title (if any):	
1,0,000 1,000 (1,000)	
2. This is an application for (Check all that apply to your Land	Use Application):
✓ Zoning Map Amendment from PD-GDP	to PD-SIP
	Major Amendment to Approved PD-SIP Zoning
☐ Review of Alteration to Planned Development (By Plan Con	
☐ Conditional Use, or Major Alteration to an Approved Condit	ional Use
☐ Demolition Permit	
Other Requests:	<u>.</u>
3. Applicant, Agent & Property Owner Information:	
Applicant Name: Fred Rouse Compa	ny: Rouse Management Co
Street Address: 2428 Perry Street City/State:	Madison, WI Zip: 53713
Telephone: (608) 251-7471 Fax: ()	Email: fred@rousemgmt.com
Project Contact Person: Randy Bruce Compa	ny: Knothe & Bruce Architects, LLC
7601 University Avenue Ste 201	Middleton, WI Zip: 53562
	Email: rbruce@knothebruce.com
Telephone: (608) 836-3690 Fax: ()	
Property Owner (if not applicant):	
Street Address: City/State:	Zip:
4. Project Information:	
Provide a brief description of the project and all proposed uses of the 80 unit multifamily development with underground parking	e site:
Development Schedule: Commencement Spring 2017	Spring 2018 Completion
Development Schedule. Commencement	

5. Required Submittal Information

All Land Use applications are required to include the following:

- ✓ Project Plans including:*
 - Site Plans (<u>fully dimensioned</u> plans depicting project details including all lot lines and property setbacks to buildings; demolished/proposed/altered buildings; parking stalls, driveways, sidewalks, location of existing/proposed signage; HVAC/Utility location and screening details; useable open space; and other physical improvements on a property)
 - Grading and Utility Plans (existing and proposed)
 - Landscape Plan (including planting schedule depicting species name and planting size)
 - Building Elevation Drawings (fully dimensioned drawings for all building sides, labeling primary exterior materials)
 - Floor Plans (fully dimensioned plans including interior wall and room location)

Provide collated project plan sets as follows:

- Seven (7) copies of a full-sized plan set drawn to a scale of 1 inch = 20 feet (folded or rolled and stapled)
- Twenty Five (25) copies of the plan set reduced to fit onto 11 X 17-inch paper (folded and stapled)
- One (1) copy of the plan set reduced to fit onto 8 ½ X 11-inch paper
- * For projects requiring review by the **Urban Design Commission**, provide *Fourteen (14) additional 11x17 copies* of the plan set. In addition to the above information, <u>all</u> plan sets should also include: 1) Colored elevation drawings with shadow lines and a list of exterior building materials/colors; 2) Existing/proposed lighting with photometric plan & fixture cutsheet; and 3) Contextual site plan information including photographs and layout of adjacent buildings and structures. The applicant shall <u>bring</u> samples of exterior building materials and color scheme to the Urban Design Commission meeting.
- Letter of Intent: Provide one (1) Copy per Plan Set describing this application in detail including, but not limited to:
 - Project Team
 - Existing Conditions
 - Project Schedule
 - Proposed Uses (and ft² of each)
 - Hours of Operation

- Building Square Footage
- Number of Dwelling Units
- Auto and Bike Parking Stalls
- Lot Coverage & Usable Open
 Space Calculations
- Value of Land
- Estimated Project Cost
- Number of Construction & Full-Time Equivalent Jobs Created
- Public Subsidy Requested
- Filing Fee: Refer to the Land Use Application Instructions & Fee Schedule. Make checks payable to: City Treasurer.
- Electronic Submittal: All applicants are required to submit copies of all items submitted in hard copy with their application as Adobe Acrobat PDF files on a non-returnable CD to be included with their application materials, or by e-mail to pcapplications@cityofmadison.com.
- Additional Information may be required, depending on application. Refer to the Supplemental Submittal Requirements.

6. Applicant Declarations

- Pre-application Notification: The Zoning Code requires that the applicant notify the district alder and any nearby neighborhood and business associations in writing no later than 30 days prior to FILING this request. List the alderperson, neighborhood association(s), and business association(s) AND the dates you sent the notices:

 Alder Paul Skidmore / July 19, 2016 & August 15, 2016
 - → If a waiver has been granted to this requirement, please attach any correspondence to this effect to this form.

The applicant attests that this form is accurately completed and all required materials are submitted:

Name of Applicant Fred Rouse

Authorizing Signature of Property Owner

Relationship to Property: Owner

Date 8/31 16



September 7, 2016

Ms. Heather Stouder
Department of Planning & Development
City of Madison
215 Martin Luther King Jr. Blvd
PO Box 2985
Madison, Wisconsin 53701

Re:

Letter of Intent

Rezoning to PUD-SIP 489 Commerce Drive

Dear Ms. Stouder:

The following is submitted together with the plans, application and zoning text for staff for approval.

Organizational structure:

Owner:

Fred Rouse

Rouse Management

2428 Perry Street

Madison, WI 53713

608-251-5382

608-251-5350 fax

Contact: Fred Rouse

info@rousemgmt.com

Engineer: Vierbicher

999 Fourier Drive Ste 201

Madison, WI 53717

608-826-0532

608-826-0530 fax

Contact: Joe Doyle

jdoy@vierbicher.com

Architect:

Knothe & Bruce Architects, LLC

7601 University Avenue, Ste 201

Middleton, WI 53562

608-836-3690

Contact: Randy Bruce

rbruce@knothebruce.com

Landscape

Design:

The Bruce Company

2830 Parmenter Street

Middleton, WI 53562

(608) 836-7041

Contact: Sarah Ricker

sricker@brucecompany.com

Introduction:

The proposed site is located on the northwest corner of Commerce Drive and Watts Road. It is part of the PUD that contains the Princeton Health Club, a dental office and two existing hotels: Hampton Inn & Suites and Homewood Suites. Other surrounding uses in this mixed-use neighborhood include professional offices, a grocery, restaurants, coffee shop, a senior living community and market-rate multifamily housing.

Letter of Intent 489 Commerce Drive September 07, 2016 Page 2 of 3

A development proposal for a third hotel is being submitted at this same time for the site immediately east of the subject property. The site planning and civil engineering have been coordinated between the two sites.

In addition to this proposal and the proposed PD-SIP for the hotel, an Alteration to a PD-GDP is being submitted which will expand the allowable uses within the GDP area. A CSM will also be submitted that will redefine the lot line separating the two proposed developments.

Project Description:

The project consists of an 80 unit, four-story multi-family building with enclosed parking at the basement and first floor levels. The building takes advantage of the topography and is set into the site to provide vehicular access to the two parking levels. The "L-shaped "building will front both Commerce Drive and Watts Road and features strong architecture at the street corner. Pedestrian access is located off the parking (north) and the Watts Road (south) sides of the building. Vehicular access is achieved from Homewood Way, the private internal street that serves the properties within the PUD.

Site Development Data:

Densities:

Lot Area 80,617 S.F. or 1.85 acres

Dwelling Units 80 units

Lot Area / D.U. 1,007 S.F./unit Density 43 units/acre

Building Height 4 stories

Usable Open Space 15,586 S.F. (194 S.F./unit)

Lot Coverage 48,859 S.F.

Dwelling Unit Mix:

Efficiency	13
One Bedroom	47
One Bedroom + Den	4
Two Bedroom	14
Two Bedroom + Den	_2
Total	80

Vehicle Parking Stalls:

Basement Level	63
First Floor Level	18
Surface	_43
Total	124

Parking Ratio 1.5 stalls/unit

Bicycle Parking:

	Floor Mount	Wall Mount	Total
Underground	23	12	35
First Floor	<u>30</u>	7	37
Total-Secured	53	19 (24%)	72 (90%)
Surface			8
Surface-Short Term			8 (10% of units)
Total			88 bike stalls

Project Schedule:

The project is a single building and will be constructed starting in spring 2017 and be completed in summer 2018.

Social & Economic Impacts:

This development will have a positive social and economic impact. Many construction industry jobs will be supported and additional high-quality, energy efficient housing will be provided to the marketplace.

Thank you for your time reviewing our proposal.

Sincerely,

Zoning Text 489 Commerce Drive PD -SIP September 07, 2016 KBA #1217

Legal Description:

Lot 4, Certified Survey Map Number 11993, as recorded in Volume 73 of Certified Survey Maps, on pages 352-358, as Document Number 4257029, Dane County Registry and located in the Southwest Quarter of the Northwest Quarter of Section 26, Township 07 North, Range 08 East, City of Madison, Dane County, Wisconsin.

- A. Statement of Purpose: This zoning district is established to allow for the construction of a residential development with 80 dwelling units.
- B. Permitted Uses: Following are permitted uses:
 - 1. Multifamily residential uses as shown on approved plans.
 - 2. Accessory uses including but not limited to:
 - a. Accessory uses directly associated with those permitted uses including parking for residents and guests.
 - b. Temporary buildings for storage of building materials and equipment for construction purposes when on the same lot as a principle use for a period not to exceed the duration of such construction.
- C. Lot Area: As shown on the approved plans.
- D. Height Regulations: As shown on the approved plans.
- E. Yard Regulations: As shown on the approved plans.
- F. Landscaping: Landscaping will be provided as shown on the approved plans.
- G. Usable Open Space Requirements: Usable open space will be provided as shown on the approved plans.
- H. Parking & Loading: Off-street parking and loading shall be provided as shown on the approved plans.
- I. Family Definition: The family definition shall coincide with the definition given in M.G.O. for the TR-U2 zoning district.
- J. Signage: Signage for the residential building will be allowed as provided by M.G.O. and as further regulated for the TR-U2 zoning district, with signage as approved by the Urban Design Commission and Zoning Administrator.
- K. Alterations and Revisions: No alteration or revision of this Planned Unit Development shall be permitted unless approved by the City Planning Commission, however, the Zoning Administrator may issue permits for minor alterations or additions which are approved by the, Director Of Planning and Development and the alderperson of the district and are compatible with the concept approved by the City Planning Commission.

Cree Edge™ Series

LED Area/Flood Luminaire

Product Description

The Cree Edge™ Series has a stim, low profile design. Its rugged cast aluminum housing minimizes wind load requirements and features an integral, weathertight LED driver compartment and high performance aluminum heat sinks. Various mounting choices: Adjustable Arm, Direct Arm, Direct Arm Long, or Side Arm (details on page 2). Includes a leaf/debris guard.

Applications: Parking lots, walkways, campuses, car dealerships, office complexes, and internal roadways

Performance Summary

Patented NanoOptic® Product Technology

Made in the U.S.A. of U.S. and imported parts

CRI: Minimum 70 CRI

CCT: 4000K (+/- 300K), 5700K (+/- 500K) standard

Limited Warranty[†]: 10 years on luminaire/10 years on Colorfast DeltaGuard® finish


Accessories

Field-Installed	
Bird Spikes XA-BRDSPK	Backlight Control Shields XA-20BLS-4
Hand-Held Remote	- Four-pack
XA-SENSREM	- Unpainted stainless steel
- For successful implementation of the progra	

489 Commerce Drive

DA Mount



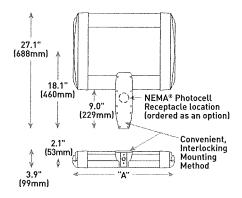

LED Count (x10)	Dim. "A"	Weight
02	12.1" (306mm)	21 lbs. (10kg)
04	12.1" (306mm)	24 lbs. (11kg)
06	14.1" (357mm)	27 lbs. (12kg)
08	16.1" (408mm)	28 lbs. (13kg)
10	18.1" [459mm]	32 lbs. (15kg)
12	20.1" (510mm)	34 lbs. (15kg)
14	22.1" (560mm)	37 lbs. (17kg)
16	24.1" [611mm]	41 lbs. [19kg]

AA/DL/SA Mount - see page 22 for weight & dimensions

Ordering Information

Example: ARE-EDG-2M-AA-12-E-UL-SV-350

						E					
Product	Optic			Mounting*	LED Count (x10)	Series	Voltage	Color Options	Drive Current	Options	
ARE- EDG	2M Type II Medium 2MB Type II Medium w/BLS 2MP Type II Medium w/Partial BLS 3M Type III Medium	3MB Type III Medium w/BLS 3MP Type III Medium w/Partial BLS 4M Type IV Medium 4MB Type IV Medium w/BLS	4MP Type IV Medium w/Partial BLS 5M Type V Medium 5S Type V Short	AA Adjustable Arm DA Direct Arm DL Direct Long Arm SA Side Arm - Available with 20-60 LEDs	02 04 06 08 10 12 14 16	E	UL Universal 120-277V UH Universal 347-480V	BK Black BZ Bronze SY Silver WH White	350 350mA 525 525mA 700 700mA - Available with 20- 60 LEOs	DIM 0-10V Dimming - Control by others - Refer to Dimming spec sheet for details - Can't exceed specified drive current F Fuse - Refer to ML spec sheet for availability with ML options - Available with UL voltage only - When code dictates fusing, use time delay fuse HL Hi/Low (Duat Circuit Input) - Refer to HL spec sheet for details - Sensor not included	PML Programmable Multi-Level, 20-40' Mounting Height - Refer to PML spec sheet for details - Intended for downlight applications at 0' tilt PML2 Programmable Multi-Level, 10-30' Mounting Height - Refer to PML spec sheet for details - Intended for downlight applications at 0' tilt R NEMA* Photocell Receptacle - Intended for downlight applications with maximum 45' tilt - Photocell by others
FLD- EDG	25 25° Flood 40 40° Flood	70 70° Flood SN Sígn	N6 NEMA [©] 6							ML Multi-Level - Refer to ML spec sheet for details - Intended for downlight applications at 0° tilt P Photocell - Refer to ML spec sheet for availability with ML options - Available with UL voltage only	Refer to ML spec sheet for availability with ML options 40K 4000K Color Temperature Minimum 70 CRI Color temperature per luminaire

Reference EPA and pole configuration suitability data beginning on page 19 NOTE: Price adder may apply depending on configuration





Rev. Date: V3 08/03/2016




See http://lighting.cree.com/warranty for warranty terms


Cree Edge™ LED Area/Flood Luminaire

Photometry

All published luminaire photometric testing performed to IESNA LM-79-08 standards by a NVLAP accredited laboratory. To obtain an IES file specific to your project consult: http://lighting.cree.com/products/outdoor/area/cree-edge-series-1

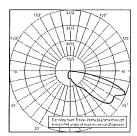

CSA Test Report #: 6448 ARE-EDG-3MB-**-06-E-UL-700 Initial Delivered Lumens: 7,740

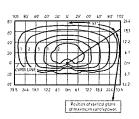

ARE-EDG-3MB-**-12-E-UL-525-40K Mounting Height: 25' [7.6m] A.F.G. Initial Delivered Lumens: 12,420 Initial FC at grade

	dium Distributio		E200V	ens dreg his hydersate marking hely		
LED Count	4000K		5700K			
LED Count (x10)	Initial Delivered Lumens*	BUG Ratings" Per TM-15-11	Initial Delivered Lumens*	BUG Ratings" Per TM-15-11		
350mA						
02	1,499	B1 U0 G1	1,557	B1 U0 G1		
04	2,999	B1 U0 G1	3,114	B1 U0 G1		
06	4,446	B1 U0 G1	4,617	B1 U0 G1		
08	5,929	B1 U0 G2	6,157	B1 U0 G2		
10	7,393	B1 U0 G2	7,677	B1 U0 G2		
12	8,872	B1 U0 G2	9,213	B1 U0 G2		
14	10,285	B1 U0 G2	10,680	B1 U0 G2		
16	11,754	B1 U0 G3	12,206	B1 U0 G3		
525mA						
02	2,099	B1 U0 G1	2,180	B1 U0 G1		
04	4,198	B1 U0 G1	4,359	B1 U0 G1		
06	6,225	B1 U0 G2	6,464	B1 U0 G2		
08	8,300	B1 U0 G2	8,619	B1 U0 G2		
10	10,350	B1 U0 G2	10,748	B1 U0 G2		
12	12,420	B1 U0 G3	12,898	B1 U0 G3		
14	14,398	B1 U0 G3	14,952	B2 U0 G3		
16	16,455	B2 U0 G3	17,088	B2 U0 G3		
700mA						
02	2,564	B1 U0 G1	2,662	B1 U0 G1		
04	5,127	B1 U0 G2	5,325	B1 U0 G2		
06	7,603	B1 U0 G2	7,896	B1 U0 G2		


^{*} Initial delivered lumens at 25°C (77°F). Actual production yield may vary between -10 and +10% of initial delivered

turnens
** For more information on the IES BUG (Backlight-Uplight-Glare) Rating visit: www.ies.org/PDF/Erratas/TM-15-11BugRatingsAddendum.pdf. Vatid with no titt







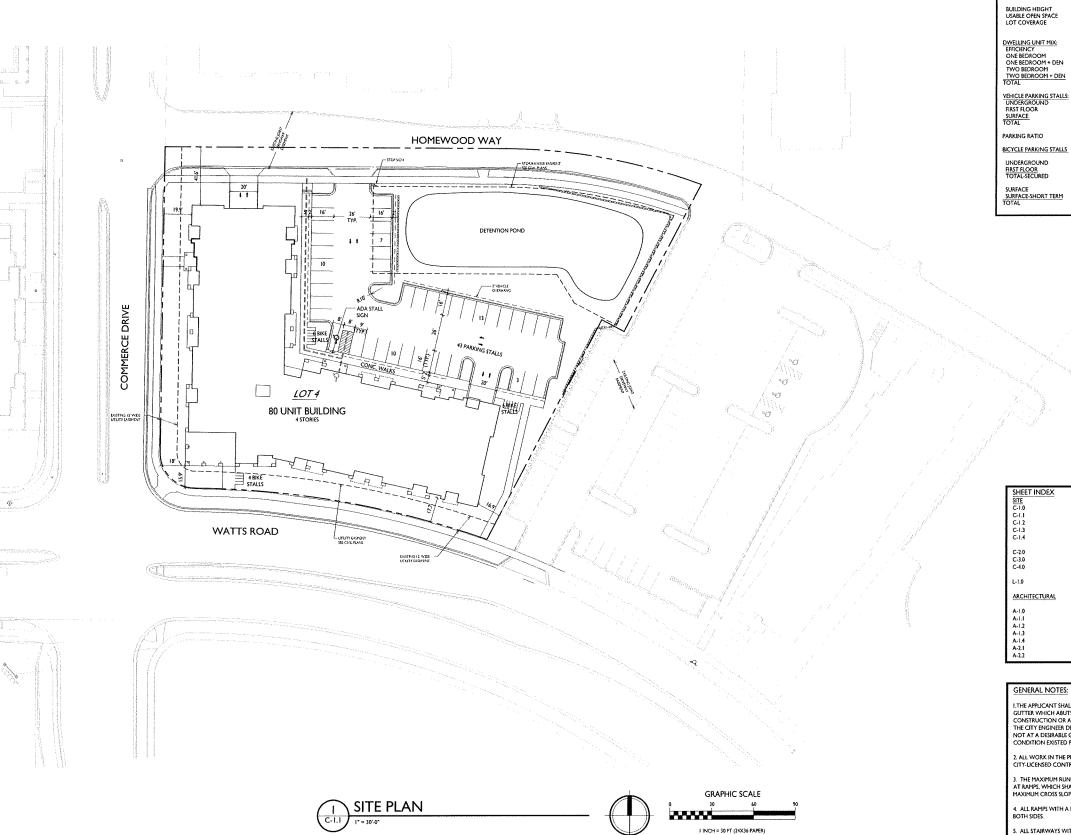

SITE DEVELOPMENT DATA
DENSITIES
LOT AREA
DWELLING UNITS
LOT AREA/ D.U.
DENSITY 80,617 S.F./1.8 ACRES 80 DU 1,007 S.F./DU 43 UNITS/ACRE 4 STORIES 18,259 S.F. (228 S.F/UNIT) 47,584S.F (59%) 124 VEHICLE STALLS 1.5 STALLS/UNIT 8 (10% OF UNITS

knothe | bruce Phone: 7601 University Ave, Ste 201 608.836.3690 Hiddleton, WI 53562

ISSUED

Issued for Land Use - September 07, 2016 Issued for Diocese Review - September 23, 2016 Ussued for PC & UDC - October 20, 2016

PROJECT TITLE

I.THE APPLICANT SHALL REPLACE ALL SIDEWALK AND CURB AND GUTTER WHICH ABUTS THE PROPERTY WHICH IS DAMAGED BY THE CONSTRUCTION OR ANY SIDEWALK AND CURB AND GUTTER WHICH THE CITY ENGINEER DETERMINES NEEDS TO BE REPLACED BECAUSE IT IS NOT AT A DESIRABLE GRADE REGARDLESS OF WHETHER THE CONDITION EXISTED PRIOR TO BEGINNING CONSTRUCTION.

SITE PLAN SITE LIGHTING HRE DEPARTMENT ACCESS OPEN SPACE LOT COVERAGE

EXISTING CONDITIONS

BASEMENT PLAN
FIRST FLOOR PLAN
SECOND FLOOR PLAN
THIRD FLOOR PLAN
FOURTH FLOOR PLAN
ELEVATIONS
ELEVATIONS

SITE GRADING AND EROSION CONTROL PLAI SITE UTILITY PLAN

ALL WORK IN THE PUBLIC RIGHT OF WAY SHALL BE PERFORMED BY CITY-LICENSED CONTRACTOR.

3. THE MAXIMUM RUNNING SLOPE OF ALL WALKS SHALL BE 1:20, EXCEP AT RAMPS, WHICH SHALL HAVE A MAXIMUM SLOPE OF 1:12. THE MAXIMUM CROSS SLOPE AT ALL WALKS SHALL BE 1:50.

4. ALL RAMPS WITH A RISE OVER 6 INCHES SHALL HAVE HANDRAILS ON BOTH SIDES.

5. ALL STAIRWAYS WITH MORE THAN ONE RISER SHALL HAVE HANDRAILS ON BOTH SIDES.

6.ALL DAMAGE TO THE PAVEMENT ON COMMERCE DRIVE & WATTS ROAD ADJACENT TO THIS DEVELOPMENT SHALL BE RESTORED IN ACCORDANCE WITH THE CITY OF MADISONS PAVEMENT PATCHING CRITERIA.

7.APPROVAL OF PLANS FOR THIS PROJECT DOES NOT INCLUDE ANY APPROVAL TO PRUNE, REMOVE, OR PLANT TREES IN THE PUBLIC RIGHT-OF-WAY, PERMISSION FOR SUCH ACTIVITIES MUST BE OBTAINE FROM THE CITY FORESTER, 266-4816.

SHEET TITLE Site Plan

SHEET NUMBER

PROJECT NO.

© Knothe & Bruce Architects. LLC



STATISTIC	S					
Description	Symbol	Avg	Max	Min	Max/Min	Avg/Min
Calc Zone #1	+	1.2 fc	2.1 fc	0.4 fc	5.3:1	3.0:1


ymbol	Label	Qty	Catalog	Description	Lamp	File	Mounting
	Α	5	ARE-EDG-3MB-**- 06-E-UL-350-40K (350mA)	LED TYPE III MEDIUM OPTIC W/ FULL BACKLIGHT 700MA 4000K LEDWAY STREETLIGHT	60 WHITE LED, VERTICAL BASEUP	ARE-EDG- 3MB06-E- UL-350-40K- CONFIGURED. IES	16'-0" POLE ON 2'-0" TALL CONC. BASE
0	В	2	SEC-EDG-4MB-**- 02-E-UL-350-40K (350mA)	CREE EDGE AREA, TYPE IV MEDIUM W- FULL BLS, 120 LEDS, 525MA, 4000K	120 WHITE LED, VERTICAL BASE-UP	SEC-EDG- 4MB02-E- UL-350-40K- CONFIGURED. IES	8'-0" AOVE GRADE ON SIDE OF BUILDING
			EX	AMPLE LIGHT FIX	TURE DISTRIBU	ITION	
				ISOLUX	CONTOUR = 0.25 F	c	
	((• /	CONTOUR = 0.5 FC	eur.	
	1)		/ (/ ISOLUX	CONTOUR = 1.0 FC	ì.	
		L		LIGHT	FIXTURE		

PROJECT TITLE
489 Commerce Dr.


Site Lighting Plan


SHEET NUMBER

PROJECT NO. © Knothe & Bruce Architects, LLC

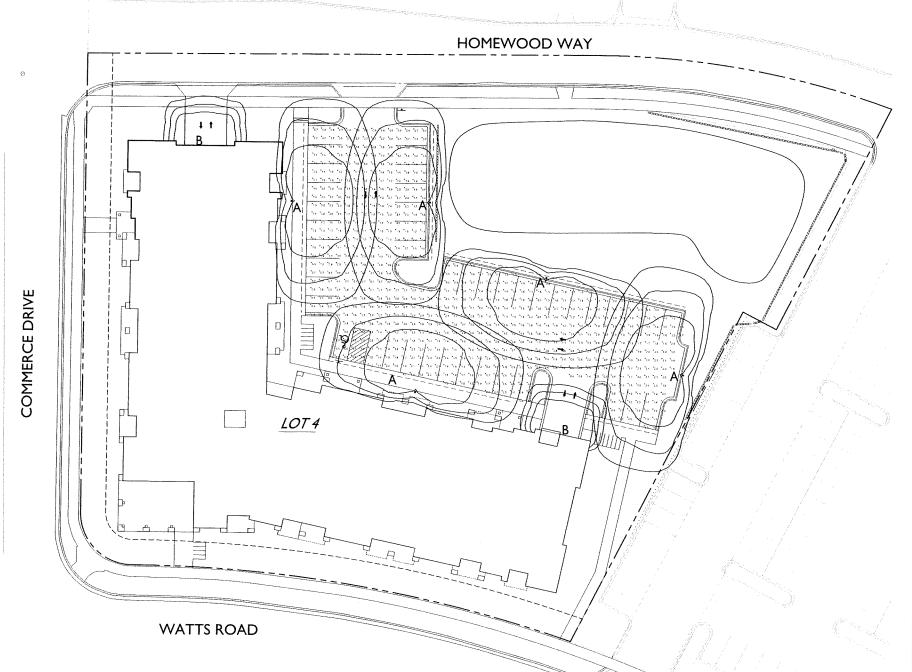

SITE LIGHTING PLAN

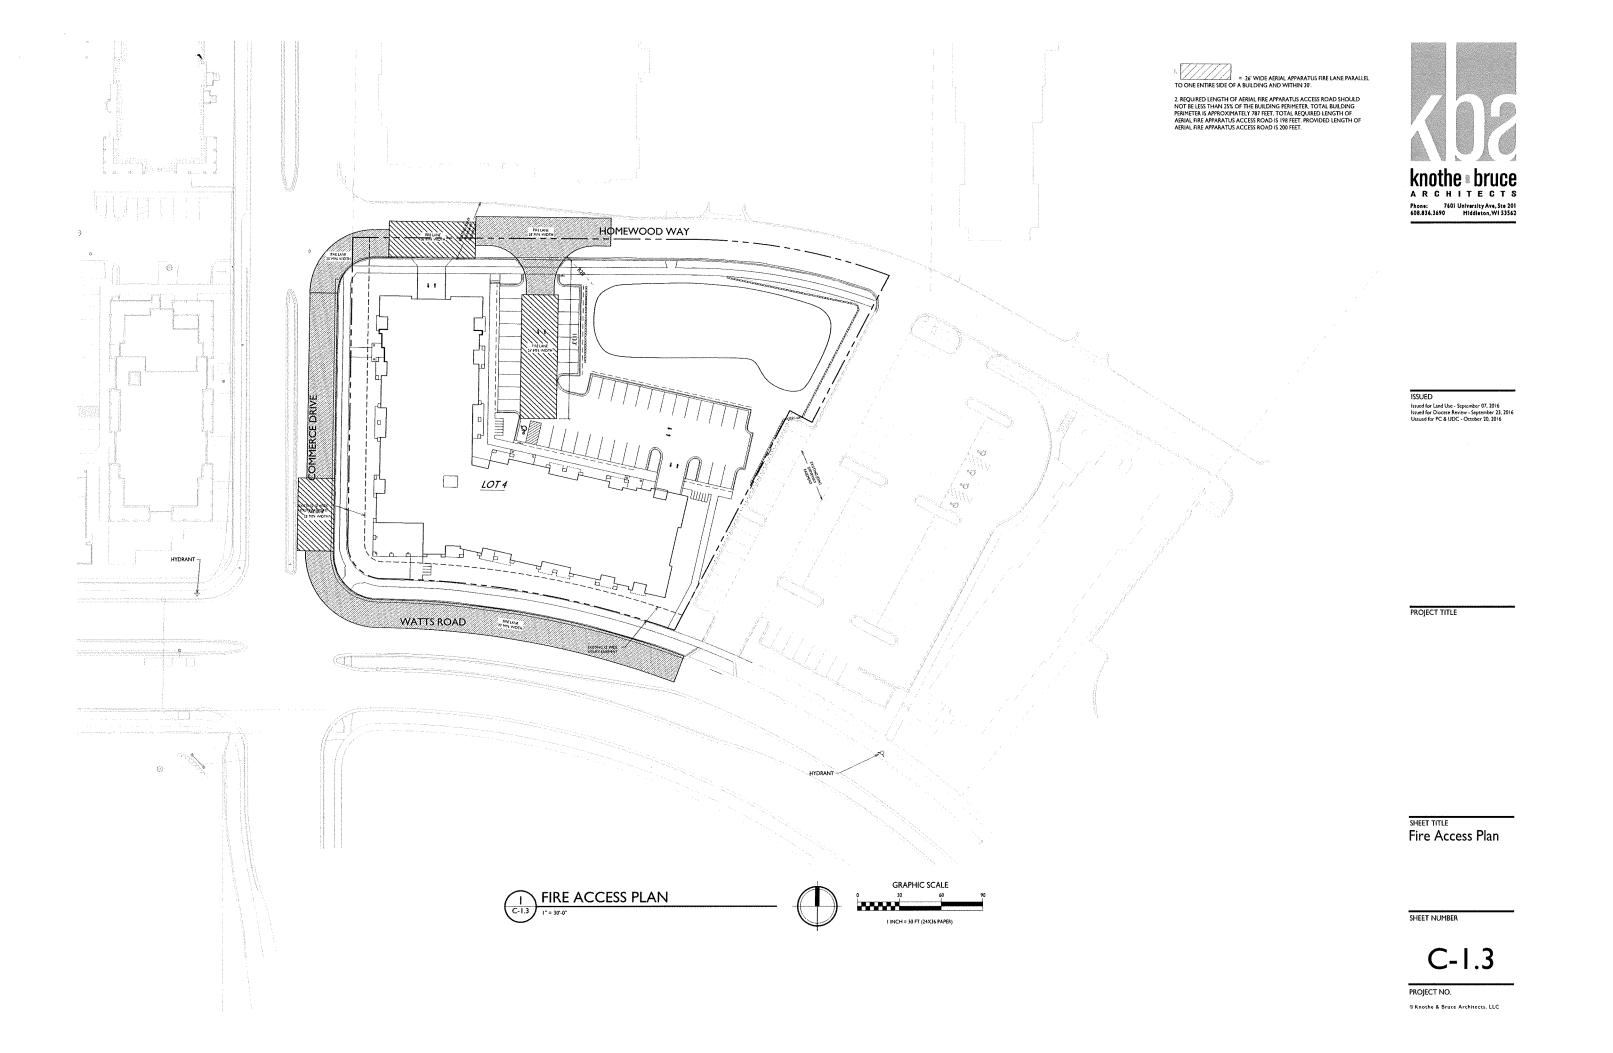

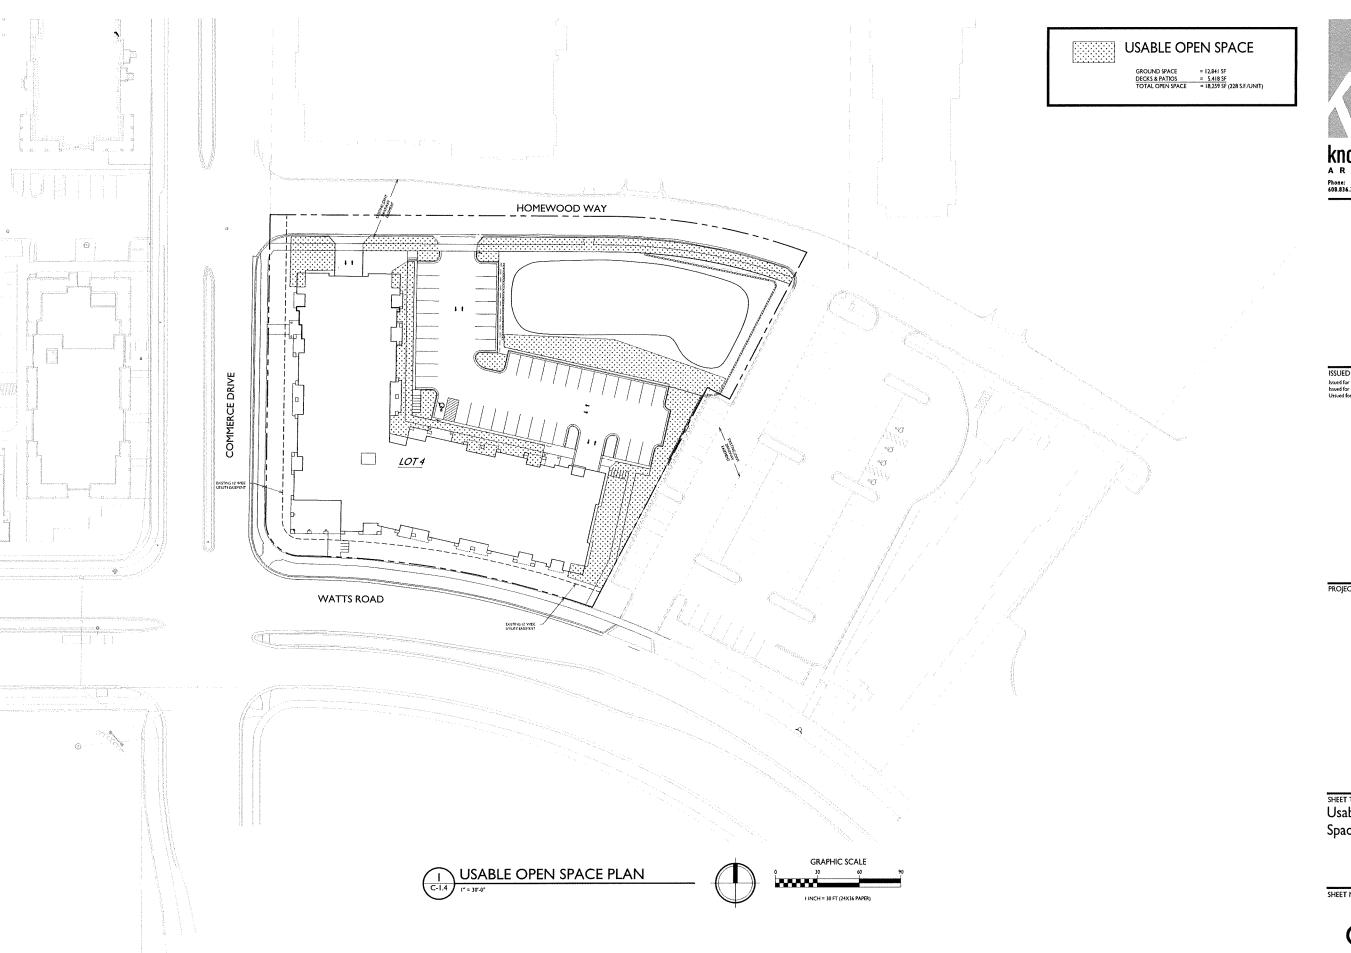




PROJECT TITLE


SHEET TITLE
Usable Open
Space Plan


SHEET NUMBER


C-1.4

PROJECT NO. ⊕ Knothe & Bruce Architects. LLC

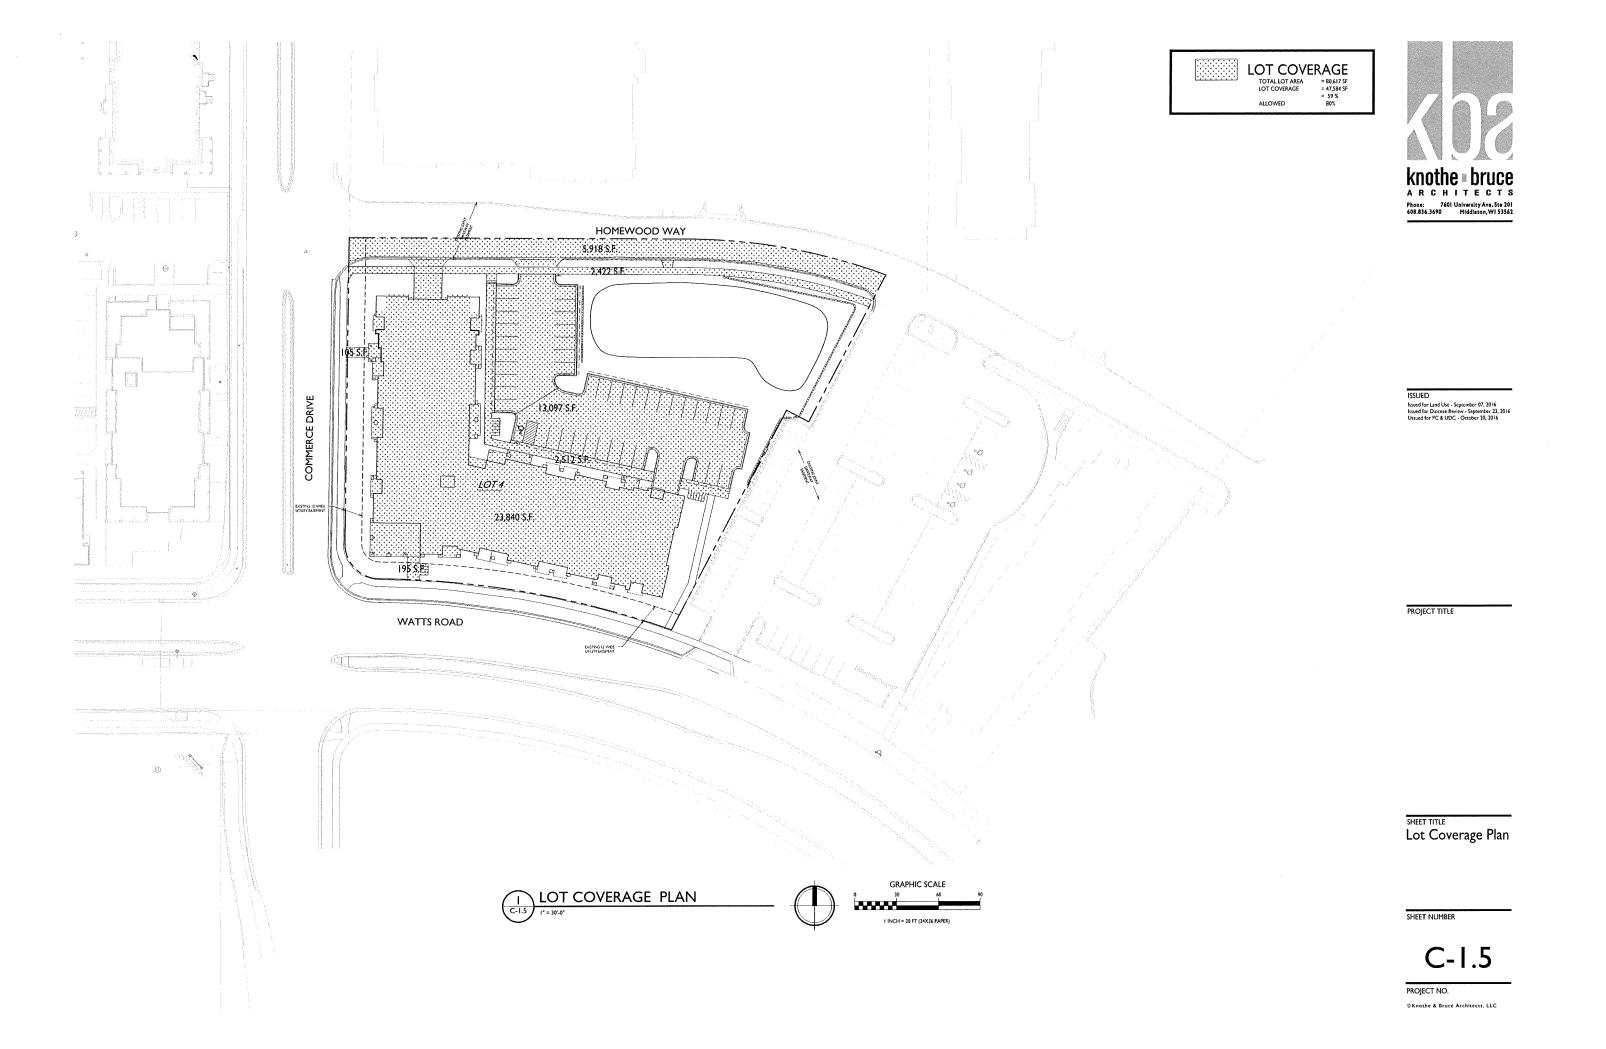

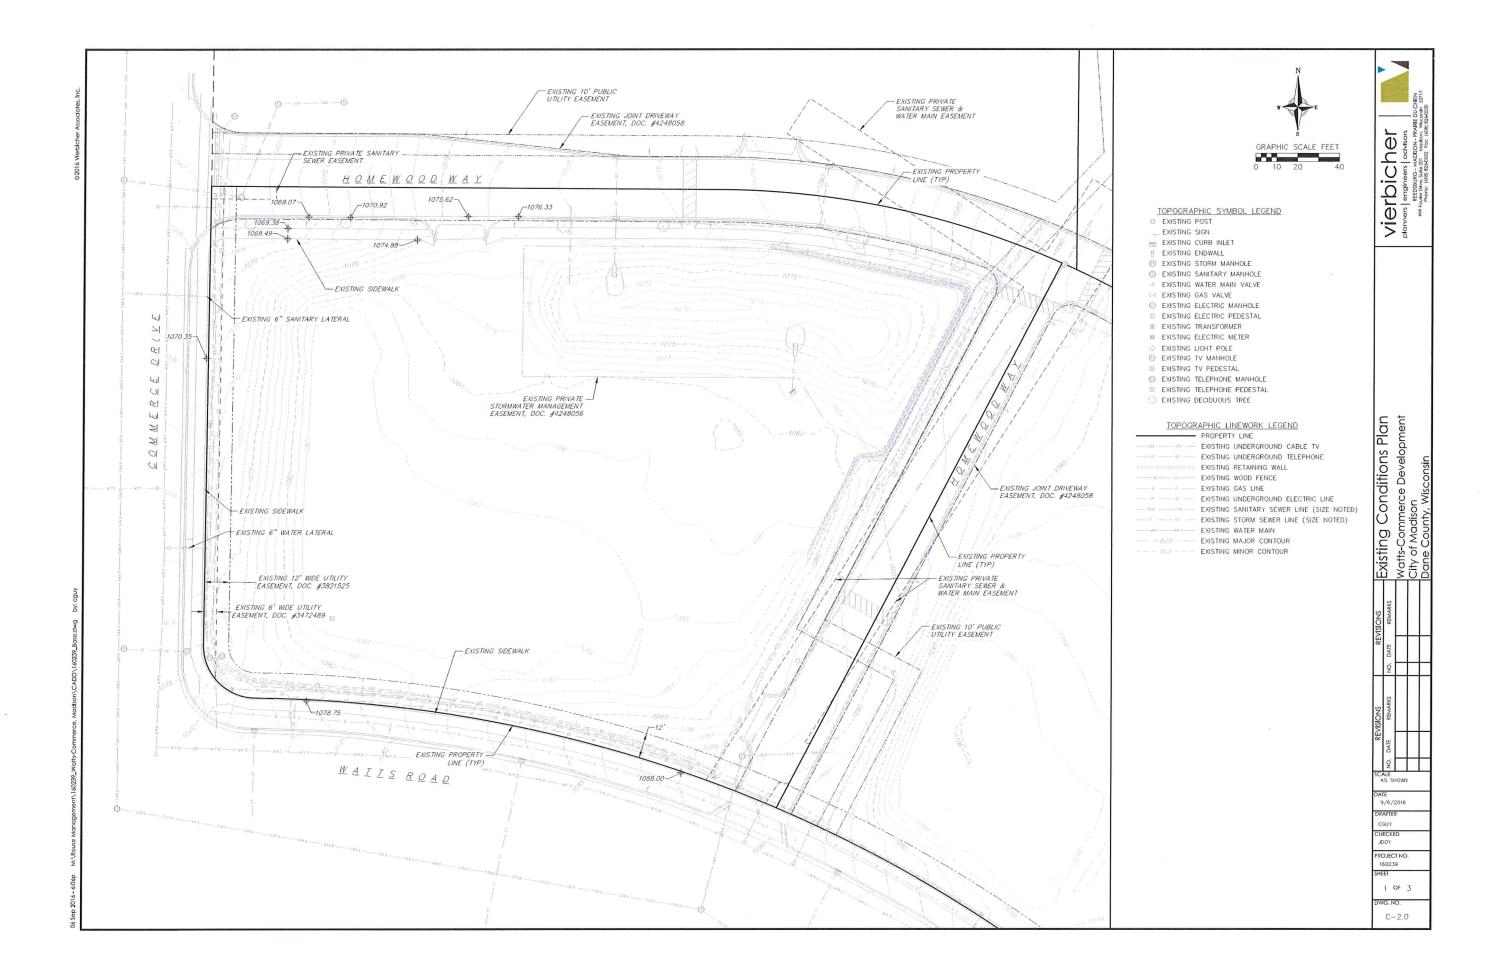

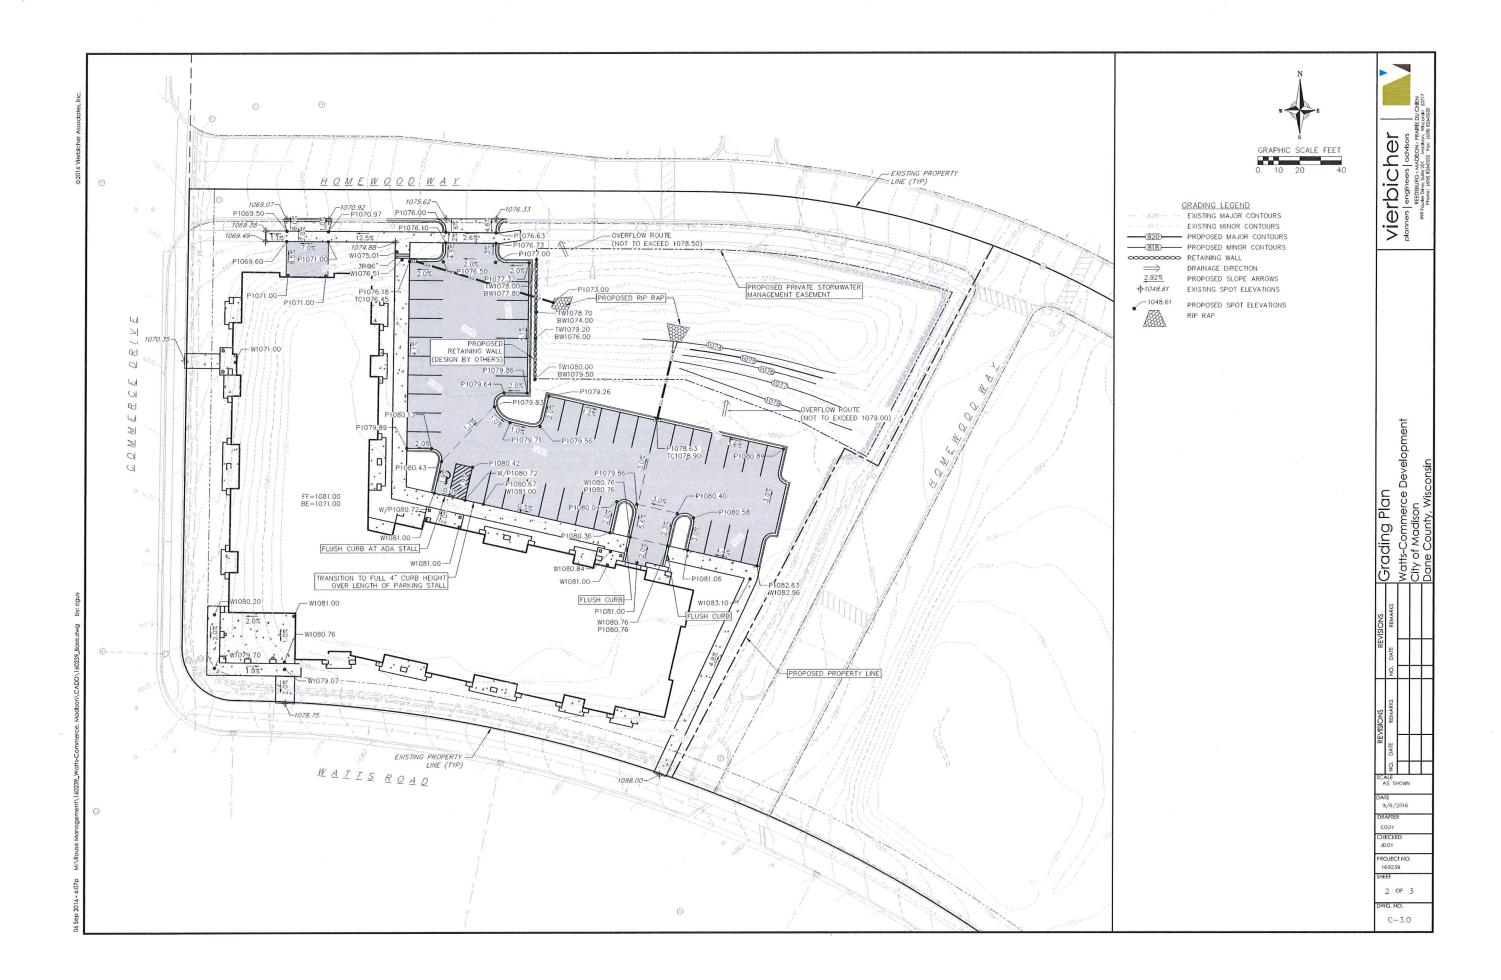

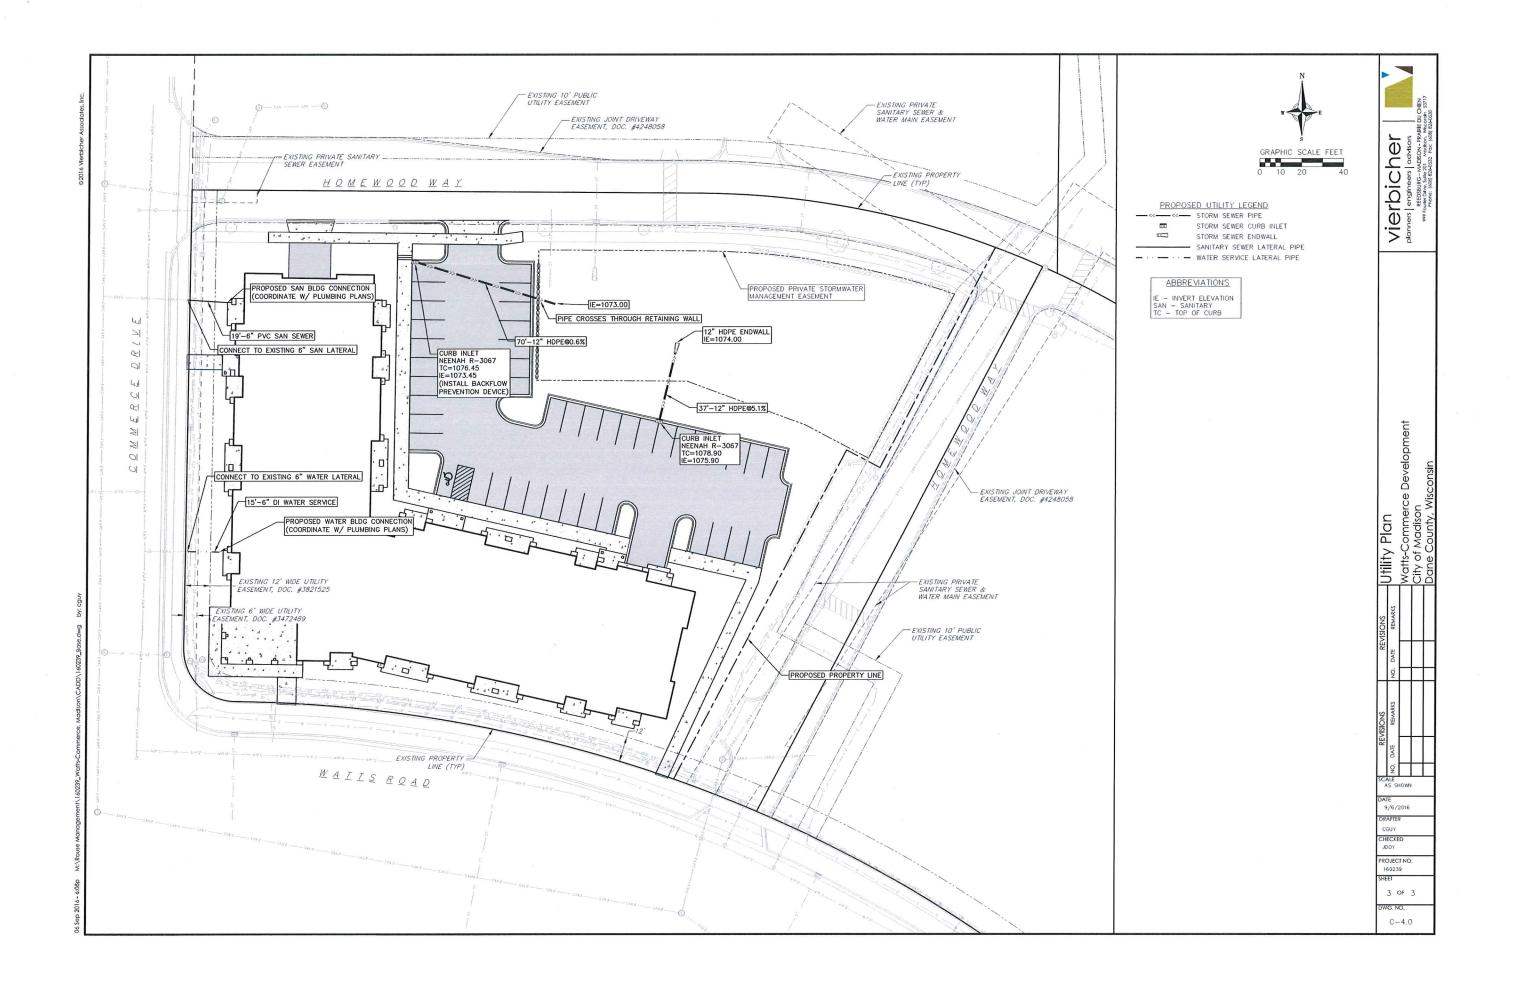

Plant Material List

Dunadlast	Deciduous
proaglear	Deciduous

Di Oadicai Dei	igaous			
Quantity	Code Name	Common Name	Scientific Name	Planting Size
4	ABM	Autumn Blaze Maple	Acer X Freemanii 'jeffersred'	2 1/2" B&B
3	ABS	Autumn Brill Serviceberry	Amelanchier X Grand 'autumn Brill'	6' B&B
2	СНВ	Common Hackberry	Celtis Occidentalis	2 [/2" B&B
I	PADWT	Pagoda Dogwood (tf)	Cornus Alternifolia (tf)	8' B&B
I	SKH	Street Keeper Honeylocust	Gleditsia Triacan 'draves'	2" B&B
2	PFC	Prairifire Crabapple	Malus 'prairifire'	2" B&B
4	SSC	Spring Snow Crabapple	Malus 'spring Snow'	2" B&B
2	TCS	Tina Crabapple (std)	Malus Sargentii 'tina' (std)	2" B&B
3	CCP	Chanticleer Callery Pear	Pyrus Calleryana 'chanticleer'	2 1/2" B&B
4	swo	Swamp White Oak	Quercus Bicolor	2 I/2" B&B
4	GSL	Greenspire Littleleaf Linden	Tilia Cordata 'greenspire'	2 1/2" B&B
I	NHE	New Horizon Elm	Ulmus 'new Horizon'	2 I/2" B&B
Conifer Everg	reen			
Quantity	Code Name	Common Name	Scientific Name	Planting Size
3	мві	Mountbatten Juniper	Juniperus Chinen 'mountbatten'	5' B&B
6	MAJ	Mini Arcadia Juniper	Juniperus Sabina 'mini Arcadia'	#3 CONT.
7	BHS	Black Hills Spruce	Picea Glauca Var Densata	5' B&B
5	TY	Taunton Yew	Taxus X Media 'tauntonii'	18" B&B
18	EA	Emerald Arborvitae	Thuja Occidentalis 'smaragd'	5' B&B
Perennial				
Quantity	Code Name	Common Name	Scientific Name	Planting Size
50	KFG	Karl Foerster's Feather Reed Grass	Calamagnostis Acutiflora 'karl Foerster'	#2 CONT.
37	SDD	Stella De Oro Daylily	Hemerocallis 'stella De Oro'	#I CONT.
23	PMG	Purple Maiden Grass	Miscanthus Sinensis Var Purpurescens	#I CONT.
14	GBES	Goldsturm Black-Eyed Susan	Rudbeckia Ful Var Sullivan 'goldsturm'	#I CONT.
Shrub				
Quantity	Code Name	Common Name	Scientific Name	Planting Size
19	GBC	Glossy Black Chokeberry	Aronia Melanocarpa Var Elata	#5 CONT.
20	DBH	Dwf Bush-Honeysuckle	Diervilla Lonicera	#5 CONT.
5	SWN	Summer Wine Ninebark	Physocarpus Opulifolius 'seward'	#5 CONT.
8	RRSR	Red Ribbons Sh Rose	Rosa 'kortemma'	#3 CONT.
13	DKOR	Double Knock Out Rose	Rosa 'radtko'	#3 CONT.
3	MKL	Miss Kim Lilac	Syringa Pubescens Subsp. Patula 'miss Kim'	#5 CONT.
15	LJAV	Little Joe Arwd Viburnum	Viburnum Dentatum 'Idmseventeen'	#5 CONT.
	•	•		

MADISON LANDSCAPE WORKSHEET

ZORING GISTRICE IS FOLD/SIF	
Total square footage of developed area	19,184 SF
Total square footage of first 5 acres of developed area + 300 square feet =	64 Landscape Unit
Total square footage of 0 additional acres of developed area + 100 square feet =0	Landscape Units
NUMBER OF LANDSCAPE POINT REQUIRED	

64 Landscape Units x 5 landscape points for first 5 as	res
O Landscpe Units x I landscape point for additional	acres0 points
TOTAL LANDSCAPE POINTS REQURED	

	Point N Value Qty.	EW	EXIS	TING		
PLANT TYPE or ELEMENT		Qty.	Points Achieved	Qty.	Points Achieved	
Overstory Deciduous Tree : 2-1/2" (dbh)	35	19	665			
Tall Evergreen Tree : 5-6 feet tall	35	7	245			
Ornamental Tree : I-1/2" Caliper (dbh)	15	12	180			
Upright Evergreen Shrub : 3-4 feet tall	10	21	210			
Shrub, deciduous : 3 gallon / 12"-24"	3	83	249			
Shrub, evergreen: 3 gallon / 12"-24"	4	Ш	44			
Ornamental grass/perennial : Igallon / 8"-18"	2	124	248			
Ornamental / Decorative fencing or wall	4 per 10 l.f.					
Existing significant specimen tree	l 4 per Cal. In.					TOTAL
Landscape furniture for public seating and /or transit connections	5 per 'seat'		and control control			POINTS PROVIDED
	Sub	Totals	[84]	+	NA	= 1841

	Street Frontage Landscape Required	
	Street Frontage = 812 LF	
i	Canopy Trees Required: per 30 LF Frontage =27	
	Shrubs Required : 5 per 30 LF Frontage =	
	Street Frontage Landscape Supplied	
l	Proposed Canopy Trees =32	
l	Proposed Shrubs =	

GENERAL NOTES

Ex. Street Tree

(I)TCS

(2)DKOR

(3)SDD -(2)DKOR (1)PMG -(I)TCS 1 1/2" Was

COMMERCE DRIVE

SOD

A) Areas labeled "Brown Colored Wood Mulch" to receive a mixture of recycled wood

B) Individual trees (and shrub groupings) found along perimeter of property as well as those found within lawn areas to receive wood mulch rings (and wood mulch beds) consisting of a mixture of recycled wood mulch, colored brown, spread to a minimum 3" depth (3' wide beds for shrub groupings).

C) "Vinyl Edging" to be Valley View Black Diamond Vinyl Edging or equivalent.

D) Areas labeled "washed stone" to receive 1-1/2" washed stone spread to a 3" depth over

(I)BHS -(3)SDD -

(2)EA (6)KFG -(3)DKOR

E) "Seed" areas shall be finish-graded and seeded at a rate of 4 lbs. per 1,000 sq. ft.

(I)SWN

(12)KFG

(I)ABM

WATTS ROAD

F) Seed shall consist of the following mixture: 10% Palmer IV Perennial Ryegrass 20% Dragon Kentucky Bluegrass

20% Diva Kentucky Bluegrass 20% Foxy II Creeping Red Fescue

15% Vail II Perennial Ryegrass 15% Ginney Kentucky Bluegrass

G) Areas labeled "Seed/Mat" shall be seeded with the above-noted premium lawn seed mixture and overlaid with DS75 straw erosion control netting that is then pegged into the soil with metal staples.

HOMEWOOD WAY

-- (5)LIAV

- Boulder Wall

MICHB

(I)CCP

(I)SKH

(1)SSC (5)DBH


LOT4


-1 1/2" Washed Stone/Vinyl Edging


- UTILITY EASMENT SEE CIVIL PLANS

H) Areas labeled "Sod" shall receive only No. I grade nursery-grown bluegrass sod.

i) Plant beds adjacent to building foundation to be mulched with 1-1/2" diameter washed stone mulch spread to a 3" depth over fabric weed barrier.

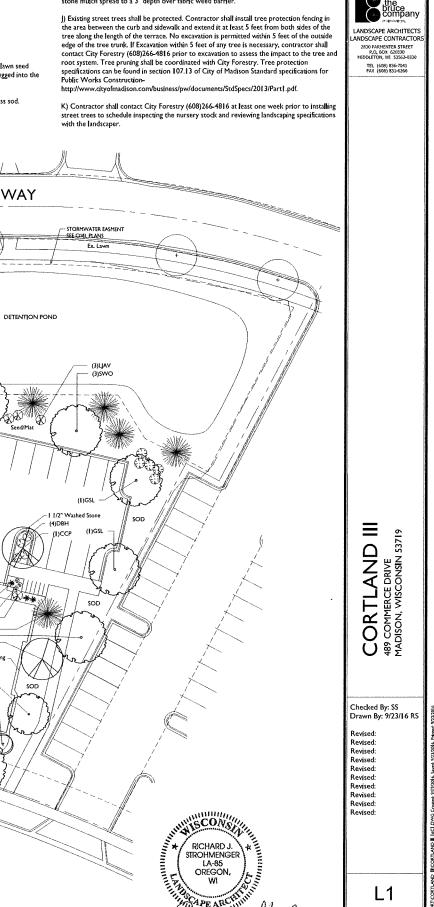

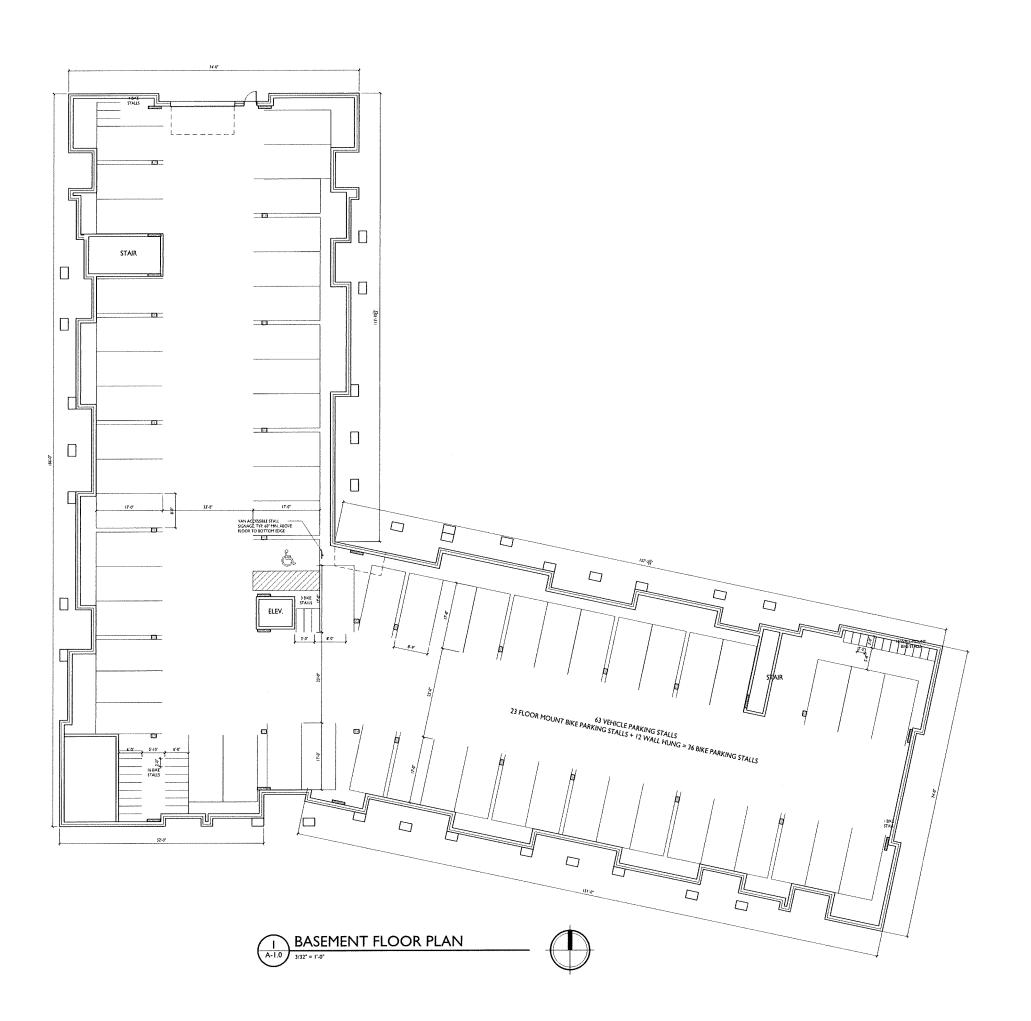

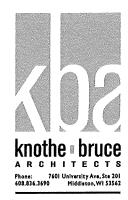

ISSUED Street for Land Use-September 07, 2016
Issued for Diocese Review - September 23, 2016
Issued for Plan Com & UDC - October 20, 2016

PROJECT TITLE
Watts Hill
Apartments


489 Commerce Dr. Madison, WI SHEET TITLE

Basement Floor Plan

SHEET NUMBER

A-1.0

PROJECT NO. 1217
9 Knothe & Bruce Architects, LLC

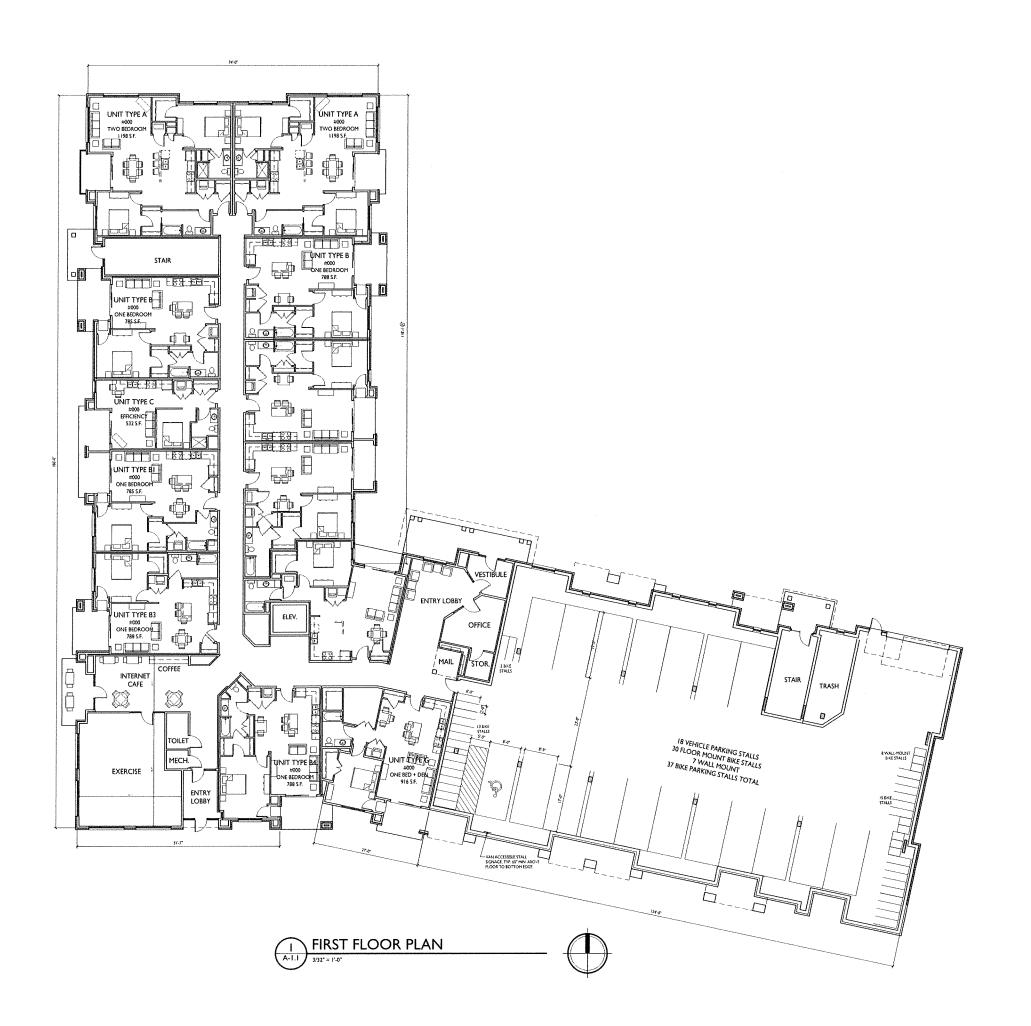



ssued for Land Use-September 07, 2016 ssued for Diocese Review - September 23, 2

PROJECT TITLE
Watts Hill
Apartments

489 Commerce Dr.

Madison, WI

SHEET TITLE


First Floor Plan

SHEET NUMBER

A-1.1

PROJECT NO. 1217

© Knothe & Bruce Architects, LLC

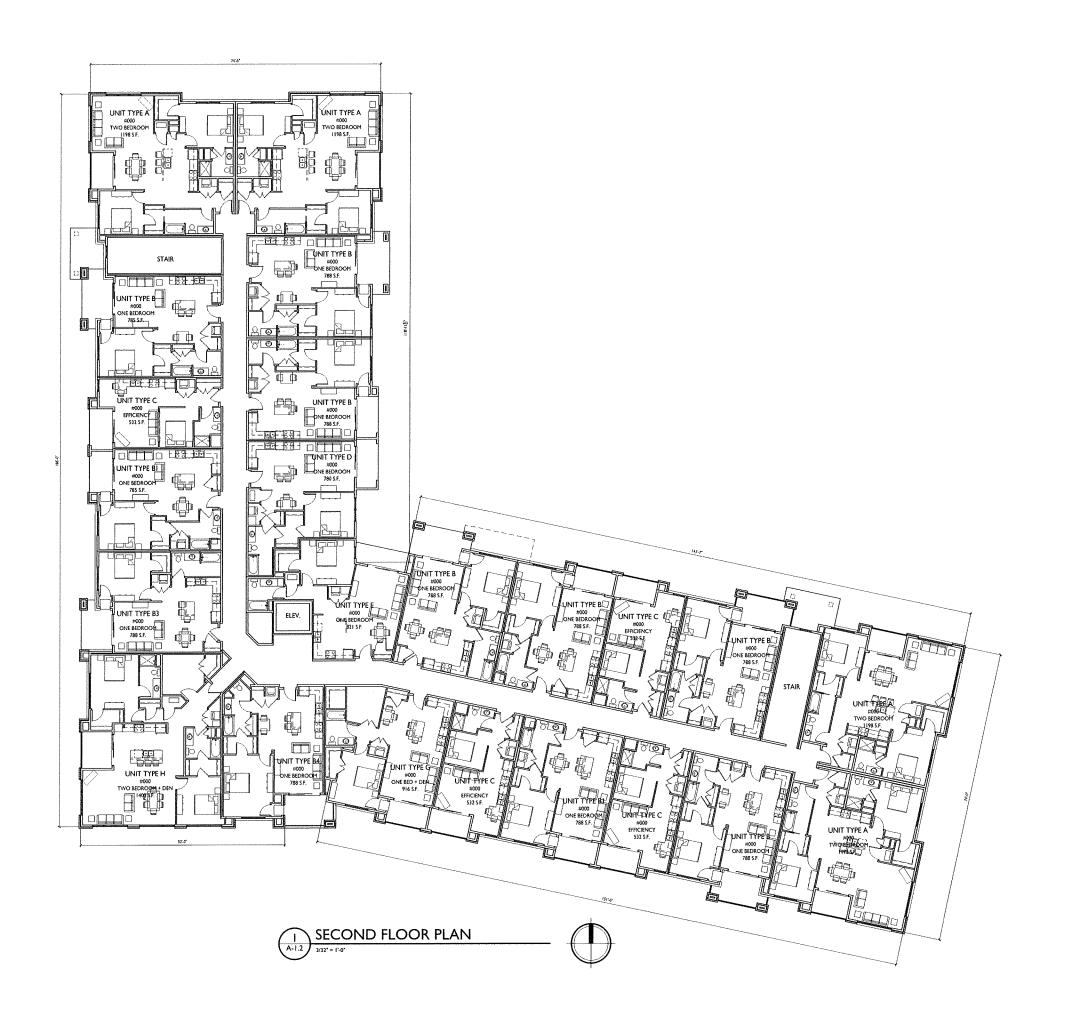



Issued for Land Use-Septembor 07, 2016 Issued for Diocese Review - September 23, 2016 Issued for Plan Com & UDC - October 20, 2016

PROJECT TITLE
Watts Hill
Apartments


489 Commerce Dr.

Madison, WI
SHEET TITLE
Second Floor Plan

SHEET NUMBER

A-1.2

PROJECT NO. 1217

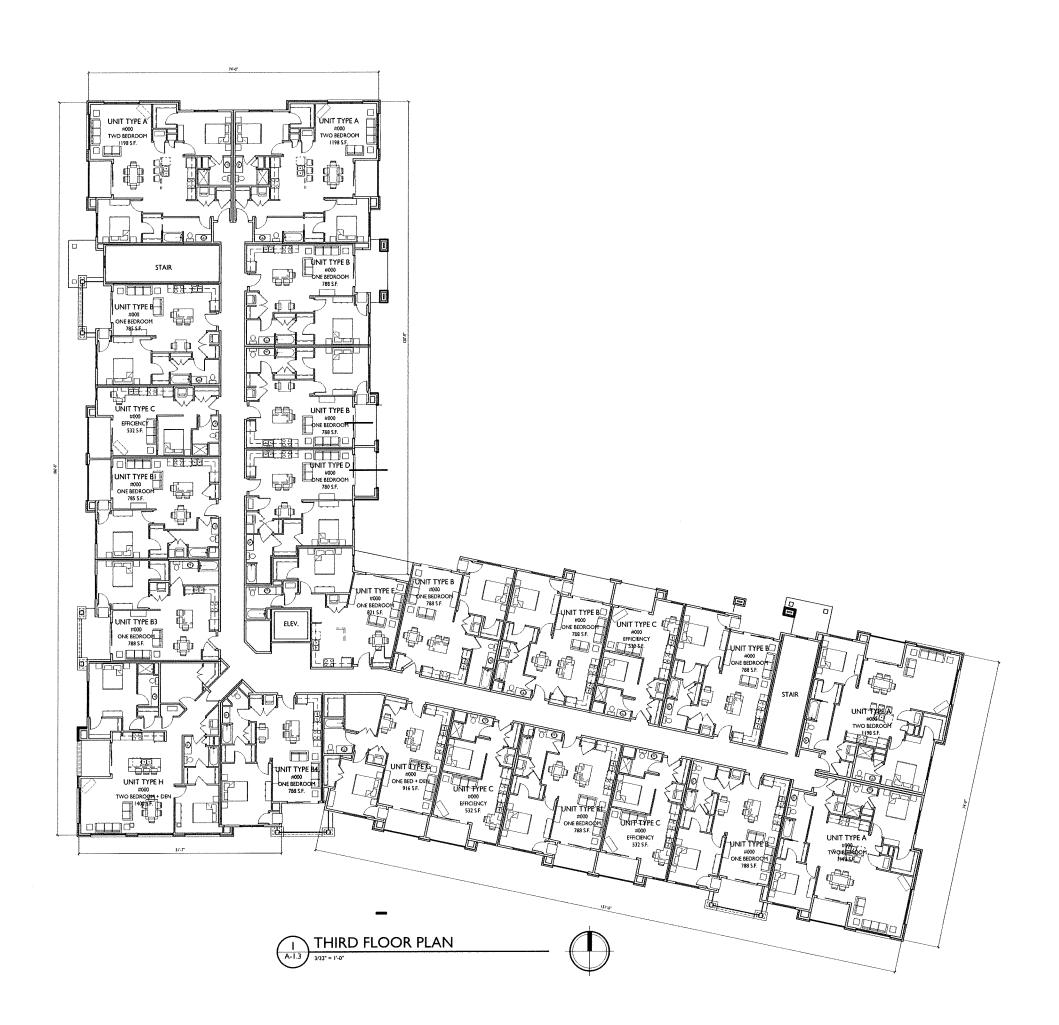



Issued for Land Use-September 07, 2016 Issued for Diocese Review - September 23, 2016 Issued for Plan Com & UDC - October 20, 2016


PROJECT TITLE
Watts Hill
Apartments

489 Commerce Dr.
Madison, WI
SHEET TITLE
Third Floor Plan

SHEET NUMBER

A-1.3

PROJECT NO. 1217

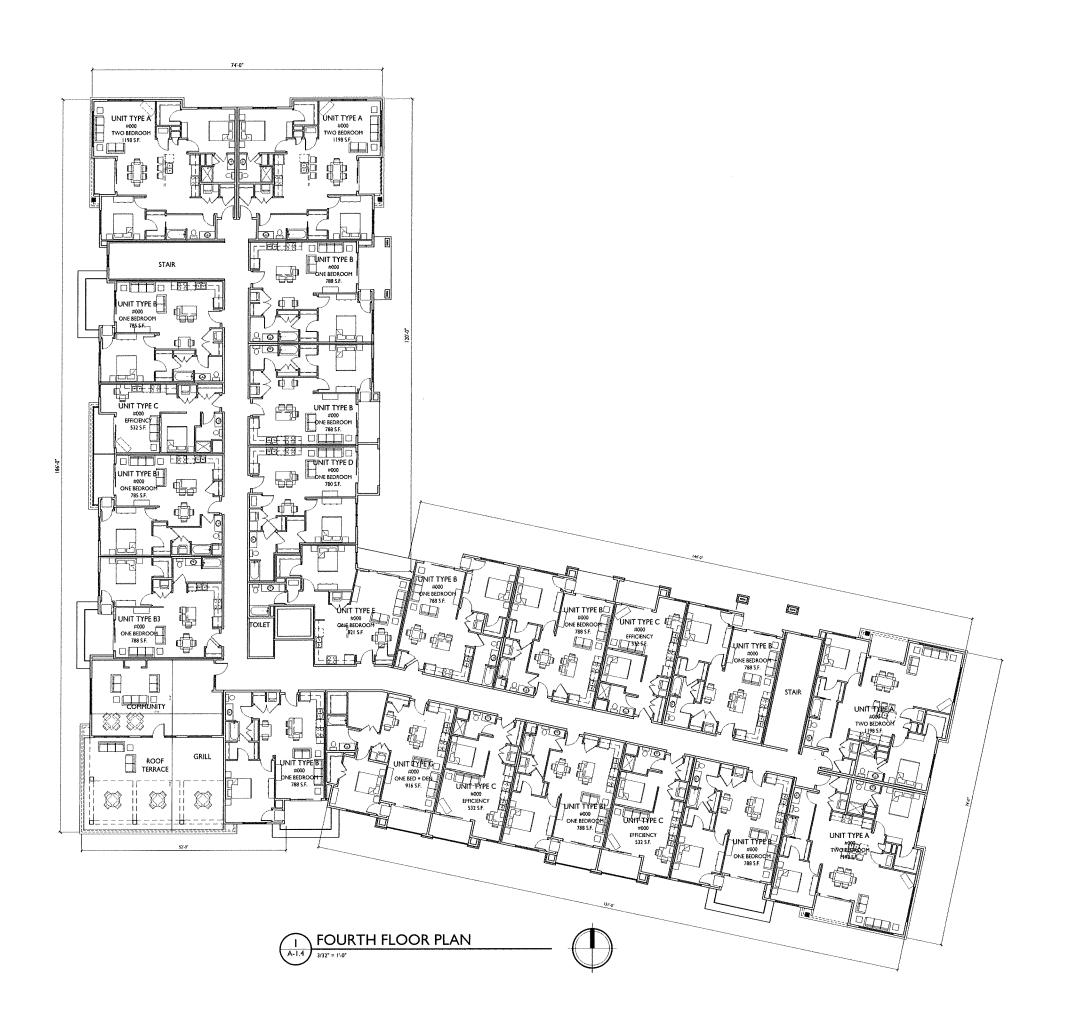



Issued for Land Use-September 07, 2016 Issued for Diocese Review - September 23, 2016 Issued for Plan Com & UDC - October 20, 2016

PROJECT TITLE
Watts Hill
Apartments

489 Commerce Dr.

Madison, WI

SHEET TITLE

Fourth Floor Plan

SHEET NUMBER

A-1.4

PROJECT NO. 1217

S Knothe & Bruce Architects, LLC





SOUTH ELEVATION ALONG WATTS ROAD

PROJECT TITLE
Watts Hill
Apartments

ISSUED

489 Commerce Dr. Madison, WI

Elevations

SHEET TITLE

Color

Black

Rich Expresso

Rich Expresso

Rich Expresso

Brindle- Smooth

Heritage Brown

Burnished Slate

Brindle-Split Face

Stained Dark Mahogany

Downing Earth SW2820

Manufacturer

Hardie

Hardie

Hardie

Hardie

TBD

Visions

Rockcast

CMG

Rockcast

TBD

Material

Composite Fascia

Composite Vert. Siding

Precast Band and Sills

Aluminum Railing

Cast Stone

Composite Horiz.Upper Siding

Composite Horiz. Lower Siding

Vinyl or Composite Windows

Metal Roof/Canopy/Panels

Heavy Timber

SHEET NUMBER

A-2.1

PROJECT NO. 1217



WEST ELEVATION ALONG COMMERCE DRIVE

A-2.1 3/32"=1/20"





Issued for Land Use - September 07, 2016 Issued for Land Use Supplement - Sept. 12, 2016 Issued for Diocese Review - September 23, 2016 Issued for PC & UDC - October 20, 2016

 $\begin{pmatrix} 1 \\ A-2.2 \end{pmatrix}$

PROJECT TITLE
Watts Hill
Apartments

489 Commerce Dr. Madison, WI

Elevations

Color

Rich Expresso

Brindle-Split Face

Stained Dark Mahogany

Manufacturer

Hardie

Rockcast

TBD

SHEET NUMBER

A-2.2

PROJECT NO. 1217

EAST ELEVATION

Composite Horiz.Upper Siding Hardie Downing Earth SW2820 Rich Expresso Composite Vert. Siding Hardie Rich Expresso Composite Horiz. Lower Siding Hardie Brindle- Smooth Precast Band and Sills Rockcast Aluminum Railing TBD Black Vinyl or Composite Windows Heritage Brown Visions Metal Roof/Canopy/Panels CMG Burnished Slate

Material

Composite Fascia

Heavy Timber

Cast Stone



West Elevation along Commerce Drive



South Elevation along Watts Road

