

### URBAN DESIGN COMMISSION APPLICATION CITY OF MADISON

This form may also be completed online at: <a href="http://www.cityofmadison.com/planning/documents/UDCapplication.pdf">http://www.cityofmadison.com/planning/documents/UDCapplication.pdf</a>

215 Martin Luther King Jr. Blvd; Room LL-100 PO Box 2985; Madison, Wisconsin 53701-2985 Phone: 608.266.4635 | Facsimile: 608.267.8739

Please complete all sections of the application, including the desired meeting date and the type of action requested.

Date Submitted: April 27, 2016	☐ Informational Presentation
UDC Meeting Date: May 11, 2016	☐ Initial Approval
Combined Schedule Plan Commission Date (if applicable):	Final Approval
1. Project Address: 5401 Tancho Drive Project Title (if any): 22 Slate Apartments  2. This is an application for (check all that apply to this UDC application  New Development A. Project Type: SIP for a previously appro □ Project in an Urban Design District* (public hearing-\$300 fee □ Project in the Downtown Core District (DC) or Urban N	reviously-Approved Development  Dived GDP  Wixed-Use District (UMX) (\$150 fee, Minor Exterior Alterations)  Intional District (CI) or Employment Campus District (EC)
B. Signage:  Comprehensive Design Review* (public hearing-\$300 fee) Signage Exception(s) in an Urban Design District (public C. Other:  Please specify:	Street Graphics Variance* (public hearing-\$300 fee) hearing-\$300 fee)
3. Applicant, Agent & Property Owner Information:	
Applicant Name: Joseph Lee	Company: JLA Architects + Planners
Street Address: 2418 Crossroads Drive - 2300 Telephone: (608) 241-9500	City/State: Madison, Wisconsin Zip: 53718
Fax:()	Email: jlee@jla-ap.com
Project Contact Person: Joseph Lee	Company: JLA Architects + Planners
Street Address: 2418 Crossroads Drive - 2300	City/State: Madison, Wisconsin Zip: 53718
Telephone:(608) 241-9500 Fax:()	Email: jlee@jla-ap.com
Project Owner (if not applicant): Fiduciary Real Estate Developm Street Address: 789 N: Water Street - Suite 200 Telephone:(414) 226-4535 Fax:(	
4. Applicant Declarations:	
A. Prior to submitting this application, the applicant is required to discuss the	Various Times  (date of meeting)  ttal and understands that if any required information is not provided by gn Commission agenda for consideration.
Name of Applicant Joseph Lee	Relationship to Property Project Designer
Authorized Signature	Date April 27, 2016

# 22-SLATE APARTMENTS

5401 Tancho Drive Madison, Wisconsin







# MADISON URBAN DESIGN SUBMITTAL

BUILDINGS A1, A2, A3, B1, B2, B3, B4, AND CLUBHOUSE



JLA PROJECT NUMBER: 15-0617-01

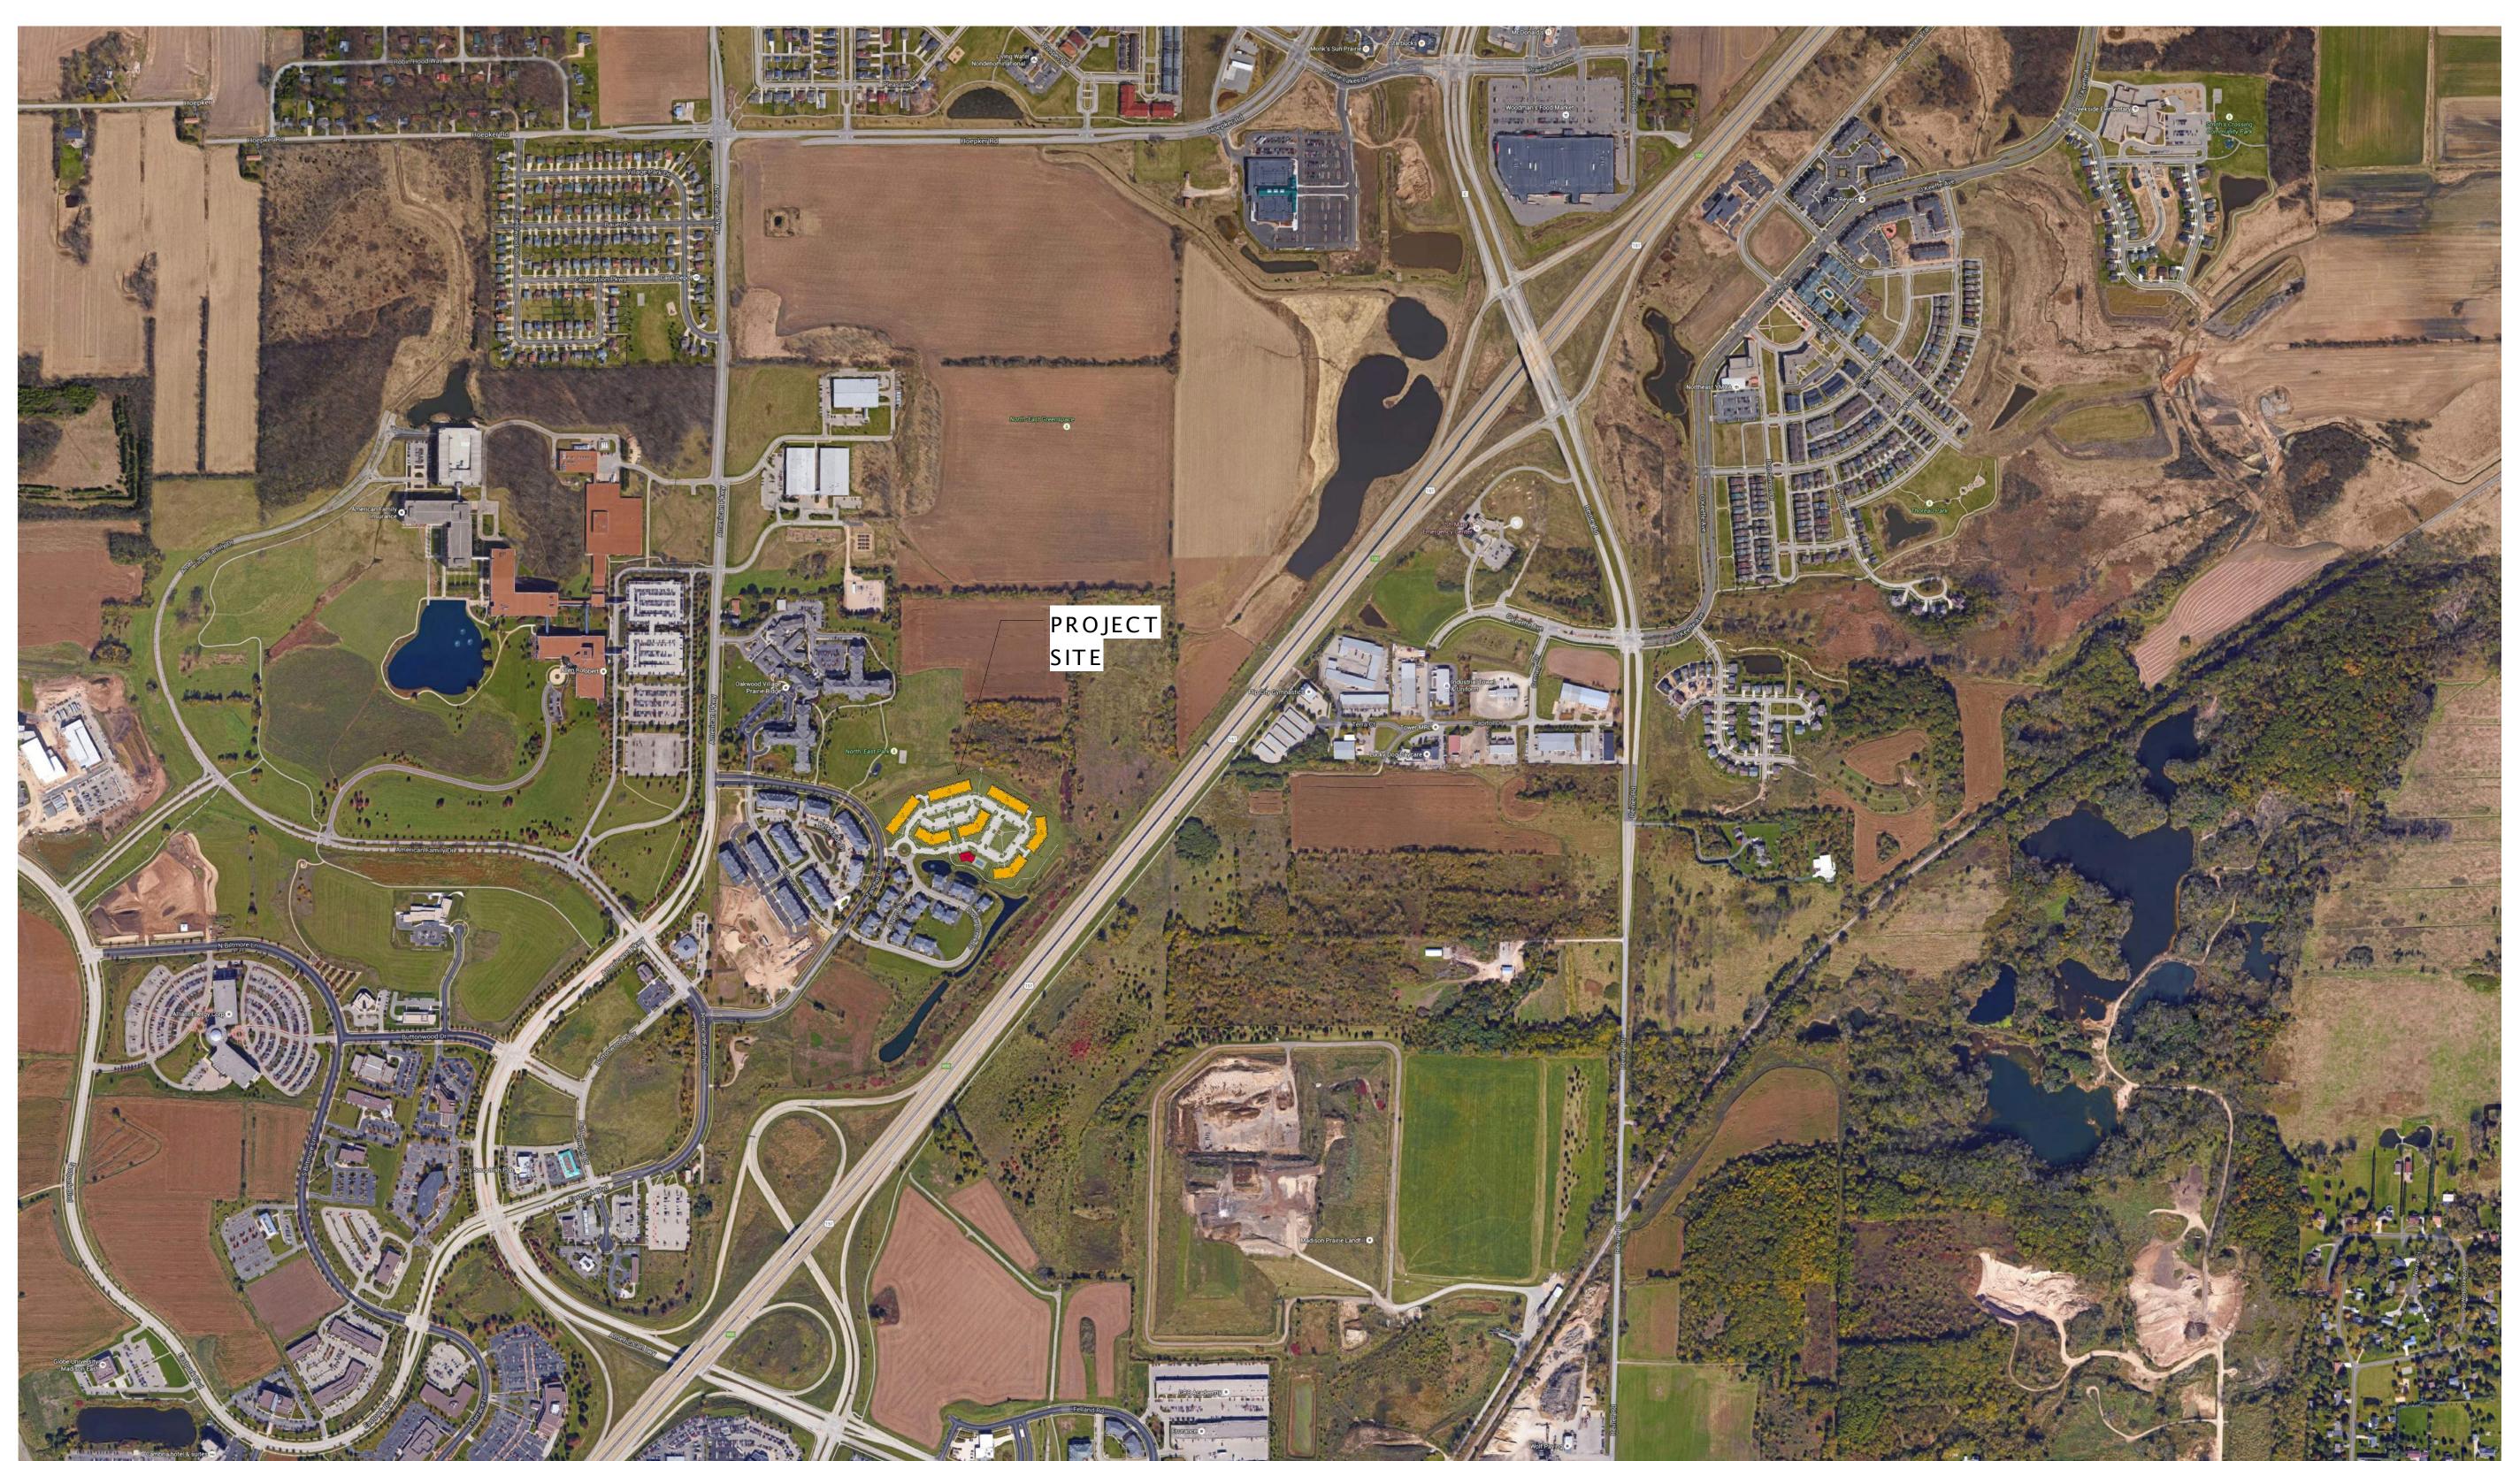

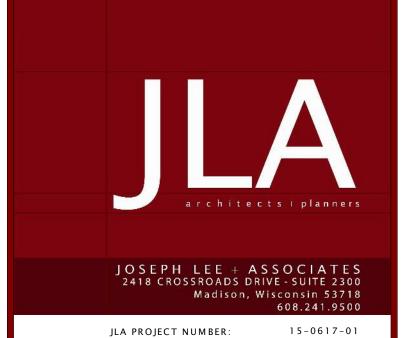

Fiduciary
REAL ESTATE DEVELOPMENT INC.

**UDC** Submittal

22-SLATE APARTMENTS

## PROGRESS DOCUMENTS


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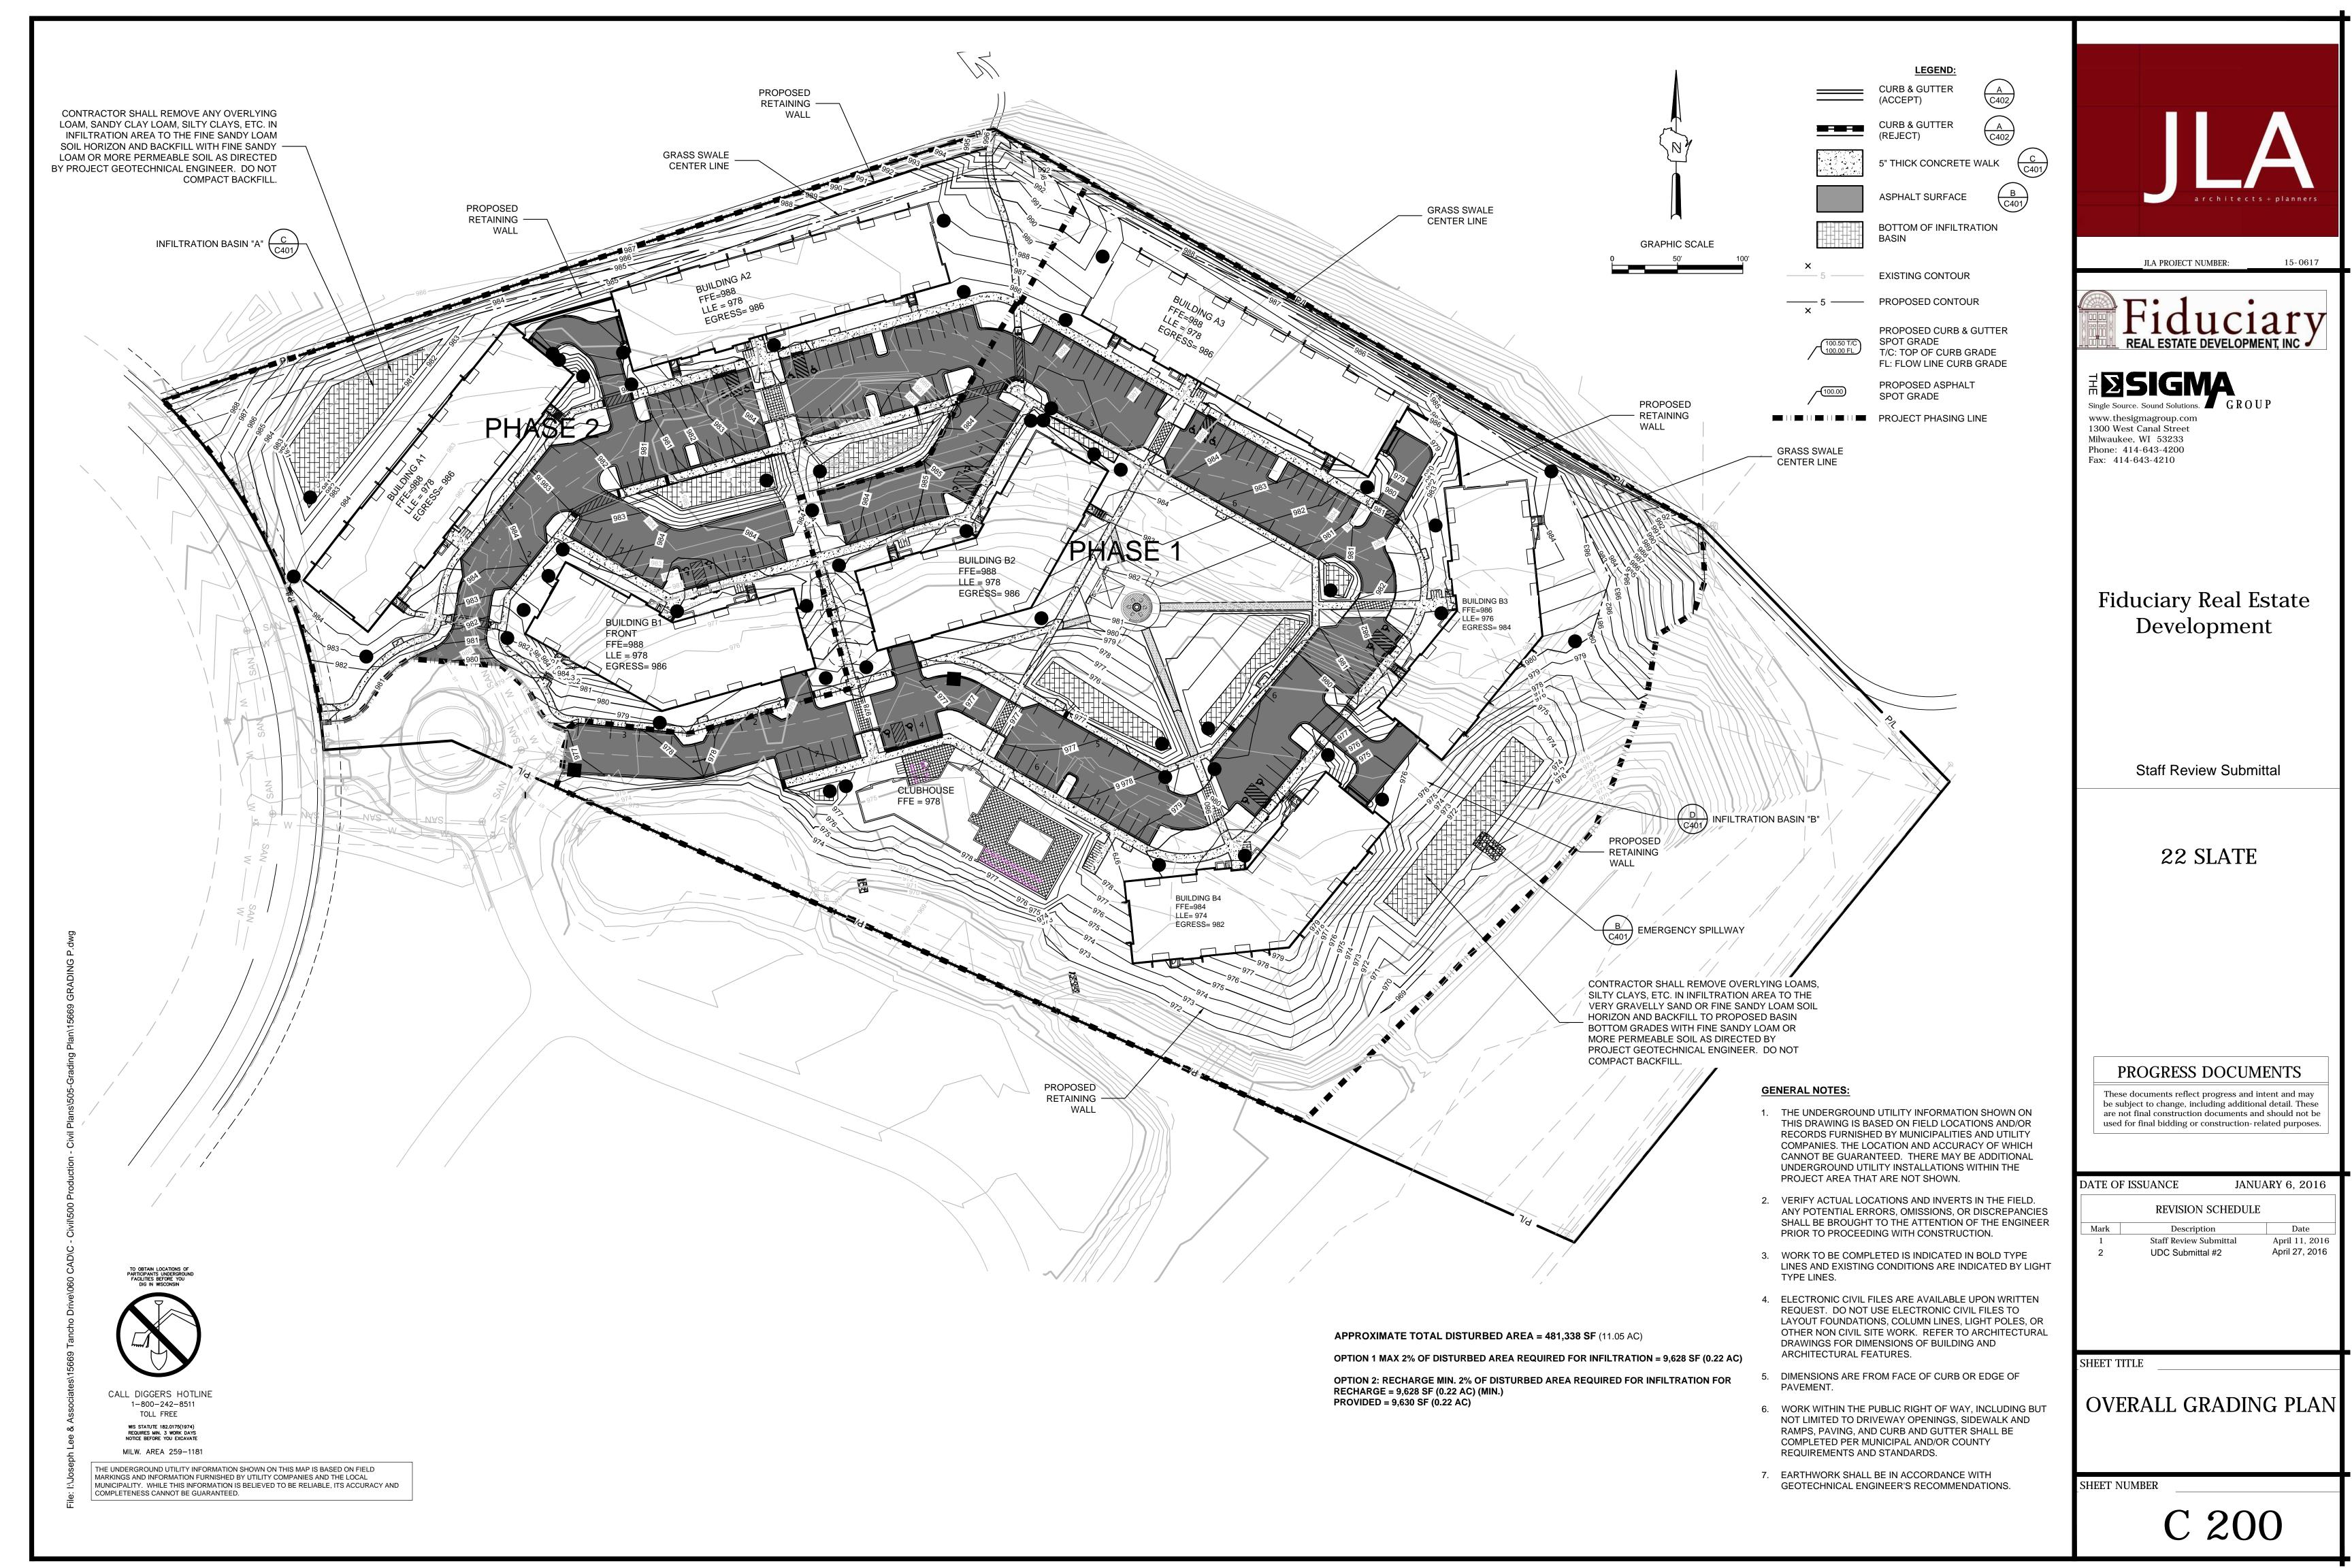
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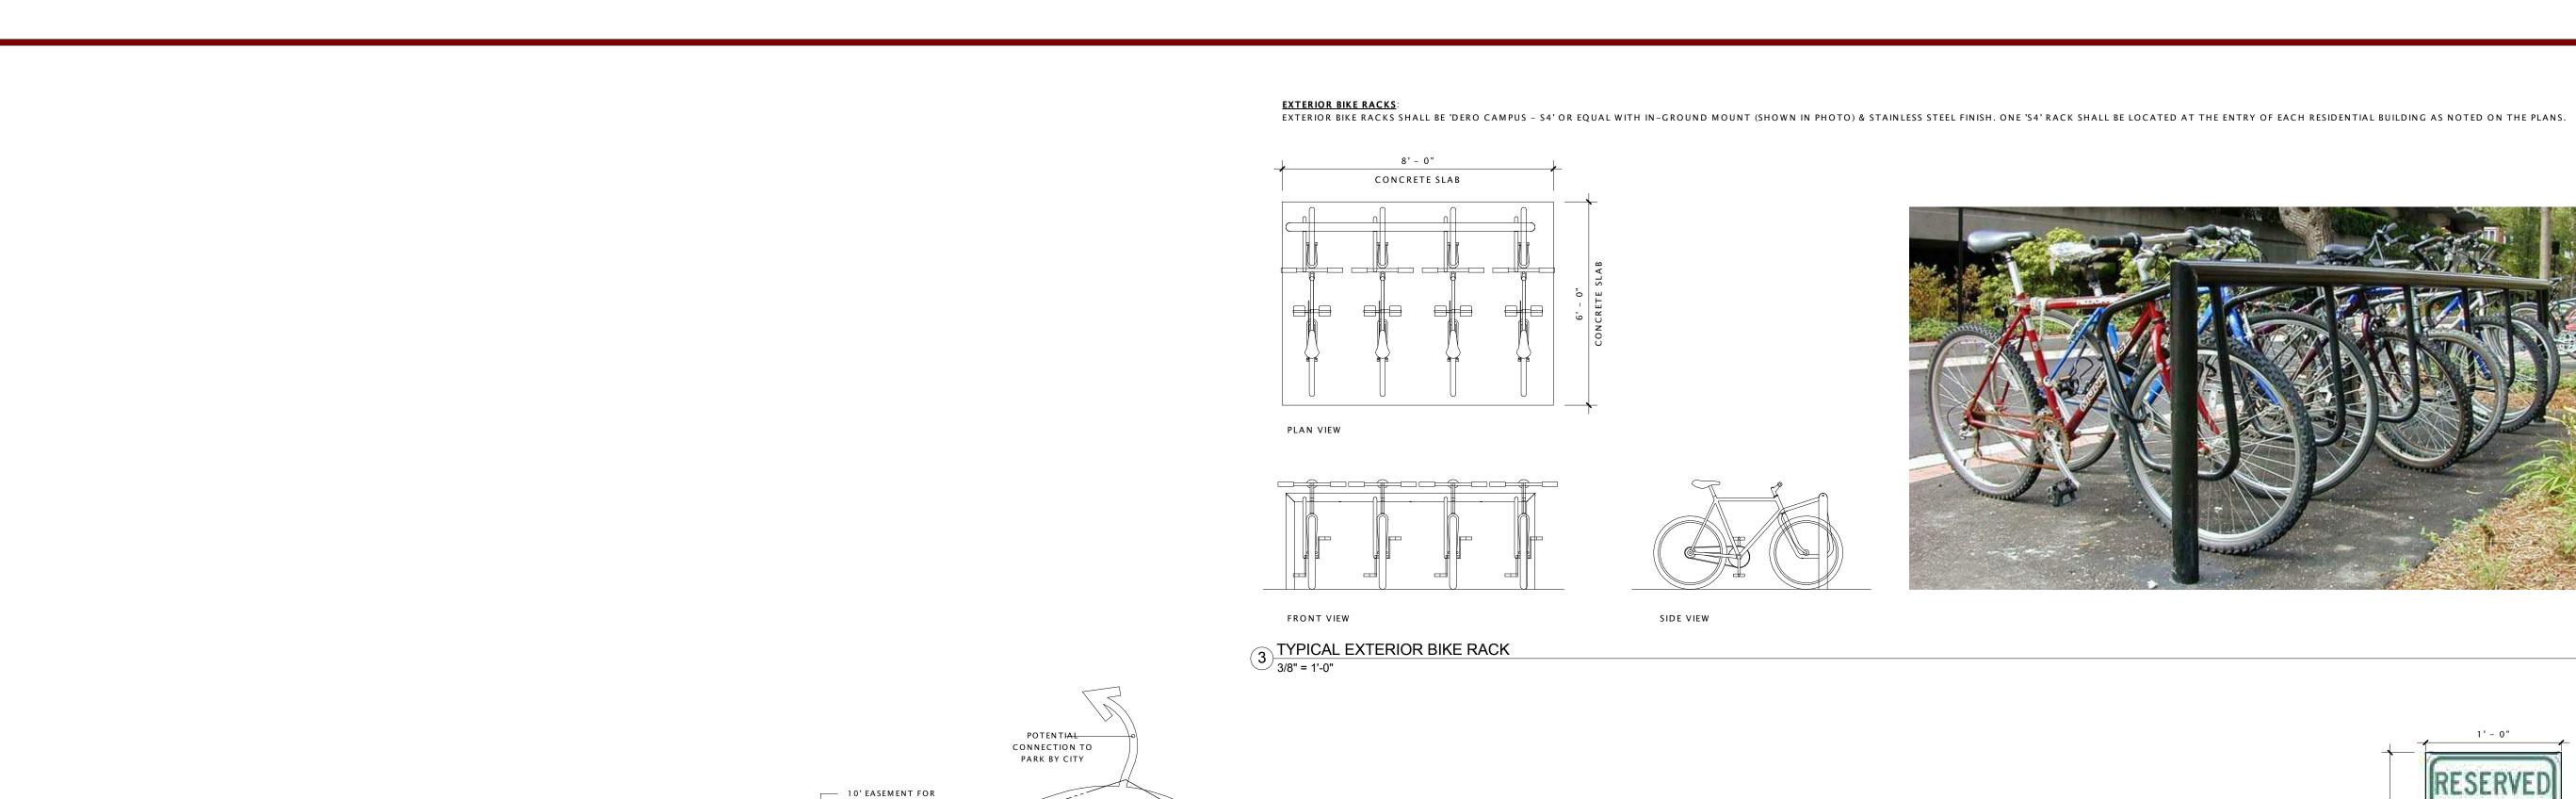
Locator Map

SHEET NUMBER

G 0 0 1 - U D C





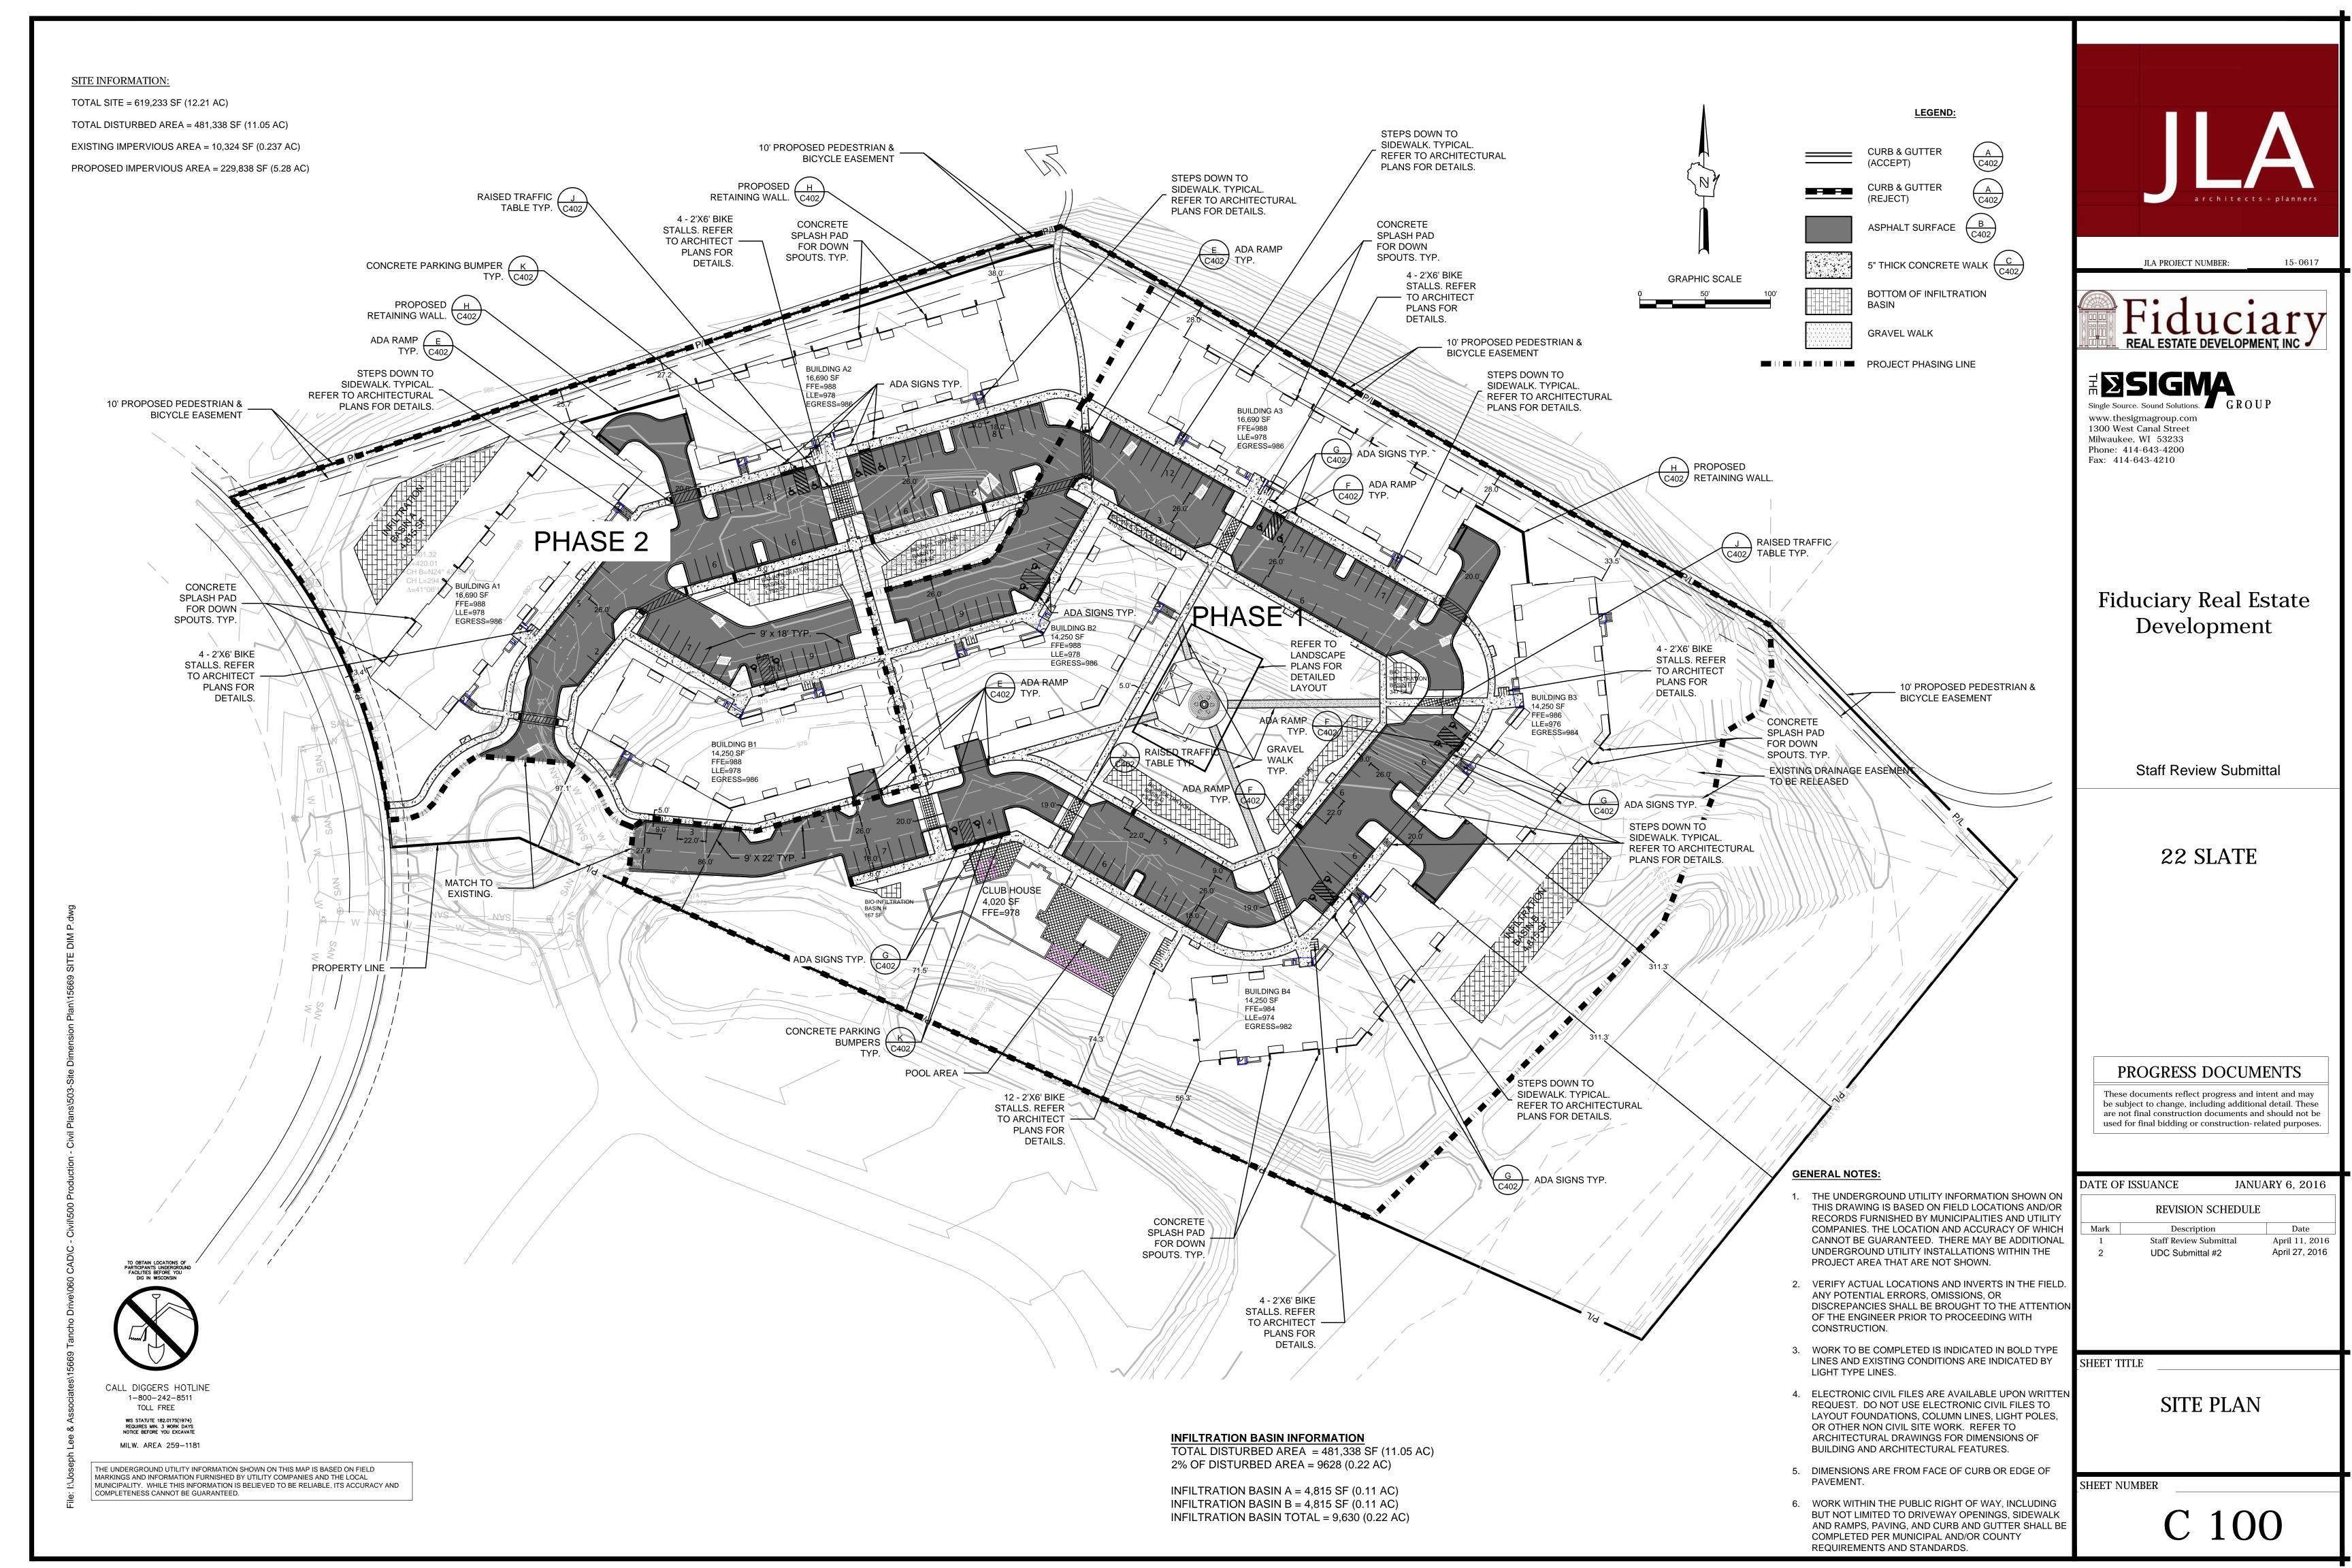

PHASE LINE

25' BUILDING SETBACK ALONG NORTH PROPERTY LINE

EXISTING STORM
WATER MANAGEMENT

CITY CONSTRUCTED

50' BUILDING SETBACK — ALONG SOUTH PROPERTY LINE

25' BUILDING SETBACK ALONG NORTH PROPERTY LINE

SLATE DRIVE

EXISTING STORM WATER MANAGEMENT

12' BUILDING SETBACK ALONG TANCHO DRIVE

16 ARCHITECTURAL SITE PLAN - OVERALL
1" = 60'-0"



— 10'EASEMENT FOR
CITY CONSTRUCTED
BIKE PATH

CONNECTION TO— EXISTING BIKE PATH BY CITY

ADA PARKING SIGNAGE
1 1/2" = 1'-0"



15-0617-01 JLA PROJECT NUMBER:



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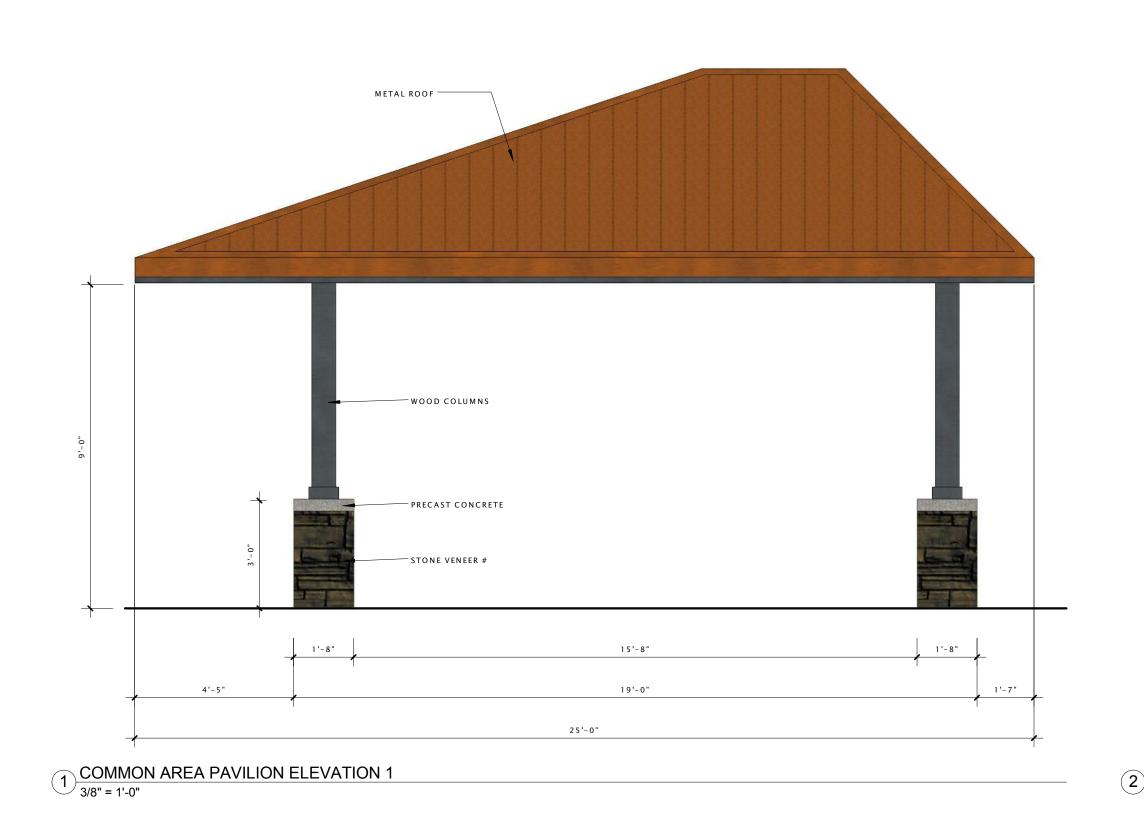
REVISION SCHEDULE
Mark Description Date


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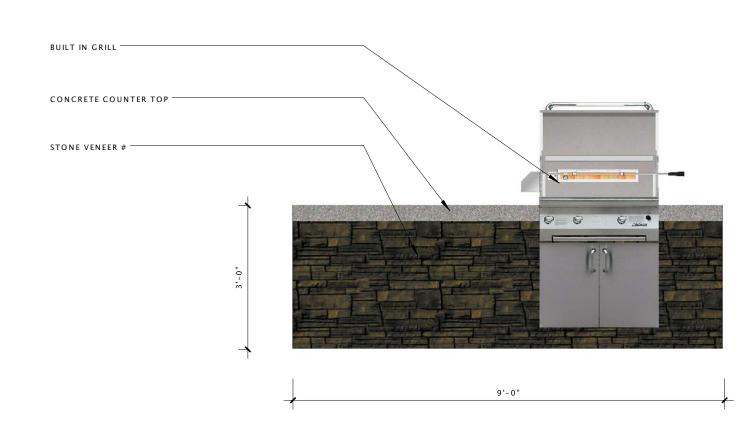
ARCHITECTURAL SITE PLAN - OVERALL

SHEET NUMBER


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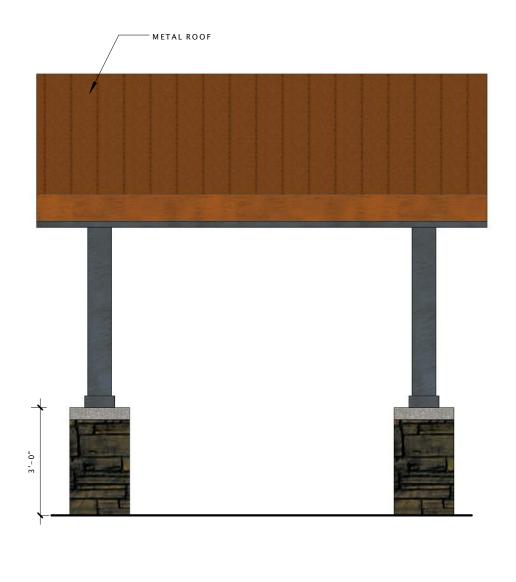





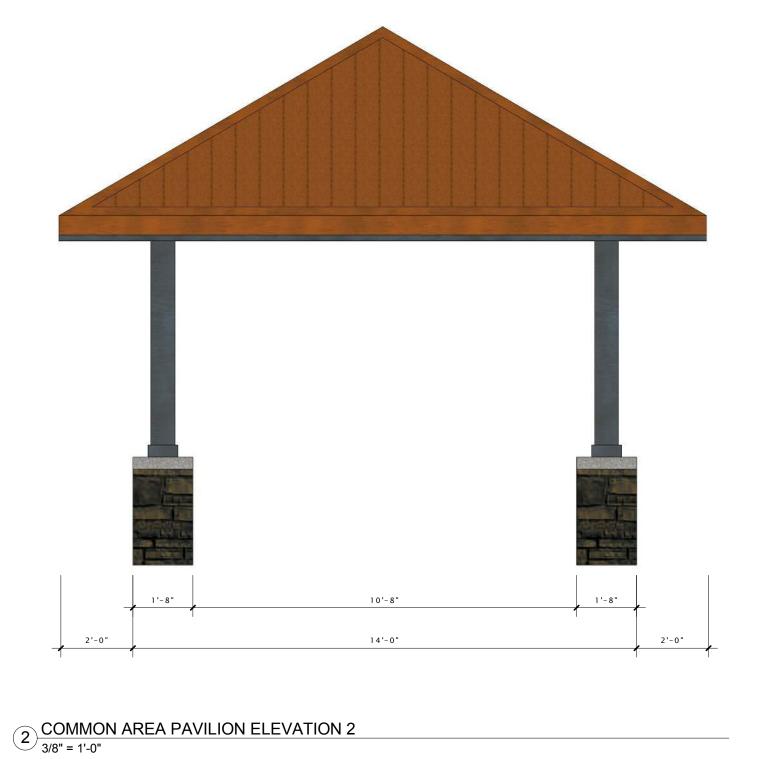

3 GRILL ISLAND ELEVATION
1/2" = 1'-0"



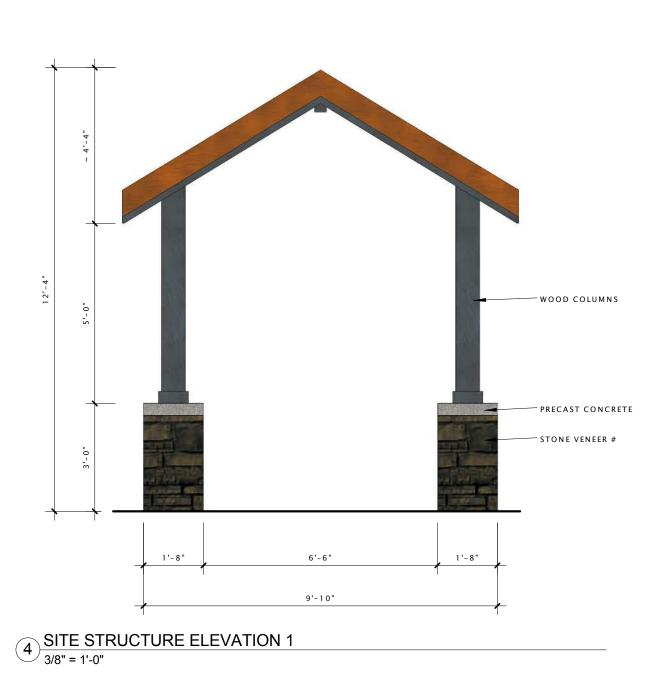

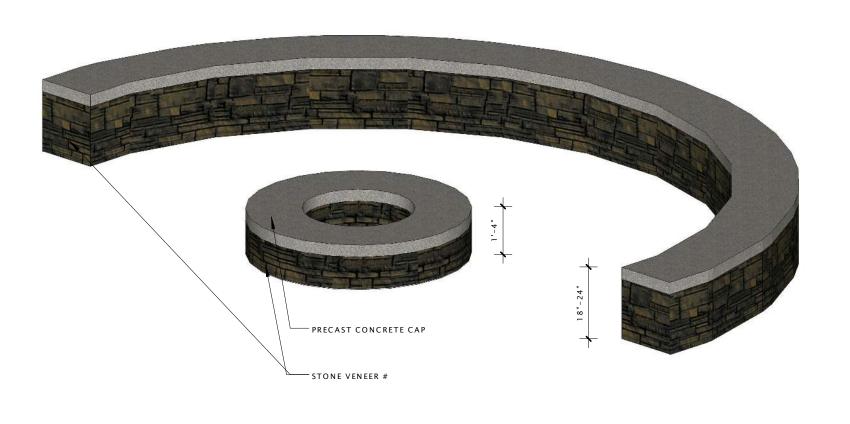

5 SITE STRUCTURE ELEVATION 2
3/8" = 1'-0"

6 SEAT WALL & FIRE PIT

3/8" = 1'-0"

JOSEPH LEE + ASSOCIATES
2418 CROSSROADS DRIVE - SUITE 2300
Madison, Wisconsin 53718
608.241.9500

JLA PROJECT NUMBER: 15-0617-01

Fiduciary Real Estate Development

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22-SLATE APARTMENTS

DATE OF ISSUANCE APRIL 27, 2016

REVISION SCHEDULE

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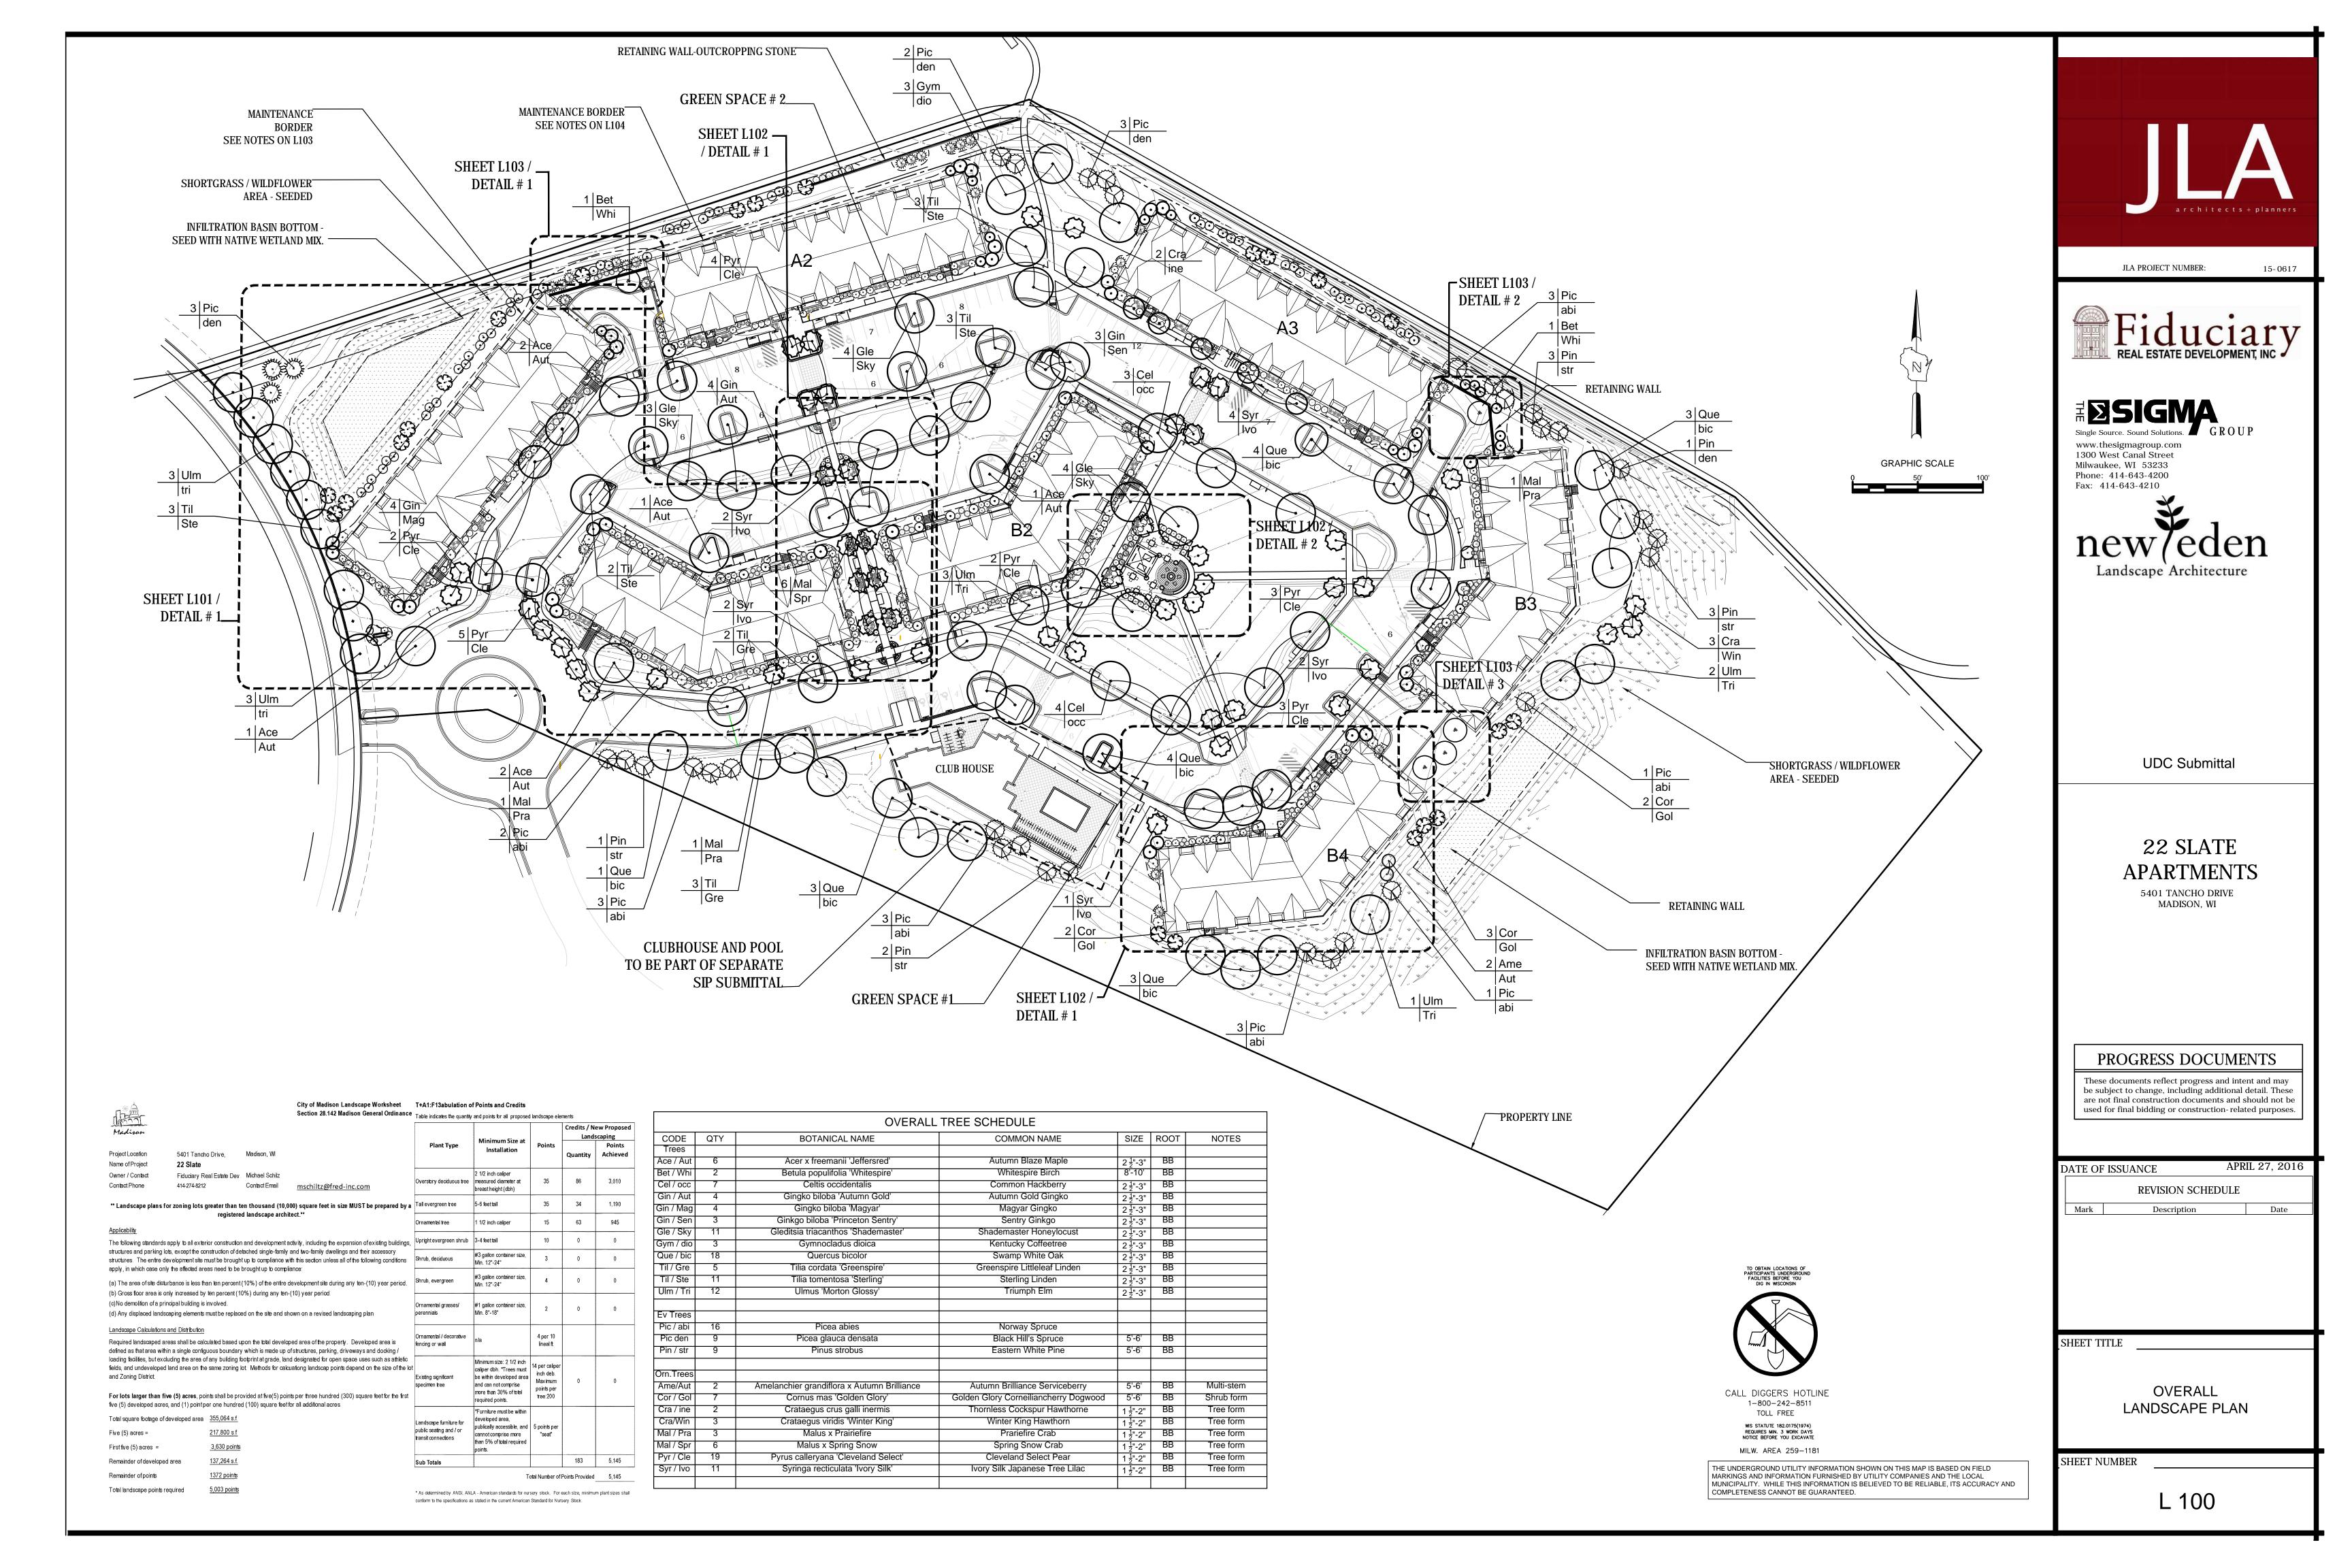
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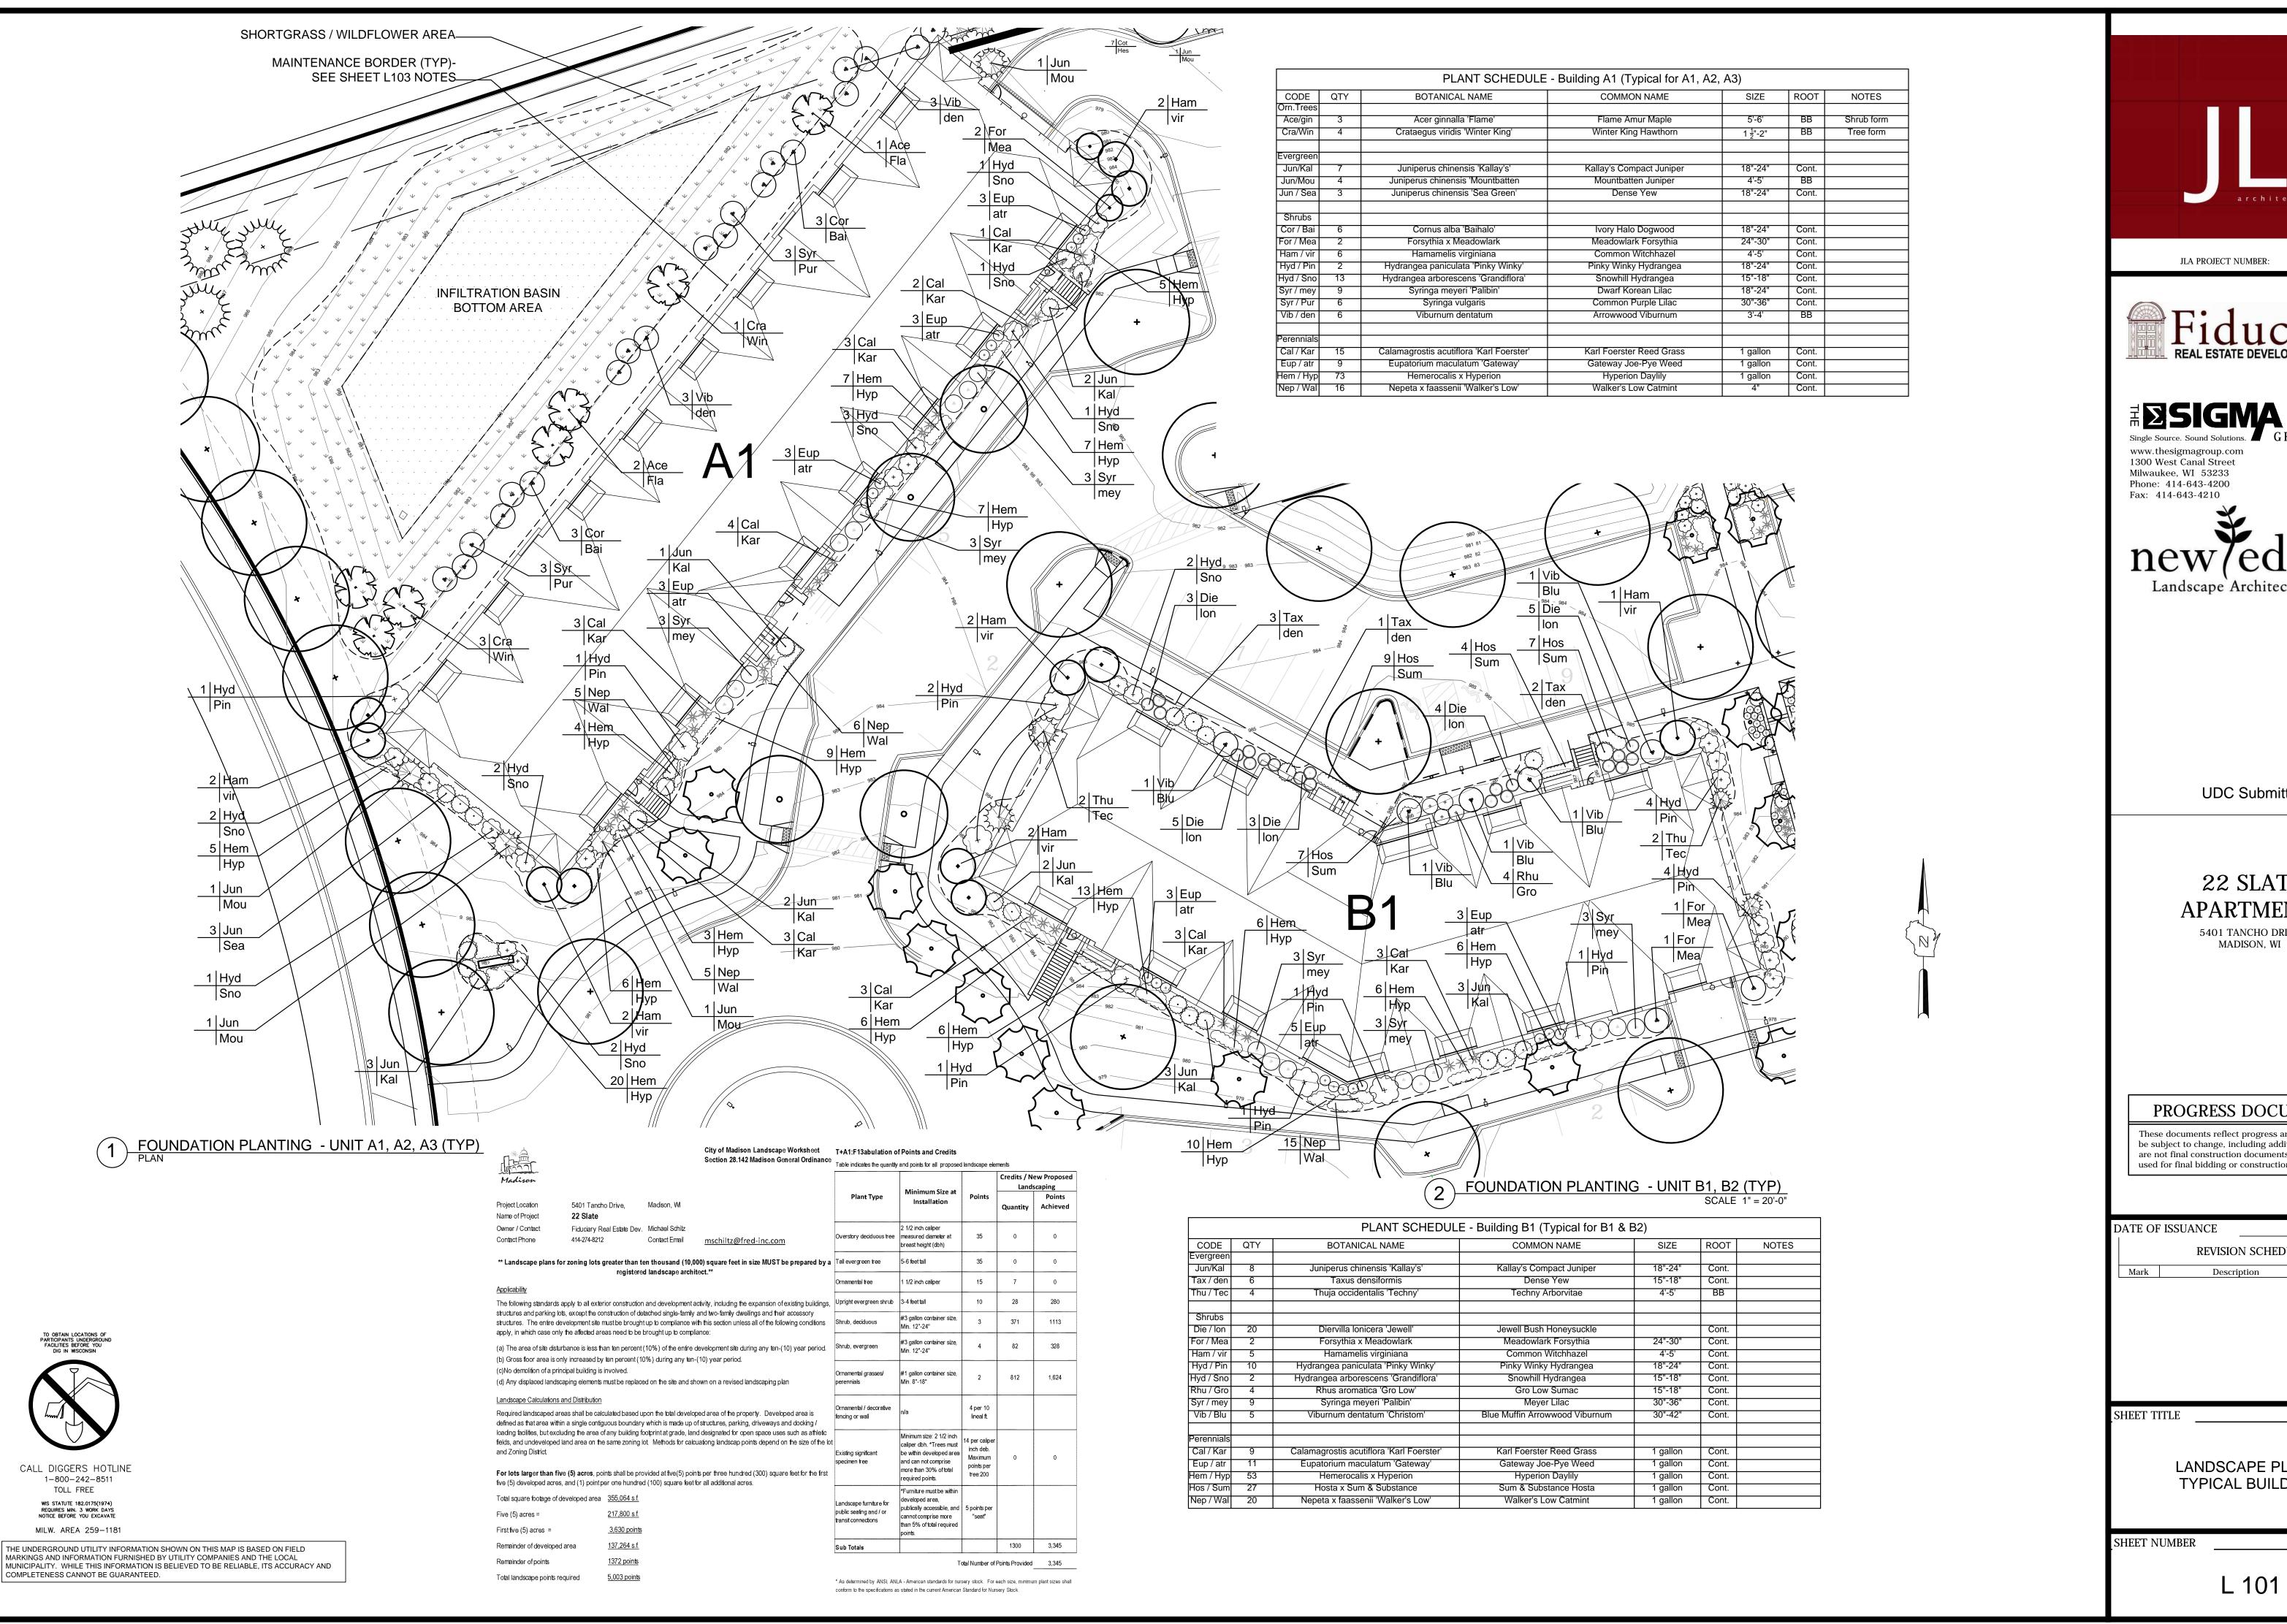
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ARCHITECTURAL SITE ELEMENTS

SHEET NUMBER

ASP101





15-0617



#**DSIGMA** 



**UDC** Submittal

22 SLATE **APARTMENTS** 

5401 TANCHO DRIVE


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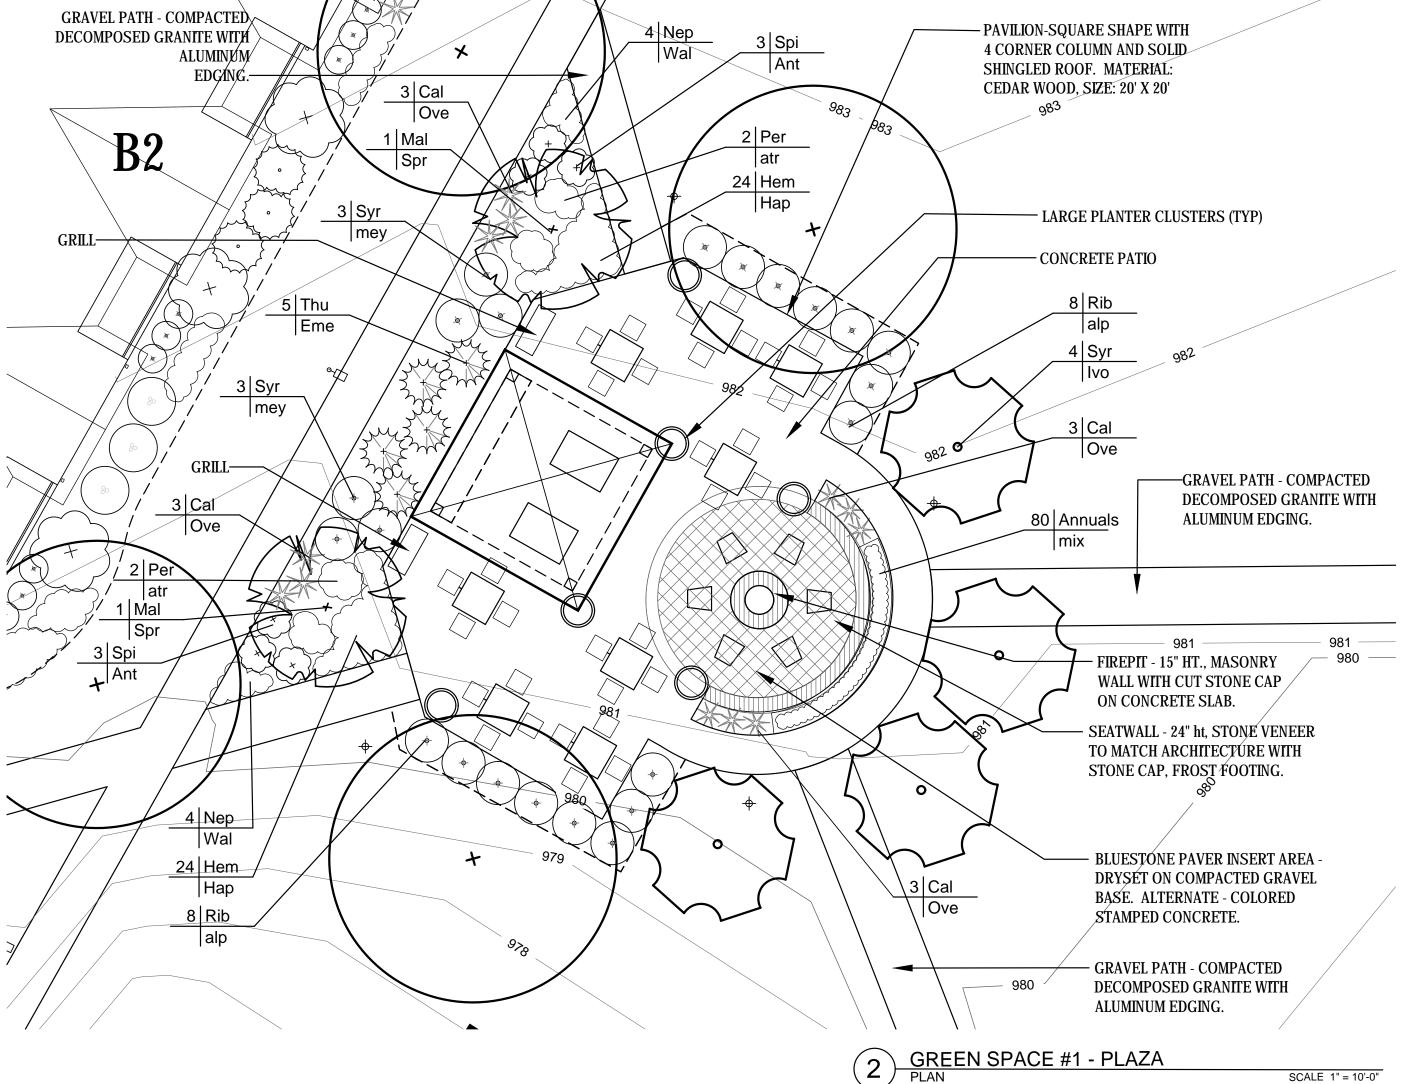
Γ	DATE OF ISSUANCE APRIL 27, 2016				
REVISION SCHEDULE					
	Mark Description Date				

LANDSCAPE PLANS TYPICAL BUILDING

L 101



		PLANT S	SCHEDULE - DETAIL # 1			
CODE	QTY	BOTANICAL NAME	COMMON NAME	SIZE	ROOT	NOTES
Evergreen						
Jun/Kal	4	Juniperus chinensis 'Kallay's'	Kallay's Compact Juniper	18"-24"	Cont.	
Pic / Nid	8	Picea abies 'Nidiformis'	Nest Spruce	18"-24"	Cont.	
Shrubs						
Spi / Ant	8	Spirea bumalda 'Anthony Waterer'	Anthony Waterer Spirea	15"-18"	Cont.	
Spi / Tor	12	Spirea betulifolia 'Tor'	Tor Birchleaf Spirea	15"-18"	Cont.	
Perennials						
Cal / Kar	18	Calamagrostis acutiflora 'Karl Foerster'	Karl Foerster Reed Grass	1 gallon	Cont.	
Hem / Hyp	34	Hemerocalis x Hyperion	Hyperion Daylily	1 gallon	Cont.	
Lon / Hec	4	Lonicera x Heckrottii	Goldflame Honeysuckle	1 gallon	Cont.	
Nep / Wal	92	Nepeta x faassenii 'Walker's Low'	Walker's Low Catmint	1 gallon	Cont.	
Pan / Hea	6	Panicum virgatum 'Heavy Metal	Heavy Metal Switch Grass	1 gallon	Cont.	
Per / mix	80	Perennials-mix	Variety mix	1 gallon	Cont.	
Sch / sco	14	Schizachyrium scorparium	Little Bluestem	1 gallon	Cont.	

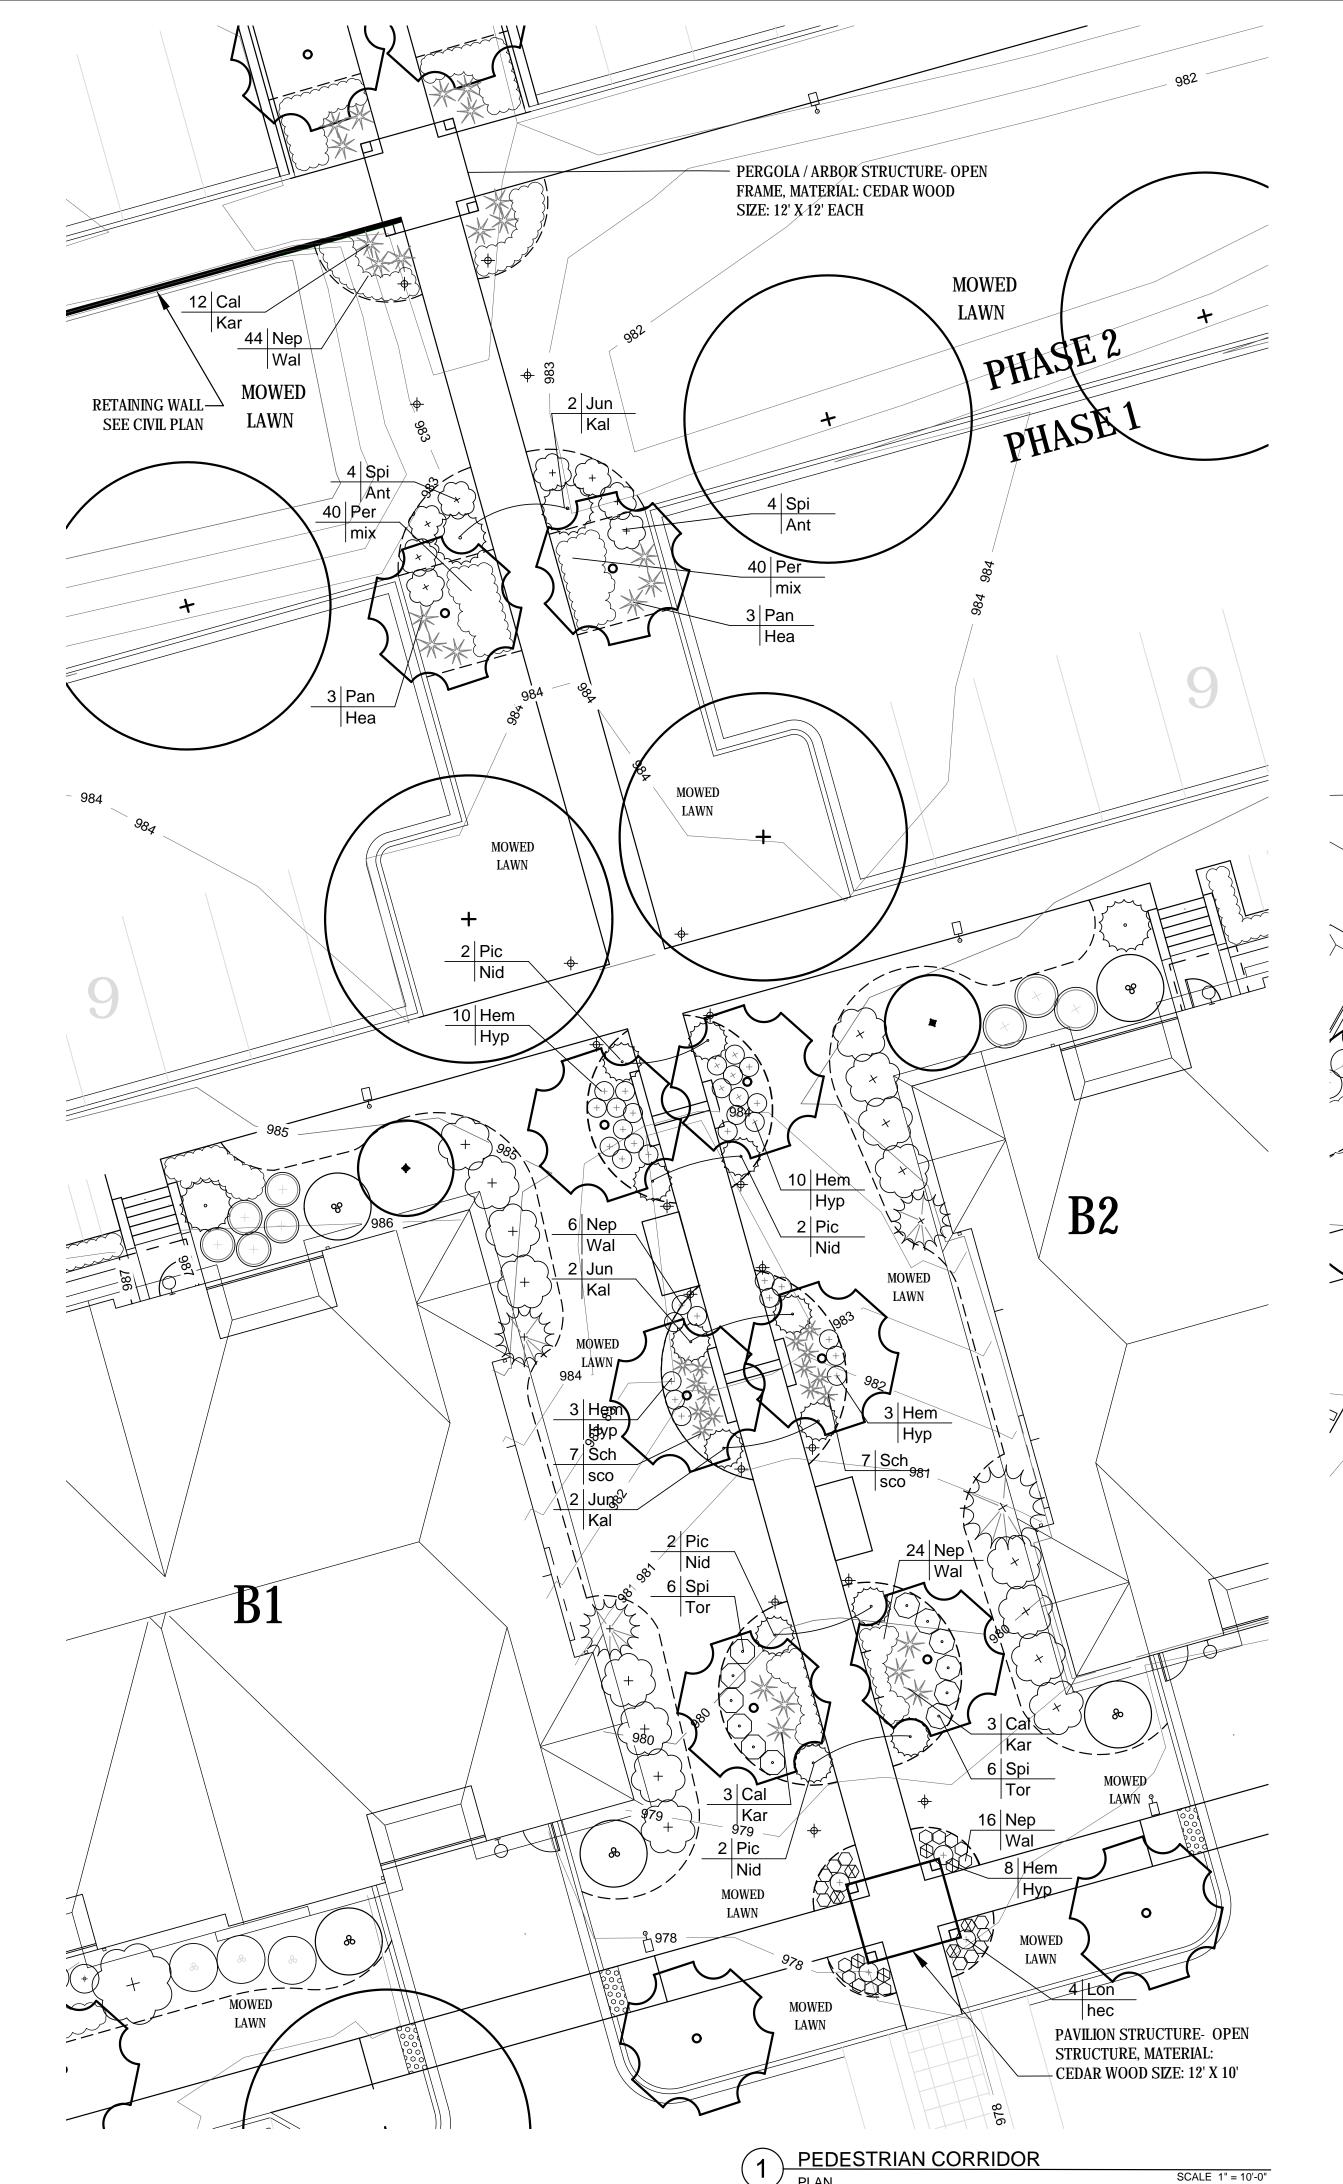

		PLANT S	SCHEDULE - DETAIL # 2			
CODE	QTY	BOTANICAL NAME	COMMON NAME	SIZE	ROOT	NOTES
Orn Tree						
Mal / Spr	2	Malus x Spring Snow	Spring Snow Crab	1 ½"-2"	ВВ	
Syr / Ivo	4	Syringa recticulata 'Ivory Silk'	Ivory Silk Japanese Tree Lilac	1 1 2"-2"	ВВ	
Evergreen						
Thu / Eme	5	Thuja occidentalis 'Smargd'	Emerald Green Arborvitae			
Shrubs						
Rib / alp	16	Ribes alpinum	Alpine Currant	15"-18"	Cont.	
Spi / Ant	6	Spirea bumalda 'Anthony Waterer'	Anthony Waterer Spirea	15"-18"	Cont.	
Syr / mey	6	Syringa meyeri 'Palibin'	Dwarf Korean Lilac			
Perennials						
Cal / Ove	12	Calamagrostis acutifolia 'Overdam'	Overdam Reed Grass	1 gallon	Cont.	
Hem / Hap	48	Hemerocalis x Hyperion	Hyperion Daylily	1 gallon	Cont.	
Nep / Wal	8	Nepeta x faassenii 'Walker's Low'	Walker's Low Catmint	1 gallon	Cont.	
Per / atr	4	Perovskia atriplicifolia	Russian Sage			
Annuals						
	80	Annuals - mixed	Variety mix			





CALL DIGGERS HOTLINE
1-800-242-8511
TOLL FREE
WS STATUTE 182.0175(1974)

WIS STATUTE 182.0175(1974)
REQUIRES MIN. 3 WORK DAYS
NOTICE BEFORE YOU EXCAVATE

MILW. AREA 259—1181

THE UNDERGROUND UTILITY INFORMATION SHOWN ON THIS MAP IS BASED ON FIELD MARKINGS AND INFORMATION FURNISHED BY UTILITY COMPANIES AND THE LOCAL MUNICIPALITY. WHILE THIS INFORMATION IS BELIEVED TO BE RELIABLE, ITS ACCURACY AND COMPLETENESS CANNOT BE GUARANTEED.



JLA PROJECT NUMBER: 15-0617



#**BSIGMA** 

www.thesigmagroup.com 1300 West Canal Street Milwaukee, WI 53233 Phone: 414-643-4200 Fax: 414-643-4210



**UDC** Submittal

22 SLATE
APARTMENTS
5401 TANCHO DRIVE

MADISON, WI

PROGRESS DOCUMENTS

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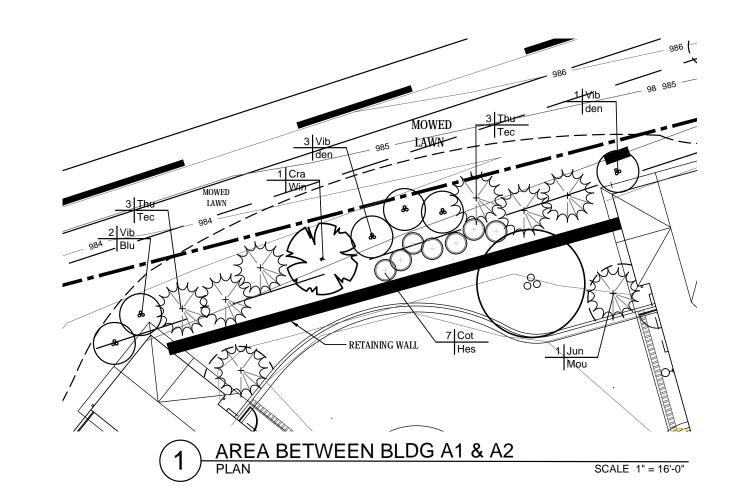
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	REVISION	SCHEDULE
Mark	Descript	tion Date


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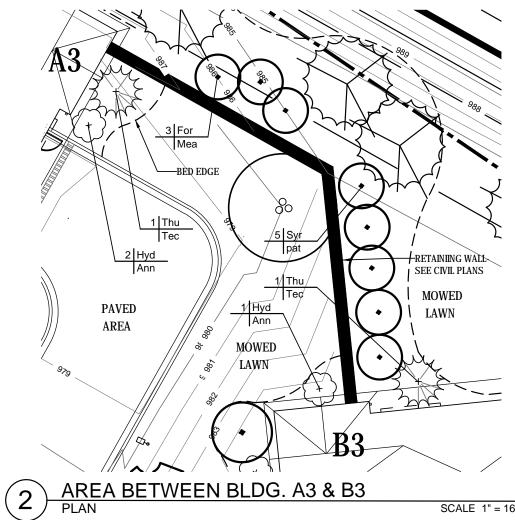
LANDSCAPE PLAN GREENS SPACE AND COMMON AREA DETAILS

SHEET NUMBER


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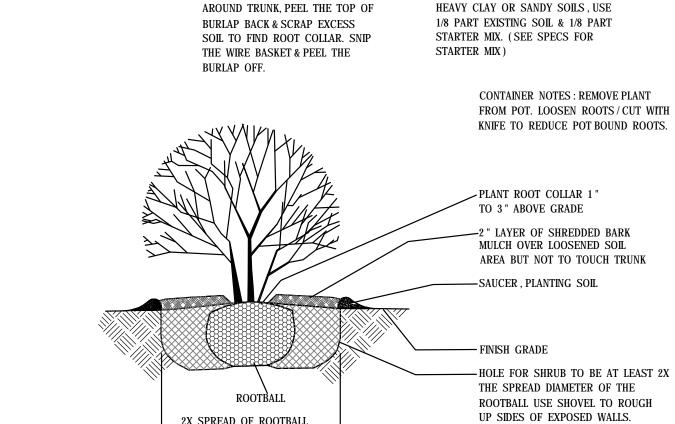


	PLANT SCHEDULE - DETAIL # 2					
CODE	QTY	BOTANICAL NAME	COMMON NAME	SIZE	ROOT	NOTES
Evergreen						
Thu/Tec	2	Thuja occidentalis 'Techny'	Techny Arborvitae	18"-24"	Cont.	
Shrubs						
For / Mea	3	Forsythia x Meadowlark	Meadowlark Forsythia	30"-36"	Cont.	
Hyd / Ann	2	Hydrangea arborscens 'Annabelle'	Annabelle Hydrangea	15"-18"	Cont.	
Syr / pat	5	Syringa patula	Miss Kim Lilac	24"-30"	Cont.	

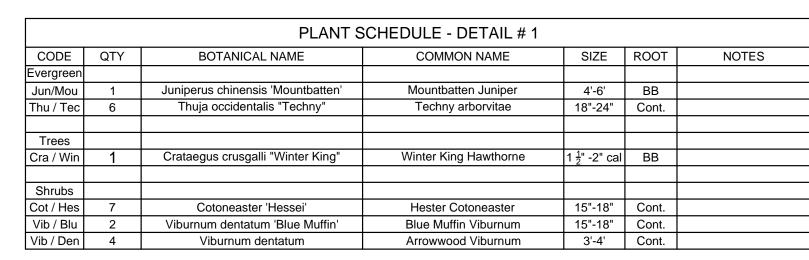


SOIL NOTES: SOIL MIXTURE FOR

HEAVY CLAY OR SANDY SOILS, USE

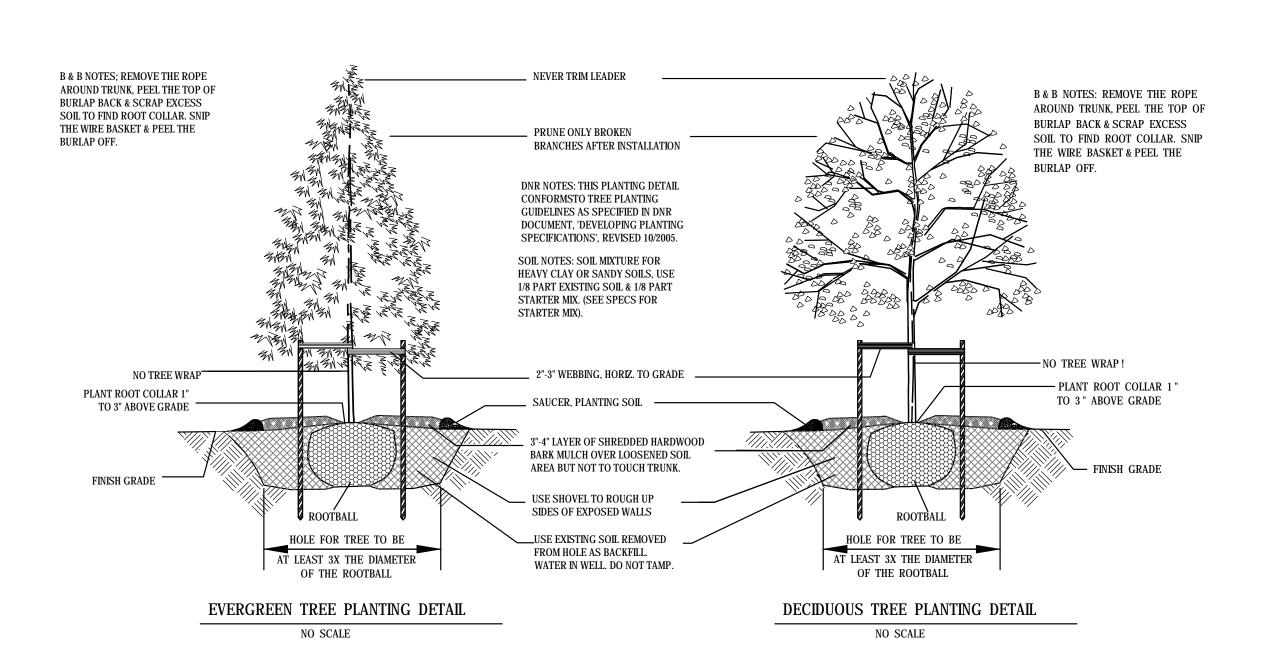

B & B NOTES: REMOVE THE ROPE

2X SPREAD OF ROOTBALL

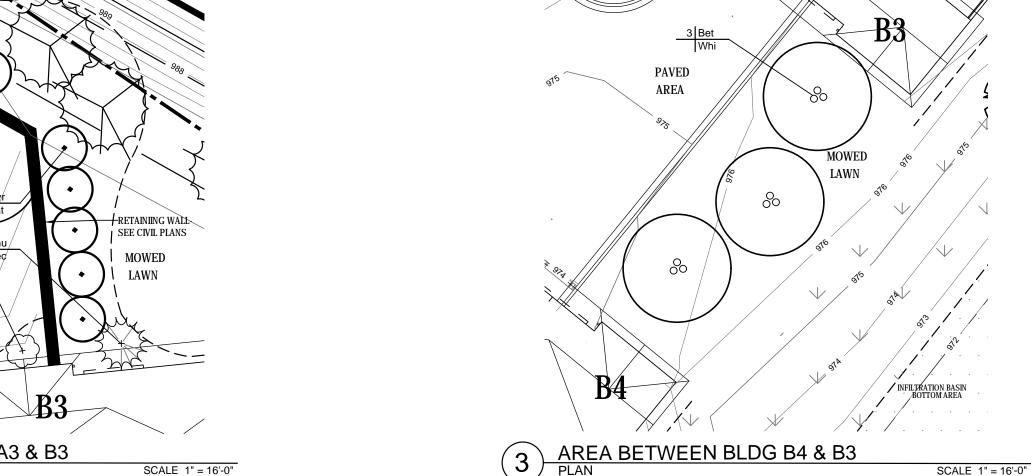

		PLANT S	SCHEDULE - DETAIL # 3			
CODE	QTY	BOTANICAL NAME	COMMON NAME	SIZE	ROOT	NOTES
Trees						
Bet / Whi	3	Betula populifolia 'Whitespire'	Whitespiure Birch	8'-10'	BB	

### LANDSCAPE INSTALLATION NOTES

- 1. The Landscaping Contractor shall verify location of all underground utilities and additional information prior to installation of all landscaping. Call Digger's Hotline.
- 2. Rough grading and drainage shall be completed prior to Landscape Contractor's commensing work. Verify all existing site and grading conditions prior to construction.
- 3. All landscape work shall be in conformance with all applicable local codes & ordinances.
- 4. All areas disturbed by grading or site construction shall be fine graded, planted or seeded.
- 5. Contractor shall verify plant quantities shown on plan and provide a list to the Architect identifying the species and sized to be used throughout the project. The Landscape Architect reserves the right to reject any sub-standard planting material. Such rejected material shall be removed from the project site immediately.
- 6. All planting beds shall receive a blended topsoil mix to a depth of 6" and turf areas a depth of 3". Contractor shall provide positive drainage away from all buildings for a minimum of 10'. Remove excessive clay, gravel & stones which would be detrimental to healthy plant growth. Roto-til new topsoil into existing soil.
- 7. All perennial and groundcover areas shall receive a blend of organic soil amendments prior to planting.
  Roto-til the amendments into the new topsoil to a depth of 6". Avoid damage to existing tree roots where applicable by lightly working amendments into soil with pitch fork

Add to beds:

2 inch cover of plant starter soil mix

1/2 lb. of 5-10-5 garden fertilizer (Ozmocote or Milorganite)

- 8. All perennial and groundcover areas shall receive a 1-2" layer of finely shredded bark mulch. Do not allow mulch to touch stems or leaves of perennials! All woody planting areas shall receive a 3" layer. Unless otherwise noted, no landscape fabric or weed barrier is to be installed.
- 9. Unless otherwise shown, all perennials & shrubs shall be planted in a triangular arrangement. For plants not shown individually, refer to the spacing shown in the plant schedule.
- 10. All areas indicated as Maintenenace border beds shall be covered with a 2.5" cover of Mississippi aggregate (Source: Kafka Stone) over landscape fabric underlayment and aluminum edging. Color of Spardust to be approved by owner.
- 11. All planting and maintenance beds shall be edged with aluminum edging Permaloc Clean Line, Size: 1/8" x 4" x 16', Finish: mill or approved equal.

## SEED MIXES (See plans for locations)

SEEDED MOWED TURF: "Delux 50 Lawn Seed Mix" Available from Rheinders (800) 785-3301 Shall be installed & maintained per supplier's specifications.

> 25% Creeping Red Fescue 20% Kentucky Bluegrass 15% Bluebonnet Kentucky Bluegrass 15% Quebec Perennial Ryegrass 15% Kenblue Kentucky Bluegrass 10% Wicked Perennial Ryegrass

SHORT GRASS / WILDFLOWER AREA / DETENTION BASINS "Short Prairie Wildflower & Grass Mix" Available from Reinders Sussex, WI Phone 1-800-785-3301 / Or approved equal. To be installed & maintained per supplier's specifications.

NATIVE WETLAND MIX - INFILTRATION BOTTOM "Native Wetland Mix" Available from Reinders Sussex, WI Phone 1-800-785-3301 / Or approved equal. To be installed & maintained per supplier's specifications.



JLA PROJECT NUMBER:

15-0617



 $www. the {\bf sigmagroup.com}$ 1300 West Canal Street Milwaukee, WI 53233 Phone: 414-643-4200 Fax: 414-643-4210



**UDC** Submittal

22 SLATE **APARTMENTS** 5401 TANCHO DRIVE MADISON, WI

# PROGRESS DOCUMENTS

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DATE OF	ISSUANCE	APR	IL 27, 2016
	REVISION	N SCHEDULE	
Mark	Mark Description		

SHEET TITLE

**NOTES & DETAILS** 

SHEET NUMBER



CALL DIGGERS HOTLINE 1-800-242-8511

> TOLL FREE WIS STATUTE 182.0175(1974)

MILW. AREA 259-1181

COMPLETENESS CANNOT BE GUARANTEED.

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6 A1 & A3 - FRONT ELEVATION
3/32" = 1'-0"



11 A1 & A3 - END ELEVATION
3/32" = 1'-0"



JLA PROJECT NUMBER: 15-0617-01



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22-SLATE APARTMENTS

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SHEET TITLE

EXTERIOR ELEVATIONS - BUILDINGS A1 & A3

SHEET NUMBER

A200-A1.A3







11) A1 & A3 - END ELEVATION (W/ GARAGE)



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22-SLATE APARTMENTS

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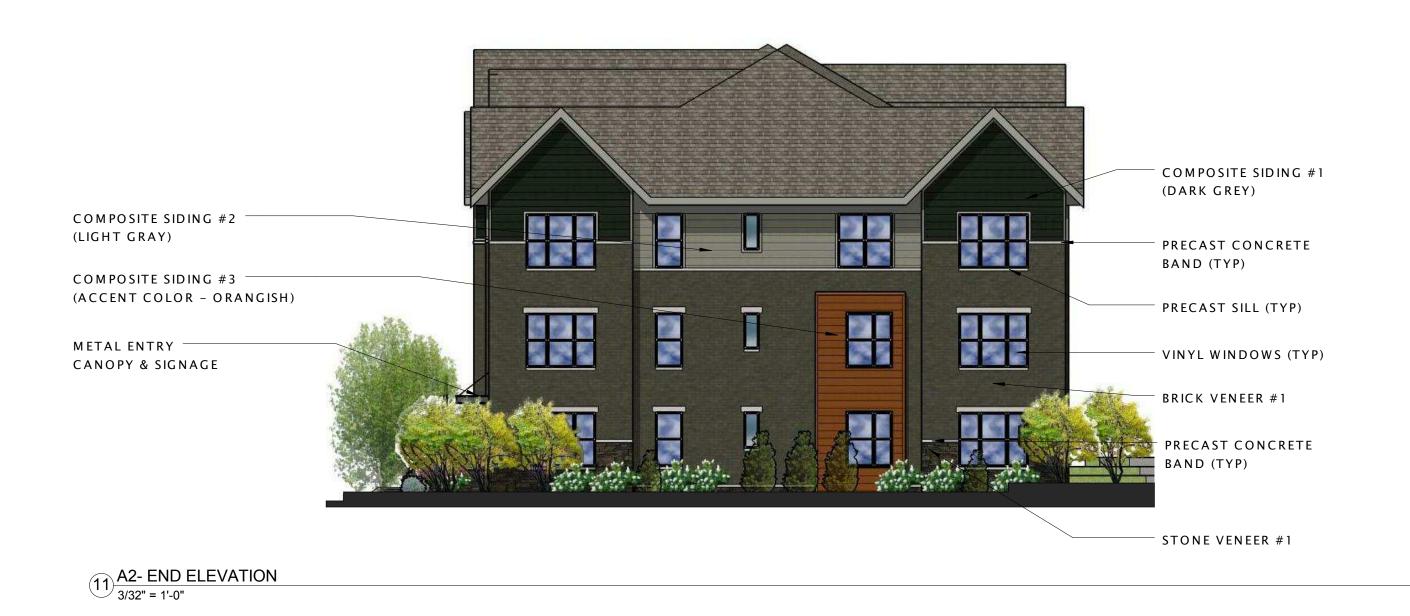
SHEET TITLE

EXTERIOR ELEVATIONS BUILDINGS A1 & A3

SHEET NUMBER

A201-A1.A3





JOSEPH LEE + ASSOCIATES
2418 CROSSROADS DRIVE - SUITE 2300
Madison, Wisconsin 53718
608.241.9500

JLA PROJECT NUMBER: 15-0617-01



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SHEET TITLE

EXTERIOR ELEVATIONS -BUILDING A2

SHEET NUMBER

A200-A2.



6 A2 - REAR ELEVATION
3/32" = 1'-0"



11) A2 - END ELEVATION (W/ GARAGE) 3/32" = 1'-0"



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UDC Submittal

22-SLATE APARTMENTS

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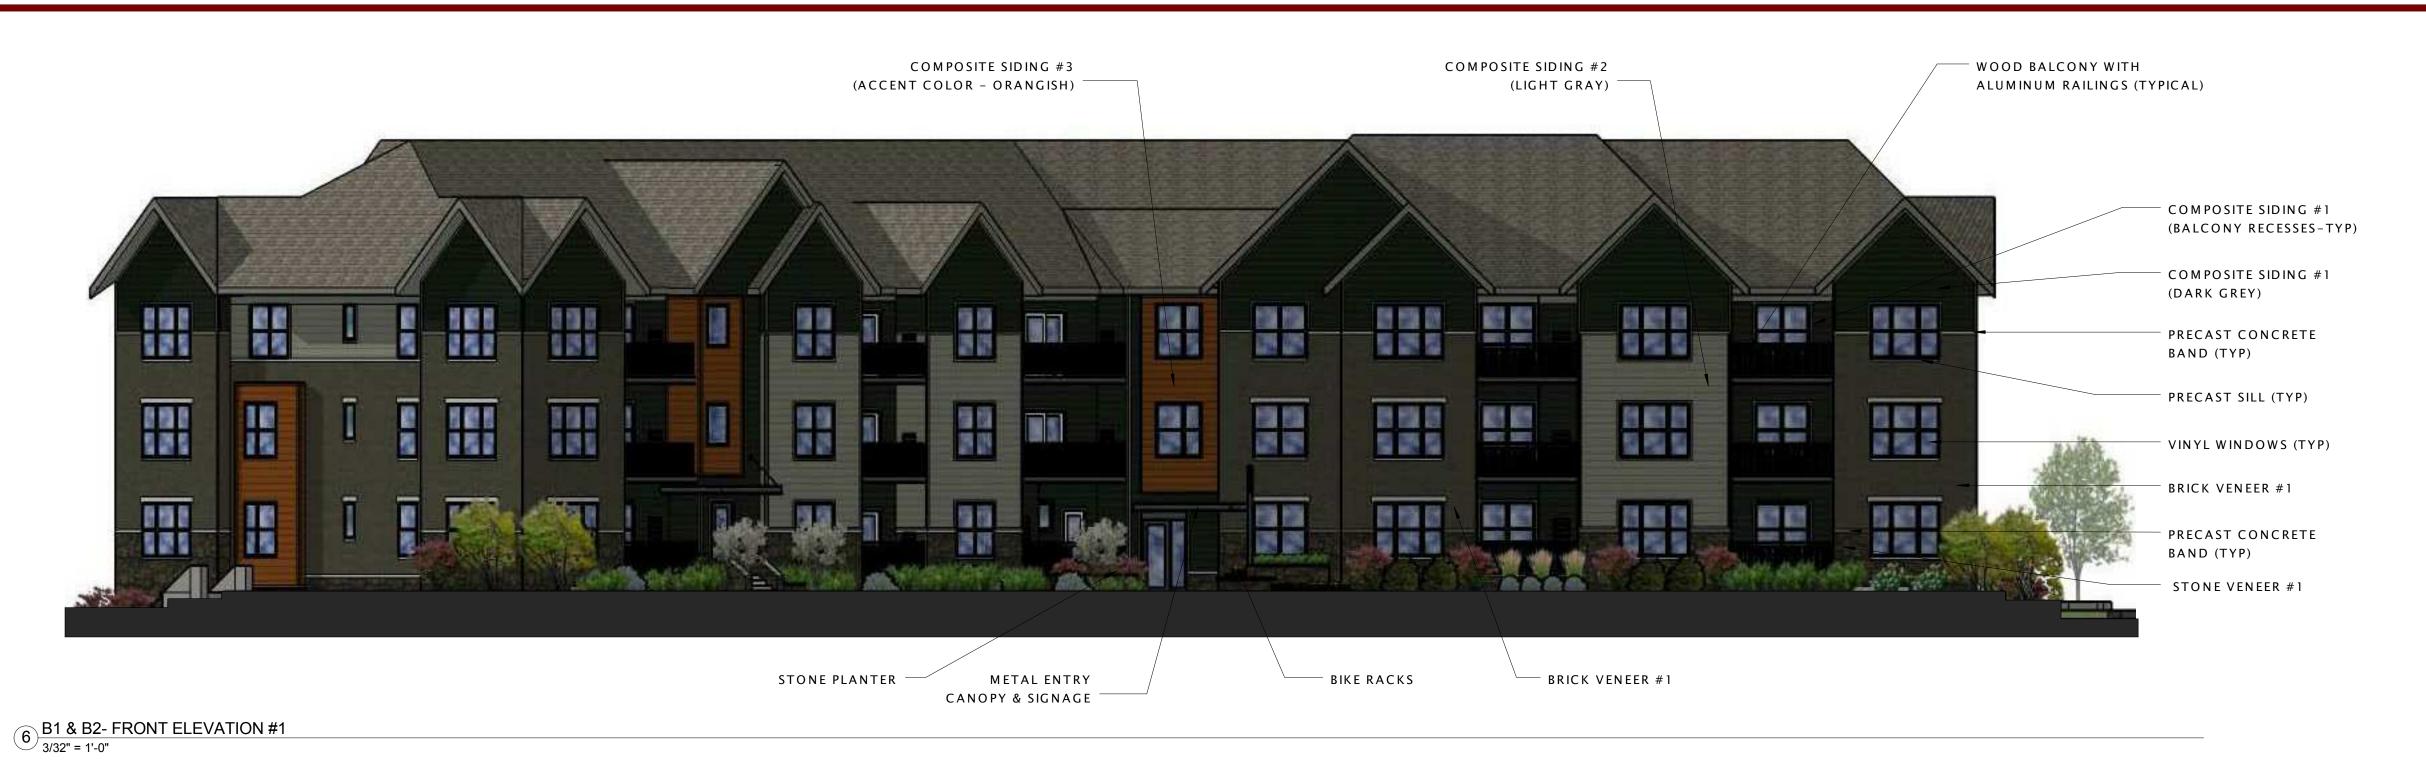
DATEO	F ISSUANCE	APRIL 27, 2016	
	REVISION SO	CHEDULE	
Mark	Mark Description		

SHEET TITLE

EXTERIOR ELEVATIONS -BUILDING A2

SHEET NUMBER

A201-A2.



WOOD BALCONY WITH COMPOSITE SIDING #3 COMPOSITE SIDING #2 (LIGHT GRAY) (ACCENT COLOR - ORANGISH) ALUMINUM RAILINGS (TYPICAL) COMPOSITE SIDING #1 (BALCONY RECESSES-TYP) COMPOSITE SIDING #1 (DARK GREY) PRECAST CONCRETE 200 BAND (TYP) PRECAST SILL (TYP) 81 88 181 81 82 181 525 3 16 7 VINYL WINDOWS (TYP) BRICK VENEER #1 PRECAST CONCRETE BAND (TYP) MANUFACTURED STONE VENEER #1

COMPOSITE SIDING #2 (LIGHT GRAY) COMPOSITE SIDING #3 (ACCENT COLOR - ORANGISH) COMPOSITE SIDING #1 (DARK GREY) PRECAST CONCRETE BAND (TYP) PRECAST SILL (TYP) VINYL WINDOWS (TYP) BRICK VENEER #1 PRECAST CONCRETE 888 BAND (TYP) STONE VENEER #1

STONE PLANTER

METAL ENTRY CANOPY & SIGNAGE

16 B1 & B2 - END ELEVATION #1

11 B1 & B2- FRONT ELEVATION #2 3/32" = 1'-0"



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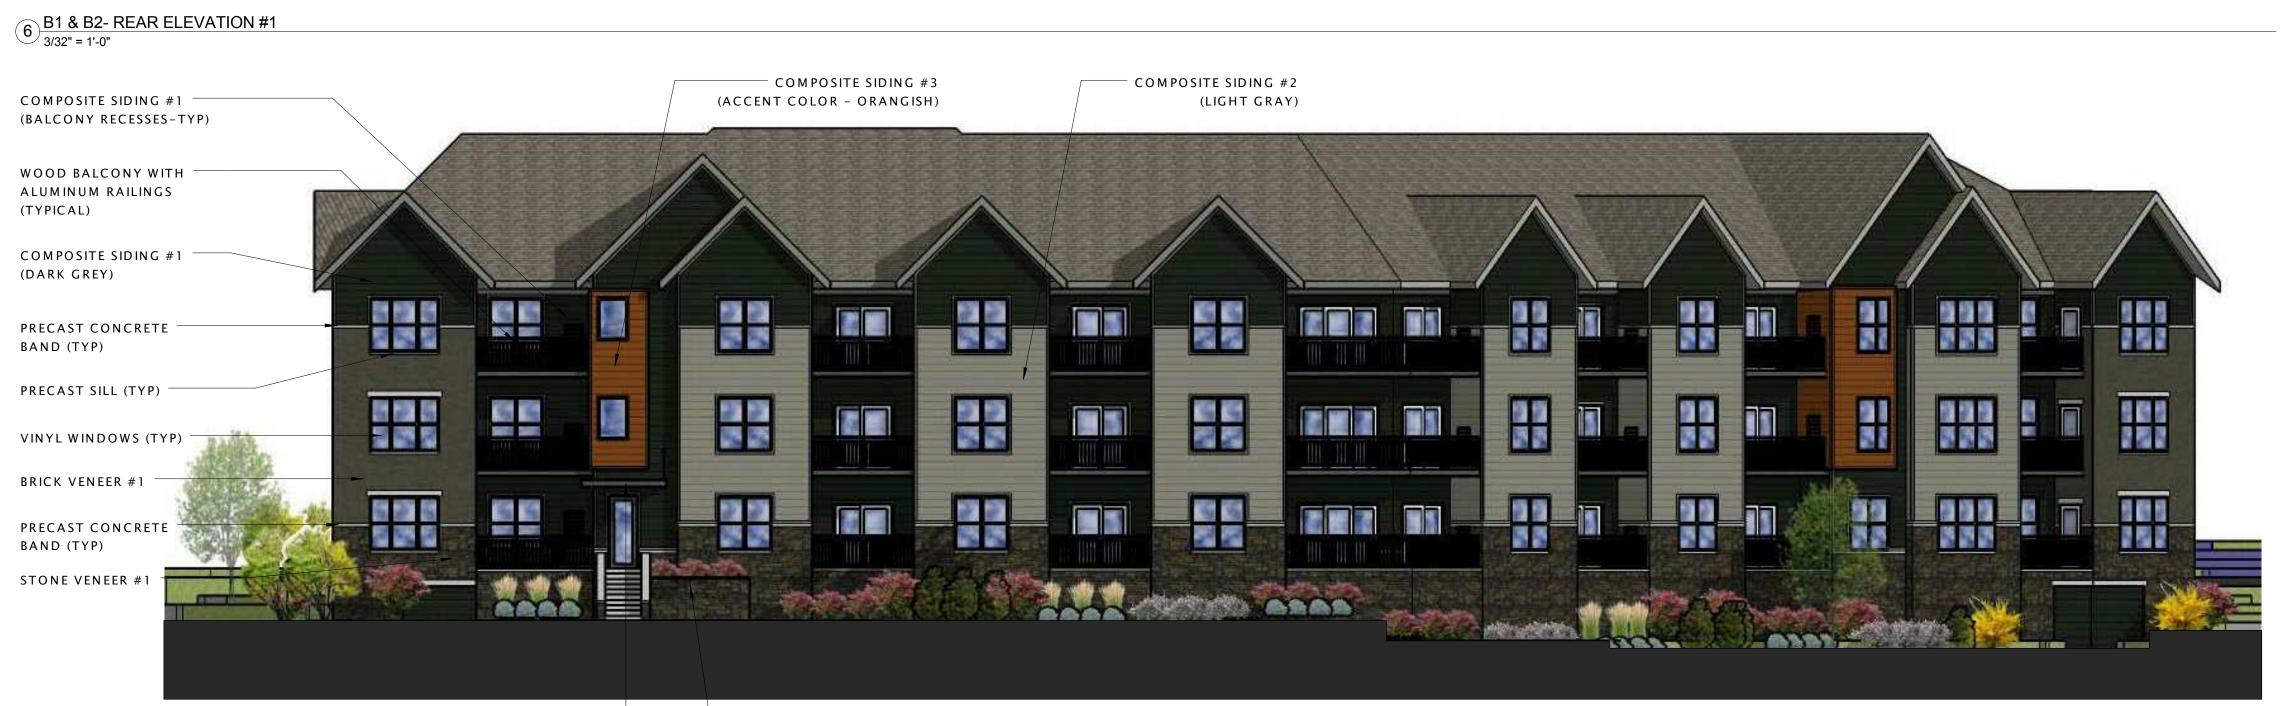
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EXTERIOR ELEVATIONS BUILDINGS B1 & B2

SHEET NUMBER

A200-B1.B2





11) B1 & B2- REAR ELEVATION 2
3/32" = 1'-0"



STONE PLANTER

METAL ENTRY CANOPY & SIGNAGE ———

16 B1 & B2 - END ELEVATION #2



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22-SLATE APARTMENTS

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Mark Description		
	REVISION S	

SHEET TITLE

EXTERIOR ELEVATIONS - BUILDINGS B1 & B2

SHEET NUMBER

A201-B1.B2





11 B3 & B4 - FRONT ELEVATION #2 3/32" = 1'-0"

METAL ENTRY CANOPY & SIGNAGE



STONE PLANTER

JOSEPH LEE + ASSOCIATES
2418 CROSSROADS DRIVE - SUITE 2300
Madison, Wisconsin 53718
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APRIL 27, 2016

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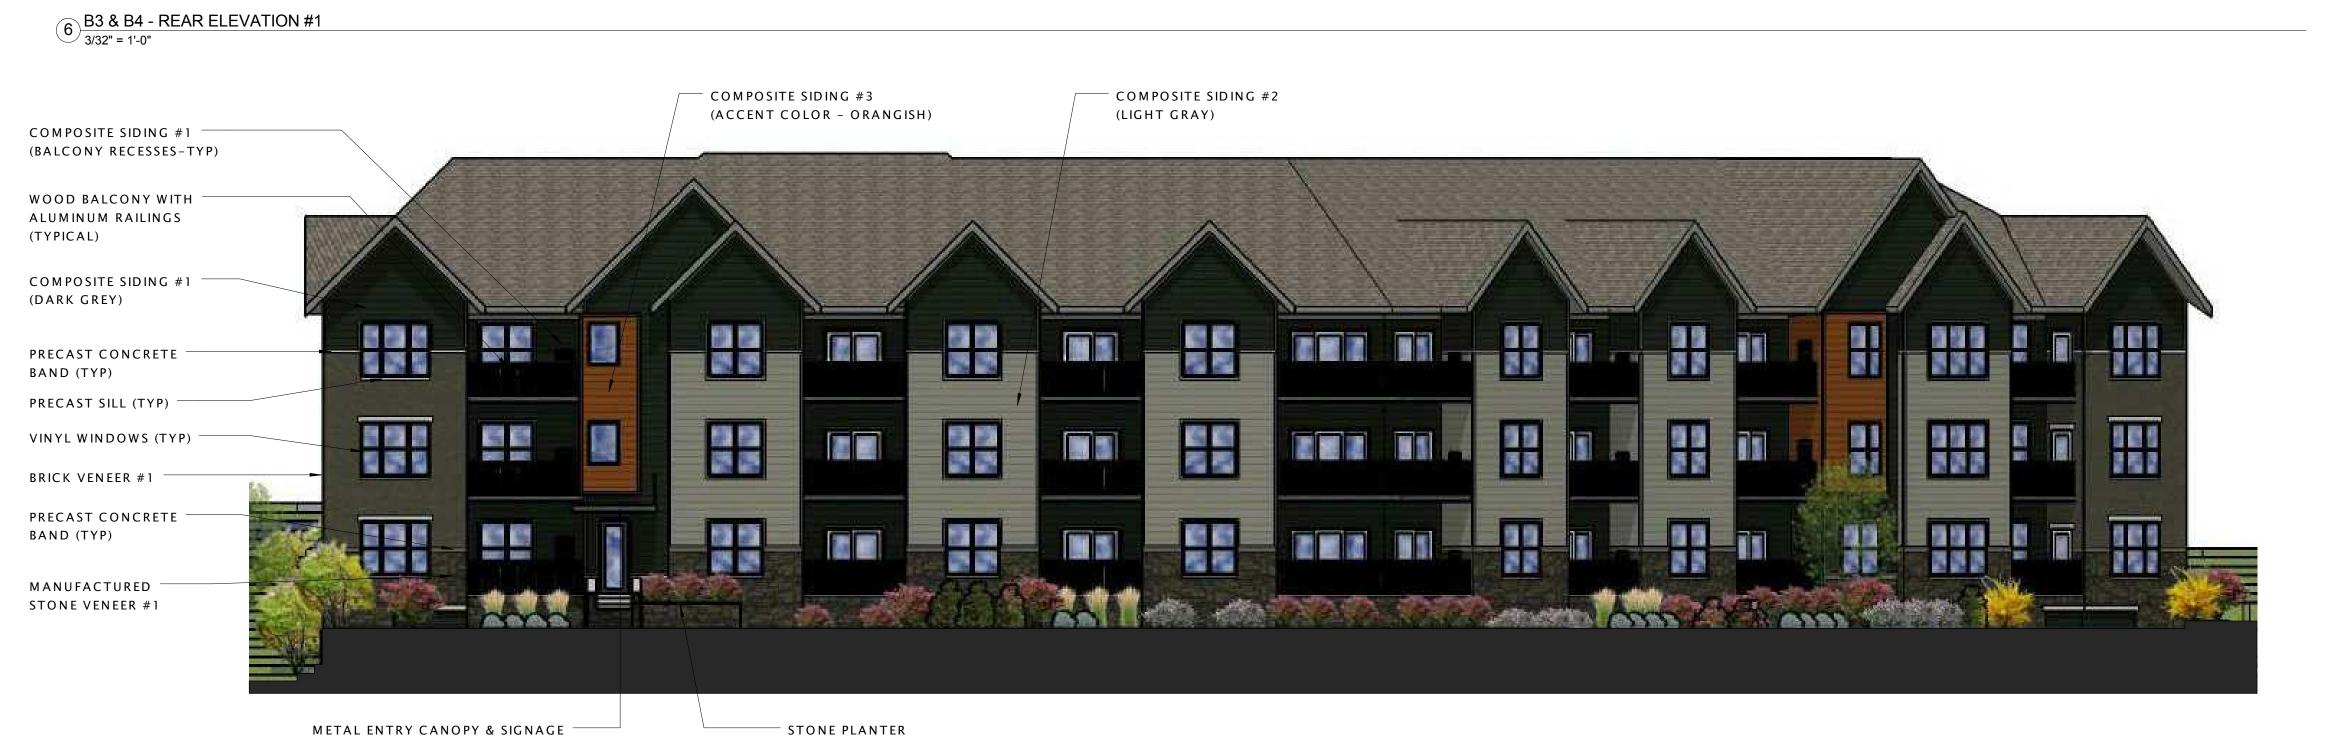
DATE OF ISSUANCE

EXTERIOR ELEVATIONS BUILDINGS B3 & B4

SHEET NUMBER

A200-B3.B4





B3 & B4 - REAR ELEVATION #2
3/32" = 1'-0"



B3 & B4 - END ELEVATION (W/ GARAGE)
3/32" = 1'-0"



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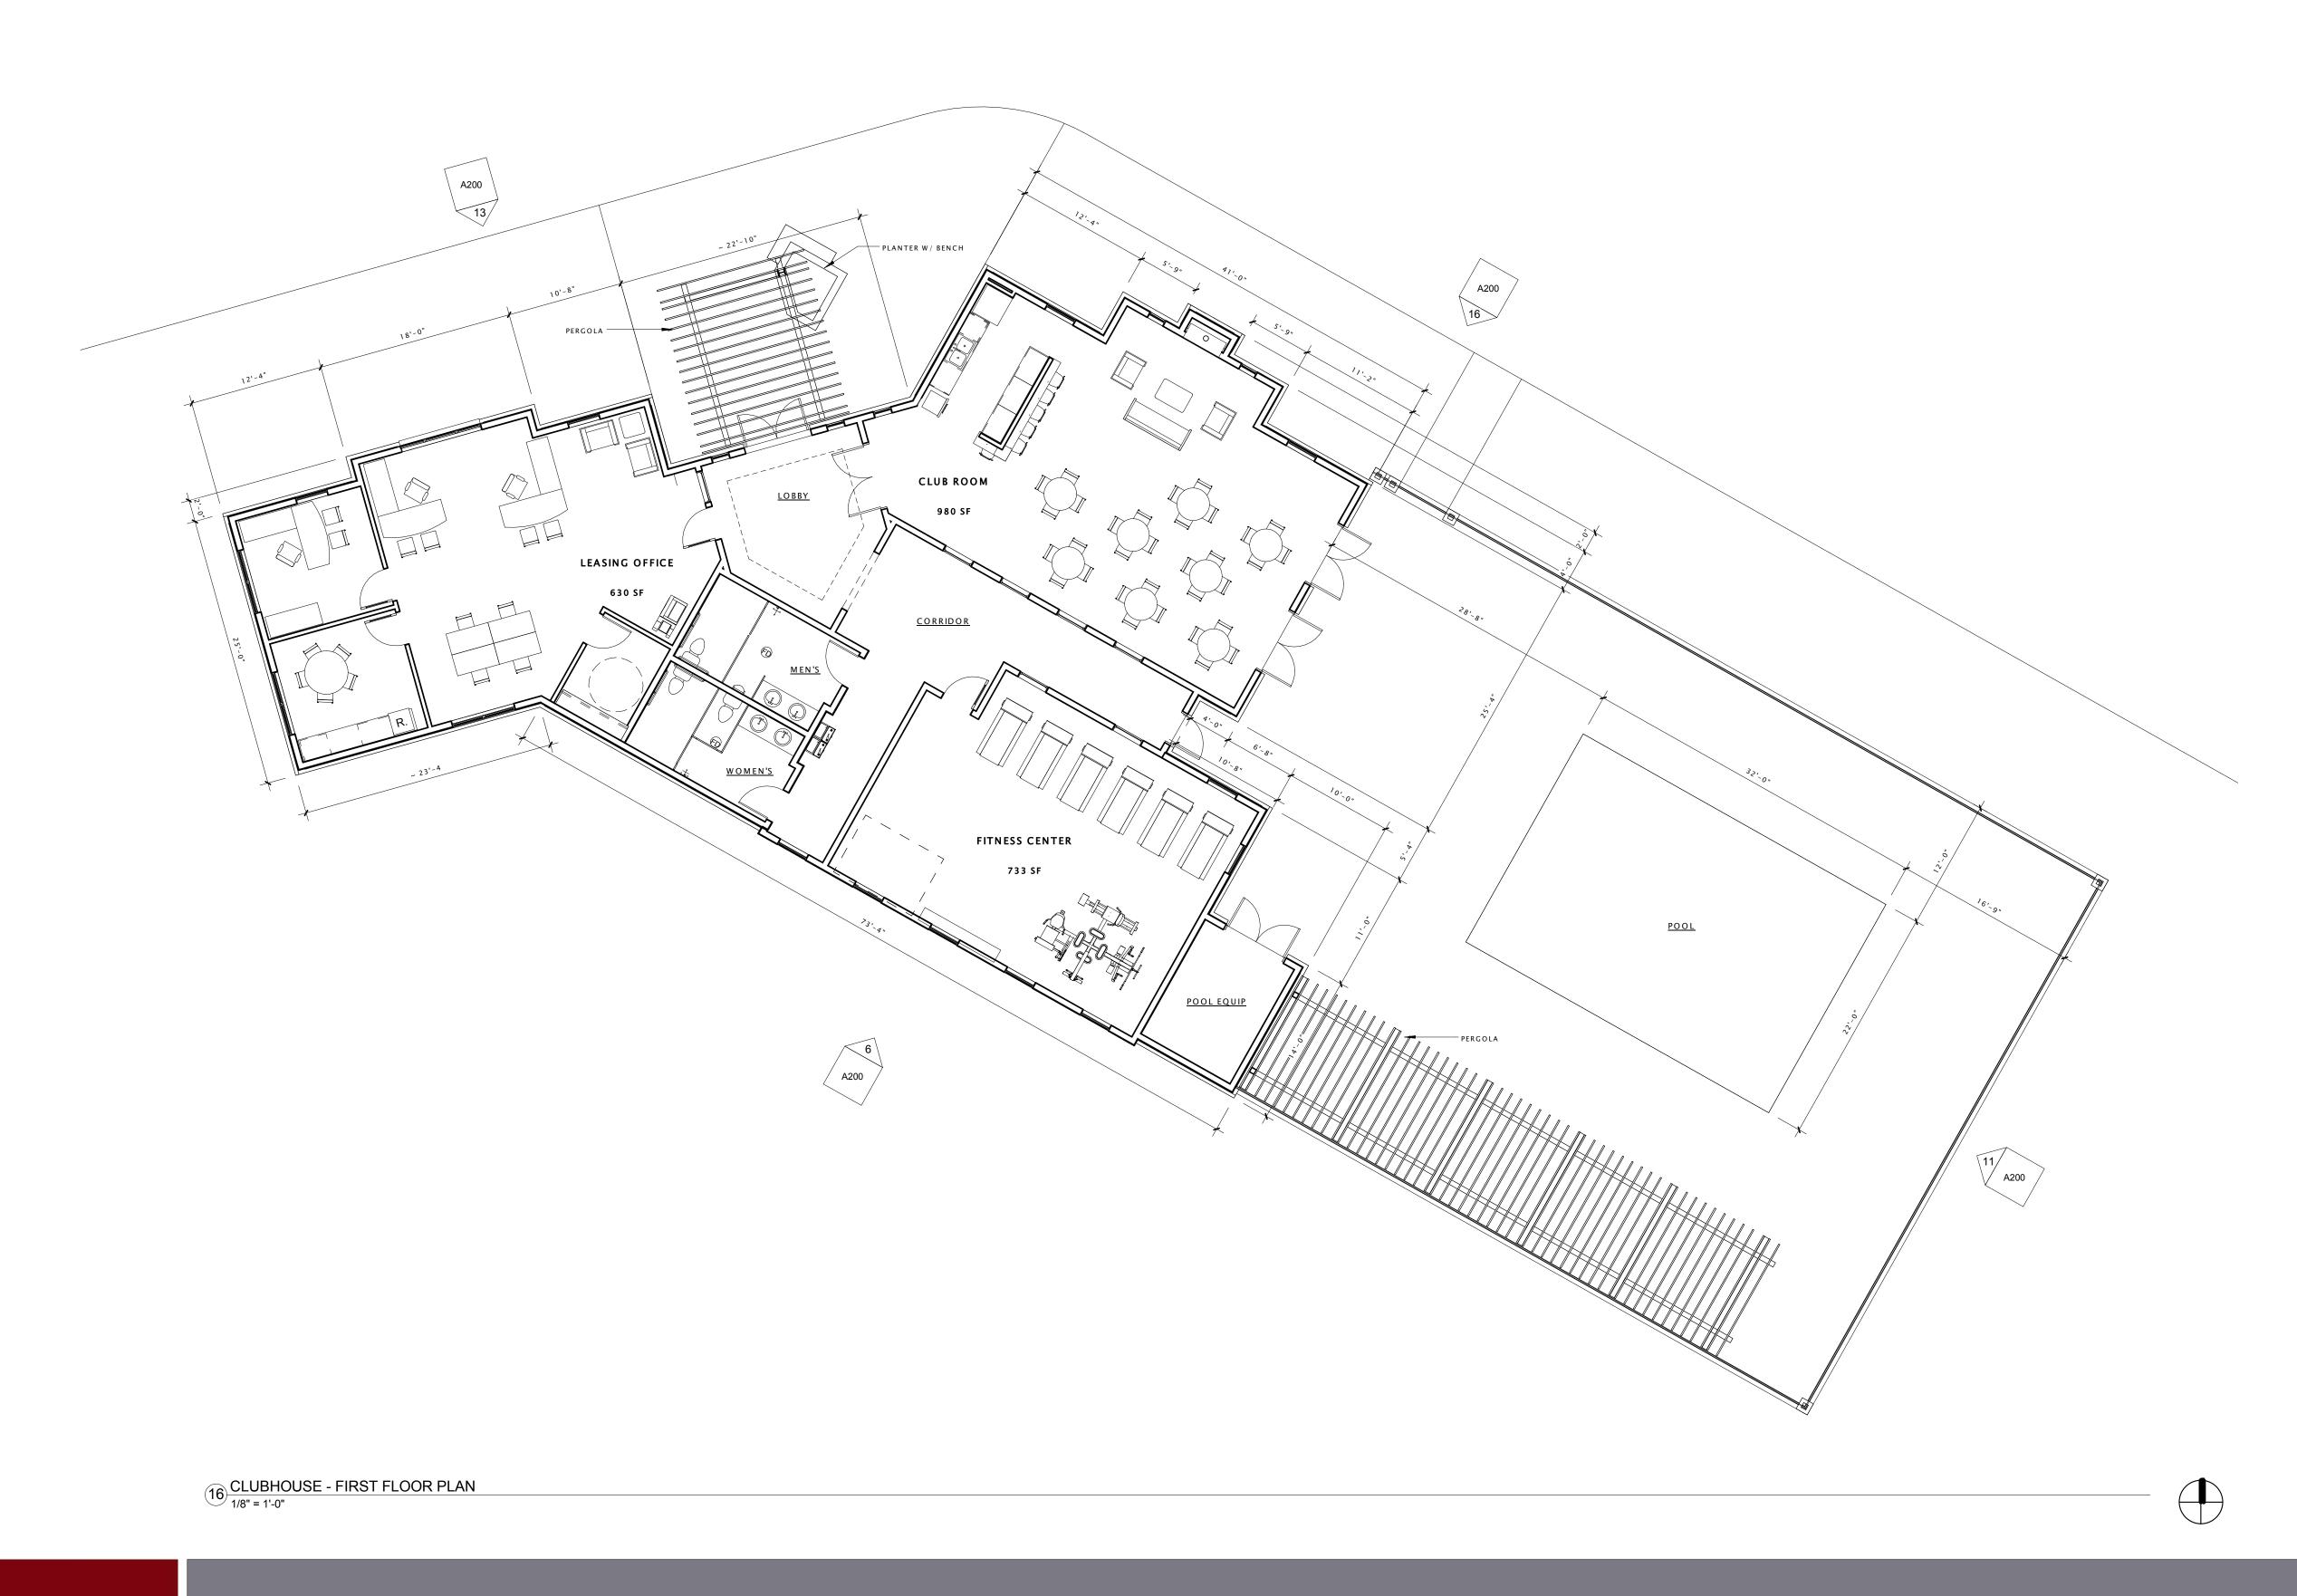
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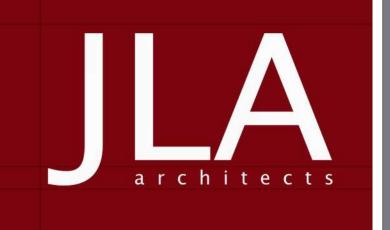
SHEET TITLE

EXTERIOR ELEVATIONS
BUILDINGS B3 & B4

SHEET NUMBER

A201-B3.B4





# 22-SLATE APARTMENTS - CLUBHOUSE

5401 Tancho Drive
Madison, Wisconsin
CLUBHOUSE FIRST FLOOR PLAN

PROGRESS DOCUMENTS


These documents reflect progress and intent and may be subject to change, including additional detail. These are not final construction documents and should not be

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JLA PROJECT #:

15-0617-01 MARCH 1, 2016



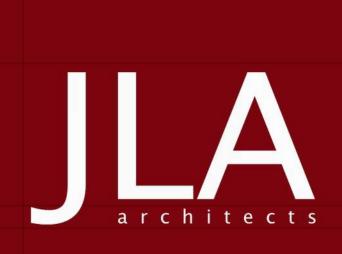

# 22-SLATE APARTMENTS - CLUBHOUSE

5401 Tancho Drive
Madison, Wisconsin
CLUBHOUSE EXTERIOR ELEVATIONS


PROGRESS DOCUMENTS

These documents reflect progress and intent and may be subject to change, including additional detail. These are not final construction documents and should not be used for final bidding or construction-related purposes.

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JLA PROJECT #:

MARCH 1, 2016

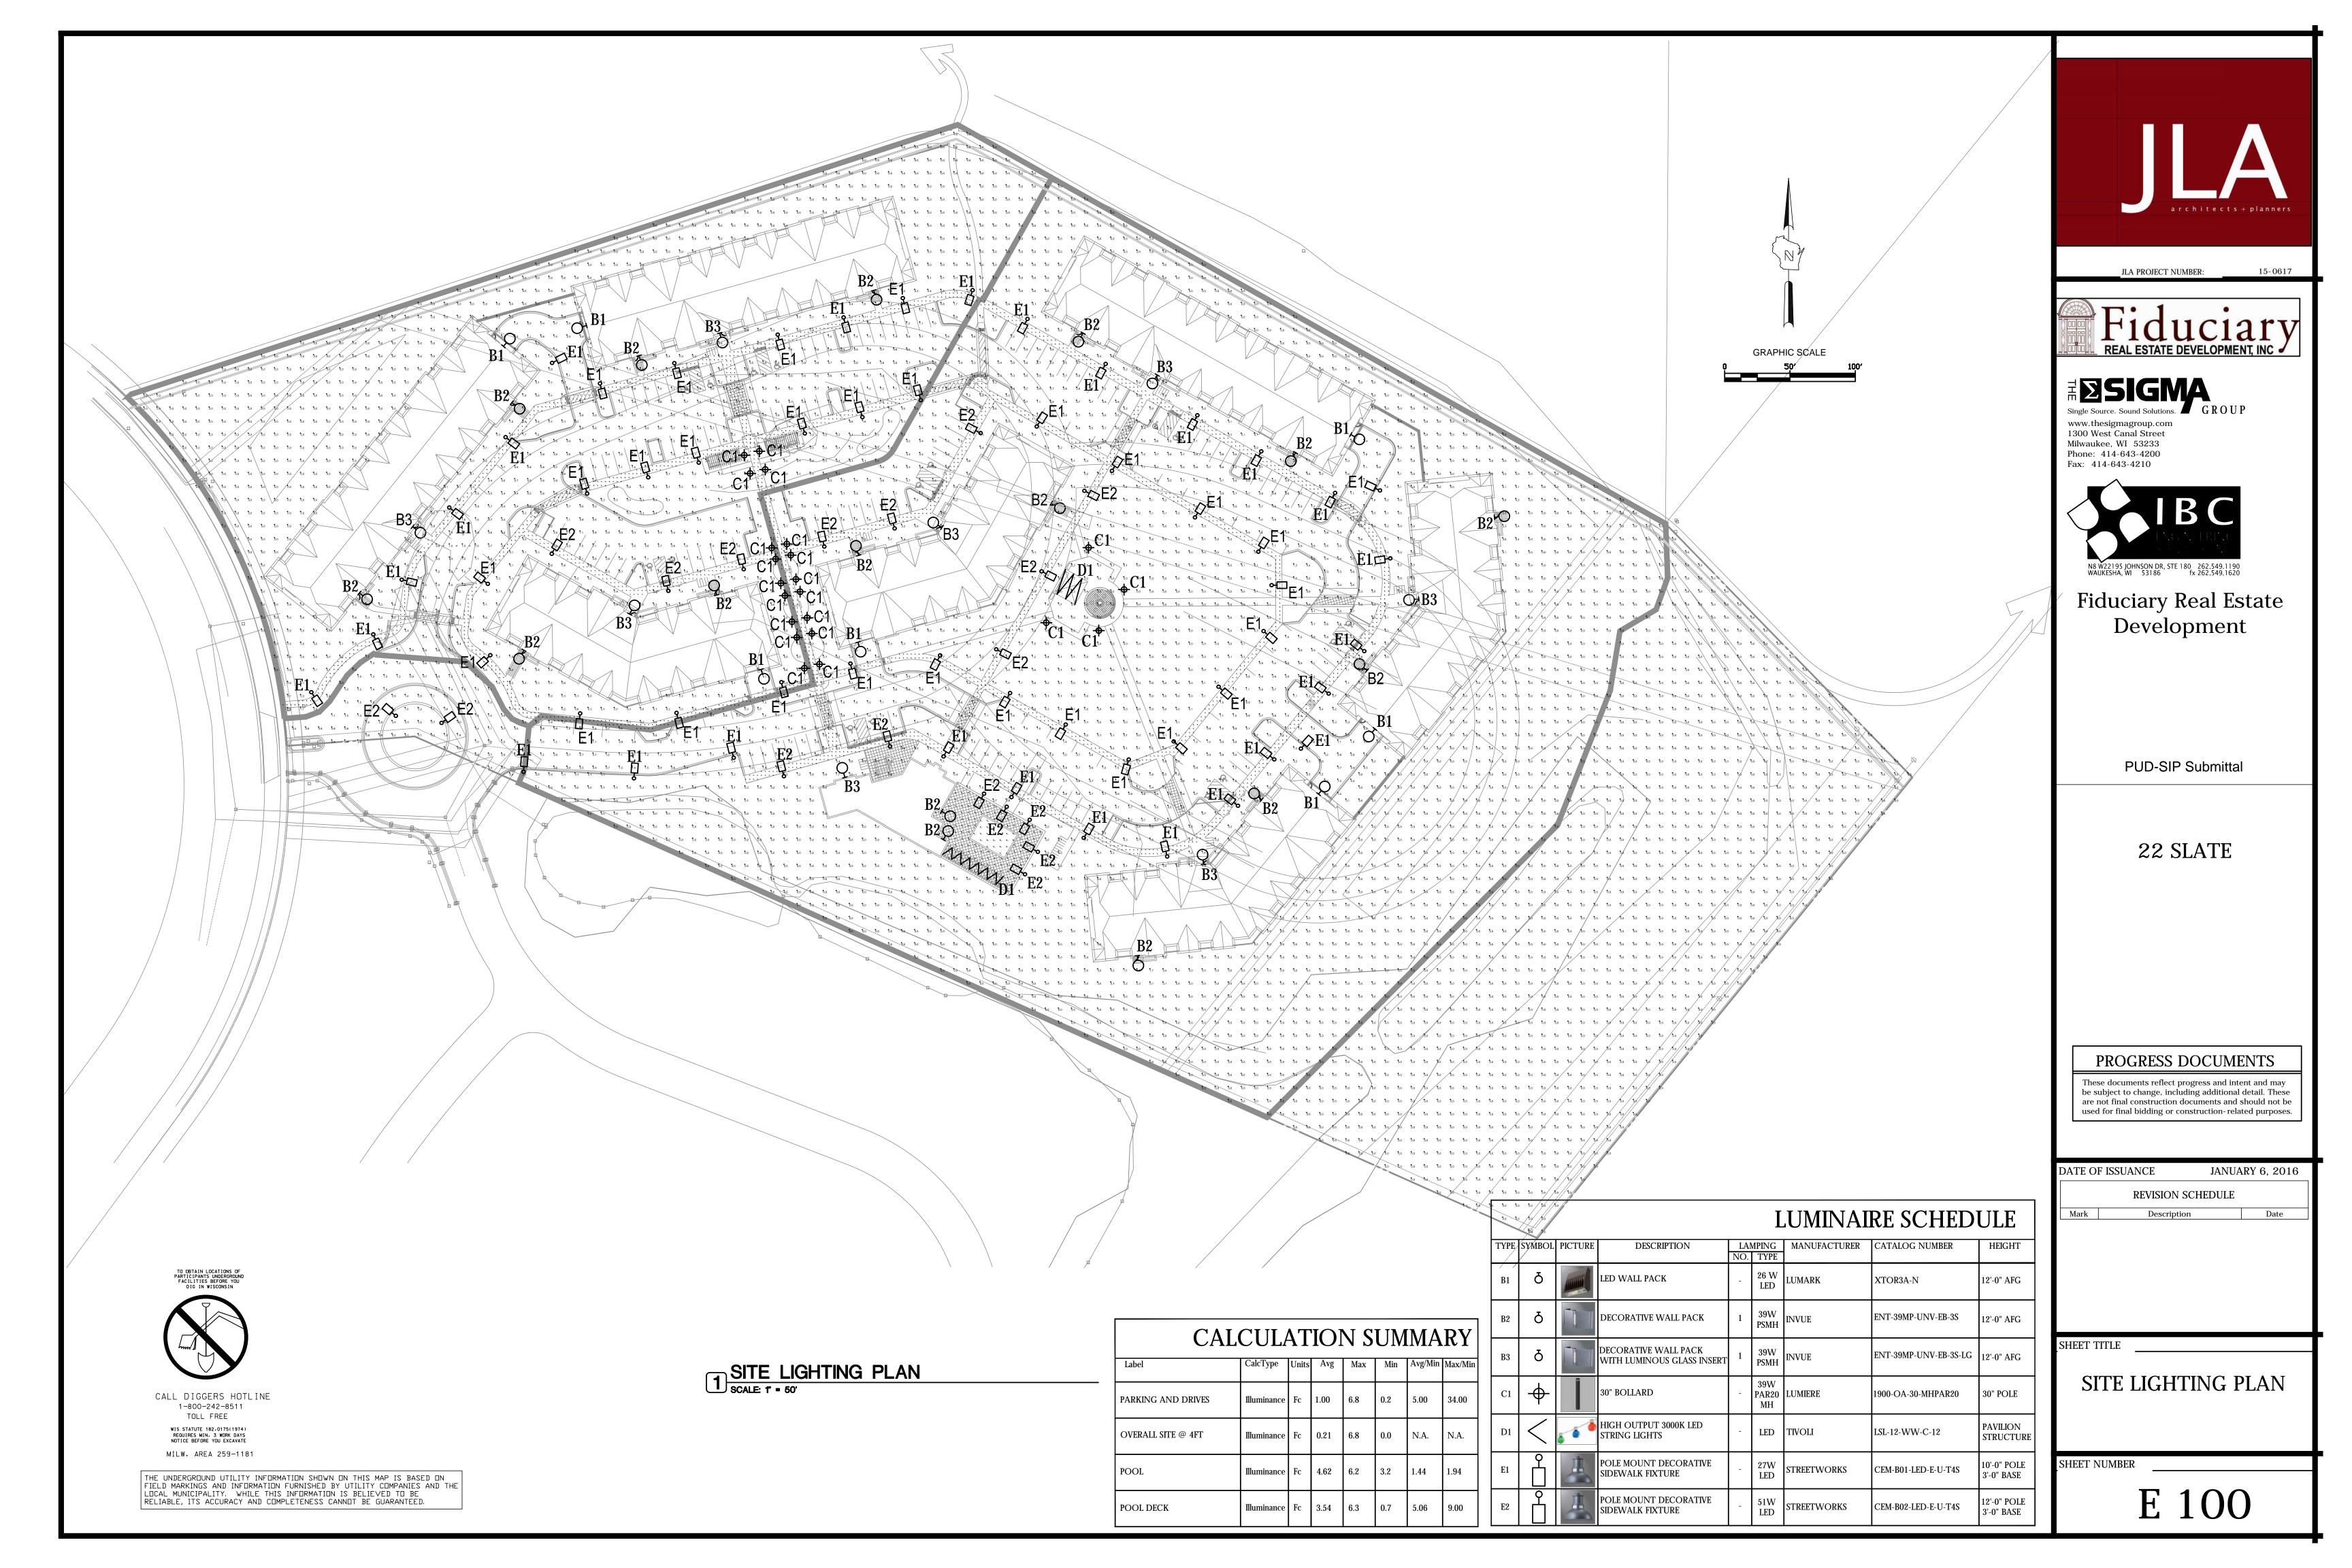

### DESCRIPTION

Lumark

TYPE B1

The patented Lumark Crosstour™ LED Wall Pack Series of luminaries provides an architectural style with super bright, energy efficient LEDs. The low-profile, rugged die-cast aluminum construction, universal back box, stainless steel hardware along with a sealed and gasketed optical compartment make the Crosstour impervious to contaminants. The Crosstour wall luminaire is ideal for wall/surface, inverted mount for façade/canopy illumination, post/bollard, site lighting, floodlight and low level pathway illumination including stairs. Typical applications include building entrances, multi-use facilities, apartment buildings, institutions, schools, stairways and loading docks test.

Catalog #	Туре
Project	
Comments	Date
Prepared by	

### SPECIFICATION FEATURES

### Construction

DIMENSIONS

Slim, low-profile LED design with rugged one-piece, die-cast aluminum hinged removable door and back box. Matching housing styles incorporate both a small and large design. The small housing is available in 7W and 18W. The large housing is available in the 26W model. Patent pending secure lock hinge feature allows for safe and easy tool-less electrical connections with the supplied push-in connectors. Back box includes three (3) half-inch, NPT threaded conduit entry points. The universal back box supports both the small and large forms and mounts to standard 3-1/2" to 4" round and octagonal, 4" square, single gang and masonry junction boxes. Key hole gasket allows for adaptation to junction box or wall. External fin design extracts heat from the fixture surface. Onepiece silicone gasket seals door and back box. Minimum 5" wide pole for site lighting application. Not recommended for car wash applications.

### Optical

Silicone sealed optical LED chamber incorporates a custom engineered mirrored anodized reflector providing high-efficiency illumination. Optical assembly includes impact-resistant tempered glass and meets IESNA requirements for full cutoff compliance. Solid state LED Crosstour luminaries are thermally optimized with five (5) lumen packages in cool 5000K or neutral warm 3500K LED color temperature Electrical LED driver is mounted to the die-cast housing for optimal heat

sinking. LED thermal management system incorporates both conduction and natural convection to transfer heat rapidly away from the LED source. 7W models operate in -40°C to 40°C [-40°F to 104°F]. 18W and 26W models operate in -40°C to 40°C [-40°F to 104°F]. High ambient 50°C models available. Crosstour luminaires maintain greater than 90% of initial

**ESCUTCHEON PLATES** 

light output after 72,000 hours of operation. Three (3) half-inch NPT threaded conduit entry points allow for thru-branch wiring. Back box is an authorized electrical wiring compartment. Integral LED electronic driver incorporates surge protection. 120-277V 50/60Hz or 347V 60Hz models.

#### Finish

Crosstour is protected with a Super durable TGIC carbon bronze or summit white polyester powder coat paint. Super durable TGIC powder coat paint finishes withstand extreme climate conditions while providing optimal color and gloss retention of the installed life.

#### Warranty


Five-year warranty.



### **XTOR CROSSTOUR LED**

APPLICATIONS: WALL / SURFACE POST / BOLLARD LOW LEVEL FLOODLIGHT INVERTED SITE LIGHTING

### 7W & 18W 6-3/4" [171mm 8" [203mm] 7W & 18W 7W & 18W 5-3/4" [146mm] 3-5/8" [92mm] 6-5/8" [168mm] 4" [102mm]

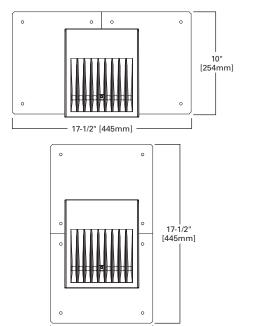

– 10" [254mm] ·



### CERTIFICATION DATA

UL/cUL Wet Location Listed LM79 / LM80 Compliant **ROHS** Compliant ADA Compliant NOM Compliant Models IP66 Ingressed Protection Rated Title 24 Compliant DesignLights Consortium® Qualified\*

### TECHNICAL DATA

40°C Maximum Ambient Temperature External Supply Wiring 90°C Minimum

Effective Projected Area (Sq. Ft.): XTOR1A/XT0R2A=0.34 XTOR3A=0.45

#### SHIPPING DATA: Approximate Net Weight:

3.7 - 5.25 lbs. [1.7 - 2.4 kgs.]



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### LUMEN MAINTENANCE

Ambient Temperature	TM-21 Lumen Maintenance (72,000 Hours)	Theoretical L70 (Hours)			
XTOR1A Model					
25°C	> 92%	> 290,000			
40°C	> 92%	> 290,000			
50°C	> 91%	> 270,000			
XTOR2A Model					
25°C	> 91%	> 270,000			
40°C	> 90%	> 260,000			
50°C	> 88%	> 225,000			
XTOR3A Model					
25°C	> 91%	> 280,000			
40°C	> 91%	> 270,000			
50°C	> 89%	> 240,000			

### **CURRENT DRAW**

Valtana	Model Series				
Voltage	XTOR1A	XTOR2A	XTOR3A		
120V	0.05A	0.15A	0.22A		
208V	0.03A	0.08A	0.13A		
240V	0.03A	0.07A	0.11A		
277V	0.03A	0.06A	0.10A		
347V	0.025A	0.058A	0.082A		

### LUMENS - CRI/CCT TABLE

LED Information	XTOR1A	XTOR2A	XTOR2A-N	XTOR3A	XTOR3A-N
Delivered Lumens (Wall Mount)	722	1,633	1,523	2,804	2,284
Delivered Lumens (With Flood Accessory Kit) <sup>1</sup>	468	1,060	978	2,168	1,738
B.U.G. Rating <sup>2</sup>	B0-U0-G0	B1-U0-G0	B1-U0-G0	B1-U0-G0	B1-U0-G0
CCT (Kelvin)	5,000	5,000	3,500	5,000	3,500
CRI (Color Rendering Index)	65	65	70	65	70
Power Consumption (Watts)	7W	18W	18W	26W	26W

NOTES: 1 Includes shield and visor. 2 B.U.G. Rating does not apply to floodlighting.

### ORDERING INFORMATION

### Sample Number: XTOR2A-N-WT-PC1

Series 1	LED Kelvin Color	Housing Color	Options (Add as Suffix)	Accessories (Order Separately)
XTOR1A=Small Door, 7W XTOR2A=Small Door, 18W XTOR3A=Small Door, 26W	[Blank]=Bright White (Standard) 5000K N=Neutral Warm White, 3500K <sup>2</sup>	[Blank]=Carbon Bronze (Standard) WT=Summit White TBD	PC1=Photocontrol 120V <sup>3</sup> PC2=Photocontrol 208-277V <sup>3,4</sup> 347V=347V <sup>5</sup> HA=50°C High Ambient <sup>5</sup>	WG/XTOR=Wire Guard <sup>6</sup> XTORFLD-KNC=Knuckle Floodlight Kit <sup>7</sup> XTORFLD-TRN=Trunnion Floodlight Kit <sup>7</sup> XTORFLD-KNC-WT=Knuckle Floodlight Kit, Summit White <sup>7</sup> XTORFLD-TRN-WT=Trunnion Floodlight Kit, Summit White <sup>7</sup> EWP/XTOR=Escutcheon Wall Plate, Carbon Bronze EWP/XTOR-WT=Escutcheon Wall Plate, Summit White

NOTES: 1 DesignLights Consortium® Qualified. Refer to www.designlights.org Qualified Products List under Family Models for details. 2 XTOR1A not available in 3500K. 3 Photocontrols are factory installed. 4 Order PC2 for 347V models. 5 Thru-branch wiring not available with HA option or with 347V. 6 Wire guard for wall/surface mount. Not for use with floodlight kit accessory. 7 Floodlight kit accessory supplied with knuckle (KNC) or trunnion (TRN) base, small and large top visors and small and large impact shields.

### STOCK ORDERING INFORMATION

7W Series	18W Series	26W Series	
XTOR1A=7W, 5000K, Carbon Bronze	XTOR2A=18W, 5000K, Carbon Bronze	XTOR3A=26W, 5000K, Carbon Bronze	
XTOR1A-WT=7W, 5000K, Summit White	XTOR2A-N=18W, 3500K, Carbon Bronze	XTOR3A-N=26W, 3500K, Carbon Bronze	
XTOR1A-PC1=7W, 5000K, 120V PC, Carbon Bronze	XTOR2A-WT=18W, Summit White	XTOR3A-WT=26W, Summit White	
	XTOR2A-PC1=18W, 120V PC, Carbon Bronze	XTOR3A-PC1=26W, 120V PC, Carbon Bronze	

### 5-DAY QUICK SHIP ORDERING INFORMATION

7W Series	18W Series	26W Series	
XTOR1A-WT-PC1=7W, 5000K, Summit White, 120V PC	XTOR2A-PC2=18W, 5000K, 208-277V PC, Carbon Bronze	XTOR3A-PC2=26W, 5000K, 208-277V PC, Carbon Bronze	
	XTOR2A-WT-PC1=18W, 5000K, Summit White, 120V PC	XTOR3A-WT-PC1=26W, 5000K, Summit White, 120V PC	
	XTOR2A-WT-PC2=18W, 5000K, Summit White, 208-277V PC	XTOR3A-WT-PC2=26W, 5000K, Summit White, 208-277V PC	
	XTOR2A-N-WT=18W, 3500K, Summit White	XTOR3A-N-WT=26W, 3500K, Summit White	
	XTOR2A-N-PC1=18W, 3500K, 120V PC, Carbon Bronze	XTOR3A-N-PC1=26W, 3500K, 120V PC, Carbon Bronze	
	XTOR2A-N-PC2=18W, 3500K, 208-277V PC, Carbon Bronze	XTOR3A-N-PC2=26W, 3500K, 208-277V PC, Carbon Bronze	
	XTOR2A-N-WHT-PC1=18W, 3500K, Summit White, 120V PC	XTOR3A-N-WHT-PC1=26W, 3500K, Summit White, 120V PC	
	XTOR2A-N-WT-PC2=18W, 3500K, Summit White, 208-277V PC	XTOR3A-N-WT-PC2=26W, 3500K, Summit White, 208-277V PC	




Eaton
1121 Highway 74 South
Peachtree City, GA 30269
P: 770-486-4800
www.eaton.com/lighting
Specifications and
dimensions subject to
change without notice.

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XTOR CROSSTOUR LED



ENTRI Series' family of modular faceplate designs provide a tasteful architectural statement equally suitable for indoor and outdoor environments. Available luminous faceplate window adds a signature look, while affording custom color capability.

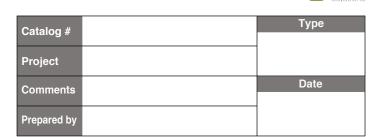

### SPECIFICATION FEATURES

#### Construction

HOUSING: One piece die-cast aluminum construction for precise tolerance control and repeatability in manufacturing. Accommodates either up or down mounting configurations with no modifications. Downlight and uplight lens' are impact resistant 5/32" thick tempered clear or frosted flat glass, sealed to the housing with high strength VHB adhesive tape and a continuous silicone bead gasket. Silicone wireway plug on housing back wall seals incoming electrical leads to prevent moisture and dust entry. FACEPLATE: One piece die-cast aluminum faceplate utilizes a continuous silicone gasket to seal securely to housing. Side hinged faceplate swings open via release of one (1) flush mount die-cast aluminum latch on housing side panel. Available luminous glass insert is .16" thick frosted glass, secured to back of faceplate with a continuous EPDM gasket, Available colored gel film secures behind glass.

#### **Electrical**

**ELECTRICAL COMPONENTS:** Ballast and related electrical componentry are heat sunk to the housing for cooler operation and prolonged life.

Optical OPTICAL SYSTEM: Choice of ten (10) high efficiency optical systems constructed of premium 95% reflective anodized aluminum sheet, or bright specular anodized polished spun aluminum. Available distributions include Type III, Type III with 10% secondary glow, Type III with pencil secondary, Forward Throw, Forward Throw with 10% secondary glow, Forward Throw with pencil secondary, FX grazing optic, FXF 50% up/50% down grazing optic, Tight Spot, and 50% up/50% downTight Spot. Optical segments are rigidly mounted inside a heavy wall aluminum housing for superior protection. All segment faces are clean of rivet heads, tabs, or other means of attachment which may cause streaking in the light distribution. All reflector modules feature quick disconnect wiring plugs. T6 Pulse Start Metal Halide lamps feature G12 lampholders, WhiteSon(TM) High Pressure Sodium lamp features a GX12 lampholder,

Quartz Halogen lamps feature minican screw based lampholders, and Compact Fluorescent lamps feature GX24q-(3,4,5) 4-pin lampholders.

#### Mounting

Standard zinc plated attachment plate mounts directly to 4" J-Box. Fixture slides over mounting plate and is secured with two (2) concealed stainless steel fasteners. Mounting plate features one-piece, EPDM gasket on back side of plate to firmly seal fixture to wall surface, forbidding entry of moisture and particulates. Optional mounting arrangements utilize a die-cast aluminum adapter box to allow for surface conduit wiring, quartz lamp options, and emergency battery pack capability.

#### Finish

Housing finished in a 5 stage premium TGIC polyester powder coat paint, 2.5 mil nominal thickness for superior protection against fade and wear. Standard colors include black, bronze, grey, white, dark platinum, and graphite metallic. RAL and custom color matches available. Consult your **INVUE Lighting Systems** Representative for more information.




### **ENTRI TRIANGLE REVEALS**

TYPES B2, B3

26 - 250W Pulse Start Metal Halide Whiteson High Pressure Sodium **Compact Fluorescent** Quartz Halogen

> **ARCHITECTURAL** WALL LUMINAIRE

### DIMENSIONS

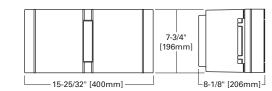

### WATTAGE TABLE

Lamp Type	Wattage
Pulse Start Metal Halide (MP)	39, 70, 100, 150W
WhiteSON HPS (WS)	100W
Compact Fluorescent (CF)	(1) 26, (2) 26, (1) 32, (2) 32, (1) 42, (2) 42, (1) 57 W
Quartz Halogen (HL)	100, 150, 250W



### CERTIFICATION DATA

IP66 Rated U.L. 1598 Listed CSA Listed 40°C Ambient Temperature Rating ISO 9001 Full Cutoff (In downlight only

configurations with no faceplate window)

#### SHIPPING DATA (Approximate)

Net Weight (lbs.): 13 Volume (cu. ft): 4.5





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### **ENT** ENTRITRIANGLE REVEALS

### ORDERING INFORMATION

Sample Number: ENT-150-MH-120-EB-3S-BK-LG-L Lamp Wattage Accessories 20 Product Family Voltage <sup>8</sup> Optical System Optional Luminous Faceplate Insert ENT=ENTRI 120=120V Downlight or Uplight (HID or Halogen) VA2001-XX=Thru-way Box16 Triangle Reveals **39**=39W 3S=Type III LG=Luminous Glass Insert VA2002=Wire Guard Kit 208=208V LGO=Luminous Glass Insert **70**=70W 240=240V FT=Forward Throw w/ Warm Orange Gel 100=100W FX=Wall Grazing Optic **277**=277V LGR: Luminous Glass Insert 150= 150W 347= 347V TS= Tight Spot Downlight and Uplight (HID and 480= 480V LGB: Luminous Glass Insert 100= 100W DT= Dual-Tap 9 w/ Bright Blue Gel 3SG= Type III, 90% Main/10% Secondary Compact Fluorescent wired 277V LGG: Luminous Glass Insert **26**= 26W MT= Multi-Tap 10 w/ Deep Green Gel 3SP= Type III with Pencil Secondary **32**= 32W wired 277V FTG= Forward Throw, 90% Main/10% 42= 42W TT: Triple-Tap 11 Options 14 Secondary Glow wired 347V F: Single Fuse (120, 277 or 347V) Specify Voltage 52= (2) 26W3 FTP: Forward Throw with Pencil UNV= 120-277\ FF= Double Fuse (208, 240 or 480V) Specify Voltage 57= 57W4 Secondary DSAB: Dual Fluorescent Switching Control 64= (2) 32W3 FXF: Wall Grazing Optic, 50% Up/50% Electronic Ballast 84: (2) 42W3 QAB= Quartz Restrike Adapter Box16 TSF: Tight Spot, 50% Up/50% Down Ballast EMAB = Quartz Restrike w/ Delay Adapter Box (Also16 100= 100W Compact Fluorescent MB: Magnetic Strikes at Cold Start) CFG= 90% Main + 10% Secondary Glow 150= 150W EM/SCAB= Quartz Emergency Separate Circuit Adapter 16 CFM= 100% Main, Up or Downlighting 250= 250W EB= Electronic 12 Ballast CF/EMAB=Emergency Battery Backup Adapter Box16, 17 Color 13 Lamp Type PC=Button Type Photocontrol (Specify Voltage) BK=Black MP=Pulse Start Metal Halide WG=Wire Guard18 AP=Grey WS=WhiteSON High 6
Pressure Sodium FRM=Frosted Main Flat Glass BZ=Bronze TBD FRS=Frosted Secondary Flat Glass<sup>19</sup> CF=Compact Fluorescent7 WH=White L=Lamp Included (Standard for all Halogen lamps) DP=Dark Platinum **HL**=Quartz Halogen GM=Graphite Metallic

Notes: 1 All MP lamps are T6 envelope with G12 lamp base. All HPS lamps are T6 envelope with GX12 lamp base.

- 2 All 26/32/42/57W CF lamps feature a 4-pin lamp base. Available in CFM and CFG distributions only.
- 3 Dual compact fluorescent lamps.
- 4 Nominal M.O.L lamp length of 57W CFL not to exceed 7".
- 5 All Halogen lamps are T4 envelope with mini-can base.
- 6 WhiteSON HPS lamp available in 100W only. Requires electronic ballast. 120/277V only. Requires use of VA2001 accessory Thru-way Box.
- 7 CF ballasts are 120 through 277V. Specify with UNV voltage designation.
- 8 Products also available in non-US voltages and 50Hz for international markets. Consult factory for availability and ordering information
- 9 Dual-tap is 120/277V wired 277V.
- 10 Multi-tap is 120/208/240/277V wired 277V.
- 11 Triple-tap is 120/277/347V wired 347V.
- 12 120 through 277V only. Electronic ballast standard with all CF lamps. EB available with 39/70/100/150W MP lamps. 150W requires and is supplied with VA2001 Thru-way Box. Not available with QAB or EMAB options.
- 13 Custom and RAL color matching available upon request. Consult your INVUE Lighting Systems Representative for further information.
- 14 Add as suffix in the order shown.
- 15 Dual switching requires dual 26, 32 or 42W Compact Fluorescent lamps. Allows independent switching control of each lamp through use of two (2) electronic ballasts. Allows 50% power reduction when dual ballasts are independently wired and controlled.
- 16 VA2001 and thru-way adaptor box options to be mounted facing downward only. Cannot be used for primary "uplight only" applications.
- 17 CF lamps only. Battery backup provides 90 minutes of supplemental light, minimum operating temperature of 32°F (0°C), 42W maximum.
- 18 For use in down lighting applications only.
- 19 Frosted secondary lens provided standard on 3SG, FTG, and CFG distributions
- 20 Order separately, replace XX with color suffix.



NOTE: Specifications and dimensions subject to change without notice.

Visit our web site at www.cooperlighting.com

Customer First Center 1121 Highway 74 South Peachtree City, GA 30269 770.486.4800 FAX 770.486.4801

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#### DESCRIPTION

The Aspen 1900-OA bollard features a sleek, contemporary aesthetic and low glare fixed optics. Fixtures that utilize a metal halide lamp source include an integral core & coil ballast (electronic ballast optional); fixtures with a halogen source are available with integral or remote 12V transformer. Our patented LumaLevel" leveling system provides quick installation, easy adjustment, secure mounting and protection from vibration. Aspen bollards are available in two standard sizes.

Catalog #	Туре
Project	
Comments	Date
Prepared by	


### SPECIFICATION FEATURES

#### A ... Material

Housing is precision-machined from corrosion-resistant 6061-T6 aluminum extrusion. Mounting base is cast from corrosion-resistant silicone aluminum alloy.

### B ... Finish

Fixture and mounting base are double protected by a chromate conversion undercoating and polyester powdercoat paint finish, surpassing the rigorous demands of the outdoor environment.
Fixture housing is available in a variety of standard colors.
Mounting base is painted black.

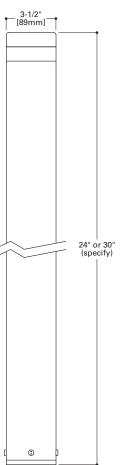

### C ... Lens

Lens is machined from solid U.V. stabilized clear acrylic and is designed to produce maximum light output with low brightness.

# **D** ... Adjustable Mounting Base Cast aluminum mounting base assembly is equipped with the

patented LumaLevel" leveling system that includes mounting chassis, 70 shore neoprene base, stainless steel hardware and 3/4" conduit entry. The LumaLevel" leveling system provides quick installation, easy adjustment, secure mounting and protection from vibration.

### E ... Anchor Bolts & Template

Three (3) 3/8" x 12" galvanized anchor bolts and a galvanized steel anchor bolt template are standard. Anchor bolts and template are available to ship in advance of fixture for rough-in purposes (specify option -LAB and order anchor bolts/template kit separately).

### F ... Hardware

Stainless steel hardware is standard to provide maximum corrosion-resistance.

### G ... Socket

MH39PAR20: Ceramic socket with 250° C Teflon® coated lead wires and medium base. 50MR16: Ceramic socket with 250° C Teflon® coated lead wires and GU5.3 bi-pin base.

#### H ... Electrical

MH39PAR20: Integral core & coil ballast is standard (120/208/240/277/347V). Rated for -20° C starting temperature. Integral electronic ballast (120/277V) is available (specify option -EL). 50MR16: 12V transformer required (not included). Remote transformer is available from Lumière as an accessory - see the Accessories & Technical Data section of this catalog for details. Integral 12V transformer is available as an option (specify option -IT).

### I ... Lamp

Not included. Available from Lumière as an accessory - see reverse side of this page.

### J ... Labels & Approvals

UL and cUL listed, standard wet label. Manufactured to ISO 9001-2000 Quality Systems Standard. IBEW union made.

### K ... Warranty

Lumière warrants its fixtures against defects in materials & workmanship for three (3) years. Auxiliary equipment such as transformers, ballasts and lamps carry the original manufacturer's warranty.



ASPEN
1900-OA
Open Aperture

39W (max.) PAR20 Metal Halide

50W (max.) MR16 Halogen Low Voltage

Bollard



Aspen 1900-OA


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PHOTOMETRIC DATA


ASPEN 1900-OA

 Aspen
 1900-OA-30-MHPAR20
 Lamp=MH39PAR20/FL
 Lumens=2000
 Aspen 1900-OA-24-50MR16
 Lamp=50MR16
 Lumens=950

### ISO Footcandle Plot

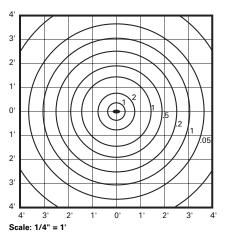

### ISO Footcandle Plot

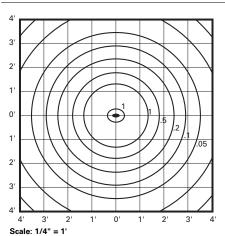

### LAMP INFORMATION

Lamp	ANSI Code	Watts	Beam Spread	CBCP	°K	Life (hrs.)	Base	Volts
CDM39PAR20/SP	M130KK-39	39	10°	23,000	3000	9000	medium	120-347
50MR16/NSP	EXT	50	12°	11,000	3050	4000	GU5.3 bi-pin	12

NOTE: Inferior quality lamps may adversely affect the performance of this product. Use only name brand lamps from reputable lamp manufacturers.

### NOTES AND FORMULAS

- Beam diameter is to 50% of maximum footcandles, rounded to the nearest half-foot.
- Footcandle values are initial. Apply appropriate light loss factors where necessary.



Specifications and Dimensions subject to change without notice.

Lumiere • Customer First Center • 1121 Highway 74 South • Peachtree City, GA 30269 • TEL 770.486.4800 • FAX 770.486.4801

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### Litesphere™ LED Strand



CAT:		FEET:
TYPE:	PROJECT:	

PROJECT:



Energy-efficient, low voltage strand lighting using wedge-base LED lamps protected by clear, frosted or colored polycarbonate globes.

- Flexible 16AWG. cord available in Black or White with matching
- Shatterproof, polycarbonate, O-ring fitted globes protect lamps with clarity and seamless appearance.
- Socket is parallel wired and permanently fixed to cord.
- Field cuttable.

### Mounting

Each Socket has mounting holes for screw attachment in under-eve applications. Use 1/8" stainless steel wire cable (by others) and hanger clips for festoon applications.

### **Applications**

Ideal for indoor and outdoor applications.

### Warranty

3 years

### **Technical Information**

Lamp Spacing	6" O.C.	12″ O.C.	18" O.C. 24" O.C					
*Lumens/ft(STD)	8	4	3	2				
*Lumens/ft (HO)	24	12	9	6				
*Watts/ft (STD)	0.2	0.1	0.08	0.05				
*Watts/ft (HO)	0.52	0.26	0.20	0.13				
*Lumens/watt* (STD)	40	40	40	40				
*Lumens/watt (HO)	46	46 46 46 46						
CRI		> 80/TYP83						
LED Colors		1900°K, 2700°K, , 3000°K, 3500°K, 4000°K (+/- 80°K) 3SDCM White (4200°K), Warm White (2800°K)						

75,000 hr.

12V DC

Class II


Ordering Increment

Operating Voltage

Rated Life

**Profile Dimensions** 



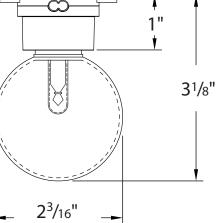

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Power Supply \* 3000°K Sample

### **12V** Litesphere<sup>™</sup> LED Strand




### **Recommended Power Supplies**

CAT NO	APPLICATION	PRIMARY AND SECONDARY	TOTAL WATTAGE / AMPS PER BREAKER	LISTING	DIMENSIONS	ELECTRONIC OR AC MAGNETIC
ADNM-80-1-5-12-D		120-277V AC / 12V DC	60W / 1X5A	cULus	12"W X 12"L X 4"D	Electronic
ADNM-150-2-5-12-D		120-277V AC / 12V DC	120W / 2X5A	cULus	12"W X 12"L X 4"D	Electronic
ADNM-240-3-5-12-D	Outdoor	120-277V AC / 12V DC	180W / 3X5A	cULus	12"W X 12"L X 4"D	Electronic
ADNM-320-4-5-12-D		120-277V AC / 12V DC	240W / 4X5A	cULus	12"W X 12"L X 4"D	Electronic
ADUL-80-1-5-12-D		120-277V AC / 12V DC	60W / 1X5A	UL/ETL/CSA	10"W X 10"L X 4"D	Electronic
ADUL-150-2-5-12-D		120-277V AC / 12V DC	120W / 2X5A	UL/ETL/CSA	10"W X 10"L X 4"D	Electronic
ADUL-240-3-5-12-D	Indoor	120-277V AC / 12V DC	180W / 3X5A	UL/ETL/CSA	10"W X 10"L X 4"D	Electronic
ADUL-320-4-5-12-D		120-277V AC / 12V DC	240W / 4X5A	UL/ETL/CSA	10"W X 10"L X 4"D	Electronic
MT-60-1-5-12-D	l= d= = = (O : t d= = =	120V AC / 12V DC	60W / 1X5A	cULus	2.50"W X 12.32"L X 1.56"D	Electronic
MT-60-1-5-12-DD	Indoor/Outdoor	120V AC / 12V DC	60W / 1X5A	cULus	2.50"W X 12.32"L X 1.56"D	Electronic
JT-60-1-5-12-D		120V AC / 12V DC	60W / 1X5A	cETLus	4.25"W X 8.50"L X 3.25"D	Magnetic
JTH-60-1-5-12-D	Indoor/Outdoor	277V AC / 12V DC	60W / 1X5A	cETLus	4.25"W X 8.50"L X 3.25"D	Magnetic
JT-240-4-5-12-D	Indoor/Outdoor	120V AC / 12V DC	240W / 4X5A	cETLus	8.50"W X 16.00"L X 4.50"D	Magnetic
JTH-240-4-5-12-D		277V AC / 12V DC	240W / 4X5A	cETLus	8.50"W X 16.00"L X 4.50"D	Magnetic


### Ordering Information



### Wiring Accessories

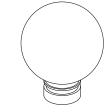


REPLACEMENT GLOBES LS-OG LS-OG Clear **LS-FG** Orange LS-GG Frosted LS-YG Green **LS-BG** Yellow LS-RG Blue **LS-PG** 

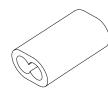

LS-EC-BK Black end cap LS-EC-WH White end cap



LS-HANG-CLIP Hanger clip for installation from 8 gauge stainless steel aircraft cable

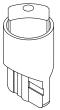

Blue LSL-GR-F-12

REPLACEMENT LEDS LSL-BL-F-12 LSL-YL-F-12 Yellow LSL-WH-F-12 Green LSL-RD-F-12 White LSL-WW-F-12

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#### DESCRIPTION

The EPIC Collection delivers custom luminaire flexibility with high quality, yet availability expectations of standard specification grade product. The EPIC Collection can be dressed to suit any application. Recognizing evolving environmental and legislative trends, EPIC Collection delivers world class LED optical and performance solutions to the decorative luminaire marketplace.

## TYPES E1, E2 **STREETWORKS**

Catalog #	Туре
outulog #	
Project	
Comments	Date
Prepared by	

### SPECIFICATION FEATURES

### Construction

TOP: Cast aluminum classical top housing maintains a nominal 1/8" sidewall thickness. Top attaches to cast aluminum mounting arm hub with four (4) stainless steel fasteners. One (1) piece silicone gasket between mounting hub and top casting seals out moisture and contaminants. MIDSECTION: Continuous silicone gaskets seal lens to top casting and shade. The mid-section options feature cast aluminum construction and stainless steel assembly hardware. SHADES: Heavy-gauge precision spun aluminum shades offer superior surface finish and consistency in form. DOORFRAME: Die-cast aluminum 1/8" thick door and doorframe seal to underside of shade with a thick wall continuous silicone gasket. Mounting hub ships attached to mounting arm.

### Optics

DISTRIBUTION: Choice of thirteen (13) patented, highefficiency AccuLED Optics™, that maximize light collection and

directional distribution onto the application region. Each optical lens is precision manufactured via injection-molding, then precisely arranged and sealed on the board media. LEDs: High output LEDs, 50,000+ hours life at >70% lumen maintenance, offered standard in 4000° K (+/- 275K) CCT and nominal 70 CRI.

#### **Electrical**

**ELECTRICAL TRAY: Driver and** related electrical componentry are mounted to one-piece tray. Quick disconnect wiring plugs allow for tray removal during routine maintenance. DRIVER: LED drivers are potted and heat sunk for optimal performance and prolonged life. Standard drivers feature electronic universal voltage (120-277V/50-60hz), greater than 0.9 power factor, less than 20% harmonic distortion and feature ambient temperature range of +40°C (104°F) down to minimum starting temperature of -30°C (- 22°F). Shipped standard with Cooper Lighting proprietary circuit

module designed to withstand 10kV of transient line surge. All LED LightBARs™ and drivers are mounted to dedicated mounting trays and are easily replaced by use of quick disconnects for ease of wiring.

Housing is finished in 5 stage Super TGIC polyester powder coat paint, 2.5 mil nominal thickness for superior protection against fade and wear. Standard colors include black, bronze, grey, white, dark platinum and graphite metallic. RAL and custom color matches available. Consult Outdoor Architectural Colors brochure for a complete selection. LightBAR™ cover plates are standard white and may be specified to match finish of luminaire housing.

### Warranty

CEM LED features a five-year limited warranty.



### **CEM CLASSICAL EPIC MEDIUM LED**

1 - 4 LightBARs Solid State LED


DECORATIVE AREA



### DIMENSIONS

**COOPER** Lighting

www.cooperlighting.com

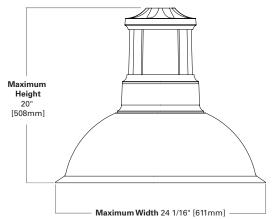

NOTE: See configurations for more detailed information.

### CERTIFICATION DATA

UL/cUL Listed ISO 9001 IP66 LightBARs ARRA Compliant LM79 / LM80 Compliant 3.5G Vibration Tested

### **ENERGY DATA**

**Electronic LED Driver** >0.9 Power Factor <20% Total Harmonic Distortion 120-277V/50 & 60hz, 347V/60hz, 480V/60hz -30°C Minimum Temperature

40°C Ambient Temperature Rating

### EPA

Effective Projected Area: (Sq. Ft.)

SHIPPING DATA **Approximate Net Weight:** 



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CEM CLASSICAL EPIC MEDIUM LED

### POWER AND LUMENS BY BAR COUNT

	DISTRIBUTION														
Number of LightBARs	Power [Watts]	Current @ 120V [A]	Current @ 277V [A]	T2A	ТЗА	T3S	T4S	SL2	SL3	SL4	5МΩ	5WQ	5XQ	RWQ	SLR/ SLL
7 LED LIGHTBAR															
C01	27	0.23	0.13	1,873	1,866	1,814	1,817	1,836	1,756	1,807	1,937	1,907	1,911	1,847	1,704
C02	54	0.46	0.21	3,716	3,701	3,600	3,605	3,642	3,485	3,585	3,843	3,783	3,792	3,665	3,380
C03	77	0.65	0.29	5,475	5,453	5,303	5,311	5,366	5,134	5,282	5,661	5,573	5,586	5,399	4,980
C04	101	0.86	0.37	7,282	7,253	7,054	7,064	7,137	6,829	7,026	7,530	7,413	7,430	7,181	6,624
						E1_21	LED LIGHT	ΓBAR							
B01	<mark>27</mark>	0.23	0.13	2,304	2,295	2,232	2,235	2,258	2,160	2,223	2,382	2,345	2,351	2,272	2,096
B02	51	0.43	0.20	4,571	4,553	4,428	4,434	4,480	4,286	4,410	4,726	4,653	4,664	4,508	4,158
B03	73	0.62	0.28	6,734	6,707	6,523	<b>6,533</b>	6,600	6,315	6,497	6,963	6,855	6,871	6,641	6,125
B04	95	0.81	0.35	8,957	8,921	8,676/	8,689	8,779	8,399	8,642	9,262	9,118	9,139	8,833	8,148
						E2/							LUMEN	MULTIP	LIER

### LUMEN MULTIPLIER


Ambient Temperature	Lumen Multiplier
10°C	1.04
15°C	1.03
25°C	1.00
40°C	0.96


Height from ceiling equals calculated height of fixture plus pendant length and 7/8"


### PRODUCT CONFIGURATION






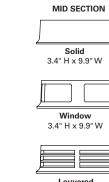

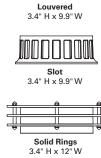

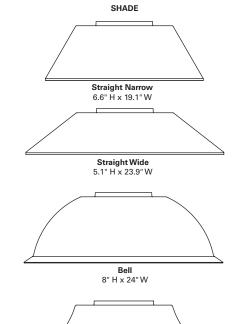

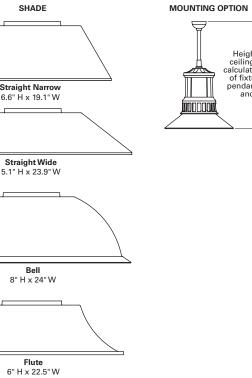



NOTE: Specifications and dimensions subject to change without notice. Visit our web site at www.cooperlighting.com Customer First Center 1121 Highway 74 South Peachtree City, GA 30269 770.486.4800 FAX 770.486.4801

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CEM CLASSICAL EPIC MEDIUM LED

### ORDERING INFORMATION

Sample Number: CEMB04LEDUT2A4FLBK2L Product Family 1.2 Mid-Section Type Accessories 12 Voltage Shade Type SA6158-XX=Traditional Single Pole Mount Arm CEM=Classic Epic Medium **U**=Universal (120-277V) **x**=Solid Standard SN=Straight Narrow **sw**=Straight Wide SA6159-XX=Traditional Single Pole Mount Arm with Rounded Upper Bar 1=Window 8=480V Number of Lightbars 3.4 **9**=347V 2=Louvered BL=Bell SA6160-XX=Traditional Single Pole Mount Arm with16
Rounded Lower Bar B01=[1] 21 LED LightBAR FL=Flute 3=Slot B02= [2] 21 LED LightBARs Distribution SA6161-XX= Traditional Single Pole Mount Arm with 45 Degree Upper Bar 4= Solid Rings B03= [3] 21 LED LightBARs T2A= Type II Finish 5 SA6162-XX= Traditonal Single Pole Mount Arm with 4516 Degree Lower Bar B04: [4] 21 LED LightBARs T3A= Type III RK: Black **TBD** SA6163-XX: Traditional Single Pole Mount Arm with 45 Degree Upper Straps C01: [1] 7 LED LightBAR T3S: Type III Short AP≕ Grey C02= [2] 7 LED LightBARs T4S: Type IV Short BZ= Bronze SA6165-XX= Traditional Twin Pole Mount Arm C03= [3] 7 LED LightBARs RWQ: Rectangular Wide **WH**= White SA6166-XX: Traditional Twin Pole Mount Arm with Rounded Upper Bars C04= [4] 7 LED LightBARs 5MQ: Type V Square DP= Dark Platinum SA6167-XX= Traditional Twin Pole Mount Arm with 16 Rounded Lower Bars GM= Graphite Metallic 5WQ: Type V Square Wide Lamp Type GN= Hartford Green SA6168-XX= Traditional Twin Pole Mount Arm w/45 Degree Upper Bars **5MR**: Type V Round Medium LED= Solid State Light Emitting Diodes Options <sup>6</sup> SA6169-XX: Traditional Twin Pole Mount Arm with 4516 Degree Lower Bars 5WR: Type V Round Wide 2L= Two Circuits7 Ballast Type SA6170-XX= Traditional Twin Pole Mount Arm with 45
Degree Upper Straps 5XQ= Type V Square Extra LCF: LightBAR Cover Plate E= Electronic Matches Housing Finish SA6171-XX= ECM Mast Arm Adapter SLL= 90 Degree Spill Light Eliminator Left 7060= 70 CRI 6000K8 OA/RA1016= NEMA Photocontrol - Multi-Tap 8030= 80 CRI 3000K8 SLR=90 Degree Spill Light Eliminator Right Accessory Options 13 PM48=Pendant Mount 9 V=Victorian Finial14 48" Length M=Modern Finial14 DesignLights™ Consortium Qualified. Refer to www.designlights.org Qualified Products List under Family Models for MS-LXX=Motion Sensor for 10 A=Architectural Finial14 On/Off operation Arm not included. Must be used with Streetworks brand arms. See Accessories. N=Nostalgic Finial14 MS/X-LXX=Motion Sensor11 21 LED LightBAR powered at 350mA, 7 LED LightBAR powered at 1A. 4=NEMA Twistlock Photocontrol Recptacle15 for Bi-Level Standard 4000K CCT and nominal 70 CRI. Switching Cutsom and RAL color matching available upon request. Consult your Cooper Lighting Representative for further MS/DIM-LXX=Motion Sensor for Dimming Add as suffix in the order shown. Operation Low-level output varies by bar count. Requres quantity of two or more LightBARs. Consult factory. Consult factory for lead times and lumen multiplier. Minimum pendant length is 9.5". For lengths above 48", consult Streetworks Lighting Systems representative. Includes 3/4" pendant pipe in specified length, swivel hanger and canopy cover. Swivel under canopy uses 3/4" NPT thread; fixture head uses 3/4" NPSM; 3-3/4" long thread. "PM" option must be used with Streetworks Pendant Kit only.

Sensor housed in external box mounted to luminaire. Available in B02 - B04 and C02 - C04 configurations. Replace XX with mounting height in feet for proper lens selection. (i.e., MS-L20). Consult factory for additional information.
 Motion sensor for bi-level switching. Sensor housed in external box mounted to luminaire. Available in B02 - B04 and C02 - C04 configurations. Replace X with the number of bars and XX with fixture mounting height in feet (i.e., MS/3-L20). Consult factory for additional information.

Order separately/replace XX with color suffix.
 Add as suffix to accessory. Example: SA6158-BK-R.
 Finials compatible with Traditional Arms only.

16 Requires use of 4" O.D. round straight pole.

15 Not compatible with finials, wall mount bishop arms or pendant mounting.



NOTE: Specifications and dimensions subject to change without notice.

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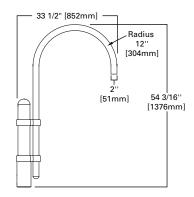
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### **DECORATIVE**

## **EPIC COLLECTION ARMS**

DECORATIVE AREA COLLECTION


### ARMS SPECIFICATIONS



### **BISHOP SINGLE POLE MOUNT ARM**

[SA6105, SA6154, SA6005, SA6054] Slipfits over 4" round straight pole, or 4" 0.D. by 6" tall tenon.

Weight: 24 lbs. E.P.A: .92

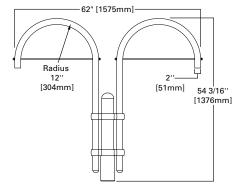


### **BISHOP TWIN POLE MOUNT**

ARM WITH CROSS RODS

[SA6108, SA6157, SA6008, SA6057] Slipfits over 4" round straight pole, or 4" 0.D. by 6" tall tenon.


Weight: 39 lbs. E.P.A: 1.55

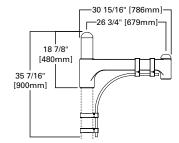

### TRADITIONAL SINGLE POLE MOUNT ARM WITH ROUNDED LOWER BAR

[SA6111, SA6160, SA6011, SA6060] Slipfits over 4" round straight pole. Requires use of 4" O.D. Round Straight Pole


Weight: 25 lbs. E.P.A: 1.16

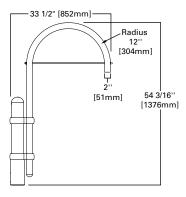

### **BISHOP SINGLE POLE MOUNT ARM** WITH CROSS ROD

[SA6106, SA6155, SA6006, SA6055] Slipfits over 4" round straight pole, or 4" 0.D. by 6" tall tenon.

Weight: 25 lbs. E.P.A: .98

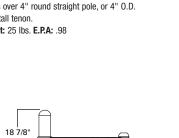


### TRADITIONAL SINGLE POLE

**MOUNT ARM** 

[SA6109, SA6158, SA6009, SA6058] Slipfits over 4" round straight pole, or 4" 0.D. by 6" tall tenon.


Weight: 20 lbs. E.P.A: .86

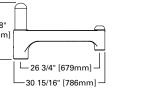

### TRADITIONAL SINGLE POLE MOUNT ARM

WITH ROUNDED UPPER BAR

[SA6110, SA6159, SA6010, SA6059]

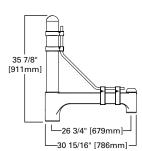


### TRADITIONAL SINGLE POLE MOUNT ARM WITH 45° UPPER BAR

[SA6112, SA6161, SA6012, SA6061] Slipfits over 4" round straight pole, or 4" 0.D.

by 6" tall tenon.


Weight: 28 lbs. E.P.A: 1.38

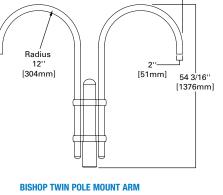

- 62" [1575mm]-


[SA6107, SA6156, SA6007, SA6056] Slipfits over 4" round straight pole, or 4" 0.D. by 6" tall tenon.

Weight: 37 lbs. E.P.A: 1.43

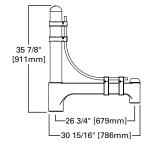

Slipfits over 4" round straight pole, or 4" 0.D. by 6" tall tenon.

Weight: 28 lbs. E.P.A: 1.4

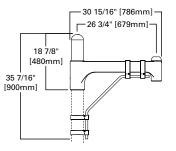


### TRADITIONAL SINGLE POLE MOUNT ARM WITH 45° LOWER BAR

[SA6113, SA6162, SA6013, SA6062] Slipfits over 4" round straight pole. Requires use of 4" O.D. Round Straight Pole

Weight: 25 lbs. E.P.A: 1.14

### EPIC COLLECTION ARMS


### ARMS SPECIFICATIONS (CON'T.)

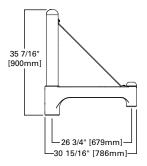

### TRADITIONAL SINGLE POLE MOUNT ARM WITH 45° UPPER STRAP

[SA6114, SA6163, SA6014, SA6063] Slipfits over 4" round straight pole, or 4" 0.D. by 6" tall tenon.


Weight: 24 lbs. E.P.A: 1.17

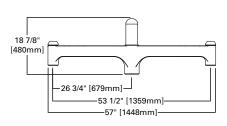

#### TRADITIONAL TWIN POLE MOUNT ARM

[SA6116, SA6165, SA6016, SA6065] Slipfits over 4" round straight pole, or 4" 0.D. by 6" tall tenon.


Weight: 30 lbs. E.P.A: 1.44

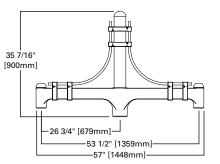

### TRADITIONAL TWIN POLE MOUNT ARM WITH ROUNDED UPPER BARS

[SA6117, SA6166, SA6017, SA6066] Slipfits over 4" round straight pole, or 4" 0.D. by 6" tall tenon.


Weight: 43 lbs. E.P.A: 2.28

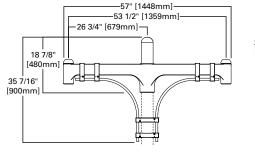

### TRADITIONAL TWIN POLE MOUNT ARM WITH ROUNDED LOWER BARS

[SA6118, SA6167, SA6018, SA6067] Slipfits over 4" round straight pole. Requires use of 4" O.D. Round Straight Pole


Weight: 40 lbs. E.P.A: 2.04

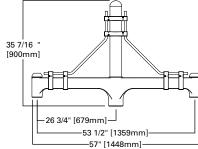

### TRADITIONAL TWIN POLE MOUNT ARM WITH 45° UPPER BARS

[SA6119, SA6168, SA6019, SA6068] Slipfits over 4" round straight pole, or 4" 0.D. by 6" tall tenon.


Weight: 43 lbs. E.P.A: 2.24

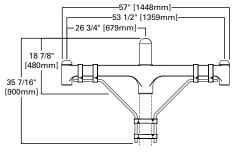

### TRADITIONAL TWIN POLE MOUNT ARM WITH 45° LOWER BARS

[SA6120, SA6169, SA6020, SA6069] Slipfits over 4" round straight pole. Requires use of 4" O.D. Round Straight Pole

Weight: 40 lbs. E.P.A: 2.0

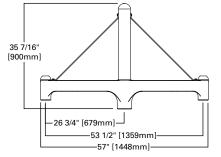

### TRADITIONAL TWIN POLE MOUNT ARM

WITH 45° UPPER STRAPS


[SA6121, SA6170, SA6021, SA6070] Slipfits over 4" round straight pole, or 4" 0.D. by 6" tall tenon.

Weight: 37 lbs. E.P.A: 1.81



### TENON ADAPTER

Weight: 4 lbs. E.P.A: .08

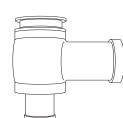

[SA6022, SA6071, SA6122, SA6172] Attaches to a 2 3/8" O.D. horizontal tenon.

