

URBAN DESIGN COMMISSION APPLICATION CITY OF MADISON

This form may also be completed online at: http://www.cityofmadison.com/planning/documents/UDCapplication.pdf

215 Martin Luther King Jr. Blvd; Room LL-100 PO Box 2985; Madison, Wisconsin 53701-2985 Phone: 608.266.4635 | Facsimile: 608.267.8739

Please complete all sections of the application, including the desired meeting date and the type of action requested.

Date Submitted:	
UDC Meeting Date: $2-84-16$	Initial Approval
Combined Schedule Plan Commission Date (If applicable):	Final Approval
1. Project Address: 5401 Tancho Drive Project Title (if any): Tancho Drive Multi-Family Deve	elopment (working name)
2 This is an application for an annual and a second	
2. This is an application for (check all that apply to this UDC application	
New Development Alteration to an Existing or P A. Project Type: SIP for a previously appreviously appreviou	
A TO COUTY PC	
Project in an Urban Design District* (public hearing-\$300 fee	
Project in the Downtown Core District (DC) or Urban	utional District (CI) or Employment Campus District (EC)
Planned Development (PD)	ational district (CI) of Employment Campus district (EC)
Д Franned Development (PD) ☐ General Development Plan (GDP)	
Specific Implementation Plan (SIP)	AGENDA ITEM#
☐ Planned Multi-Use Site or Planned Residential Comple	LEGISTAR # 40975 ALD. DIST. 13-
·	Theo, Diot,
B. Signage:	
Comprehensive Design Review* (public hearing-\$300 fee)	Street Graphics Variance* (public hearing-\$300 fee)
☐ Signage Exception(s) in an Urban Design District (public	hearing-\$300 fee)
C. Other:	
Please specify:	AATTAIN AND AND AND AND AND AND AND AND AND AN
3. Applicant, Agent & Property Owner Information:	
Applicant Name: Joseph Lee	Company: JLA Architects + Planners
Street Address: 2418 Crossroads Drive - 2300	City/State: Madison, Wisconsin Zip: 53718
Telephone:(<u>608</u>) 241-9500 Fax:()	Email: jlee@jla-ap.com
Project Contact Person: Joseph Lee	Company: JLA Architects + Planners
Street Address: 2418 Crossroads Drive - 2300	City/State: Madison, Wisconsin zip: 53718
Telephone:(608) 241-9500 Fax:()	Email: ilee@ila-ap.com
Project Owner (If not applicant): Fiduciary Real Estate Developm	
Street Address: 789 N. Water Street - Suite 200	City/state: Milwaukee, Wisconsin zip: 53718
Telephone:(414)226-4535 Fax:()	Email: mschiltz@fred-inc.com
4. Applicant Declarations:	
A. Prior to submitting this application, the applicant is required to discuss the application was discussed with Jay Wendf on	proposed project with Urban Design Commission staff. This November 9, 2015
(name of staff person)	(date of meeting)
B. The applicant attests that all required materials are included in this submit the application deadline, the application will not be placed on an Urban Desi	ital and understands that if any required information is not provided by
Name of Applicant Joseph Lee	Relationship to Property Project Designer
Authorized Signature / / r.h.	Date November 23, 2015
varioused signature , }	Date Trovelline 20, 2010



JOSEPH LEE + ASSOCIATES, LLC 2418 Crossroads Drive, Suite 2300 Madison, Wisconsin 53718

January 6, 2016

608.241.9500

Madison Plan Commission & Common Council c/o Mr. Matt Tucker Madison Zoning Administrator 215 Martin Luther King Jr. Boulevard Madison, Wisconsin 53701-2985

RE:

22 Slate Apartments: PUD-SIP & CSM Submittals

5401 Tancho Drive

Mr. Tucker,

Please find enclosed, the following required materials for a PUD-SIP submittal and the UDC submittal, and associated CSM for our proposed "22 Slate Apartments" located at 5401 Tancho Drive on Madison's east side.

- Letter of Intent 59 total copies
 - o 33 copies for SIP Submittal
 - o 14 copies for UDC Submittal
 - o 12 copies for CSM Submittal
- PUD-SIP Application
 - o Seven (7) Full Size Plan Sets at 24"x36"
 - o Twenty-Five (25) Reduced Sets at 11"x17"
 - o One (1) Reduced Set at 8.5"x11"
 - o One (1) Set of Storm Water Management Calculations
 - o Application Fee
 - o Fourteen (14) UDC Submittal Sets at 11"x17"
- CSM Application Preliminary Plat
 - o Eighteen (18) Sets at 11"x17"
- CD with Digital Files of Submittal

We respectfully request that our project be inserted into the Plan Commission/Common Council Meeting Schedule for review. Below is a brief description of the project.

Project Team:

The project team consists of the following members:

Owner

Fiduciary Real Estate Development, Inc.

Architect:

JLA Architects & Planners

Mr. Matt Tucker – 22 Slate PUD-SiP Submittal January 6, 2016 Page 2 of 4

Civil Engineers:

The Sigma Group

JLA Architects & Planners

Landscape Architect:

New Eden Landscape Architecture

Existing Site Conditions:

The 14.2 acre (+/-) site is located on the east side of Madison – just east of American Parkway. The site is currently a vacant parcel that is bordered by:

- Highway 151 to the east;
- Permanent open space and Madison parkland to the north;
- Various multi-family residential communities to the west and the south.

The site has a topographic change – dropping 10'-15' from north to south – and has no significant trees/vegetation. The site has an existing Storm Water management facility – shared with other adjacent buildings.

Project Program:

The "22 Slate Apartments" consists of seven (7) multi-family residential buildings and a single, standalone Clubhouse building. The buildings are organized around thoughtfully designed common greens that serve as common amenity space for the community. For this project, we are proposing to divide a single parcel into two (2) separate parcels via the Land Division/CSM process.

Residential Buildings:

There are two (2) different residential buildings types - Building Type 'A' and Building Type 'B. Both are three story buildings above a single level of covered parking. They are to have a more traditional aesthetic to complement the existing traditional multi-family buildings adjacent to the project site.

			OTALS		
	Total	Units	Common	D.:II.	
	833 A	.S.F.		DUNG	ing Totals
	Qty.	Area	Space	Area	Efficiency
Floor 5		2 (2) (2) (3)			#DIV/OI
Floor 4					#DIV/01
Floor 3	15	12,410	2,380	14,790	83.9%
Floor 2	15	12,410	2,380	14,790	83.9%
Floor 1	14	11,810	2,980	14,790	79.9%
Totals	44	36,630	7,740	44,370	82.6%
Unit Breakdown	100%		<u> </u>	1,008	s.f. per unit

NOTE: Final Unit Counts, Types, Mix, and Sizes are subject to change.

		1	TOTALS			
	Total		Common	Bulld	ing Totals	
	919 A	.S.F.	31349-1782-1782-1783	Bullding Totals		
	Qty.	Area	Space	Area	Efficiency	
Floor 5	-	9			#DIV/OI	
Floor 4	-				#DIV/01	
Floor 3	11	10,170	2,450	12,620	80.6%	
Floor 2	11	10,170	2,450	12,620	80.6%	
Floor 1	11	9,985	2,635	12,620	79.1%	
Totals	33	30,325	7,535	37,860	80.1%	
Unit Breakdown	100%			1,147	s.f. per unit	

NOTE: Final Unit Counts, Types, Mix, and Sizes are subject to change.

Mr. Matt Tucker – 22 State PUD-SIP Submittal January 6, 2016 Page 3 of 4

Clubhouse Building:

The Clubhouse building will be a single story building with a basement level. At 3,500, it will contain the development's leasing office as well as common amenity spaces such as a club room, fitness center, and pool. Like the apartment buildings, the Clubhouse will have a more traditional aesthetic.

Density:

The total unit count for '22 Slate' is 264 units - resulting in a project density of 18.6 units/per acre. These units are comprised of the following unit mix:

- 14% Studio Units
- 44% One-Bedroom Units
- 6% One-Bedroom + Den Units
- 28% Two-Bedroom Units
- 8% Three-Bedroom Units.

Project Data

Currently, the Project Data for '22 Slate' is as follows:

	BUILDI	NG						P.	ARKING		
NAME	USE	FOOTPRIN	aT .	FLOOR A	REA	UNITS	COVERED	SURFACE	TOTAL	RA	ATIO
A1	Multi-Family Residential	15,000	S.F.	45,000	\$.F,	44	44	24	68	1,55	PER UNI
A2	Multi-Family Residential	15,000	S.F.	45,000	Ş.F.	44	44	24	68	1.55	PER UNIT
A3	Multi-Family Residential	15,000	S.F.	45,000	Ş.F.	44	44	24	68	1,55	PER UNIT
B1	Multi-Family Residential	13,000	S.F.	39,000	S.F.	33	33	18	51	1.55	PER UNIT
B2	Multi-Family Residential	13,000	Ş,F,	39,000	S,F,	33	33	18	51	1,55	PER UNIT
В3	Multi-Family Residential	13,000	S.F.	39,000	S.F.	33	33	18	51	1,55	PER UNIT
B4	Multi-Family Residential	13,000	S,F.	39,000	S.F.	33	33	18	51	1,55	PER UNII
СН	Clubhouse	3,500	Ş,F.	3,500	S.F.	: 0	0	2	2	0.00	PER UNIT
	TOTALS	100,500	S.F.	294,500	S.F.	264	264	146	410	1,55	PER UNIT

22 SLATE -	BIKE P	ARKING				
BUILDIN	NG .		BICYC	LE PARKING		
NAME	UNITS	COVERED	SURFACE	TOTAL	·R	ATIO
A1	- 44	44	6	50	1,14	PER UNIT
A2	44	44	6	50	1.14	PER UNIT
A3	44	44	6	50	1,14	PER UNIT
B1	33	33	4	37	1,12	PER UNIT
B2	33	33	-4	-37	1,12	PER UNIT
В3	33	33	4	37	1.12	PER UNIT
B4	33	33	4	37	1.12	PER UNIT
CLUBHOUSE		-0	12	12		
TOTALS	264	264	46	310	1,17	PER UNIT

ZONING REQUIREMENT	DESIGN VALUE	CALCULATIONS
SITE DENSITY	18.57 Units/Acre	264 Units / 14.22 AC. = 18.57
BUILDING COVERAGE	16.2% of Parcel	100,500 S.F. / 619,231 S.F. = 16.2%
FLOOR AREA RATIO	47.6% of Parcel	294,500 S.F. / 619,231 S.F. = 47.6%
IMPERVIOUS SURFACE	37.6% of Parcel	233,078 S.F. / 619,231 S.F. = 37.6%
LANDSCAPE AREA	62.4% of Parcel	386,153 S.F. / 619,231 S.F. = 62.4%

Mr. Matt Tucker – 22 Slate PUD-SIP Submittal January 6, 2016 Page 4 of 4

Project Schedule:

Currently, the anticipated Construction Schedule would be as follows. However, changing market conditions could result in either the acceleration or delay in this schedule.

- Phase 1
 - o Clubhouse May 2016 to December 2016
 - o Building B2 May 2016 to March 2017
 - o Building B4 July 2016 to April 2017
 - o Bullding B3 September 2016 to June 2017
 - o Building A3 November 2016 to August 2017
- Phase 2
 - o Building A2 July 2017 to April 2018
 - o Building B1 September 2017 to June 2018
 - o Building A1 November 2017 to August 2018

Project Cost:

The current anticipated value & construction cost of the project is as follows:

Land Value

\$2,480,000

Total Construction Cost

\$37,750,000

Post-Occupancy Operation:

After the completion of the project – it is anticipated that there would be seven (7) full-time equivalent jobs create. These will be a combination of Property Managers, Office Staff, Leasing Agents, and Maintenance Staff. The regular office hours would be as follows:

Mondays-Fridays

8:00AM - 6:00PM

Saturdays

10:00AM - 5:00PM

Sundays

11:00AM - 4:00PM

We look forward to working with you, and other City of Madison Departments on this project. Please feel free to contact us if you have any questions or need anything else.

Regards,

Joseph M. Lee, AIA

JLA Architects + Planners

22 SLATE APARTMENTS

5401 Tancho Drive Madison, Wisconsin





PUD-SIP Submittal







JLA PROJECT NUMBER:

15-0617


January 6, 2016

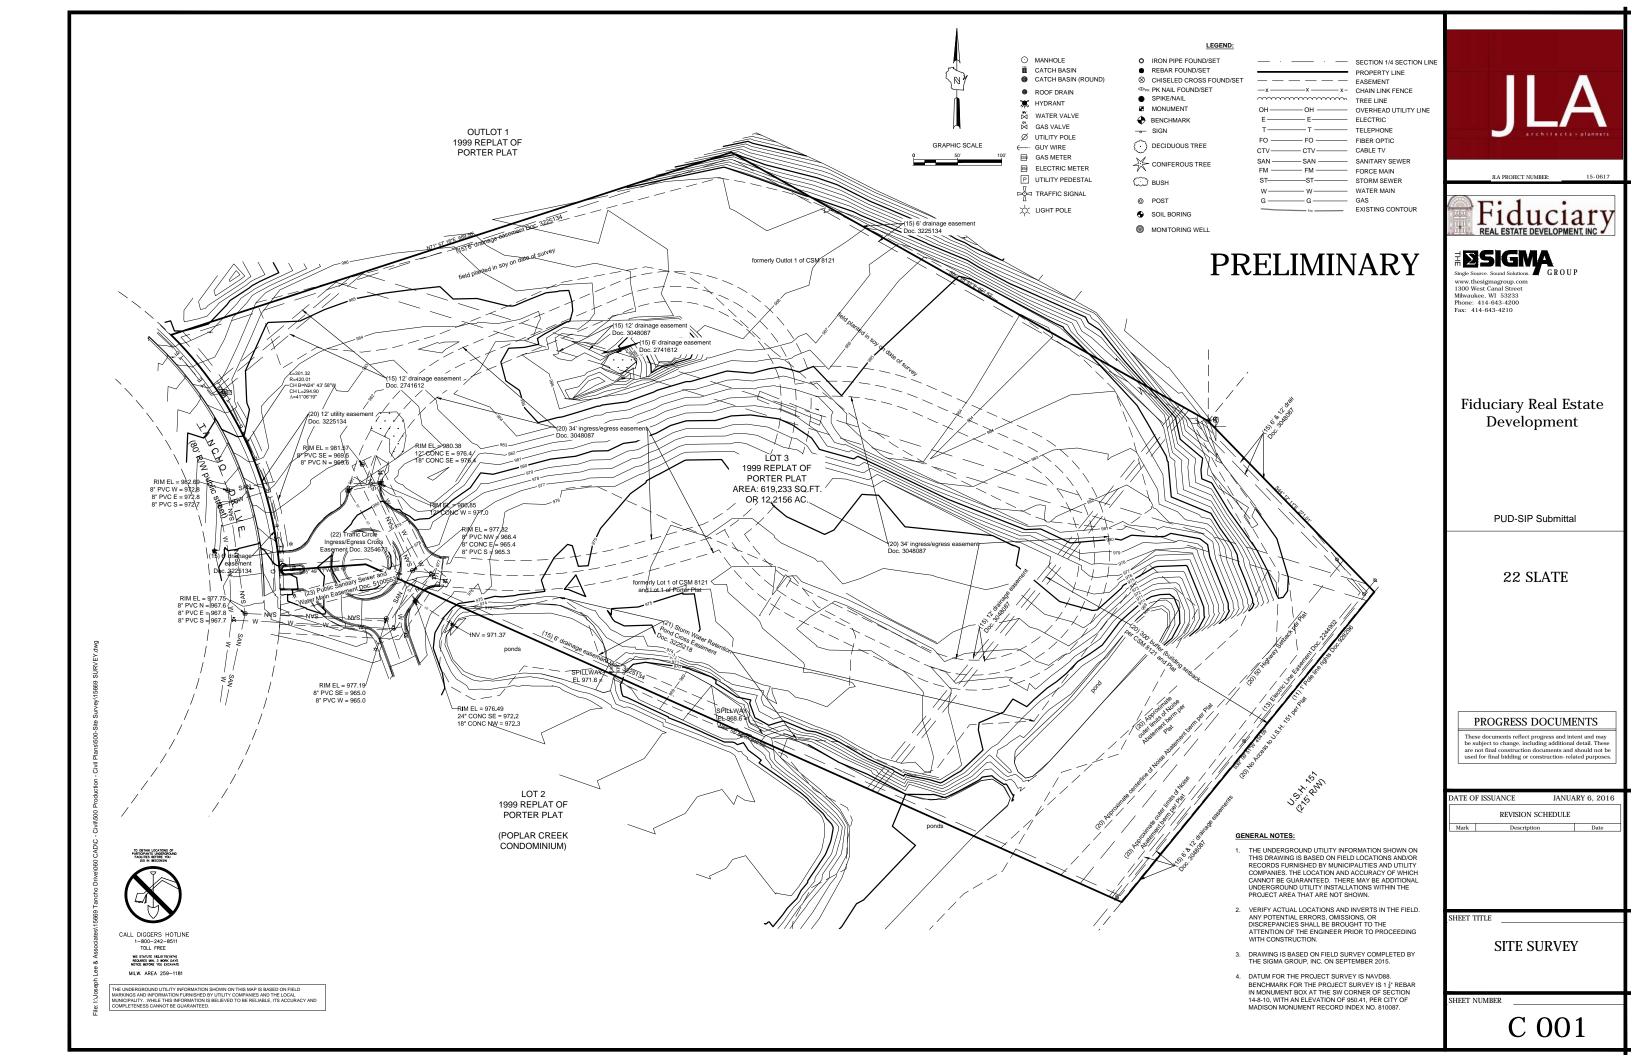


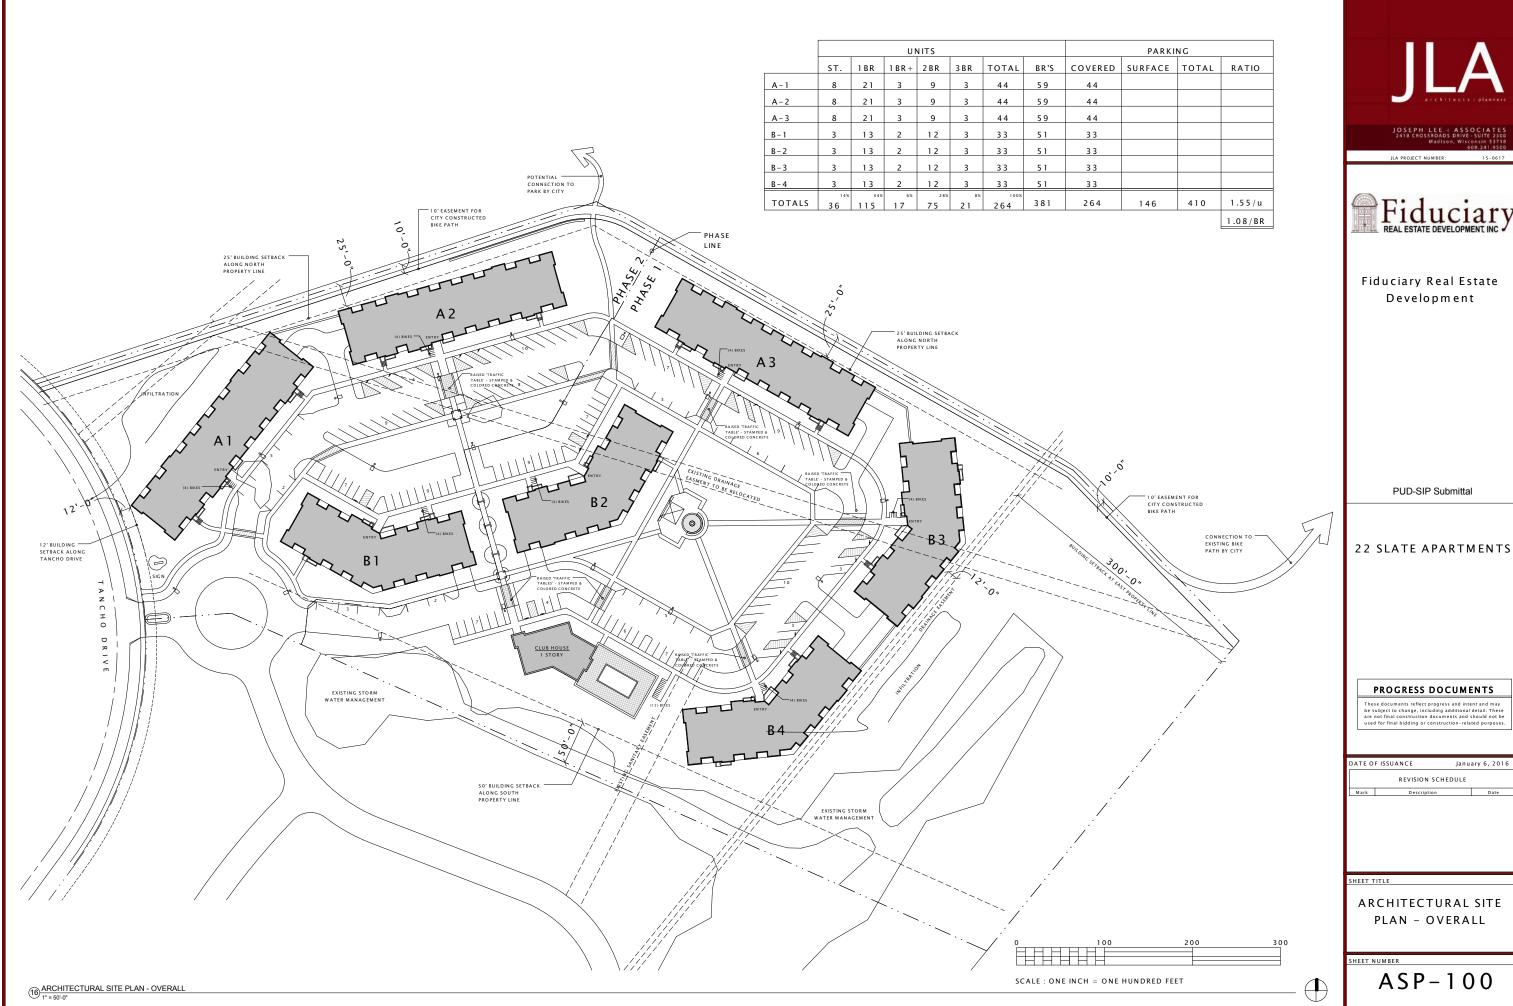






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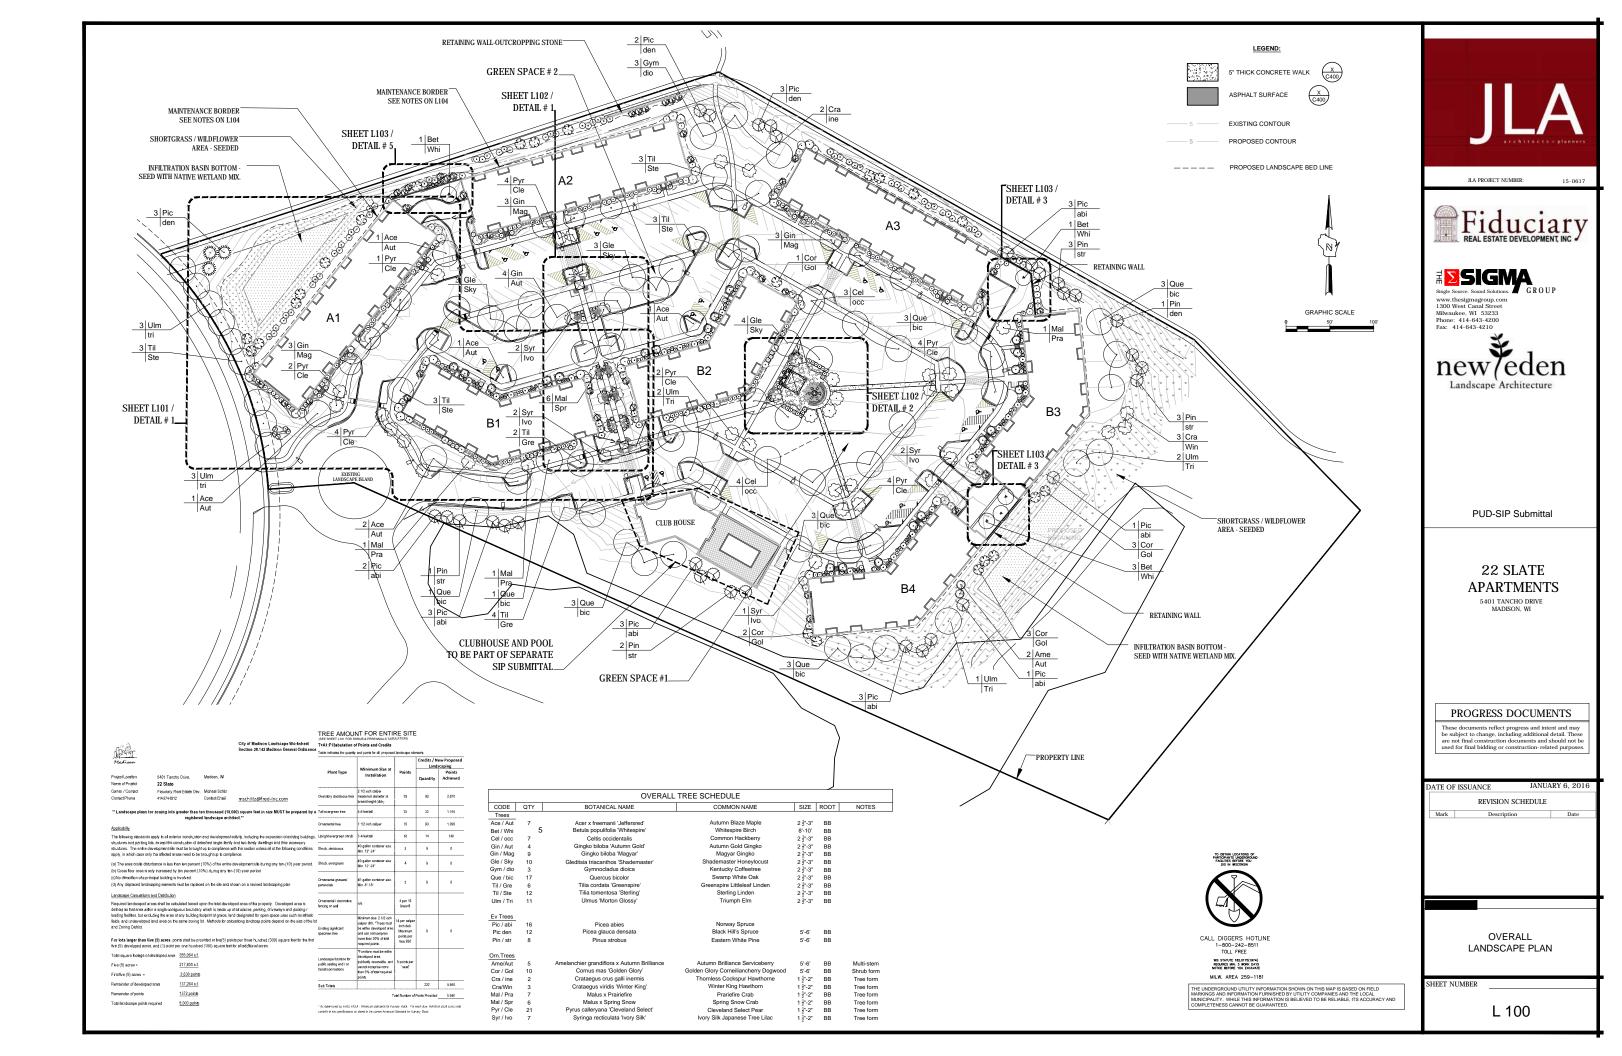


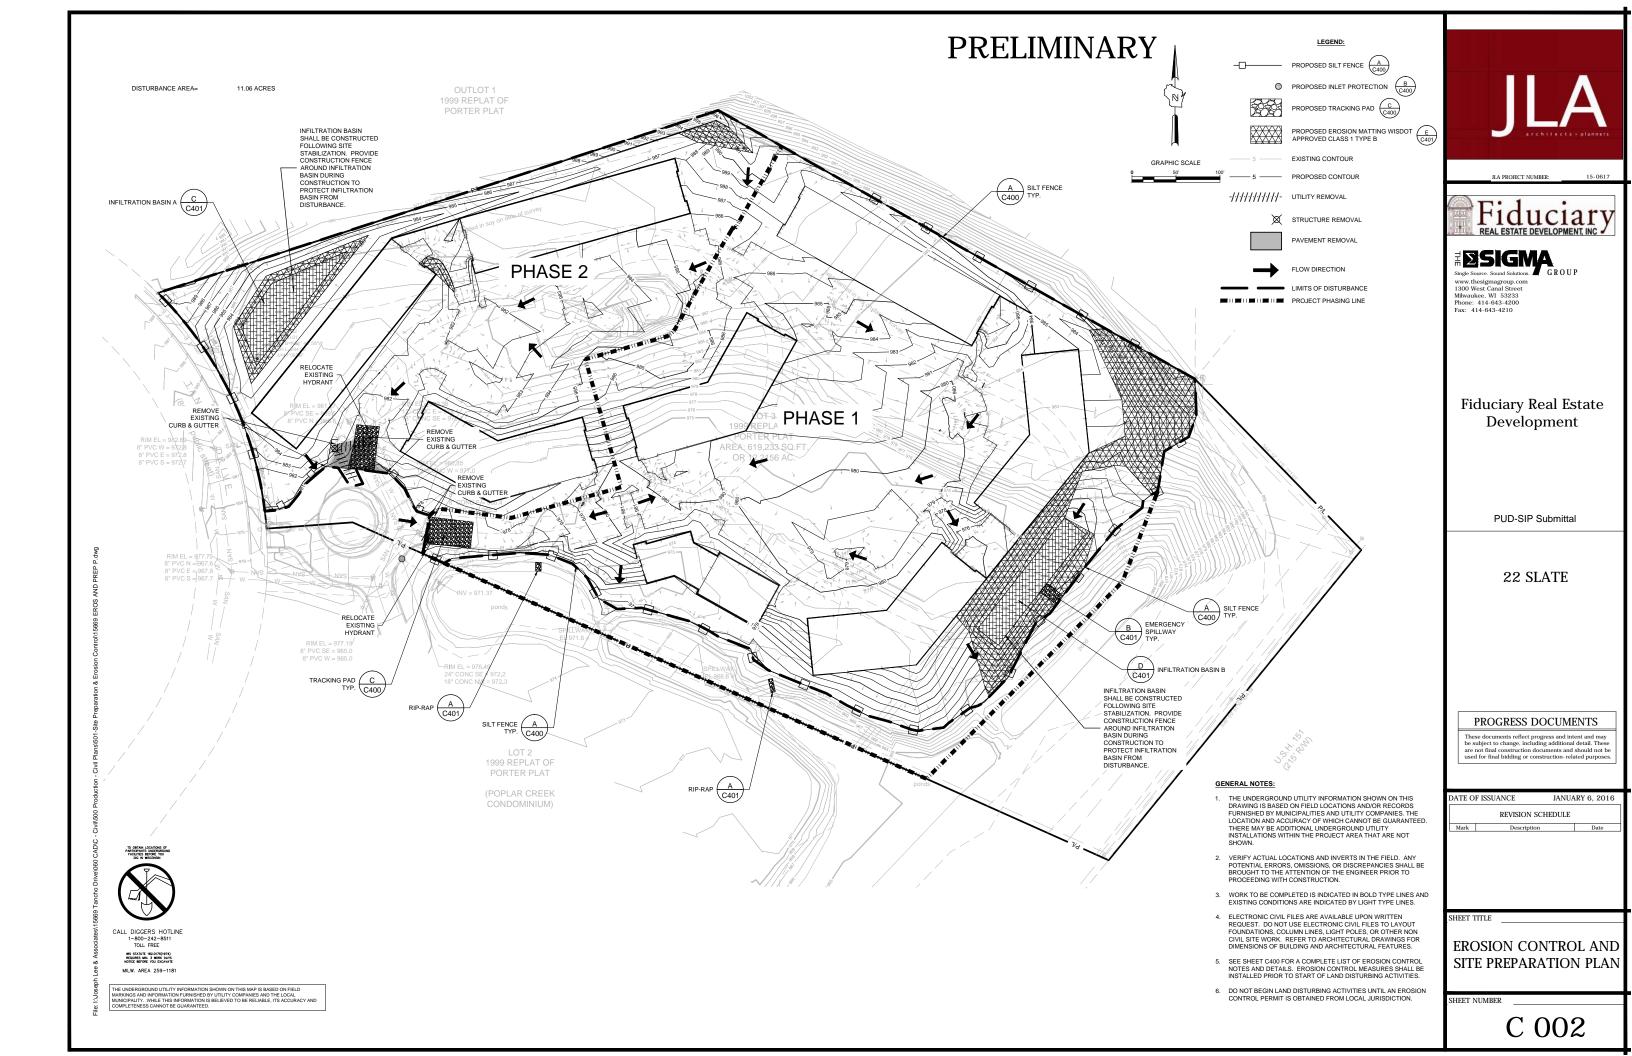


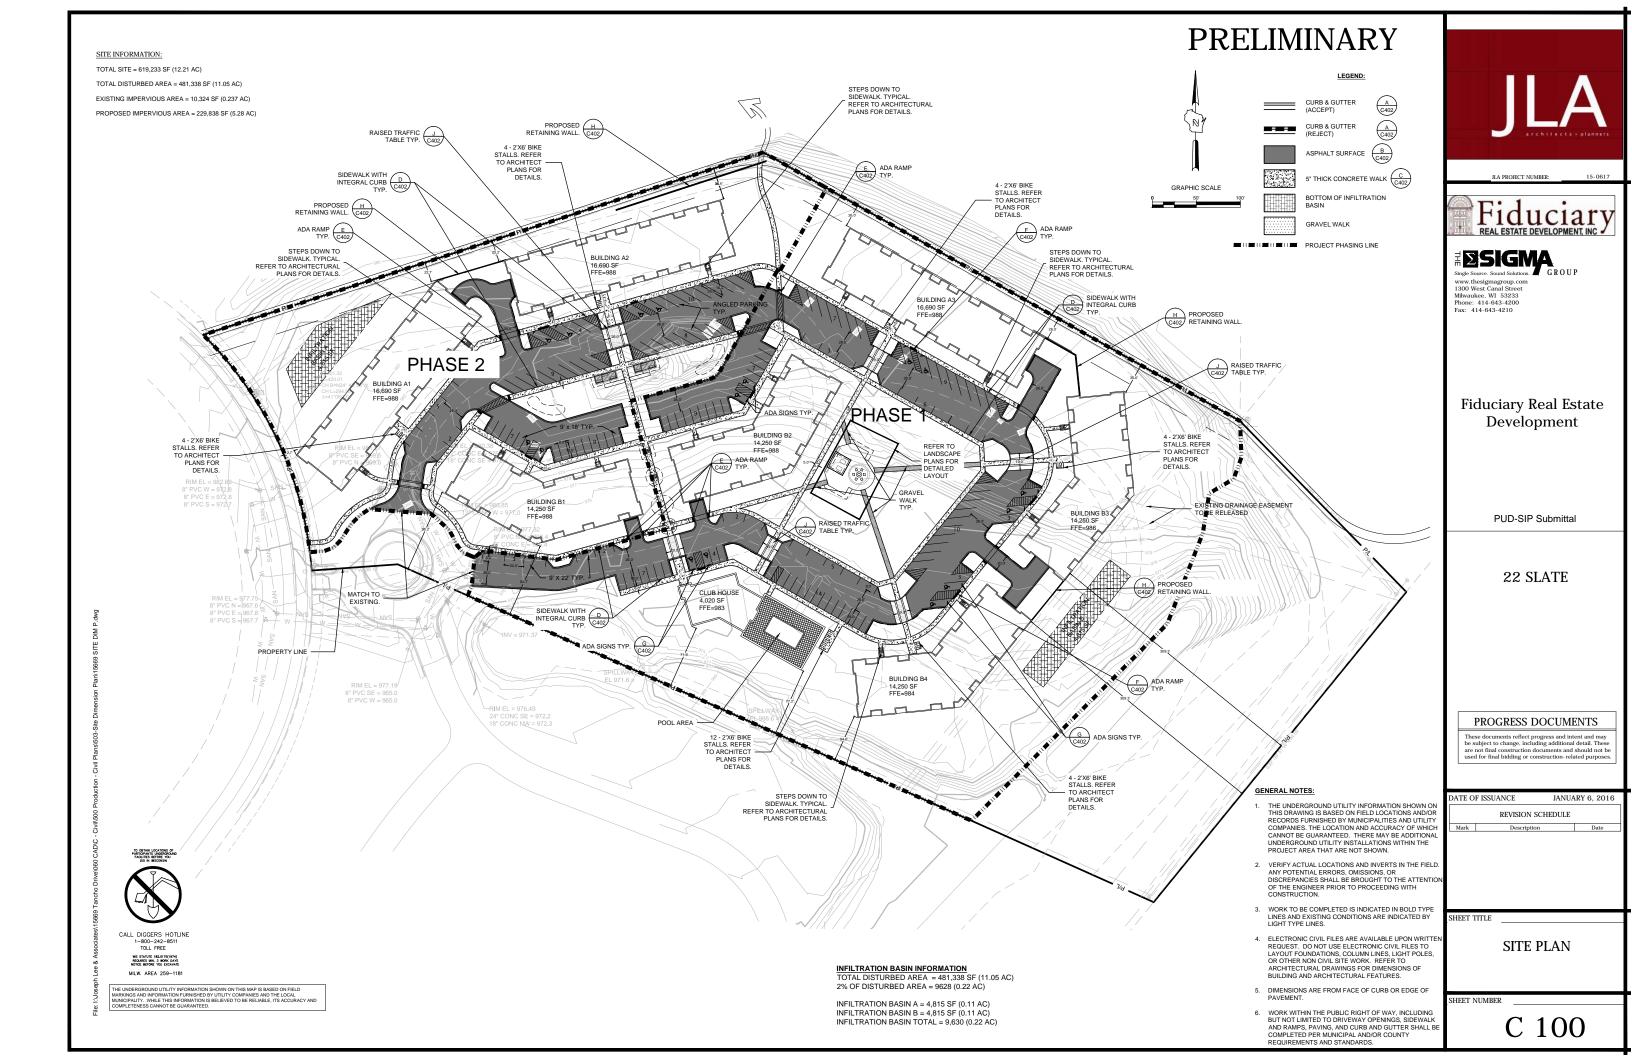

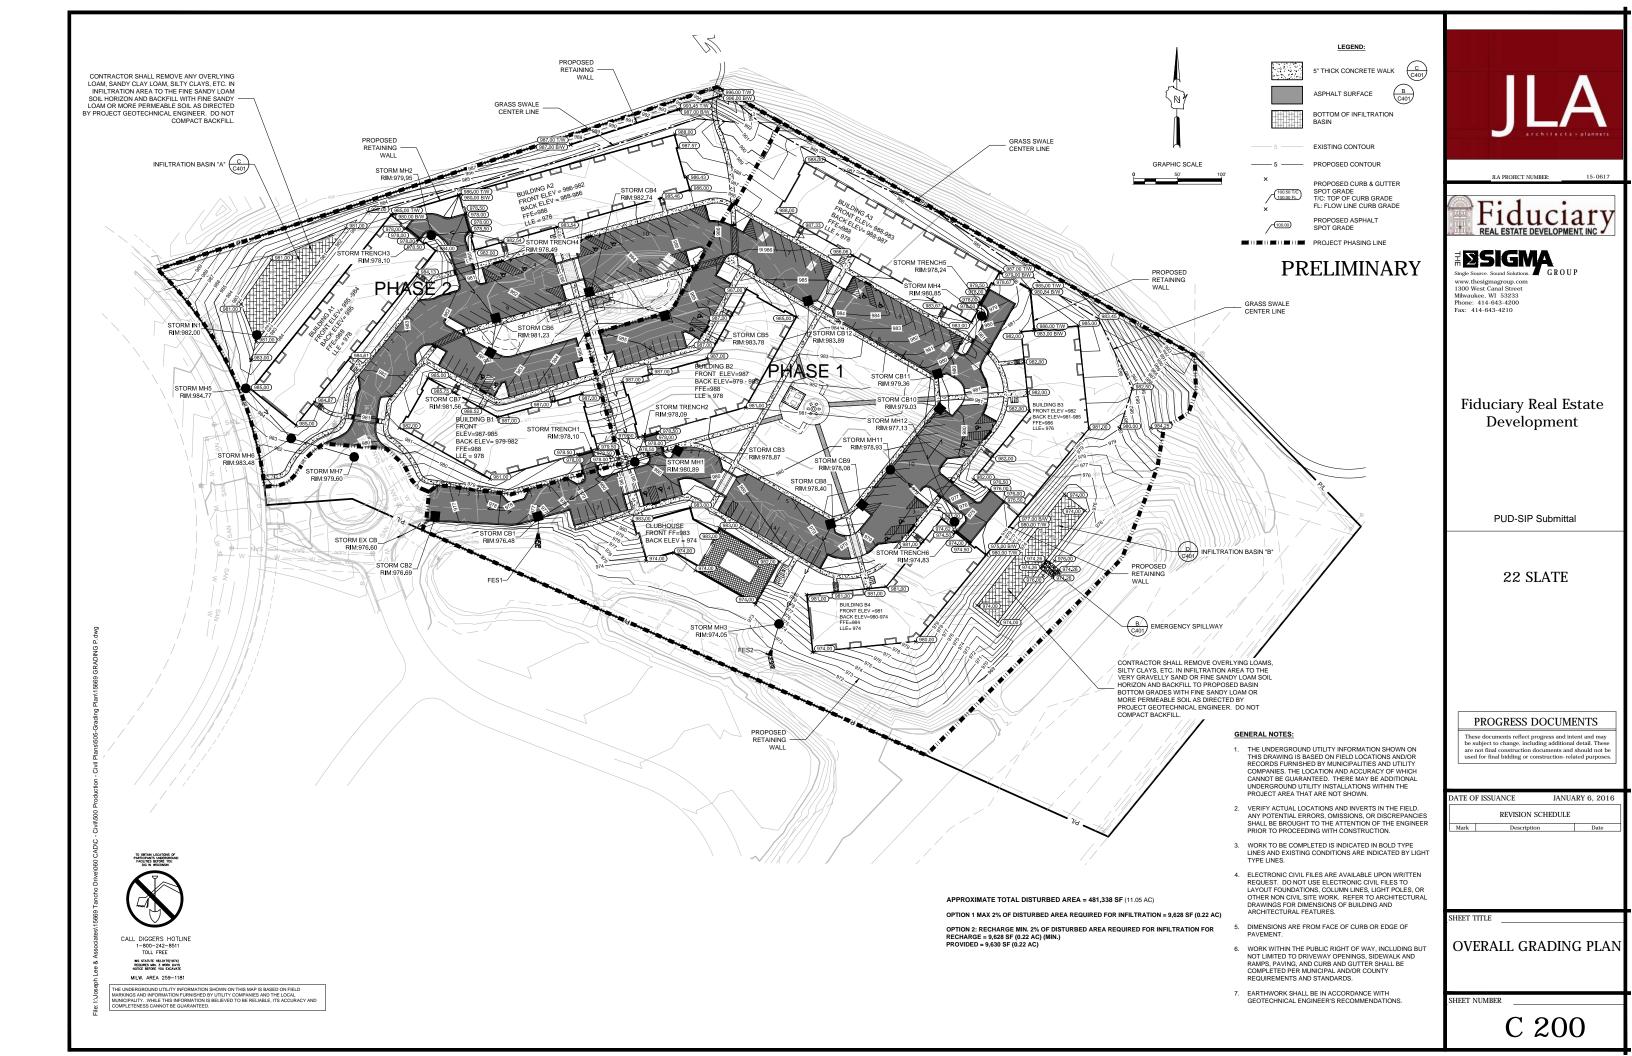

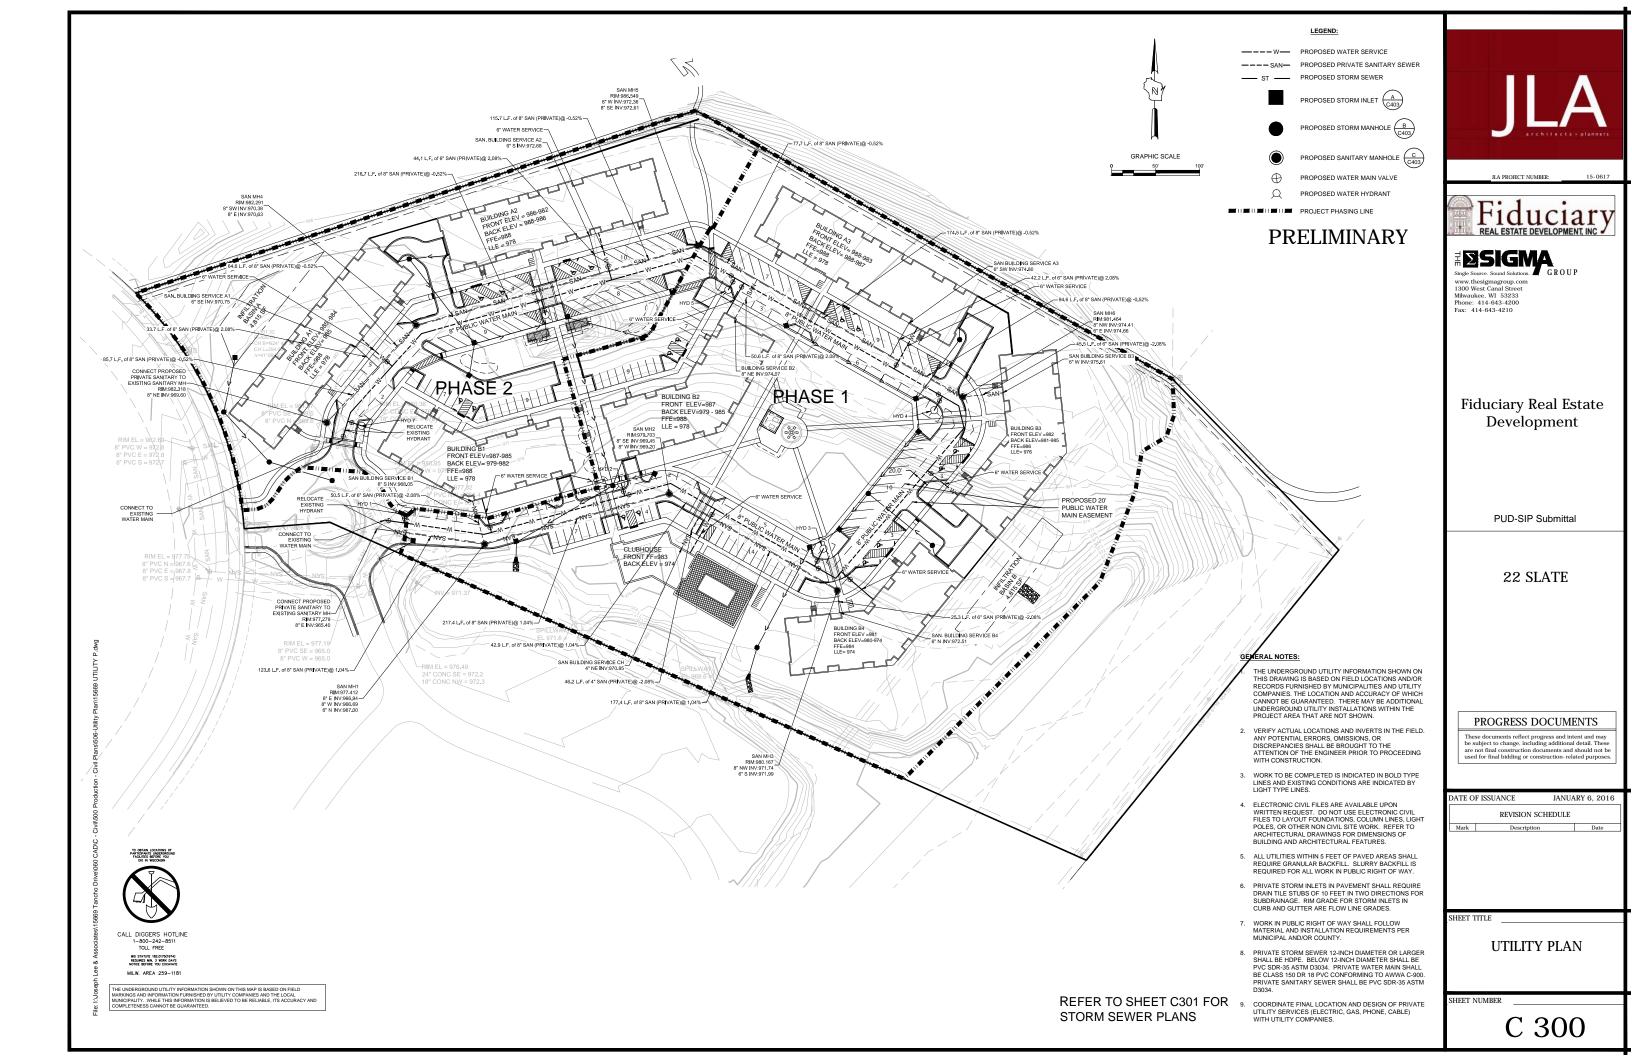

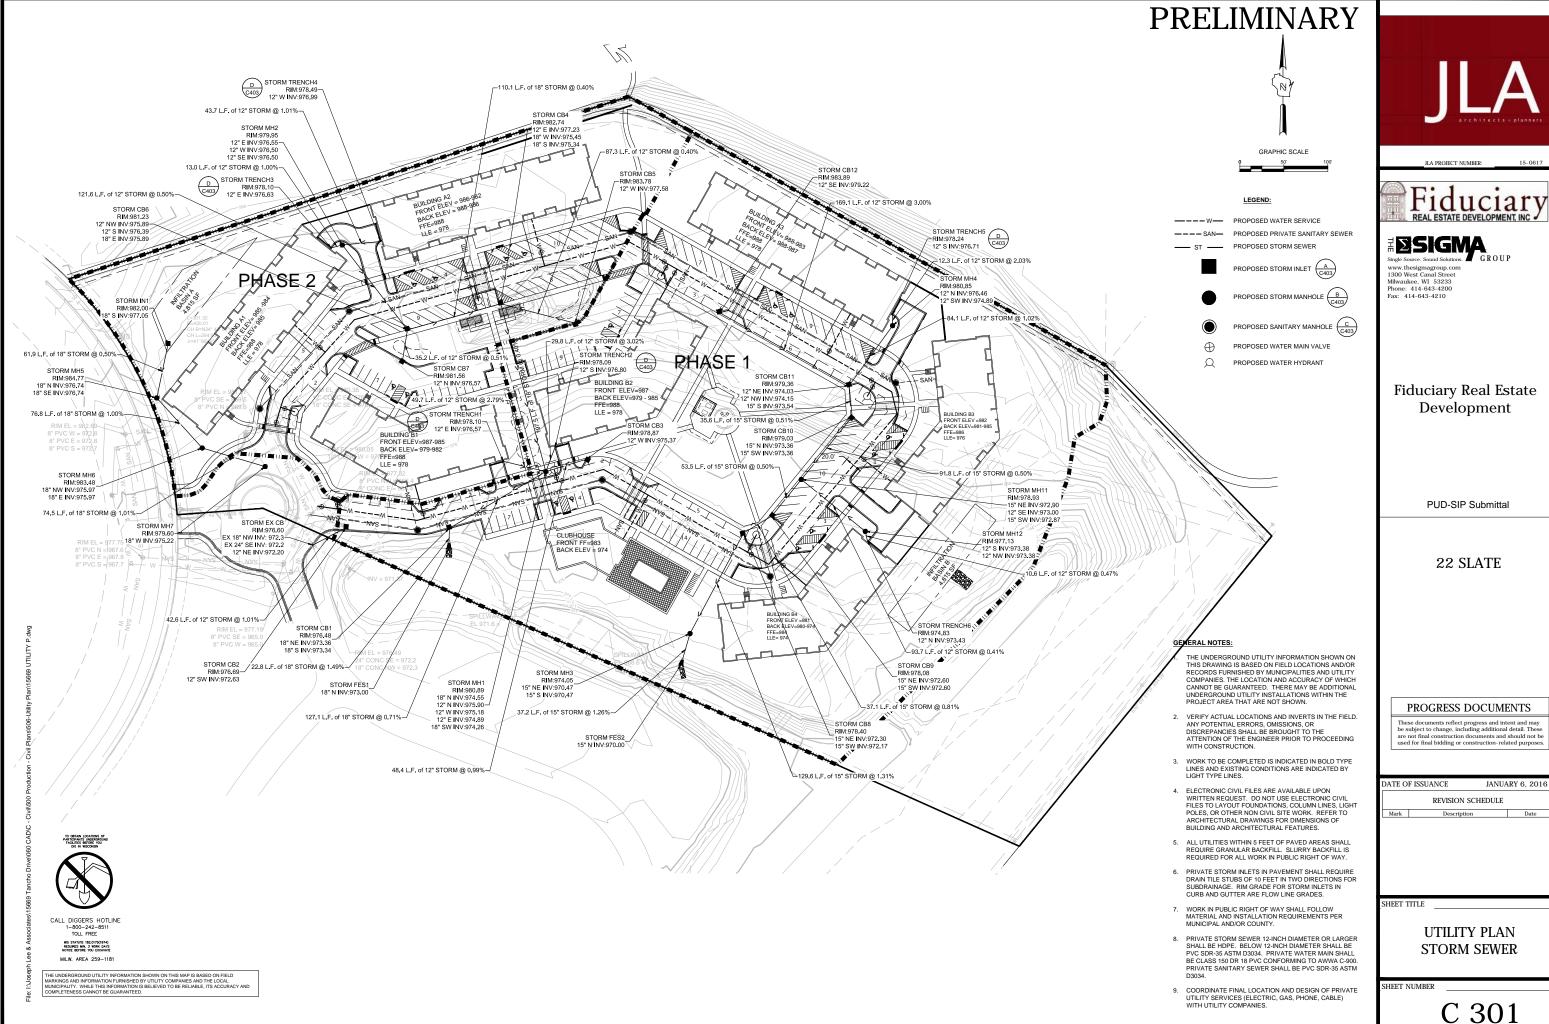

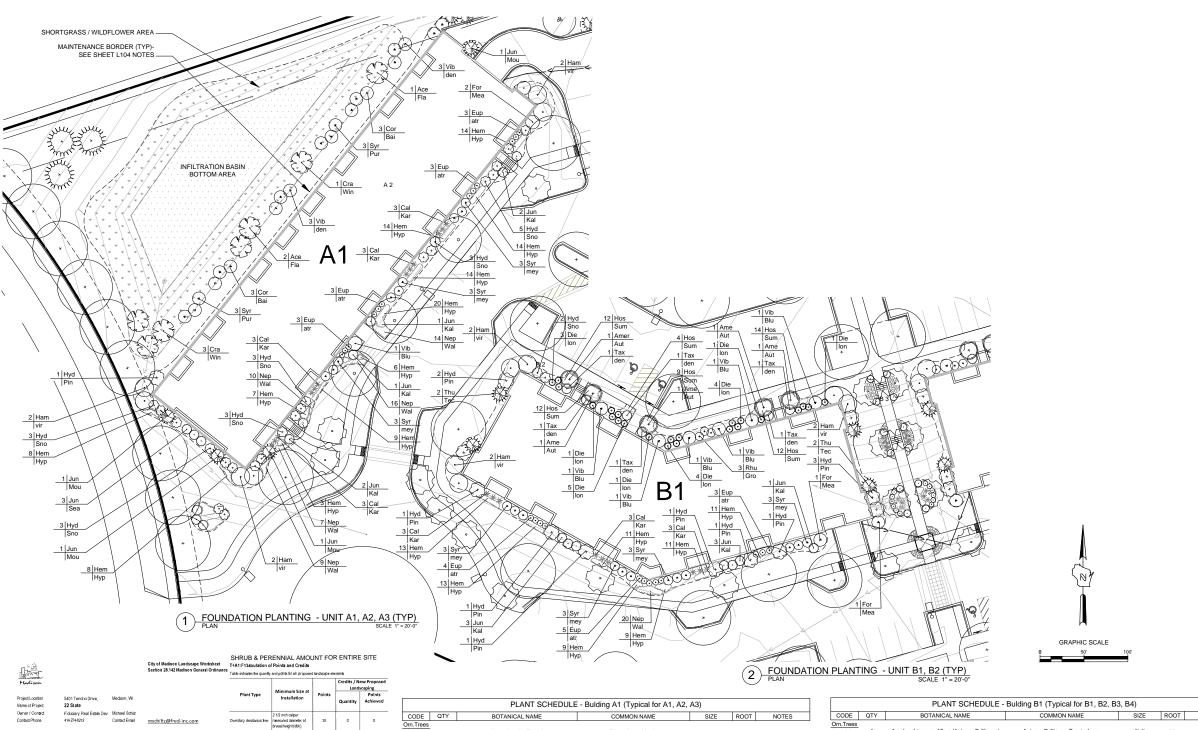

24011411	and prime,	mouson, re					Quantity	Achieved
22 State								
Fiduciary 1 414-274-82	Real Estato Dev. 12	Michael Schilz Contact Email	mschiltz@fred-inc.com	Overstory deciduous fee	2 1/2 inch caliper measured dismeter at breastheight(dbh)	35	0	0
lans for zoning lots		en thousand (10,0 d landscape archi	00) square feet in size MUST be prepared by a tect.**	Taltevergreen tree	5-8 Nect Val	35	0	0
				Ornamental tree	1 1/2 inch caliper	15	0	0
rking lots, except the o	construction of de	tached single-family	ctivity, including the expension of existing buildings, end two-family dwellings and their eccessory	Upright evergreen shrub	3-4 feet tall	10	38	390
intre development site ase only the affected a			ith this section unless all of the following conditions lance:	Shrub, deciduous	#3 gallon container size. Min. 12"-24"	3	408	1218
ea is only increased t	y ten percent [:		development sits during any ten-(10) year period. (10) year period.	Strub, evergreen	#3 gallon container size, Min. 12*-24"	4	77	308
ot e principal building i I landscaping element Materia and Distributor	s must be replace	ed on the site and sh	own on a revised landscaping plan	Ornamental grasses/ perennials	#1 gallon containes size Min. 81-181	2	t32	264
aped erees sher be ca ea within a single cont out excluding the afea	doubted besed u iguous boundery of any building t	which is made up o colprint algrade, lan	ped erea of the property. Developed erea is at structures, parking, driveways and docking / d designated for open space uses such as athletic	Ornamental / decorative fencing or wall	n/a	4 per 19 Ensel t		
ict han five (5) acres, p	oints shall be pro per one hundre	ovided at five(5) poin	uationg sandscap points depend on the size of the iz its per three hundred (300) square feet for the first for all additional acres.	Existing significant specimen tree	Minimum size, 2 1/2 inch caliper dbh. 'Trees must be within developed stea and can not comprise more than 30% at lotal required points.	14 per caliper inch deb. Maximum points per tree:200	0	0
age or developed area	217,800 at			Landscape furniture for	*Furniture must be within developed area, publically accessible, and	5 points per		
s = veloped area	3,630 points 137,264 s.f.			public senting and / or framsit connections	cannot comprise more than 5% of total required	spont per		
					points			
ints	1372 points			Sub Totals			653	2,170
coints required	5,003 paints							

		I LANT SCHEDOLL	- building AT (Typical for AT, Az,	A3)		
CODE	QTY	BOTANICAL NAME	COMMON NAME	SIZE	ROOT	NOTES
Orn.Trees						
Ace/gin	3	Acer ginnalla 'Flame'	Flame Amur Maple	5'-6'	BB	Shrub form
Cra/Win	4	Crataegus viridis 'Winter King'	Winter King Hawthorn	1 ½"-2"	BB	Tree form
Evergreen						
Jun / Buf	3	Juniperus sabina 'Buffalo'	Buffalo Juniper	18"-24"	Cont.	
Jun/Kal	10	Juniperus chinensis 'Kallay's'	Kallay's Compact Juniper	18"-24"	Cont.	
Jun/Mou	4	Juniperus chinensis 'Mountbatten	Mountbatten Juniper	4'-5'	BB	
Jun / Sea	3	Juniperus chinensis 'Sea Green'	Dense Yew	18"-24"	Cont.	
Shrubs						
Cor / Bai	6	Cornus alba 'Baihalo'	Ivory Halo Dogwood	18"-24"	Cont.	
For / Mea	2	Forsythia x Meadowlark	Meadowlark Forsythia	24"-30"	Cont.	
Ham / vir	6	Hamamelis virginiana	Common Witchhazel	4'-5'	Cont.	
Hyd / Pin	1	Hydrangea paniculata 'Pinky Winky'	Pinky Winky Hydrangea	18"-24"	Cont.	
Hyd / Sno	22	Hydrangea arborescens 'Grandiflora'	Snowhill Hydrangea	15"-18"	Cont.	
Syr / mey	9	Syringa meyeri 'Palibin'	Dwarf Korean Lilac	18"-24"	Cont.	
Syr / Pur	6	Syringa vulgaris	Common Purple Lilac	30"-36"	Cont.	
Vib / Blu	1	Viburnum dentatum 'Christom'	Blue Muffin Arrowwood Viburnum	30"-42"	Cont.	
Vib / den	6	Viburnum dentatum	Arrowwood Viburnum	3'-4'	BB	
Perennials						
Cal / Kar	9	Calamagrostis acutiflora 'Karl Foerster'	Karl Foerster Reed Grass			
Eup / atr	12	Eupatorium maculatum 'Gateway'	Gateway Joe-Pye Weed			
Hem / Hyp	117	Hemerocalis x Hyperion	Hyperion Daylily			
Nep / Wal	56	Nepeta x faassenii 'Walker's Low'	Walker's Low Catmint			

		PLANT SCHEDULE - I	Bulding B1 (Typical for B1, B2, B	3, B4)		
CODE	QTY	BOTANICAL NAME	COMMON NAME	SIZE	ROOT	NOTES
Orn.Trees				•		
Ame / Aut	5	Amelanchier grandiflora 'Autumn Brilliance'	Autumn Brilliance Serviceberry	5'-6'	BB	Shrub for
Cra/Win	4	Crataegus viridis 'Winter King'	Winter King Hawthorn	1 ½"-2"	BB	Tree for
Evergreen						
Jun / Buf	3	Juniperus sabina 'Buffalo'	Buffalo Juniper	18"-24"	Cont.	
Jun/Kal	7	Juniperus chinensis 'Kallay's'	Kallay's Compact Juniper	18"-24"	Cont.	
Jun/Mou	4	Juniperus chinensis 'Mountbatten	Mountbatten Juniper	4'-5'	BB	
Jun / Sea	3	Juniperus chinensis 'Sea Green'	Dense Yew	18"-24"	Cont.	
Tax / den	6	Taxus densiformis	Dense Yew	15"-18"	Cont.	
Thu / Tec	2	Thuja occidentalis 'Techny'	Techny Arborvitae	4'-5'	BB	
Shrubs						
Cor / Bai	6	Cornus alba 'Baihalo'	Ivory Halo Dogwood	18"-24"	Cont.	
Die / Ion	20	Diervilla Ionicera 'Jewell'	Jewell Bush Honeysuckle		Cont.	
For / Mea	2	Forsythia x Meadowlark	Meadowlark Forsythia	24"-30"	Cont.	
Ham / vir	4	Hamamelis virginiana	Common Witchhazel	4'-5'	Cont.	
Hyd / Pin	9	Hydrangea paniculata 'Pinky Winky'	Pinky Winky Hydrangea	18"-24"	Cont.	
Hyd / Sno	2	Hydrangea arborescens 'Grandiflora'	Snowhill Hydrangea	15"-18"	Cont.	
Rhu / Gro	3	Rhus aromatica 'Gro Low'	Gro Low Sumac	15"-18"	Cont.	
Syr / Pur	6	Syringa vulgaris	Common Purple Lilac	30"-36"	Cont.	
Vib / Blu	6	Viburnum dentatum 'Christom'	Blue Muffin Arrowwood Viburnum	30"-42"	Cont.	
Perennials						
Cal / Kar	9	Calamagrostis acutiflora 'Karl Foerster'	Karl Foerster Reed Grass	1 gallon	Cont.	
Eup / atr	12	Eupatorium maculatum 'Gateway'	Gateway Joe-Pye Weed	1 gallon	Cont.	
Hem / Hyp	77	Hemerocalis x Hyperion	Hyperion Daylily	1 gallon	Cont.	
Hos / Sum	63	Hosta x Sum & Substance	Sum & Substance Hosta	1 gallon	Cont.	
Nep / Wal	20	Nepeta x faassenii 'Walker's Low'	Walker's Low Catmint	1 gallon	Cont.	







www.thesigmagroup.cor 1300 West Canal Street Milwaukee, WI 53233 Phone: 414-643-4200 Fax: 414-643-4210



PUD-SIP Submittal

22 SLATE **APARTMENTS**

5401 TANCHO DRIVE MADISON, WI

PROGRESS DOCUMENTS

These documents reflect progress and intent and may be subject to change, including additional detail. These are not final construction documents and should not be used for final bidding or construction-related purposes.

DATE OF ISSUANCE REVISION SCHEDULE

SHEET TITLE

LANDSCAPE PLANS TYPICAL BUILDING

SHEET NUMBER

L 101

CALL DIGGERS HOTLINE


1-800-242-8511

TOLL FREE


Renainder of points

Renainder of points WS STATUTE 182,0175(1974) REQUIRES MIN. 3 WORK DAYS NOTICE BEFORE YOU EXCAVATE MILW. AREA 259-1181

First five (5) acres

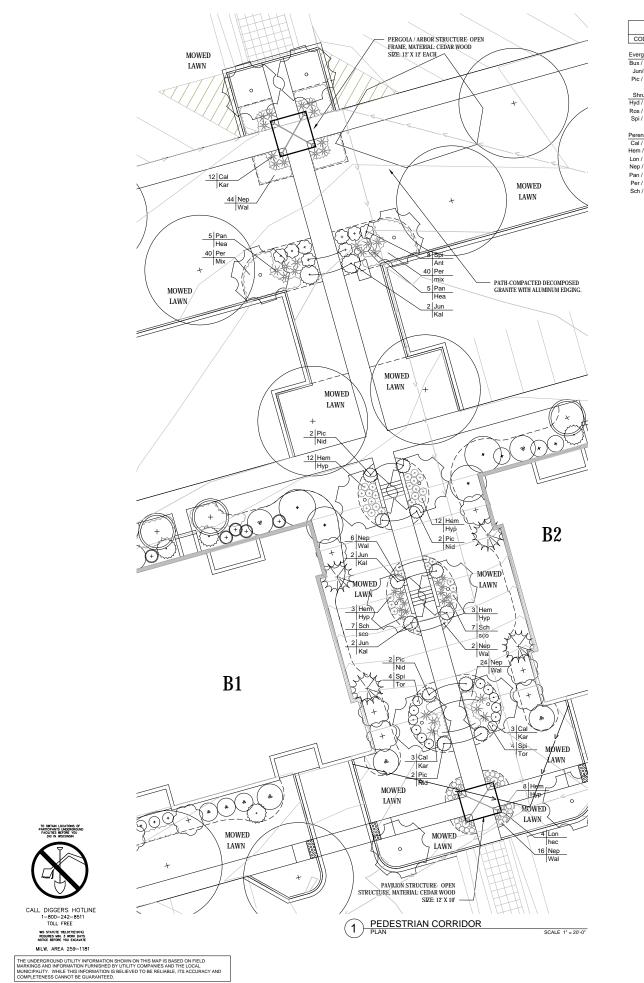

		PLANT SO	CHEDULE - DETAIL # 1			
CODE	QTY	BOTANICAL NAME	COMMON NAME	SIZE	ROOT	NOTES
Evergreen						
Bux / GrV	4	Buxus x Green Velvet	Green Velvet Boxwood	18"-24"	Cont.	
Jun/Kal	6	Juniperus chinensis 'Kallay's'	Kallay's Compact Juniper	18"-24"	Cont.	
Pic / Nid	8	Picea abies 'Nidiformis'	Nest Spruce	18"-24"	Cont.	
Shrubs						
Hyd / Sno	18	Hydrangea arborescens 'Grandiflora'	Snowhill Hydrangea	15"-18"	Cont.	
Ros / Kno	8	Rosa x Knockout	Knockout Rose	15"-18"	Cont.	
Spi / Ant	8	Spirea bumalda 'Anthony Waterer'	Anthony Waterer Spirea	15"-18"	Cont.	
Perennials						
Cal / Kar	18	Calamagrostis acutiflora 'Karl Foerster'	Karl Foerster Reed Grass	1 gallon	Cont.	
Hem / Hyp	38	Hemerocalis x Hyperion	Hyperion Daylily	1 gallon	Cont.	
Lon / Hec	4	Lonicera x Heckrottii	Goldflame Honeysuckle	1 gallon	Cont.	
Nep / Wal	48	Nepeta x faassenii 'Walker's Low'	Walker's Low Catmint	1 gallon	Cont.	
Pan / Hea	10	Panicum virgatum 'Heavy Metal	Heavy Metal Switch Grass	1 gallon	Cont.	
Per / mix	80	Perennials-mix	Variety mix	1 gallon	Cont.	
Sch / sco	14	Schizachyrium scorparium	Little Bluestem	1 gallon	Cont.	

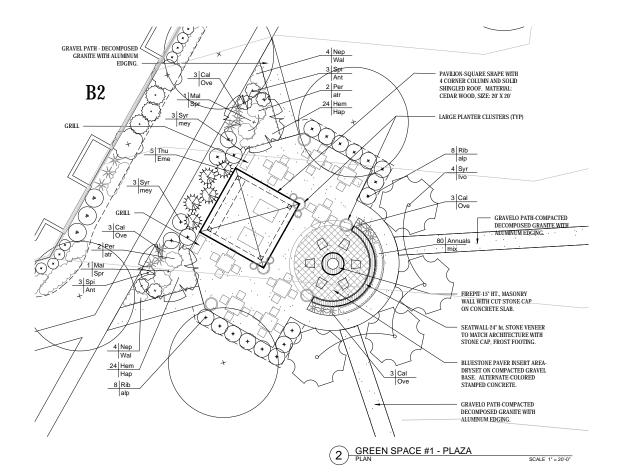

		PLANT S	CHEDULE - DETAIL # 2			
CODE	QTY	BOTANICAL NAME	COMMON NAME	SIZE	ROOT	NOTES
Orn Tree		•		•		
Mal / Spr	2	Malus x Spring Snow	Spring Snow Crab	1 ½"-2"	BB	
Syr / Ivo	4	Syringa recticulata 'Ivory Silk'	Ivory Silk Japanese Tree Lilac	1 ½"-2"	BB	
Evergreen						
Bux / GrV	4	Buxus x Green Velvet	Green Velvet Boxwood	18"-24"	Cont.	
Jun/Kal	6	Juniperus chinensis 'Kallay's'	Kallay's Compact Juniper	18"-24"	Cont.	
Pic / Nid	8	Picea abies 'Nidiformis'	Nest Spruce	18"-24"	Cont.	
Thu / Eme	5	Thuja occidentalis 'Smargd'	Emerald Green Arborvitae			
Shrubs						
Hyd / Sno	18	Hydrangea arborescens 'Grandiflora'	Snowhill Hydrangea	15"-18"	Cont.	
Rib / alp	16	Ribes alpinum	Alpine Currant	15"-18"	Cont.	
Ros / Kno	8	Rosa x Knockout	Knockout Rose	15"-18"	Cont.	
Spi / Ant	6	Spirea bumalda 'Anthony Waterer'	Anthony Waterer Spirea	15"-18"	Cont.	
Syr / mey	6	Syringa meyeri 'Palibin'	Dwarf Korean Lilac			
Perennials						
Cal / Kar	18	Calamagrostis acutiflora 'Karl Foerster'	Karl Foerster Reed Grass	1 gallon	Cont.	
Cal / Ove	9					
Hem / Hyp	48	Hemerocalis x Hyperion	Hyperion Daylily	1 gallon	Cont.	
Lon / Hec	4	Lonicera x Heckrottii	Goldflame Honeysuckle	1 gallon	Cont.	
Nep / Wal	8	Nepeta x faassenii 'Walker's Low'	Walker's Low Catmint	1 gallon	Cont.	
Pan / Hea	10	Panicum virgatum 'Heavy Metal	Heavy Metal Switch Grass	1 gallon	Cont.	
Per / atr	4	Perovskia atriplicifolia	Russian Sage			
Per / mix	80	Perennials-mix	Variety mix	1 gallon	Cont.	
Sch / sco	14	Schizachyrium scorparium	Little Bluestem	1 gallon	Cont.	



J LA ***CALLECTS ** Planners

JLA PROJECT NUMBER:





www.thesigmagroup.con 1300 West Canal Street Milwaukee, WI 53233 Phone: 414-643-4200 Fax: 414-643-4210



PUD-SIP Submittal

22 SLATE APARTMENTS

5401 TANCHO DRIVE MADISON, WI

PROGRESS DOCUMENTS


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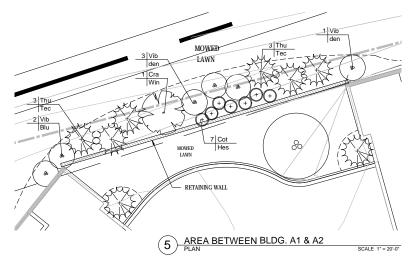
DATE OF IS	SUANCE	JANUA	RY 6, 2016				
	REVISION SCHEDULE						
Mark	Description	on	Date				
SHEET TITI	E						

LANDSCAPE PLAN GREENS SPACE AND COMMON AREA DETAILS


SHEET NUMBER


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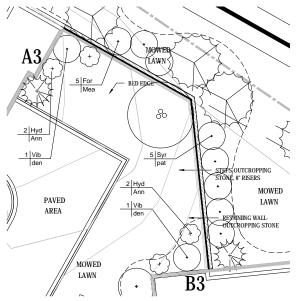


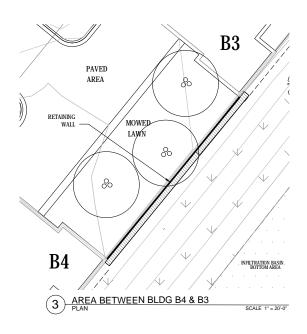

PLANT SCHEDULE - DETAIL # 5									
CODE	QTY	BOTANICAL NAME	SIZE	ROOT	NOTES				
vergreen				_					
Thu / Tec	6	Thuja occidentalis "Techny"	Techny arbortive	18"-24"	Cont.				
Trees									
Cra / Win	1	Crataegus crusgalli "Winter King"	Winter King Hawthorne	1 ½" -2" caliper	B &B				
Shrubs									
Cot / Hes	7	Cotoneaster 'Hessei'	Hester Cotoneaster	15"-18"	Cont.				
Vib / Blu	2	Viburnum dentatum 'Blue Muffin'	Blue Muffin Viburnum	15"-18"	Cont.				
Vib / Den	4	Viburnum dentatum	Arrowwood Viburnum	3'-4'	Cont.				



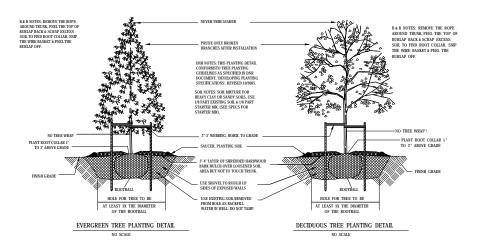

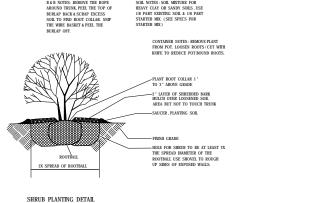

4 AREA BETWEEN BLDG A3 & B3

SCALE 1" = 20'-0"

PLANT SCHEDULE - DETAIL # 4										
CODE	CODE OTY BOTANICAL NAME COMMON NAME SIZE ROOT NOTES									
	QII	BOTANICAL NAME	COMMON NAME	SIZE	KOOT	NOTES				
Shrubs										
For / Mea	3	Forsythia x Meadowlark	Meadowlark Forsythia	30"-36"	Cont.					
Hyd / Ann	4	Hydrangea arborscens 'Annabelle'	Annabelle Hydrangea	15"-18"	Cont.					
Syr / pat	8	Syringa patula	Miss Kim Lilac	24"-30"	Cont.					
Vib / den	2	Viburnum dentatum	Arrowwood Viburnum	3'-4'	Cont.					

LANDSCAPE INSTALLATION NOTES

- The Landscaping Contractor shall verify location of all underground utilities and additional information prior to installation of all landscaping. Call Digger's Hotline.
- Rough grading and drainage shall be completed prior to Landscape Contractor's commensing work. Verify all existing site and grading conditions prior to construction.
- 3. All landscape work shall be in conformance with all applicable local codes & ordinances.
- 4. All areas disturbed by grading or site construction shall be fine graded , planted or seeded.
- Contractor shall verify plant quantities shown on plan and provide a list to the Architect identifying the species
 and sized to be used throughout the project. The Landscape Architect reserves the right to reject any
 sub-standard planting material. Such rejected material shall be removed from the project stei immediately.
 All planting beds shall receive a blended topsoil mix to a depth of 6° and turf areas a depth of 3°. Contractor shall
 provide positive drainage away from all buildings for a minimum of 10°. Remove excessive clay, gravel & stones
 which would be detrimental to healthy plant growth. Roto-til new topsoil into existing soil.
- All perennial and groundcover areas shall receive a blend of organic soil amendments prior to planting.
 Roto-til the amendments into the new topsoil to a depth of 6*. Avoid damage to existing tree roots where applicable by lightly working amendments into soil with pitch fork

2 inch cover of plant starter soil mix 1/2 lb. of 5-10-5 garden fertilizer (Ozmocote or Milorganite)

- 8. All perennial and groundcover areas shall receive a 1-2" layer of finely shredded bark mulch. Do not allow mulch to touch stems or leaves of perennials! All woody planting areas shall receive a 3" layer. Unless otherwise noted, no landscape fabric or weed barrier is to be installed.
- Unless otherwise shown, all perennials & shrubs shall be planted in a triangular arrangement. For plants not shown individually, refer to the spacing shown in the plant schedule.
- 10. All areas indicated as Maintenenace border beds shall be covered with a 2.5" cover of Mississippi aggregate (Source: Kafka Stone) over landscape fabric underlayment and aluminum edging. Color of Spardust to be approved by owner.
- All planting and maintenance beds shall be edged with aluminum edging Permaloc Clean Line, Size: 1/8" x 4" x 16', Finish: mill or approved equal. SEED MIXES (See plans for locations)

SEEDED MOWED TURF:
"Dehx 50 Lawn Seed Mix"
Available from Rheinders (800) 785-3301
Shall be installed & maintained per supplier's specifications.

20% Kentucky Bluegrass 25% Creeping Red Fescue 15% Bluebonnet Kentucky Bluegrass 15% Quebec Perennial Ryegrass 15% Kenblue Kentucky Bluegrass 10% Wicked Perennial Ryegrass SHORT GRASS / WILDFLOWER AREA / DETENTION BASINS

Short Grass's Willipflower & Grass Mix"
Available from Reinders Sussex, WI
Phone 1-800-785-3301 / Or approved equal.
To be installed & maintained per supplier's specification

NATIVE WETLAND MIX - INFILTRATION BOTTOM Native Wetland Mix'
Available from Reinders Sussex, WI
Phone 1-800-785-3301 / Or approved equal
To be installed & maintained per supplier's specifications.



JLA PROJECT NUMBER:





www.thesigmagroup.cor 1300 West Canal Street Milwaukee, WI 53233 Phone: 414-643-4200 Fax: 414-643-4210



PUD-SIP Submittal

22 SLATE **APARTMENTS**

5401 TANCHO DRIVE

PROGRESS DOCUMENTS

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DATE OF ISSUANCE REVISION SCHEDULE

SHEET TITLE

(N)

GRAPHIC SCALE

AREA BETWEEN BLDG NOTES & DETAILS

SHEET NUMBER

L 103




CALL DIGGERS HOTLINE 1-800-242-8511 TOLL FREE

WS STATUTE 182.0175(1974) REQUIRES MN. 3 WORK DAYS NOTICE BEFORE YOU EXCAVATE MILW. AREA 259-1181

THE UNDERGROUND UTILITY INFORMATION SHOWN ON THIS MAP IS BASED ON FIELD MARKINGS AND INFORMATION FURNISHED BY UTILITY COMPANIES AND THE LOCAL MUNICIPALITY. WHILE THIS INFORMATION IS BELIEVED TO BE RELIABLE, ITS ACCURACY AND COMPLETENESS CANNOT BE GUARANTEED.

SHRUB PLANTING DETAIL

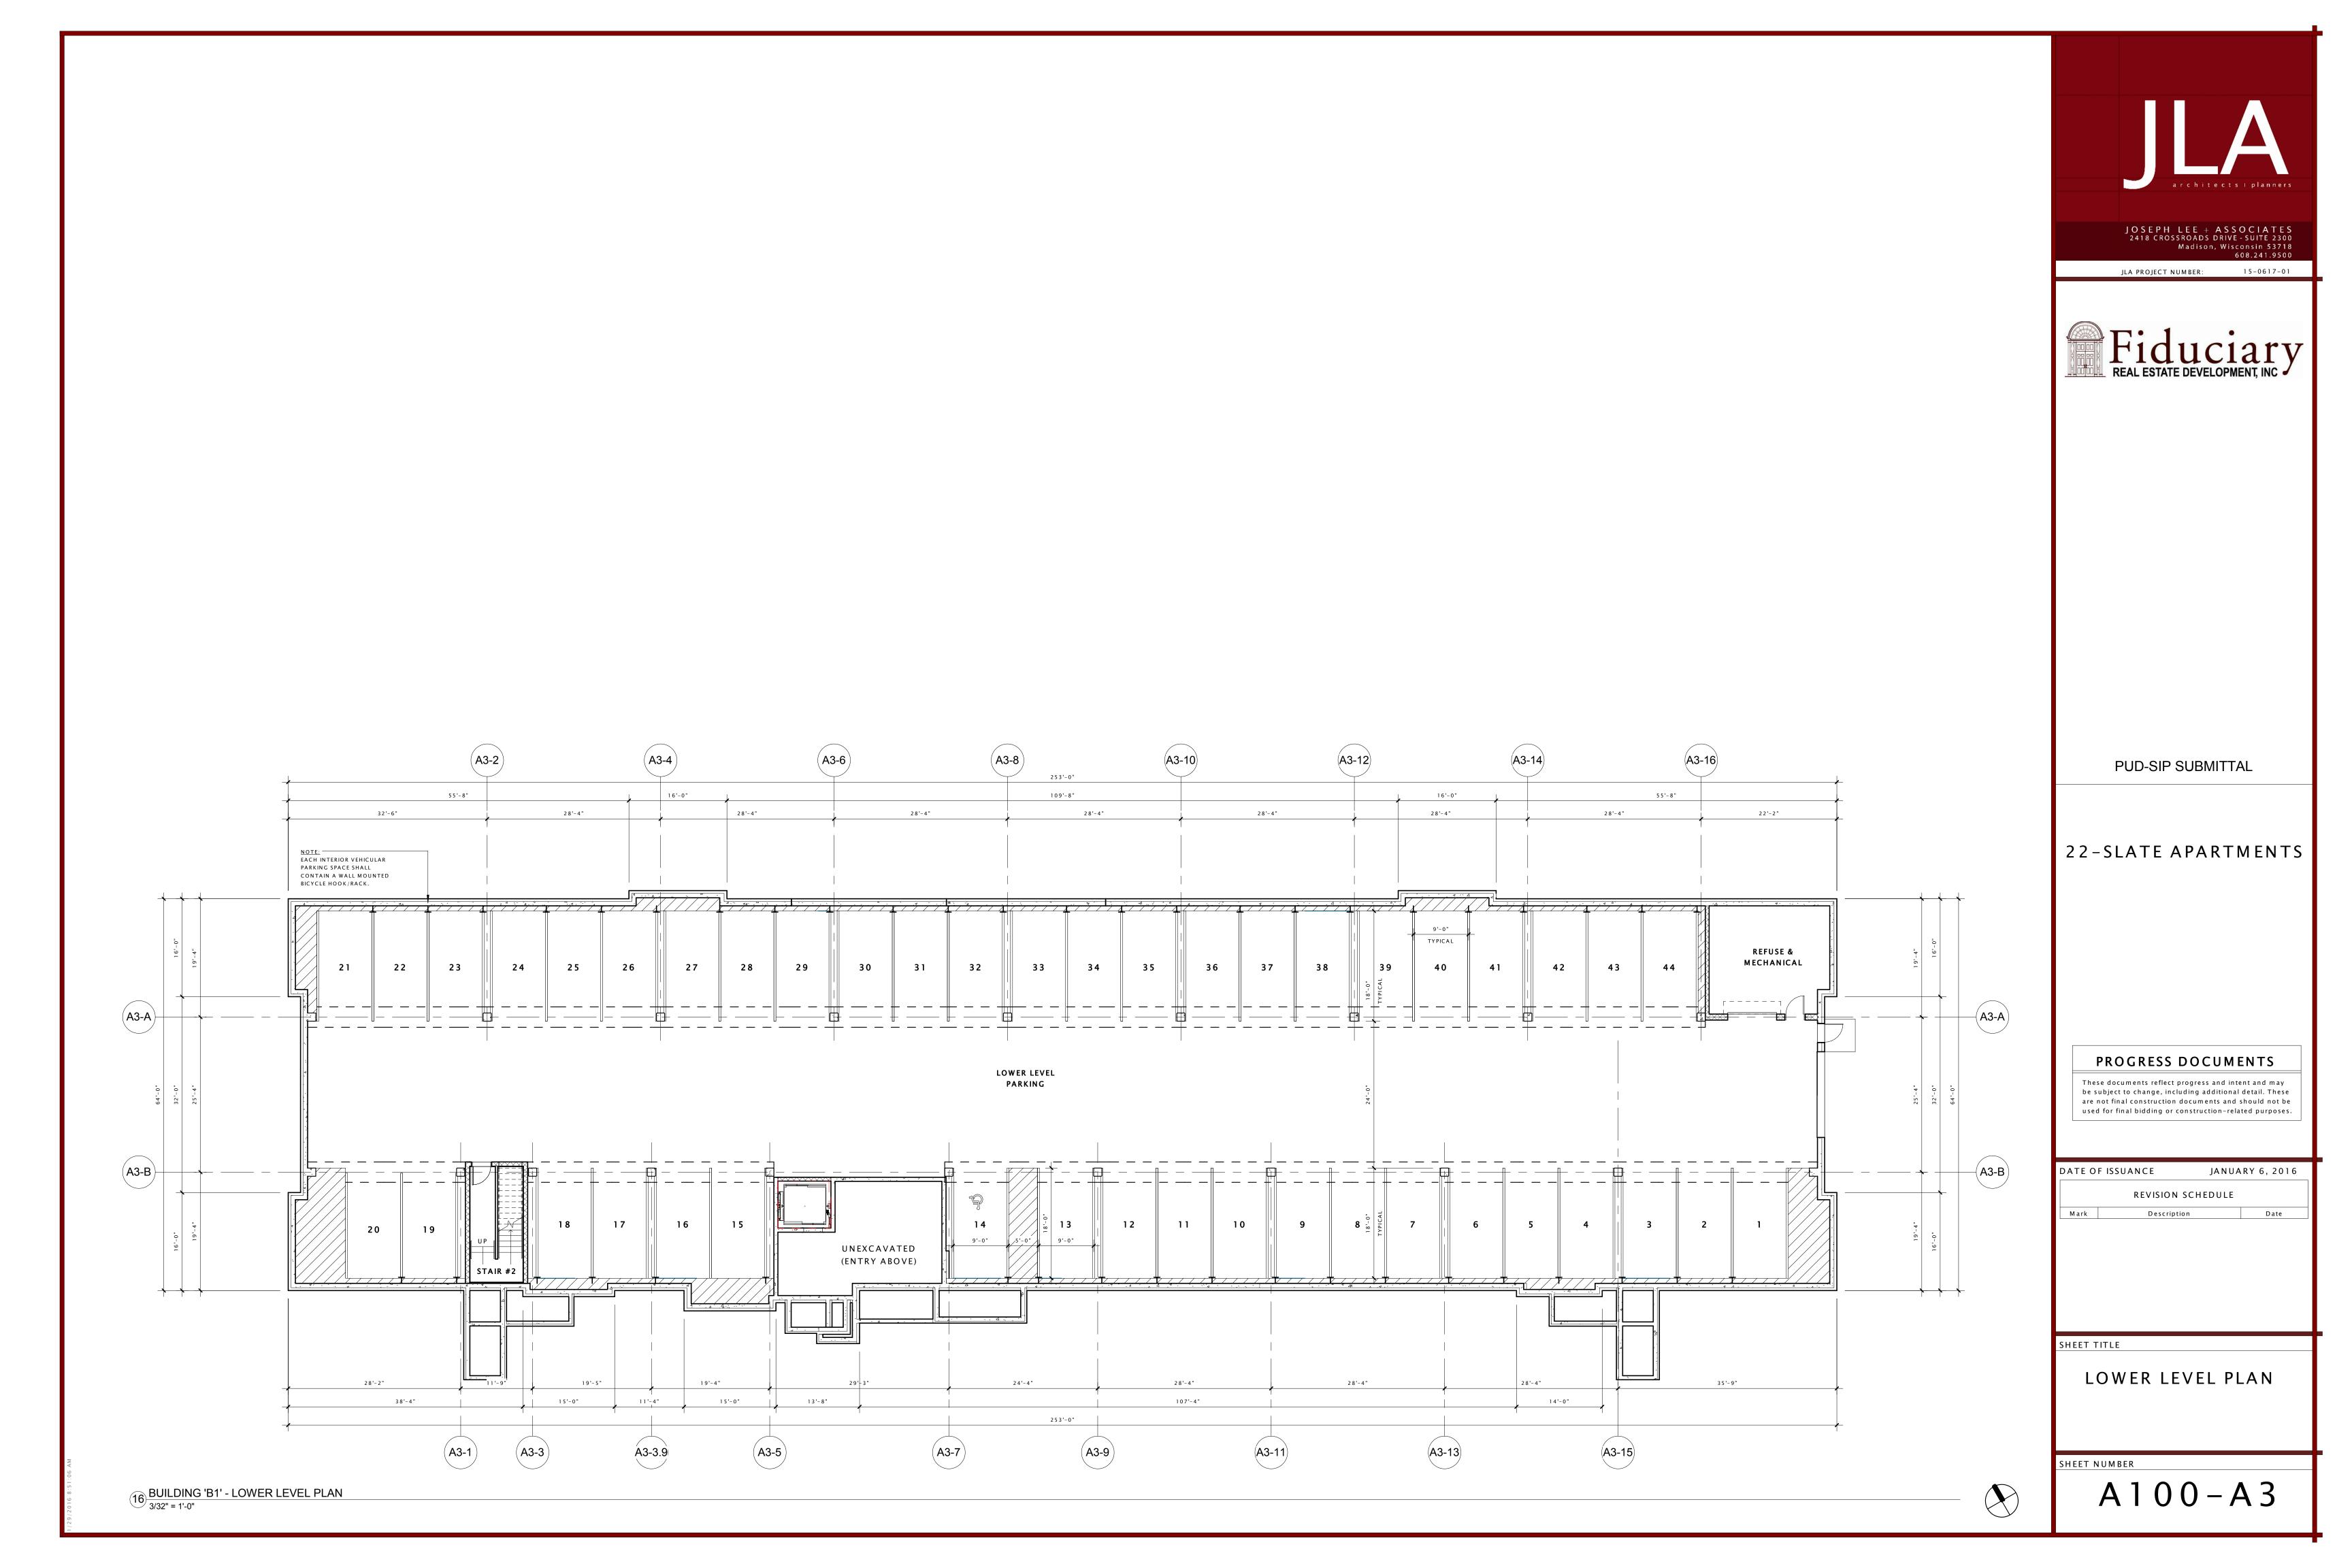



JLA PROJECT NUMBER: 15-0617-01



PUD-SIP SUBMITTAL

22-SLATE APARTMENTS

PROGRESS DOCUMENTS

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DATE OF ISSUANCE JANUARY 6, 2016

REVISION SCHEDULE

Mark Description Date


SHEET TITLE

FIRST FLOOR PLAN

SHEET NUMBER

A101-A3



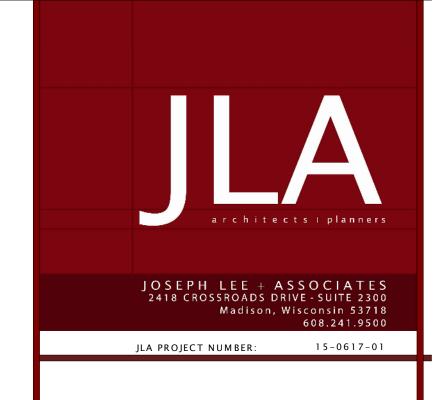

Fiduciary REAL ESTATE DEVELOPMENT, INC

PUD-SIP SUBMITTAL

22-SLATE APARTMENTS

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REVISION SCHEDULE

Mark Description Date

SHEET TITLE

SECOND FLOOR PLAN

SHEET NUMBER

A102-A3







JLA PROJECT NUMBER: 15-0617-01



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22-SLATE APARTMENTS

PROGRESS DOCUMENTS

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SHEET TITLE

THIRD FLOOR PLAN

SHEET NUMBER

A103-A3

16 BUILDING 'B1' - THIRD FLOOR PLAN
3/32" = 1'-0"







JLA PROJECT NUMBER: 15-0617-01



PUD-SIP SUBMITTAL

22-SLATE APARTMENTS

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ATE O	FISSUANCE	JANUARY 6, 2016
	REVISION SCI	HEDULE
Mark	Description	Date

SHEET TITLE

EXTERIOR ELEVATIONS

SHEET NUMBER

A 2 0 0 - A



6 TYPICAL 'A' BUILDING - REAR ELEVATION
3/32" = 1'-0"



JOSEPH LEE + ASSOCIATES
2418 CROSSROADS DRIVE - SUITE 2300
Madison, Wisconsin 53718
608.241.9500

JLA PROJECT NUMBER: 15-0617-01



PUD-SIP SUBMITTAL

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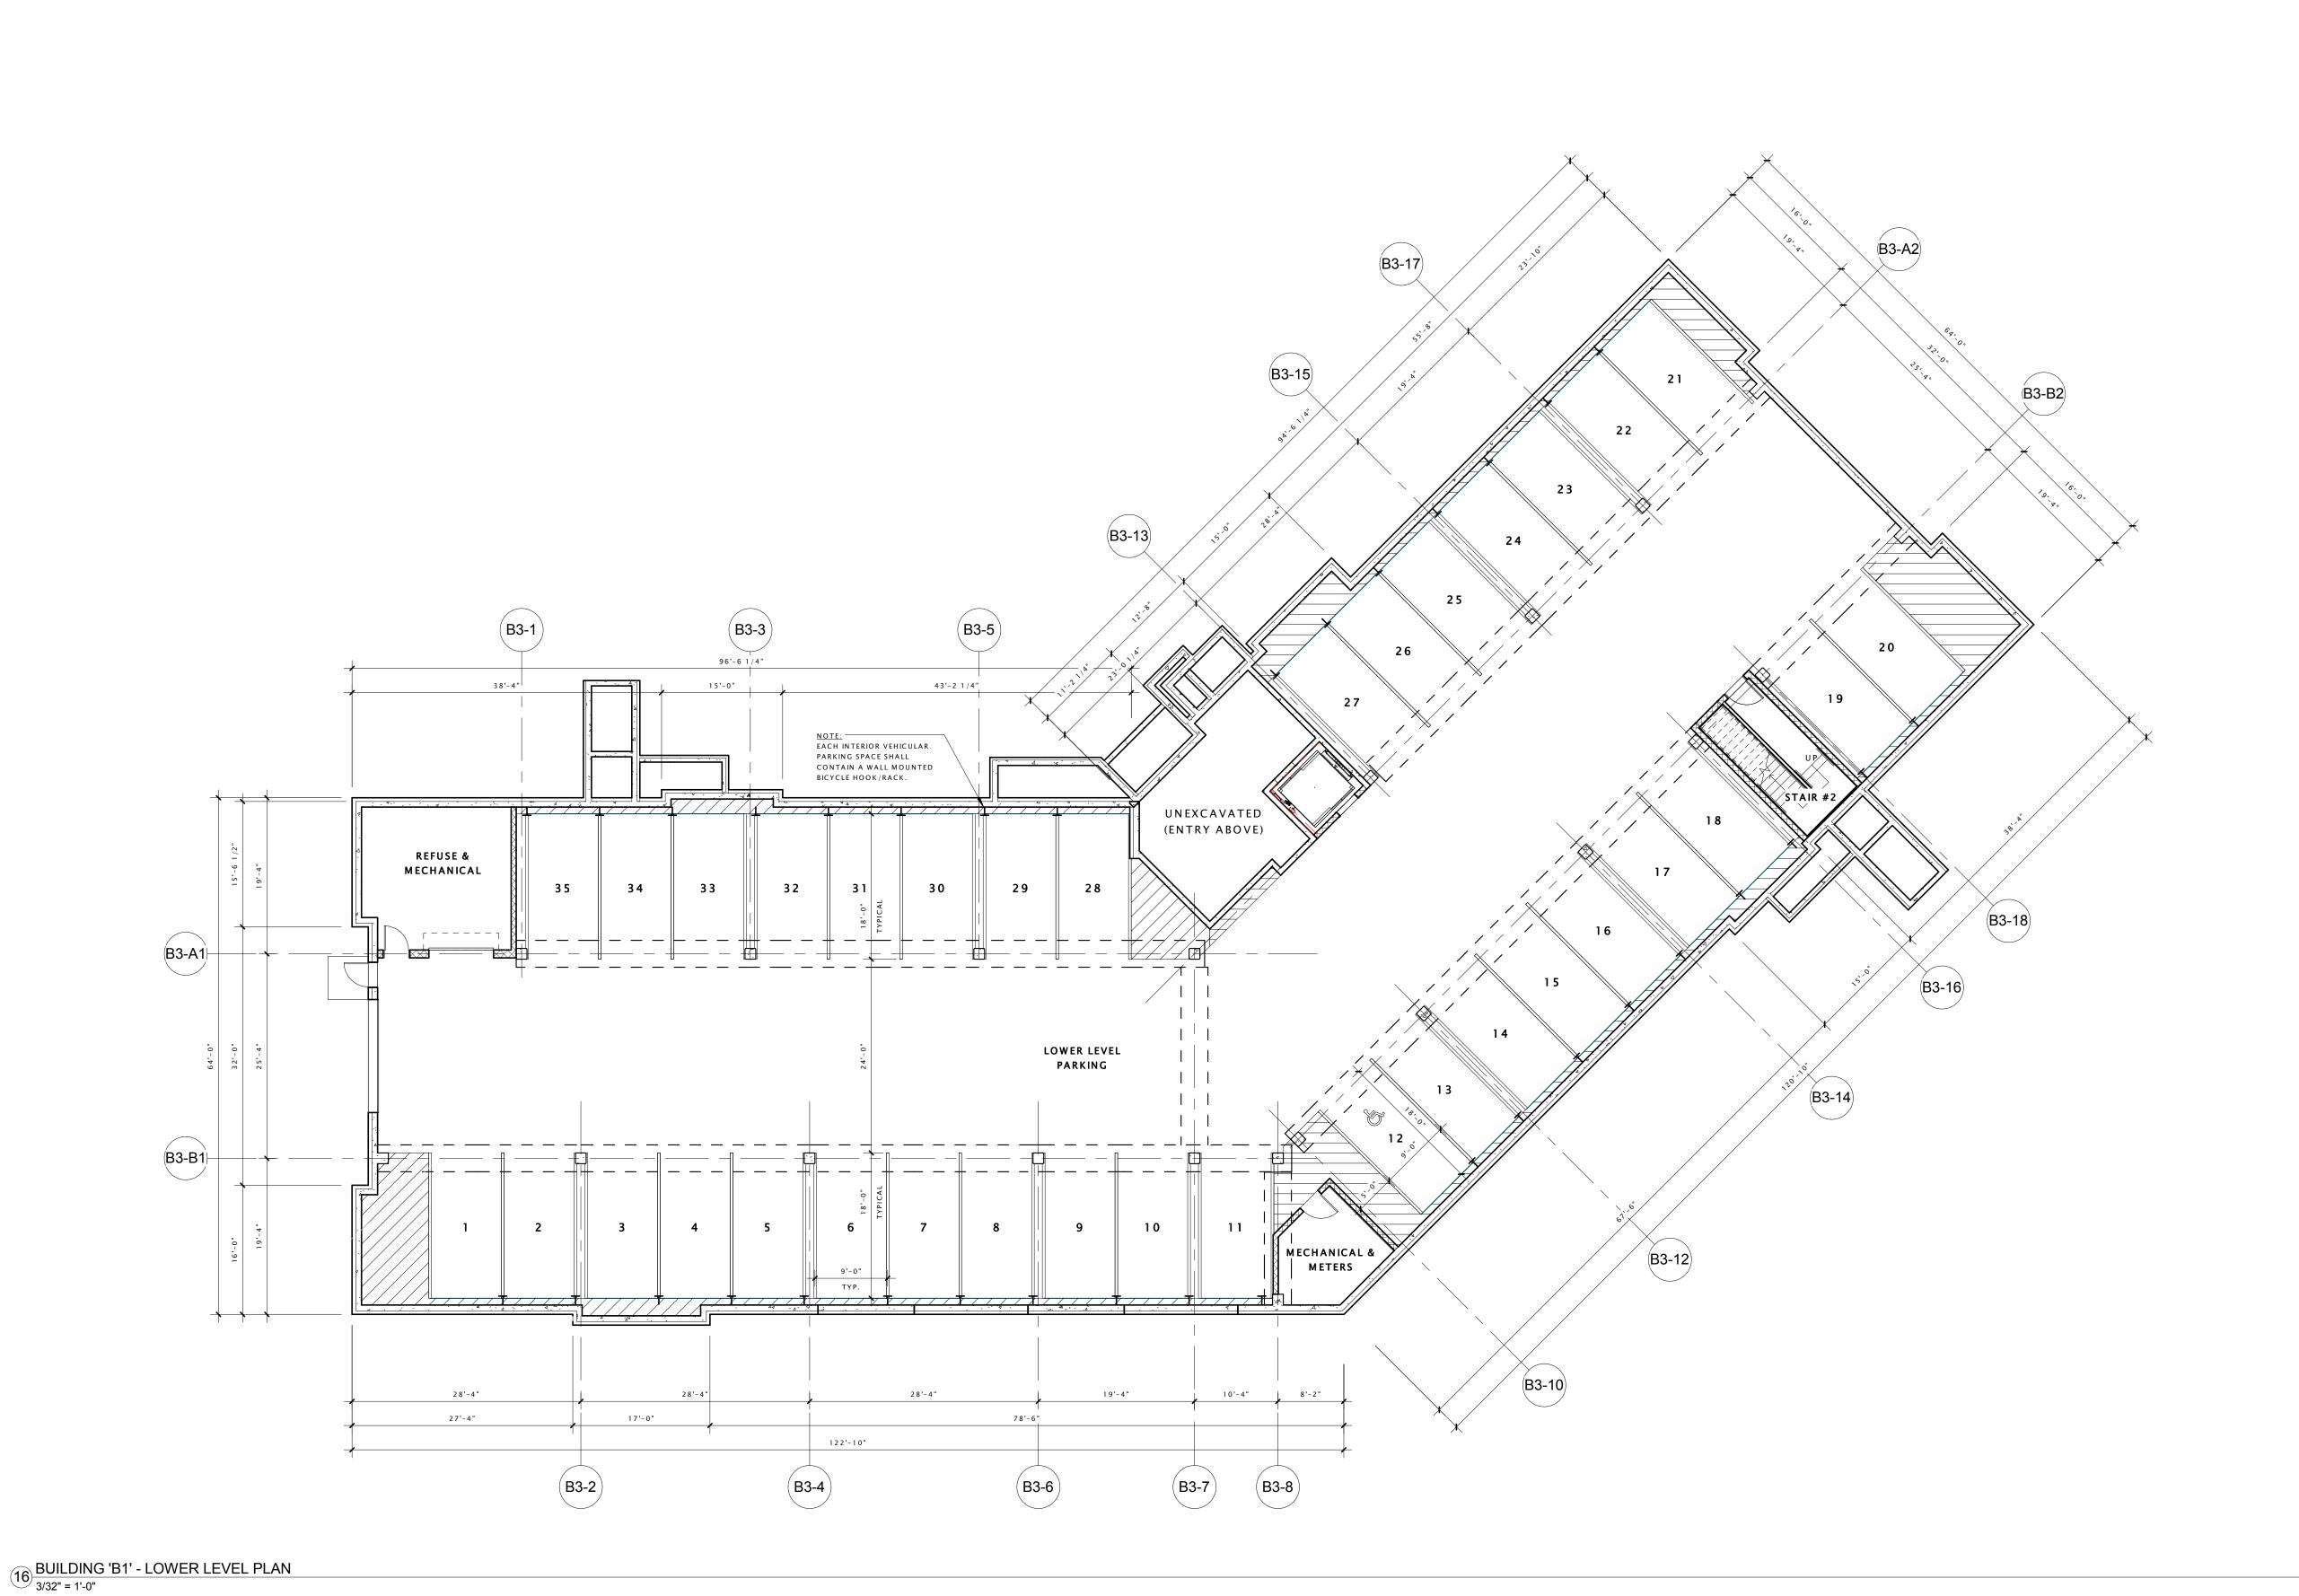
Mark Description Date

SHEET TITLE

EXTERIOR ELEVATIONS

SHEET NUMBER

A 2 0 1 – A





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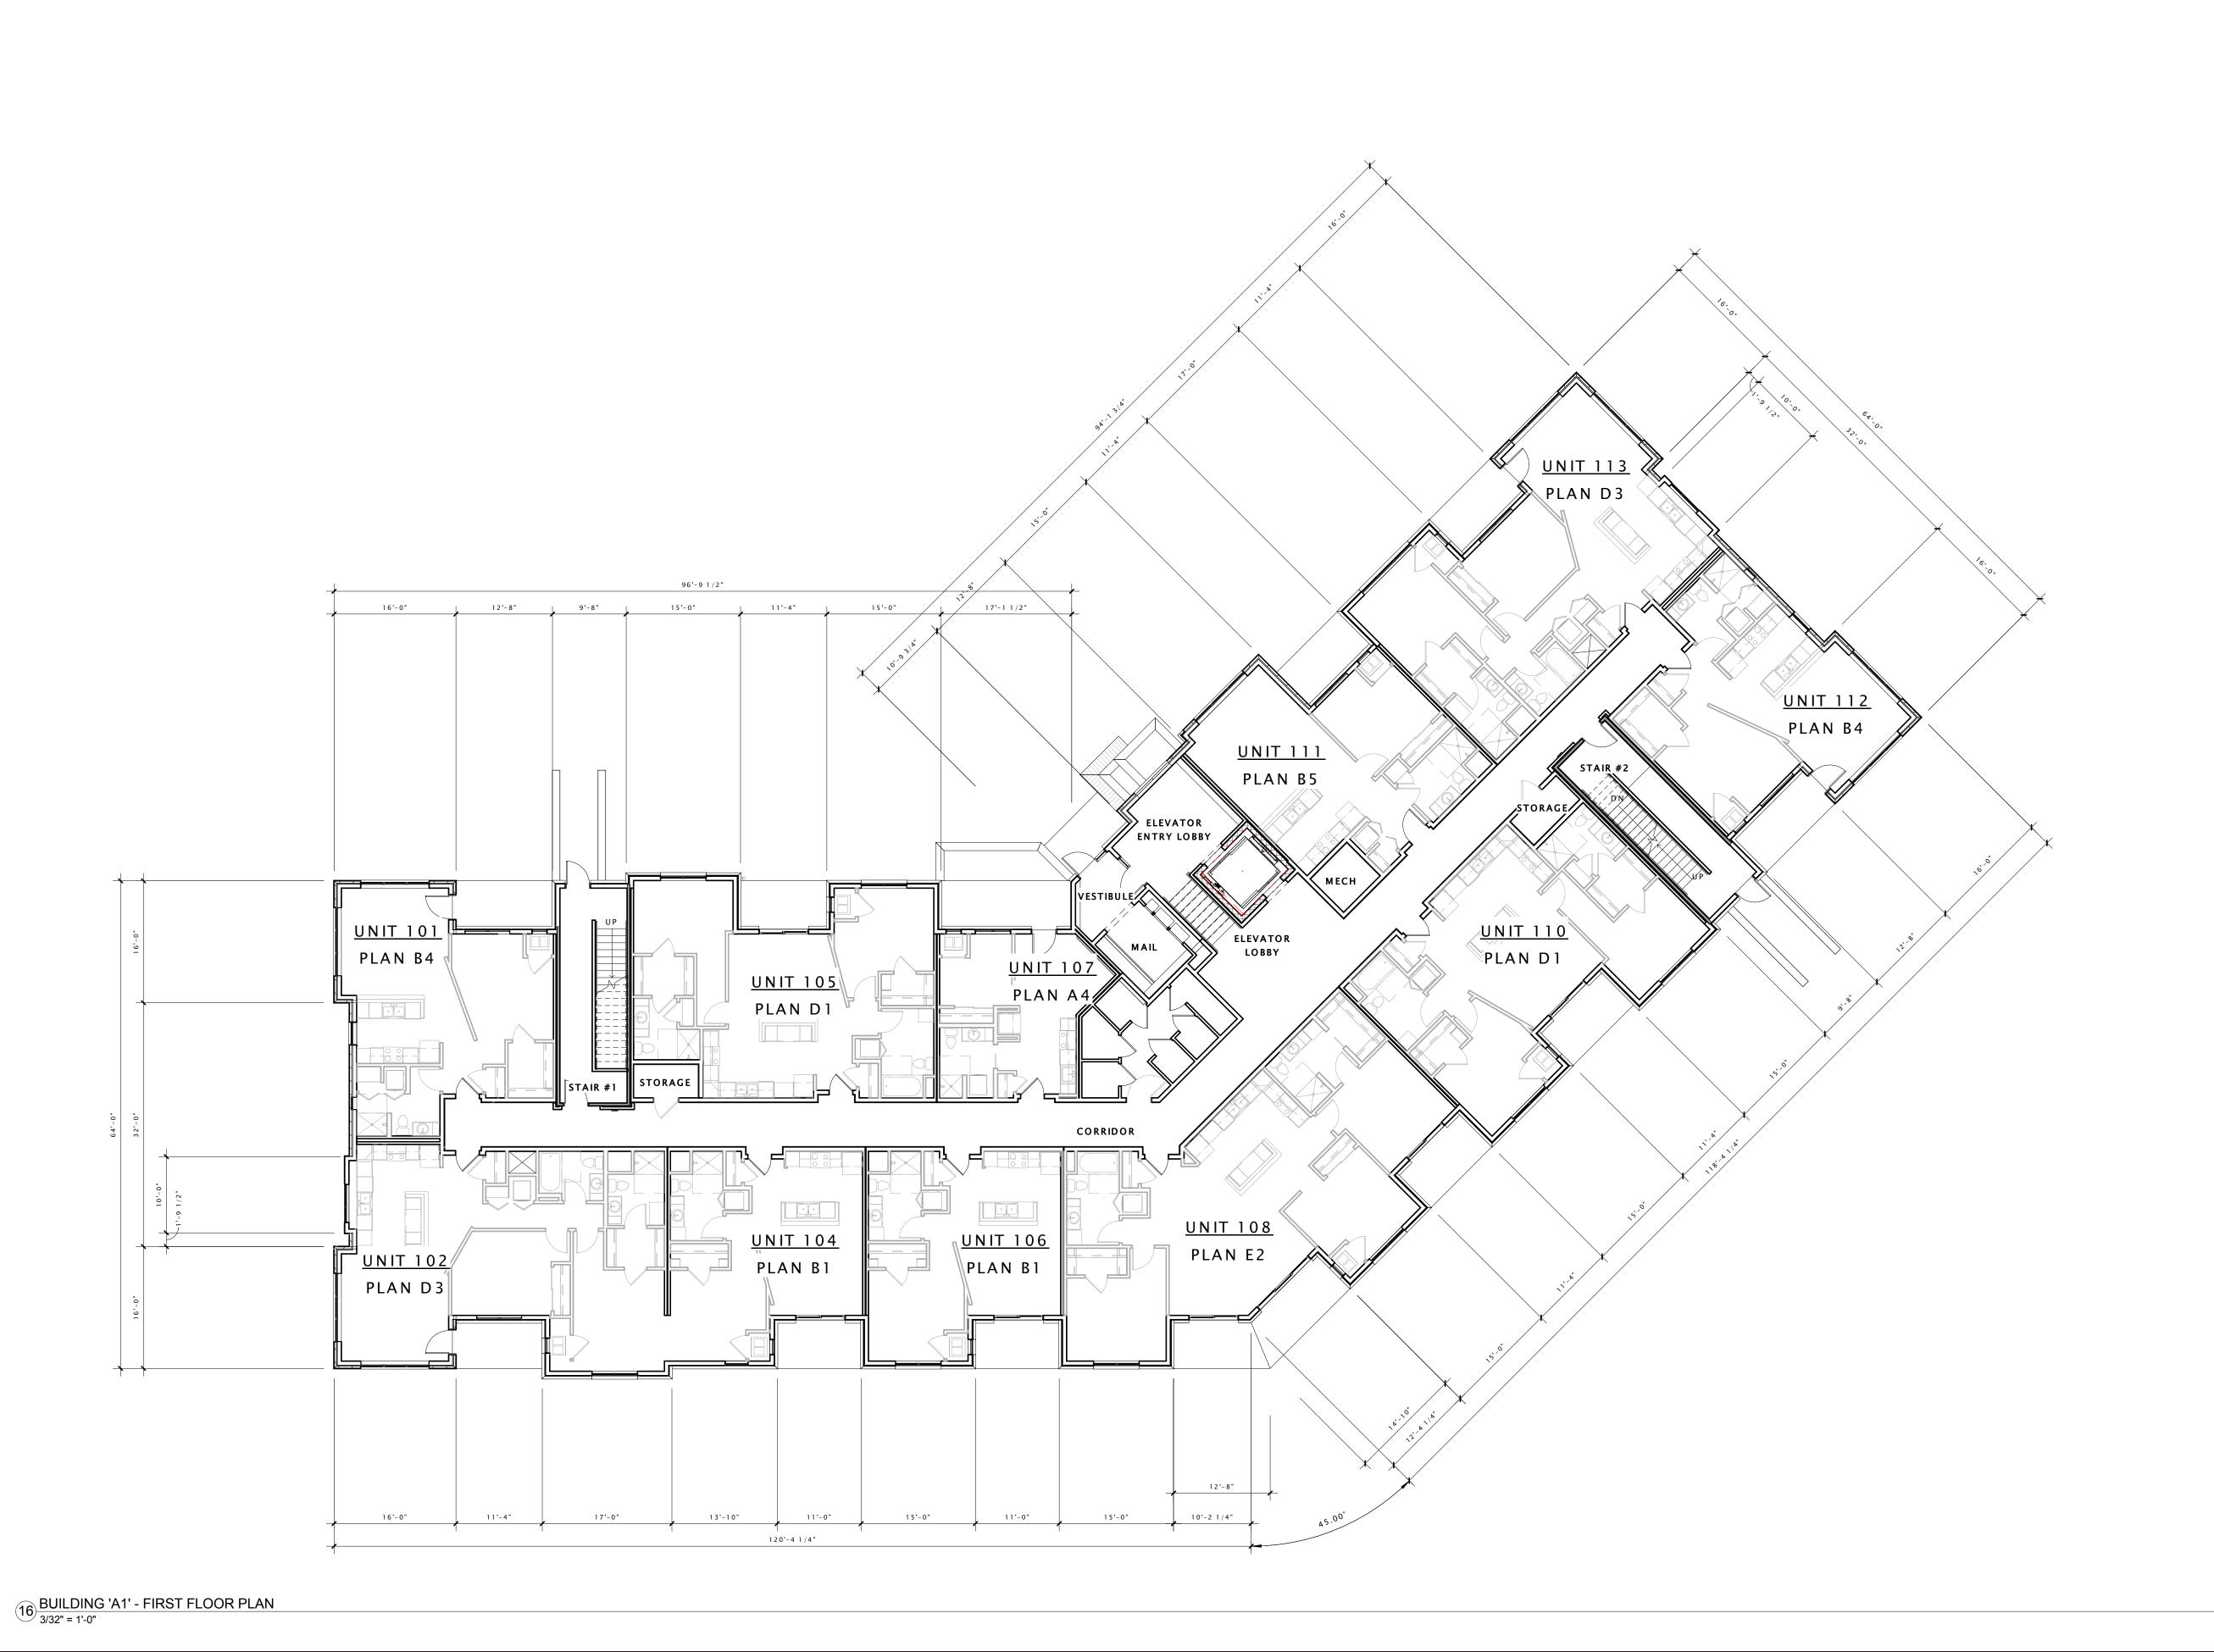
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	REVISION SCHEDULE					
Mark	Description	l	Date			

SHEET TITLE

LOWER LEVEL PLAN

SHEET NUMBER

A 1 0 0 – B 3







15-0617-01

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REVISION SCHEDULE

Mark Description Date

SHEET TITLE

FIRST FLOOR PLAN

SHEET NUMBER

A 1 0 1 – B 3







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REVISION SCHEDULE

Mark Description Date

SHEET TITLE

SECOND FLOOR PLAN

SHEET NUMBER

A 1 0 2 – B 3







15-0617-01

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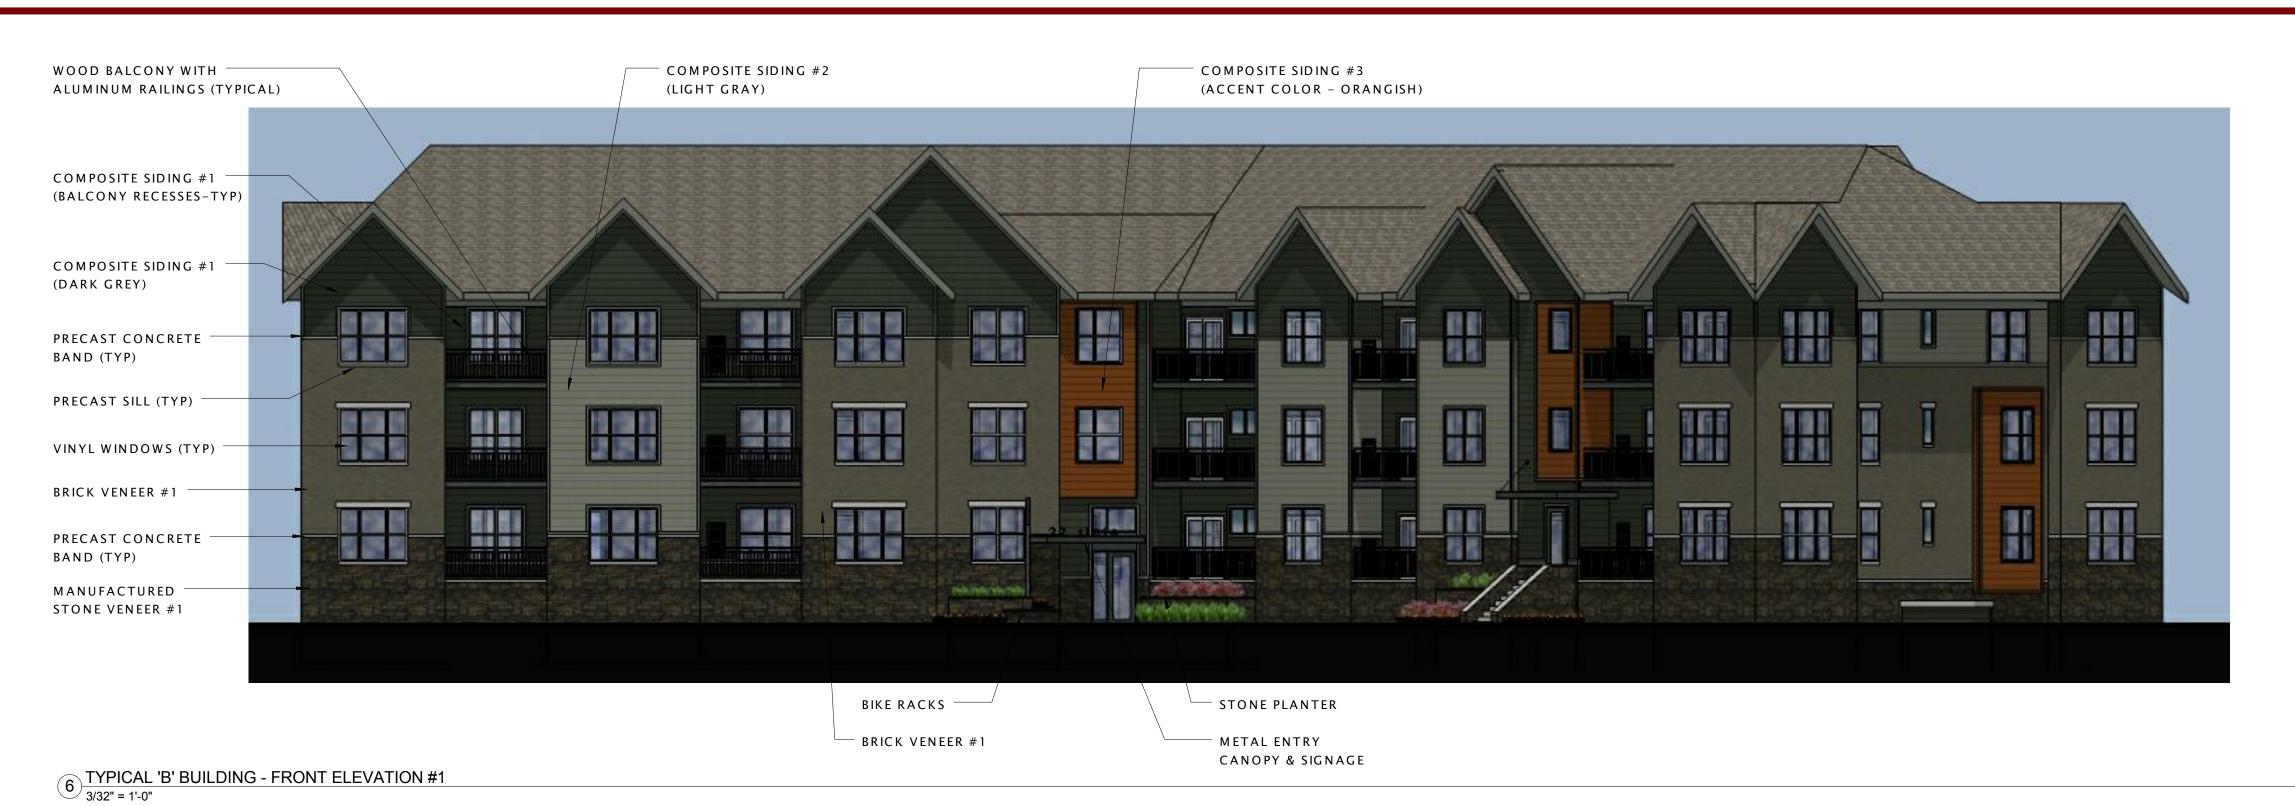
SHEET TITLE

THIRD FLOOR PLAN

SHEET NUMBER

A 1 0 3 - B 3

BUILDING 'B1' - THIRD FLOOR PLAN
3/32" = 1'-0"



COMPOSITE SIDING #3 COMPOSITE SIDING #2 WOOD BALCONY WITH (ACCENT COLOR - ORANGISH) (LIGHT GRAY) ALUMINUM RAILINGS (TYPICAL) COMPOSITE SIDING #1 (BALCONY RECESSES-TYP) COMPOSITE SIDING #1 (DARK GREY) PRECAST CONCRETE 8 2 5 BAND (TYP) PRECAST SILL (TYP) VINYL WINDOWS (TYP) BRICK VENEER #1 SER SAIL PRECAST CONCRETE BAND (TYP) MANUFACTURED STONE VENEER #1

METAL ENTRY CANOPY & SIGNAGE

STONE PLANTER ————

COMPOSITE SIDING #1 (DARK GREY) COMPOSITE SIDING #2 (LIGHT GRAY) PRECAST CONCRETE BAND (TYP) COMPOSITE SIDING #3 (ACCENT COLOR - ORANGISH) PRECAST SILL (TYP) METAL ENTRY — VINYL WINDOWS (TYP) CANOPY & SIGNAGE BRICK VENEER #1 PRECAST CONCRETE BAND (TYP) MANUFACTURED STONE VENEER #1

JOSEPH LEE + ASSOCIATES
2418 CROSSROADS DRIVE - SUITE 2300
Madison, Wisconsin 53718
608.241.9500

JLA PROJECT NUMBER: 15-0617-01



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SHEET TITLE

EXTERIOR ELEVATIONS


SHEET NUMBER

A 2 0 0 - B

TYPICAL 'B' BUILDING - FRONT ELEVATION #2
3/32" = 1'-0"



6 TYPICAL 'B' BUILDING - REAR ELEVATION #1

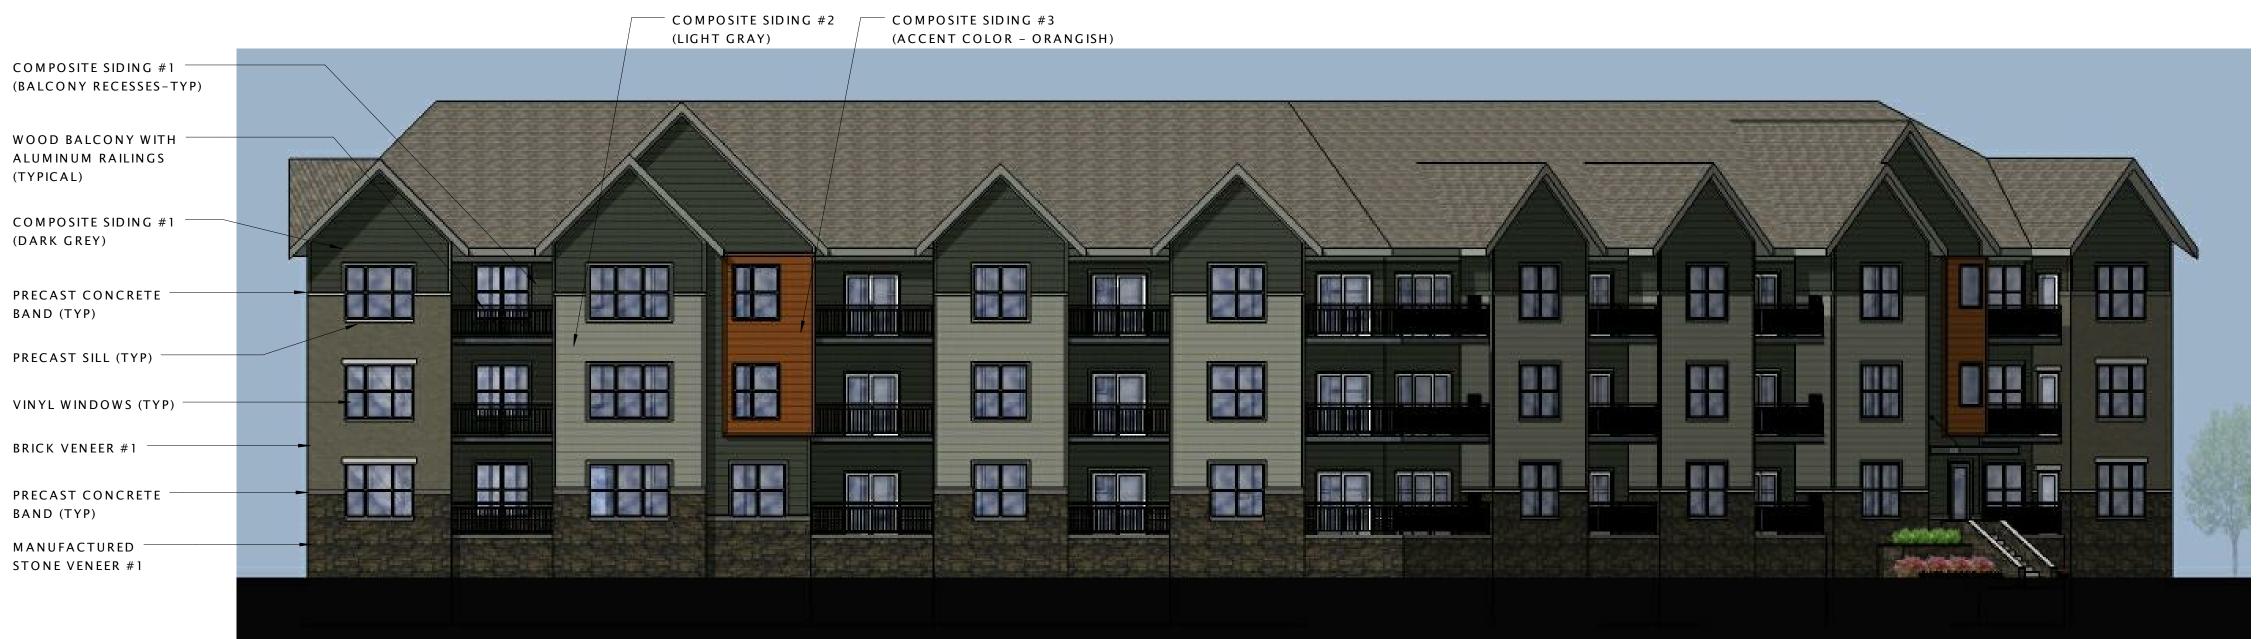



JOSEPH LEE + ASSOCIATES 2418 CROSSROADS DRIVE - SUITE 2300 Madison, Wisconsin 53718 608.241.9500

JLA PROJECT NUMBER: 15-0617-01



PUD-SIP SUBMITTAL

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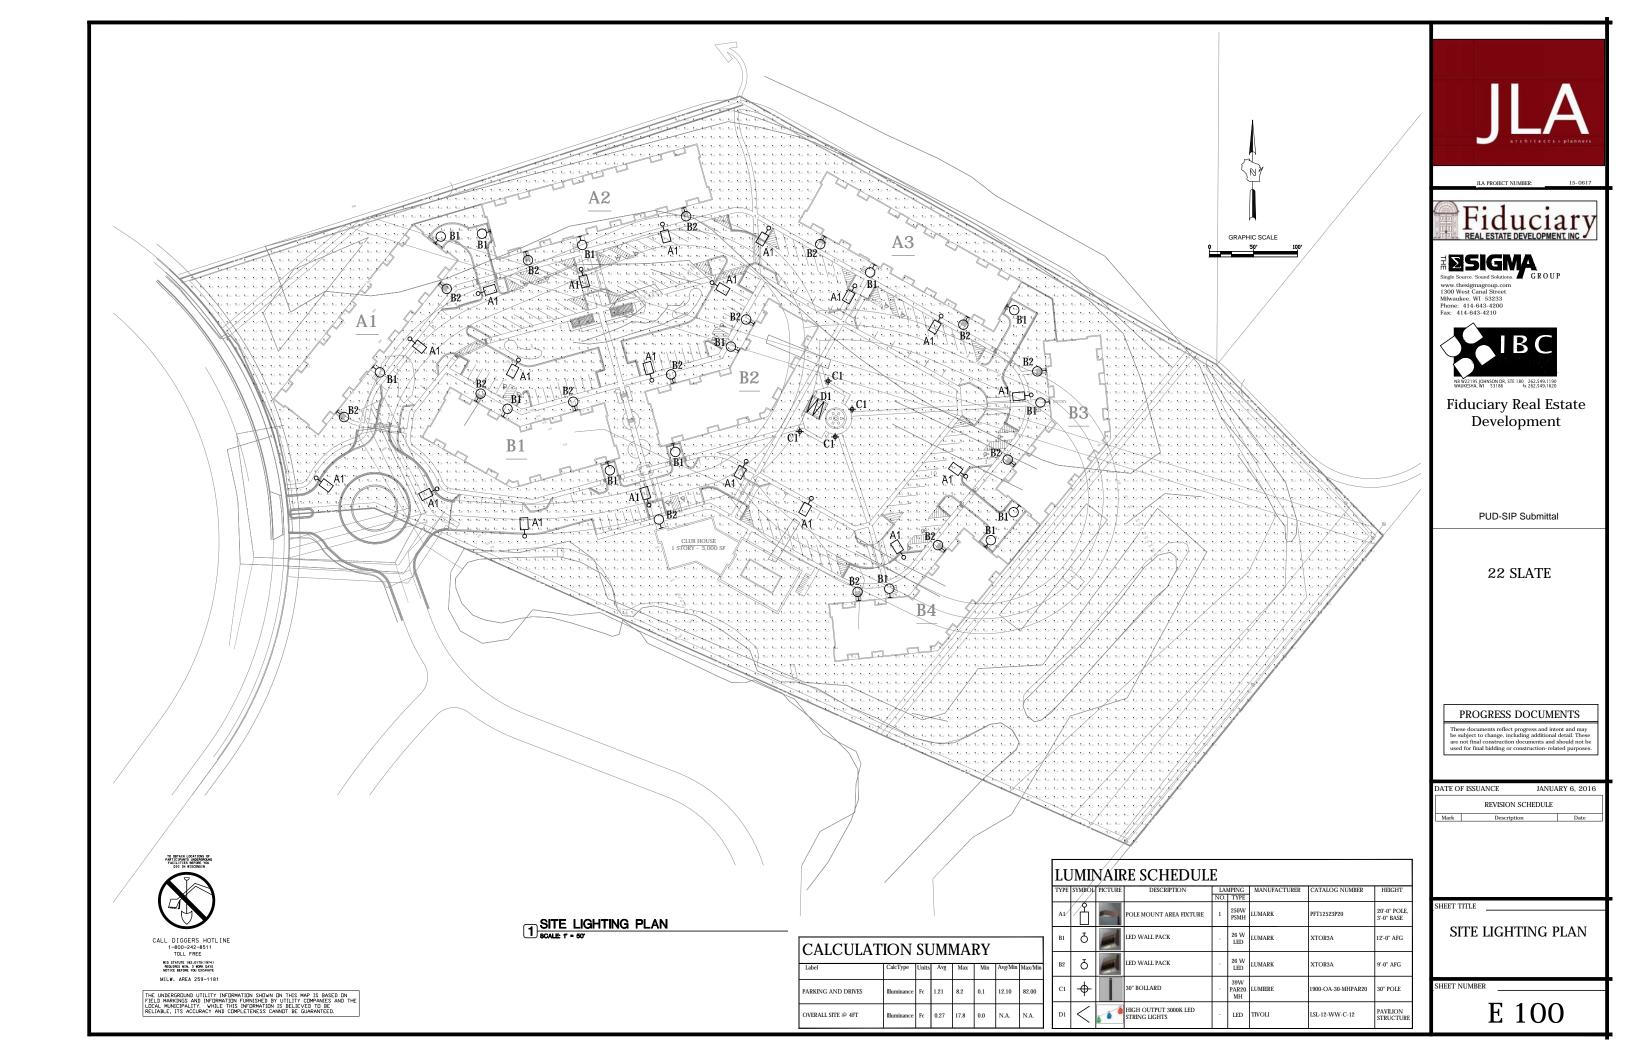
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REVISION SCHEDULE									
Mark Description Date									

SHEET TITLE

EXTERIOR ELEVATIONS


SHEET NUMBER

A 2 0 1 - B



DESCRIPTION

The Tribute Pole and Fixture Combo features all you need for easy selection and installation for poles and fixtures. Including the quality die-cast Tribute area luminaire and 8" arm complete with lamp, square straight steel pole and necessary anchorage. Available in single and dual fixture combinations. The Tribute and Pole Combo is ideal for parking areas, access roadways and other general off street area/site lighting applications.

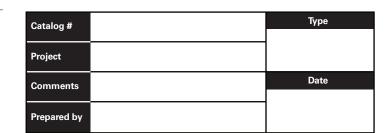

SPECIFICATION FEATURES

Construction

Rugged, one-piece, die-cast aluminum housing and door frame and one lock washer. Hardware finished in dark bronze polyester powder paint. One-piece silicone gasket protects the optical chamber from performance degrading contaminants. One stainless spring latch and two stainless steel hinges allow tool-less opening and removal of door frame. U.L. Listed and CSA certified for wet locations.

Pole

Shaft is one-piece construction ASTM A500 grade "B" steel, shot blasted and finished in dark bronze polyester powder coat. Anchor base is fabricated from ASTM grade steel. ASTM A366 steel full base cover is provided to enclose base plate and anchor bolts.

Anchor bolts are per ASTM A576 with two nuts, two flat washers, and threaded portion of bolt are hot dip galvanized. 3" hook for 3/4" bolt. 4" hook for 1" bolt.

Electrical

Ballast and related electrical componentry are hard mounted to die-cast housing for optimal heat transfer and operating efficiency.

Reflector

Hydroformed anodized aluminum eflector offered in an adjustable Type II/III or a Type IV distribution. Optical modules are field rotatable in 90° increments and offered standard with medium or mogulbase lampholders.

Mounting

Extruded 8" aluminum arm features internal bolt guides for easy positioning of fixture during installation to pole.

Finish

Housing and arm finished in a five-stage premium TGIC bronze polyester powder coat paint.

15' 20' 25' 30'



TRIBUTE AND POLE COMBO


TYPE A1

LUMARK®

150 - 400W **High Pressure Sodium Pulse Start Metal Halide**

POLE AND FIXTURE COMBO

DIMENSIONS

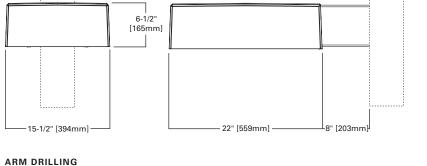

TYPE "M"

[59mm] 3/4" [19mm] Dia. Hole 2-7/16" [62mm] 4-7/8" [124mm]

WATT

Lamp Type	Wattage
Pulse Start Metal Halide	150, 250, 320, 400W
High Pressure Sodium	150, 250, 400W

Cooper Lighting

by **F**AT•N

16mm] s
Wattage
150, 250, 320, 400W
150, 250, 400W

CERTFICATIONS

UL Wet Location Listed CSA Certified EISA Compliant ®

ENERGY DATA Hi-Reactance Ballast Input Watts

150W HPS HPF (190 Watts) 150W MP HPF (185 Watts) **CWA Ballast Input Watts**

250W MP HPF (283 Watts) ®

250W HPS HPF (295 Watts) 320W MP HPF (365 Watts) ® 400W MP HPF (452 Watts) ® 400W HPS HPF (465 Watts)

EPA DATA

Effective Projected Area: (Sq. Ft.) Single Fixture: 1.59 Dual Fixture: 3.18

SHIPPING DATA

Approximate Net Weight: 39 lbs. (17.73 kgs.)



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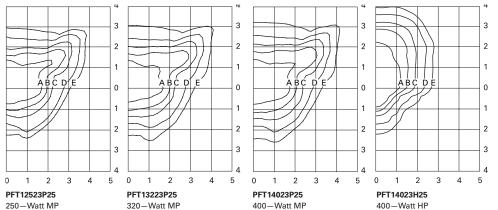




PHOTOMETRICS (COMPLETE IES FILES AVAILABLE AT WWW.COOPERLIGHTING.COM)

30,000-Lumen Clear Lamp

Type III Formed



40,000-Lumen Clear Lamp

Type III Formed

Footcandle Table

Select mounting height and read across for footcandle values of each isofootcandle line. Distance in units of mounting height.

Mounting Footcandle Values for Height Isofootcandle Lines A B C D E 3.00 1.50 0.75 0.30 0.15 20'
 2.00
 1.00
 0.50
 0.20
 0.10

 1.38
 1.69
 0.34
 0.13
 0.06
 25' 30'

ORDERING INFORMATION

22,000-Lumen Clear Lamp

Type III Formed

Sample Number: PFT1153H159N/AB

Series	Number of Fixtures	Lamp Wattage	Distribution	Lamp Type ¹	Pole Height	Zone	Options (Add as Suffix)
PFT=Tribute Fixture and Pole Combo	1 =1 2 =2	15=150W 25=250W 32=320W 40=400W	23=Type II/III 4F=Type IV Formed	P=Pulse Start Metal Halide H=High Pressure Sodium	15=15' 20=20' 25=25' 30=30'	9=90 MPH Wind Zone 0=100 MPH Wind Zone	CEC=California Title 20 Compliant Ballast (Applies to 200-320W and 400W MP Only) N/AB=No Anchor Bolts (Used when ordered separately)

50,000-Lumen Clear Lamp

Type IV

NOTES: 1.8" arm and pole adapter included with fixture. Lamp included with all PFT configurations. Supplied with multi-tap ballast 120/208/240/277V wired 277V wired 277V with straight steel shaft, anchor bolts, template, base cover and

STOCK OPTION CONFIGURATIONS

Mounting Height (Feet)	Square Steel Pole Shaft Size (Inches)	Maximum Wind Zone (MPH)	Number of Fixture(s)	Lamp Type	Wattage	IES Distribution Type	EISA Compliant	Catalog Number
15'	4'	100	1	MP	150W	2/3	•	PFT11523P15N/AB
	4'	100	1	MP	250W	2/3	•	PFT12523P20
	4'	100	1	MP	250W	2/3	•	PFT12523P20N/AB
	4'	100	2	MP	250W	2/3	•	PFT22523P20
20'	4'	100	2	MP	250W	2/3	•	PFT22523P20N/AB
20	4'	100	1	MP	400W	2/3	•	PFT14023P20
	4'	100	1	MP	400W	2/3	•	PFT14023P20N/AB
	4'	100	2	MP	400W	2/3	•	PFT24023P20
	4'	100	2	MP	400W	2/3	•	PFT24023P20N/AB
	4'	90	1	MP	250W	2/3	•	PFT12523P25
	4'	90	1	MP	250W	2/3	•	PFT12523P25N/AB
	4'	80	2	MP	250W	2/3	•	PFT22523P25
25'	4'	90	1	MP	400W	2/3	•	PFT14023P25
	4'	90	1	MP	400W	2/3	•	PFT14023P25N/AB
	4'	80	2	MP	400W	2/3	•	PFT24023P25
	4'	80	2	MP	400W	2/3	•	PFT24023P25N/AB

NOTES: 1 Four Anchor botts and one template included with each Mombo Combo setup. 2 To order without anchor botts, add "N/AB" to end of catalog number, no dashes. 3 8" Square Pole Arm included inside each Tribute fixture carton. 4 All Tribute fixtures come equipped with Type IV/III (adjustable—set to Type III) or Type IV distribution. 5 Lamp is included. 6 Supplied with Multi-tap voltages 120/208/240/277V wired 277V. 7 Check Stock Guide for availability. 25"-5" and Type IV configurations available in select warehouses only



Eaton 1000 Eaton Boulevard Cleveland, OH 44122 United States Eaton.com

Eaton's Cooper Lighting Business 1121 Highway 74 South Peachtree City, GA 30269 P: 770-486-4800

www.cooperlighting.com

dimensions subject to change without notice.

TD500005EN 2015-03-25 13:26:52



ONE TO TWO FIXTURE CONFIGURATIONS

Mounting Height (Feet)	Square Steel Pole Shaft Size (Inches)	Maximum Wind Zone (MPH)	Number of Fixture(s)	Lamp Type	Wattage	IES Distribution Type	EISA Compliant	Catalog Number
	4'	100	1	HPS	150W	2/3		PFT11523H15
	4'	100	2	HPS	150W	2/3		PFT21523H15
15'	4'	100	1	MP	150W	2/3	EXEMPT	PFT11523P15
15	4'	100	2	MP	150W	2/3	EXEMPT	PFT21523P15
	4'	100	1	MP	250W	2/3	•	PFT12523P15
	4'	100	2	MP	250W	2/3	•	PFT22523P15
	4'	100	1	HPS	250W	2/3		PFT12523H20
	4'	100	2	HPS	250W	2/3		PFT22523H20
20'	4'	100	1	HPS	400W	2/3		PFT14023H20
20	4'	100	2	HPS	400W	2/3		PFT24023H20
	4'	100	1	MP	400W	4	•	PFT1404FP20
	4'	100	2	MP	400W	4	•	PFT2404FP20
	4'	90	1	HPS	250W	2/3		PFT12523H25
	4'	80	2	HPS	250W	2/3		PFT22523H25
25'	4'	90	1	HPS	400W	2/3		PFT14023H25
25	4'	80	2	HPS	400W	2/3		PFT24023H25
	4'	90	1	MP	400W	4	•	PFT1404FP25
	4'	80	2	MP	400W	4	•	PFT2404FP25
	5'	100	2	HPS	400W	2/3		PFT24023H250
25'	5'	100	2	MP	400W	2/3	•	PFT24023P250
	5'	100	2	MP	400W	4	•	PFT2404FP250
	5'	90	1	HPS	250W	2/3		PFT12523H30
	5'	80	2	HPS	250W	2/3	•	PFT22523H30
	5'	90	1	HPS	400W	2/3		PFT14023H30
	5'	80	2	HPS	400W	2/3		PFT24023H30
001	5'	90	1	MP	250W	2/3	•	PFT12523P30
30'	5'	80	2	MP	250W	2/3	•	PFT22523P30
	5'	90	1	MP	400W	2/3	•	PFT14023P30
	5'	80	2	MP	400W	2/3	•	PFT24023P30
	5'	90	1	MP	400W	4	•	PFT1404FP30
	5'	80	2	MP	400W	4	•	PFT2404FP30

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Specifications and dimensions subject to change without notice.



PFT TRIBUTE AND POLE COMBO

THREE TO FOUR FIXTURE CONFIGURATIONS

100 3	Mounting Height (Feet)	Square Steel Pole Shaft Size (Inches)	Maximum Wind Zone (MPH)	Number of Fixture(s)	Lamp Туре	Wattage	IES Distribution Type	EISA Compliant	Catalog Number
20' 4' 100 3 HPS 400W 2/3 PFT34023H20 4' 90 4 HPS 400W 2/3 PFT34023H20 4' 90 4 MP 2560W 2/3 PFT32523P20 4' 90 4 MP 2560W 2/3 PFT32523P20 4' 100 3 MP 2560W 2/3 PFT32523P20 4' 100 3 MP 400W 2/3 PFT34023P20 4' 100 3 MP 400W 2/3 PFT34023P20 4' 100 3 MP 400W 4 PFT3404P20 4' 90 4 MP 400W 4 PFT3404P20 4' 90 4 MP 400W 4 PFT3404P20 4' 80 3 HPS 2560W 2/3 PFT32523H25 4' 80 4 HPS 2560W 2/3 PFT34023H25 4' 80 3 HPS 400W 2/3 PFT34023H25 4' 80 4 HPS 400W 2/3 PFT34023H25 4' 80 3 MP 2560W 2/3 PFT34023H25 4' 80 3 MP 2560W 2/3 PFT34023H25 4' 80 4 MP 2560W 2/3 PFT34023H25 4' 80 3 MP 2560W 2/3 PFT34023H25 4' 80 3 MP 400W 2/3 PFT34023H25 4' 80 3 MP 2560W 2/3 PFT34023H25 4' 80 4 MP 2560W 2/3 PFT34023H25 4' 80 3 MP 400W 2/3 PFT34023H25 4' 80 3 MP 400W 4 PFT3404P25 4' 80 3 MP 400W 2/3 PFT34023P25 4' 80 3 MP 400W 2/3 PFT34023P25 5' 80 3 HPS 2560W 2/3 PFT34023H25 5' 80 3 HPS 2560W 2/3 PFT34023H20 5' 80 3 MP 400W 2/3 PFT34023H20 5' 80 3 MP 2560W 2/3 PFT34023H20 5' 80 3 MP 2560W 2/3 PFT34023H20 5' 80 3 MP 400W 2/3 PFT34023H20 5' 80 3 MP 2560W 2/3 PFT34023H20 5' 80 3 MP 4000W 2/3 -		4'	100	3	HPS	250W	2/3		PFT32523H20
20' 4' 100 3 MP 250W 2'3 - PFT32523P20 4' 100 3 MP 250W 2'3 - PFT32523P20 4' 100 3 MP 250W 2'3 - PFT32523P20 4' 100 3 MP 400W 2'3 - PFT3403P20 4' 90 4 MP 400W 2'3 - PFT3403P20 4' 90 4 MP 400W 4 - PFT3404FP20 4' 80 3 HPS 250W 2'3 - PFT3402FP20 4' 80 4 HPS 250W 2'3 - PFT3402FP20 4' 80 3 HPS 400W 2'3 - PFT3402FP20 4' 80 4 HPS 250W 2'3 - PFT3403P25 4' 80 4 HPS 250W 2'3 - PFT3423P25 4' 80 4 HPS 400W 2'3 - PFT3423P25 4' 80 3 MP 250W 2'3 - PFT3423P25 4' 80 4 MP 250W 2'3 - PFT3423P25 4' 80 3 MP 400W 2'3 - PFT3423P25 4' 80 4 MP 250W 2'3 - PFT3423P25 4' 80 4 MP 400W 2'3 - PFT3423P25 4' 80 3 MP 400W 2'3 - PFT3423P25 4' 80 4 MP 400W 2'3 - PFT3423P25 4' 80 4 MP 400W 2'3 - PFT3423P25 5' 80 3 HPS 250W 2'3 - PFT3403P25 5' 80 4 HPS 250W 2'3 - PFT3423P30 5' 80 4 HPS 400W 2'3 - PFT3423P30 5' 80 4 HPS 400W 2'3 - PFT3423P30 5' 80 4 HPS 400W 2'3 - PFT3423P30 5' 80 4 HPS 250W 2'3 - PFT3423P30 5' 80 4 HPS 400W 2'3 - PFT3423P30 5' 80 4 HPS 400W 2'3 - PFT3423P30 5' 80 4 MP 400W 2'3 - PFT3423P30 5' 80 4 MP 250W 2'3 - PFT3423P30 5' 80 4 MP 400W 2'3 - PFT3423P30 5' 80 4 MP 250W 2'3 - PFT3423P30 5' 80 4 MP 400W 2'3 - PFT3423P30 5' 80 4 PF 3404PP30		4'	90	4	HPS	250W	2/3		PFT42523H20
20' 4' 90 4 MP 250W 2/3 • PFT32523P20 4' 90 4 MP 250W 2/3 • PFT32523P20 4' 90 4 MP 400W 2/3 • PFT34023P20 4' 100 3 MP 400W 2/3 • PFT34023P20 4' 100 3 MP 400W 4 • PFT34023P20 4' 90 4 MP 400W 4 • PFT3404FP20 4' 90 4 MP 400W 4 • PFT3404FP20 4' 90 4 MP 400W 4 • PFT3404FP20 4' 80 3 HPS 250W 2/3 - PFT32523H25 4' 80 4 HPS 250W 2/3 - PFT32523H25 4' 80 3 HPS 400W 2/3 - PFT34023H25 4' 80 3 MP 250W 2/3 - PFT34023H25 4' 80 3 MP 400W 2/3 - PFT34023H25 5' 80 3 HPS 250W 2/3 - PFT34023H25 5' 80 3 HPS 250W 2/3 - PFT3403H25 5' 80 3 HPS 250W 2/3 - PFT34023H30 5' 80 4 HPS 250W 2/3 - PFT34023H30 5' 80 3 MP 250W 2/3 - PFT34023H30 5' 80 3 MP 250W 2/3 - PFT34023H30 5' 80 4 HPS 250W 2/3 - PFT34023H30 5' 80 3 MP 250W 2/3 - PFT34023H30 5' 80 4 MP 250W 2/3 - PFT34023H30 5' 80 6 4 MP 250W 2/3 - PFT34023H30 5' 80 6 4 MP 250W 2/3 - PFT34023H30		4'	100	3	HPS	400W	2/3		PFT34023H20
20' 4' 90 4 MP 250W 2/3 • PFT4523P20 4' 100 3 MP 400W 2/3 • PFT4023P20 4' 90 4 MP 400W 2/3 • PFT4023P20 4' 90 4 MP 400W 4 • PFT404FP20 4' 90 4 MP 400W 4 • PFT404FP20 4' 80 3 HPS 250W 2/3 · PFT4023P25 4' 80 3 HPS 250W 2/3 · PFT4023P25 4' 80 3 HPS 250W 2/3 · PFT4023P25 4' 80 3 HPS 400W 2/3 · PFT4023P25 4' 80 3 HPS 400W 2/3 · PFT4023P25 4' 80 3 HPS 400W 2/3 · PFT4023P25 4' 80 4 HPS 400W 2/3 · PFT4023P25 4' 80 3 MP 250W 2/3 · PFT4023P25 4' 80 4 MP 250W 2/3 · PFT4023P25 4' 80 4 MP 250W 2/3 · PFT4023P25 4' 80 3 MP 400W 2/3 · PFT4023P25 4' 80 4 MP 400W 2/3 · PFT3023P25 4' 80 3 MP 400W 2/3 · PFT4023P25 4' 80 3 MP 400W 2/3 · PFT4023P25 5' 80 3 HPS 250W 2/3 · PFT4023P25 5' 80 3 HPS 250W 2/3 · PFT34023P25 5' 80 3 HPS 250W 2/3 · PFT34023P25 5' 80 3 MP 400W 2/3 · PFT34023P25 5' 80 3 MP 250W 2/3 · PFT34023P30 5' 80 3 MP 400W 2/3 · PFT34023P30 5' 80 4 MP 250W 2/3 · PFT34023P30 5' 80 4 MP 250W 2/3 · PFT34023P30 5' 80 4 MP 250W 2/3 · PFT34023P30 5' 80 4 MP 400W 2/3 · PFT34023P30		4'	90	4	HPS	400W	2/3		PFT44023H20
4' 90 4 MP 250W 2/3 • PFT42523P20 4' 100 3 MP 400W 2/3 • PFT4023P20 4' 90 4 MP 400W 2/3 • PFT4023P20 4' 100 3 MP 400W 4 • PFT4023P20 4' 100 3 MP 400W 4 • PFT4023P20 4' 90 4 MP 400W 4 • PFT4023P20 4' 80 3 HPS 250W 2/3 - PFT4523H25 4' 80 3 HPS 250W 2/3 - PFT3423H25 4' 80 3 HPS 400W 2/3 - PFT3423H25 4' 80 3 HPS 400W 2/3 - PFT3423H25 4' 80 3 MP 250W 2/3 - PFT3423H25 4' 80 3 MP 400W 2/3 - PFT3423H25 4' 80 3 MP 400W 2/3 - PFT3423H25 4' 80 3 MP 400W 2/3 - PFT3423P25 4' 80 3 MP 400W 2/3 - PFT3423P25 4' 80 3 MP 400W 2/3 - PFT3423P25 5' 80 3 HPS 250W 2/3 - PFT3403F25 5' 80 3 HPS 250W 2/3 - PFT3423H30 5' 80 3 HPS 400W 2/3 - PFT3423H30 5' 80 3 HPS 400W 2/3 - PFT3423H30 5' 80 3 MP 250W 2/3 - PFT3423H30 5' 80 4 MP 250W 2/3 - PFT3423H30 5' 80 4 MP 250W 2/3 - PFT3423H30 5' 80 6 H MP 250W 2/3 - PFT3423H30 5' 80 7 PFT3403H30 5' 80 7 PFT3403H30 5' 80 8 M MP 400W 2/3 - PFT3423H30 5' 80 8 M MP 400W 2/3 - PFT3423H30 5' 80 8 M MP 400W 2/3 - PFT3423H30 5' 80 9 M MP 400W 2/3 - PFT3423H30 5' 80 9 M MP 400W 2/3 - PFT3423H30 5' 80 9 M MP 400W 2/3 - PFT3423H30 5' 80 9 M MP 400W 2/3 - PFT3423H30 5' 80 9 M MP 400W 2/3 - PFT3423H30	201	4'	100	3	MP	250W	2/3	•	PFT32523P20
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4' 80 4 MP 250W 2/3 PFT42523P25 4' 80 3 MP 400W 2/3 PFT34023P25 4' 80 4 MP 400W 2/3 PFT44023P25 4' 80 3 MP 400W 4 PFT3404FP25 4' 80 4 MP 400W 4 PFT3404FP25 4' 80 3 HPS 250W 2/3 PFT32523H30 5' 80 3 HPS 250W 2/3 PFT32523H30 5' 80 4 HPS 250W 2/3 PFT34023H30 5' 80 3 HPS 400W 2/3 PFT34023H30 5' 80 4 MP 250W 2/3 PFT34023H30 5' 80 3 MP 250W 2/3 PFT34023H30 5' 80 3 MP 250W 2/3 PFT34023H30 5' 80 4 MP 250W 2/3 PFT34023H30 5' 80 3 MP 400W 2/3 PFT34023P30 5' 80 3 MP 400W 2/3 PFT34023P30 5' 80 4 MP 400W 2/3 PFT3404FP30	251	4'	80	3	MP	250W	2/3		PFT32523P25
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5' 80 3 HPS 400W 2/3 PFT34023H30 5' 80 4 HPS 400W 2/3 PFT44023H30 5' 80 3 MP 250W 2/3 • PFT32523P30 5' 80 4 MP 250W 2/3 • PFT32523P30 5' 80 4 MP 250W 2/3 • PFT4523P30 5' 80 3 MP 400W 2/3 • PFT44023P30 5' 80 4 MP 400W 2/3 • PFT34023P30 5' 80 4 MP 400W 2/3 • PFT34023P30 5' 80 3 MP 400W 4 • PFT3404FP30		5'	80	3	HPS	250W	2/3		PFT32523H30
5' 80 4 HPS 400W 2/3 PFT44023H30 5' 80 3 MP 250W 2/3 • PFT32523P30 5' 80 4 MP 250W 2/3 • PFT45252P30 5' 80 3 MP 400W 2/3 • PFT4523P30 5' 80 4 MP 400W 2/3 • PFT44023P30 5' 80 4 MP 400W 2/3 • PFT44023P30 5' 80 3 MP 400W 4 • PFT3404FP30		5'	80	4	HPS	250W	2/3		PFT42523H30
5' 80 3 MP 250W 2/3 • PFT32523P30 5' 80 4 MP 250W 2/3 • PFT42523P30 5' 80 3 MP 400W 2/3 • PFT34023P30 5' 80 4 MP 400W 2/3 • PFT34023P30 5' 80 4 MP 400W 2/3 • PFT44023P30 5' 80 3 MP 400W 4 • PFT3404FP30		5'	80	3	HPS	400W	2/3		PFT34023H30
5' 80 4 MP 250W 2/3 • PFT42523P30 5' 80 3 MP 400W 2/3 • PFT34023P30 5' 80 4 MP 400W 2/3 • PFT34023P30 5' 80 3 MP 400W 2/3 • PFT44023P30 5' 80 3 MP 400W 4 • PFT3404FP30		5'	80	4	HPS	400W	2/3		PFT44023H30
5' 80 4 MP 250W 2/3 • PFT42523P30 5' 80 3 MP 400W 2/3 • PFT34023P30 5' 80 4 MP 400W 2/3 • PFT44023P30 5' 80 3 MP 400W 4 • PFT3404FP30	20'	5'	80	3	MP	250W	2/3	•	PFT32523P30
5' 80 4 MP 400W 2/3 • PFT44023P30 5' 80 3 MP 400W 4 • PFT3404FP30	30	5'	80	4	MP	250W	2/3	•	PFT42523P30
5' 80 3 MP 400W 4 • PFT3404FP30		5'	80	3	MP	400W	2/3	•	PFT34023P30
		5'	80	4	MP	400W	2/3	•	PFT44023P30
5' 80 4 MP 400W 4 • PFT4404FP30		5'	80	3	MP	400W	4	•	PFT3404FP30
		5'	80	4	MP	400W	4	•	PFT4404FP30

NOTES: 1 Four Anchor bolts and one template included with each Mombo Combo setup. 2 To order without anchor bolts, add "N/AB" to end of catalog number, no dashes. 3 8" Square Pole Arm included inside each Tribute fixture carton. 4 All Tribute fixtures come equipped with Type II/III (adjustable—set to Type III) or Type IV distribution. 5 Lamp is included. 6 Supplied with Multi-tap voltages 120/208/240/277V wired 277V. 7 Check Stock Guide for availability. 25'-5" and Type IV configurations available in select warehouses only.



Eaton's Cooper Lighting Business 1121 Highway 74 South Peachtree City, GA 30269 P: 770-486-4800 www.cooperlighting.com Eaton 1000 Eaton Boulevard Cleveland, OH 44122 United States Eaton.com

Specifications and dimensions subject to change without notice.

DESCRIPTION

The patented Lumark Crosstour™ LED Wall Pack Series of luminaries provides an architectural style with super bright, energy efficient LEDs. The low-profile, rugged die-cast aluminum construction, universal back box, stainless steel hardware along with a sealed and gasketed optical compartment make the Crosstour impervious to contaminants. The Crosstour wall luminaire is ideal for wall/surface, inverted mount for façade/canopy illumination, post/bollard, site lighting, floodlight and low level pathway illumination including stairs. Typical applications include building entrances, multi-use facilities, apartment buildings, institutions, schools, stairways and loading docks test.

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SPECIFICATION FEATURES

Construction

Slim, low-profile LED design with rugged one-piece, die-cast aluminum hinged removable door and back box. Matching housing styles incorporate both a small and large design. The small housing is available in 7W and 18W. The large housing is available in the 26W model. Patent pending secure lock hinge feature allows for safe and easy tool-less electrical connections with the supplied push-in connectors. Back box includes three (3) half-inch, NPT threaded conduit entry points. The universal back box supports both the small and large forms and mounts to standard 3-1/2" to 4" round and octagonal, 4" square, single gang and masonry junction boxes. Key hole gasket allows for adaptation to junction box or wall. External fin design extracts heat from the fixture surface. Onepiece silicone gasket seals door and back box. Minimum 5" wide pole for site lighting application. Not recommended for car wash applications.

Optical

Silicone sealed optical LED chamber incorporates a custom engineered mirrored anodized reflector providing high-efficiency illumination. Optical assembly includes impact-resistant tempered glass and meets IESNA requirements for full cutoff compliance. Solid state LED Crosstour luminaries are thermally optimized with five (5) lumen packages in cool 5000K or neutral warm 3500K LED color temperature Electrical LED driver is mounted to the die-cast housing for optimal heat

sinking. LED thermal management system incorporates both conduction and natural convection to transfer heat rapidly away from the LED source. 7W models operate in -40°C to 40°C [-40°F to 104°F]. 18W and 26W models operate in -40°C to 40°C [-40°F to 104°F]. High ambient 50°C models available. Crosstour luminaires maintain greater than 90% of initial

light output after 72,000 hours of operation. Three (3) half-inch NPT threaded conduit entry points allow for thru-branch wiring. Back box is an authorized electrical wiring compartment. Integral LED electronic driver incorporates surge protection. 120-277V 50/60Hz or 347V 60Hz models.

Finish

Crosstour is protected with a Super durable TGIC carbon bronze or summit white polyester powder coat paint. Super durable TGIC powder coat paint finishes withstand extreme climate conditions while providing optimal color and gloss retention of the installed life.

Warranty

Five-year warranty.





TYPES B1, B2 Lumark


XTOR CROSSTOUR LED


APPLICATIONS: WALL / SURFACE POST / BOLLARD LOW LEVEL FLOODLIGHT INVERTED SITE LIGHTING

DIMENSIONS **ESCUTCHEON PLATES** 7W & 18W

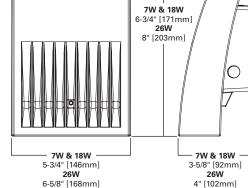

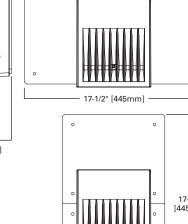

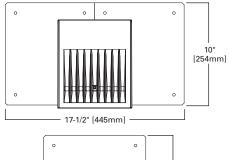

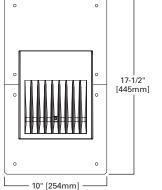



CERTIFICATION DATA

UL/cUL Wet Location Listed LM79 / LM80 Compliant **ROHS** Compliant ADA Compliant NOM Compliant Models IP66 Ingressed Protection Rated Title 24 Compliant DesignLights Consortium® Qualified*

TECHNICAL DATA

40°C Maximum Ambient Temperature External Supply Wiring 90°C Minimum

Effective Projected Area (Sq. Ft.): XTOR1A/XT0R2A=0.34 XTOR3A=0.45

SHIPPING DATA: Approximate Net Weight:

3.7 – 5.25 lbs. [1.7 – 2.4 kgs.]



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LUMEN MAINTENANCE

Ambient Temperature	TM-21 Lumen Maintenance (72,000 Hours)	Theoretical L70 (Hours)
XTOR1A Mode	el	
25°C	> 92%	> 290,000
40°C	> 92%	> 290,000
50°C	> 91%	> 270,000
XTOR2A Mode		
25°C	> 91%	> 270,000
40°C	> 90%	> 260,000
50°C	> 88%	> 225,000
XTOR3A Mode	el	
25°C	> 91%	> 280,000
40°C	> 91%	> 270,000
50°C	> 89%	> 240,000

CURRENT DRAW

\/alta==a	Model Series					
Voltage	XTOR1A	XTOR2A	XTOR3A			
120V	0.05A	0.15A	0.22A			
208V	0.03A	0.08A	0.13A			
240V	0.03A	0.07A	0.11A			
277V	0.03A	0.06A	0.10A			
347V	0.025A	0.058A	0.082A			

LUMENS - CRI/CCT TABLE

LED Information	XTOR1A	XTOR2A	XTOR2A-N	XTOR3A	XTOR3A-N
Delivered Lumens (Wall Mount)	722	1,633	1,523	2,804	2,284
Delivered Lumens (With Flood Accessory Kit) ¹	468	1,060	978	2,168	1,738
B.U.G. Rating ²	B0-U0-G0	B1-U0-G0	B1-U0-G0	B1-U0-G0	B1-U0-G0
CCT (Kelvin)	5,000	5,000	3,500	5,000	3,500
CRI (Color Rendering Index)	65	65	70	65	70
Power Consumption (Watts)	7W	18W	18W	26W	26W

NOTES: 1 Includes shield and visor. 2 B.U.G. Rating does not apply to floodlighting.

ORDERING INFORMATION

Sample Number: XTOR2A-N-WT-PC1

Series 1	LED Kelvin Color	Housing Color	Options (Add as Suffix)	Accessories (Order Separately)
XTOR1A=Small Door, 7W XTOR2A=Small Door, 18W XTOR3A=Small Door, 26W	[Blank]=Bright White (Standard) 5000K N=Neutral Warm White, 3500K ²	[Blank]=Carbon Bronze (Standard) WT=Summit White TBD	PC1=Photocontrol 120V ³ PC2=Photocontrol 208-277V ^{3,4} 347V=347V ⁵ HA=50°C High Ambient ⁵	WG/XTOR=Wire Guard ⁶ XTORFLD-KNC=Knuckle Floodlight Kit ⁷ XTORFLD-TRN=Trunnion Floodlight Kit ⁷ XTORFLD-KNC-WT=Knuckle Floodlight Kit, Summit White ⁷ XTORFLD-TRN-WT=Trunnion Floodlight Kit, Summit White ⁷ EWP/XTOR=Escutcheon Wall Plate, Carbon Bronze EWP/XTOR-WT=Escutcheon Wall Plate, Summit White

NOTES: 1 DesignLights Consortium® Qualified. Refer to www.designlights.org Qualified Products List under Family Models for details. 2 XTOR1A not available in 3500K. 3 Photocontrols are factory installed. 4 Order PC2 for 347V models. 5 Thru-branch wiring not available with HA option or with 347V. 6 Wire guard for wall/surface mount. Not for use with floodlight kit accessory. 7 Floodlight kit accessory supplied with knuckle (KNC) or trunnion (TRN) base, small and large top visors and small and large impact shields.

STOCK ORDERING INFORMATION

7W Series	18W Series	26W Series
XTOR1A=7W, 5000K, Carbon Bronze	XTOR2A=18W, 5000K, Carbon Bronze	XTOR3A=26W, 5000K, Carbon Bronze
XTOR1A-WT=7W, 5000K, Summit White	XTOR2A-N=18W, 3500K, Carbon Bronze	XTOR3A-N=26W, 3500K, Carbon Bronze
XTOR1A-PC1=7W, 5000K, 120V PC, Carbon Bronze	XTOR2A-WT=18W, Summit White	XTOR3A-WT=26W, Summit White
	XTOR2A-PC1=18W, 120V PC, Carbon Bronze	XTOR3A-PC1=26W, 120V PC, Carbon Bronze

5-DAY QUICK SHIP ORDERING INFORMATION

7W Series	18W Series	26W Series
XTOR1A-WT-PC1=7W, 5000K, Summit White, 120V PC	XTOR2A-PC2=18W, 5000K, 208-277V PC, Carbon Bronze	XTOR3A-PC2=26W, 5000K, 208-277V PC, Carbon Bronze
	XTOR2A-WT-PC1=18W, 5000K, Summit White, 120V PC	XTOR3A-WT-PC1=26W, 5000K, Summit White, 120V PC
	XTOR2A-WT-PC2=18W, 5000K, Summit White, 208-277V PC	XTOR3A-WT-PC2=26W, 5000K, Summit White, 208-277V PC
	XTOR2A-N-WT=18W, 3500K, Summit White	XTOR3A-N-WT=26W, 3500K, Summit White
	XTOR2A-N-PC1=18W, 3500K, 120V PC, Carbon Bronze	XTOR3A-N-PC1=26W, 3500K, 120V PC, Carbon Bronze
	XTOR2A-N-PC2=18W, 3500K, 208-277V PC, Carbon Bronze	XTOR3A-N-PC2=26W, 3500K, 208-277V PC, Carbon Bronze
	XTOR2A-N-WHT-PC1=18W, 3500K, Summit White, 120V PC	XTOR3A-N-WHT-PC1=26W, 3500K, Summit White, 120V PC
	XTOR2A-N-WT-PC2=18W, 3500K, Summit White, 208-277V PC	XTOR3A-N-WT-PC2=26W, 3500K, Summit White, 208-277V PC



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XTOR CROSSTOUR LED



DESCRIPTION

The Aspen 1900-OA bollard features a sleek, contemporary aesthetic and low glare fixed optics. Fixtures that utilize a metal halide lamp source include an integral core & coil ballast (electronic ballast optional); fixtures with a halogen source are available with integral or remote 12V transformer. Our patented LumaLevel" leveling system provides quick installation, easy adjustment, secure mounting and protection from vibration. Aspen bollards are available in two standard sizes.

Catalog #	Туре
Project	
Comments	Date
Prepared by	


SPECIFICATION FEATURES

A ... Material

Housing is precision-machined from corrosion-resistant 6061-T6 aluminum extrusion. Mounting base is cast from corrosion-resistant silicone aluminum alloy.

B ... Finish

Fixture and mounting base are double protected by a chromate conversion undercoating and polyester powdercoat paint finish, surpassing the rigorous demands of the outdoor environment.
Fixture housing is available in a variety of standard colors.
Mounting base is painted black.

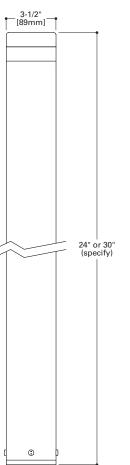

C ... Lens

Lens is machined from solid U.V. stabilized clear acrylic and is designed to produce maximum light output with low brightness.

D ... Adjustable Mounting Base Cast aluminum mounting base assembly is equipped with the

patented LumaLevel" leveling system that includes mounting chassis, 70 shore neoprene base, stainless steel hardware and 3/4" conduit entry. The LumaLevel" leveling system provides quick installation, easy adjustment, secure mounting and protection from vibration.

E ... Anchor Bolts & Template

Three (3) 3/8" x 12" galvanized anchor bolts and a galvanized steel anchor bolt template are standard. Anchor bolts and template are available to ship in advance of fixture for rough-in purposes (specify option -LAB and order anchor bolts/template kit separately).

F ... Hardware

Stainless steel hardware is standard to provide maximum corrosion-resistance.

G ... Socket

MH39PAR20: Ceramic socket with 250° C Teflon® coated lead wires and medium base. 50MR16: Ceramic socket with 250° C Teflon® coated lead wires and GU5.3 bi-pin base.

H ... Electrical

MH39PAR20: Integral core & coil ballast is standard (120/208/240/277/347V). Rated for -20° C starting temperature. Integral electronic ballast (120/277V) is available (specify option -EL). 50MR16: 12V transformer required (not included). Remote transformer is available from Lumière as an accessory - see the Accessories & Technical Data section of this catalog for details. Integral 12V transformer is available as an option (specify option -IT).

I ... Lamp

Not included. Available from Lumière as an accessory - see reverse side of this page.

J ... Labels & Approvals

UL and cUL listed, standard wet label. Manufactured to ISO 9001-2000 Quality Systems Standard. IBEW union made.

K ... Warranty

Lumière warrants its fixtures against defects in materials & workmanship for three (3) years. Auxiliary equipment such as transformers, ballasts and lamps carry the original manufacturer's warranty.



ASPEN
1900-OA
Open Aperture

39W (max.) PAR20 Metal Halide

50W (max.) MR16 Halogen Low Voltage

Bollard



Aspen 1900-OA

Specifications and Dimensions subject to change without notice.


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PHOTOMETRIC DATA


ASPEN 1900-OA

 Aspen
 1900-OA-30-MHPAR20
 Lamp=MH39PAR20/FL
 Lumens=2000
 Aspen 1900-OA-24-50MR16
 Lamp=50MR16
 Lumens=950

ISO Footcandle Plot

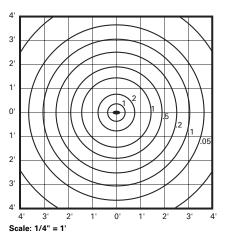

ISO Footcandle Plot

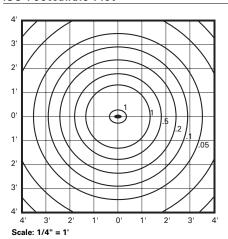

LAMP INFORMATION

Lamp	ANSI Code	Watts	Beam Spread	СВСР	°K	Life (hrs.)	Base	Volts
CDM39PAR20/SP	M130KK-39	39	10°	23,000	3000	9000	medium	120-347
50MR16/NSP	EXT	50	12°	11,000	3050	4000	GU5.3 bi-pin	12

NOTE: Inferior quality lamps may adversely affect the performance of this product. Use only name brand lamps from reputable lamp manufacturers.

NOTES AND FORMULAS

- Beam diameter is to 50% of maximum footcandles, rounded to the nearest half-foot.
- Footcandle values are initial. Apply appropriate light loss factors where necessary.



Specifications and Dimensions subject to change without notice.

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Litesphere™ LED Strand



CAT:		FEET:
TYPE:	PROJECT:	

PROJECT:



Energy-efficient, low voltage strand lighting using wedge-base LED lamps protected by clear, frosted or colored polycarbonate globes.

- Flexible 16AWG. cord available in Black or White with matching
- Shatterproof, polycarbonate, O-ring fitted globes protect lamps with clarity and seamless appearance.
- Socket is parallel wired and permanently fixed to cord.
- Field cuttable.

Mounting

Each Socket has mounting holes for screw attachment in under-eve applications. Use 1/8" stainless steel wire cable (by others) and hanger clips for festoon applications.

Applications

Ideal for indoor and outdoor applications.

Warranty

3 years

Technical Information

Lamp Spacing	6" O.C.	12″ O.C.	18" O.C.	24" O.C.			
*Lumens/ft(STD)	8	4	3	2			
*Lumens/ft (HO)	24	12	9	6			
*Watts/ft (STD)	0.2	0.1	0.08	0.05			
*Watts/ft (HO)	0.52	0.26	0.20	0.13			
Lumens/watt (STD)	40	40	40	40			
*Lumens/watt (HO)	46	46	46	46			
CRI		> 80/TYP83					
LED Colors		1900°K, 2700°K, , 3000°K, 3500°K, 4000°K (+/- 80°K) 3SDCM White (4200°K), Warm White (2800°K)					

75,000 hr.

12V DC

Class II


Ordering Increment

Operating Voltage

Rated Life

Profile Dimensions



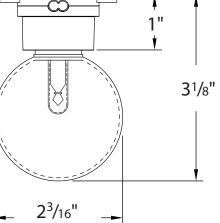

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Power Supply * 3000°K Sample

12V Litesphere[™] LED Strand




Recommended Power Supplies

CAT NO	APPLICATION	PRIMARY AND SECONDARY	TOTAL WATTAGE / AMPS PER BREAKER	LISTING	DIMENSIONS	ELECTRONIC OR AC MAGNETIC
ADNM-80-1-5-12-D		120-277V AC / 12V DC	60W / 1X5A	cULus	12"W X 12"L X 4"D	Electronic
ADNM-150-2-5-12-D	Outdoor	120-277V AC / 12V DC	120W / 2X5A	cULus	12"W X 12"L X 4"D	Electronic
ADNM-240-3-5-12-D		120-277V AC / 12V DC	180W / 3X5A	cULus	12"W X 12"L X 4"D	Electronic
ADNM-320-4-5-12-D		120-277V AC / 12V DC	240W / 4X5A	cULus	12"W X 12"L X 4"D	Electronic
ADUL-80-1-5-12-D	Indoor	120-277V AC / 12V DC	60W / 1X5A	UL/ETL/CSA	10"W X 10"L X 4"D	Electronic
ADUL-150-2-5-12-D		120-277V AC / 12V DC	120W / 2X5A	UL/ETL/CSA	10"W X 10"L X 4"D	Electronic
ADUL-240-3-5-12-D		120-277V AC / 12V DC	180W / 3X5A	UL/ETL/CSA	10"W X 10"L X 4"D	Electronic
ADUL-320-4-5-12-D		120-277V AC / 12V DC	240W / 4X5A	UL/ETL/CSA	10"W X 10"L X 4"D	Electronic
MT-60-1-5-12-D	1. 1 (0. 1.1	120V AC / 12V DC	60W / 1X5A	cULus	2.50"W X 12.32"L X 1.56"D	Electronic
MT-60-1-5-12-DD	Indoor/Outdoor	120V AC / 12V DC	60W / 1X5A	cULus	2.50"W X 12.32"L X 1.56"D	Electronic
JT-60-1-5-12-D		120V AC / 12V DC	60W / 1X5A	cETLus	4.25"W X 8.50"L X 3.25"D	Magnetic
JTH-60-1-5-12-D		277V AC / 12V DC	60W / 1X5A	cETLus	4.25"W X 8.50"L X 3.25"D	Magnetic
JT-240-4-5-12-D	Indoor/Outdoor	120V AC / 12V DC	240W / 4X5A	cETLus	8.50"W X 16.00"L X 4.50"D	Magnetic
JTH-240-4-5-12-D		277V AC / 12V DC	240W / 4X5A	cETLus	8.50"W X 16.00"L X 4.50"D	Magnetic


Ordering Information



Wiring Accessories

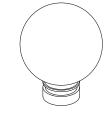


REPLACEMENT GLOBES LS-OG LS-OG Clear **LS-FG** Orange LS-GG Frosted LS-YG Green **LS-BG** Yellow LS-RG Blue **LS-PG**

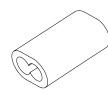

LS-EC-BK Black end cap LS-EC-WH White end cap



LS-HANG-CLIP Hanger clip for installation from 8 gauge stainless steel aircraft cable

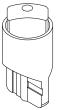

Blue LSL-GR-F-12

REPLACEMENT LEDS LSL-BL-F-12 LSL-YL-F-12 Yellow LSL-WH-F-12 Green LSL-RD-F-12 White LSL-WW-F-12

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