7933 TREE LANE MADISON, WI HEARTLAND ALLIANCE HOUSING LAND USE SUBMISSION

# HEARTLAND ALLIANCE

PROJECT ADDRESS

MADISON, WI



ARCHITECT

VALERIO DEWALT TRAIN ASSOCIATES, IN 500 N. DEARBORN, 9TH FLOOR CHICAGO, ILLINOIS 60654 312.260.7300

PROJECT TEAM

ARCHITECT STAMP

VDTA PROJECT NUMBER

15010.00

**AYRES** 

101 E. BADGER ROAD MADISON, WI 53713 608.255.0800 www.AyresAssociates.com


	ISSUE	
NO.	REVISION DESCRIPTION	DATE
1	CITY SUBMITTAL	10.07.2015

© 2015 VALERIO DEWALT TRAIN ASSOCIATES, INC

SHEET TITLE

COVER SHEET



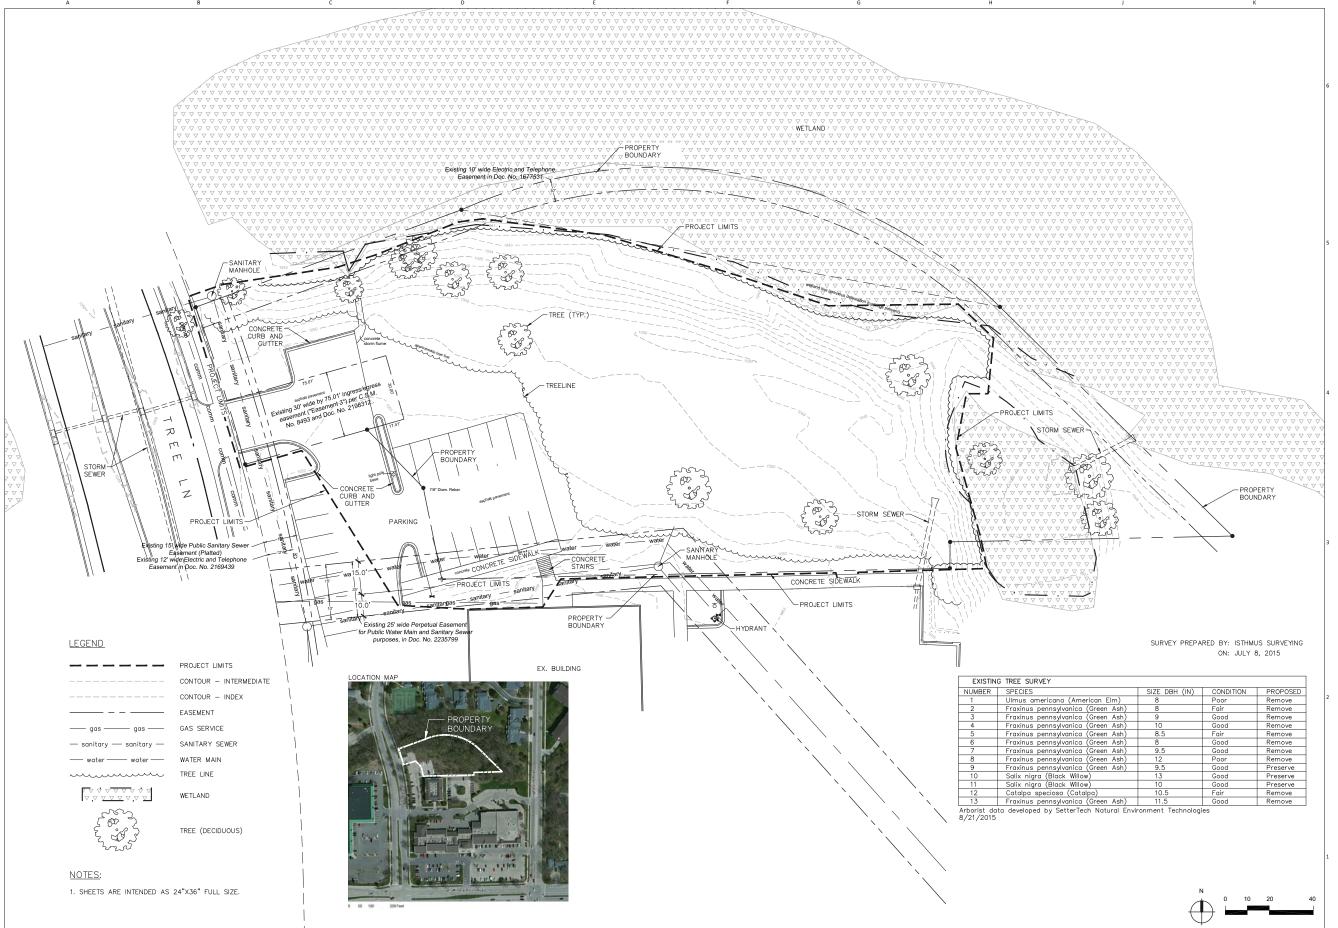





ARCHITECT

VALERIO DEWALT TRAIN ASSOCIATES, INC. 500 N. DEARBORN, 9TH FLOOR CHICAGO, ILLINOIS 60654 312.260.7300

PROJECT TEAM

CT TEAM ARCHITECT STAMP

VDTA PROJECT NUMBER

CONSULTANT

AYRES

101 E. BADGER ROAD MADISON, WI 53713 608.255.0800 www.AyresAssociates.com

CONSULTANT PROJECT NUMBER

27-1019


	ISSUE	
NO.	REVISION DESCRIPTION	DATE
1	CITY SUBMITTAL	10.07.2015

© 2015 VALERIO DEWALT TRAIN ASSOCIATES, INC

SHEET TITLE

**Existing Conditions** 



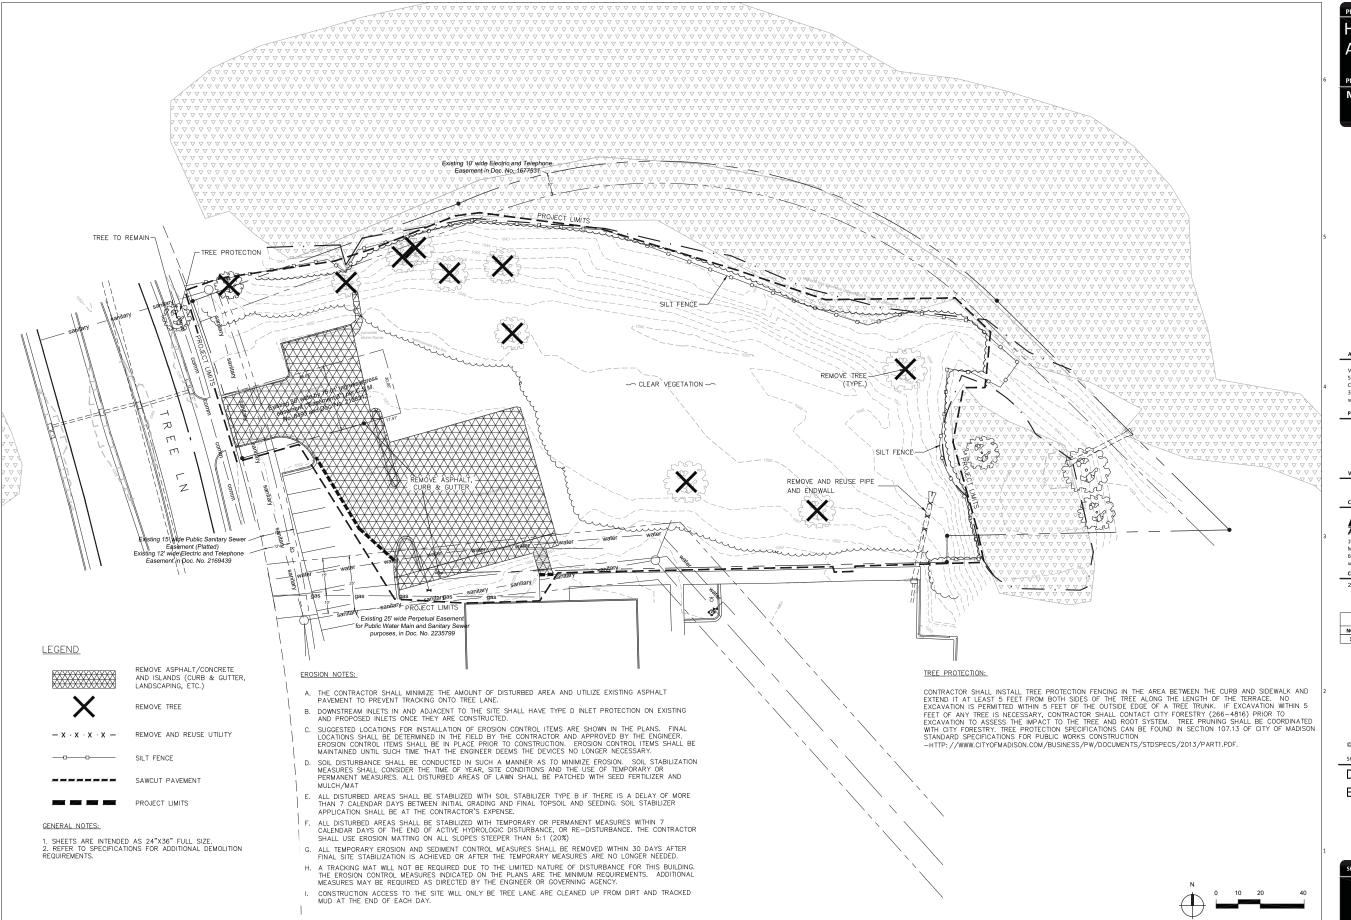



MADISON, WI



ARCHITEC

VALERIO DEWALT TRAIN ASSOCIATES, INC 500 N. DEARBORN, 9TH FLOOR CHICAGO, ILLINOIS 60654 312.260, 7310

PROJECT TEAM

CT TEAM ARCHITECT STAMP

VDTA PROJECT NUMBER



101 E. BADGER ROAD MADISON, WI 53713 608.255.0800 www.AyresAssociates.com

CONSULTANT PROJECT NUMBER

27-1019

	ISSUE	
NO.	REVISION DESCRIPTION	DATE
1	CITY SUBMITTAL	10.07.2015

© 2015 VALERIO DEWALT TRAIN ASSOCIATES, INC


SHEET TITLE

Demolition and Erosion Control



EET NUMBER

C-100

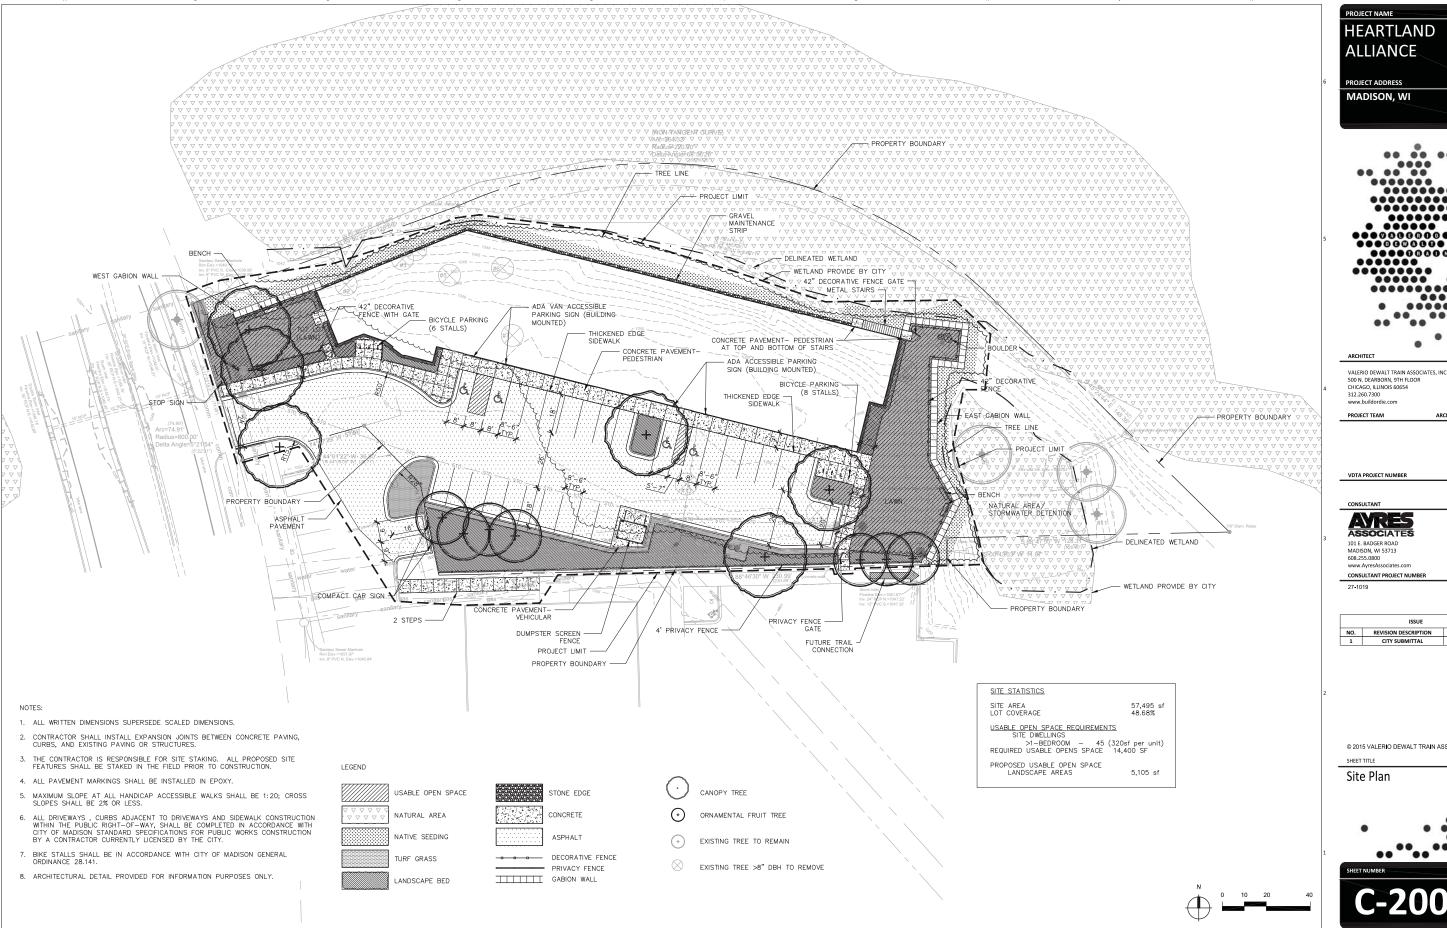



PROJECT ADDRESS MADISON, WI



VALERIO DEWALT TRAIN ASSOCIATES, INC. 500 N. DEARBORN, 9TH FLOOR CHICAGO, ILLINOIS 60654 312.260.7300

ARCHITECT STAMP

PROJECT TEAM

VDTA PROJECT NUMBER

# AYRES ASSOCIATES

101 E. BADGER ROAD MADISON, WI 53713 608.255.0800 www.AyresAssociates.com


CONSULTANT PROJECT NUMBER

ISSUE

© 2015 VALERIO DEWALT TRAIN ASSOCIATES, INC

Site Plan



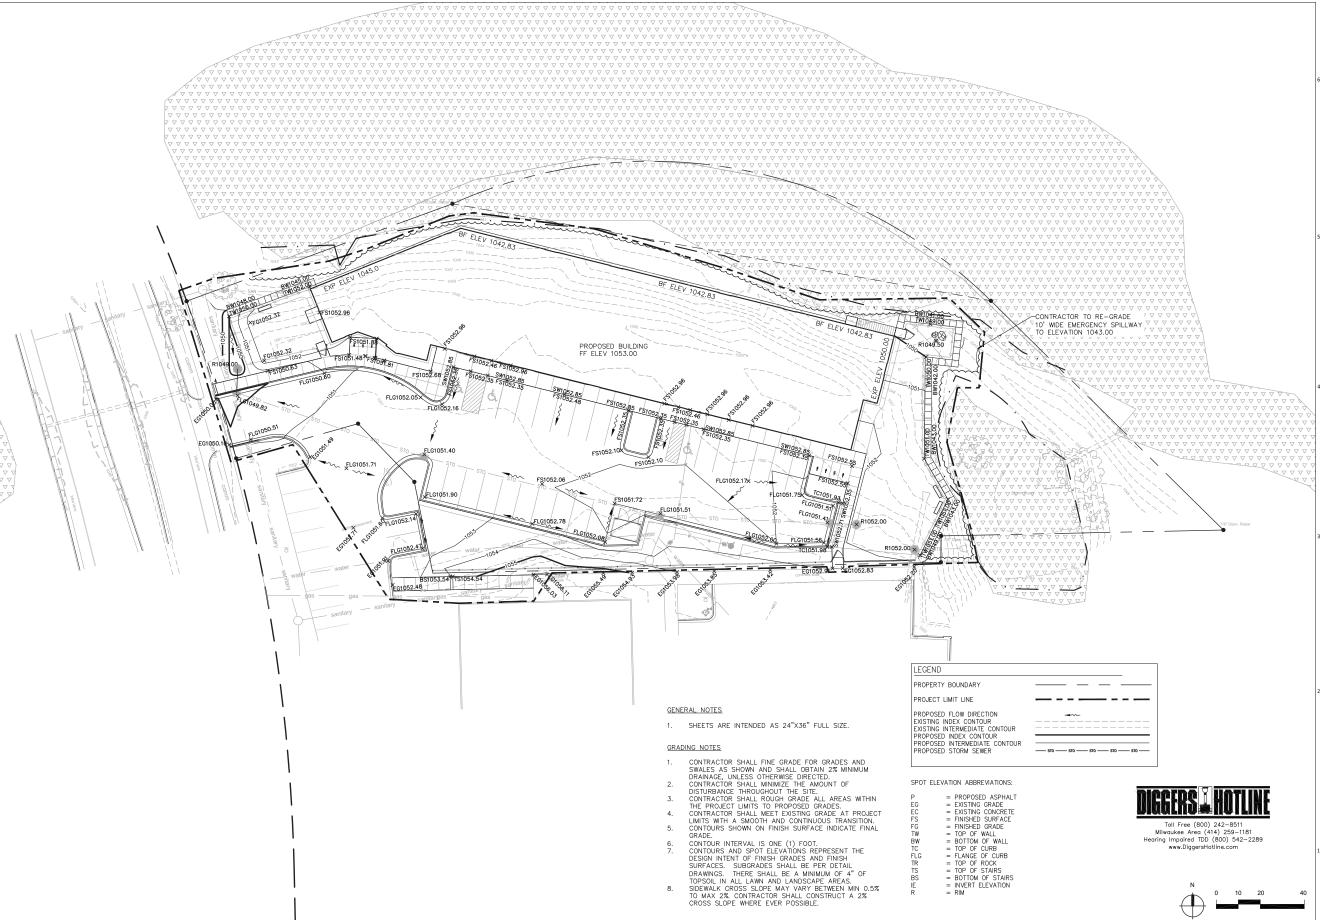





VALERIO DEWALT TRAIN ASSOCIATES, INC. 500 N. DEARBORN, 9TH FLOOR CHICAGO, ILLINOIS 60654 312.260.7300

PROJECT TEAM

ARCHITECT STAMP

VDTA PROJECT NUMBER

CONSULTANT AYRES ASSOCIATES

101 E. BADGER ROAD MADISON, WI 53713 608.255.0800 www.AyresAssociates.com


CONSULTANT PROJECT NUMBER 27-1019


ISSUE NO. REVISION DESCRIPTION

© 2015 VALERIO DEWALT TRAIN ASSOCIATES, INC

SHEET TITLE

Site Grading & Drainage Plan

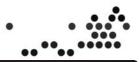

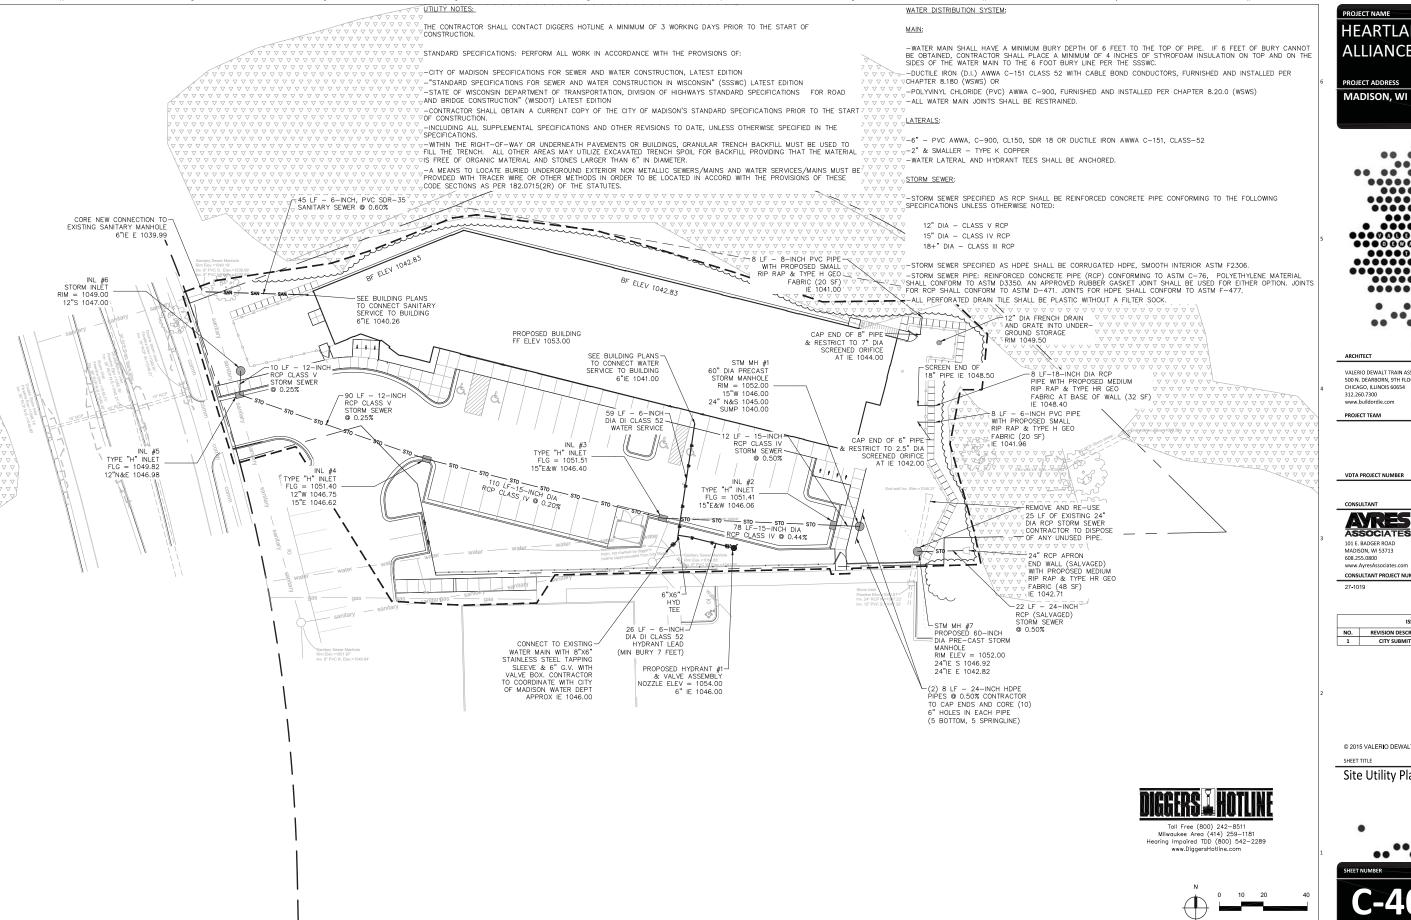

PROJECT NAME HEARTLAND ALLIANCE PROJECT ADDRESS



VALERIO DEWALT TRAIN ASSOCIATES, INC. 500 N. DEARBORN, 9TH FLOOR CHICAGO, ILLINOIS 60654 312.260.7300

ARCHITECT STAMP

PROJECT TEAM

VDTA PROJECT NUMBER

AYRES ASSOCIATES

101 E. BADGER ROAD MADISON, WI 53713 608.255.0800 www.AyresAssociates.cor

CONSULTANT PROJECT NUMBER

27-1019


	ISSUE	
NO.	REVISION DESCRIPTION	DATE
1	CITY SUBMITTAL	10.07.2015

© 2015 VALERIO DEWALT TRAIN ASSOCIATES, INC

SHEET TITLE

Site Utility Plan



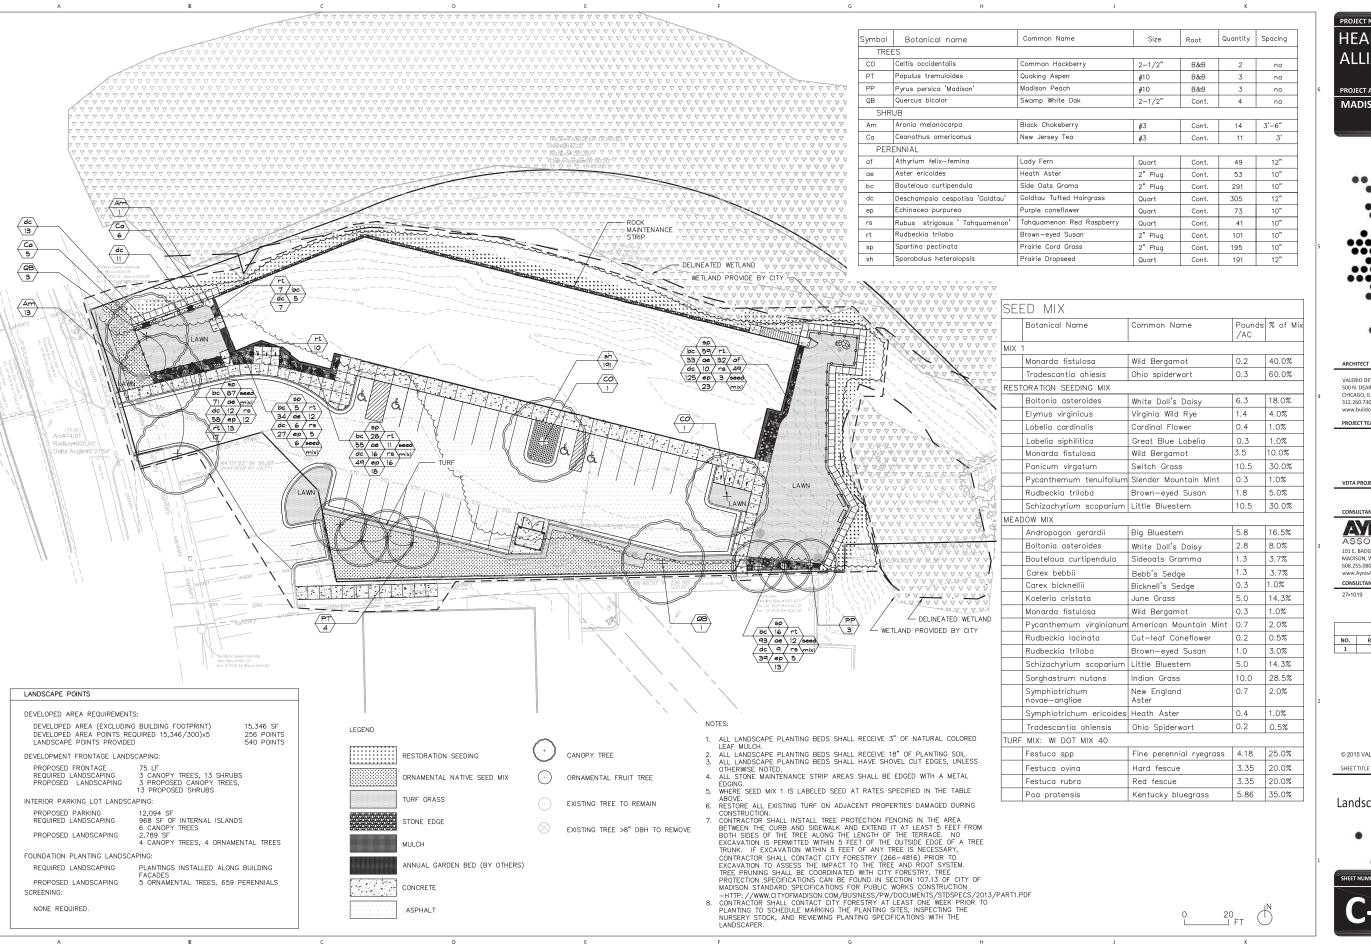

ROJECT NAME HEARTLAND ALLIANCE ROJECT ADDRESS MADISON, WI



VALERIO DEWALT TRAIN ASSOCIATES, INC 500 N. DEARBORN, 9TH FLOOR CHICAGO, ILLINOIS 60654 312,260,7300

PROJECT TEAM ARCHITECT STAMP

VDTA PROJECT NUMBER

CONSULTANT

**AYRES** 

101 E. BADGER ROAD MADISON, WI 53713 608.255.0800 www.AyresAssociates.


CONSULTANT PROJECT NUMBER

	ISSUE	
NO.	REVISION DESCRIPTION	DATE
1	CITY SUBMITTAL	10.07.2015

© 2015 VALERIO DEWALT TRAIN ASSOCIATES, INC.

Landscape Plan



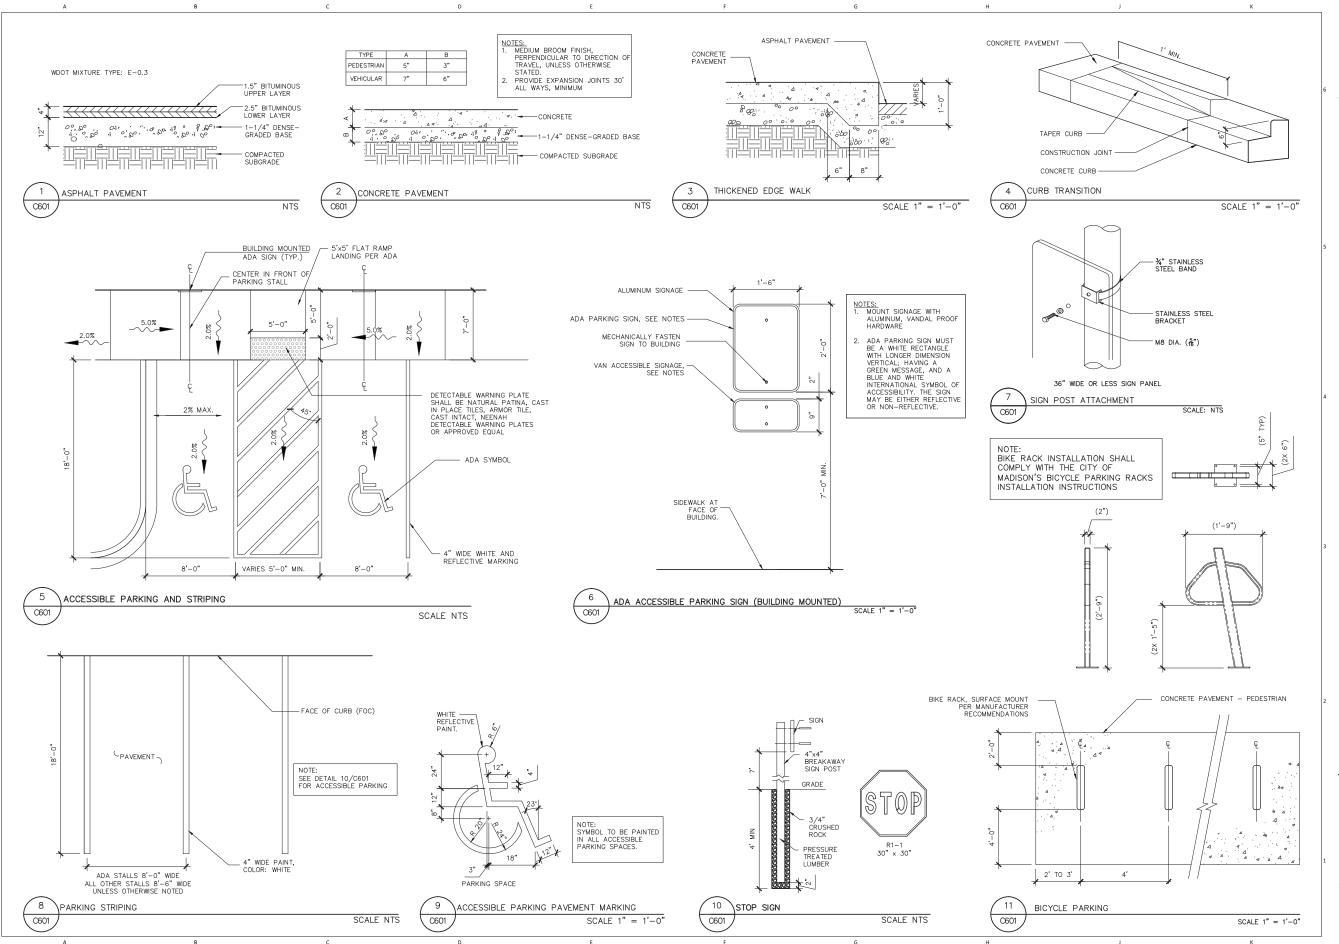





ARCHITECT

VALERIO DEWALT TRAIN ASSOCIATES, INC. 500 N. DEARBORN, 9TH FLOOR CHICAGO, ILLINOIS 60654 312.260.7300

PROJECT TEAM ARCHITECT STAMP

VDTA PROJECT NUMBER

CONSULTANT

AYRES

101 E. BADGER ROAD MADISON, WI 53713 608.255.0800 www.AyresAssociates.com

CONSULTANT PROJECT NUMBER


27-1019

	ISSUE	
NO.	REVISION DESCRIPTION	DATE
1	CITY SUBMITTAL	10.07.2015

© 2015 VALERIO DEWALT TRAIN ASSOCIATES, INC

- . ..



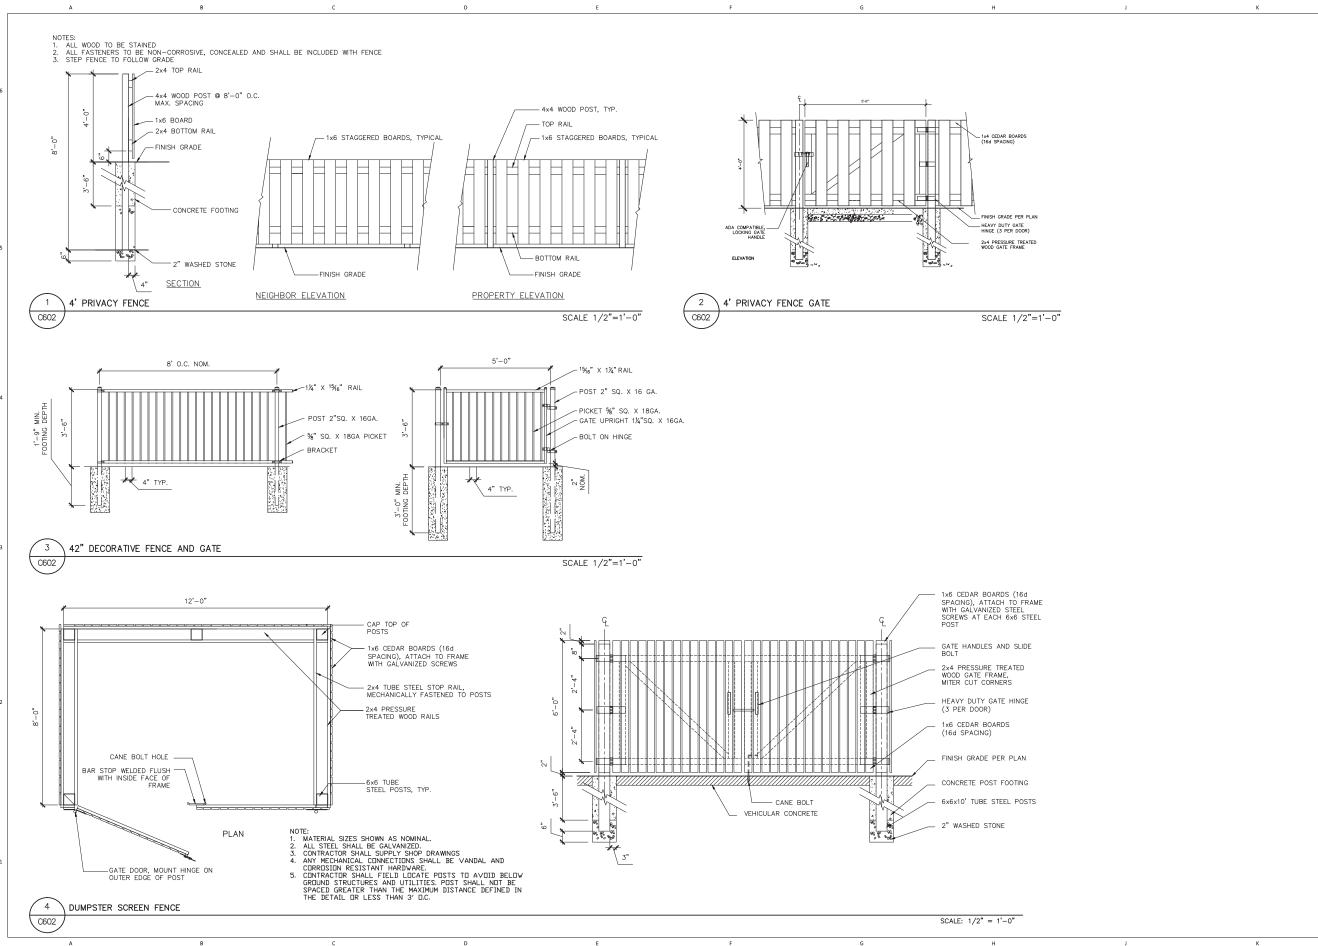

PROJECT NAME
HEARTLAND
ALLIANCE
PROJECT ADDRESS
MADISON, WI



ARCHITECT

VALERIO DEWALT TRAIN ASSOCIATES, INC. 500 N. DEARBORN, 9TH FLOOR CHICAGO, ILLINOIS 60654 312.260.7300 www.buildordie.com

ARCHITECT STAMP

PROJECT TEAM

VDTA PROJECT NUMBER

AYRES ASSOCIATES

101 E. BADGER ROAD MADISON, WI 53713 608.255.0800 www.AyresAssociates.com

CONSULTANT PROJECT NUMBER


27-1019

	ISSUE	
NO.	REVISION DESCRIPTION	DATE
1	CITY SUBMITTAL	10.07.2015


© 2015 VALERIO DEWALT TRAIN ASSOCIATES, INC

SHEET TITLE

Details

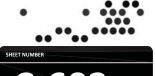

C-602

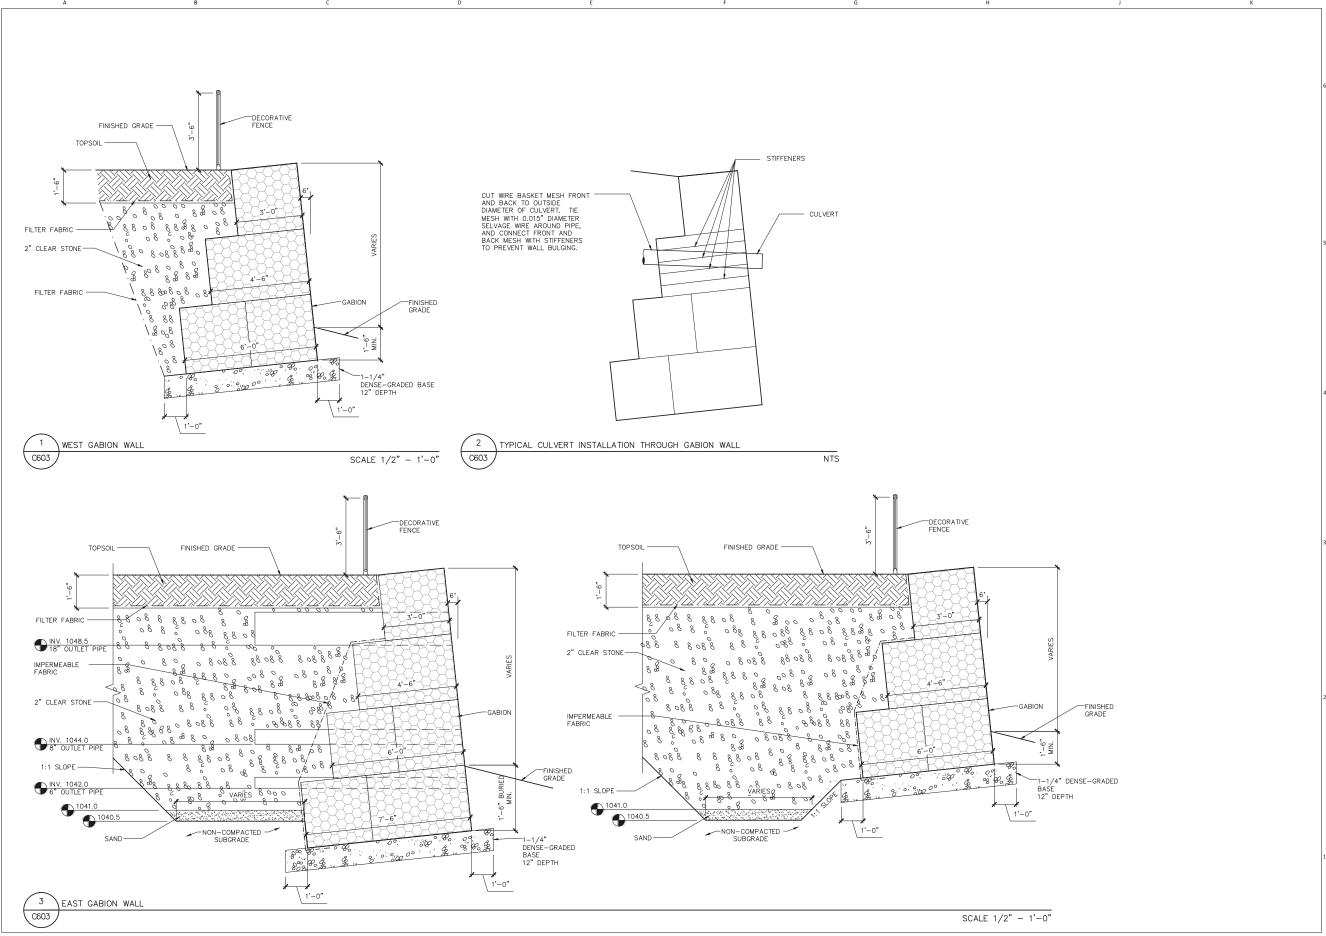

PROJECT NAME HEARTLAND ALLIANCE PROJECT ADDRESS MADISON, WI



VALERIO DEWALT TRAIN ASSOCIATES, INC. 500 N. DEARBORN, 9TH FLOOR CHICAGO, ILLINOIS 60654 312.260.7300

ARCHITECT STAMP

PROJECT TEAM

VDTA PROJECT NUMBER

CONSULTANT

AYRES ASSOCIATES

101 E. BADGER ROAD MADISON, WI 53713 608.255.0800 www.AyresAssociates.com


CONSULTANT PROJECT NUMBER

27-1019

	ISSUE	
NO.	REVISION DESCRIPTION	DATE
1	CITY SUBMITTAL	10.07.2015

© 2015 VALERIO DEWALT TRAIN ASSOCIATES, INC SHEET TITLE




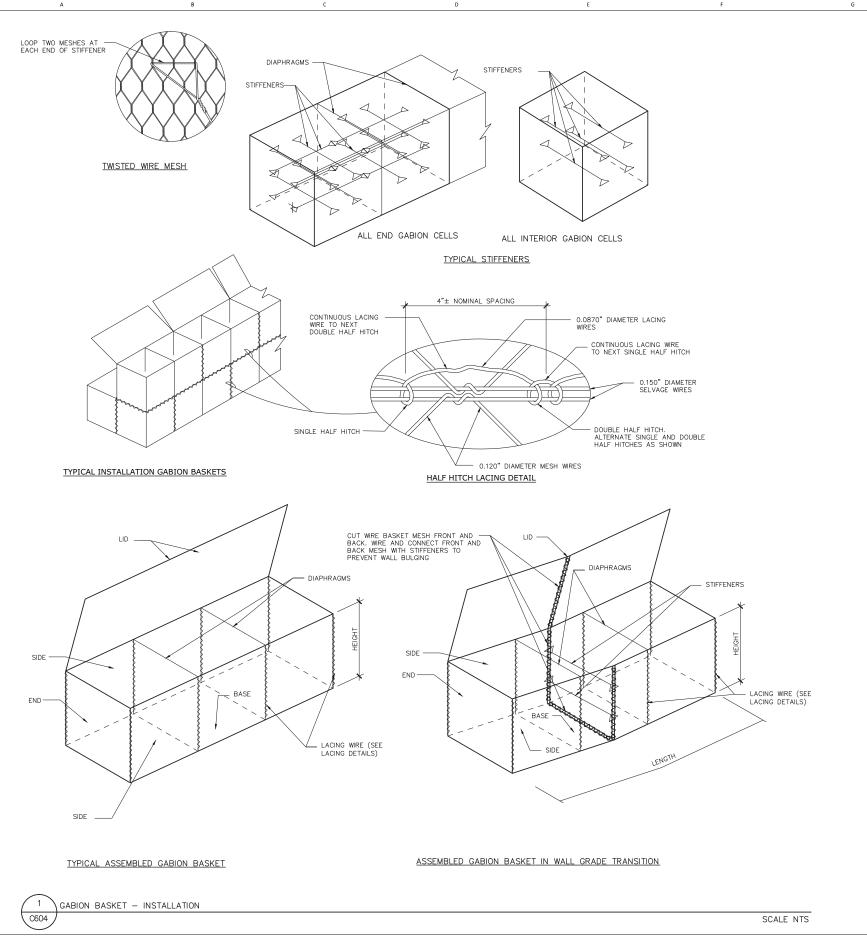

## McGraw-Edison

(atalog #	Type
froject	
Comments	Date
Irepared by	

GLEON GALLEON LED 1-10 Light Squares Solid State LED AREA/SITE LUMINAIRE

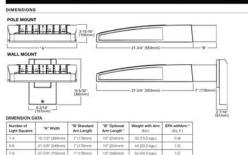

F:T·N 



SCALE NTS

WALL MOUNTED LIGHT C604

PROJECT ADDRESS MADISON, WI

PROJECT NAME HEARTLAND

ALLIANCE



VALERIO DEWALT TRAIN ASSOCIATES, INC. 500 N. DEARBORN, 9TH FLOOR CHICAGO, ILLINOIS 60654 312.260.7300

PROJECT TEAM ARCHITECT STAMP

VDTA PROJECT NUMBER

CONSULTANT



101 E. BADGER ROAD MADISON, WI 53713 608.255.0800 www.AyresAssociates.com

CONSULTANT PROJECT NUMBER


27-1019

ISSUE		
NO.	REVISION DESCRIPTION	DATE
1	CITY SUBMITTAL	10.07.2015

© 2015 VALERIO DEWALT TRAIN ASSOCIATES, INC

SHEET TITLE



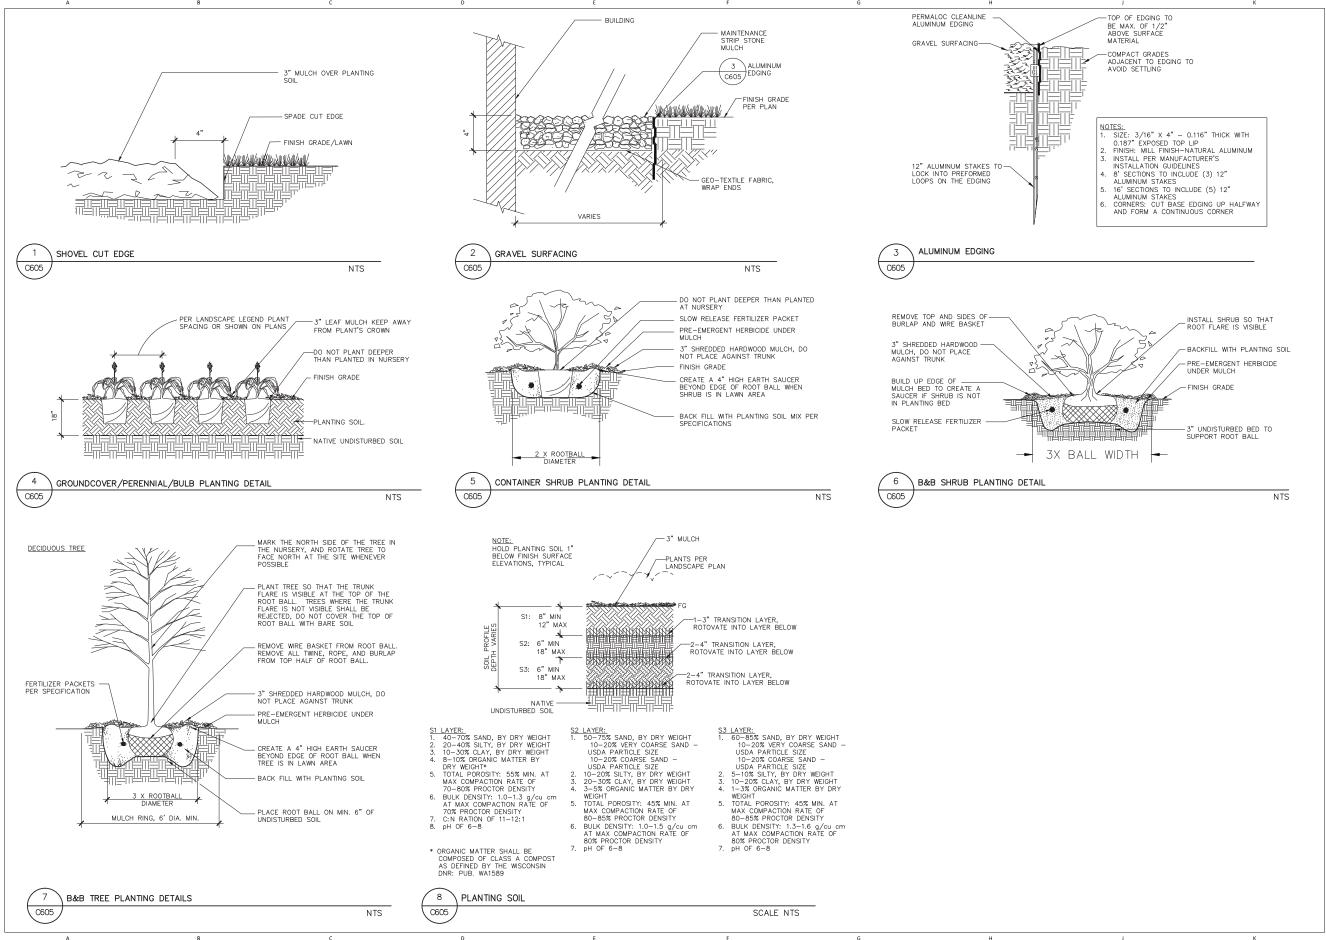

PROJECT NAME
HEARTLAND
ALLIANCE

PROJECT ADDRESS
MADISON, WI



ARCHITECT

VALERIO DEWALT TRAIN ASSOCIATES, INC. 500 N. DEARBORN, 9TH FLOOR CHICAGO, ILLINOIS 60654 312.260.7300 www.buildordie.com

PROJECT TEAM ARCHITECT STAMP

VDTA PROJECT NUMBER

CONSULTANT

AYRES

101 E. BADGER ROAD MADISON, WI 53713 608.255.0800 www.AyresAssociates.com


CONSULTANT PROJECT NUMBER


27-1019

	ISSUE	
NO.	REVISION DESCRIPTION	DATE
1	CITY SUBMITTAL	10.07.2015

© 2015 VALERIO DEWALT TRAIN ASSOCIATES, INC



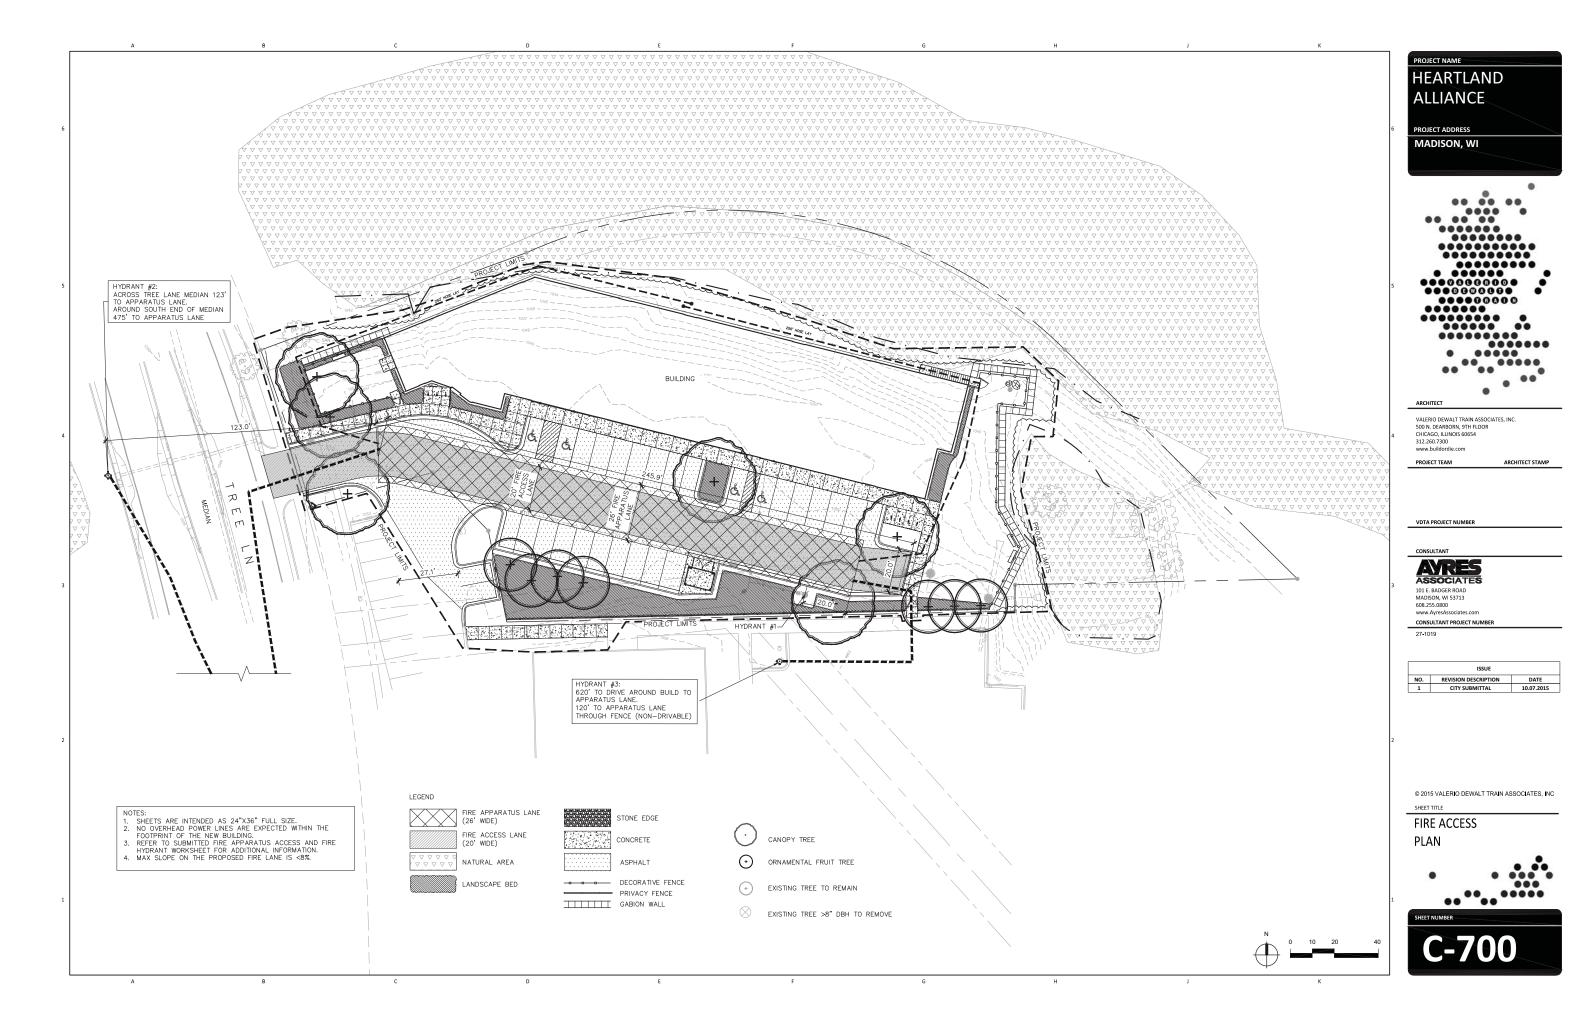

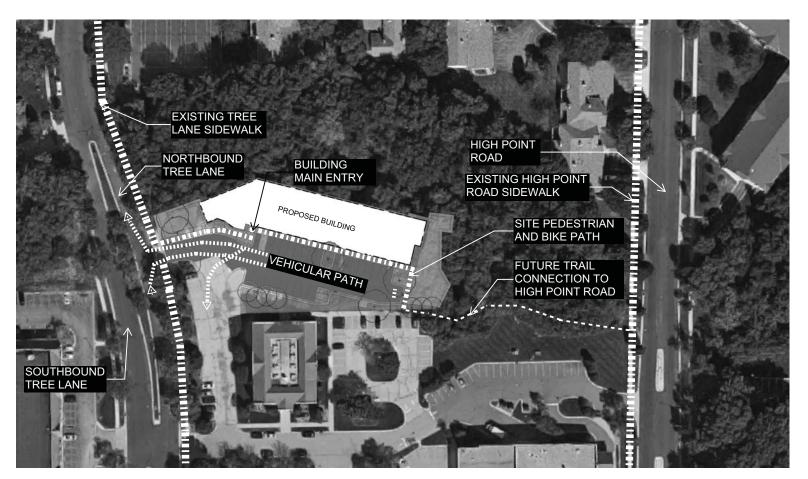

SITE CIRCULATION DIAGRAM



## CITY OF MADISON FIRE DEPARTMENT

Project Address: 7933 Tree Lane, Madison, WI 53714				
Contact Name & Phone #: Jacob Blue, PLA	Ayres Associates Inc	608-441-3564		

### FIRE APPARATUS ACCESS AND FIRE HYDRANT WORKSHEET

If non-sprinklered, fire lanes extend to within 150-feet of all portions of the exterior wall?  If sprinklered, fire lanes are within 250-feet of all portions of the exterior wall?	✓ Yes ☐ Yes ☐ Yes	□ No □ No □ No	□ N/A ▼ N/A ▼ N/A
2. Is the fire lane constructed of concrete or asphalt, designed to support a minimum load of 85,000 lbs?  a) Is the fire lane a minimum unobstructed width of at least 20-feet? b) Is the fire lane unobstructed with a vertical clearance of at least 13½-feet? c) Is the minimum inside turning radius of the fire lane at least 28-feet? d) Is the grade of the fire lane not more than a slope of 78½? c) Is the fire lane posted as fire lane? a. Is a detail of the sitingage included on the site plan? f) Is a roll-able curb used as part of the fire lane? a. Is a detail of the curb included on the site plan? g) Is part of a sidewalk used as part of the frequired fire lane? a. Is the sidewalk constructed to withstand 85,000-lbs?		No   No   No   No   No   No   No   No	N/A   N/A   N/A   N/A   N/A   N/A   N/A   N/A   N/A
Is the fire lane obstructed by security gates or barricades? If yes:     a) is the gate a minimum of 20-feet clear opening,     b) is an approved means of emergency operations installed, key vault, padlock or key switch?	Yes Yes Yes	☑ No □ No □ No	□ N/A ☑ N/A ☑ N/A
4. Is the Fire lane dead-ended with a length greater than 150-fee?  If yes, is the area for turning around fire apparatus provided by: a) A cul-de-sac with a minimum inside diameter of 70-fee? b) A 5-degree wye with a minimum length of 60-feet per side? c) A 90-degree tee with a minimum length of 60-feet per side?	☐ Yes ☐ Yes ☐ Yes ☐ Yes ☐ Yes ☐ Yes	No No No No	N/A N/A N/A
<ol> <li>Is any portion of the building to be used for high-piled storage in accordance with IFC Chapter 23?         If yes, see IFC 2306.6 for further requirements.     </li> </ol>	Yes	▼ No	□ N/A
6. Is any part of the building greater than 30-feet above the lowest level of fire apparatus access? If yes, answer the following questions: a) Is the acrial apparatus fire lane parallel to one entire side of the building? b) Is the near edge of the acrial apparatus fire lane between 15' and 30' from the building? c) Are there any overhead power or utility lines located across the acrial apparatus fire lane? d) Does the acrial apparatus fire lane have a minimum unobstructed width of 26-feet?	☐ Yes  ☑ Yes ☑ Yes ☐ Yes ☐ Yes ☐ Yes	V No  No  No  No  No  No  No  No	□ N/A □ N/A □ N/A □ N/A □ N/A
7. Are all portions of the required fire lanes within 500-feet of at least (2) hydrants? Note: Distances shall be measured along the path of the hose lay as it comes off the fire apparatus. a) Is the fire lane at least 26' wide for at least 20-feet on each side of the hydrants? b) Is there at least 40' between a hydrant and the building? c) Are the hydrant(s) settlesch on less than 5-feet nor more than 10-feet from the curb or edge of the street or fire lane? d) Are hydrants located in parking lot islands a minimum of 3½-feet from the hydrant to the curb?	✓ Yes ✓ Yes ✓ Yes ✓ Yes ✓ Yes ✓ Yes	No No No No No No	□ N/A □ N/A □ N/A □ N/A □ N/A □ N/A

Attach an additional sheet if further explanation is required for any answers.



### CITY OF MADISON LANDSCAPE WORKSHEET

Project Location /	Address 7933 Tree Lar	ne	
	Madison Supportive		
Owner Contact	Jacob Blue, PLA, Ayı	res Associates In	c.
Contact Phone	608-441-3564	Contact Email	BlueJ@AyresAssociates.com

\*\* Landscape plans for zoning lots greater than ten thousand (10,000) square feet in size MUST be prepared by a registered landscape architect. \*\*

The following standards apply to all exterior construction and development activity, including the expansion of existing buildings, structures and parking lots, except the construction of detached single-family and two-family dwellings and their accessory structures. The entire development site must be brought up to compliance with this section unless all of the following conditions apply, in which case only the affected areas need to be brought up to compliance.

- year period.
- (c) No demolition of a principal building is involved.
- (d) Any displaced landscaping elements must be replaced on the site and shown on a revised landscaping plan.

Landscape Calculations and Distribution
Required landscaped areas shall be calculated based upon the total developed area of the property. Developed area is defined as that area within a single contiguous boundary which is made up of structures, parking, driveways and docking/loading facilities, but excluding the area of any building footprint at grade, land designated for open space uses such as athletic fields, and undeveloped land area on the same zoning lot. There are three methods for calculating landscape points depending on the size of the lot and Zoning District.

Total square footage of developed area 15,346 sf Total landscape points required 256

For lots larger than five (5) acres, points shall be provided at five (5) points per three hundred (300) square feet for the first five (5) developed acres, and one (1) point per one hundred (100) square feet for all additional

Total square footage of developed area Five (5) acres = 217,800 square feet First five (5) developed acres = 3,630 points

Total landscape points required For the Industrial – Limited (IL) and Industrial – General (IG) districts, one (1) point shall be provided per one hundred (100) square feet of developed area.

10/2013

### Tabulation of Points and Credits

Use the table to indicate the quantity and points for all existing and proposed landscape elements.

Di T	Minimum Size at		Credits/ Existing Landscaping		New/ Proposed Landscaping	
Plant Type/ Element	Installation		Quantity	Points Achieved	Quantity	Points Achieved
Overstory deciduous tree	2½ inch caliper measured diameter at breast height (dbh)	35			6	210
Tall evergreen tree (i.e. pine, spruce)	5-6 feet tall	35				
Ornamental tree	1 1/2 inch caliper	15			7	105
Upright evergreen shrub (i.e. arborvitae)	3-4 feet tall	10				
Shrub, deciduous	#3 gallon container size, Min. 12"-24"	3			14	42
Shrub, evergreen	#3 gallon container size, Min. 12"-24"	4				
Ornamental grasses/ perennials	#1 gallon container size, Min. 8"-18"	2				
Ornamental/ decorative fencing or wall	n/a	4 per 10 lineal ft.			458	183
Existing significant specimen tree	Minimum size: 2 ½ inch caliper dbh. *Trees must be within developed area and cannot comprise more than 30% of total required points.	14 per caliper inch dbh. Maximum points per tree: 200				
Landscape furniture for public scating and/or transit connections	* Furniture must be within developed area, publically accessible, and cannot comprise more than 5% of total required points.	5 points per "seat"				
Sub Totals						540

Total Number of Points Provided \_\_\_\_\_540

10/2013

ROJECT NAME HEARTLAND ALLIANCE PROJECT ADDRESS MADISON, WI



500 N. DEARBORN, 9TH FLOOR CHICAGO, ILLINOIS 60654 312,260,7300 www.buildordie.com

PROJECT TEAM ARCHITECT STAMP

VDTA PROJECT NUMBER

CONSULTANT

AYRES ASSOCIATES

101 F BADGER ROAD MADISON, WI 53713 608.255.0800 www.AyresAssociates.co


CONSULTANT PROJECT NUMBER

ISSUE NO. REVISION DESCRIPTION 1 CITY SUBMITTAL 10.07.2015

© 2015 VALERIO DEWALT TRAIN ASSOCIATES, INC.

SHEET TITLE



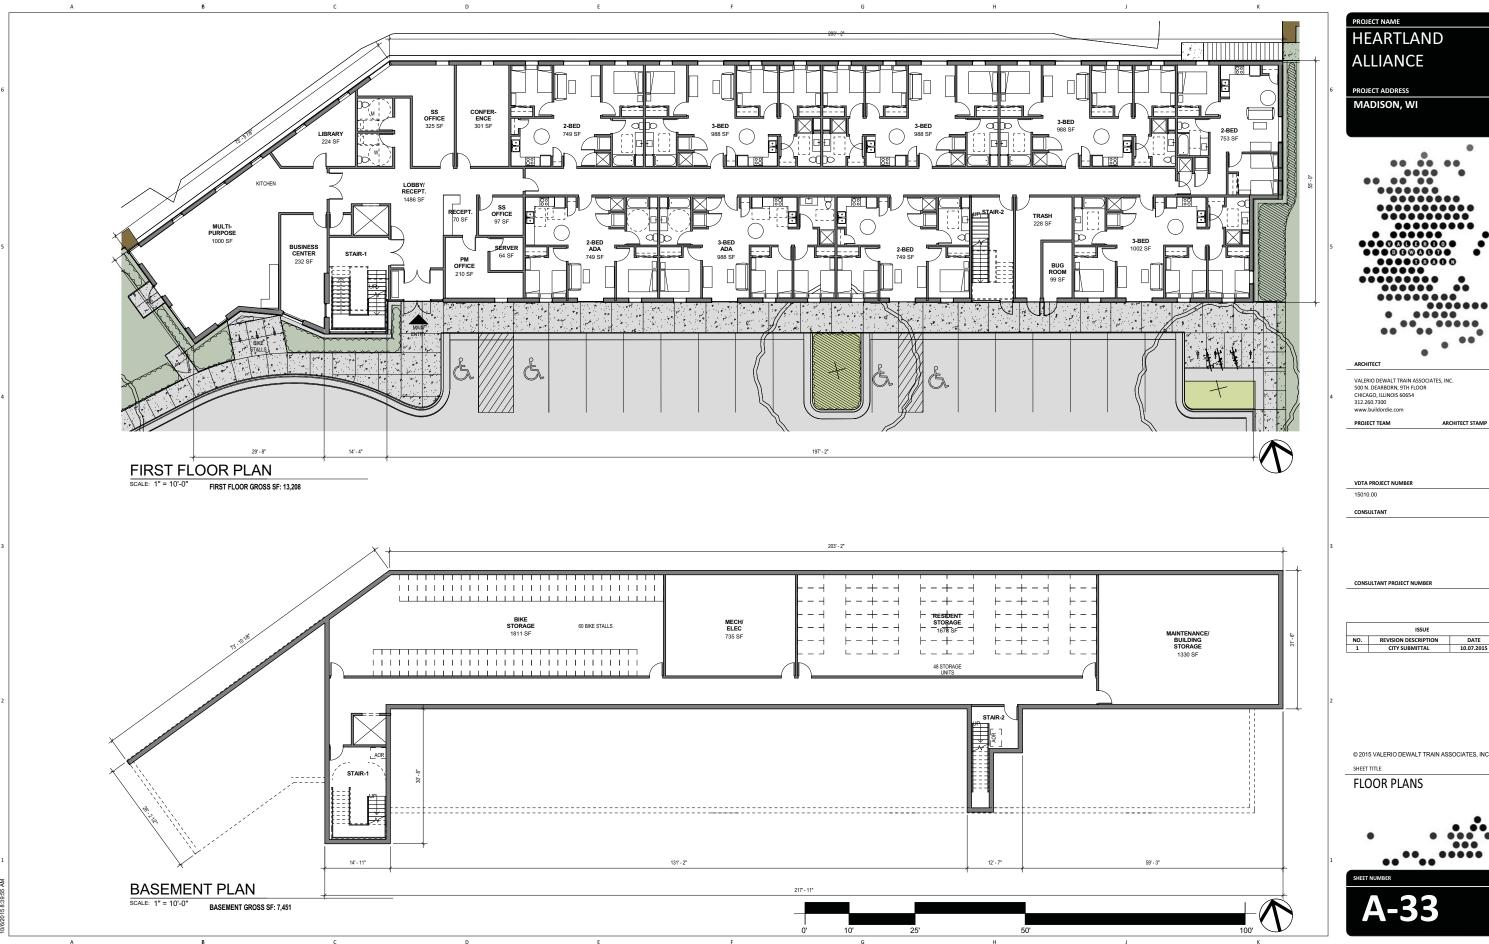




	ISSUE	
NO.	REVISION DESCRIPTION	DATE
1	CITY SUBMITTAL	10.07.2015

© 2015 VALERIO DEWALT TRAIN ASSOCIATES, INC



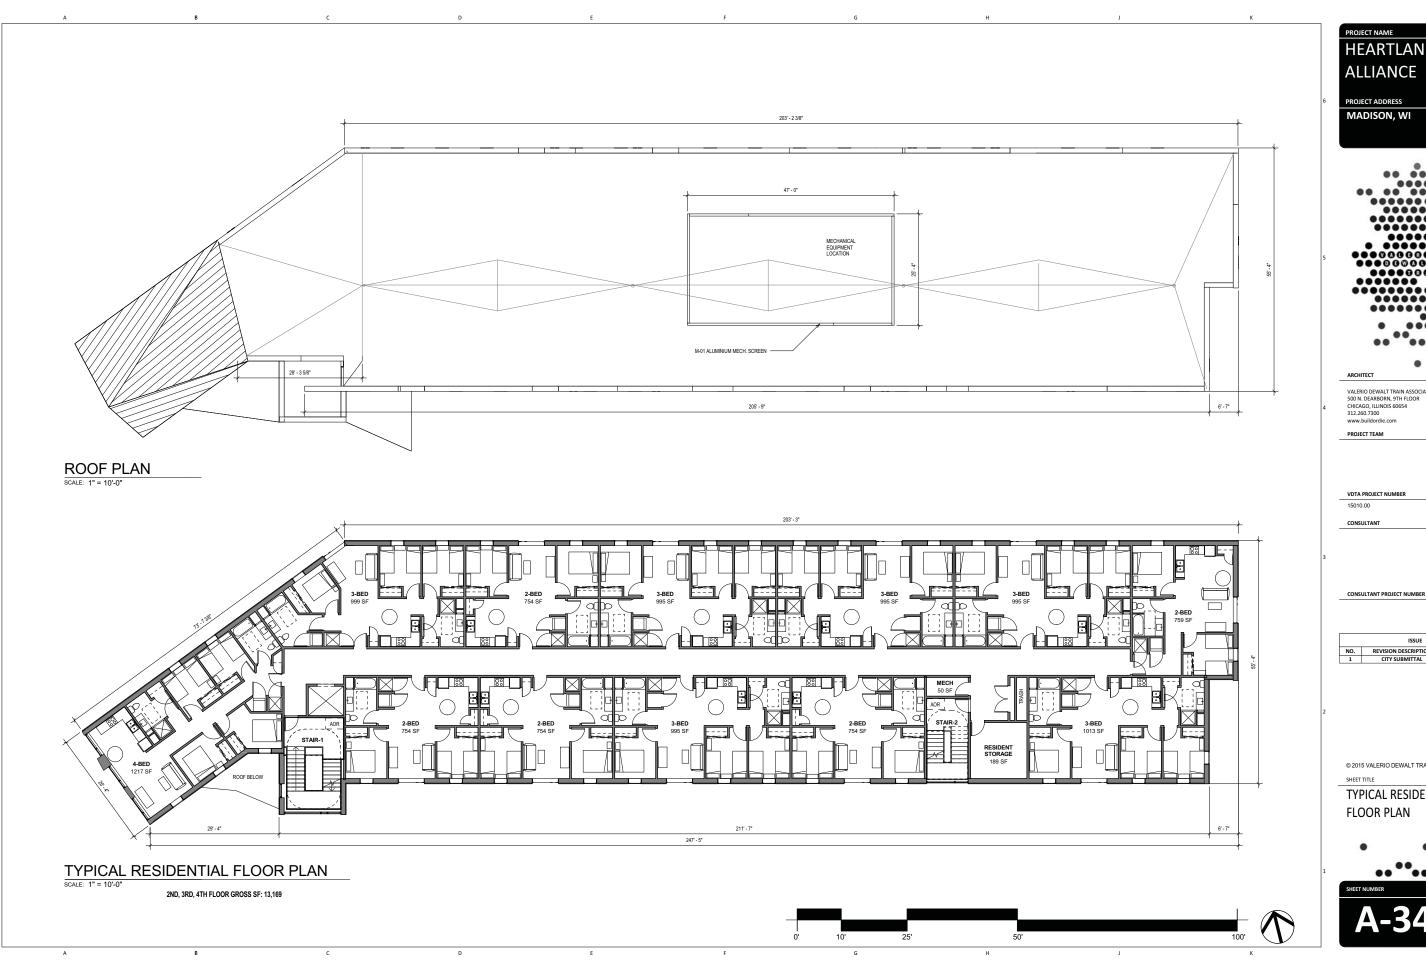

PROJECT NAME HEARTLAND ALLIANCE

PROJECT ADDRESS MADISON, WI



VALERIO DEWALT TRAIN ASSOCIATES, INC. 500 N. DEARBORN, 9TH FLOOR CHICAGO, ILLINOIS 60654 312.260.7300

PROJECT TEAM

ARCHITECT STAMP

VDTA PROJECT NUMBER


	ISSUE	
NO.	REVISION DESCRIPTION	DATE
1	CITY SUBMITTAL	10.07.2015

© 2015 VALERIO DEWALT TRAIN ASSOCIATES, INC

SHEET TITLE

TYPICAL RESIDENTIAL FLOOR PLAN




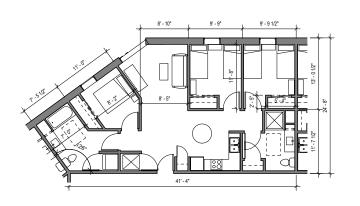


ATYPICAL 3 BED UNIT PLAN

SCALE: 1/8" = 1'-0"


ADA 3 BED UNIT PLAN

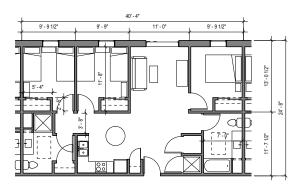


## TYPICAL 3 BED UNIT PLAN

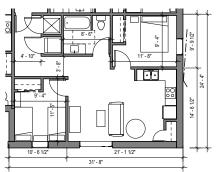


ATYPICAL 2 BED UNIT PLAN
SCALE: 1/8" = 1'-0"

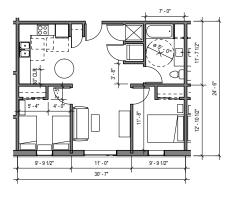

ADA 2 BED UNIT PLAN SCALE: 1/8" = 1'-0"

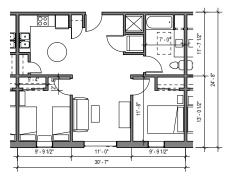

# TYPICAL 2 BED UNIT PLAN SCALE: 1/8" = 1'-0"

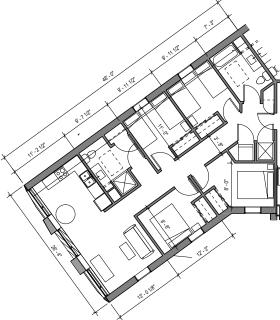

TYPICAL 4 BED UNIT PLAN

PROJECT NAME HEARTLAND ALLIANCE PROJECT ADDRESS

MADISON, WI



VALERIO DEWALT TRAIN ASSOCIATES, INC. 500 N. DEARBORN, 9TH FLOOR CHICAGO, ILLINOIS 60654 312.260.7300 www.buildordie.com

PROJECT TEAM ARCHITECT STAMP

VDTA PROJECT NUMBER

15010.00 CONSULTANT

CONSULTANT PROJECT NUMBER

ISSUE		
NO.	REVISION DESCRIPTION	DATE
1	CITY SUBMITTAL	10.07.2015

© 2015 VALERIO DEWALT TRAIN ASSOCIATES, INC SHEET TITLE

ENLARGED UNIT PLANS



