


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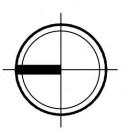
Issued for SIP March 13, 2015 Issued for UDC - May 6, 2015 Issued for UDC - May 13, 2015

PROJECT TITLE WINGRA POINT PHASE 2

Fish Hatchery Road & Park Street Madison, WI SHEET TITLE Site Plan


C-1.1 PROJECT NO. 1433 © 2013 Knothe & Bruce Architects, LLC




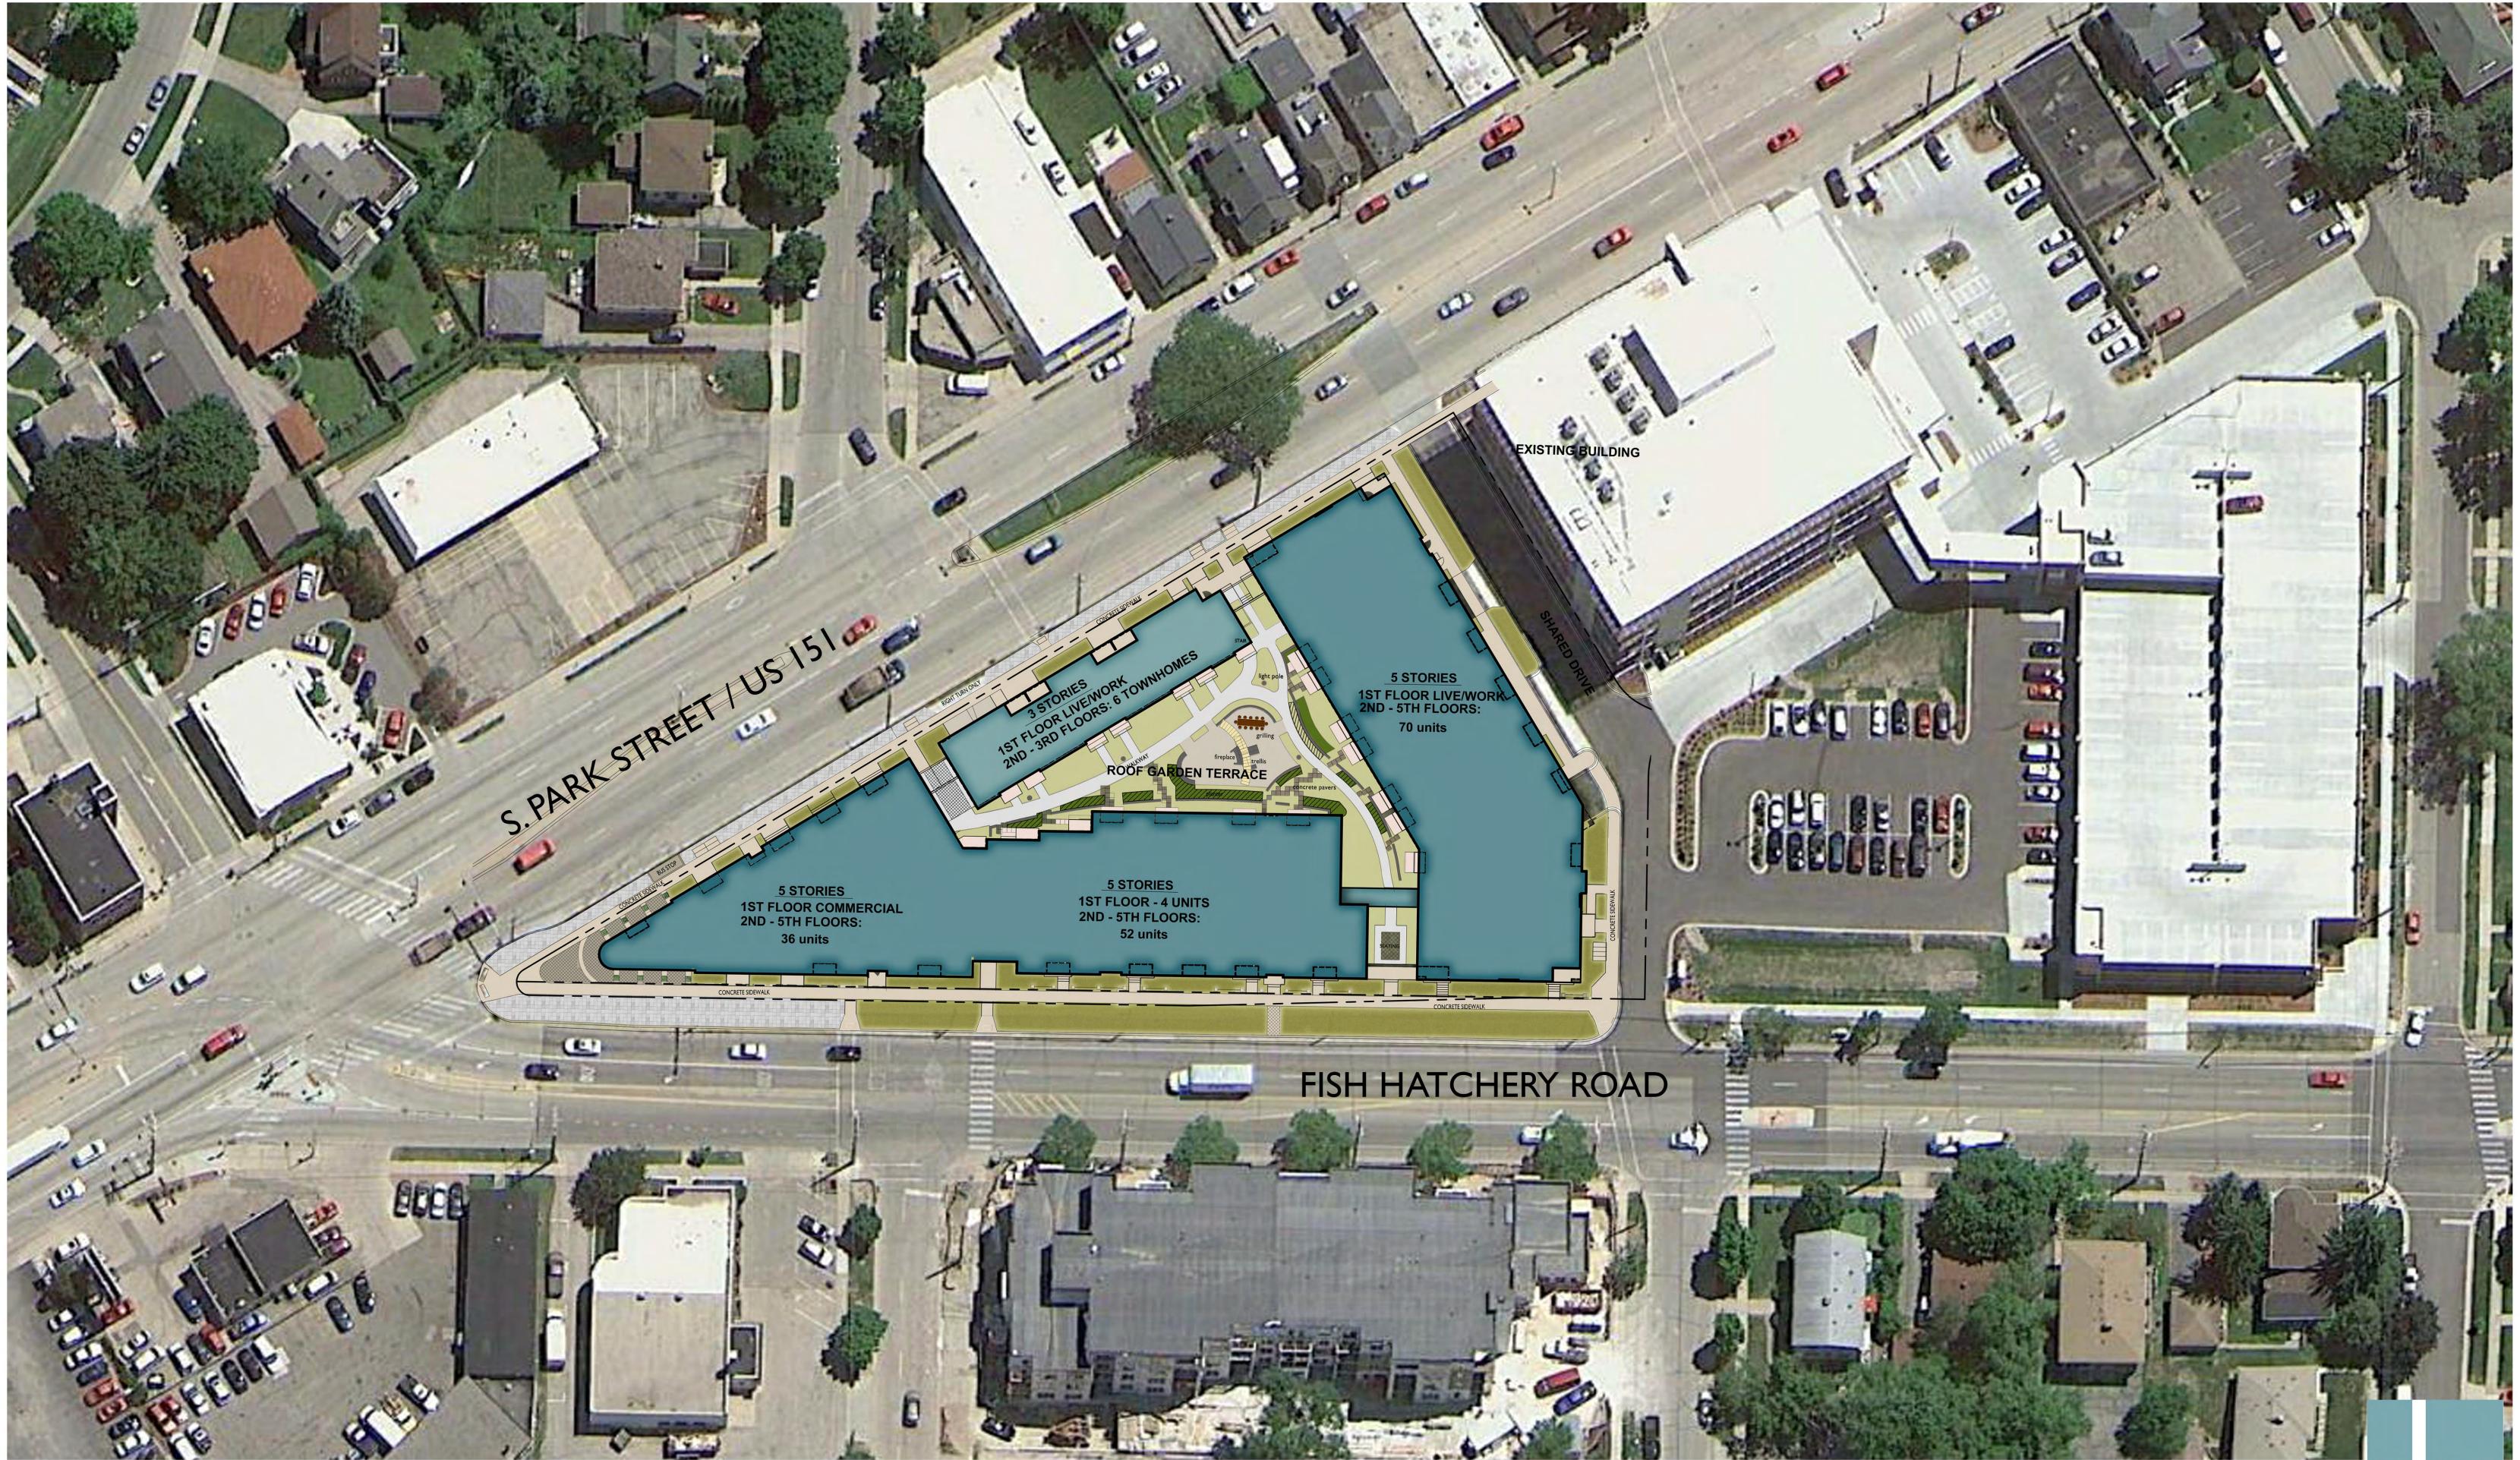

Roof Plan Wingra Point II August 5, 2015



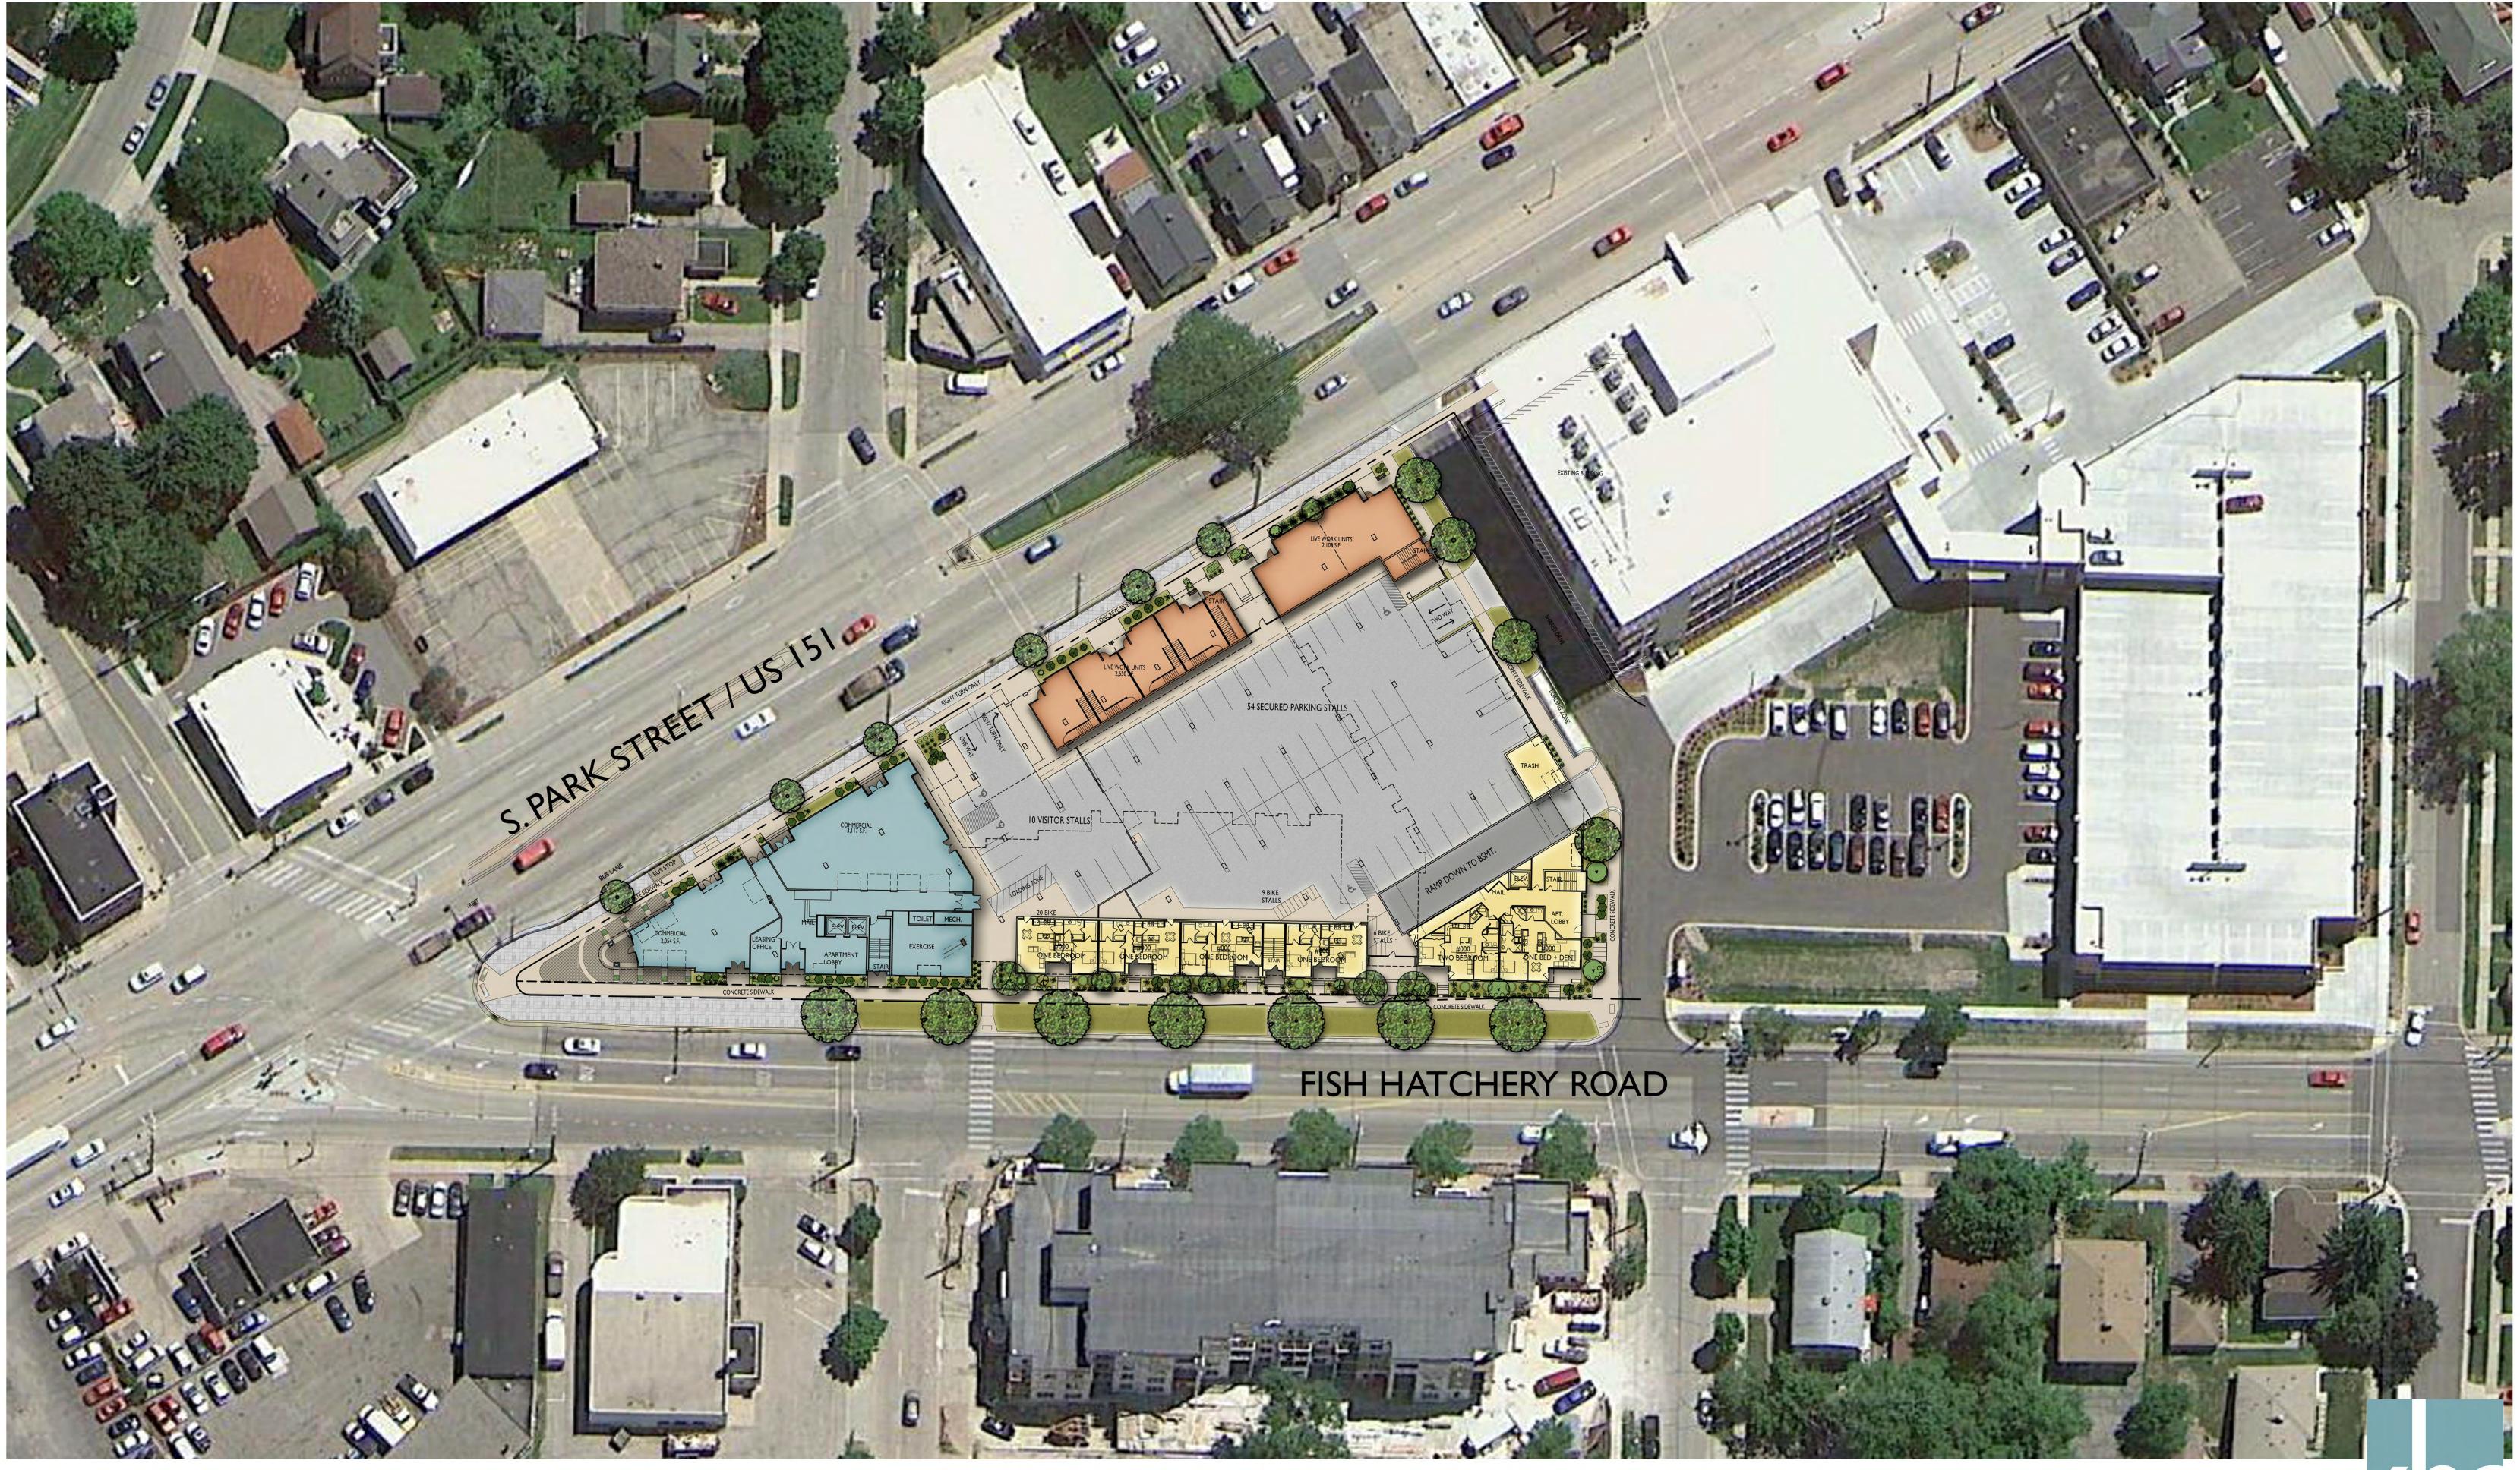

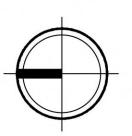


Aerial Site Plan Wingra Point II August 5, 2015








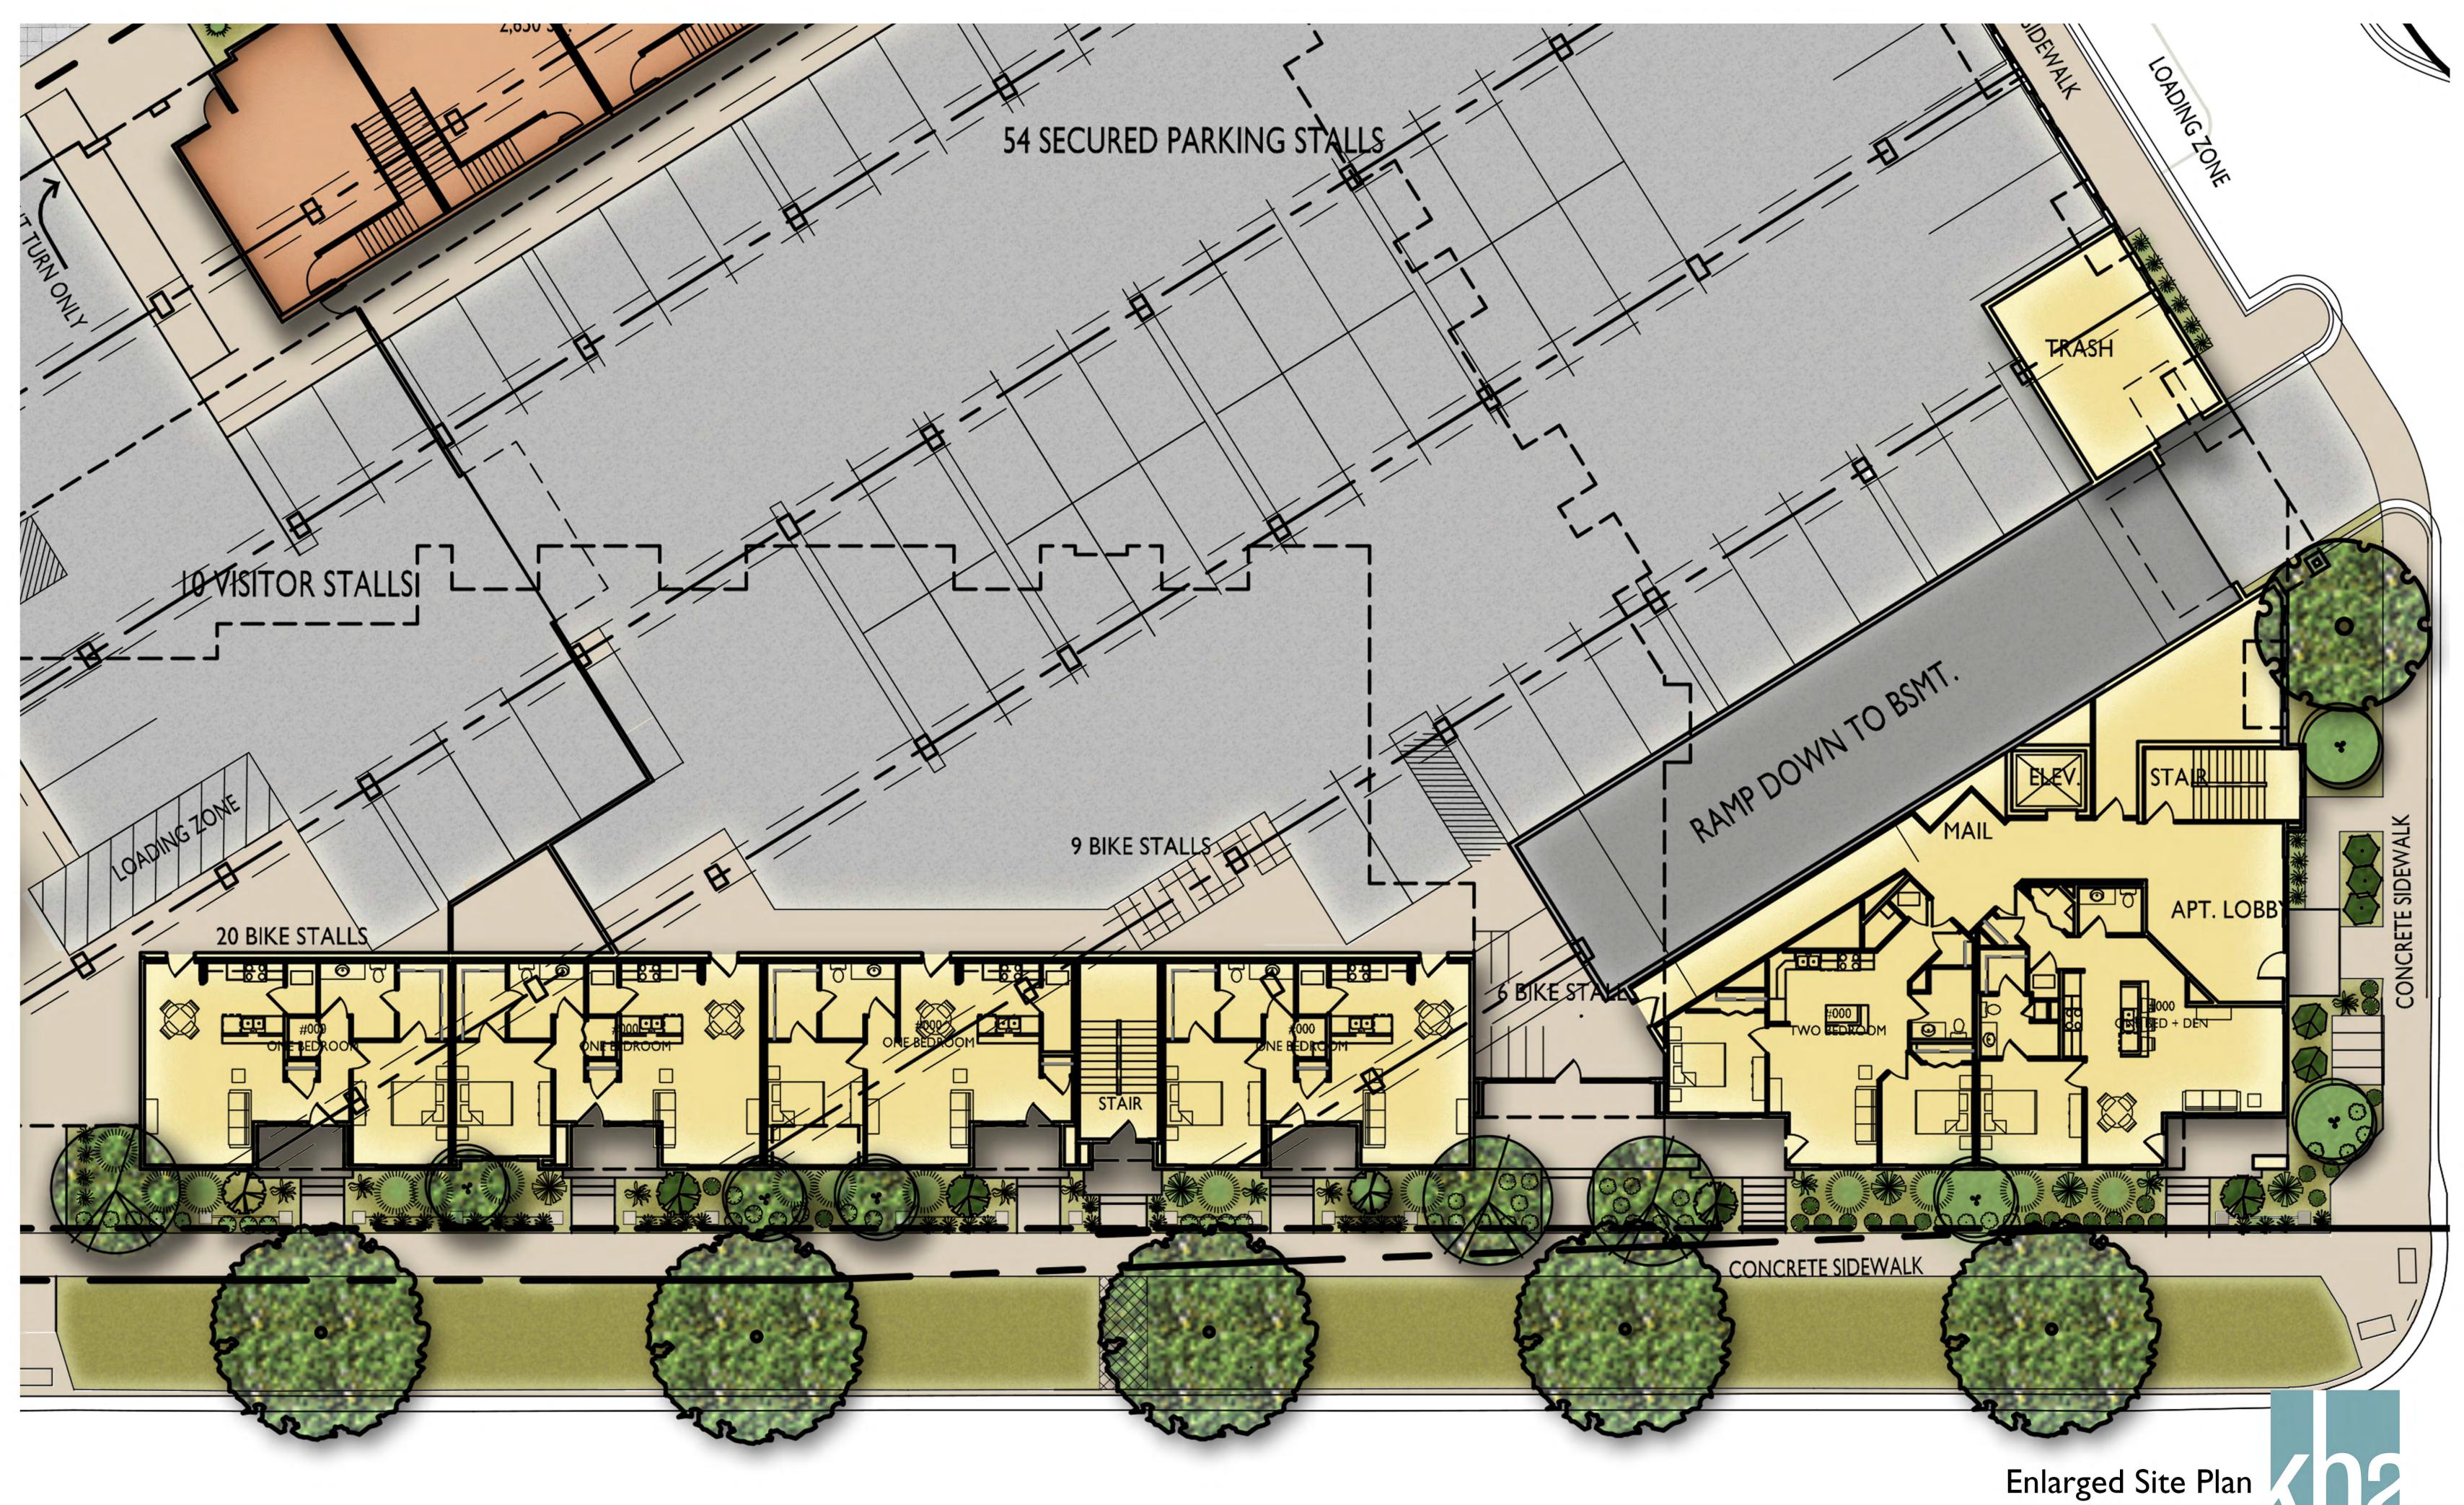


Wingra Point II July 29, 2015


STATISTICS						
Description	Symbol	Avg	Max	Min	Max/Min	Avg/Min
BLDG. TO PROP	+	0.9 fc	5.6 fc	0.0 fc	N / A	N / A
PROP TO CURB	+	0.3 fc	4.0 fc	0.0 fc	N / A	N / A

LUMIN	AIRE S	CHED	ULE						
Symbol	Label	Qty	Catalog Number	Description	Lamp	File	Lumens	LLF	Watts
0	PWY	4	PWY-EDG-5S-**- 02-D-UL-350 or BXBP*R18D-UH (350mA)	18 LED TYPE V SHORT 350mA 5700K EDGE PATHWAY	EIGHTEEN WHITE LIGHT EMITTING DIODES (LEDS), VERTICAL BASE- -UP POSITION.	PWY-EDG- _5S02-D- UL-350- 57K IES	Absolute	1.00	21.2
	OHD	3	BXSPWAx2MG-U	Cree XSPW Series Wallpack Luminaire, Type II Medium, 5700K, G Input Power Designator	4 type MDA LEDs	XSPWAx2MG- U_RESTL-2014- -0033.IES	Absolute	1.00	24.56
0	CNPY	28	ML5606930-691WB	HALO 6 INCH ML56 600 SERIES LED DOWNLIGHT WITH WHITE POLYMER BAFFLE REFLECTOR	(1) HIGH LUMEN LED 90CRI / 3000K CCT ABSOLUTE PHOTOMETRY IS BASED ON CALIBRATION FACTORS CREATED USING LAB LUMEN STANDARDS IN GONIOPHOTOMETER WITH TEST DISTANCE OF 28.75 FEET	ML5606930- 691WB.ies	Absolute	1.00	9.8
				EXAMPLE I	LIGHT FIXTURE DISTRIBUTION				
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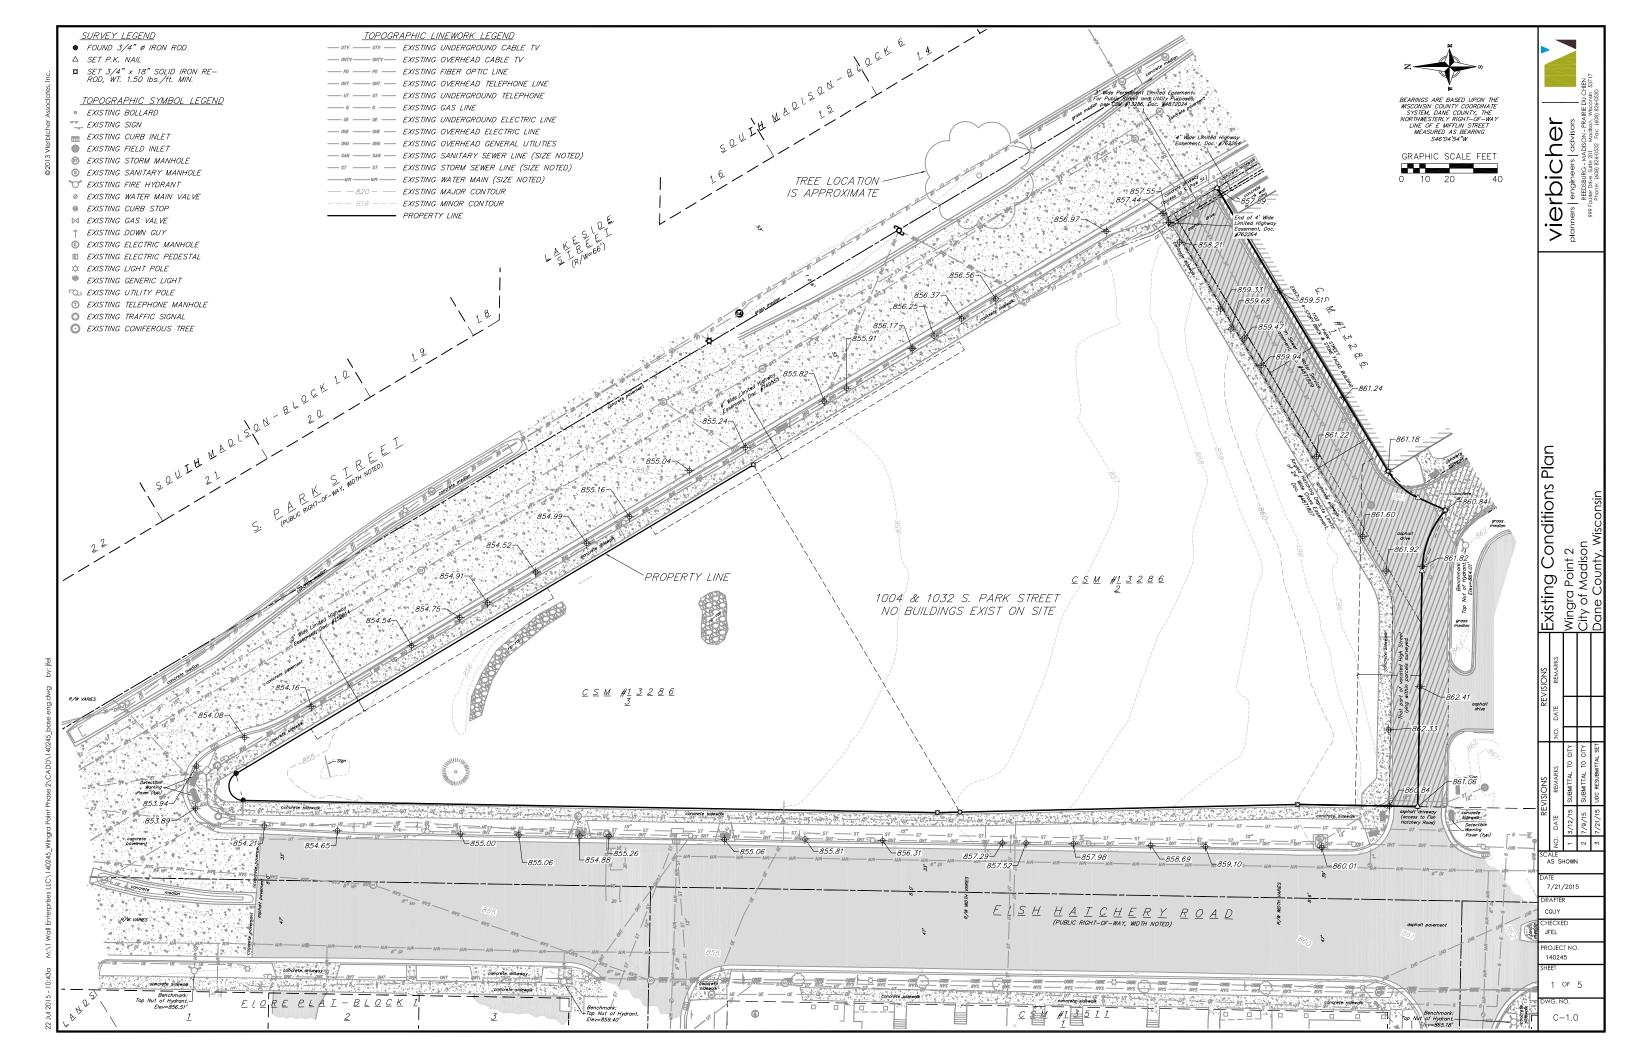
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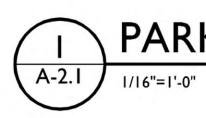
PROJECT TITLE WINGRA POINT PHASE 2

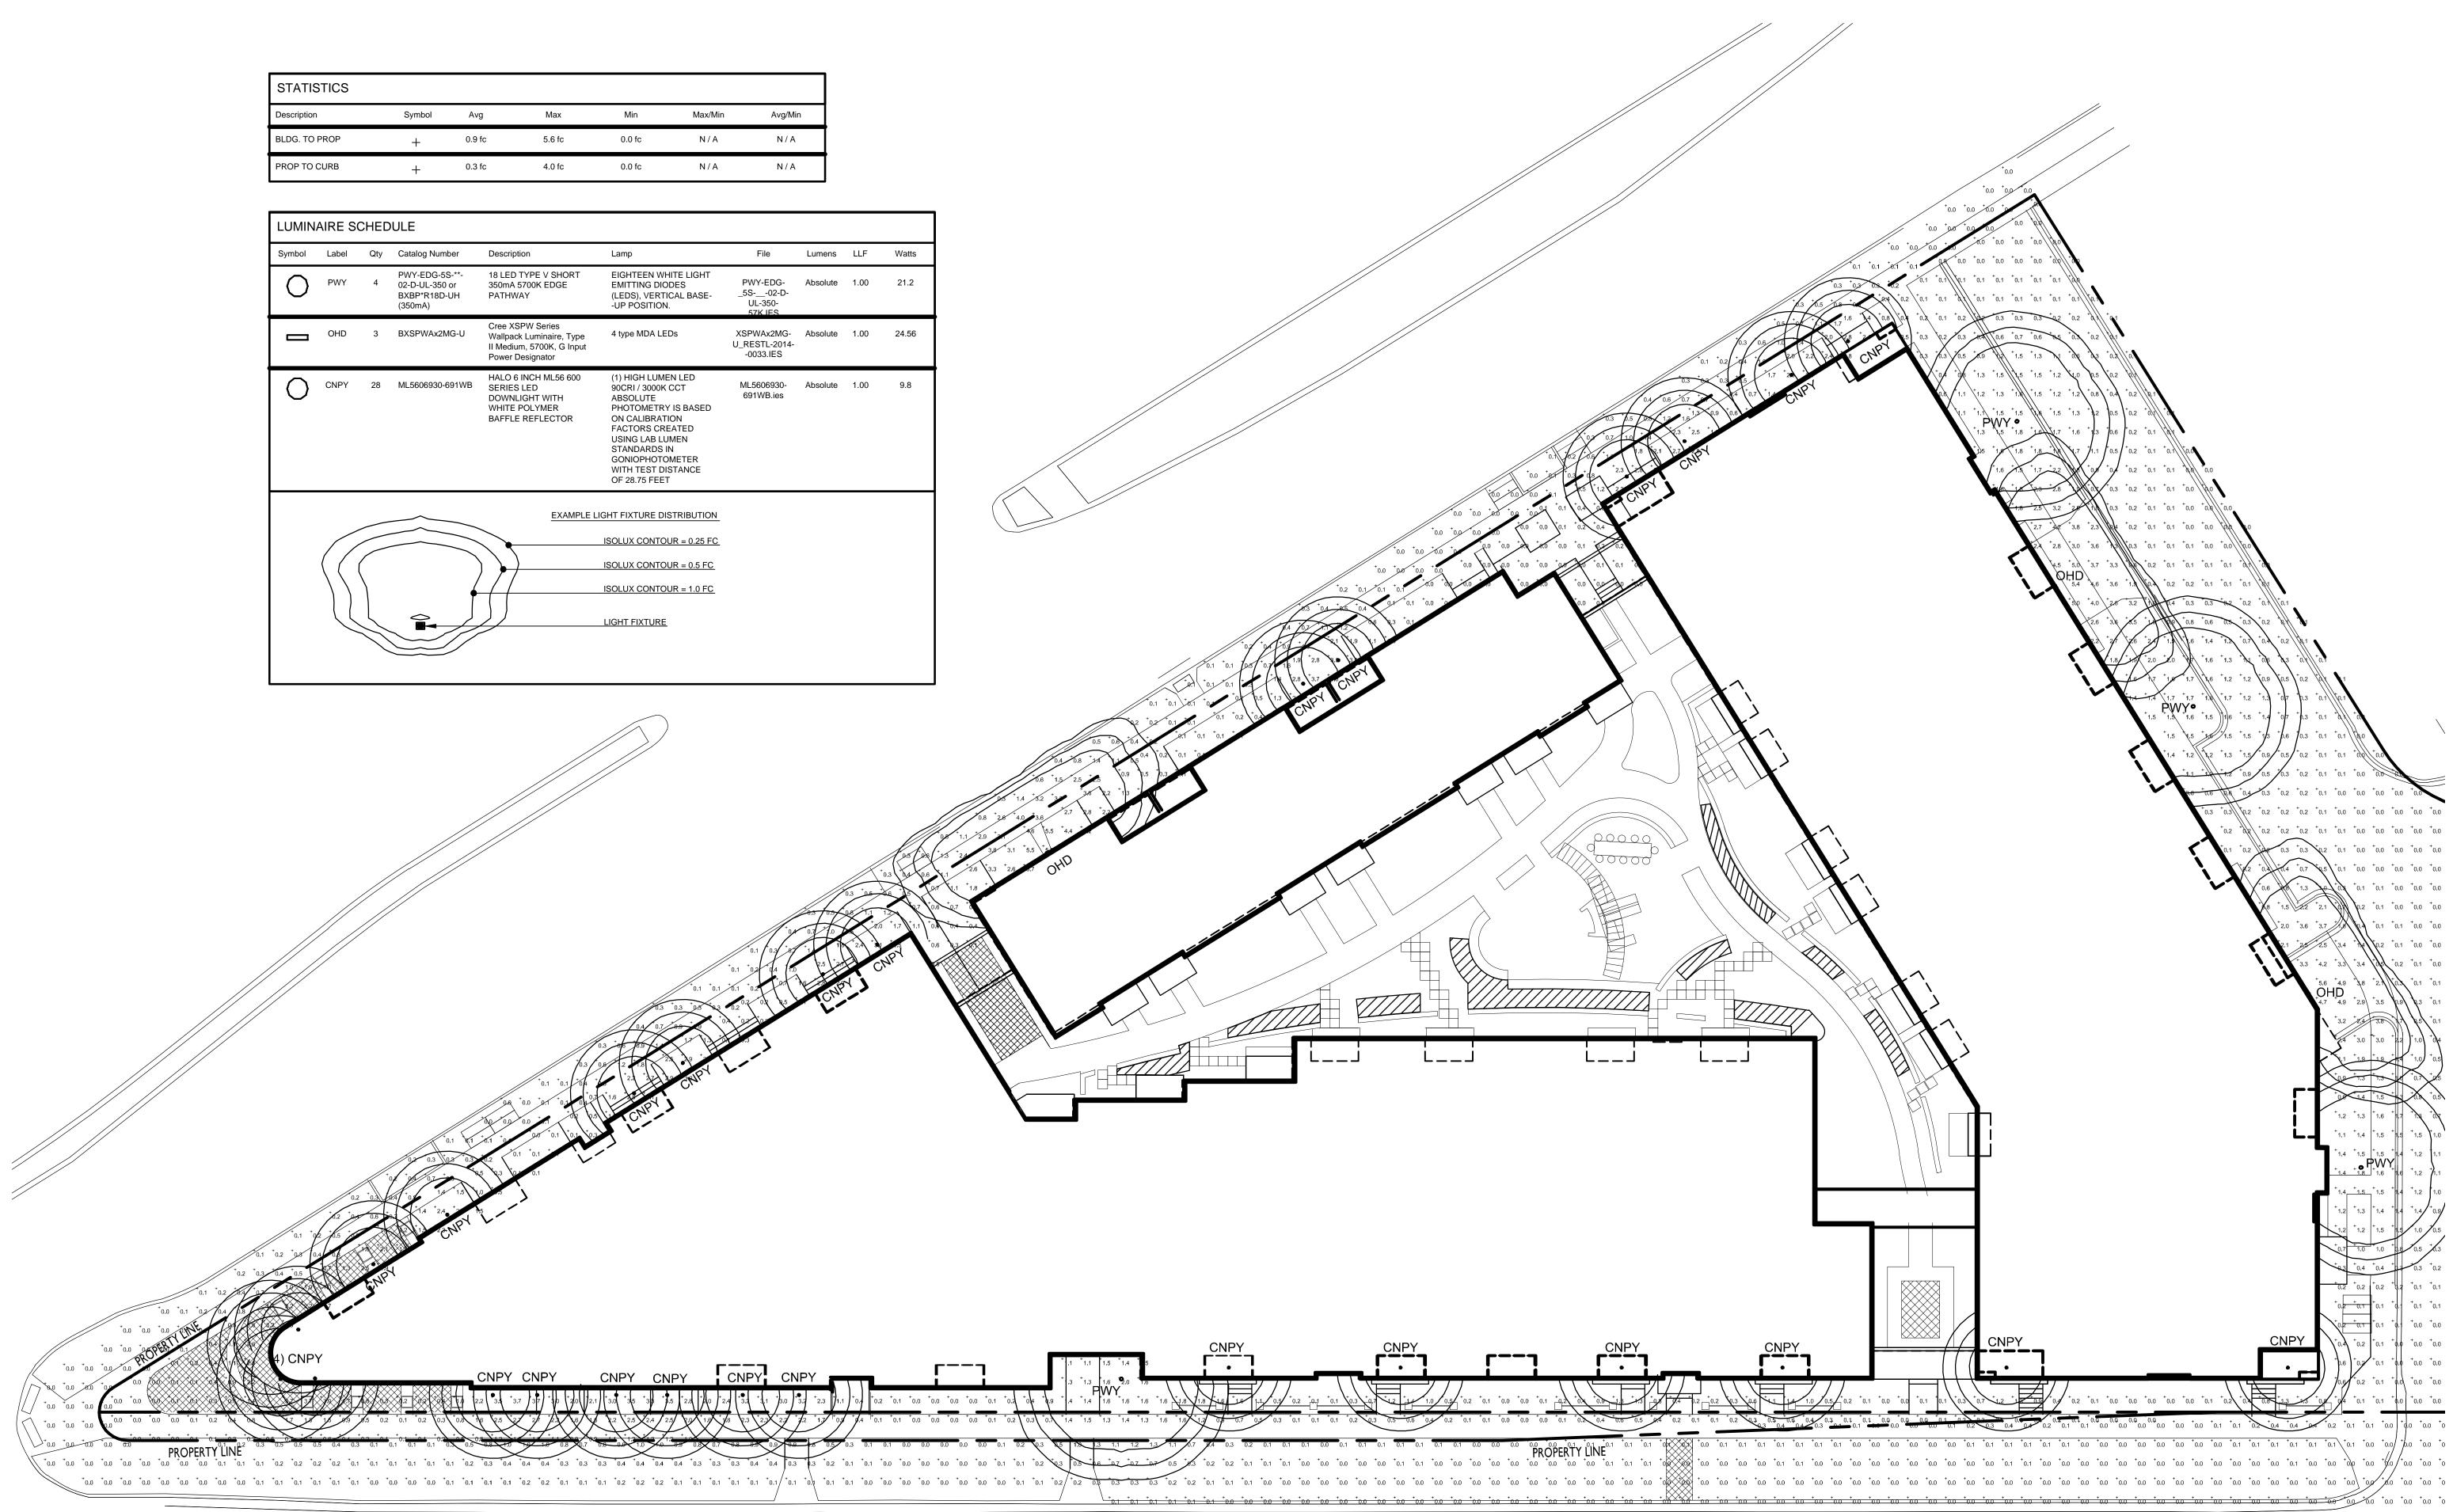Fish Hatchery Road & Park Street Madison, WI SHEET TITLE
Site Lighting Plan


C-1.2

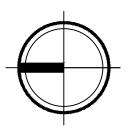

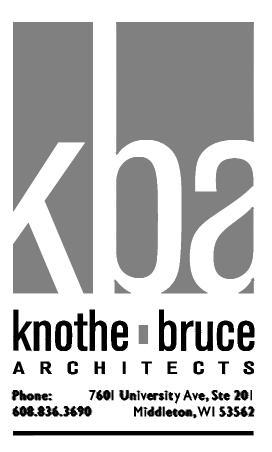





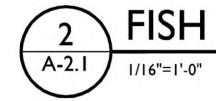

FISH HATCHERY ROAD ELEVATION



PARK STREET ELEVATION

Exterior Elevations Wingra Point II August 5, 2015














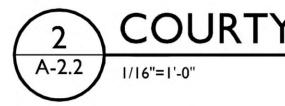





COURTYARD ELEVATION


Exterior Elevations Wingra Point II July 22, 2015





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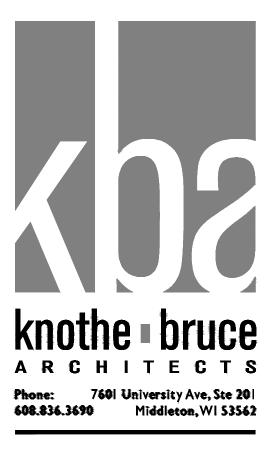


PARK STREET ELEVATION

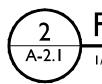1/16"=1'-0"

FISH HATCHERY ROAD ELEVATION

1/16"=1'-0"



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Issued for SIP March 13, 2015 Issued for UDC - April 1, 2015 Issued for UDC - May 6, 2015 Issued for UDC - May 13, 2015


PROJECT TITLE WINGRA POINT PHASE 2

Fish Hatchery Road & Park Street Madison, WI SHEET TITLE Exterior Elevations

A-2.1






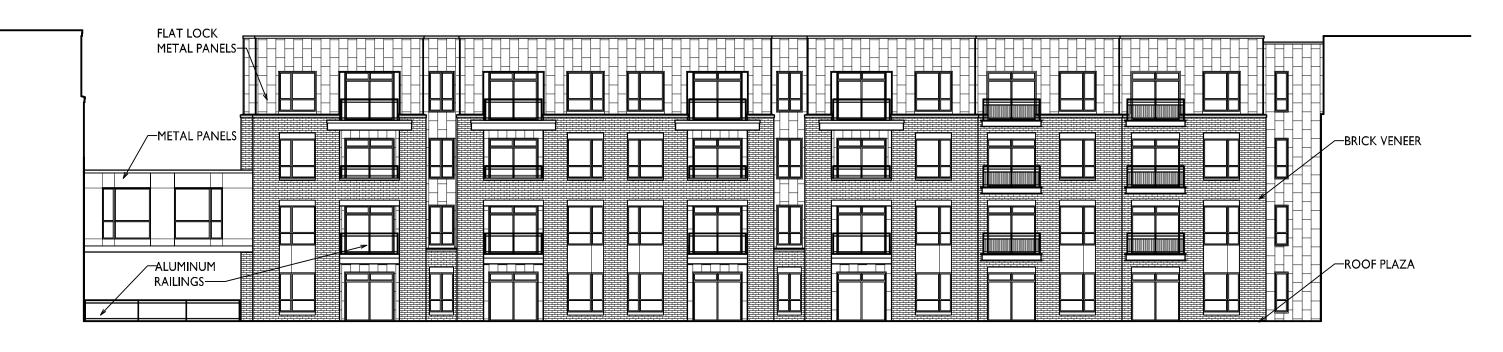

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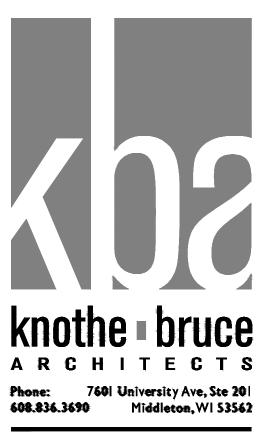




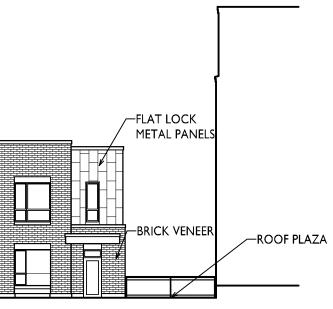







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PROJECT TITLE WINGRA POINT PHASE 2


Fish Hatchery Road & Park Street Madison, WI SHEET TITLE Exterior Elevations

SHEET NUMBER

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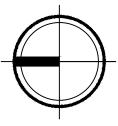
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BASEMENT FLOOR PLAN





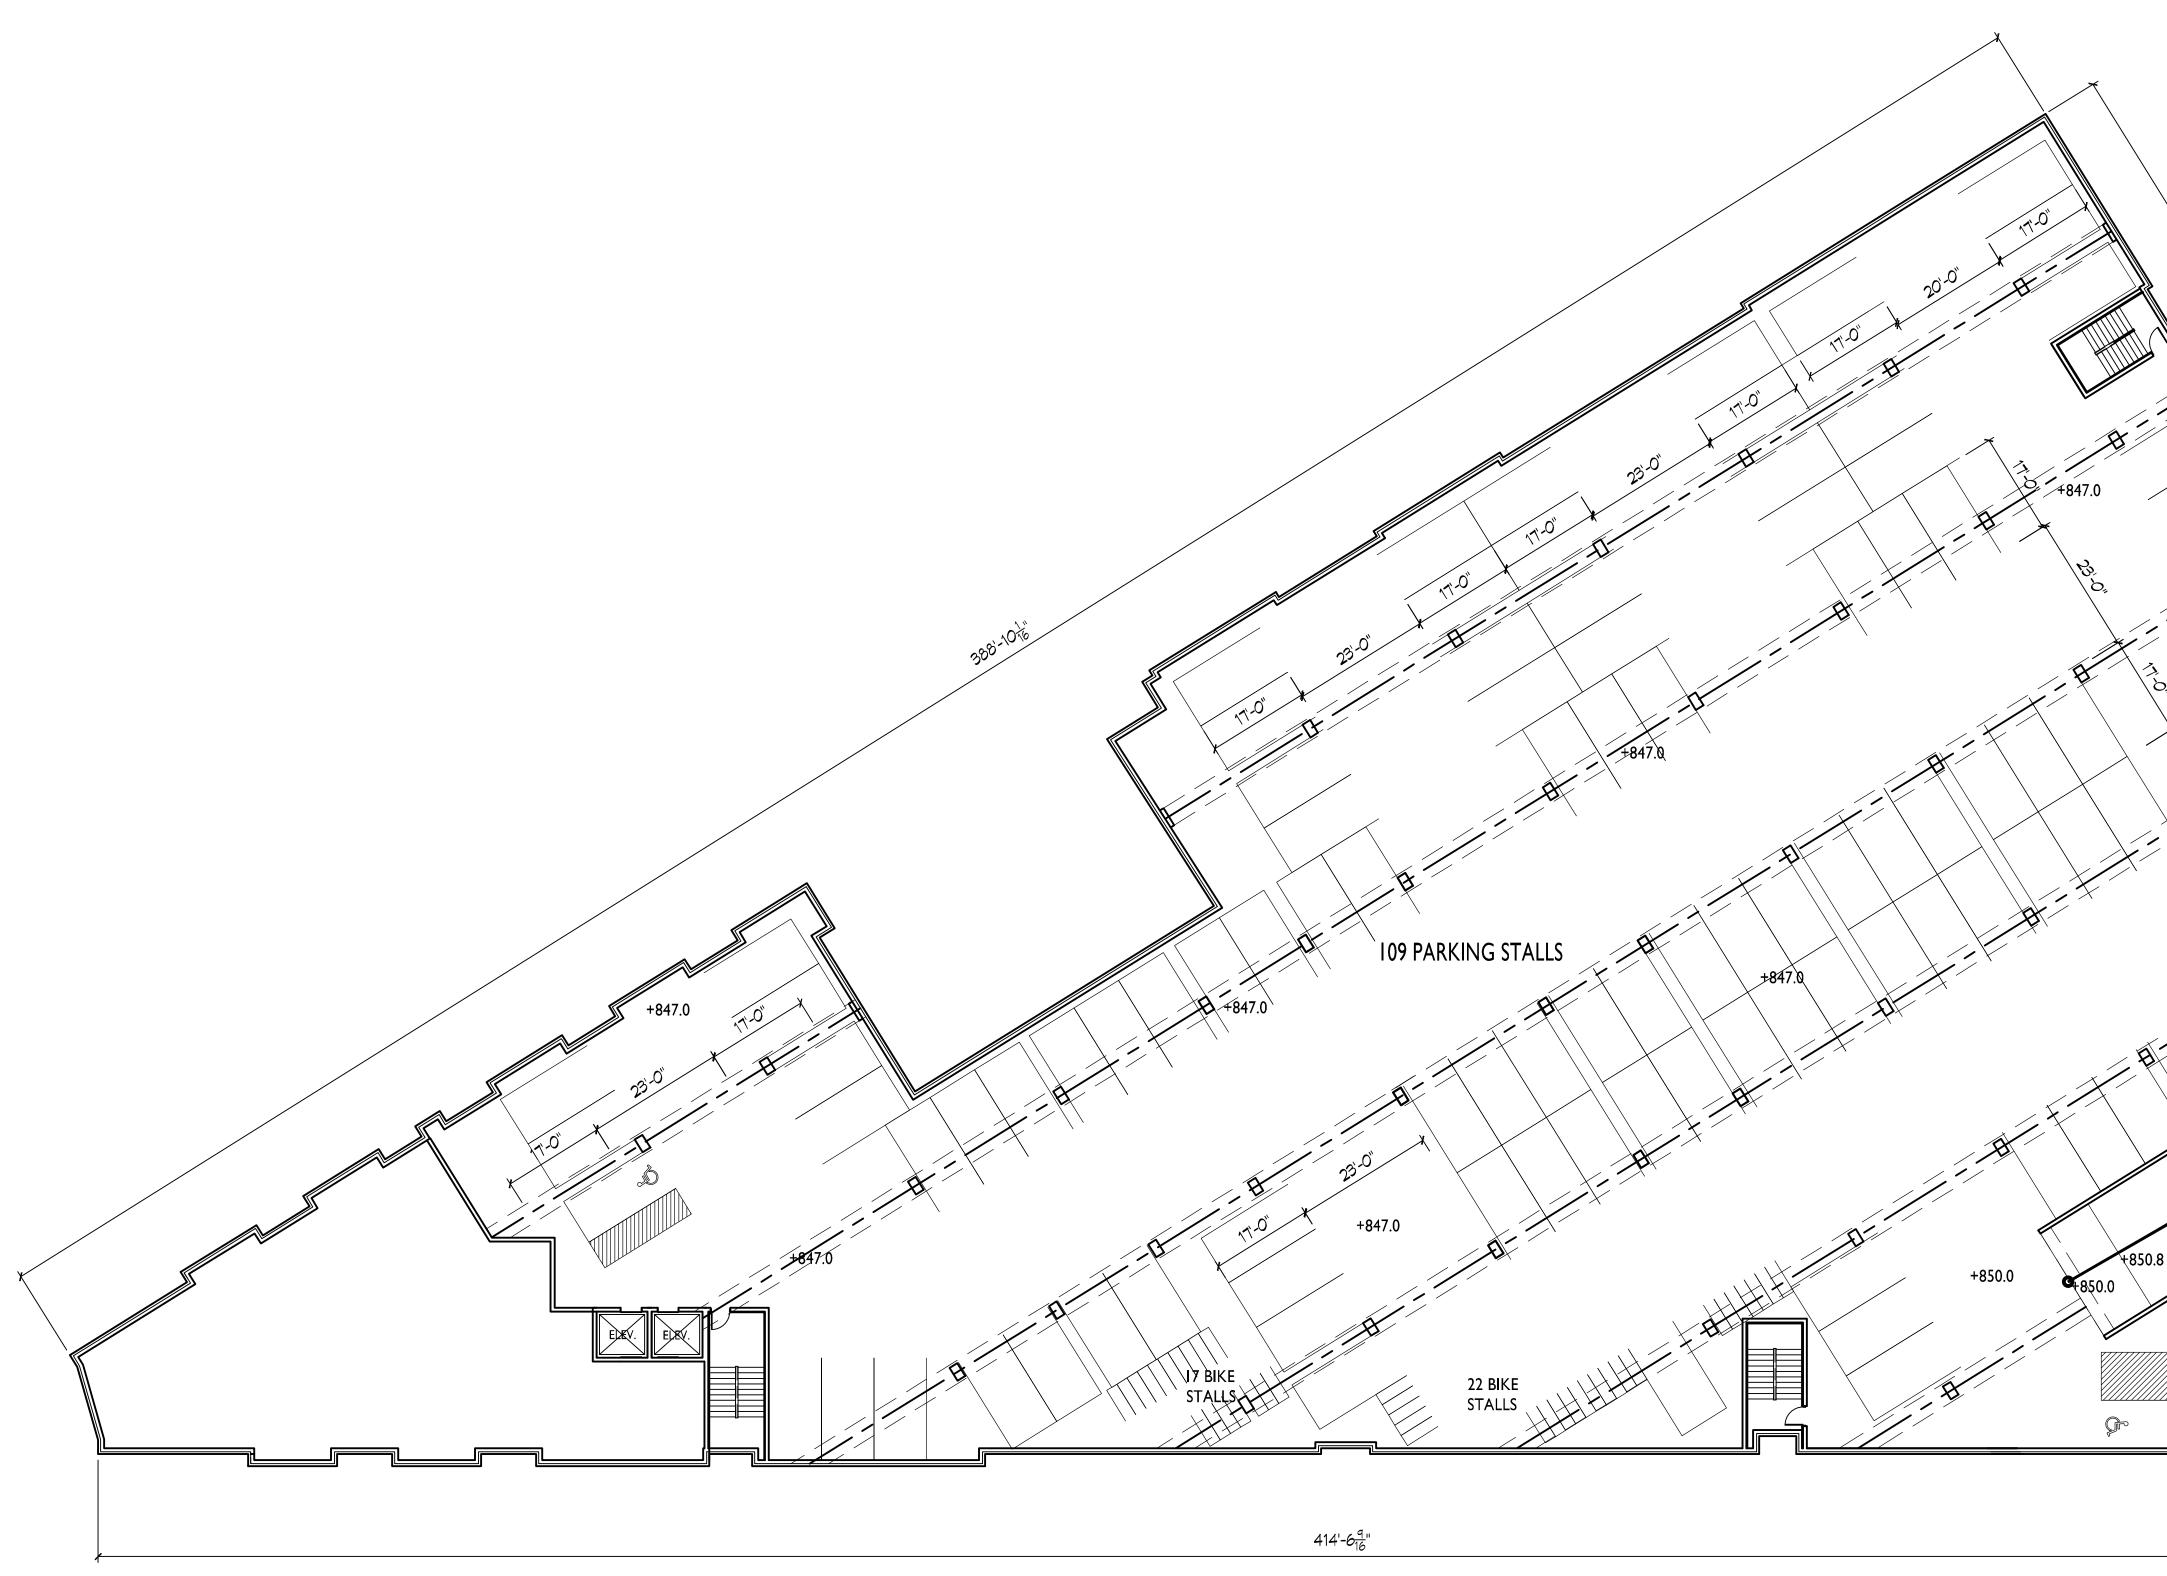

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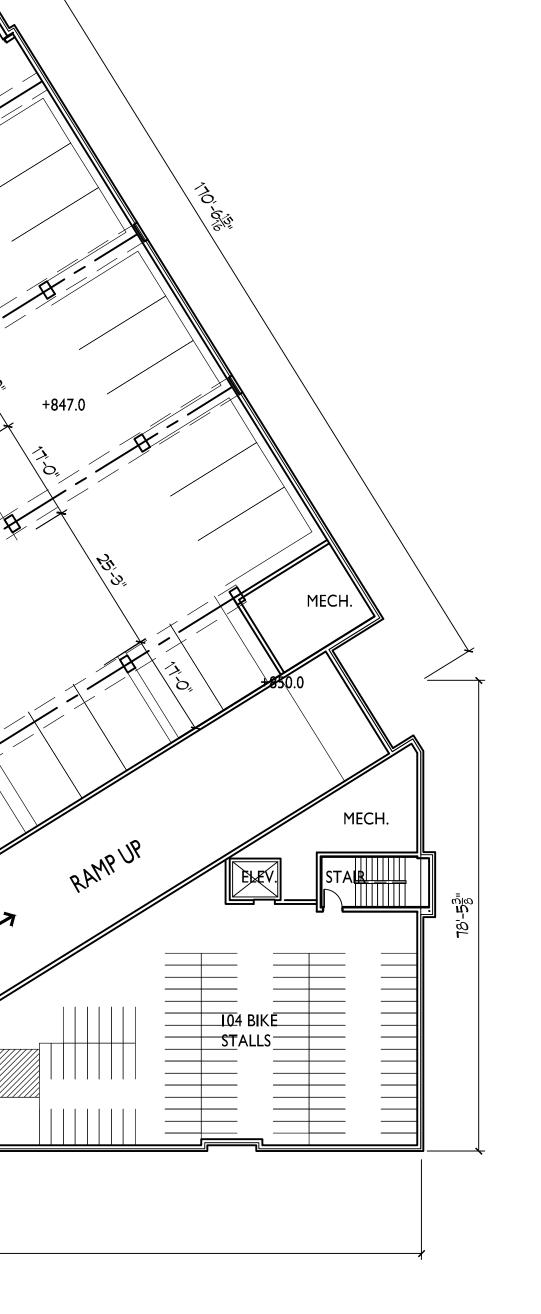
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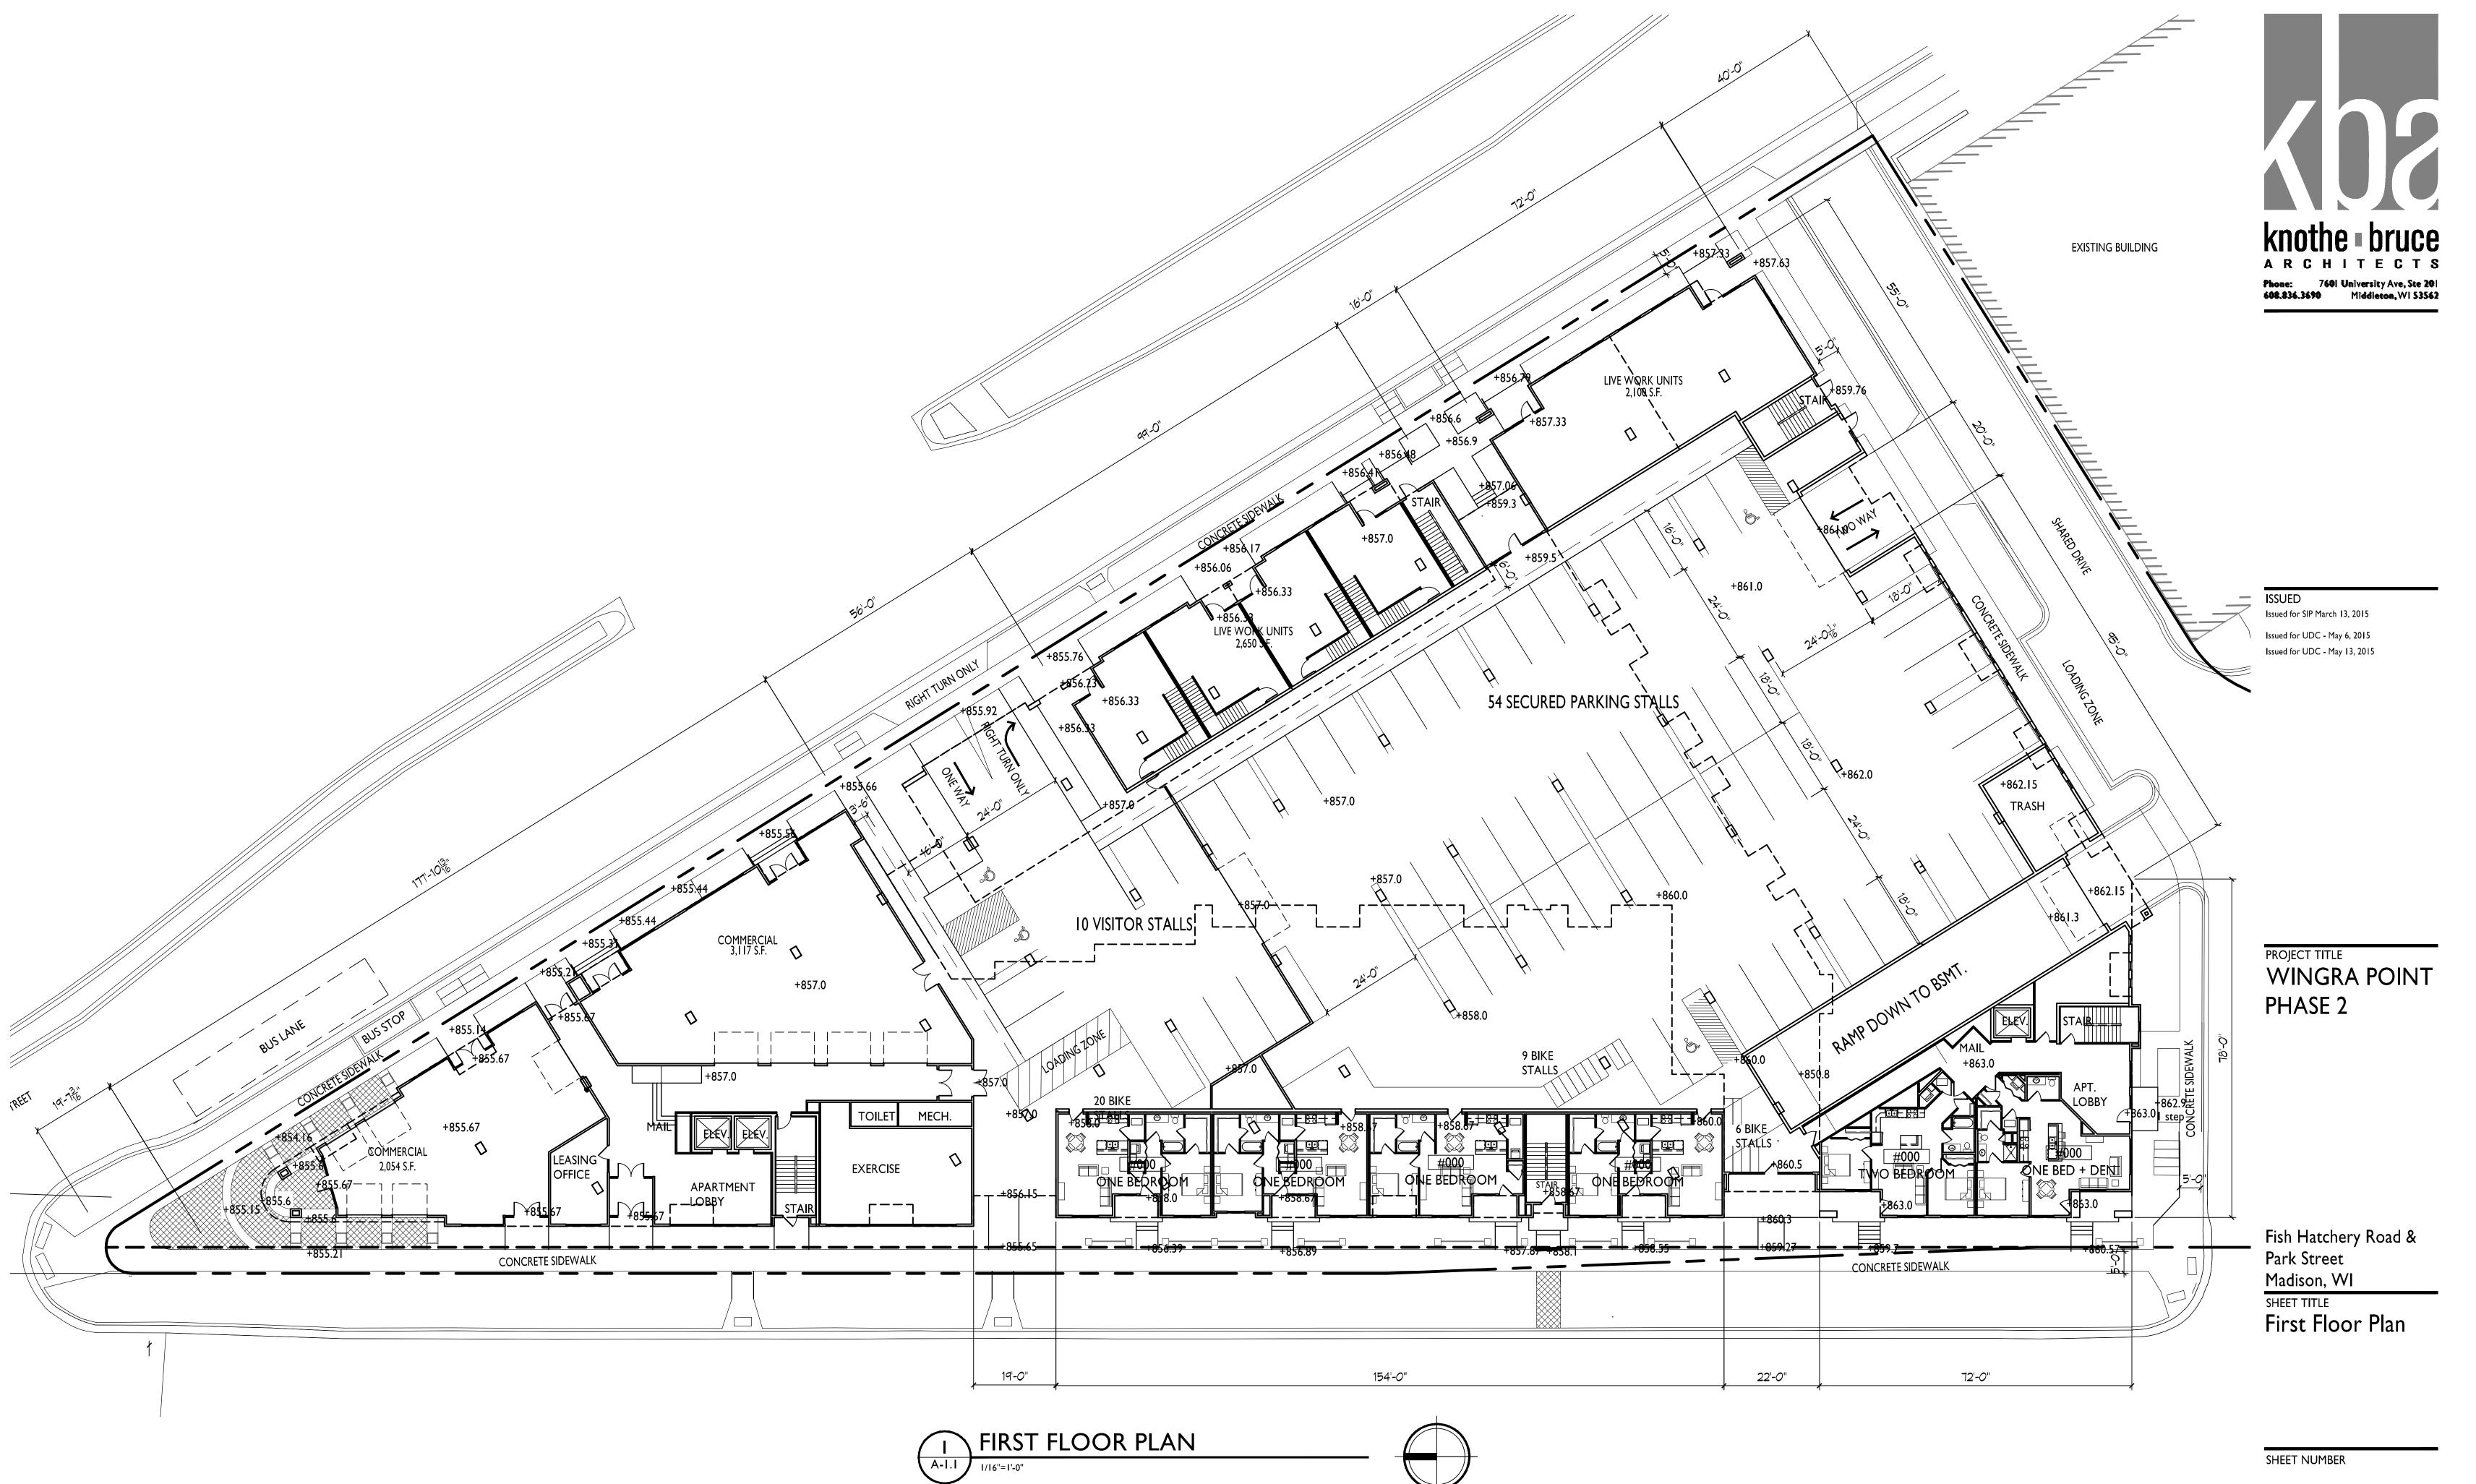
Fish Hatchery Road & Park Street Madison, WI SHEET TITLE Basement Floor Plan

SHEET NUMBER

A-1.0 PROJECT NO. 1433


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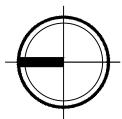



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SECOND FLOOR PLAN





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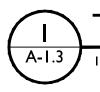
PROJECT TITLE WINGRA POINT PHASE 2

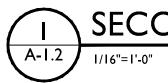Fish Hatchery Road & Park Street Madison, WI SHEET TITLE Second Floor Plan

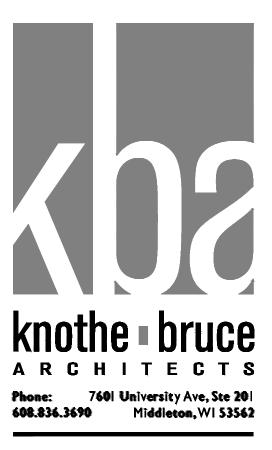
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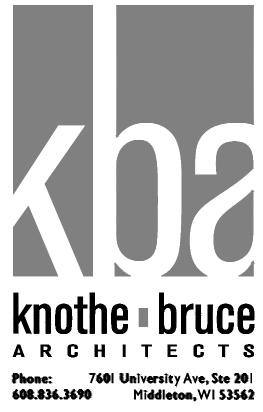
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I THIRD FLOOR PLAN





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PROJECT TITLE WINGRA POINT PHASE 2


Fish Hatchery Road & Park Street Madison, WI sheet title Third Floor Plan
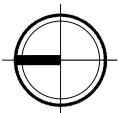
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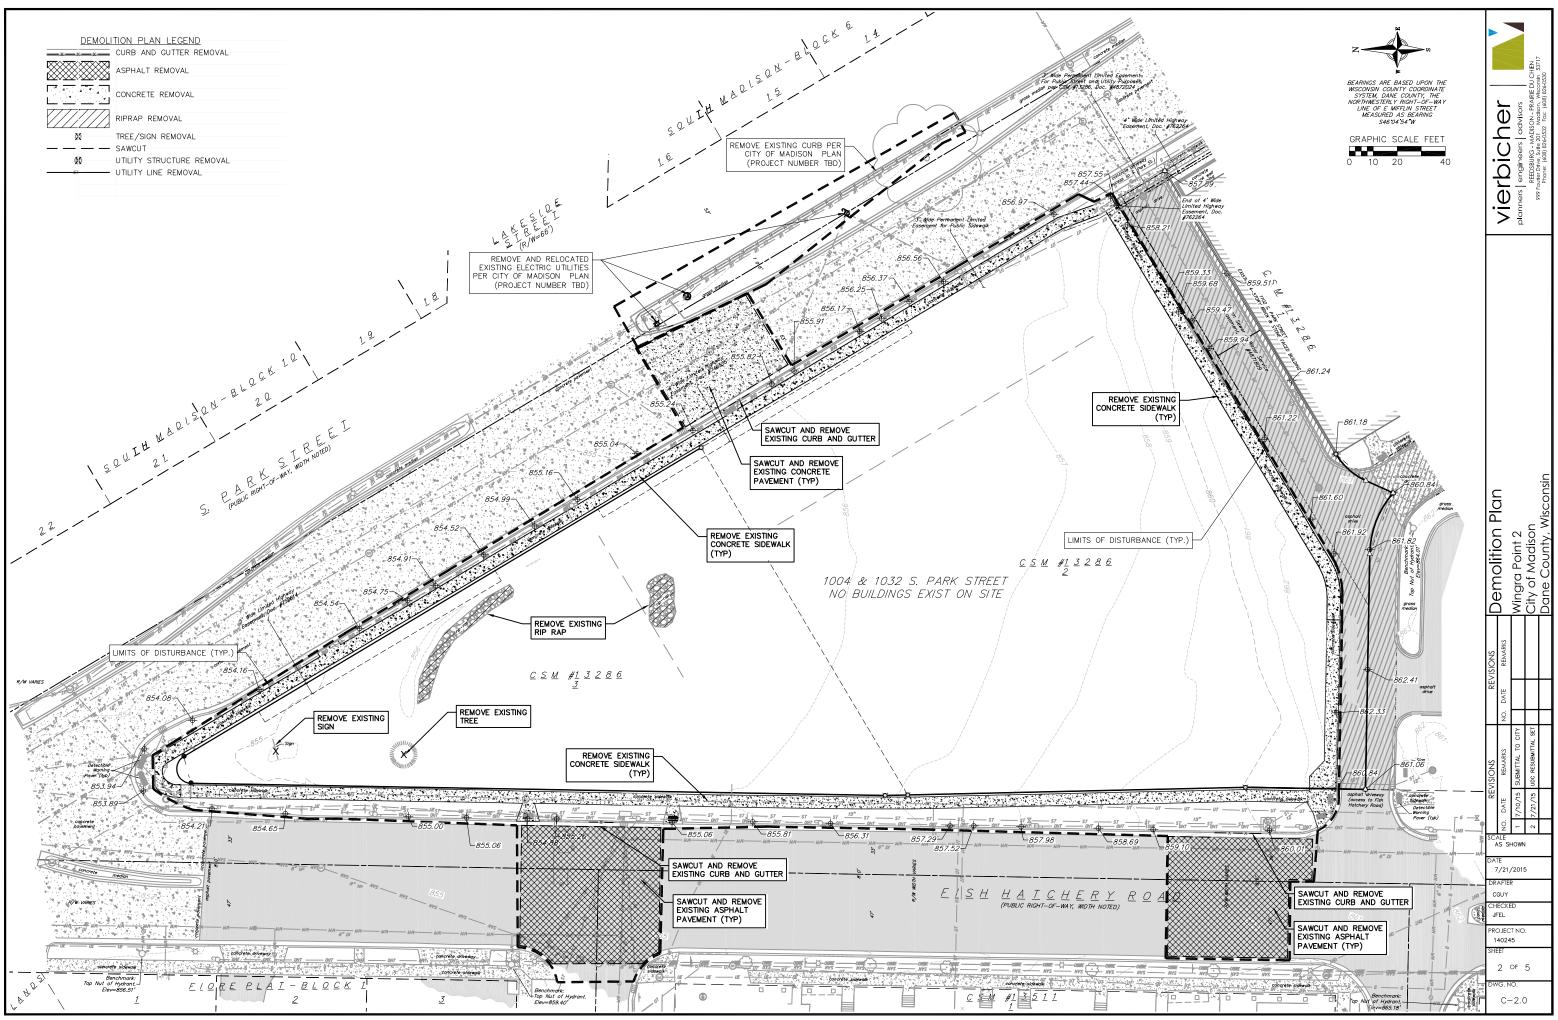
PROJECT TITLE WINGRA POINT PHASE 2


Fish Hatchery Road & Park Street Madison, WI SHEET TITLE Fourth - Fifth Floor Plan

SHEET NUMBER


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GENERAL NOTES:

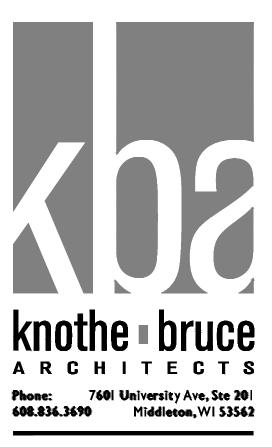- 1. THE LOCATION OF EXISTING UNDERGROUND UTILITIES AS SHOWN ON THE PLANS HAS BEEN DETERMINED FROM THE BEST AVAILABLE INFORMATION AND IS GIVEN FOR THE CONVENIENCE OF THE CONTRACTOR. THE OWNER AND THE ENGINEER DO NOT ASSUME RESPONSIBILITY IN THE EVENT THAT DURING CONSTRUCTION, UTILITIES OTHER THAN THOSE SHOWN MAY BE ENCOUNTERED, AND THAT THE ACTUAL LOCATION OF THOSE WHICH ARE SHOWN MAY BE DIFFERENT FROM THE LOCATION AS SHOWN ON THE PLANS.
- 2. CONTRACTOR SHALL KEEP ALL STREETS FREE AND CLEAR OF CONSTRUCTION RELATED DIRT/DUST/DEBRIS.
- 3. THESE DRAWINGS ASSUME THAT THE CONTRACTOR WILL UTILIZE AN ELECTRONIC DRAWING FILE AND STAKE ALL SITE IMPROVEMENTS USING COORDINATES TIED INTO CONTROL POINTS. THE DIMENSIONS INDICATED ON THE DRAWINGS ARE FOR THE CONVENIENCE OF THE CONTRACTOR ONLY.
- 4. PRIOR TO THE USE OF THESE DRAWINGS FOR CONSTRUCTION PURPOSES, THE USER SHALL VERIFY ALL DIMENSIONS AND LOCATIONS OF BUILDINGS WITH THE FOUNDATION DRAWINGS AND ARCHITECTURAL SITE PLAN. IF CONFLICTS EXIST THE USER OF THESE DRAWINGS SHALL CONTACT THE ENGINEER IMMEDIATELY.
- 5. CONTRACTOR SHALL NOTIFY THE OWNER, ENGINEER AND THE CITY OF MADISON A MINIMUM OF 48 HOURS IN ADVANCE OF PERFORMING ANY WORK
- 6. ALL WORK IN THE PUBLIC RIGHT-OF-WAY SHALL BE PERFORMED BY A CITY-LICENSED CONTRACTOR
- 7. PUBLIC RIGHT-OF-WAY IMPROVEMENTS TO BE CONSTRUCTED PER CITY OF MADISON PLANS (PROJECT NUMBER TBD).

SITE CONSTRUCTION NOTES:

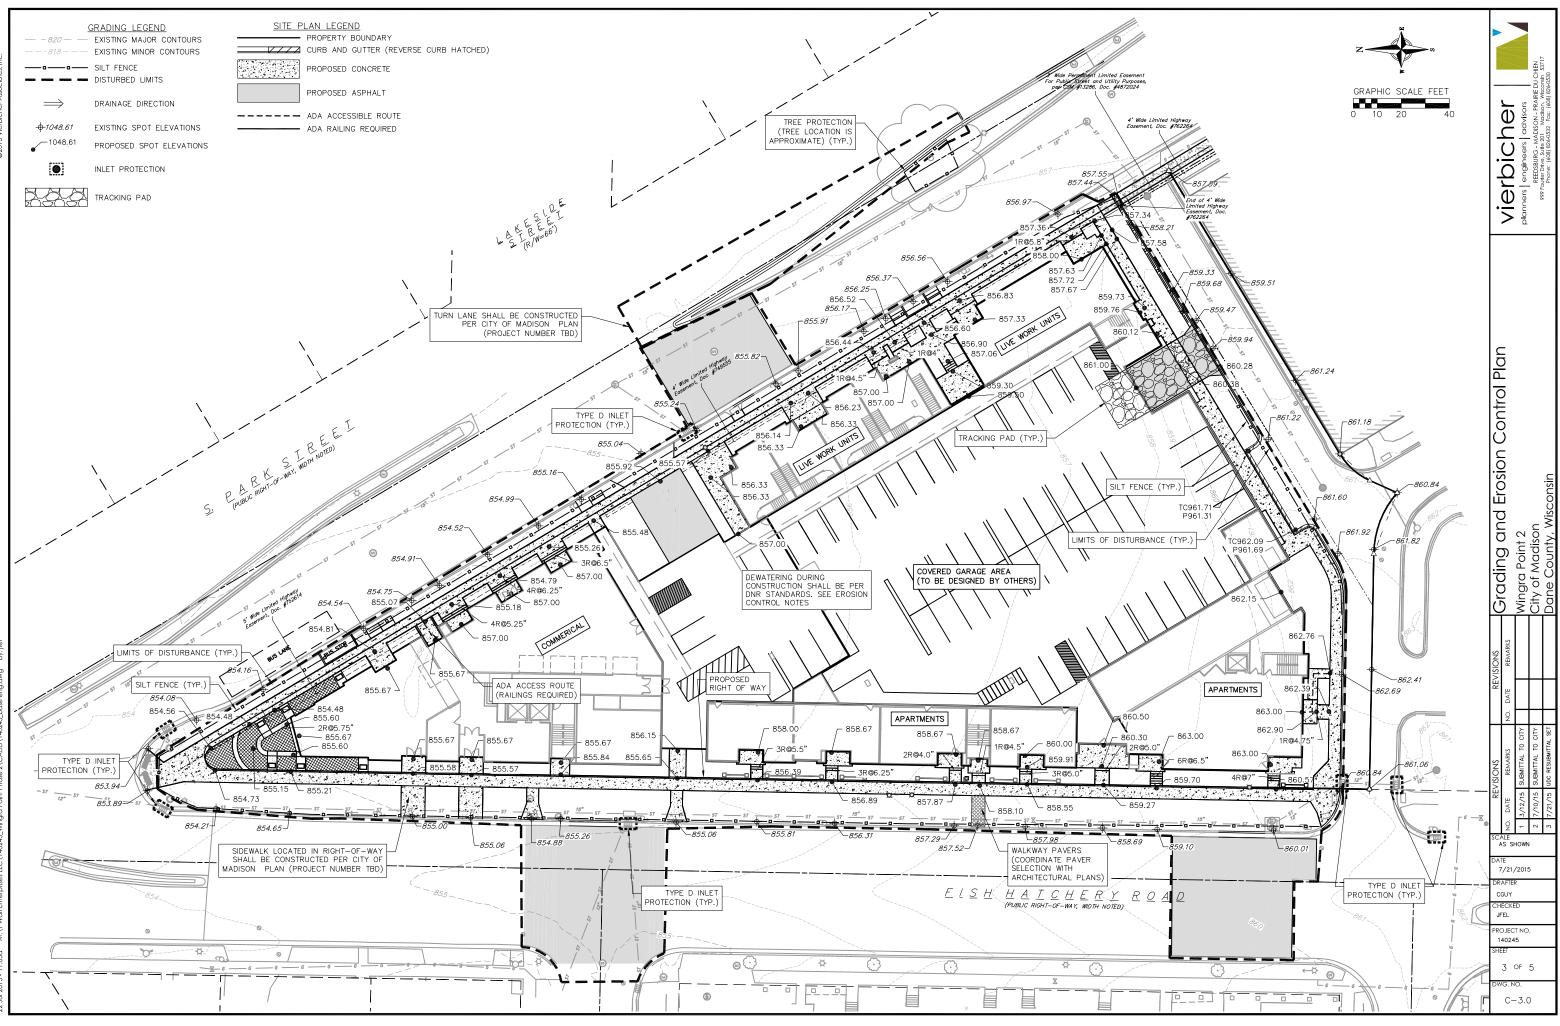- 1. CONCRETE SIDEWALK TO BE 5" THICK, CONSTRUCTED ON A BASE OF 4" COMPACTED SAND OR CRUSHED STONE.
- CONCRETE FOR DRIVEWAYS AND SIDEWALK AT DRIVEWAY ENTRANCES SHALL BE 7" THICK, CONSTRUCTED ON A BASE OF 5" COMPACTED SAND OR CRUSHED STONE.
- 3. CONTRACTOR TO OBTAIN ANY NECESSARY UTILITY CONNECTION, DEMOLITION, OR RIGHT-OF-WAY PERMITS.
- 4. CONTRACTOR SHALL OBTAIN ANY NECESSARY DRIVEWAY CONNECTION, WORK IN RIGHT-OF-WAY AND EXCAVATION PERMITS PRIOR TO CONSTRUCTION.
- 5. ANY SIDEWALK AND CURB & GUTTER ABUTTING THE PROPERTY SHALL BE REPLACED IF IT IS DAMAGED DURING CONSTRUCTION OR IF THE CITY ENGINEERING DEPARTMENT DETERMINES THAT IT IS NOT AT A DESIRABLE GRADE, REGARDLESS OF WHETHER THE CONSTRUCTION ENGINE DEPARTMENT OF DEPARTMENT CONDITION EXISTED PRIOR TO BEGINNING CONSTRUCTION.
- 6. PUBLIC RIGHT-OF-WAY IMPROVEMENTS TO BE CONSTRUCTED PER CITY OF MADISON PLANS (PROJECT NUMBER TBD).
- 7. ALL WORK IN THE PUBLIC RIGHT-OF-WAY SHALL BE PERFORMED BY A CITY-LICENSED CONTRACTOR

EROSION CONTROL MEASURE NOTES:

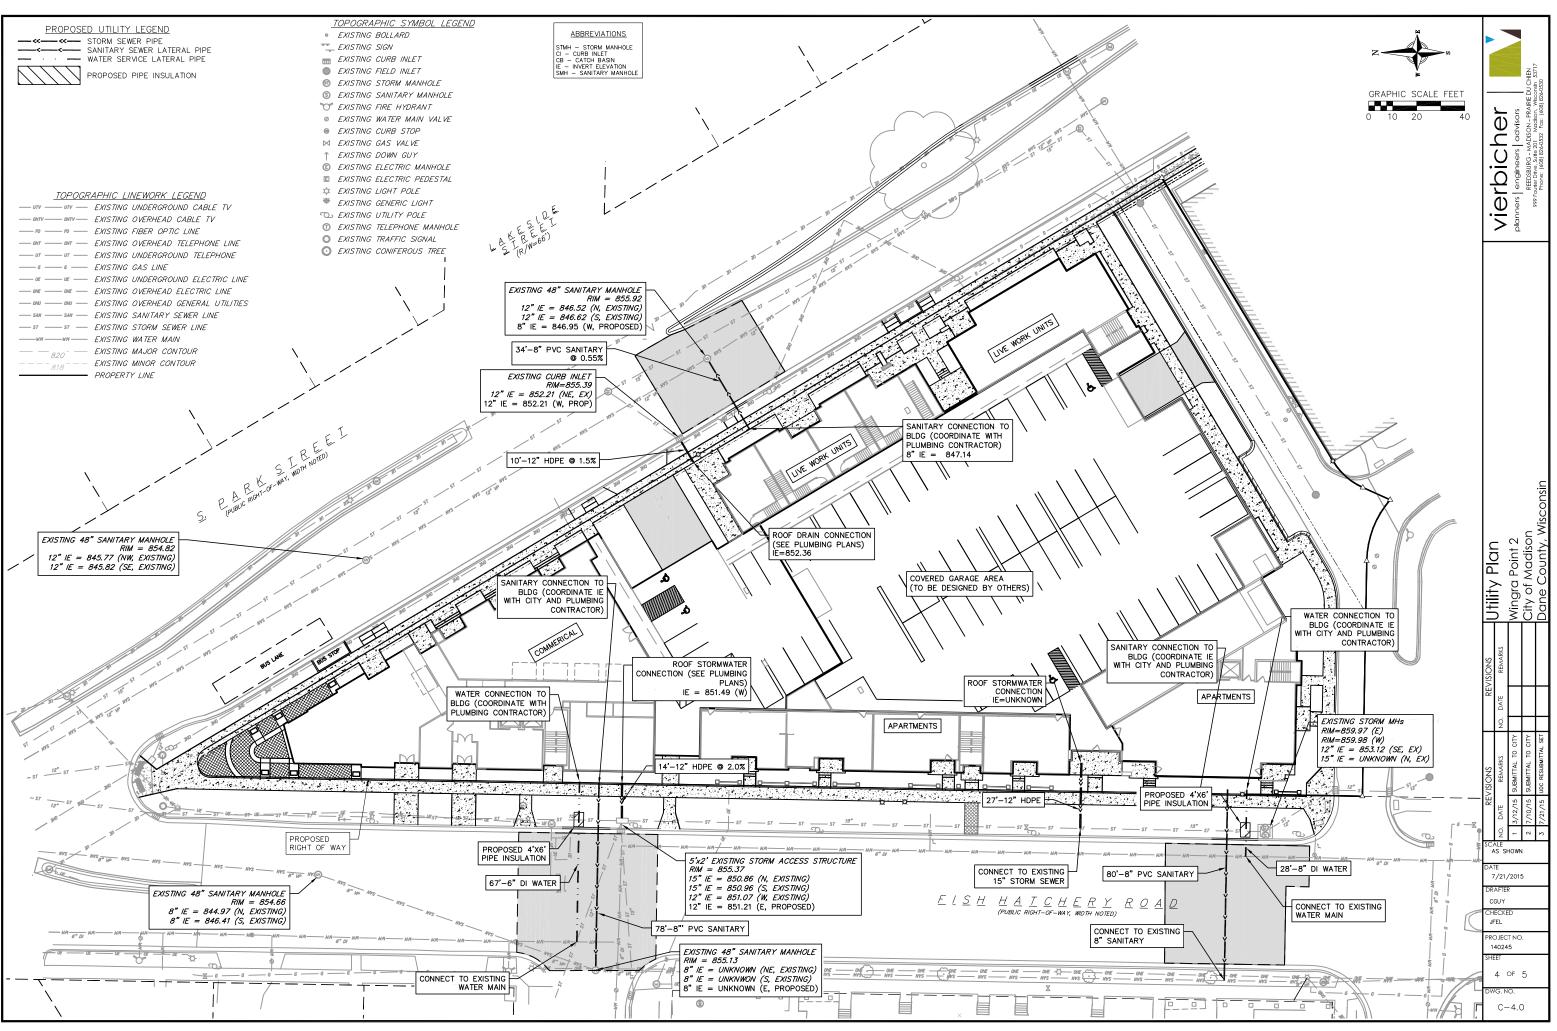- 1. EROSION CONTROL SHALL BE IN ACCORDANCE WITH THE CITY EROSION CONTROL ORDINANCE AND CHAPTER NR 216 OF THE WISCONSIN ADMINISTRATIVE CODE.
- 2. CONSTRUCT AND MAINTAIN ALL EROSION AND SEDIMENT CONTROL MEASURES IN ACCORDANCE WITH WISCONSIN DNR TECHNICAL STANDARDS (http://dnr.wi.gov/runoff/stormwater/techstds.htm) AND WISCONSIN CONSTRUCTION SITE BEST MANAGEMENT PRACTICE HANDBOOK.
- INSTALL SEDIMENT CONTROL PRACTICES (TRACKING PAD, PERIMETER SILT FENCE, ETC.) PRIOR TO INITIATING OTHER LAND DISTURBING CONSTRUCTION ACTIVITIES.
- 4. THE CONTRACTOR IS REQUIRED TO MAKE EROSION CONTROL INSPECTIONS AT THE END OF EACH WEEK AND WHEN 0.5 INCHES OF RAIN FALLS WITHIN 24 HOURS. INSPECTION REPORTS SHALL BE PREPARED AND FILED AS REQUIRED BY THE DNR AND/OR CITY. ALL MAINTENANCE WILL FOLLOW AN INSPECTION WITHIN 24 HOURS.
- 5. EROSION CONTROL IS THE RESPONSIBILITY OF THE CONTRACTOR UNTIL ACCEPTANCE OF THIS PROJECT. EROSION CONTROL MEASURES AS SHOWN SHALL BE THE MINIMUM PRECAUTIONS THAT WILL BE ALLOWED. ADDITIONAL EROSION CONTROL MEASURES, AS REQUESTED IN WRITING BY THE STATE OR LOCAL INSPECTORS, OR THE DEVELOPER'S ENGINEER, SHALL BE INSTALLED WITHIN 24 HOURS.
- 6. A 3" CLEAR STONE TRACKING PAD SHALL BE INSTALLED TO PREVENT SEDIMENT FROM BEING TRACKED ONTO THE ADJACENT PAVED PUBLIC ROADWAY. SEDIMENT TRACKING PAD SHALL CONFORM TO WISDNR TECHNICAL STANDARD 1057. SEDIMENT REACHING THE PUBLIC ROAD SHALL BE REMOVED BY STREET CLEANING (NOT HYDRAULIC FLUSHING) BEFORE THE END OF EACH WORK DAY.
- STABILIZED DISTURBED GROUND: ANY SOIL OR DIRT PILES WHICH WILL REMAIN IN EXISTENCE FOR MORE THAN 7-CONSECUTIVE DAYS, WHETHER TO BE WORKED DURING THAT PERIOD OR NOT, SHALL NOT BE LOCATED WITHIN 25-FEET OF ANY ROADWAY, PARKING LOT, PAVED AREA, OR DRAINAGE STRUCTURE OR CHANNEL (UNLESS INTENDED TO BE USED AS PART OF THE EROSION CONTROL MEASURES). TEMPORARY STABILIZATION AND CONTROL MEASURES (SEEDING, MULCHING, TARPING, EROSION MATTING, BARRIER FENCING, ETC.) ARE REQUIRED FOR THE PROTECTION OF DISTURBED AREAS AND SOIL PILES, WHICH WILL REMAIN UN-WORKED FOR A PERIOD OF MORE THAN 14-CONSECUTIVE CALENDAR DAYS. THESE MEASURES SHALL REMAIN IN PLACE UNTIL SITE HAS STABILIZED.
- 8. <u>SITE DE-WATERING</u>: WATER PUMPED FROM THE SITE SHALL BE TREATED BY TEMPORARY SEDIMENTATION BASINS OR OTHER APPROPRIATE CONTROL MERSURES. SEDIMENTATION BASINS SHALL HAVE A DEPTH OF AT LEAST 3 FEET, BE SURROUNDED BY SNOWFENCE OR EQUIVALENT BARRIER AND HAVE SUFFICIENT SURFACE AREA TO PROVIDE A SURFACE SETTLING RATE OF NO MORE THAN 750 GALLONS PER SQUARE FOOT PER DAY AT THE HIGHEST DEWATERING PUMPING RATE. WATER MAY NOT BE DISCHARGED IN A MANNER THAT CAUSES EROSION OF THE SITE, A NEIGHBORING SITE, OR THE BED OR BANKS OF THE PECLINANC WATER DO YWEPS MAY PE USED AS DIPECTED BY DNP TECHNICAL THE CAUSES ENCOUNT OF THE STIE, A NEUMBOUNING STUD. OF THE BED OF DATAS OF THE RECEIVING WATER. POLYMERS MAY BE USED AS DIRECTED BY DNR TECHNICAL STANDARD 1061 (DE-WATERING). PUMPING OF WATER FROM FOUNDATION AREA DURING CONSTRUCTION SHALL NOT EXCEED A RATE OF 70 GALLONS PER MINUTE. SUMP PUMP SHALL BE PLACED ON A CLEAR STONE BEDDING AND A CLOTH/MESH SOCK SHALL BE PLACED ON THE OUTLET END OF THE PIPE TO CONTROL SEDIMENT LOSS.
- WASHED STONE WEEPERS OR TEMPORARY EARTH BERMS SHALL BE BUILT AS NECESSARY BY CONTRACTOR TO TRAP SEDIMENT OR SLOW THE VELOCITY OF STORM WATER.
- 10. INLET FILTERS ARE TO BE PLACED IN STORMWATER INLET STRUCTURES AS SOON AS THEY ARE INSTALLED. ALL PROJECT AREA STORM INLETS NEED WISCONSIN D.O.T. TYPE D INLET PROTECTION. THE FILTERS SHALL BE MAINTAINED UNTIL THE CITY HAS ACCEPTED THE

BINDER COURSE OF ASPHALT.

- 11. RESTORATION (SEED, FERTILIZE AND MULCH) SHALL BE PER SPECIFICATIONS ON THIS SHEET UNLESS SPECIAL RESTORATION IS CALLED FOR ON THE LANDSCAPE PLAN.
- 12. ALL AREAS WHICH ARE NOT PAVED SHALL RECEIVE A MINIMUM OF 4" TOPSOIL PRIOR TO
- 13. SEED, FERTILIZER AND MULCH SHALL BE APPLIED WITHIN 7 DAYS AFTER FINAL GRADE HAS BEEN ESTABLISHED. IF DISTURBED AREAS WILL NOT BE RESTORED IMMEDIATELY AFTER ROUGH GRADING, TEMPORARY SEED SHALL BE PLACED
- 14. FOR THE FIRST SIX WEEKS AFTER RESTORATION (E.G. SEED & MULCH, EROSION MAT, SOD) OF A DISTURBED AREA, INCLUDE SUMMER WATERING PROVISIONS OF ALL NEWLY SEEDED AND MULCHED AREAS WHENEVER 7 DAYS ELAPSE WITHOUT A RAIN EVENT.
- 15. EROSION MAT (TYPE I CLASS A PER WISCONSIN D.O.T. P.A.L.) SHALL BE INSTALLED ON ALL SLOPES 3:1 OR GREATER BUT LESS THAN 1:1.
- 16. SOIL STABILIZERS SHALL BE APPLIED TO DISTURBED AREAS WITH SLOPES BETWEEN 10% AND 3:1 (DO NOT USE IN CHANNELS). SOIL STABILIZERS SHALL BE TYPE B, PER WISCONSIN D.O.T. P.A.L. (PRODUCT ACCEPTABILITY LIST), OR EQUAL. APPLY AT RATES AND METHODS SPECIFIED PER MANUFACTURER. SOIL STABILIZERS SHALL BE RE-APPLIED WHENEVER VEHICLES OR OTHER EQUIPMENT TRACK ON THE AREA.
- 17. SILT FENCE TO BE USED ACROSS AREAS OF THE LOT THAT SLOPE TOWARDS A PUBLIC STREET OR WATERWAY.
- 18. SEDIMENT SHALL BE CLEANED FROM CURB AND GUTTER AFTER EACH RAINFALL AND PRIOR TO PROJECT ACCEPTANCE
- 19. ALL CONSTRUCTION ENTRANCES SHALL HAVE TEMPORARY ROAD CLOSED SIGNS THAT WILL BE IN PLACE WHEN THE ENTRANCE IS NOT IN USE AND AT THE END OF EACH DAY.
- 20. ANY PROPOSED CHANGES TO THE EROSION CONTROL PLAN MUST BE SUBMITTED AND APPROVED BY THE CITY OF MADISON.
- 21. THE CITY OF MADISON, OWNER AND/OR ENGINEER MAY REQUIRE ADDITIONAL EROSION CONTROL MEASURES AT ANY TIME DURING CONSTRUCTION.
- 22. IF THE TERRACE IN THE R/W IS TO BE DISTURBED, CONTRACTOR SHALL CONSIDER PLACING STONE/MULCH TO MINIMIZE RUNOFF
- 23. PUBLIC RIGHT-OF-WAY IMPROVEMENTS TO BE CONSTRUCTED PER CITY OF MADISON PLANS (PROJECT NUMBER TBD).

CONSTRUCTION SEQUENCE:

- 1. INSTALL SILT FENCE AND TRACKING PAD.
- 2. INSTALL INLET PROTECTION ON EXISTING INLETS ADJACENT TO PROPERTY.
- 3. PERFORM SITE DEMOLITION AND REMOVE PAVEMENT (AS NECESSARY)
- STRIP SITE TOPSOIL AND STOCKPILE/REMOVE EXCESS.
- 5. ROUGH GRADE FOR FOR BUILDING PADS AND WALKS
- 6 CONSTRUCT UNDERGROUND UTILITIES
- 7. INSTALL INLET PROTECTION ON NEW INLETS.
- 8. CONSTRUCT WALKS, DRIVE, CURB AND GUTTER AND LOADING AREA.
- 9. FINAL GRADE SITE. INSTALL TOPSOIL, SEED, FERTILIZER AND MULCH.
- 10. REMOVE SILT FENCE AFTER DISTURBED AREAS ARE RESTORED

SEEDING RATES:

TEMPORARY:

1. USE ANNUAL OATS AT 3.0 LB /1.000 S.E. FOR SPRING AND SUMMER PLANTINGS USE WINTER WHEAT OR RYE AT 3.0 LB./1,000 SF FOR FALL PLANTINGS STARTED AFTER SEPTEMBER 15.

PERMANENT:

1. USE WISCONSIN D.O.T. SEED MIX #40 AT 2 LB./1,000 S.F.

FERTILIZING RATES

TEMPORARY AND PERMANENT: USE WISCONSIN D.O.T. TYPE A OR B AT 7 LB./1,000 S.F.

MULCHING RATES:

TEMPORARY AND PERMANENT:

USE $\frac{1}{2}$ TO 1- $\frac{1}{2}$ " STRAW OR HAY MULCH, CRIMPED PER SECTION 607.3.2.3, OR OTHER RATE AND METHOD PER SECTION 627, WISCONSIN D.O.T. STANDARD SPECIFICATIONS FOR HIGHWAY AND STRUCTURE CONSTRUCTION

UTILITY NOTES:

- PRIVATE WATER MAIN AND SERVICES SHALL BE DUCTILE IRON (AWWA C-151, CLASS 52) OR APPROVED EQUAL MATERIAL THAT CONFORMS TO COMM 84.30(4)(d).
- 2. PRIVATE SANITARY SEWER AND LATERALS SHALL BE POLYVINYL CHLORIDE (PVC) ASTM D3034 - SDR 35 OR APPROVED EQUAL MATERIAL THAT CONFORMS TO COMM 84.30(2)(c).
- 3. A MEANS TO LOCATE BURIED UNDERGROUND EXTERIOR NON METALLIC SEWERS/MAINS AND WATER SERVICES/MAINS MUST BE PROVIDED WITH TRACER WIRE OR OTHER METHODS IN ORDER TO BE LOCATED PER COMM 82.10(11)(h) AND COMM 82.40(8)(k).
- 4. EXTERIOR WATER SUPPLY PIPING SETBACKS AND CROSSINGS SHALL BE IN ACCORDANCE WITH COMM 82.40(8)(b.).
- 5. NO PERSON MAY ENGAGE IN WORK AT PLUMBING IN THE STATE UNLESS LICENSED TO DO SO BY THE DEPARTMENT OF COMMERCE PER S.145.06.
- 6. SITE CONTRACTOR SHALL LEAVE SANITARY AND WATER LATERALS FIVE (5) FEET SHORT (HORIZONTALLY) FROM THE BUILDING. BUILDING PLUMBER SHALL VERIFY SIZE AND EXACT LOCATION OF PROPOSED SANITARY AND WATER LATERALS.
- 7. CONTRACTOR SHALL FIELD VERIFY THE SIZE, TYPE, LOCATION, AND ELEVATION OF EXISTING UTILITIES PRIOR TO INSTALLING ANY ON-SITE UTILITIES OR STRUCTURES. CONTACT

- ENGINEER PRIOR TO INSTALLATION IF DISCREPANCY EXISTS WITHIN THESE PLANS.
- 8. PROPOSED UTILITY SERVICE LINES AS SHOWN ARE APPROXIMATE. COORDINATE THE EXACT LOCATIONS WITH THE PLUMBING DRAWINGS. COORDINATE THE LOCATIONS WITH THE PLUMBING CONTRACTOR AND/OR OWNER'S CONSTRUCTION REPRESENTATIVE PRIOR TO INSTALLATION OF ANY NEW UTILITIES.
- 9. CONTRACTOR SHALL BE RESPONSIBLE FOR COORDINATING THE RELOCATION OF ANY UTILITES ENCOUNTERED AND REPLACEMENT OF ANY UTILITIES DAMAGED WITHIN INFLUENCE ZONE OF NEW CONSTRUCTION. CONTACT ENGINEER IF THE EXISTING UTILITIES VARY APPRECIABLY FROM THE PLANS.
- 10. ALL WATER MAIN AND SERVICES SHALL BE INSTALLED AT A MINIMUM DEPTH OF 6.5' FROM TOP OF FINISHED GROUND ELEVATION TO TOP OF MAIN.
- CLEAN OUT ALL EXISTING AND PROPOSED STORM INLETS AND CATCH BASINS AT THE COMPLETION OF CONSTRUCTION.
- CONTRACTOR SHALL OBTAIN ANY NECESSARY WORK IN RIGHT-OF WAY, EXCAVATION, UTILITY CONNECTION, PLUGGING, ABANDONMENT, AND DRIVEWAY CONNECTION PERMITS PRIOR TO CONSTRUCTION.
- 13. THE DEVELOPER SHALL INSTALL THE 3M™ ELECTRONIC MARKER SYSTEM (EMS) 4 EXTENDED RANGE 5' BALL MARKERS-WASTEWATER (MODEL #1404-XR) FOR EACH SANITARY AND STORM SEWER LATERALS. THE CITY SHALL SUPPLY ALL THE REQUIRED MARKERS TO THE DEVELOPER OR ITS CONTRACTOR (GENERALLY REQUIRES 2 PER LATERAL) AND THE CONTRACTOR SHALL INSTALL THEM PER THE MANUFACTURER'S REQUIREMENTS OR AS DIRECTED BY THE CITY ENGINEER.
- 14. ALL WORK IN THE PUBLIC RIGHT-OF-WAY SHALL BE PERFORMED BY A CITY-LICENSED
- 15. PUBLIC RIGHT-OF-WAY IMPROVEMENTS TO BE CONSTRUCTED PER CITY OF MADISON PLANS (PROJECT NUMBER TBD).
- 16. ALL DAMAGE TO THE PAVEMENT ON SOUTH PARK STREET AND FISH HATCHERY ROAD ADJACENT TO THIS DEVELOPMENT SHALL BE RESTORED IN ACCORDANCE WITH THE CITY'S PAVEMENT PATCHING CRITERIA.
- 17. CONTRACTOR SHALL REPLACE ALL SIDEWALK AND CURB AND GUTTER ABUTTING THE PROPERTY, WHICH IS DAMAGED BY THE CONSTRUCTION, OR ANY SIDEWALK AND CURB AND GUTTER THAT THE CITY ENGINEER DETERMINES NEEDS TO BE REPLACED BECAUSE IT IS NOT AT A DESIRABLE GRADE REGARDLESS OF WHETHER THE CONDITION EXISTED PRIOR TO
- UTILITY CONTRACTOR SHALL OBTAIN A CONNECTION PERMIT AND EXCAVATION PERMIT PRIOR TO COMMENCING STORM SEWER CONSTRUCTION.

		planners engineers advisors		777 FUDITE LINE, JULE 201 MULLION, WECKIN 30717 Phone: (408) 826-0532 Fax: (408) 826-0530
Notes & Construction Details		Wingra Point 2	City of Madison	Dane County, Wisconsin
REVISIONS	NO. DATE REMARKS			
REVISIONS	NO. DATE REMARKS	1 3/12/15 SUBMITTAL TO CITY	2 7/10/15 SUBMITTAL TO CITY	3 7/21/15 UDC RESUBMITTAL SET
DA1 7 DR, CH JF PRC 1. SHE	AFTEF GUY ECKE EL DJEC 4024 ET 5 G. N	D T NO	5	

		Plant Material	erial List Ground Floor Only			
roadleaf Deo	ciduous					
Quantity	Code Name	Common Name	Scientific Name			
8	ABS	Autumn Brill Serviceberry	Amelanchier X Grand 'autumn Brill'			
5	CCP	Chanticleer Callery Pear	Pyrus Calleryana 'chanticleer'			
2	RPO	Regal Prince English Oak	Quercus Robur 'long'			
Conifer Everg	reen					
Quantity	Code Name	Common Name	Scientific Name			
I	MBJ	Mountbatten Juniper	Juniperus Chinen 'mountbatten'			
6	MGSJ	Moon glow Spiral Juniper	Juniperus scopulorum 'moonglow'			
15	TY	Taunton Yew	Taxus X Media 'tauntonii'			
6	EA	Emerald Arborvitae	Thuja Occidentalis 'smaragd'			
erennial						
Quantity	Code Name	Common Name	Scientific Name			
67	SBA	Summer Beauty Allium	Allium 'summer Beauty'			
49	KFG	Karl Foerster's Feather Reed Grass	Calamagrostis Acutiflora 'karl Foerster'			
18	PMG	Purple Maiden Grass	Miscanthus Sinensis Var Purpurescens			
42	LTC	Little Titch Catmint	Nepeta Racemosa 'little Titch'			
43	SSG	Shenandoah Switch Grass	Panicum Virgatum 'shenandoah'			
43	PRD	Prairie Dropseed	Sporobolus Heterolepis			
hrub						
Quantity	Code Name	Common Name	Scientific Name			
2	GBC	Glossy Black Chokeberry	Aronia Melanocarpa Var Elata			
22	CSSB	Cool Splash Southern Bush-Hone	Diervilla Sessilifolia 'Ipdc Podaras'			
17	DKOR	Double Knock Out Rose	Rosa 'radtko'			
6	NBV	Northern Burgundy Arwd Viburnu	Viburnum Dentatum 'morton'			

GENERAL NOTES

A) Areas labeled "Red B Colored Wood Mulch" to receive a mixture of recycled wood mulch, colored brown, spread to a 3" depth over pre-emergent herbicide. B) Individual trees (and shrub groupings) found along perimeter of property as well as those

found within lawn areas to receive wood mulch rings (and wood mulch beds) consisting of a mixture of recycled wood mulch, colored brown, spread to a minimum 3" depth (3' wide beds for shrub groupings).

C) "Spaded Edge" to be Hand Trenched to depth of 4".

D) Areas labeled "washed stone" to receive 1-1/2" washed stone spread to a 3" depth over fabric weed barrier.

E) "Seed" areas shall be finish-graded and seeded at a rate of 4 lbs. per 1,000 sq. ft.

F) Seed shall consist of the following mixture: 10% Palmer IV Perennial Ryegrass 20% Dragon Kentucky Bluegrass 20% Diva Kentucky Bluegrass 20% Foxy II Creeping Red Fescue 15% Vail II Perennial Ryegrass 15% Ginney Kentucky Bluegrass

G) Areas labeled "Seed/Mat" shall be seeded with the above-noted premium lawn seed mixture and overlaid with Class I Urban Type A organic straw erosion control netting that is then pegged into the soil with biodegradable staples.

H) Areas labeled "Sod" shall receive only No. I grade nursery-grown bluegrass sod.

I) Plant beds adjacent to building foundation to be mulched with brown colored wood mulch spread to a 3" depth with pre-emergent herbicide.

J) Existing street trees shall be protected. Contractor shall install tree protection fencing in the area between the curb and sidewalk and extend it at least 5 feet from both sides of the tree along the length of the terrace. No excavation is permitted within 5 feet of the outside edge of the tree trunk. If Excavation within 5 feet of any tree is necessary, contractor shall contact City Forestry (608)266-4816 prior to excavation to assess the impact to the tree and root system. Tree pruning shall be coordinated with City Forestry. Tree protection specifications can be found in section 107.13 of City of Madison Standard specifications for Public Works Constructionhttp://www.cityofmadison.com/business/pw/documents/StdSpecs/2013/Part1.pdf.

K) Contractor shall contact City Forestry (608)266-4816 at least one week prior to installing street trees to schedule inspecting the nursery stock and reviewing landscaping specifications with the landscaper.



Planting Size 6' B&B 2 I/2" B&B 2" B&B Planting Size

4' B&B

4' B&B 18" B&B 4' B&B Planting Size #I CONT. #I CONT. #I CONT. #I CONT. #3 CONT.

#I CONT.
Planting Size
#5 CONT.
#3 CONT.
#3 CONT.
3' B&B

GREEN ROOF: Pre-vegetated modular "Live Roof " Green Roof System With "Giants Mix", 4.25" Deep Trays (7 Sedum varieties and 1 Allium for year round color and interest) Sedum Aizoon SedumHybridum Seduma Takesimense Sedum Spurium 'Pink Jewel' Sedum Spurium 'Green Mantle' Sedum Spectabile 'Neon' Sedum Kamtschaticam 'Takahira Dake' Allium Schoenoprasum 'Pink Giant'

(3)PMG (12)SBA (12)KFG

Brown Colored Mulch -(I)CCP (In Tree Grate)

Permeable Pavers in Terrace, per City Spec Planters(SL4051) w/Annual Flowers I)MGS|

(I)MGSJ (5)PRD

(I)PMG

(4)DKOR -


(1)PMG (7)KFC Brown Colored Mulch

Ì Í)SBA

Planters(SL4061) w/Annual Flowers(Typ.)


City Street Tree (Typ.) (I)NHE (In Tree Grate)

Concrete by Others Planters(ŠL4061) w/Annual Flowers(Typ.)

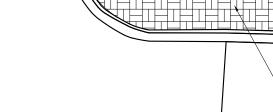


Permeable Pavers in Terrace

Permeable Pavers

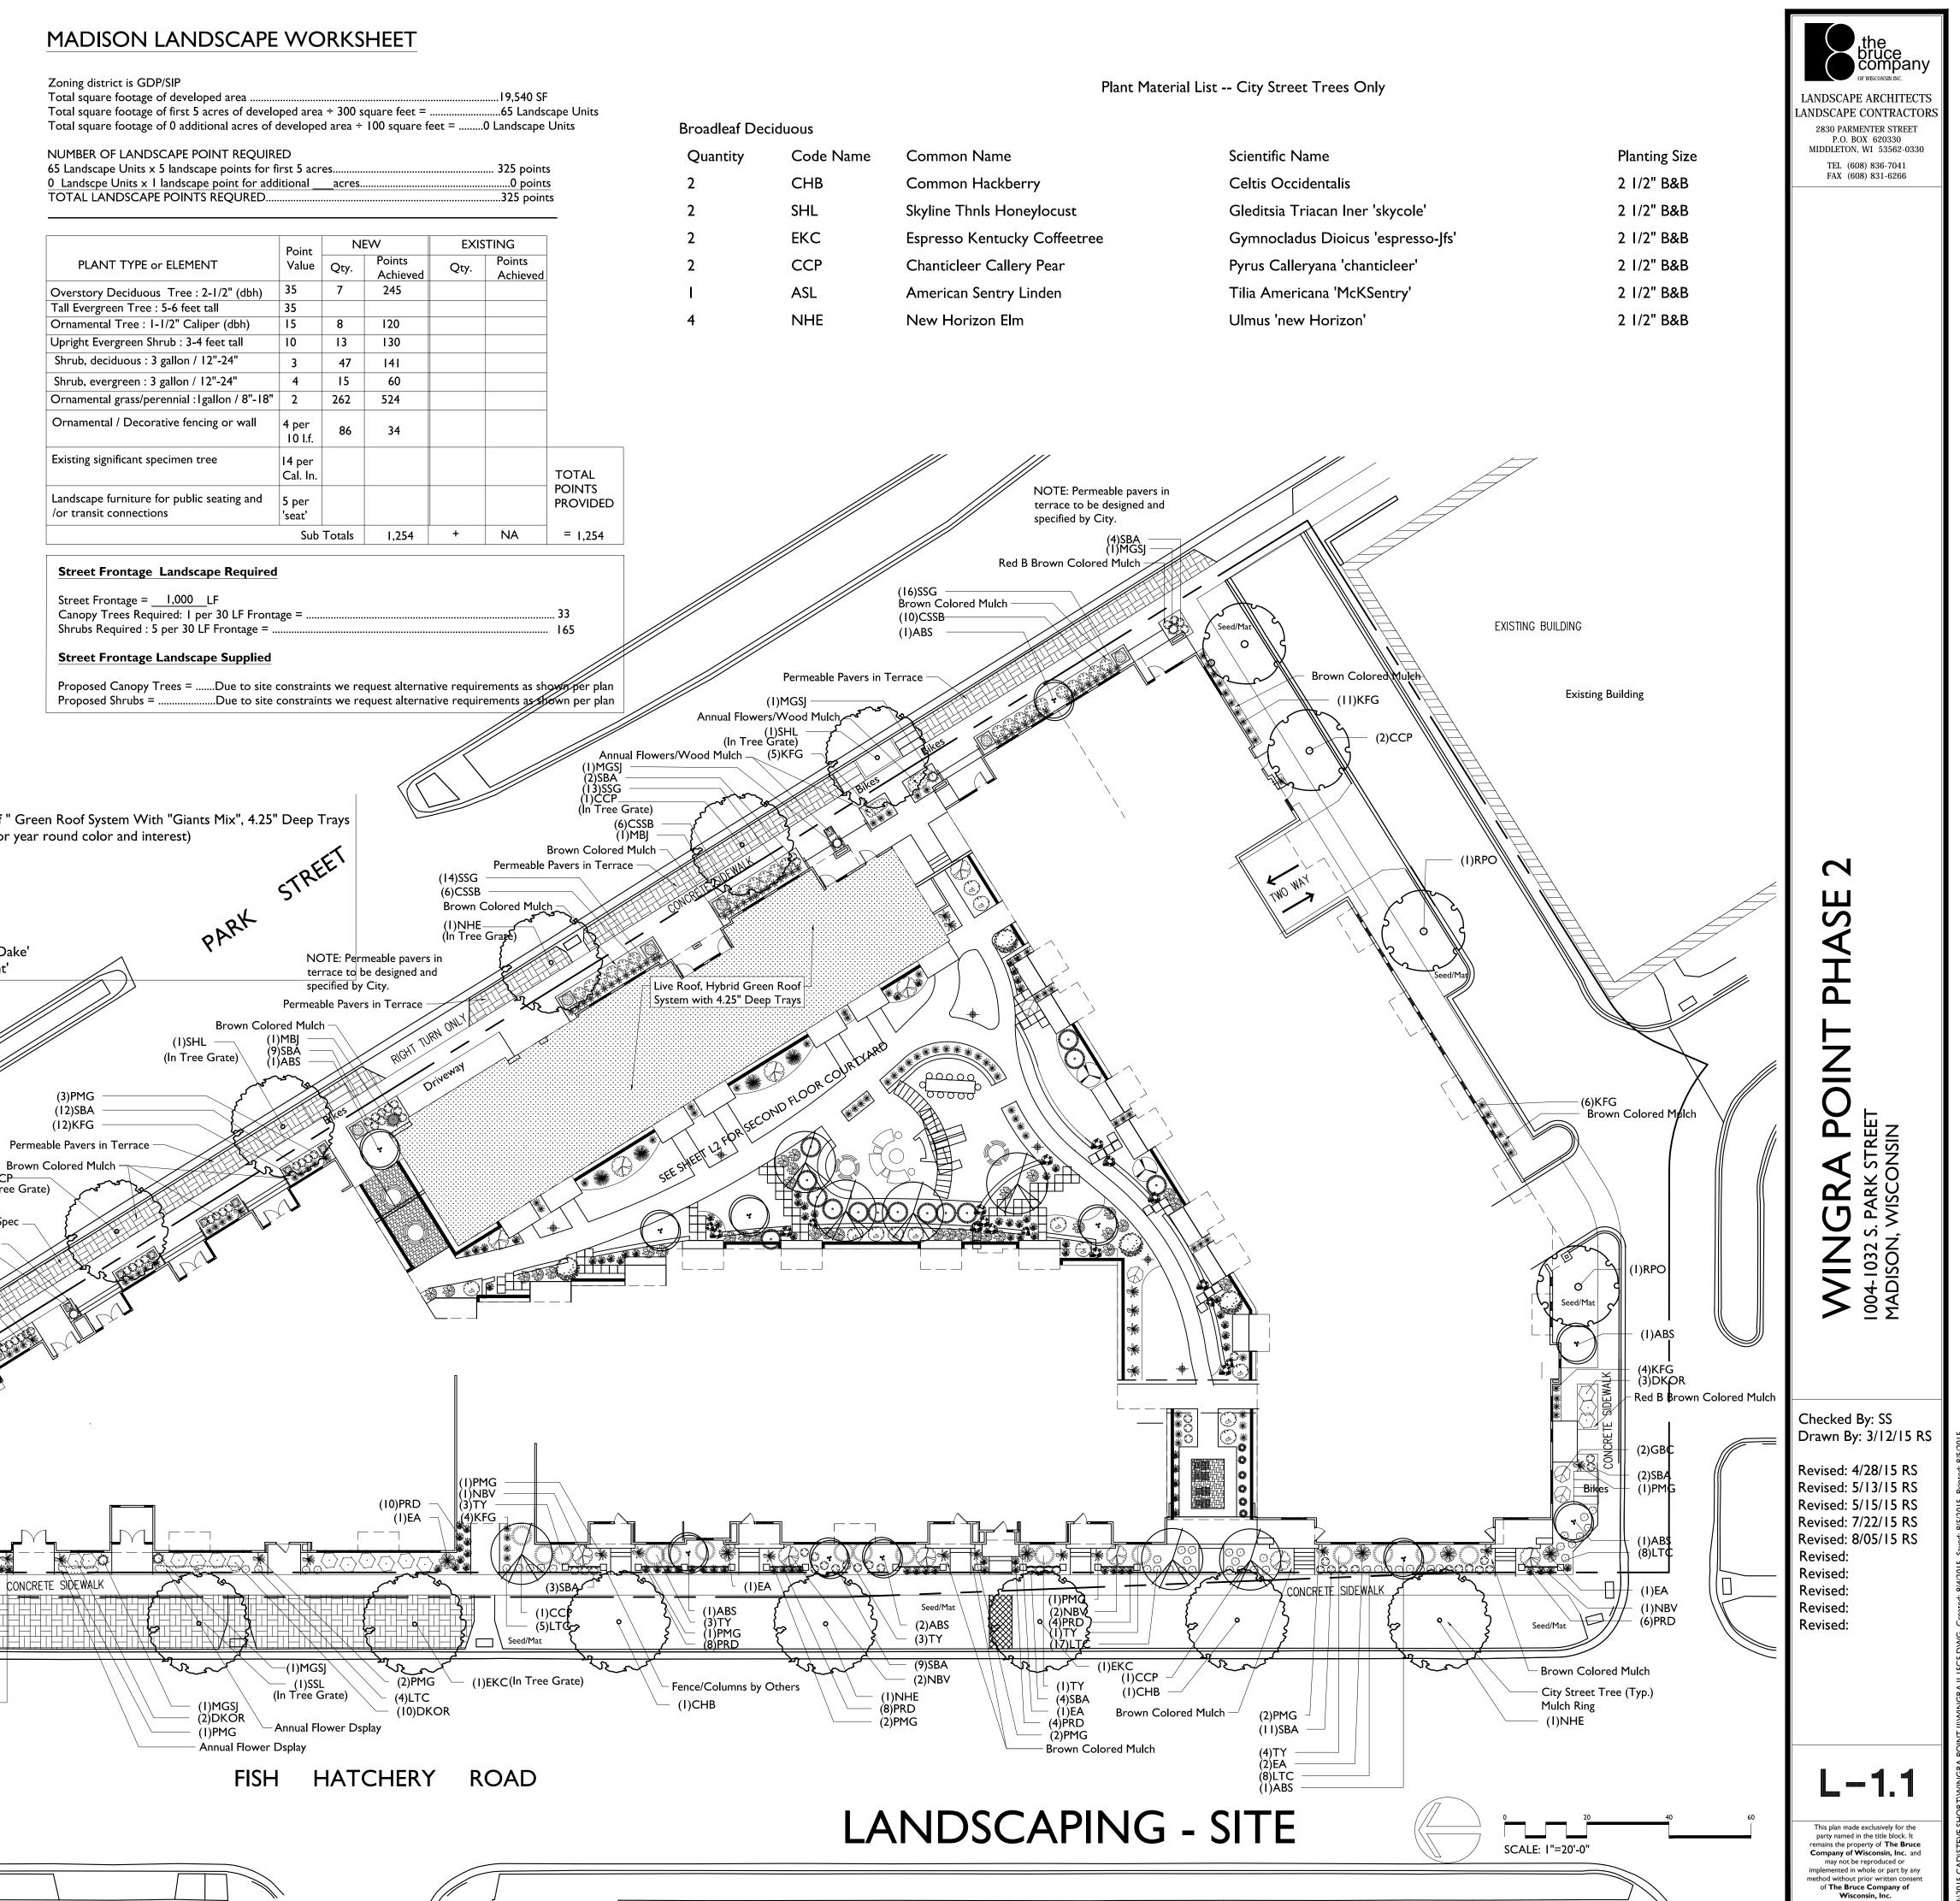


Broadleaf Deci	duous			
Quantity	Code Name	Common Name	Scientific Name	Planting Size
3	ABS	Autumn Brill Serviceberry	Amelanchier X Grand 'autumn Brill'	6' B&B
4	CCP	Chanticleer Callery Pear	Pyrus Calleryana 'chanticleer'	2 I/2" B&B
Conifer Evergr	een			
Quantity	Code Name	Common Name	Scientific Name	Planting Size
4	MMP	Mops Mugo Pine	Pinus Mugo 'mops'	#3 CONT.
14	WGA	Woodward Globe Arborvitae	Thuja Occidentalis 'woodwardii'	#5 CONT.
Perennial				
Quantity	Code Name	Common Name	Scientific Name	Planting Size
53	KFG	Karl Foerster's Feather Reed Grass	Calamagrostis Acutiflora 'karl Foerster'	#I CONT.
33	ОВН	Olive Bailey Langdon Hosta	Hosta X 'olive Bailey Langdon'	#I CONT.
7	PMG	Purple Maiden Grass	Miscanthus Sinensis Var Purpurescens	#I CONT.
4	MNMS	May Night Sage	Salvia Nemorosa 'mainacht'	#I CONT.
6	LBS	Little Bluestem	Schizachyrium Scoparium	#I CONT.
47	PRD	Prairie Dropseed	Sporobolus Heterolepis	#I CONT.
Shrub				
Quantity	Code Name	Common Name	Scientific Name	Planting Size
2	GBC	Glossy Black Chokeberry	Aronia Melanocarpa Var Elata	#5 CONT.
12	АН	Annabelle Hydrangea	Hydrangea Arborescens 'annabelle'	#3 CONT.
4	PDH	Pink Diamond Hydrangea	Hydrangea Paniculata 'pink Diamond'	#5 CONT.
2	KV	Koreanspice Viburnum	Viburnum Carlesii	30" B&B
5	NBV	Northern Burgundy Arwd Viburnu	Viburnum Dentatum 'morton'	3' B&B

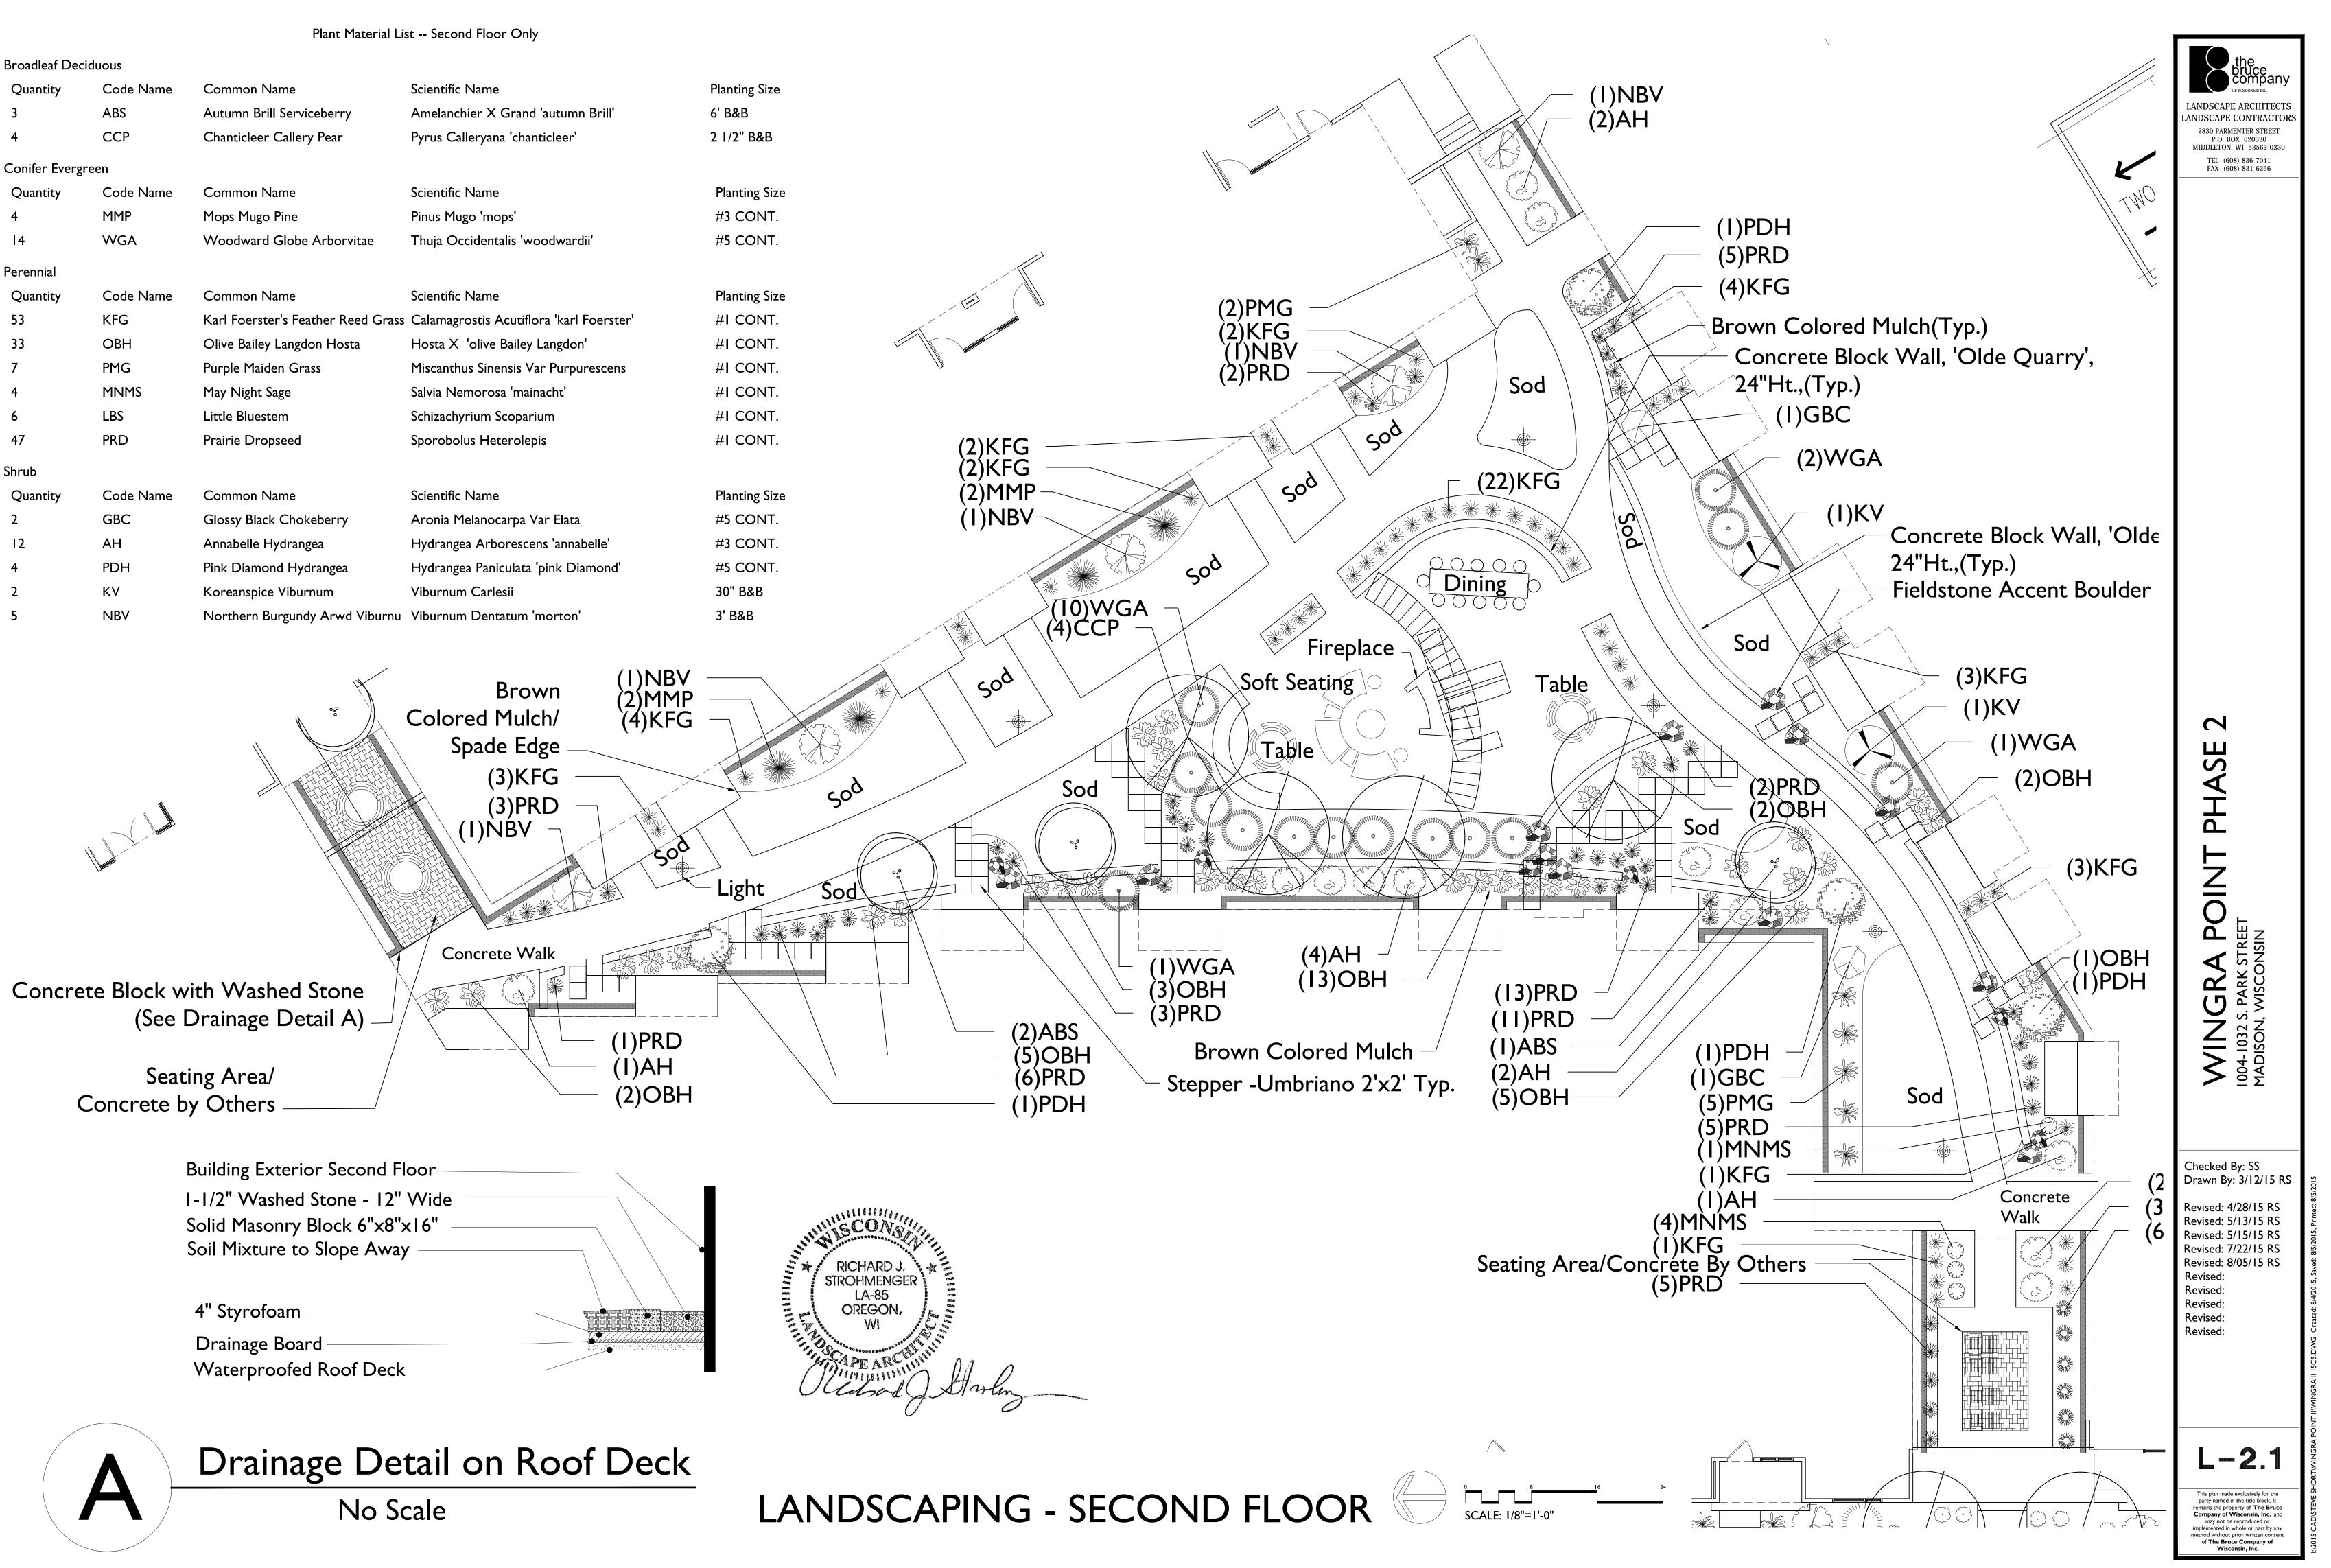



Product Information

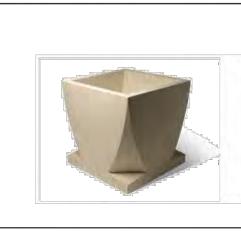


Finish Options

Standard -Weatherstone(B)


Premium -Weatherstone Glass(C)

Site Furnishing Division PO Box 1520, Wausau, WI 54402-1520 (800 388-8728) Date: 06/11/14

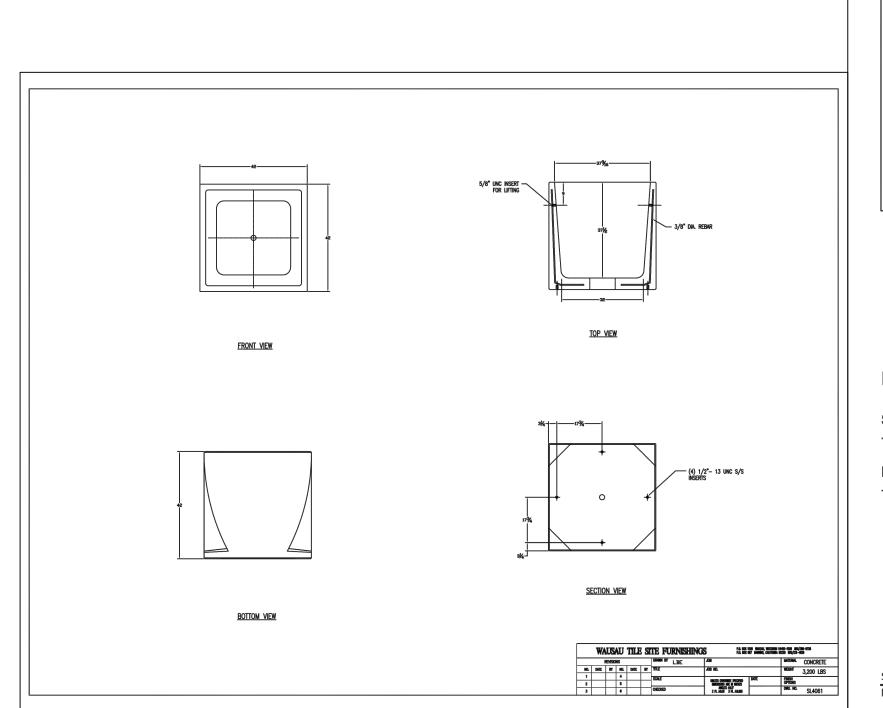





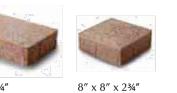


8" x 8" x 2¾" (20cm x 20cm x 7cm)


MIDNIGHT SKY

SUMMER WHEAT

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-	_	_								
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			-					-		



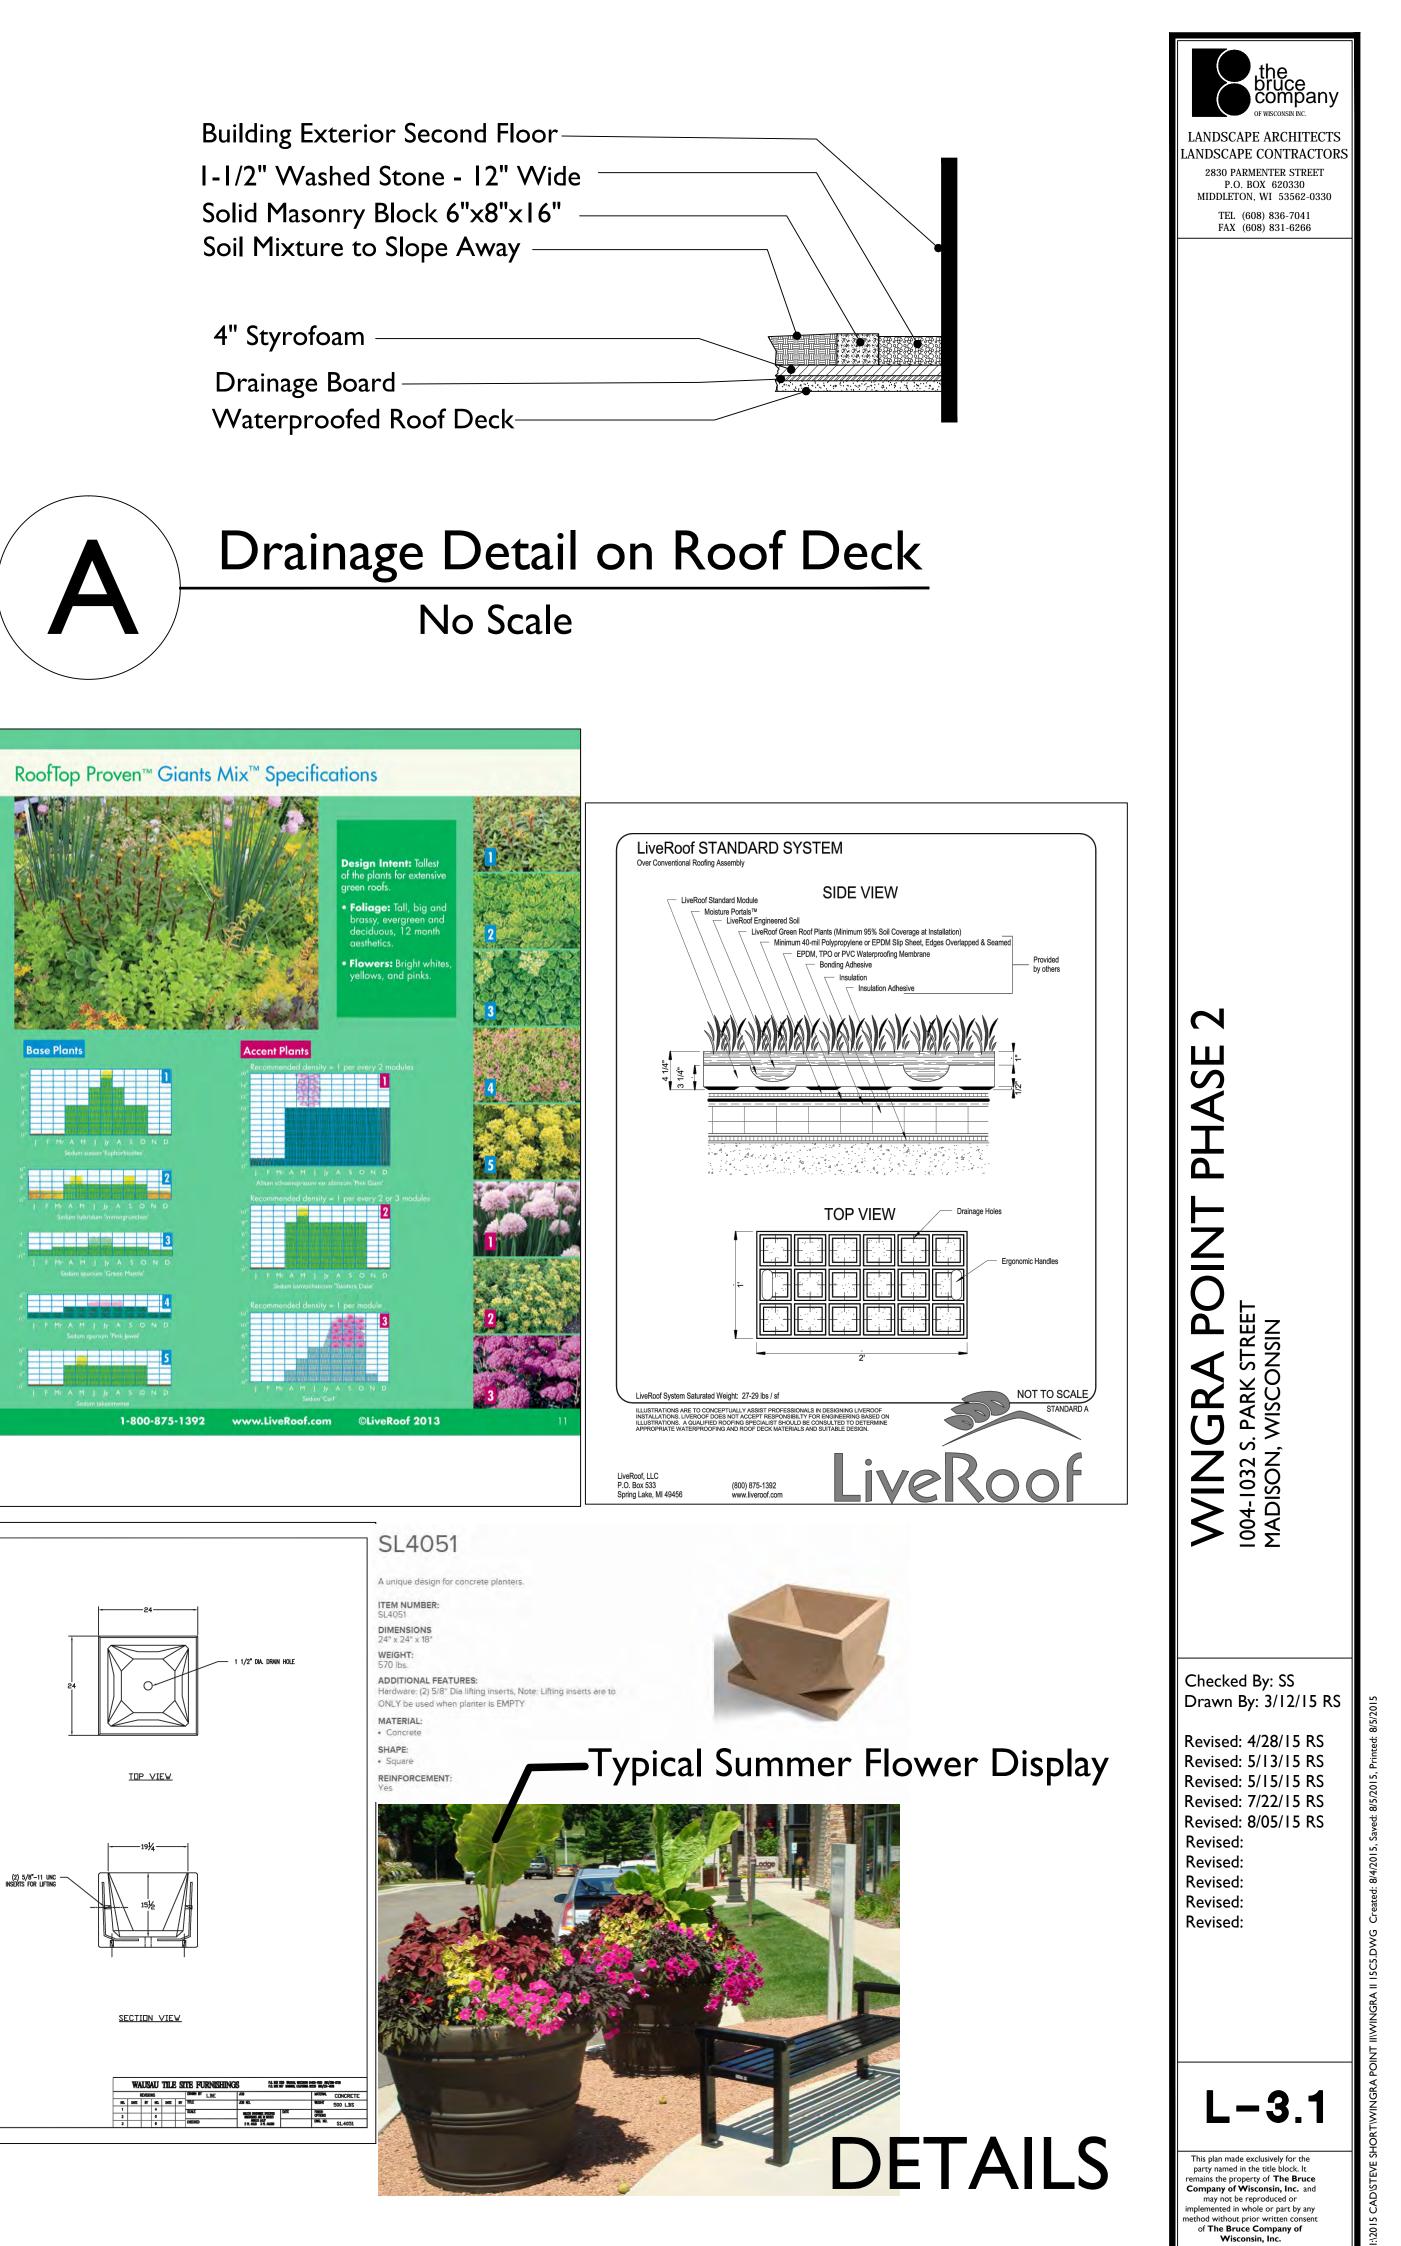

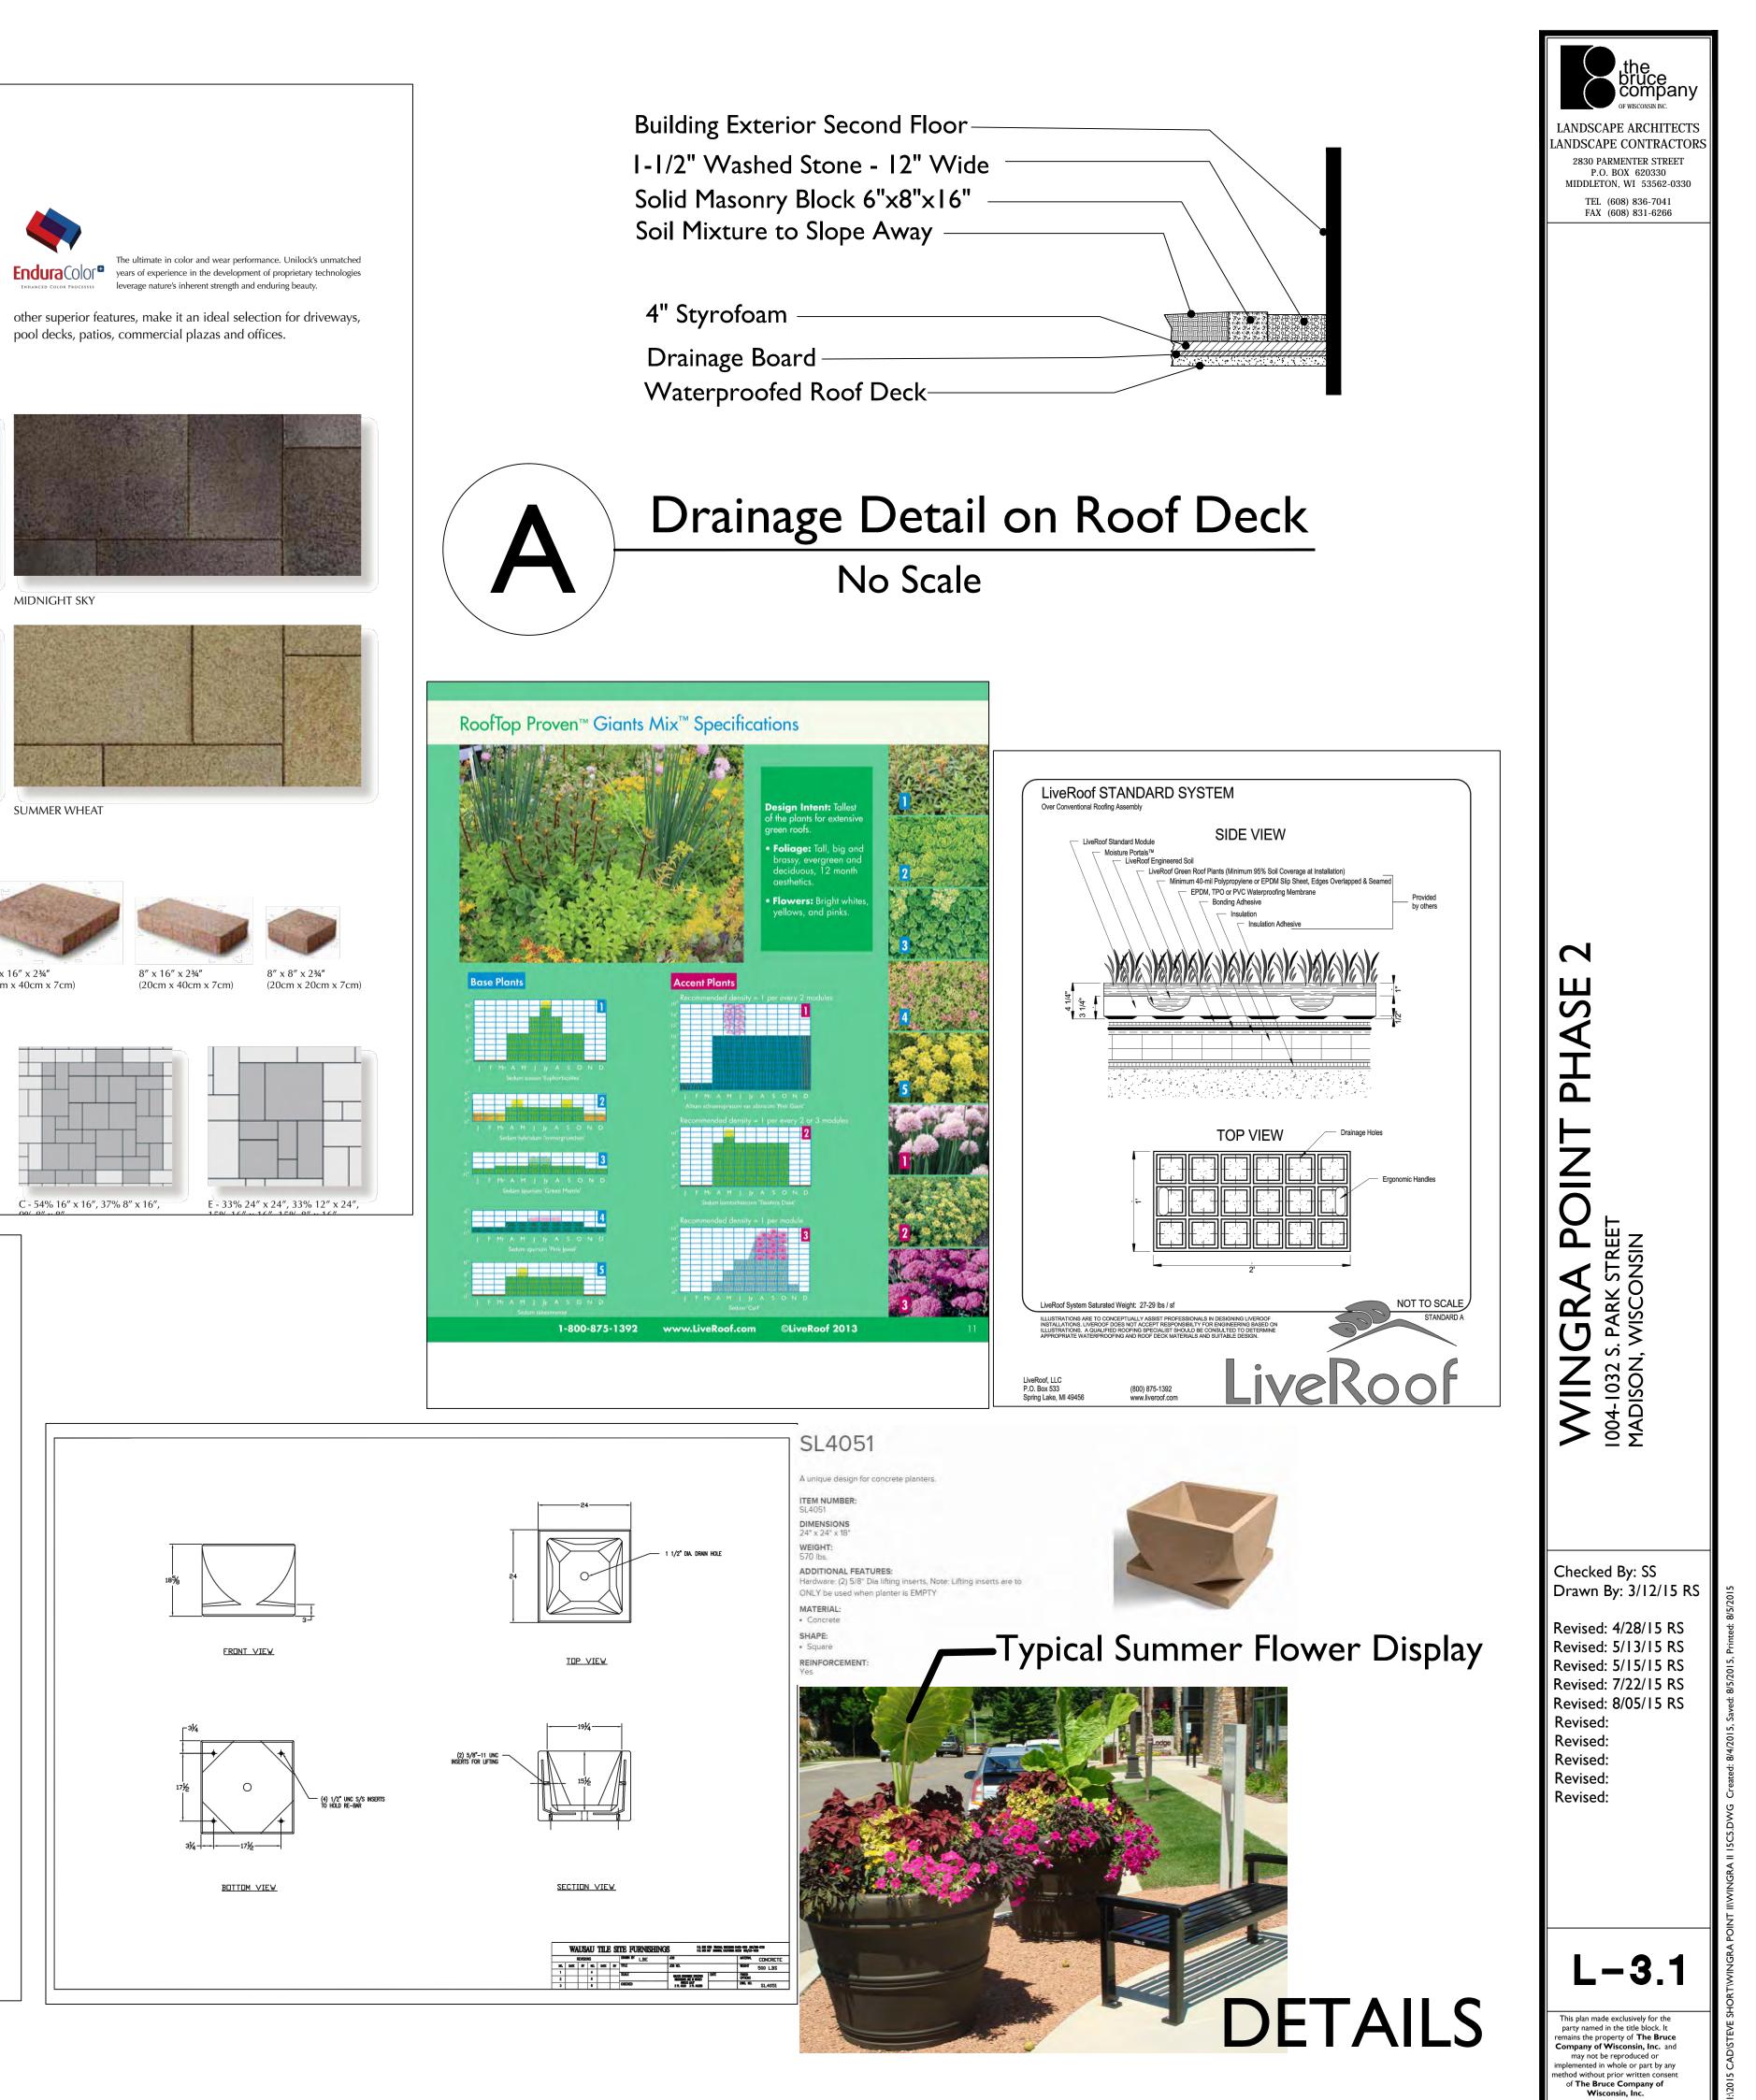

Size:	42" Sq. x 42" H
Weight:	3,200 Lbs.
Material:	Reinforced concre
Reinforcing:	3/8" Dia. steel reba
Logo Options:	Inkjet or Cast
Drain Hole:	(1) 2" Dia drain hol
Hardware:	(2) 5/8" Dia lifting in


Lifting inserts are to ONLY be used

when planter is EMPTY

Accepts Reservoir System


Note:

Size:	42" Sq. x 42" H
Weight:	3,200 Lbs.
Material:	Reinforced concrete
Reinforcing:	3/8" Dia. steel rebar
Logo Options:	Inkjet or Cast
Drain Hole:	(1) 2" Dia drain hole
Hardware:	(2) 5/8" Dia lifting inserts

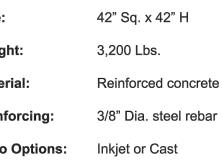

WAUSAU. Wausau Tile



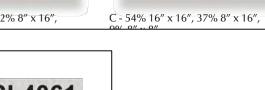

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