

URBAN DESIGN COMMISSION APPLICATION CITY OF MADISON

This form may also be completed online at: http://www.cityofmadison.com/planning/documents/UDCapplication.pdf

215 Martin Luther King Jr. Blvd; Room LL-100 PO Box 2985; Madison, Wisconsin 53701-2985 Phone: 608.266.4635 | Facsimile: 608.267.8739

Please complete all sections of the application, including the desired meeting date and the type of action requested.

Date Submitted: May 27, 2015	☐ Informational Presentation
UDC Meeting Date: _ June 10, 2015	☐ Initial Approval
Combined Schedule Plan Commission Date (if applicable):	X Final Approval
1. Project Address: 2500 Winnebago Street, Madison, Project Title (if any): Union Corners - Bldgs 4 & 5	Wi
7. This is an application for all the second second	
2. This is an application for (Check all that apply to this UDC application	
□ New Development	reviously-Approved Development
· · · · · · · · · · · · · · · · · · ·	Mixed-Use District (UMX) (\$150 fee, Minor Exterior Alterations) utional District (CI) or Employment Campus District (EC)
B. Signage: Comprehensive Design Review* (public hearing-\$300 fee) Signage Exception(s) in an Urban Design District (public C. Other: Please specify:	Street Graphics Variance* (public hearing-\$300 fee) c hearing-\$300 fee)
3. Applicant, Agent & Property Owner Information:	
Applicant Name: Gary Gorman	Company: Gorman & Company, Inc.
Street Address: 200 N. Main Street	City/State: Madison, Wi Zip: 53575
Telephone:(608) 835-3900 Fax:()	Email: tmatkom@gormanusa.com
Marc Ott	Gorman & Company Inc
Project Contact Person: Marc Ott	Company: Gorman & Company, Inc.
Street Address: 200 N. Main Street	City/State: Oregon, Wi
Telephone:(<u>608</u>) <u>835-6388</u> Fax:()	Email: mott@gormanusa.com
Project Owner (if not applicant) :	
Street Address:	City/State:Zip:
Telephone:() Fax:()	Email:
4. Applicant Declarations:	-
A. Prior to submitting this application, the applicant is required to discuss the	<u>Union Corners GDP Approval</u> (date of meeting) iittal and understands that if any required information is not provided b
Name of Applicant Gorman & Company, Inc.	Relationship to Property Architect
Authorized Signature	Date May 27, 2015



P: (608) 835-3900 F: (608) 835-3922

www.GormanUSA.com

REAL ESTATE DEVELOPMENT

MILWAUKEE MIAMI PHOENIX CHICAGO DENVER

May 27, 2015

Mr. Al Martin Urban Design Commission 215 Martin Luther King Jr. Blvd P.O. Box 2985 Madison, Wi 53701

Re: Letter of Intent

PD-SIP Re Zoning

2500 Winnebago Street Madison, Wi 53704

Dear Mr. Martin:

The following is submitted together with the plans, and application for staff approval.

Project Organizational Structure:

Owner: Gorman & Company, Inc.

200 N. Main Street Oregon, WI 53575 414-617-9997

Contact: Edward Matkom tmatkom@gormanusa.com

Architect: Gorman & Company, Inc.

200 N. Main Street
Oregon, WI 53575
608-835-3900
Contact: Marc Ott
mott@gormanusa.com

Civil: JSD Professional Services, Inc. Engineer 161 Horizon Dr, Suite 101

Madison, WI 53593 608-848-5060

Contact: Hans Justeson hans.justeson@jsdinc.com

Landscape: JSD Professional Services, Inc.
Design 161 Horizon Dr, Suite 101

Madison, WI 53593 608-848-5060

Contact: Justin Frahm justin.frahm@jsdinc.com

Introduction:

The site property is located on the east side of Madison, on Winnebago Street just off of East Washington Boulevard. The property is within the Union corners General Plan Development. The site is currently vacant.

Zoning:

The site is currently within the Union Corners General Plan Development.

Project Description:

The Project consists of two four story buildings with a shared basement parking structure. The ground floor contains retail suites, building common areas/ amenity spaces, live/work apartments, and lobbies. The upper three floors are rental apartments. The project includes improvements to Winnebago street outside of the property line of this phase, including new sidewalks, and angled street parking. Additionally, the project constructs a new serpentine pedestrian pathway and stormwater management swales.

Project Development Data:

Site Density:

Lot area: 48,701 s.f. (1.118 acres)

Dwelling Units: 90 Units
Lot Area / D.U. 541 s.f / d.u.
Density 80.50 d.u. / acre

Site Coverage:

Building: 30,244 s.f. (62.1 %)
Ramp: 1,465 s.f. (3.0 %)
Sidewalks: 1,012 s.f. (2.1 %)
Plaza: 4,708 s.f. (9.6%)
Building Patios: 3,641 s.f. (7.7%)
Pedestrian Path: 1,123 s.f. (2.2%)
Pervious: 6,508 s.f. (13.3 %)

Building Ratio:

Retail Shell: 65,211 s.f. (28.4 %)
Apartments & Amenities 72,330 s.f. (31.5 %)
Underground Parking: 9,666 s.f. (4.2 %)
Misc (corridor, mech, stairs): 52,280 s.f. (22.7 %)

229,682 s.f. Total Building Area

<u>Dwelling Unit Mix</u> <u>Bike Parking:</u>

One Bedroom 19 Enclosed: 68
Two Bedroom 57 Surface: 44

Three Bedroom___14 112 Total

90 Total

Vehicular Parking:

Enclosed 97

Surface 33 (In City R.O.W.)

130 Total

Schedule:

The development schedule calls for construction to start October of 2015, with a scheduled completion in October 2016.

Social & Economic Impacts:

This development will have a positive social and economic impact on the surrounding community. The redevelopment of this property will provide high quality affordable housing, create new retail establishments, and infuse local businesses with new revenue sources.

Thank you for your time in reviewing our proposal.

Edwald. Matter

Sincerely,

Edward Matkom

President – Wisconsin Market

Gorman & Company, Inc.

Zoning Text

Rezoning PD-GDP to PD-SIP Union Corners – Bldg 4 & 5 2500 Winnebago Road Lot 3 & 4 of Union Corner May 27, 2015

Legal Description: Lot 3 & 4 of Union Corners

A. **Statement of Purpose:** Re-zoning of Lot 3 & 4 from PD-GDP PD-SIP to allow for the construction of two four story mixed-use buildings. Buildings will consist of retail space on the ground floor, and 90 dwelling units on the upper three floors. Tenant parking will be provided in one shared underground parking garage.

B. **Permitted Uses:** Uses as shown on Exhibit A, attached hereto

C. **Lot Area:** Lot 3 & 4 – 48,701 s.f. (1.118 acres)

D. Floor Area Ratio: 0.21

E. Yard Requirements: As shown on the attached plans

F. Landscaping: Site landscaping provided as shown on the attached landscape plan.

G. **Accessory Off-Site Parking:** Off-street and surface parking shall be provided as shown the attached plans.

- H. **Lighting:** Site lighting will be provided along north pedestrian path, plaza, and building façade and meeting MGO requirements. Exhibit to follow.
- **I. Signage:** Retail tenant, and apartment signage will be located on building façade, and meet MGO requirements. See attached plans. Signage approval will made in a separate submittal.
- J. Alterations and Revisions: No alteration or revision of the planned unit development shall be permitted unless approved by the City Plan Commission, however, the Zoning Administration may issue permits for minor alterations or additions which are approved by the Director of Planning and Development and the alderperson of the district and are compatible with the concept approved by the City Plan Commission.

Exhibit A - Permitted Uses

Residential – Family Living

- Live/work unit
- Multi-family dwelling (>8 dwelling units)

Residential - Group Living

- Adult family home
- Cohousing community
- Community living arrangement (> 15 residents)
- Housing cooperative

Civic and Institutional Uses

- Counseling, community services organization
- Community center
- Day care center
- Library, museum
- Recreational, community, and neighborhood centers

Agriculture and Resource Uses

- Community garden
- Market garden

Accessory Uses and Structures

- Management office, restaurant, limited retail, recreation facilities within multi-family building
- Non-accessory temporary outdoor events
- On-site agricultural retail, farm stand
- Outdoor display
- Outdoor eating area associated with food & beverage establishment
- Outdoor sales event
- Temporary outdoor events
- Walk-up service windows

Offices

- Artist, photographer studio, etc.
- Insurance office, real estate office, sales office
- General office
- Professional office

Medical Facilities


- Physical, occupational or message therapy
- Dentist
- Chiropractor

Retail Sales and Services

- Animal grooming
- Artisan workshop
- Bank, financial institution
- Business sales and services
- Dry cleaning plant, commercial laundry
- Farmers' market
- Food and related goods sales
- Furniture and household goods sales
- General retail
- Health/sports club
- Home occupation
- Indoor recreation
- Package delivery service
- Printing and publishing
- Post office
- Real estate sales office
- Secondhand goods sales
- Service business
- Telecommunications center
- Tobacco shop

Food and Beverage

- Catering
- Coffee shop, tea house
- Restaurant
- Restaurant-tavern
- Tavern, brewpub

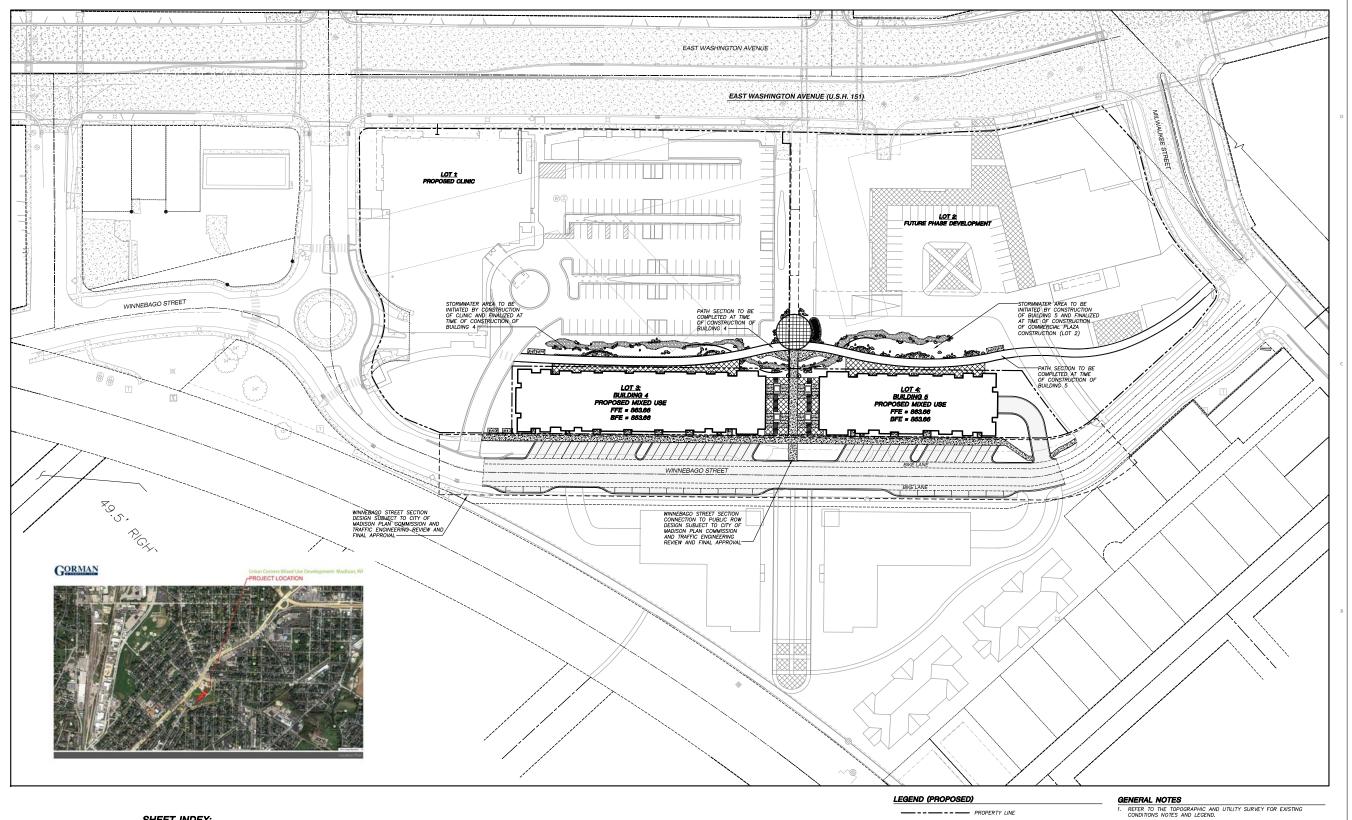

A200 - BUILDING FLOOR PLANS

A400 - BUILDING ELEVATIONS

A401 - BUILDING ELEVATIONS

C100 - OVERALL SITE PLAN

C201 - BUILDING 5 SITE PLAN

C501 - DETAILS

L200 - BUILDING 4 LANDSCAPE PLAN

L201 - BUILDING 5 LANDSCAPE PLAN

L300 - LANDSCAPE DETAILS, NOTES AND SPECIFICATIONS

PROPERTY LINE ---- RIGHT-OF-WAY --- WINNEBAGO STREET PUBLIC WORKS APPROVA ---- FUTURE PATH

—x —x —x —x — PROPOSED RAILING CONCRETE PAVEMENT

ARCHITECTURAL BRICK PAVERS ARCHITECTURAL BRICK PAVERS 2

GORMAN R COMPANY, INC.

REAL ESTATE DEVELOPMENT & MANAGEMENT

> 200 N. MAIN STREET OREGON, WI 53575

ISD Professional Serviços, Inc.

MADISON REGIONAL OFFICE 161 HORIZON DRIVE, SUITE 101 VERONA, WISCONSIN 53593 608.848.5060 PHONE

■ 608.848.2255 FAX

MADISON MILWAUKEE KENOSHA APPLETON WWW.jsdinc.com

UNION CORNERS SPECIFIC IMPLEMENTATION PLAN COMPANY

В				
	Project No.		1	14-6534
	Plot Date:			
	Drawn by:	ILE	KIY	MG

GORMAN &

Date Issue Description GDP 06-25-14 SIP 11-05-14 UDC/PC 1-14-15 RESUBMITTAL UDC FINAL 05-27-15

Sheet Title

JSD SHALL BE HELD HARMLESS AND DOES NOT WARRANT ANY DEVAILONS BY THE OWNER/CONTRACTOR FROM THE APPROVED CONSTRUCTION PLANS THAT MAY RESULT IN DISCIPLINARY ACTIONS BY ANY OR ALL REGULATORY AGENCIES.

4. DRAWING FOR REVIEW — NOT FOR CONSTRUCTION UNLESS OTHERWISE NOTED IN THE TITLE BLOCK.

OVERALL SITE PLAN

Sheet No.

C100

SHEET INDEX:

C200 - BUILDING 4 SITE PLAN

C300 - GRADING AND EROSION CONTROL PLAN

C400 - UTILITY PLAN C500 - DETAILS

L100 - OVERALL LANDSCAPE PLAN

 BUILDING LINE - EDGE OF PAVEMENT


MASONRY BRICK (RECYCLED)

LIMESTONE BOULDERS (VARY IN SIZE AND COLOR)

TO OBTAIN LOCATIONS OF PARTICIPANT UNDERGROUND FACILITIES BEFORE YOU DIG IN WISCONSIN





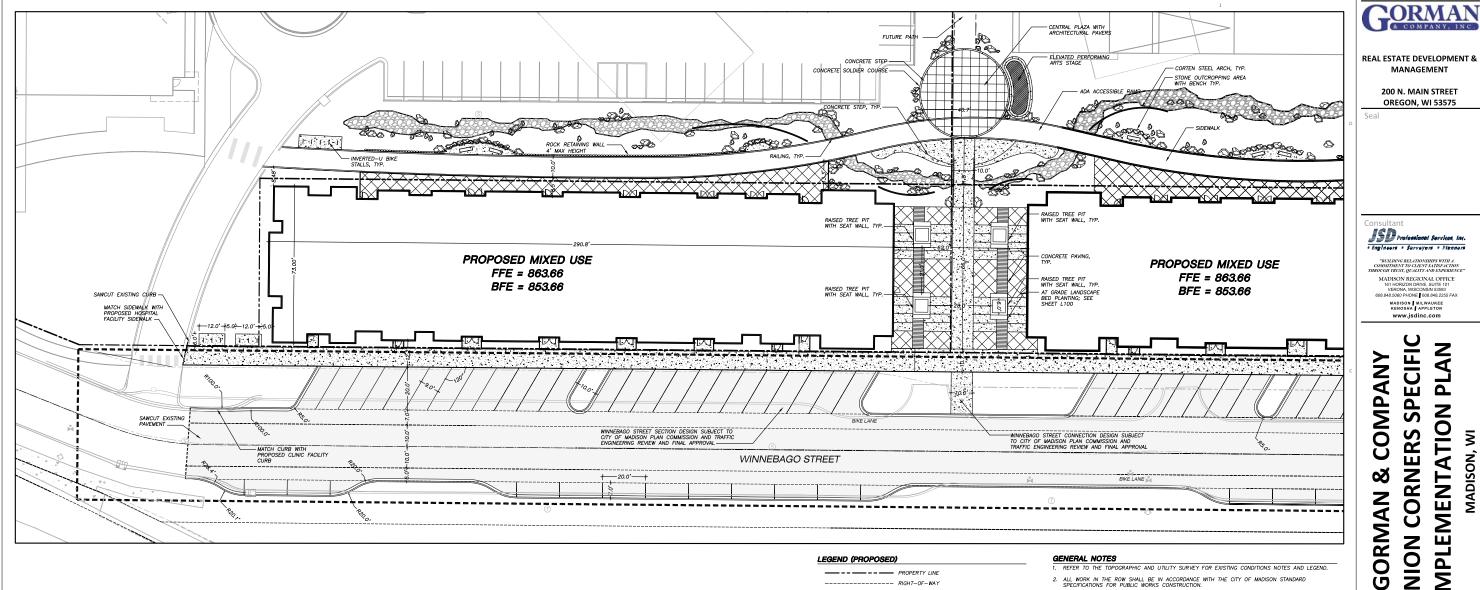

_____ FUTURE PATH

-x-x-x-x-PROPOSED RAILING

CONCRETE PAVEMENT ARCHITECTURAL BRICK PAVERS

---- RIGHT-OF-WAY ---- WINNEBAGO STREET PUBLIC WORKS APPROVAL

BUILDING LINE

- EDGE OF PAVEMENT

ARCHITECTURAL BRICK PAVERS 2

MASONRY BRICK (RECYCLED)


LIMESTONE BOULDERS (VARY IN SIZE AND COLOR)

REFER TO THE TOPOGRAPHIC AND UTILITY SURVEY FOR EXISTING CONDITIONS NOTES AND LEGEND.

ALL WORK IN THE ROW SHALL BE IN ACCORDANCE WITH THE CITY OF MADISON STANDARD SPECIFICATIONS FOR PUBLIC WORKS CONSTRUCTION.

JSD SHALL BE HELD HARMLESS AND DOES NOT WARRANT ANY DEVIATIONS BY THE OWNER/CONTRACTOR FROM THE APPROVED CONSTRUCTION PLANS THAT MAY RESULT IN DISCIPLINARY ACTIONS BY ANY OR ALL REGULATORY AGENCIES.

4. DRAWING FOR REVIEW - NOT FOR CONSTRUCTION UNLESS OTHERWISE NOTED IN THE TITLE BLOCK.

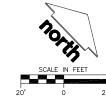

TO OBTAIN LOCATIONS OF PARTICIPANT UNDERGROUND FACILITIES BEFORE YOU DIG IN WISCONSIN



CALL DIGGERS HOTLINE WISCONSIN STATE STATUTE 182.0175(1974) REQUIRES MINIMUM THREE (3) WORK DAYS NOTICE BEFORE YOU ENCAVATE



Sheet Title

Project No.

Plot Date:

Drawn by:

Date

GDP

UDC/PC

RESUBMITTAL

UDC FINAL

BUILDING 4 SITE PLAN

MANAGEMENT

200 N. MAIN STREET OREGON, WI 53575

MADISON REGIONAL OFFICE 161 HORIZON DRIVE, SUITE 101 VERONA, WISCONSIN 53593 608.848.5060 PHONE \$ 608.848,2255 FAX

MADISON MILWAUKEE KENOSHA APPLETON WWW.jsdinc.com

UNION CORNERS SPECIFIC

IMPLEMENTATION PLAN

MADISON, WI

14-6534

JLF, KJY, MG


Issue Description

06-25-14 11-05-14

1-14-15

05-27-15

Sheet No.

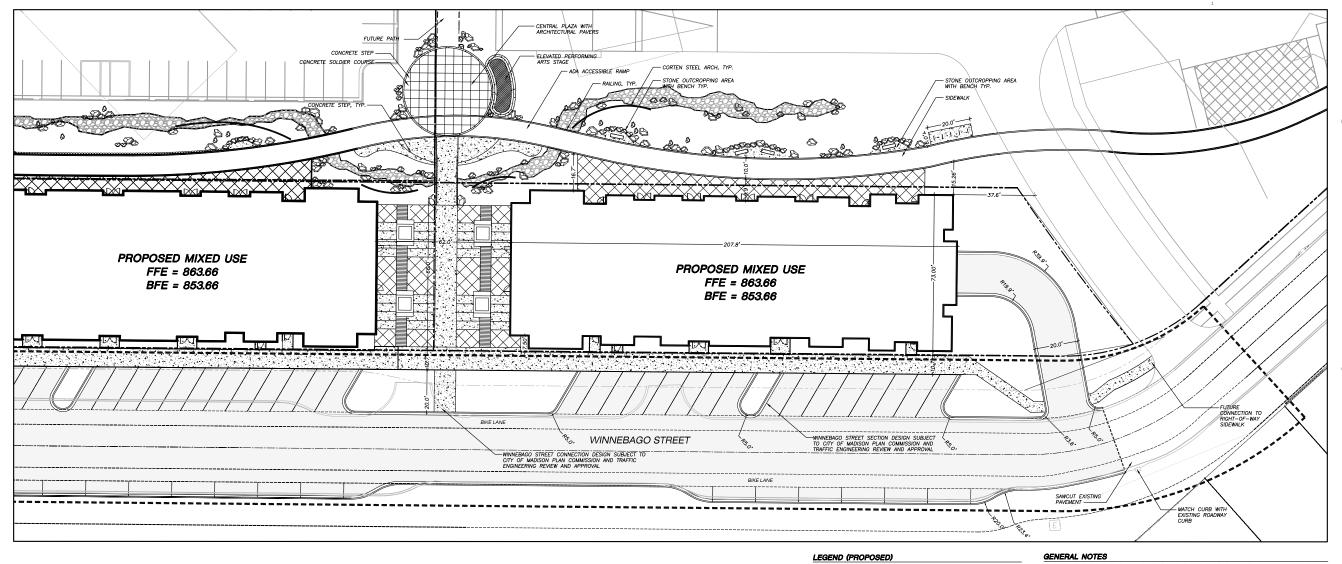

CONCRETE PAVEMENT


ARCHITECTURAL BRICK PAVERS

ARCHITECTURAL BRICK PAVERS 2

MASONRY BRICK (RECYCLED)

LIMESTONE BOULDERS (VARY IN SIZE AND COLOR)

- REFER TO THE TOPOGRAPHIC AND UTILITY SURVEY FOR EXISTING CONDITIONS NOTES AND LEGEND.
- ALL WORK IN THE ROW SHALL BE IN ACCORDANCE WITH THE CITY OF MADISON STANDARD SPECIFICATIONS FOR PUBLIC WORKS CONSTRUCTION.
- JSD SHALL BE HELD HARMLESS AND DOES NOT WARRANT ANY DEVIATIONS BY THE OWNER/CONTRACTOR FROM THE APPROVED CONSTRUCTION PLANS THAT MAY RESULT IN DISCIPLINARY ACTIONS BY MAY OR ALL REQUILATORY AGENCIES.
- 4. DRAWING FOR REVIEW NOT FOR CONSTRUCTION UNLESS OTHERWISE NOTED IN THE TITLE BLOCK.

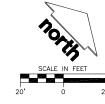

TO OBTAIN LOCATIONS OF PARTICIPANT UNDERGROUND FACULTIES BEFORE YOU DIG IN MISCONSIN

CALL DIGGERS HOTLINE
1-800-242-8511 TOLL FREE
COMMUNICATION REPORT OF THE PROPERTY WARRANT HOUSE TO EXCHANGE





REAL ESTATE DEVELOPMENT & MANAGEMENT

200 N. MAIN STREET OREGON, WI 53575

Spal

Consultant

| SD Professional Services, Inc.

- Engineers - Surveyors - Planners

"BUILDING RELATIONSHIPS WITH A
COMMITMENT TO CLEN'S ATISEACTION
UROUGH TRUST, QUALITY AND EXPERIENCE
MADISON REGIONAL OFFICE
161 HORIZON DRIVE, SUITE 101
VERONA, WISCONSIN 53583
608 848 5060 PHONE | 608 842.256 FAX
MADISON | MILWAUKEE

MADISON | MILWAUKEE KENOSHA | APPLETON WWW.jsdinc.com

GORMAN & COMPANY UNION CORNERS SPECIFIC IMPLEMENTATION PLAN

MADISON, WI

Project No.	14-65
Plot Date:	
Drawn by:	JLF, KJY, M
Date	Issue Description
GDP	06-25-14
SIP	11-05-14

1-14-15

05-27-15


Sheet Title

UDC/PC

RESUBMITTAL UDC FINAL

BUILDING 5 SITE PLAN

Sheet No.

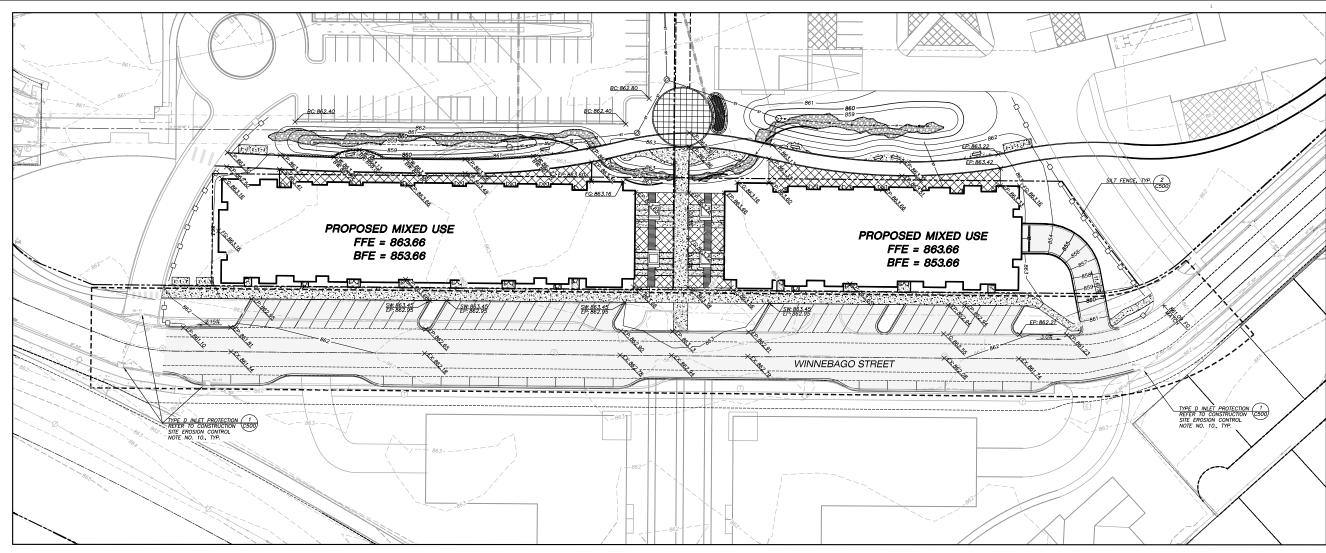

LEGEND (PROPOSED)

 PROPERTY LINE
 RIGHT-OF-WAY
 WINNEBAGO STREET

---- FUTURE PATH — SILT FENCE


- REFER TO THE TOPOGRAPHIC AND UTILITY SURVEY FOR EXISTING CONDITIONS NOTES AND LEGEND.
- 2. EXISTING CONDITION SURVEY AS PROVIDED BY POINT OF BEGINNING, INC. ON 4-14-2014. ANY DISCREPANCIES TO BE REPORTED TO JSD IMMEDIATELY UPON DISCOVERY.
- JSD SHALL BE HELD HARMLESS AND DOES NOT WARRANT ANY DEVIATIONS BY THE OWNER/CONTRACTOR FROM THE APPROVED CONSTRUCTION PLANS
 THAT MAY RESULT IN DISCIPLINARY ACTIONS BY ANY OR ALL REGULATORY AGENCIES.
- 5. DRAWING FOR REVIEW NOT FOR CONSTRUCTION UNLESS OTHERWISE NOTED IN THE TITLE BLOCK.

CONSTRUCTION SITE EROSION CONTROL REQUIREMENTS

- ALL EROSION AND SEDIMENT CONTROL PRACTICES SHALL BE DESIGNED AND IMPLEMENTED IN ACCORDANCE WITH THE CURRENT DEPARTMENT OF NATURAL RESOURCES EROSION AND SEDIMENT CONTROL TECHNICAL STANDARDS WHICH ARE AVAILABLE AT: http://www.dnr.state.wi.us/mont/stormworter/clenstds.htm

- 4. INSPECT EROSION CONTROL MEASURES AFTER EACH 1/2" OR GREATER RAINFALL. REPAIR ANY DAMAGE OBSERVED DURING THE INSPECTION.
- 5. EROSION CONTROL MEASURES SHALL BE REMOVED ONLY AFTER SITE CONSTRUCTION IS COMPLETE WITH ALL SOIL SURFACES HAVING AN ESTABLISHED VEGETATIVE COVER.
- INSTALL EROSION CONTROLS ON THE DOWNSTREAM SIDE OF STOCKPILES AND PROVIDE TEMPORARY SEEDING ON STOCKPILES WHICH ARE TO REMAIN IN PLACE FOR MORE THAN 7 DAYS.
- 7. INSTALL CHECK DAMS WITHIN DRAINAGESDITCHES AND IN FRONT OF SILT FENCING IN ANY LOW AREA ALL IN ACCORDANCE WITH WONR TECHNICAL STANDARDS
- 8. EROSION CONTROL FOR UTILITY CONSTRUCTION (STORM SEWER, SANITARY SEWER, WATER MAIN, ETC.):
 A. PLACE EXCAVATED TRENCH MATERIAL ON THE HIGH SIDE OF THE TRENCH.
 B. BACKFILL, COMPACT, AND STABLIZE THE TRENCH MANDEMATELY AFTER PIPE CONSTRUCTION.
 C. DISCHARGE RENCH WATER INTO A SEDMENTATION BASIN OR FILLERING TANK IN ACCORDANCE WITH THE DEWATERING TECHNICAL STANDARD NO. 1061 PRIOR TO RELASE INTO THE STORM SEWER, RECEIVING STREAM, OR DRAINAGE DITCH.
- 10. INSTALL TYPE D INLET PROTECTION AROUND ALL STORM SEWER INLETS AND CATCH BASINS THAT MAY RECEIVE RUNOFF FROM AREAS UNDER CONSTRUCTION. REFER TO WISDOT FDM FOR RESPECTIVE DETAILS.
- 11. APPLY ANIONIC POLYMER TO DISTURBED AREAS IF EROSION BECOMES PROBLEMATIC.
- 12. ADDITIONAL EROSION CONTROL MEASURES, AS REQUESTED BY STATE INSPECTORS, LOCAL INSPECTORS, AND/OR ENGINEER SHALL BE INSTALLED WITHIN 24 HOURS OF REQUEST.
- 1.3. ALL SLOPES EXCEDING 5:1 (20%) SHALL BE STABILIZED WITH A CLASS II, TYPE B EROSION MATTING AND DRAINAGE SWALES SHALL BE STABILIZED WITH CLASS I, TYPE B EROSION MATTING OR APPLICATION OF A WORLD FOLLYMER SOIL STABILIZATION TREATMENT OR A COMBINATION THEREOF, AS REQUIRED. CONTRACTOR SHALL PROVIDE PRODUCT SPECIFICATIONS TO PROJECT ISONIDER FOR APPLICATION.
- 14. CONTRACTOR SHALL TAKE ALL NECESSARY STEPS TO CONTROL DUST ARISING FROM CONSTRUCTION OPERATIONS. REFER TO WDNR TECHNICAL STANDARD 1068
- 15. CONTRACTOR TO PROVIDE SOLID LID OR METAL PLATE ON ALL OPEN MANHOLES DURING CONSTRUCTION TO MINIMIZE SEDIMENT FROM ENTERING THE STORM SEWER SYSTEM.

- ALL DISTURBED AREAS IN R.O.W. SHALL BE SODDED IMMEDIATELY FOLLOWING GRADING ACTIVITIES. SOD TO BE IN ACCORDANCE WITH LANDSCAPE PLAN. ALL PROPOSED GRADES SHOWN ARE FINISHED GRADES. CONTRACTOR SHALL VERIFY ALL GRADES, MAKE SURE ALL AREAS DRAIN PROPERLY AND SHALL
 REPORT ANY DISCREPANCIES TO THE ENGINEER PRIOR TO CONSTRUCTION.
- 3. CONTRACTOR SHALL PROTECT ADJACENT PROPERTIES WITH SILT FENCING OR OTHER APPLICABLE MEASURES FOR EROSION CONTROL UNTIL CONSTRUCTION IS COMPLETED AND NOTICE OF TERMINATION FILED.
- 4. CONTRACTOR SHALL WATER ALL NEWLY SODDED AREAS IN R.O.W. DURING THE SUMMER MONTHS WHENEVER THERE IS A 7 DAY LAPSE WITH NO SIGNIFICANT RAINFALL.
- CONTRACTOR TO DEEP TILL ALL COMPACTED PERVIOUS SURFACES PRIOR TO SODDING OR SEEDING AND MULCHING. THIS MUST BE VERIFIED BY THE ENGINEER AS PART OF THE AS-BUILT CERTIFICATION.
- 6. THE CONTRACTOR SHALL NOTIFY THE CITY OF MADISON A MINIMUM OF TWO (2) WORKING DAYS IN ADVANCE OF ANY SOIL DISTURBING ACTIVITY.

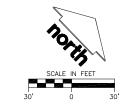

TO OBTAIN LOCATIONS OF PARTICIPANT UNDERGROUND FACULTIES BEFORE YOU DIG IN WISCONSIN



CALL DIGGERS HOTLINE
1-800-242-8511 TOLL FREE
WESCONSIN STATUTE MR. DI 78/1074) REDURES MANAGAM
THREE (J) WORK DAYS HOTICE BEFORE YOU ENCAVAIRE



GORMAN G COMPANY, INC.

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> 200 N. MAIN STREET OREGON, WI 53575

JSD Professional Serviças, Inc.

MADISON REGIONAL OFFICE 161 HORIZON DRIVE, SUITE 101 VERONA, WISCONSIN 53593 608.848.5060 PHONE

■ 608.848.2255 FAX

www.jsdinc.com

SPECIFIC PLAN COMPANY **IMPLEMENTATION UNION CORNERS** Ø ORMAN

Project No. Plot Date: JFL, MG, KJY Drawn by:


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Date Issue Description GDP 06-25-14 11-05-14 UDC/PC 1-14-15 RESUBMITTAL UDC FINAL 05-27-15

Sheet Title

GRADING AND EROSION CONTROL PLAN

Sheet No.

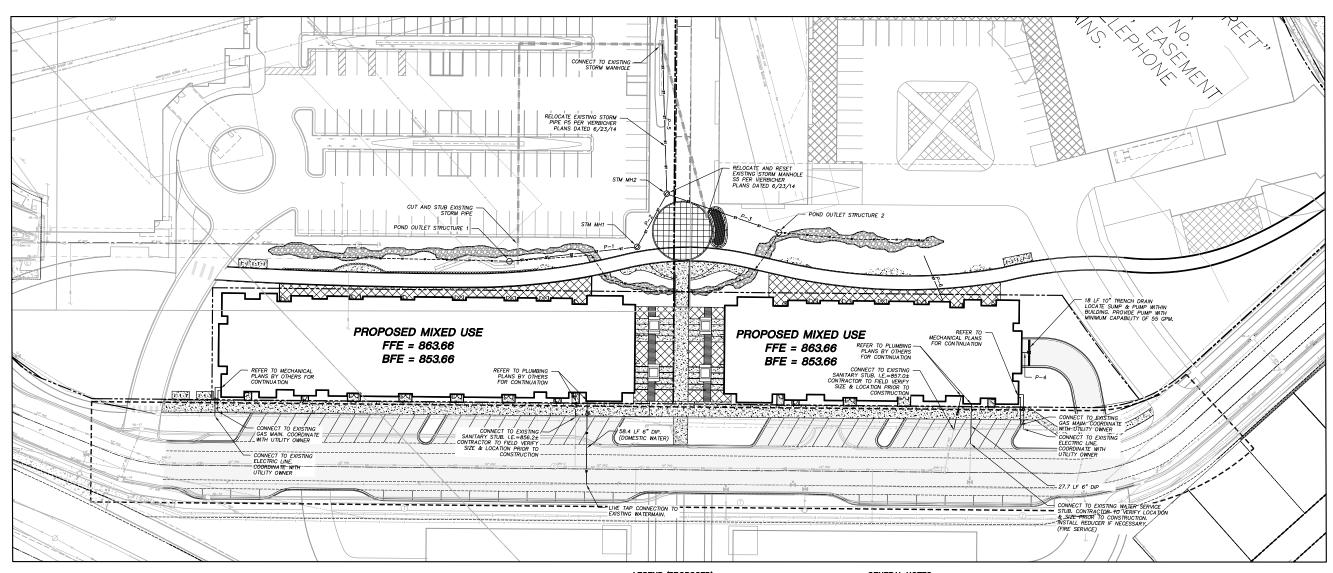

PROPOSED STORM SEWER STRUCTURES SCHEDULE					
LABEL	INVERT ELEV. (FT)	RIM ELEV. (FT)	DEPTH (FT)	STRUCTURE DESCRIPTION	GRATE
POND OUTLET STRUCTURE 1	855.45	860.00	4.55	36° DIA. CONCRETE INLET	TYPE C GRATE
STM MH1	854.92	862.50	7.58	36° DIA. CONCRETE INLET	TYPE C GRATE
POND OUTLET STRUCTURE 2	854.92	860.00	5.08	2X3'PRECAST BOX	TYPE C GRATE
STM MH2	855.35	862.50	6.07	36" DIA. CONCRETE INLET	TYPE C GRATE
TRENCH DRAIN	851.91	853.51	1.02	10° CONCRETE TRENCH DRAIN	R-4990-CX, TYPE C COVER

PIPE LABEL	FROM	то	LENGTH (FT)	INVERT ELEVATION (FT)	DISCHARGE ELEVATION (FT)	SLOPE (%)	PIPE SIZE & TYPE
P-1	POND OUTLET STRUCTURE 1	STM MH1	90	856.34	855.45	1.00%	12"HDPE
P-2	STM MH1	STM MH2	43	855.35	854.92	1.00%	12"HDPE
P-3	POND OUTLET STRUCTURE 2	STM MH2	83	855.33	854.92	0.50%	12"HDPE
P-4	TRENCH DRAIN	BUILDING	20.00	851.91	851.71	1.00%	6°PVC
P-5	STM MH2	EX STM MH	104.25	854.82	854.30	0.50%	18*RCP
P.6	BUILDING	BIORETENTION POND	34.43	960.34	960.00	1.00%	6°PVC

LEGEND (PROPOSED)

ASPHALTIC PAVEMENT CONCRETE PAVEMENT	UTILITY NOTES
TRENCH PATCH LIMITS	DRAWING FOR REVIEW — NOT FOR CONSTRUCTION UNLESS OTHERWISE NOTED IN THE TITLE BLOCK.
	ITILITY) RESULT IN DISCIPLINARY ACTIONS BY ANY OR ALL REGULATORY AGENCIES.
	4. JSD SHALL BE HELD HARMLESS AND DOES NOT WARRANT ANY DEVIATIONS BY THE OWNER/CONTRACTOR FROM THE APPROVED CONSTRUCTION F RESULT IN DISCIPLINARY ACTIONS BY ANY OR ALL REGULATORY AGENCIES.
─₩───₩ WATER MAIN	3. ALL WORK IN THE ROW SHALL BE IN ACCORDANCE WITH THE CITY OF MADISON STANDARD SPECIFICATIONS FOR PUBLIC WORKS CONSTRUCTION.
	EXISTING CONDITIONS SURVEY DATED 11-18-2013. ANY DISCREPANCIES TO BE REPORTED TO JSD IMMEDIATELY UPON DISCOVERY.
st STORM SEWER	
	 REFER TO THE TOPOGRAPHIC AND UTILITY SURVEY FOR EXISTING CONDITIONS NOTES AND LEGEND.

JSD SHALL BE HELD HARMLESS AND DOES NOT WARRANT ANY DEVIATIONS BY THE OWNER/CONTRACTOR FROM THE APPROVED CONSTRUCTION PLANS THAT MAY RESULT IN DISCIPLINARY ACTIONS BY ANY OR ALL REGULATORY AGENCIES. 5. DRAWING FOR REVIEW - NOT FOR CONSTRUCTION UNLESS OTHERWISE NOTED IN THE TITLE BLOCK.

DIMENSIONS TAKE PRECEDENCE OVER SCALE. CONTRACTOR TO VERIFY ALL DIMENSIONS IN FIELD.

- 2. IF ANY ERRORS, DISCREPANCIES, OR OMISSIONS WITHIN THE PLAN BECOME APPARENT, IT SHALL BE BROUGHT TO THE ATTENTION OF THE ENGINEER PRIOR TO CONSTRUCTION SO THAT CLARIFICATION OR REDESION MAY OCCUR.
- 3. LENGTHS OF ALL UTILITIES ARE TO CENTER OF STRUCTURES OR FITTINGS AND MAY VARY SLIGHTLY FROM PLAN. LENGTHS SHALL BE VERIFIED IN THE FIELD DURING CONSTRUCTION.
- 4. ALL CONSTRUCTION SIGNING TO BE IN ACCORDANCE WITH THE CITY OF MADISON AND WISCONSIN DEPARTMENT OF TRANSPORTATION REQUIREMENTS.
- 5. THE CONTRACTOR SHALL INSTALL A PEDESTRIAN FENCE AROUND ALL EXCAVATIONS TO BE LEFT OPEN OVER NIGHT AS REQUIRED.
- 6. THE PROPOSED IMPROVEMENTS MUST BE CONSTRUCTED IN ACCORDANCE WITH ENGINEERING PLANS DESIGNED TO MEET ORDINANCES AND REQUIREMENTS OF THE MUNICIPALITY AND WISDOT, WIDCOMM, AND WIDNR.
- 7. PRIOR TO CONSTRUCTION. THE CONTRACTOR IS RESPONSIBLE FOR:

 * EXAMINING ALL SITE CONDITIONS RELATIVE TO THE CONDITIONS INDICATED ON THE ENGINEERING DRAWINGS. ANY DISCREPANCIES ARE TO BE REPORTED TO THE ENGINEER AND RESOLVED PRIOR TO THE START OF CONSTRUCTION.

 * OBTAINING ALL PERMITS INCLUDING PERMIT COSTS, TAP FEES, METER DEPOSITS, BONDS, AND ALL OTHER FEES REQUIRED FOR PROPOSED WORK TO OBTAIN OCCUPANCY.

 * VERIFYING UTILITY ELEVATIONS AND NOTIFYING ENGINEER OF ANY DISCREPANCY. NO WORK SHALL BE PERFORMED UNTIL THE DISCREPANCY IS RESOLVED.

 * NOTIFYING ALL UTILITIES PRIOR TO THE INSTALLATION OF ANY UNDERGROUND IMPROVEMENTS.

 * NOTIFYING ALL UTILITIES PRIOR TO THE INSTALLATION OF ANY UNDERGROUND IMPROVEMENTS.

 * OBSERVATION.
- 8. THE CONTRACTOR IS RESPONSIBLE FOR PROVIDING THE ENGINEER WITH AS-BUILT CONDITIONS OF THE DESIGNATED IMPROVEMENTS IN ORDER THAT THE APPROPRIATE DRAWINGS CAN BE PREPARED, IF REQUIRED. ANY CHANGES TO THE DRAWINGS OR ADDITIONAL HEMS MUST BE REPORTED TO THE ENGINEER AS WORK PROCRESSES.
- 9. THE PRIME CONTRACTOR IS RESPONSIBLE FOR COORDINATING ALL CONSTRUCTION WITH OTHER CONTRACTORS INVOLVED WITH CONSTRUCTION OF THE PROPOSED DEVELOPMENT AND FOR REPORTING ANY ERRORS OR DISCREPANCIES BETWEEN THESE PLANS AND PLANS PREPARED BY OTHERS.
- 11. CONTRACTOR IS RESPONSIBLE FOR SITE SAFETY DURING THE CONSTRUCTION OF IMPROVEMENTS.
- 12. CONTRACTOR SHALL NOTIFY THE CITY OF MADISON PUBLIC WORKS DEPARTMENT A MINIMUM OF 48 HOURS BEFORE CONNECTING TO PUBLIC UTILITIES.
- 13. ALL PRIVATE STORM BUILDING PIPE AND TUBING SHALL CONFORM TO S&B 384.30, TABLE 384.30-6.
- 14. WATER SERVICE SHALL BE MAINTAINED AT ALL TIMES DURING CONSTRUCTION. CONTRACTOR TO FIELD VERIFY LOCATION AND SIZE. REPORT DISCREPANCIES TO ENGINEER PRIOR TO CONSTRUCTION. CONSTRUCTION TO BE IN ACCORDANCE WITH THE CITY OF MADISON STANDARD SPECIFICATIONS FOR PUBLIC WORKS CONSTRUCTION PART VI. CONTACT CITY OF MADISON DEPARTMENT OF PUBLIC WORKS 48 HOURS PRIOR TO CONSTRUCTION.
- 15. ALL WORK WITHIN THE RIGHT-OF-WAY SHALL BE INSTALLED PER CITY OF MADISON STANDARD SPECIFICATIONS FOR PUBLIC WORKS CONSTRUCTION. PRE-CONSTRUCTION MEETING WITH THE CITY OF MADISON IS REQUIRED PRIOR TO INSTALLATION.
- 16. THE CONTRACTOR SHALL DETERMINE LOCATION, DEPTH AND SIZE OF EXISTING SANITARY AND WATER SERVICES AND NOTIFY ENGINEER PRIOR TO CONSTRUCTION.



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■ 608.848.2255 FAX

www.jsdinc.com

SPECIFIC PLAN COMPANY

IMPLEMENTATION UNION CORNERS Ø GORMAN

Project No.	14-653
Plot Date:	
Drawn by:	JLF, MG, KJY
Date	Issue Description
GDP	06-25-14
SIP	11-05-14
LIDC/PC	1-14-15

05-27-15

Sheet Title

RESUBMITTAL

UDC FINAL

UTILITY PLAN


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C400



CALL DIGGERS HOTLINE 1-800-242-8511 TOLL FREE MISCONSIN STATE STATUTE 182.0176(1974) REGURES MINIMA THREE (3) MORK DAYS NOTICE BEFORE YOU EXCAVATE



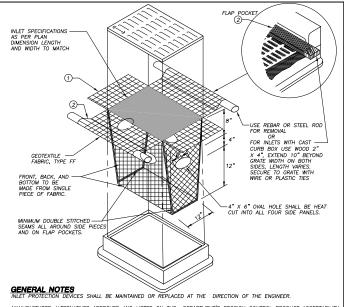

MANUFACTURED ALTERNATIVES APPROVED AND LISTED ON THE DEPARTMENT'S EROSION CONTROL PRODUCT ACCEPTABILITY LIST MAY BE SUBSTITUTED.

WHEN REMOVING OR MAINTAINING INLET PROTECTION, CARE SHALL BE TAKEN SO THAT THE SEDMENT TRAPPED ON THE GEOTEXTILE FABRIC DOES NOT FALL INTO THE INLET. ANY MARERIAL FALLING INTO THE INLET SHALL BE REMOVED IMMEDIATELY.


FINISHED SIZE, INCLUDING FLAP POCKETS WHERE REQUIRED, SHALL EXTEND A MINIMUM OF 10" AROUND THE PERIMETER
TO FACILITATE MAINTENANCE OR REMOVAL.


② FLAP POCKETS SHALL BE LARGE ENOUGH TO ACCEPT WOOD 2X4.


INSTALLATION NOTES
DO NOT INSTALL INLET PROTECTION TYPE D IN INLETS SHALLOWER THAN 30", MEASURED FROM THE BOTTOM OF THE
INLET TO THE TOP OF THE GRATE.


THE INSTALLED BAG SHALL HAVE A MINIMUM SIDE CLEARANCE, BETWEEN THE INLET WALLS AND THE BAG, MEASURED AT THE BOTTOM OF THE OVERFLOW HOLES, OF 3". WHERE NECESSARY THE CONTRACTOR SHALL CINCH THE BAG, USING PLASTIC ZIP TIES, TO ACHIEVE THE 3" CLEARANCE. THE TIES SHALL BE PLACED AT A MAXIMUM OF 4" FROM THE BOTTOM OF THE BAG.



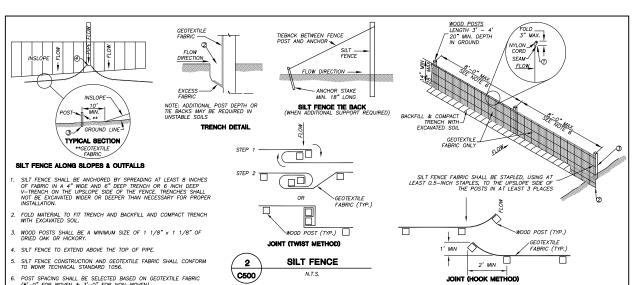

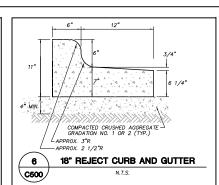

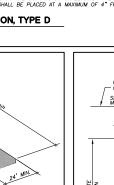

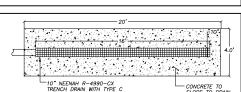


12" min. 1

CONSTRUCTION ENTRANCE


NOTE: CONTRACTOR TO VERIFY LOCATION WITH OWNER

C500

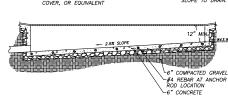

**REFER TO NEENAH FORMING PROCEDURES FOR INSTALLING NEENAH DRAINAGE STRUCTURES FOR FURTHER DETAILS AND INFORMATION.
NOTE: INSTALL CATCH-ALL HR-I ABSORBENT BOOM BY MARATHON MATERIALS, INC. WITHIN TENEVICH DRAIN.



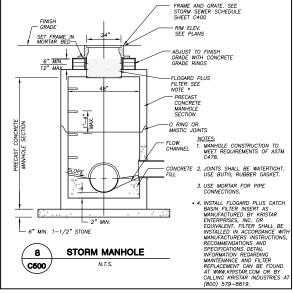


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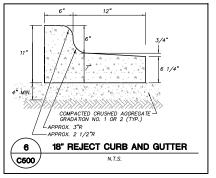
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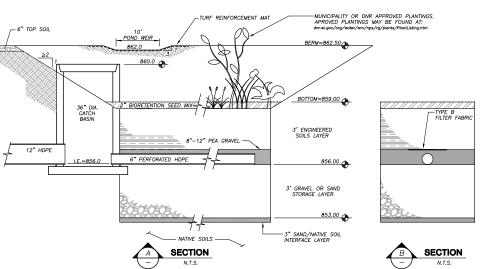
3/4"

-APPROX. 2 1/2"R

18" STANDARD CURB AND GUTTER





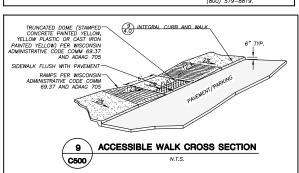

10' TYP. CONCRETE SIDEWALK

2% CROSS SLOPE

└ 4" MIN. CRUSHED AGGREGATE BASE COURSE

FLAT FACE SIDEWALK CROSS SECTION

REFER TO SITE PLAN FOR CONSTRUCTION AND CONTROL JOINT LOCATIONS

PITCH SURGRADE TO DE

GENERAL NOTES:

ALL CONSTRUCTION PRACTICES SHALL MEET THE SPECIFICATIONS OF THE WIDNR TECHNICAL STANDARD 1004 — BIORETENTION FOR INFILTRATION. IT IS THE CONTRACTOR'S RESPONSIBILITY TO OBTAIN A COPY OF THIS STANDARD AND CONSTRUCT THE BIORETENTION DEVICE IN ACCORDANCE WITH THE REQUIREMENTS OUTLINED THEREIN.

- CONTRACTOR SHALL INSTALL 36" OF ENGINEERED SOIL CONSISTING OF: 40% ASTM C33 SAND, 30% CERTIFIED COMPOST (SEE GENERAL NOTE 3), AND 30% TOPSOIL.
- 3. CERTIFIED COMPOST SHALL CONSIST OF: >40% ORGANIC MATTER, <60% ASH CONTENT, pH OF 6-8, AND MOISTURE CONTENT OF 35-50% BY WEIGHT.
- SAND/NATIVE SOIL INFILTRATION LAYER SHALL BE FORMED BY A LAYER OF SAND 3 INCHES DEEP, WHICH IS VERTICALLY MIXED WITH THE NATIVE SOIL TO A DEPTH OF 2-4 INCHES.
- FILTER FABRIC SHALL BE PLACED ABOVE THE PERFORATED PIPE, BETWEEN THE PEA GRAVEL AND THE ENGINEERED SOIL, A WIDTH OF 4 FEET CENTERED OVER THE FLOW LINE OF THE PIPE.
- ANNUAL RYE GRASS SHALL BE SEEDED AT 40 LB/ACRE WITH THE SEED MIX IN THE AREAS SURROUNDING THE BASIN, ON SIDE SLOPES, AND OVER ANY LAND THAT DISCHARGES NITO THE BASIN FOR EROSION CONTROL WHEN BASIN IS BROUGHT ON—LINE. ROOTSTOP AND PLUGS ARE REQUIRED TO ESTABLISH VEGETATION AT THE INVERT OF THE BASIN.
- RUNOFF MUST INFILTRATE WITHIN 48-HOURS. BASINS UNABLE TO MAINTAIN THESE RATES MUST BE DEEP TILLED, REGRADED, AND IF NECESSARY REPLANTED TO RESTORE ORIGINAL INFILTRATION RATES.
- ALL WORK TO BE CONDUCTED IN CONFORMANCE WITH APPLICABLE LOCAL, REGIONAL, AND STATE STORMWATER STANDARDS FOR THE PROJECT SITE AS APPROVED BY THE REGULATORY ENGINEER.
- 9. OWNER OR CONTRACTOR MUST CONSULT LANDSCAPE ARCHITECT OR ECOLOGICAL PLANTING AGENCY FOR APPROPRIATE PLANTS AND PLANTING CONFIGUI
- 10. BIORETENTION DEVICE SHALL NOT BE INSTALLED UNTIL THE SITE IS STABILIZED.
- 11. FILTER FABRIC SHALL COVER THE UNDERDRAIN AND SHALL NOT EXTEND LATERALLY FROM FITHER SIDE OF THE PIPE MORE THAN TWO FFET.
- 12. ONCE CONSTRUCTION OF BIORETENTION DEVICE BEGINS, THE BIORETENTION DEVICE SHALL BE CORDONED OFF AND PROTECTED FROM COMPACTION FROM HEAVY EQUIPMENT.
- 13. ENGINEERED SOIL SHALL BE PLACED IN 12 INCH LIFTS TO AVOID COMPACTION.
- 15. PLACEMENT OF ENGINEERED SOILS SHALL BE SUSPENDED IN PERIODS OF RAINFALL AND SNOWMELT AND SHALL REMAIN SUSPENDED IN PONDED WATER IS

INFILTRATION DEVICES ARE DESIGNED IN ACCORDANCE WITH THE SPECIFICATIONS OF THE WISCONSIN DEPARTMENT OF NATURAL RESOURCES (WDNR), COUNTY, MUNICIPALITY, AND ENGINEERING STANDARD OF CARE. ALL DESIGNATED INFILTRATION AREAS (e.g., RAIN GARDENS, INFILTRATION BASINS, BIORETENTION DEVICES) SHALL BE FEWED PRIOR TO CONSTRUCTION AND REMAIN UNIDISTURBED AND PROTECTED DURING THE CONSTRUCTION OF PROPOVEMENTS. PROPOSED BIORETENTION DEVICES SHALL NOT BE CONSTRUCTED LINTIL THE DEVICE'S CONTRIBUTION WATERSHED AREA MEETS ESTABLISHED VEGETATION REQUIREMENTS SET FORTH WITHIN THE RESPECTIVE WOMN TECHNICAL STANDARDS. IF THE LOCATION OF THE INFILIRATION AREA CONFLICTS WITH CONSTRUCTION STAGING AND/OR CONSTRUCTION TRAFFIC AND IS DISTURBED, COMPACTION WITIGATION WILL BE REQUIRED AT THE CONTRACTOR'S EXPENSE.

THE CONTRACTOR IS REQUIRED TO PROVIDE QUALIFIED STAFF FOR INSPECTION AND OBSERVATION OF THE CONSTRUCTION ACTIVITIES RELATING TO ALL JOB SITE REGULATORY COMPLIANCE INCLUDING THE PROTECTION AND CONSTRUCTION OF ALL STORMWATER MANAGEMENT FEATURES. ANY OBSERVATION OF PLAN OR SITE DISCREPANCES SHALL BE REPORTED TO THE EMPIREY OF RECORD PRIOR TO CONSTRUCTION.



CORMAN

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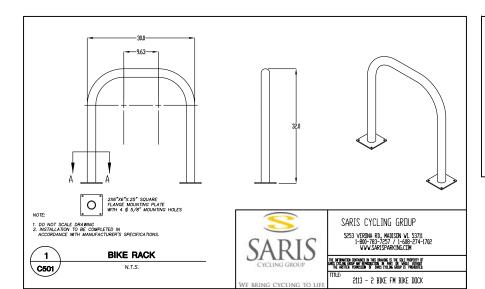
COMPANY SPI **IMPLEMENTATION CORNERS** Ø GORMAN UNION


Project No.	14-653
Plot Date:	
Drawn by:	JLF, MG, KJY
Date	Issue Description
GDP	06-25-14
SIP	11-05-14
UDC/PC	1-14-15
RESUBMITTAL	05-27-15


Sheet Title

Sheet No.

DETAILS



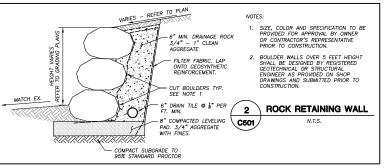

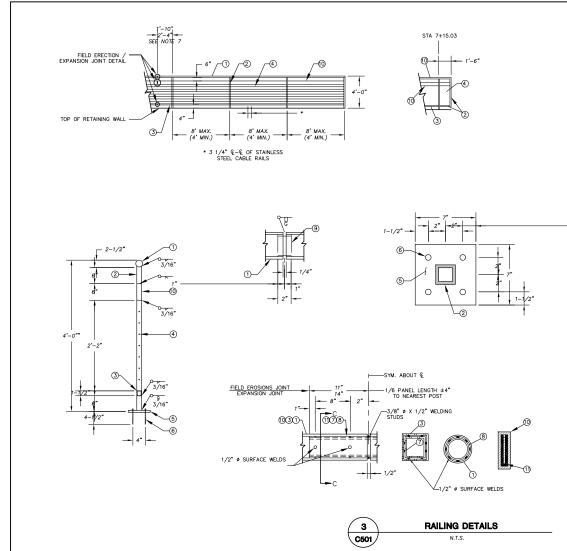

LEGEND

- 1 2-1/2" DIA. STEEL PIPE CONFORMING TO SECTION 506 OF THE WDOT STANDARD SPECIFICATIONS.
- 2) TS 2"X2"X0.188" STRUCTURAL TUBING CONFORMING TO ASTM DESIGNATION A501 OR A500 GRADE B. CUT BOTTOM OF POST TO MATCH SLOPE OF TOP OF WALL. HOLD 1/16" ABOVE BASE PLATE TO ALLOW POST AND BASE PLATE TO BE WELDED TOSETHER. PLACE POST VERTICAL AND CENTERED ON THE BASE PLATE.
- (3) TS 1-1/2" X 1-1/2" X 0.188" STRUCTURAL TUBING CONFORMING TO ASTM DESIGNATION A501 OR A500 GRADE B.
- 4 %" DIA. STAINLESS STEEL CABLE. TO BE PROVIDED NO MORE THAN 3 1/4" ON CENTER.
- 6 CONCRETE MASONRY ANCHORS, TYPE S. 5/8". PULLOUT STRENGTH SHALL BE 3.6 KIPS.
- O SQUARE SLEEVE FABRICATED FROM 1/2" COLD DRAWN STEEL ALLOY SQUARE CONFORMING TO ASTM A33

 1 X 2"-4" LONG AT EXPANSION JOINTS AND 1-10" LONG AT FIELD JOINTS, PROVIDE 1/2" DIA, SURFACE
 WELDS ON ALL SIDES AS SHOWN, GRIND WELDS TO BIT FREE INTO LO F NO. 3. PROVIDE 3/8" DIA. X
 1/2" WELDING STUDS ON TOP AND BOTTOMS SURFACES AT CENTERLINE.
- (8) 1-1/2" DIA. STEEL PIPE CONFORMING TO SECTION 506 OF THE STANDARD SPECIFICATIONS X 2'-4" LONG AT EXPANSION JOINTS AND 1'-10" LONG AT FIELD JOINTS. PROVIDE 1/2" DIA. SURFACE WELDS ON ALL SIDES AS SHOWN, GRIND WELDS TO FIT FREE INTO I.O. OF NO. 1. PROVIDE 3/8" DIA. X 1/2" WELDING STUDS ON TOP AND BOTTOMS SURFACES AT CENTERLINE.
- 2" DIA. PIPE SLEEVE CONFORMING TO SECTION 506 OF THE WDOT STANDARD SPECIFICATIONS. PROVIDE
 1-1/2"
 1-1/2"
- 10 TS 6" X 2" X 0.188" STRUCTURAL TUBING CONFORMING TO ASTM DESIGNATION A501 OR A500 GRADE B.
- 1 x 5" sleeve conforming to astm designation a709 grade 36 x 2"-4" long at expansion Joints or 1"x10" Long at field Joints, Provide 1/2" dia. Surface welds on all sides as shown. Grind welds to fit free into I.D. of No. 10. Provide 3/8" dia. x 1/2" welding studs on top and bottom surfaces at centerline.

GENERAL NOTES

BID ITEM SHALL BE "RAILING STEEL" WHICH INCLUDES ALL ITEMS SHOWN INCLUDING GALVANIZED COATING. RAILING SHALL BE FABRICATED IN 2 OR 3 PANEL LENGTHS.

POST BASE PLATES NO. 5 SHALL BE FLAT WITH ALL SURFACES SMOOTH AND FREE FROM WARP AND ALL EDGES SMOOTH, STRAIGHT AND VERTICAL. ALL PLATE CUTS SHALL BE MACHINE OR MACHINE FLAME CUT.

ALL MATERIALS EXCEPT ANCHOR BOLTS NO. 6 SHALL BE GALVANIZED AFTER FABRICATION.

PRIOR TO GALVANIZING, ALL STEEL RAILING POSTS, STEEL TUBING, AND STEEL PIPE SHALL BE GIVEN A NO. 6 BLAST CLEANING PER S.S.P.C. SPECIFICATIONS.

VERTICAL MEMBERS SHALL BE PLUMB.

HORIZONTAL MEMBERS SHALL PARALLEL GRADE.

RAILINGS LOCATED BEHIND WALLS SHALL HAVE DRIVEN POSTS A MINIMUM OF 4' INTO THE GROUND.

DAGConfrigue(ACFiledon - Iron Coron/ADOMAL-B-Confilent-logy-Millory

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Seal

Consultant



GORMAN & COMPANY UNION CORNERS SPECIFIC IMPLEMENTATION PLAN MADISON, WI


Project No.	XXX-000-XXX-0000
Plot Date:	YYYY/MM/DD 0:00 AM
Drawn by:	XXX


Date	Issue Descripti
GDP	06-25-14
SIP	11-05-14
UDC/PC	1-14-15
RESUBMITTAL	
UDC FINAL	05-27-15

Sheet Title

DETAILS

Sheet No.

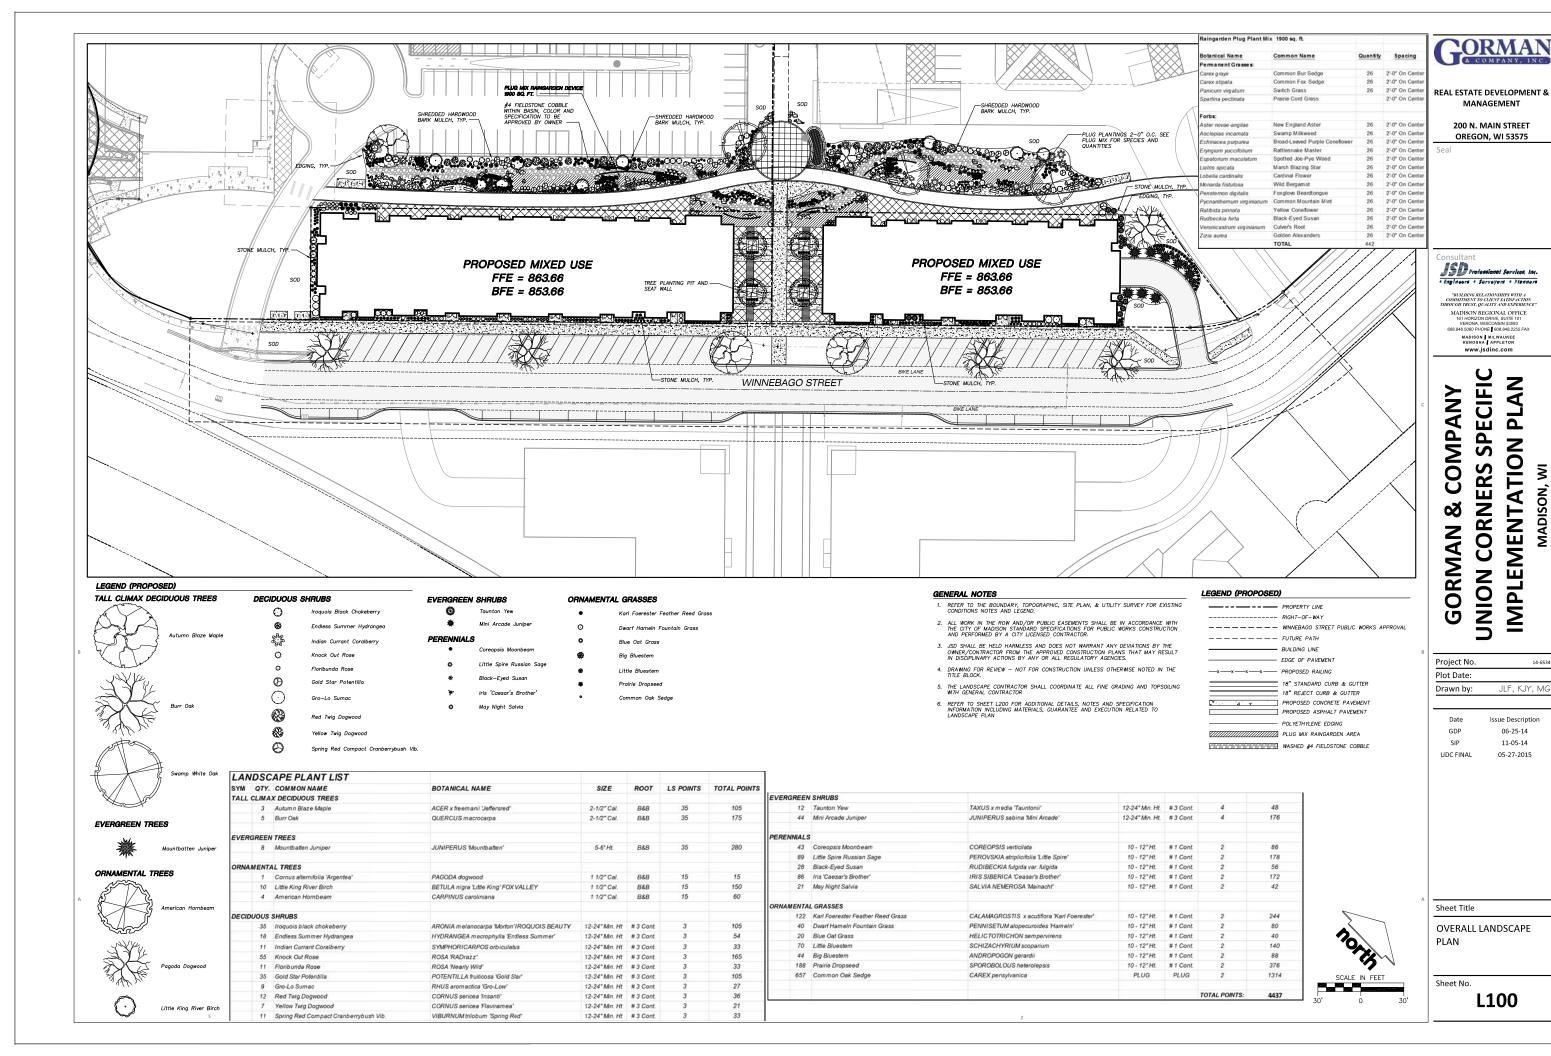

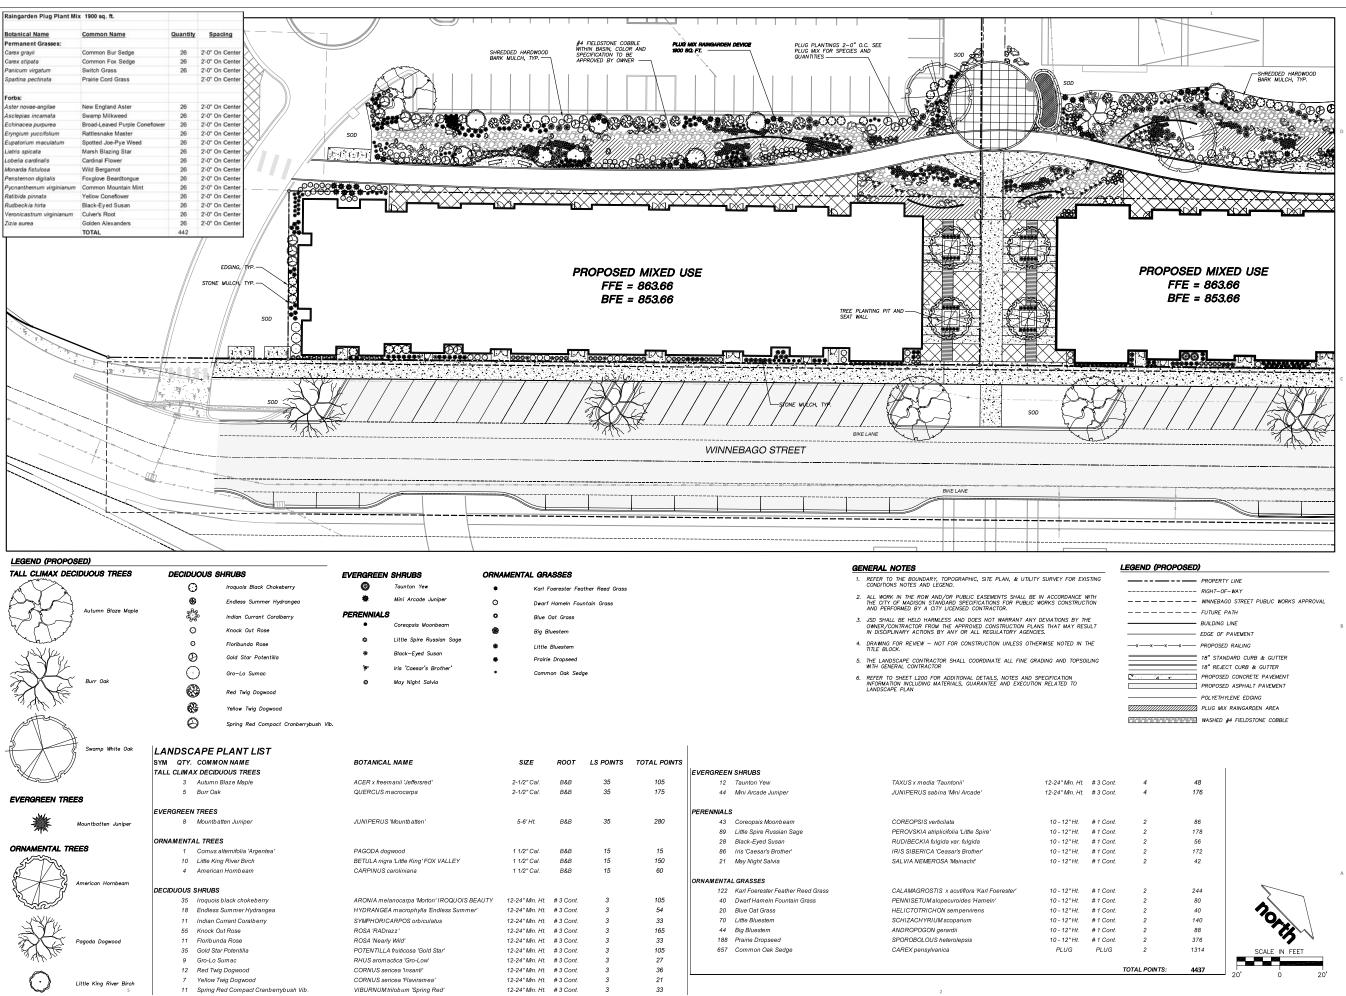

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.Onsultant **ISD** Professional Services, Inc.

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GORMAN & COMPANY UNION CORNERS SPECIFIC IMPLEMENTATION PLAN

Project No.	14-6534
Plot Date:	
Drawn by:	JLF, KJY, MG

 Date
 Issue Description

 GDP
 06-25-14

 SIP
 11-05-14


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 05-27-2015


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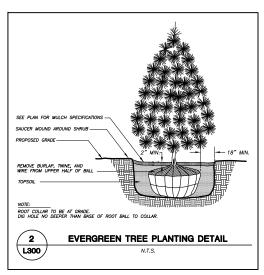
BUILDING 4 LANDSCAPE PLAN


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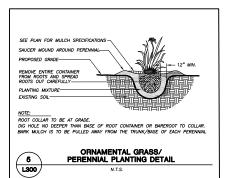
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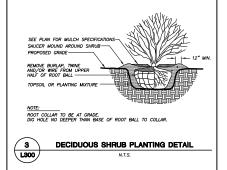






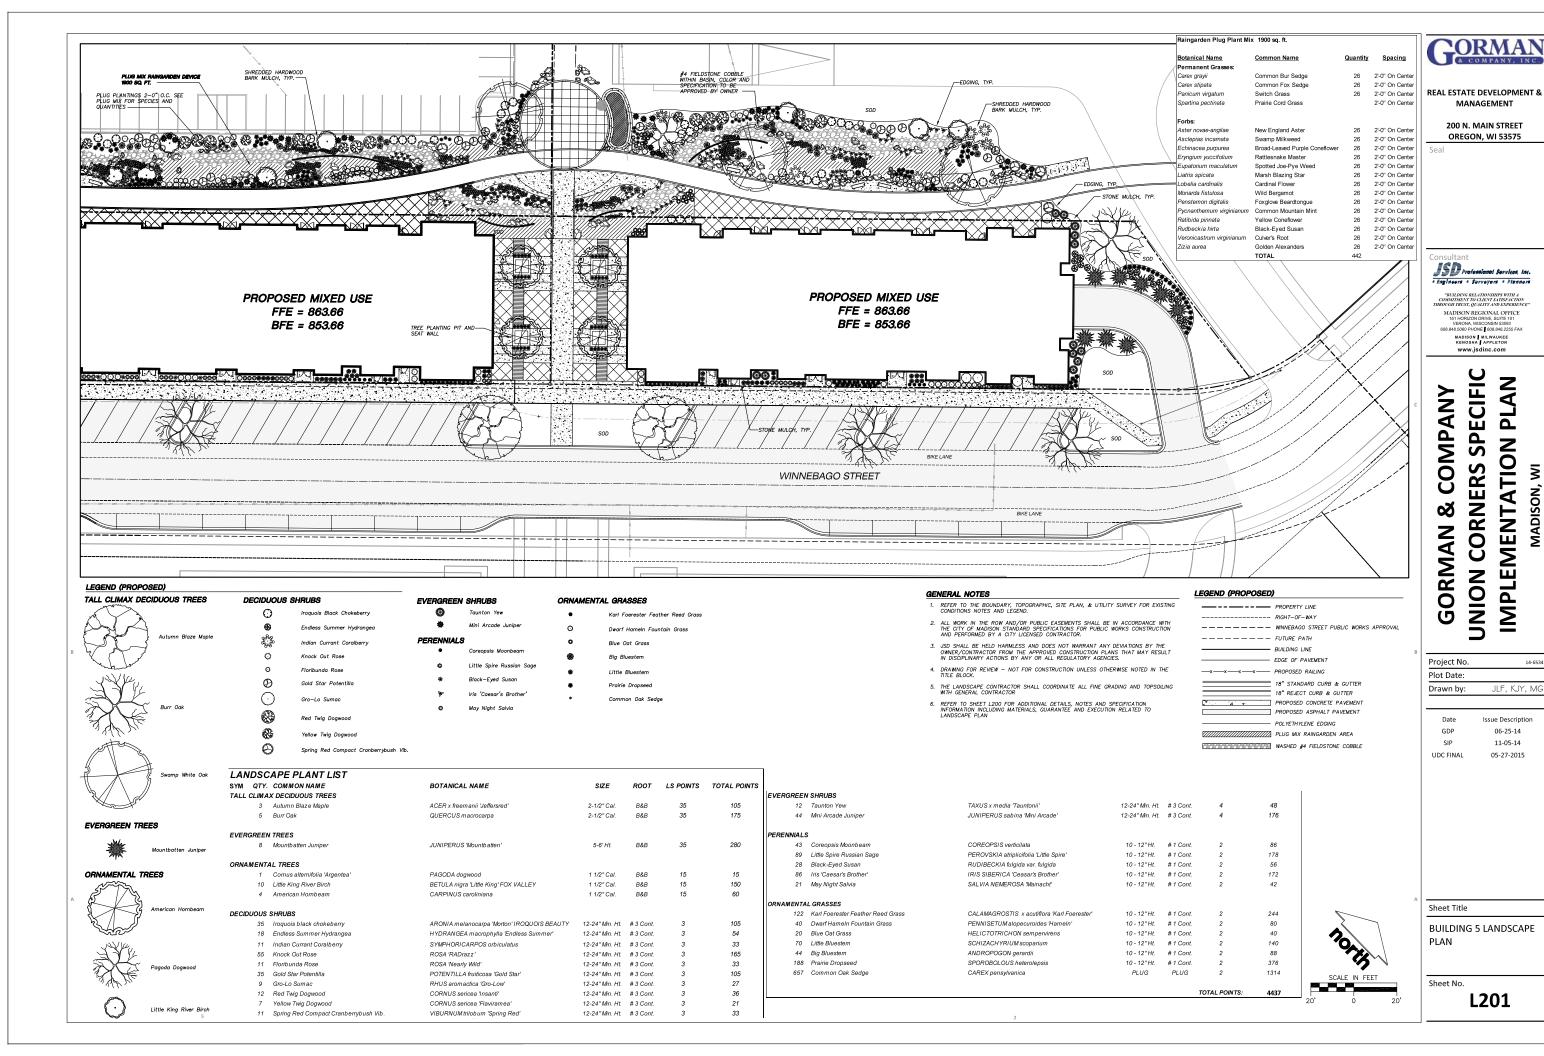

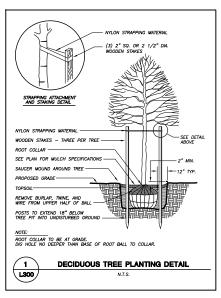

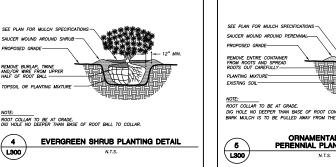

SYM	QTY.	COMMON NAME	BOTANICAL NAME	SIZE	ROOT	LS POINTS	TOTAL POINTS
ORNA	MENT	AL TREES					
	4	American Hornbeam	CARPINUS caroliniana	1 1/2* Cal.	B&B	15	60
DECID	uous	SHRUBS					
	6	Endless Summer Hydrangea	HYDRANGEA macrophylla 'Endless Summer'	12-24" Mn. Ht.	#3 Cont.	3	18
	9	Gro-Lo Sumac	RHUS aromactica 'Gro-Low'	12-24" Min. Ht.	#3 Cont	3	27
	29	Knock Out Rose	ROSA RADrazz'	12-24" Mn. Ht.	#3 Cont.	3	87
	10	Iroquois black chokeberry	ARONIA melanocarpa "Morton" IROQUOIS BEAUTY	12-24" Mn. Ht.	#3 Cont	3	30
	4	Spring Red Compact Cranberrybush Vib.	VIBURNUM trilob um 'Spring Red'	12-24" Mn. Ht.	#3 Cont.	3	12
	2	Gold Star Potentilla	POTENTILLA fruiticosa 'Gold Star'	12-24" Min. Ht.	#3 Cont	3	6
EVER	GREEN	SHRUBS					
	12	Taunton Yew	TAXUS x media 'Tauntonii'	12-24" Mn. Ht.	#3 Cont.	4	48
	4	Mini Arcade Juniper	JUNIPERUS sabina 'Mini Arcade'	12-24" Min. Ht.	#3 Cont.	4	16
PERE	NNIALS						
	39	Little Spire Russian Sage	PEROVSKIA atriplicifolia 'Little Spire'	10 - 12" Ht.	# 1 Cont.	2	78
	10	Black-Eyed Susan	RUDIBECKIA fulgida var. fulgida	10 - 12" Ht.	# 1 Cont.	2	20
	18	Coreopsis Moonbeam	COREOPSIS verticilata	10 - 12° Ht.	#1 Cont.	2	36
	2	Iris 'Caesar's Brother'	IRIS SIBERICA 'Ceasar's Brother'	10 - 12*Ht.	# 1 Cont.	2	4
	3	May Night Salvia	SALVIA NEMEROSA Mainacht	10 - 12*Ht	# 1 Cont.	2	6
ORNA	MENTA	L GRASSES					
	84	Karl Foerester Feather Reed Grass	CALAMAGROSTIS x acutiflora 'Karl Foerester'	10 - 12*Ht.	# 1 Cont.	2	168
	6	Blue Oat Grass	HELICTOTRICHON sempervirens	10 - 12*Ht	# 1 Cont.	2	12
	40	Little Bluestern	SCHIZACHYRIUM scoparium	10 - 12" Ht.	# 1 Cont.	2	80
	61	Prairie Dropseed	SPOROBOLOUS heterolepsis	10 - 12° Ht.	# 1 Cont.	2	122
	11	Dwarf Hameln Fountain Grass	PENNISETUM alopecuroides 'Harneln'	10 - 12*Ht.	# 1 Cont.	2	22
	12	Common Oak Sedge	CAREX pensylvanica	PLUG	PLUG	2	24
						TOTAL POINTS:	816

LANDSCAPE NOTES AND SPECIFICATIONS

- GENERAL: ALL WORK IN THE R-O-W AND PUBLIC EASEMENTS SHALL BE IN ACCORDANCE WITH THE CITY OF MADISON REQUIREMENTS. JSD SHALL BE HELD HARMLESS AND DOES NOT WARRANT ANY DEVIATIONS BY THE OWNER/CONTRACTOR FROM THE APPROVED CONSTRUCTION. THE CONTRACTOR IS RESPONSIBLE FOR REPAIRING ANY DAMAGE DONE TO UTILITIES. CONTRACTOR MUST CALL 1-800-382-5544 FOR UTILITY LOCATIONS AT LEAST THREE DAYS PRIOR TO DIGGING. HAND DIG AND INSTALL ALL PLANTS THAT ARE REAR EXISTING UTILITIES. PROTECT PREVIOUSLY INSTALLED WORK OF OTHER TRADES. CONTRACTOR IS RESPONSIBLE FOR STAKING THE PLANT MATERIALS FOR REVIEW BY OWNER PRIOR TO DIGGING AND PLACEMENT. THE LANDSCAPE CONTRACTOR SHALL COORDINATE ALL FINE ORGAING AND RESTORATION WITH THE GRADING CONTRACTOR.
- DELIVERY AND HANDLING: DO NOT DELIVER WORE PLANT MATERIALS THAN CAN BE PLANTED IN ONE DAY. DELIVER PLANTS WITH LEGIBLE IDENTIFICATION LABELS. PROTECT PLANTS DURING DELIVERY AND DO NOT PRUNE PRIOR TO DELIVERY. ALL TREES AND SHRUBS SHALL BE PLANTED ON THE DAY OF DELIVERY; IF THIS IS NOT POSSIBLE, PROTECT THAT STOCK NOT PLANTED BY STORING STOCK IN A SHADED AREA PROTECTING. THE ROOT MASS WITH WET SOIL, MOSS OR OTHER SUITABLE MEDIA AND KEEPING WELL WATERED. DO NOT REMOVE CONTAINER GROWN STOCK FROM CONTAINERS BEFORE THIS OF PLANTING, DO NOT PICK UP CONTAINER OR BALLED PLANTS BY STEM OR ROOTS. ALL PLANTS SHALL BE LIFTED AND HANDLED FROM THE BOTTOM OF THE BALL, PERFORM ACTUAL PLANTING ONLY WHEN WHEN WHATHER AND SOIL CONDITIONS ARE SUITABLE IN ACCORDANCE WITH LOCALLY ACCEPTED PRACTICES.
- 3. GUARANTEE: THE CONTRACTOR SHALL GUARANTEE ALL PLANTS THROUGH ONE (1) YEAR AFTER ACCEPTANCE BY OWNER. PLANTS SHALL BE ALIVE AND IN GOOD HEALTHY AND FLOURISHING CONDITION AT THE END OF THE GUARANTEE PERIOD. THE CONTRACTOR SHALL REPLACE
 WHOLL COST OF THE OWNER ANY PLANTS THAT ARE DEAD OR NOT IN A MIGOROUS THRIVING CONDITION. REPLACEMENT PLANTS SHALL BE OF THE SAME KIND AND SIZE AS ORIGINALLY SPECIFIED UNLESS OTHERWISE DIRECTED BY OWNER, RESTORE BEDS AS NECESSARY FOLLEW
 PLANT REPLACEMENT, INCLUDING BUT NOT LIMITED TO BEDDING, EDDING, MUCH, ETC. REPAIR CAMBAGE TO OTHER PLANTS OF PLANTING AREAS DURING PLANT REPLACEMENT AT NO COST TO OWNER. CONTRACTOR SHALL PROVIDE A TWO (2)-YEAR STRAIGHTENING GUARANTEE FOR
- 4. MATERIALS PLANTS: ALL PLANTS SHALL CONFORM TO THE AMERICAN STANDARD FOR NURSERY STOCK ANSI Z60.1-2004. PLANTS SHALL BE TRUE TO SPECIES AND VARIETY SPECIFIED AND NURSERY GROWN IN ACCORDANCE WITH GOOD HORTICULTURAL PRACTICES UNDER CLIMATIC MAINTENES — FLANTAS THALL CONTROMN IN ACCORDANCE WITH GOOD HORIFICITIAL PRACTICES UNDER CLIMATIC CONDITIONS SIMILAR TO THOSE IN THE LOCALITY OF THE PROJECT FOR AT LEAST 2 YEARS. PLANTS SHALL BE FRESHLY DUG (DURING THE MOST RECENT FAVORABLE HARVES FASSON). PLANTS SHALL BE SO TRAINED IN DEVELOPMENT AND APPEARANCE ST DE L'INQUESTIONABLY SUPERIOR IN FORM, COMPACTINESS, AND SYMMETRY. PLANTS SHALL BE SOUND, HEALTHY, WGOROUS, WELL BRANCHED AND DENSELY FOLIATED WHEN IN LEAF, AND FREE OF DISEASE AND INSECTS (ADULT EGGS, PUPAE OR LARVAE). THEY SHALL HAVE HEALTHY, WELL—DEVELOPED ACOT SYSTEMS AND SHALL BE FREE FROM PHYSICAL DAMAGE OR OTHER CONDITIONS THAT WOULD PREVENT THANWOUS ORDITH. PLANTS SHALL BE OF THE HIGHEST QUALITY, HAVE TYPICAL GROWTH HABITS FOR THEIR SPECIES, BE SOUND, HEALTHY, WGOROUS AND FREE OF INJURY. PARKWAY TREES AND PARKING LOT TREES SHALL HAVE A MINIMUM BRANCHING HEIGHT OF SIX (6) FEET ABOVE THE GROUND TO ALLOW ADCOUNTE VISUAL AND PHYSICAL CLEARANCE.
- 5. MATERIALS SOIL: PLANTING SOIL/COMPACTED TOPSOIL SHALL MEET THESE REQUIREMENTS: 1. PLANTING AREAS = 24° . TREE PITS = SEE DETAILS

PLANTING SOIL TO BE A MINIMUM 24" DEPTH, UNLESS OTHERWISE SPECIFIED AS ABOVE OR ON DETAILS. TOPSOIL TO BE CLEAN, FRIABILE LOAM FROM LOCAL SOURCE, FREE FROM STONES OR DEBRIS OVER 3/4" IN DIAMETER, AND FREE FROM TOXINS. TOPSOIL SOURCE, FREE FROM STONES OR DEBRIS OVER 3/4" IN DIAMETER, AND FREE FROM TOXINS. TOPSOIL SOURCE, FREE FROM STONES OR DEBRIS OVER 3/4" IN DIAMETER, AND FREE FROM TOXINS. TOPSOIL SOURCE, FREE FROM STONES OR DEBRIS OVER 3/4" IN DIAMETER, AND FREE FROM TOXINS. TOPSOIL SOURCE, FREE FROM STONES OR DEBRIS OVER 3/4" IN DIAMETER, AND FREE FROM TOXINS. TOPSOIL SOURCE, FREE FROM STONES OR DEBRIS OVER 3/4" IN DIAMETER, AND FREE FROM TOXINS. TOPSOIL SOURCE, FREE FROM STONES OR DEBRIS OVER 3/4" IN DIAMETER, AND FREE FROM TOXINS. TOPSOIL SOURCE, FREE FROM STONES OR DEBRIS OVER 3/4" IN DIAMETER, AND FREE FROM TOXINS. TOPSOIL SOURCE, FREE FROM STONES OR DEBRIS OVER 3/4" IN DIAMETER, AND FREE FROM TOXINS. TOPSOIL SOURCE, FREE FROM STONES OR DEBRIS OVER 3/4" IN DIAMETER, AND FREE FROM TOXINS. TOPSOIL SOURCE, FREE FROM STONES OR DEBRIS OVER 3/4" IN DIAMETER, AND FREE FROM TOXINS. TOPSOIL SOURCE, FREE FROM STONES OR DEBRIS OVER 3/4" IN DIAMETER, AND FREE FROM TOXINS. TOPSOIL SOURCE, FREE FROM STONES OR DEBRIS OVER 3/4" IN DIAMETER, AND FREE FROM TOXINS. TOPSOIL SOURCE, FREE FROM STONES OR DEBRIS OVER 3/4" IN DIAMETER, AND FREE FROM TOXINS. TOPSOIL SOURCE, FREE FROM TOXINS. TOPS

- 6. MATERIALS ALL PLANTING AREAS LABELED ON PLAN SHALL RECEIVE FINELY SHREDDED, WEED FREE, HARDWOOD BARK MULCH (DYE—FREE) SPREAD TO A CONSISTENT DEPTH OF THREE INCHES OVER ENTIRE PLANTING AREA, UNLESS OTHERWISE SPECIFIED ON PLANS. FERTILIZER SHALL BE IN ACCORDANCE WITH APPLICABLE LOCAL, COUNTY AND STATE OF WISCONSIN REQUIREMENTS.
- 7. RAINGARDEN PLUG PLANTINGS: ALL PLUG PLANTINGS SHALL BE PLANTED 2'-0" ON CENTER. CONTRACTOR IS TO RANDOMIZED PLUG PLANTING SELECTION THROUGHOUT BASIN AND DISTRIBUTE SPECIES VARIETY THROUGHOUT PLUG PLANTING AREAS. PRIOR TO PLANTING, BIODEGRADABLE PLANT CONTAINERS SHALL BE SPLIT AND NON-BIODEGRADABLE CONTAINERS BE REMOVED. THE ROOT SYSTEMS OF ALL SUCH PLANTS SHALL BE SPLIT OR CRUMBLED BY HAND PRIOR TO INSTALLATION.
- 8. MATERIALS ALL PLANTING AREAS LABELED ON PLAN SHALL RECEIVE WASHED STONE MULCH AS APPROVED BY OWNER. STONE SHALL BE SPREAD TO A CONSISTENT DEPTH OF THREE INCHES OVER ENTIRE PLANTING AREA, UNLESS OTHERWISE SPECIFIED ON PLANS. FERTILIZER SHALL BE IN ACCORDANCE WITH APPLICABLE LOCAL, COUNTY AND STATE OF WISCONSIN REQUIREMENTS.
- 9. MATERIALS RAINWATER DRY STREAM ADJACENT TO BUILDING SHALL RECEIVE WASHED #4 FIELDSTONE COBBLE STONE. SHALL BE SPREAD TO A CONSISTENT DEPTH OF THREE INCHES OVER ENTIRE PLANTING AREA, UNLESS OTHERWISE SPECIFIED ON PLANS.
- 10. MATERIALS TREE RINGS: ALL TREES PLANTED IN SODDED LAWN AREAS TO BE INSTALLED WITH A MINIMUM 3' DIAMETER SHREDDED HARDWOOD MULCH TREE RING SPREAD TO A CONSISTENT DEPTH OF 3 INCHES. ALL TREE RINGS SHOULD BE INSTALLED WITH A 5" DEPTH SHOVEL CUT EDGE, ANGLED 45 DEGREES INTO SOIL AT A 3' DIAMETER ABOUT THE CENTER OF THE TREE PLANTING. A PRE-EMERGENT GRANULE WEED-PREVENTER SHOULD BE MIXED WITH MULCH USED TO INSTALL TREE RING AS WELL AS TOPICALLY APPLIED TO FINISHED INSTALLATION OF
- 11. MATERIALS: SOD ALL DISTURBED AREAS AS SPECIFIED IN THESE NOTES: TURFGRASS SOD: CLASS OF TURFGRASS SOD SHALL BE PREMIUM GRADE APPROVED TURFGRASS SOD. ONLY IMPROVED TYPES OF SOD (ELITE) ARE ACCEPTABLE. TURFGRASS SOD SHALL BE MACHINE CUT AT A UNIFORM THICKNESS OF 60 INCH, PLUS OR MINUS .25 INCH, AT TIME OF CUTTING. MEASUREMENT FOR THICKNESS SHALL EXCLUDE TOP GROWTH AND THATCH. LARGE ROLL TURFGRASS SOD SHALL BE CUT TO THE SUPPLIER'S STANDARD WIDHI (36-48 INCHES) AND LENGTH. BROKEN PADS AND TORN OR UNEVER BUDDS WILL HOT BE ACCEPTABLE. STANDARD WIDHI (36-48 INCHES) AND LENGTH. BROKEN PADS AND TORN OR UNIFORMS TURFGRASS SOD SHALL BE SECTIONS OF THAT IT CAN BE PICKED UP AND HANDLED WITHOUT DAMAGE. TURFGRASS SOD SHALL BE PREMISED AND THAT IT CAN BE PICKED UP AND HANDLED WITHOUT DAMAGE. TURFGRASS SOD SHALL BE PREMISED STAYS ALIVE AND ROOTS INTO SOIL. THE CONTRACTOR IS RESPONSIBLE FOR WATERING SOD SOLD SHAPE AND ADMINISTRATION WILL BE REALWESTED OR THAT OF A HOURS. TURFGRASS SOD SHALL BE PREMISED. THE CONTRACTOR IS RESPONSIBLE FOR WATERING SOD SHALL BE RELATIVELY FREE OF THATCH, UP TO 5. NICH ALLOWABLE (UNCOMPRESSED). TURFGRASS SOD SHALL BE RELATIVELY FREE OF THATCH, UP TO 5. NICH ALLOWABLE (UNCOMPRESSED). TURFGRASS SOD SHALL BE RELATIVELY FREE OF THATCH, UP TO 5. NICH ALLOWABLE (UNCOMPRESSED). TURFGRASS SOD SHALL BE RELATIVELY FREE OF THATCH, UP TO 5. NICH ALLOWABLE (UNCOMPRESSED). TURFGRASS SOD SHALL BE RELATIVELY FREE OF THATCH, UP TO 5. NICH ALLOWABLE (UNCOMPRESSED). TURFGRASS SOD SHALL BE REASONABLY FREE (10 WEEDS,100 SQ. FT.) OF DISEASES, NEWATORING SOLD SHALL BE REASONABLY FREE OF GRASSY AND BROAD LEAF WEEDS. THE SOD SUPPLIER SHALL MAKE RECOMMENDATIONS TO THE CONTRACTOR REGARDING WATERING SCHEDULE. THE WATERING SCHEDULE SHOULD BEGIN MINDEDITELY AFTER SOD IS INSTALLED.
- 13. MATERIALS EDGING: EDGING SHALL BE 5" DEEP. POLYETHYLENE EDGING, OWNER SHALL APPROVE SPECIFICATION PROVIDED BY LANDSCAPE CONTRACTOR.
- 14. PRUNING: THE CONTRACTOR SHALL PRUNE ALL TREES AND REPAIR ANY INJURIES THAT OCCURRED DURING THE PLANTING PROCESS. DOUBLE LEADERS, DEAD BRANCHES, AND LIMBS DAMAGED OR BROKEN DURING THE PLANTING PROCESS SHALL BE PRUNED. THIS SHALL BE THE ONLY PRUNING ALLOWED AT PLANTING. PRUNING SHALL CONFORM TO AMERICAN STANDARD FOR TREE CARE OPERATIONS, ANSI ASDO. PRUNE TREES IN ACCORDANCE WITH MAN GUIDELINES. DO NOT TOP TREES, PRUNE SHRUBS ACCORDING TO STANDARD FOR TREE CARE OPERATIONS, ANSI ASDO. PRUNE TREES IN ACCORDANCE WITH MAN GUIDELINES. DO NOT TOP TREES, PRUNE SHRUBS ACCORDING TO STANDARD FOR TREE CARE.

 PROTECT OF THE PLANTING OF TREES AND REMOVE. SMOOTH AND SHAPE WOUNDS SO AS NOT TO RETAIN WATER AND COAT THE TREATED AREA WITH AN APPROVED ANTISETTIC TREE PLANT.
- 15. CLEANUP: DISPOSED OF EXCESS SOIL. REMOVE ALL CUTTINGS AND WASTE MATERIALS. SOIL, BRANCHES, BINDING AND WRAPPING MATERIALS, REJECTED PLANTS, OR OTHER DEBRIS RESULTING FROM ANY PLANTING SHALL BE PROMPTLY CLEANED UP AND REMOVED. THE WORK AREA SHALL BE KEPT SAFE AND NEAT AT ALL TIMES UNTIL THE CLEANUP OPERATION IS COMPLETED. UNDER NO CONDITIONS SHALL THE ACCUMULATION OF SOIL, BRANCHES OR OTHER DEBRIS BE ALLOWED UPON A PUBLIC PROPERTY IN SUCH A MANNER AS TO RESULT IN A PUBLIC HAZARD. LIKEWISE, UNDER NO CIRCUMSTANCES SHALL MAY DEBRIS OR INCIDENTAL MIRERIALS BE ALLOWED UPON ADJACENT PRINTER PROPERTY.
- 16. MAINTENANCE: (CONTRACTOR) FOR ALL PLANTINGS, BUFFER AREAS AND SODDED LAWN AREAS: THE CONTRACTOR SHALL MAINTAIN ALL PLANTINGS AND LAWN AREAS FOR AT LEAST A PERIOD OF 30 DAYS, OR UNTIL FINAL ACCEPTANCE FROM THE OWNER. THE CONTRACTOR IS RESPONSIBLE FOR ANY ENTERING PLANTS AND LAWN/TURFGRASS DURING THIS 30 DAY ESTABLISHMENT PERIOD. CONTRACTOR IS RESPONSIBLE FOR THE ESTABLISHMENT OF HEALTHY VIGOROUS PLANT MATERIALS AND LAWN/TURFGRASS GROWTH. CONTRACTOR IS ALSO RESPONSIBLE FOR ANY PRINING OF PLANT MATERIALS, AND SHAPING AND JOAN FOR SUCCE TO ANY PROGRAM FOR SUCH IS THE RESPONSIBILITY OF THE OWNER. ALL PLANTINGS AND LAWN/TURFGRASS AREAS SHALL BE MAINTAINED IN A MANICURED CONDITION.
- 17. MAINTENANCE: (OWNER) THE OWNER IS RESPONSIBLE FOR THE CONTINUED MAINTENANCE REPAIR AND REPLACEMENT OF ALL LANDSCAPING MATERIALS AND WEED BARRIER FARRIC AS NECESSARY FOLLOWING THE ONE (1) YEAR CONTRACTOR GUARANTEE PERIOD



CITY OF MADISON LANDSCAPE WORKSHEET Section 28.142 Madison General Ordinance

Project Location / Address UNION CORNERS - MADISON, WI Name of Project UNION CORNERS BUILDING 4 & 5 SPECIFIC IMPLEMENTATION PLAN Design / Concret GORMAN & COMPANY Contact Phone (608) 848-5060 Contact Imail JUSTIN.FRAHM@JSDINC.COM

Applicability

The following standards engly to all exterior construction and development activity, including the expension of exterior In this case, means and pulsage to the extract occurrent that of coupled using description and assume the experience of extraction of coupled using several managers of the extraction of coupled using description and wordering describing and their allowers of the extraction of the extraction of the extraction of their allowers with this section can see all of the following conditions apply, in which seek only the affected area section for brought up to compliance:

(a) The area of site disturbance is less than ten percent (10%) of the entire development site during any ten-(10)

(b) Gross floor area is only increased by ten percent (10%) during any ten-(10) year period.

(d) Any displaced landscaping elements must be replaced on the site and shown on a revised landscaping plan

landscape points depending on the size of the let and Zening Distric

Landscape Calculations and Distribution
Required Inodecycle trans the Distribution
Required Inodecycle trans the Distribution based upon the total developed area of the property. Developed area is defined at this area whether a single configuous boundary which is mask up of timestress, parking, direverses and disconfigurating facilities, but used only the read of any business foregoint it grands have designated for open apare used such as tabless feelfs, not undervoord and never on the arter acting but. Then earl them notices for collecting on the property of the prop

(a) For all loss except those described in (b) and (c) below, five (S) landscape points shall be provided for each

Tetal square footrige of developed area 8,524 Tetal landscripe points required 142

(b) For lots larger than five (5) acres, points shall be provided at five (5) points per Gree hundred (100) square feet for (se fine five (5) developed series, and one (1) point per one hundred (100) square feet for all additional acres.

Tetal square footage of developed area _

Five (5) neres = 217,800 square feet

First five (5) developed tores = 2,630 points

Total landscape points required_____

(c) For the Industrial - Limited (IL) and Industrial - General (IG) districts, one (I) point shall be provided

Tetal square footage of developed area Tetal Iradscape points required_____

10/2013

Tabulation of Points and Credits

Use the table to indicate the quantity and points for all existing and proposed landscape elements.

Plant Type/ Element	Minimum Size at Installation	Points		Existing caping		roposed caping
runt Type Element	Institution	rouns	Quantity	Points Achieved	Quantity	Points Achieved
Overstory deciduous tree	2% inch caltper measured diameter at breast height (dbt)	35				
Tall evergreer, tree (i.e. pine, spruce)	5-6 feet tail	35				
Omamental tree	1 1/2 inch caliper	15			4	60
Upright evergreen shrub (i.e. arborvitae)	3-4 feet tail	10				
Shrub, decideous	#3 gallon container size, Min. 12"-24"	3			60	180
Shrub, evergreen	#3 gallon container size, Min. 12*-24*	4			16	64
Omamental grasses/ perenn:als	#1 galloo container size, Min. 8"-18"	2			286	572
Omamental/ decentive fencing or wall	n-a	4 per 10 lineal ft.				
Existing significant specimen tree	Minimum size: 2 ½ inch caliper dbb. *Trees must be within developed area and cannot comprise more than 30% of total required points.	14 per caliper inch doh, Maximum points per tree: 200				
Landscape furniture for public senting and/or transit connections	Furniture must be within developed area, politically accessible, and cannot comprise more than 3% of total required points.	5 points per "sent"				
Sub Totals						816

Total Number of Points Provided 816



REAL ESTATE DEVELOPMENT & MANAGEMENT

> 200 N MAIN STREET OREGON, WI 53575



ECIFIC PLAN COMPANY SPI **IMPLEMENTATION** CORNERS Ø GORMAN UNION

Project No.	14-6534
Plot Date:	YYYY/MM/DD 0:00 AM
Drawn by:	XXX

Issue Description GDP 06-25-14 SIP 11-05-14 UDC FINAL 05-27-2015

Sheet Title

LANDSCAPE DETAILS, NOTES, AND **SPECIFICATIONS**

Sheet No.


L300







Consultant

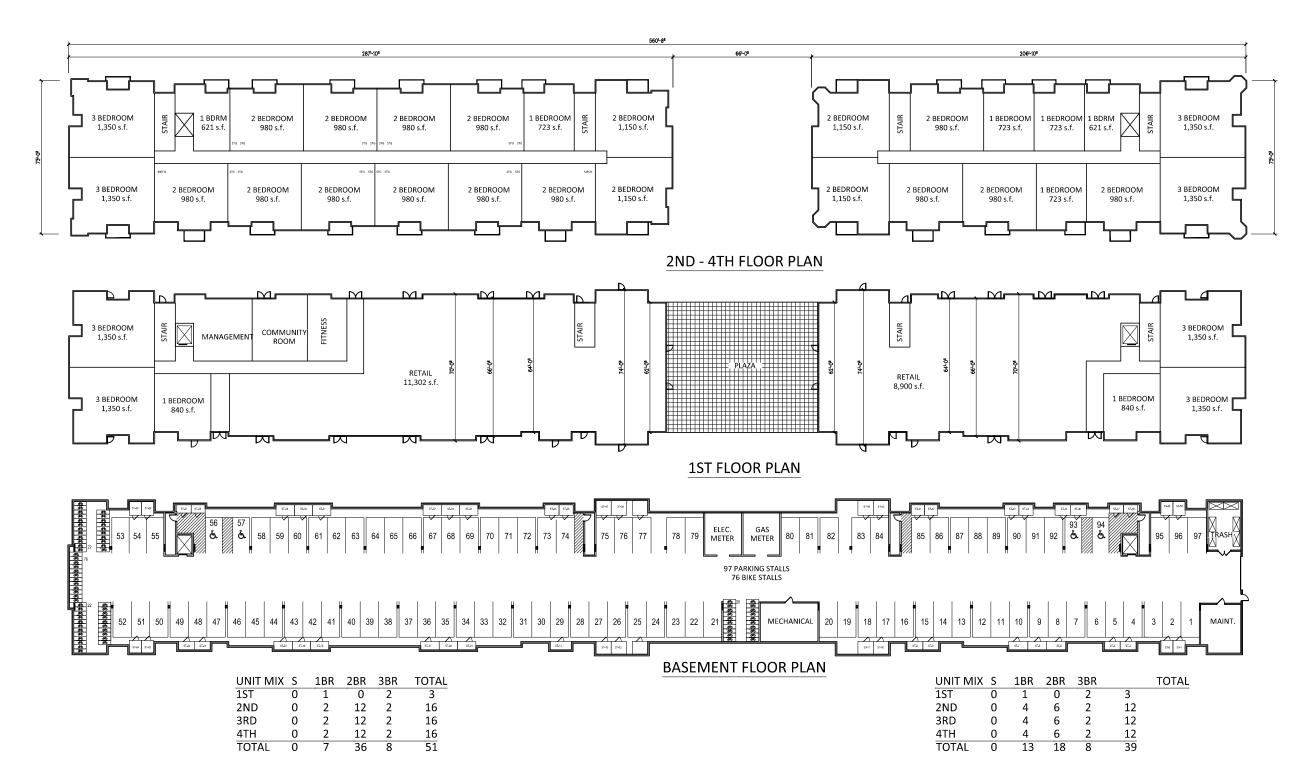

UNION CORNERS
BUILDINGS 4 & 5
2500 WINNEBAGO STREET
MADISON, WI

Project No.	130020
Plot Date:	2015/05/27 11:0
Drawn by:	JK/N
Date	Issue Description

Sheet Title

BLDG 4 & 5 PLAN

Sheet No.

A101



UNION CORNERS SWEET TREATS

Project No.	130020-43
Plot Date:	2015/05/11 11:00 AM
Drawn by:	JK/MO
Date	Issue Description

7

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BUILDINGS 4 & 2500 WINNEBAGO STREET MADISON, WI

3 BLDG #4 - PLAZA ELEVATION
SCALE: 1" = 10' - 0"

Sheet Title

BLDG # 4 ELEVATIONS

Sheet No.

A401









1 BLDG # 5 - WINNEBAGO STREET ELEVATION SCALE: 1" = 10' - 0"







REAL ESTATE
DEVELOPMENT &
MANAGEMENT
200 N. MAIN STREET
OREGON, WI 53575

Seal

Consultant

UNION CORNERS BUILDINGS 4 & 5 2500 WINNEBAGO STREET MADISON, WI

Plot Date:	2015/05/27 11:00 AN
Drawn by:	JK/MO

Sheet Title

BLDG # 5 ELEVATIONS

Sheet No.

A402