

TOPOGRAPHIC LINEWORK LEGEND

- P --- EXISTING FIBER OPTIC LINE - III ---- EXISTING UNDERGROUND TELEPHONE - * --- EXISTING GENERAL FENCE

EXISTING WOOD FENCE — a — EXISTING GAS LINE

- 12 --- EXISTING UNDERGROUND ELECTRIC LINE ____ EXISTING SANITARY SEWER LINE (SIZE NOTED)

EXISTING WATER MAIN (SIZE NOTED)

--- EXISTING MINOR CONTOUR

- EXISTING BOLLARD
- EXISTING SIGN (TYPE NOTED)
- & EXISTING SANITARY CLEANOUT
- The sanitary manhole
- "" EXISTING FIRE HYDRANT
- "=" EXISTING STANDPIPE
- 6 EXISTING WATER MAIN VALVE
- © EXISTING CURB STOP
- M EXISTING GAS VALVE EXISTING AIR CONDITIONING PEDESTAL
- EXISTING DOWN GUY © EXISTING ELECTRIC MANHOLE
- EXISTING ELECTRIC PEDESTAL

- ☼ EXISTING TRANSFORMER
- EXISTING GUY POLE
 - ϕ existing light pole
 - EXISTING GENERIC LIGHT
 - C EXISTING UTILITY POLE
 - EXISTING TV PEDESTAL
 - EXISTING TELEPHONE PEDESTAL
 - @ EXISTING UNIDENTIFIED MANHOLE & EXISTING HANDICAP PARKING
 - S EXISTING SHRUB
 - EXISTING CONIFEROUS TREE

(EXISTING DECIDUOUS TREE














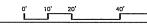

4) FIELD WORK FOR THIS MAP WAS COMPLETED BY 5-15-13. ANY CHANGES AFTER THIS DATE ARE NOT REFLECTED ON THIS MAP.

GARY BRINK & ASSOCIATES ARCHITECTS 8401 EXCELSIOR DRIVE MADISON, WI 53717 608-829-1750 608-829-3056 (FAX)



DEVELOPMENT

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PROJECT: DRAWN BY:

DATE: SCALE: AS NOTED

EXISTING CONDITIONS PLAN

C1.0

12. REMOVE ALL EXISTING BOLLARDS . WITHIN PROPERTY BOUNDARY.

UTILITY PRIOR TO REMOVING WATER METER,

15. REMOVE PLANTERS

14. REMOVE EXISTING BUILDINGS AND ATTACHMENTS, INCLUDING FOUNDATIONS.

13. REMOVE ALL EXISTING LIGHT POLES T AND CONCRETE BASES WITHIN PROPERTY BOUNDARY.

16. PLUG AND ABANDON EXISTING WATER SERVICE AT LOCATION SHOWN AND REMOVE REMAINDER OF PIPE ON SITE. CONTACT WATER

17. OBTAIN SANITARY PLUG PERMIT AND COORDINATE WITH CITY ENGINEERING PRIOR TO SEWER LATERAL PIPE REMOVAL.

BUILDING REMOVAL

UTILITY STRUCTURE REMOVAL

TREE REMOVAL

----x----x---- UTILITY LINE REMOVAL

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GARY BRINK & ASSOCIATES

ARCHITECTS

8401 EXCELSIOR DRIVE MADISON, WI 53717 608-829-1750 608-829-3056 (FAX)

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DEVELOPMENT 20 GAMMON PLACE
0 GAMMON PLACE
DISON, WI 53719 TOWNE]

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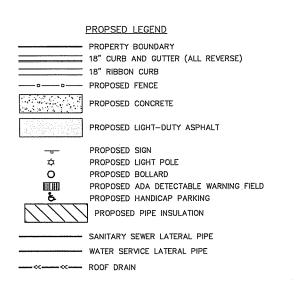
PROJECT: 201211 DRAWN BY: DATE: AS NOTED

SCALE: PRELIMINAR'

05.05.2013

REV. 1 06.24.2013

DEMOLITION PLAN



ABBREVIATIONS STMH - STORM MANHOLE



CALL DIGGER'S HOTLINE 1-800-242-8511 TOLL FREE TELEFAX: 1-800-338-3860 TDC (FOR HEARING IMPAIRED): 1-800-542-2289 WIS. STATUTE 182.0175 (1979)
REQUIRES MINIMUM OF 3 WORKING DAYS
NOTICE BEFORE YOU EXCAVATE.


SITE AND UTILITY NOTES:

- A COPY OF THE APPROVED UTILITY PLANS, SPECIFICATIONS AND PLUMBING PERMIT APPROVAL LETTER SHALL BE ON-SITE DURING CONSTRUCTION AND OPEN TO INSPECTION BY AUTHORIZED REPRESENTATIVES OF DSPS AND OTHER LOCAL INSPECTORS.
- PRIVATE SANITARY SEWER AND LATERALS SHALL BE POLYVINYL CHLORIDE (PVC) ASTM_D3034 SDR 35 OR APPROVED EQUAL MATERIAL THAT CONFORMS TO
- 3. A MEANS TO LOCATE BURIED UNDERGROUND EXTERIOR NON METALLIC SEWERS/MAINS AND WATER SERVICES/MAINS MUST BE PROVIDED WITH TRACER WIRE OR OTHER METHODS IN ORDER TO BE LOCATED PER SPS 382.
- 4. EXTERIOR WATER SUPPLY PIPING SETBACKS AND CROSSINGS SHALL BE IN
- 5. NO PERSON MAY ENGAGE IN WORK AT PLUMBING IN THE STATE UNLESS LICENSED TO DO SO.
- 6. SITE CONTRACTOR SHALL LEAVE SANITARY AND WATER LATERALS FIVE (5) FEET SHORT (HORIZONTALLY) FROM THE BUILDING. BUILDING PLUMBER SHALL VERIFY SIZE AND EXACT LOCATION OF PROPOSED SANITARY AND WATER

13. CONTRACTOR TO SUBMIT CONCRETE JOINT PATTERNS FOR REVIEW AND APPROVAL

PRIOR TO CONSTRUCTION.

7. CONTRACTOR SHALL FIELD VERIFY THE SIZE, TYPE, LOCATION, AND ELEVATION OF EXISTING UTILITIES PRIOR TO INSTALLING ANY ON-SITE UTILITIES OR STRUCTURES. CONTACT ENGINEER PRIOR TO INSTALLATION IF DISCREPANCY EXISTS WITHIN THESE PLANS.

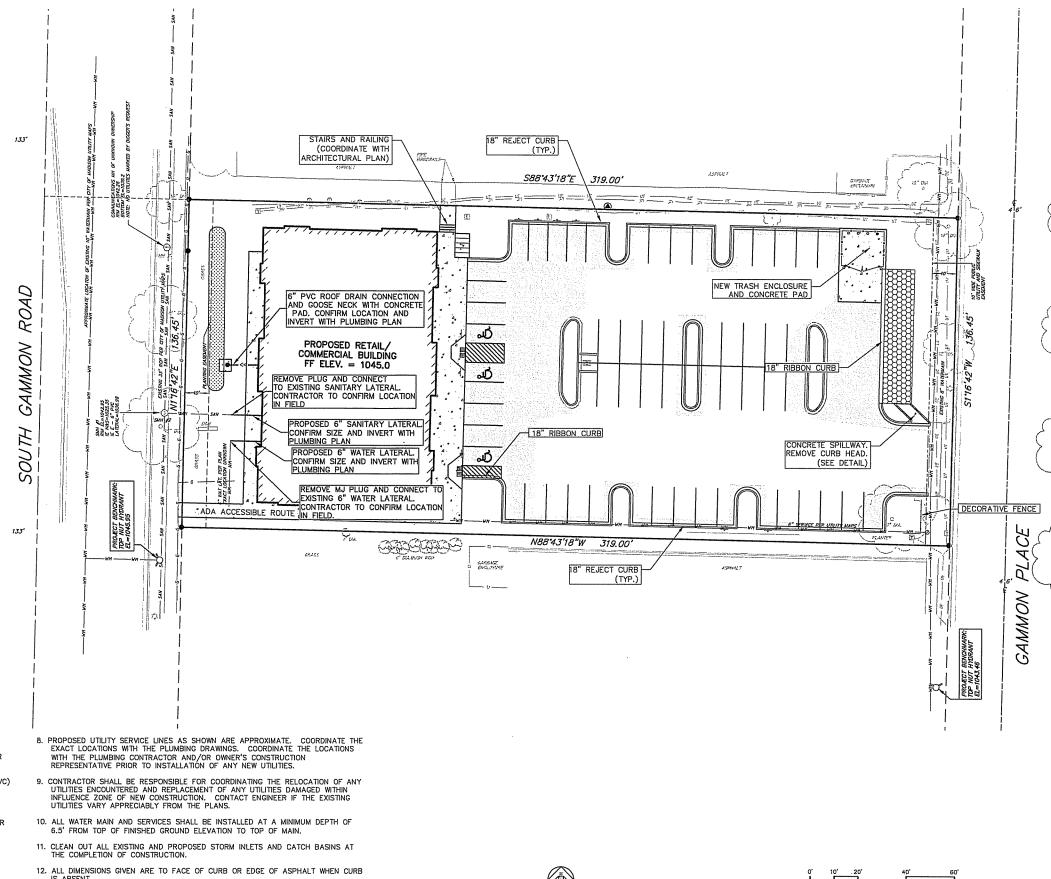

SITE UTILITY PLAN

GARY BRINK & ASSOCIATES

ARCHITECTS 8401 EXCELSIOR DRIVE MADISON, WI 53717 608-829-1750

608-829-3056 (FAX)

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AS NOTED

06.05.2013

PLACE

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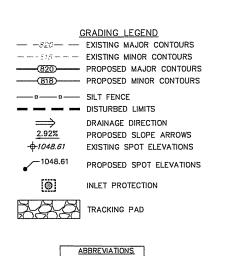
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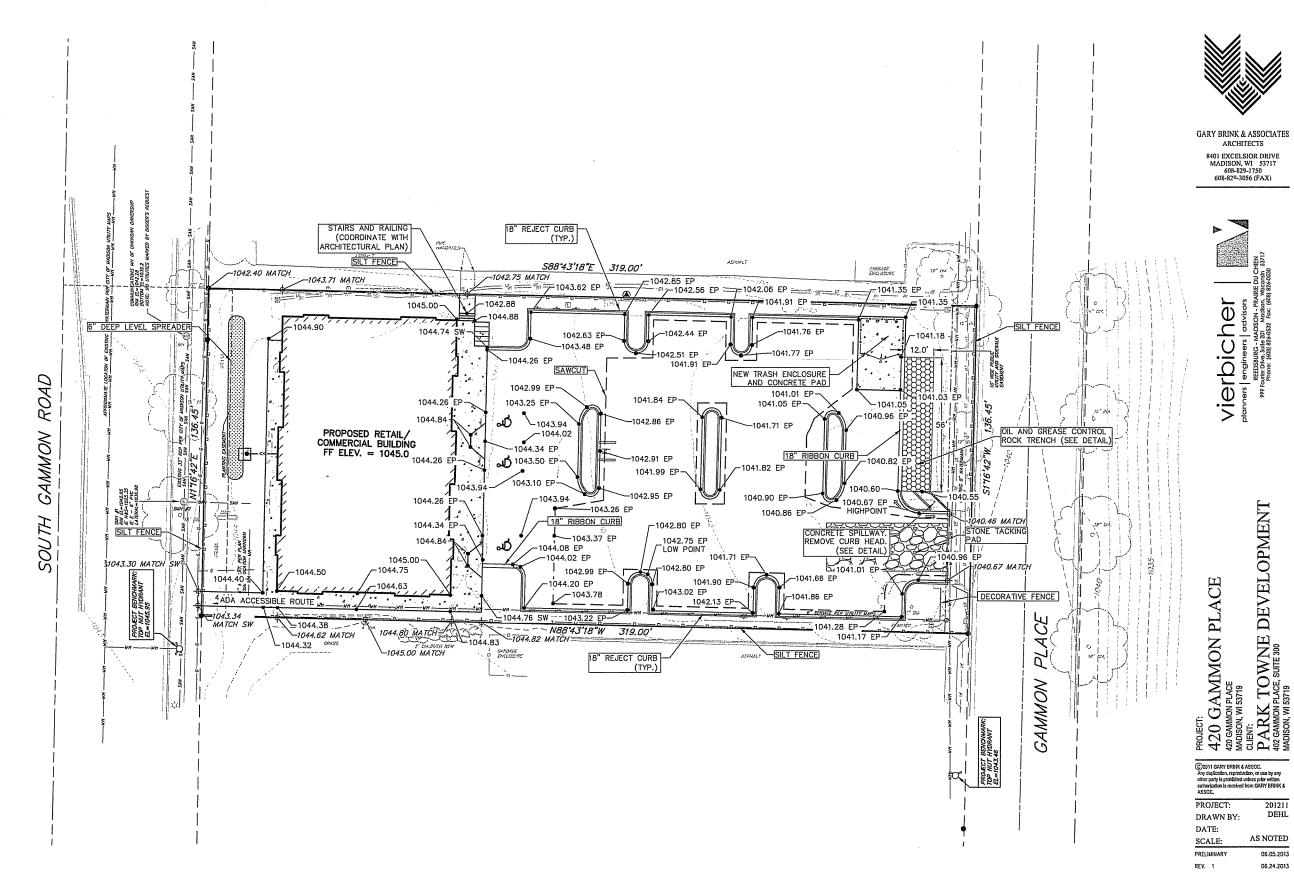
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TC — TOP OF CURB
FF — FINISHED FLOOR
EP — EDGE OF PAVEMEN'
SW — TOP OF WALL
TW — TOP OF WALL
BW — BOTTOM OF WALL

CALL DIGGER'S HOTLINE 1-800-242-8511 TOLL FREE

TELEFAX: 1-800-338-3860 TDC (FOR HEARING IMPAIRED): 1-800-542-2289 WIS. STATUTE 182.0175 (1979)
REQUIRES MINIMUM OF 3 WORKING DAYS NOTICE BEFORE YOU EXCAVATE.



GENERAL NOTES:

- 1. THE LOCATION OF EXISTING UNDERGROUND UTILITIES AS SHOWN ON THE PLANS HAS BEEN DETERMINED FROM THE BEST AVAILABLE INFORMATION AND IS GIVEN FOR THE CONVENIENCE OF THE CONTRACTOR. THE OWNER AND THE ENGINEER DO NOT ASSUME RESPONSIBILITY IN THE EVENT THAT DURING CONSTRUCTION, UTILITIES OTHER THAN THOSE SHOWN MAY BE ENCOUNTERED, AND THAT THE ACTUAL LOCATION OF THOSE WHICH ARE SHOWN MAY BE DIFFERENT FROM THE
- 2. ACCESSIBLE ROUTES SHALL BE 5% MAX LONGITUDINAL SLOPE AND 2% MAX CROSS SLOPE. ACCESSIBLE LOADING AREAS OR LANDINGS SHALL BE 2% MAX IN ANY DIRECTION. RAMPS SHALL BE 8.33% MAX.
- CONTOURS ARE SHOWN FOR PURPOSES OF INDICATING ROUGH GRADING.
- FINAL GRADE SHALL BE ESTABLISHED ON PAVED SURFACES BY USING SPOT GRADES ONLY.
- 5. SEE CONSTRUCTION DETAIL SHEET FOR EROSION CONTROL NOTES AND CONSTRUCTION SEQUENCE



GRADING AND EROSION CONTROL

ARCHITECTS

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DEVELOPMENT

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AS NOTED


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GAMMON PLACE

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EROSION CONTROL MEASURES

- 1. EROSION CONTROL SHALL BE IN ACCORDANCE WITH THE CITY OF MADISON EROSION CONTROL ORDINANCE AND CHAPTER NR 216 OF THE WISCONSIN ADMINISTRATIVE CODE.
- CONSTRUCT AND MAINTAIN ALL EROSION AND SEDIMENT CONTROL MEASURES IN ACCORDANCE WITH WISCONSIN DNR TECHNICAL STANDARDS (http://dnr.wi.gov/runoff/stormwater/techstds.htm) AND WISCONSIN CONSTRUCTION SITE BEST MANAGEMENT PRACTICE HANDBOOK.
- INSTALL SEDIMENT CONTROL PRACTICES (TRACKING PAD, PERIMETER SILT FENCE, SEDIMENT BASINS, ETC.) PRIOR TO INITIATING OTHER LAND DISTURBING
- 4. THE CONTRACTOR IS REQUIRED TO MAKE EROSION CONTROL INSPECTIONS AT THE END OF EACH WEEK AND WHEN 0.5 INCHES OF RAIN FALLS WITHIN 24 HOURS. INSPECTION REPORTS SHALL BE PREPARED AND FILED AS REQUIRED BY THE DNR AND/OR CITY. ALL MAINTENANCE WILL FOLLOW AN INSPECTION
- 5. EROSION CONTROL IS THE RESPONSIBILITY OF THE CONTRACTOR UNTIL ACCEPTANCE OF THIS PROJECT. EROSION CONTROL MEASURES AS SHOWN SHALL BE THE MINIMUM PRECAUTIONS THAT WILL BE ALLOWED. ADDITIONAL EROSION CONTROL MEASURES, AS REQUESTED IN WRITING BY THE STATE OR LOCAL INSPECTORS, OR THE DEVELOPER'S ENGINEER, SHALL BE INSTALLED WITHIN 24 HOURS,
- 6. A 3" CLEAR STONE TRACKING PAD SHALL BE INSTALLED AT THE END OF ROAD CONSTRUCTION LIMITS TO PREVENT SEDIMENT FROM BEING TRACKED ONTO THE ADJACENT PAVED PUBLIC ROADWAY. SEDIMENT TRACKING PAD SHALL CONFORM TO WisDNR TECHNICAL STANDARD 1057. SEDIMENT REACHING THE PUBLIC ROAD SHALL BE REMOVED BY STREET CLEANING (NOT HYDRAULIC FLUSHING) BEFORE THE END OF EACH WORK DAY.
- CHANNELIZED RUNOFF: FROM ADJACENT AREAS PASSING THROUGH THE SITE SHALL BE DIVERTED AROUND DISTURBED AREAS.
- 8. STABILIZED DISTURBED GROUND: ANY SOIL OR DIRT PILES WHICH WILL REMAIN IN EXISTENCE FOR MORE THAN 7-CONSECUTIVE DAYS, WHETHER TO BE WORKED DURING THAT PERIOD OR NOT, SHALL NOT BE LOCATED WITHIN 25-FEET OF ANY ROADWAY, PARKING LOT, PAVED AREA, OR DRAINAGE STRUCTURE OR CHANNEL (UNLESS INTENDED TO BE USED AS PART OF THE EROSION CONTROL MEASURES). TEMPORARY STABILIZATION AND CONTROL MEASURES (SEEDING, MULCHING, TARPING, EROSION MATTING, BARRIER FENCING, ETC.) ARE REQUIRED FOR THE PROTECTION OF DISTURBED AREAS AND SOIL PILES, WHICH WILL REMAIN UN-WORKED FOR A PERIOD OF MORE THAN 7-CONSECUTIVE CALENDAR DAYS. THESE MEASURES SHALL REMAIN IN PLACE UNTIL SITE HAS
- 9. <u>SITE DE-WATERING:</u> WATER PUMPED FROM THE SITE SHALL BE TREATED BY TEMPORARY SEDIMENTATION BASINS OR OTHER APPROPRIATE CONTROL MEASURES. SEDIMENTATION BASINS SHALL HAVE A DEPTH OF AT LEAST 3 FEET, BE SURROUNDED BY SNOWFENCE OR EQUIVALENT BARRIER AND HAVE SUFFICIENT SURFACE AREA TO PROVIDE A SURFACE SETTLING RATE OF NO MORE THAN 750 GALLONS PER SQUARE FOOT PER DAY AT THE HIGHEST DEWATERING PUMPING RATE. WATER MAY NOT BE DISCHARGED IN A MANNER THAT CAUSES EROSION OF THE SITE, A NEIGHBORING SITE, OR THE BED OR BANKS OF THE RECEIVING WATER. POLYMERS MAY BE USED AS DIRECTED BY DNR TECHNICAL STANDARD 1061 (DE-WATERING).
- 10. SEE DETAIL SHEETS FOR RIP-RAP SIZING, IN NO CASE WILL RIP-RAP BE SMALLER THAN 3" TO 6".
- RESTORATION (SEED, FERTILIZE AND MULCH) SHALL BE PER SPECIFICATIONS ON THIS SHEET (NOTE: ADD SEEDING RATE STANDARD OF DETAIL BLOCK TO PLAN) UNLESS SPECIAL RESTORATION IS CALLED FOR ON THE LANDSCAPE PLAN.
- 12. LAWN AREAS SHALL BE RESTORED WITH 6" TOPSOIL, TEMPORARY SEED, FERTILIZER AND MULCH
- 13. SEED, FERTILIZER AND MULCH SHALL BE APPLIED WITHIN 7 DAYS AFTER FINAL GRADE HAS BEEN ESTABLISHED. IF DISTURBED AREAS WILL NOT BE RESTORED IMMEDIATELY AFTER ROUGH GRADING, TEMPORARY SEED SHALL BE PLACED.
- 14. FOR THE FIRST SIX WEEKS AFTER RESTORATION (E.G. SEED & MULCH, EROSION MAT, SOD) OF A DISTURBED AREA, INCLUDE SUMMER WATERING PROVISIONS OF ALL NEWLY SEEDED AND MULCHED AREAS WHENEVER 7 DAYS ELAPSE WITHOUT A RAIN EVENT.
- 15. EROSION MAT (CLASS I, TYPE A URBAN PER WISCONSIN D.O.T. P.A.L.) SHALL BE INSTALLED ON ALL SLOPES 3:1 OR GREATER BUT LESS THAN 1:1.
- 16. EROSION MAT (CLASS I, TYPE B URBAN PER WISCONSIN D.O.T. P.A.L.) SHALL BE INSTALLED ON THE BOTTOM (INVERT) OF ROADSIDE DITCHES/SWALES AS SHOWN ON THIS PLAN, 1 ROLL WIDTH.
- 17. SOIL STABILIZERS SHALL BE APPLIED TO DISTURBED AREAS WITH SLOPES BETWEEN 10% AND 3:1 (DO NOT USE IN CHANNELS). SOIL STABILIZERS SHALL BE TYPE B, PER WISCONSIN D.O.T. P.A.L. (PRODUCT ACCEPTABILITY LIST), OR EQUAL. APPLY AT RATES AND METHODS SPECIFIED PER MANUFACTURER. SOIL STABILIZERS SHALL BE RE-APPLIED WHENEVER VEHICLES OR OTHER EQUIPMENT TRACK ON THE AREA.
- 18. SILT FENCE OR EROSION MAT SHALL BE INSTALLED ALONG THE CONTOURS AT 100 FOOT INTERVALS DOWN THE SLOPE ON THE DISTURBED SLOPES STEEPER THAN 5% AND MORE THAN 100 FEET LONG THAT SHEET FLOW TO THE ROADWAY UNLESS SOIL STABILIZERS ARE USED.
- 19. SILT FENCE TO BE USED ACROSS AREAS OF THE LOT THAT SLOPE TOWARDS A PUBLIC STREET OR WATERWAY. SEE DETAILS.
- 20. SEDIMENT SHALL BE CLEANED FROM CURB AND GUTTER AFTER EACH RAINFALL AND PRIOR TO PROJECT ACCEPTANCE
- 21. ANY PROPOSED CHANGES TO THE EROSION CONTROL PLAN MUST BE SUBMITTED AND APPROVED BY CITY OF MADISON ENGINEERING.
- 22. THE CITY, OWNER AND/OR ENGINEER MAY REQUIRE ADDITIONAL EROSION CONTROL MEASURES AT ANY TIME DURING CONSTRUCTION.



- 1. INSTALL SILT FENCE TO FOLLOW THE GROUND CONTOURS AS CLOSELY AS POSSIBLE.
- 2. CURVE THE SILT FENCE UP THE SLOPE TO PREVENT WATER FROM RUNNING AROUND THE
- 3. POST SPACING WITH FENCE SUPPORT MESH = 10 FT. (MAX.)
 - POST SPACING WITHOUT FENCE SUPPORT MESH = 6 FT. (MAX.)
- SILT FENCE SUPPORT MESH CONSISTS OF 14—GAUGE STEEL WIRE WITH A MESH SPACING OF 6 IN. X 6 IN. OR PREFABRICATED POLYMERIC MESH OF EQUIVALENT STRENGTH

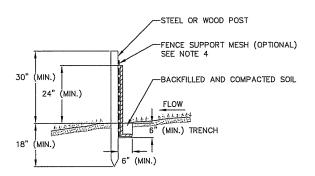

- 5. CONSTRUCT UNDERGROUND UTILITIES
- 6. CONSTRUCT PARKING AREAS (STONE
- 7. CONSTRUCT OIL AND GREASE CONTROL
- 8. REMOVE TRACKING PAD AND SILT

1. USE ANNUAL OATS AT 3.0 LB./1,000 S.F. FOR SPRING AND

AFTER SEPTEMBER 15

PERMANENT:

1. USE WISCONSIN D.O.T. SEED MIX #40 AT 2 LB./1,000 S.F.

FERTILIZING RATES:

MULCHING RATES:

TEMPORARY AND PERMANENT:

USE ½" TO 1-½" STRAW OR HAY MULCH, CRIMPED PER SECTION 607.3.2.3, OR OTHER RATE AND METHOD PER SECTION 627, WISCONSIN D.O.T. STANDARD SPECIFICATIONS FOR

CONSTRUCTION SEQUENCE:


- INSTALL SILT FENCE/SILT SOCK AND
- 2. DEMOLITION OF EXISTING BUILDING SIDEWALK, AND PARKING AREA PER DEMOLITION PLAN.
- 3. ROUGH GRADE DISTURBED AREA
- 4. SEED AND EROSION MAT THE DISTURBED PROPOSED LAWN AREAS
- BASE, CURB & GUTTER, AND SIDEWALK).
- ROCK TRENCH (PER DETAIL).
- FENCE/SILT SOCK


SEEDING RATES:

2. USE WINTER WHEAT OR RYE AT 3.0 LB./1,000 SF FOR FALL

TEMPORARY AND PERMANENT; USE WISCONSIN D.O.T. TYPE A OR B AT 7 LB./1,000 S.F.


HIGHWAY AND STRUCTURE CONSTRUCTION

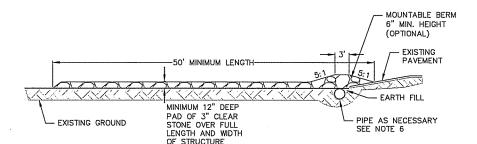

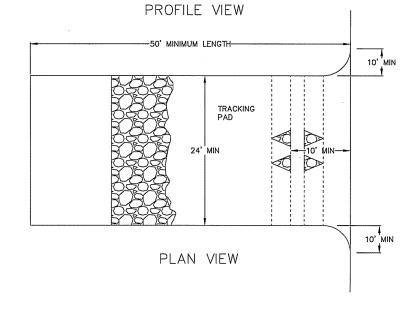

- 1. FOLLOW WISCONSIN DNR TECHNICAL STANDARD 1057 FOR FURTHER DETAILS AND INSTALLATION.
- 2. LENGTH MINIMUM OF 50'
- 3. WIDTH 24' MINIMUM, SHOULD BE FLARED AT THE EXISTING ROAD TO PROVIDE A TURNING RADIUS.
- 4. ON SITES WITH A HIGH GROUND WATER TABLE OR WHERE SATURATED CONDITIONS EXIST, GEOTEXTILE FABRICSHALL BE PLACED OVER EXISTING GROUND PRIOR TO PLACING STONE. FABRIC SHALL BE WISDOT TYPE—HR GEOTEXTILE FABRIC.
- 5. STONE CRUSHED 3" CLEAR STONE SHALL BE PLACED AT LEAST 12" DEEP OVER THE ENTIRE LENGTH AND WIDTH OF ENTRANCE.
- 6. SURFACE WATER ALL SURFACE WATER FLOWING TO OR DIVERTED TOWARDS CONSTRUCTION ENTRANCES SHALL BE PIPED THROUGH THE ENTRANCE. MAINTAINING POSITIVE DRAINAGE. PIPE INSTALLED THROUGH THE STABILIZED CONSTRUCTION ENTRANCE SHALL BE PROTECTED WITH A MOUNTABLE BERM WITH 5:1 SLOPES AND MINIMIUM OF 6" STONE OVER THE PIPE. PIPE SHALL BE SIZED ACCORDING TO THE DRAINAGE REQUIREMENTS. WHEN THE ENTRANCE IS LOCATED AT A HIGH SPOT AND HAS NO DRAINAGE TO CONVEY A PIPE SHALL NOT BE NECESSARY. THE MINIMUM PIPE DIAMETER SHALL BE 6". CONTRACTOR SHALL BE RESPONSIBLE FOR
- 7. LOCATION A STABILIZED CONSTRUCTION ENTRANCE SHALL BE LOCATED WHERE CONSTRUCTION TRAFFIC ENTERS AND/OR LEAVES THE CONSTRUCTION SITE. VEHICLES LEAVING THE SITE MUST TRAVEL OVER THE ENTIRE LENGTH OF THE TRACKING PAD.



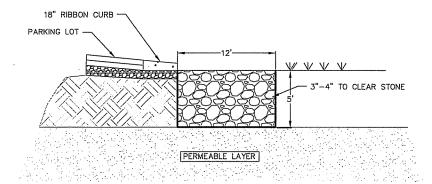





GARY BRINK & ASSOCIATES ARCHITECTS

> 8401 EXCELSIOR DRIVE MADISON, WI 53717 608-829-175 608-829-3056 (FAX)

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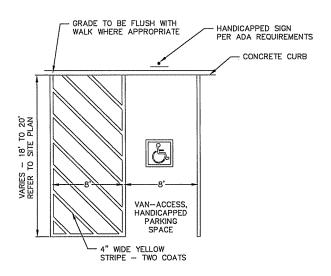
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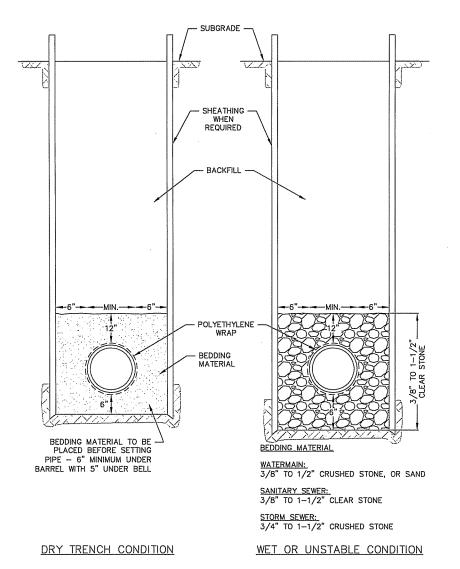
PRFI IMINAR

CONSTRUCTION

DETAILS



HANDICAP STRIPING



HANDICAP PARKING SIGN NOT TO SCALE

RESERVED

PARKING

PROVIDE US DOT #R7-8 SIGN CONTAINING INTERNATIONAL

SYMBOL OF ACCESSIBILITY (SIGN MAY VARY BY ORDINANCE).

PROVIDE SIGN INDICATING FINE AMOUNT AS PER LOCAL CODES.

2" x 2" STEEL TUBE EXTENDED

INTO CONCRETE FILLED 4" Ø PIPE

CONCRETE FILLED 4" Ø PIPE


FINISHED GRADE

12" DIAMETER CONCRETE FOUNDATION 6" BELOW FROST LINE (3 FT MIN.BELOW

FINISHED GRADE)

STANDARD TRENCH SECTION NOT TO SCALE

CONCRETE SPILLWAY/CURB CUT NOT TO SCALE

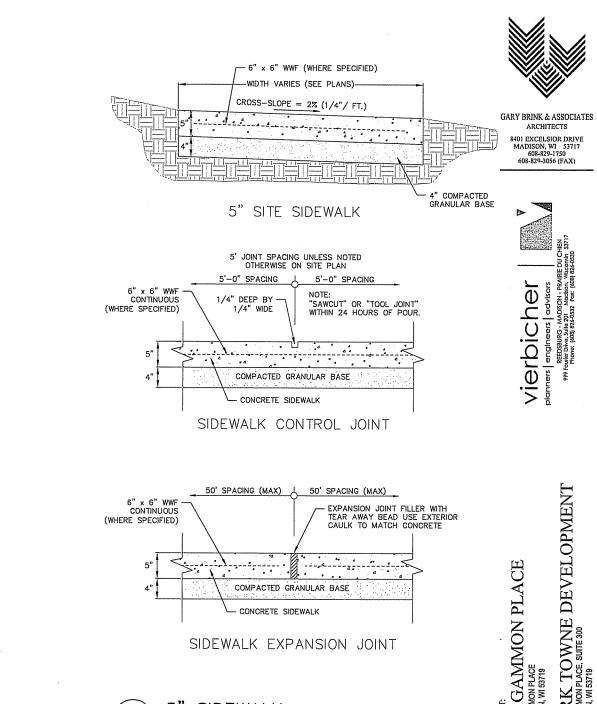

SIDEWALK EXPANSION JOINT

- CONCRETE SIDEWALK

5" SIDEWALK NOT TO SCALE

201211

. TOWNE DEVELOPMENT PLACE, SUITE 300 53719

ARCHITECTS

8401 EXCELSIOR DRIVE MADISON, WI 53717 608-829-1750 608-829-3056 (FAX)


Vierbicher
planners | engineers | advisors
REEDSBURG.-MADISON-PRAIRI
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PROJECT: DRAWN BY: DATE: AS NOTED


SCALE:

CONSTRUCTION **DETAILS**


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CURBED SIDEWALK SITE DETAIL NOT TO SCALE

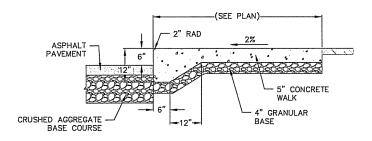


RIBBON CURB

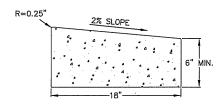


CURB AND GUTTER REJECT SECTION

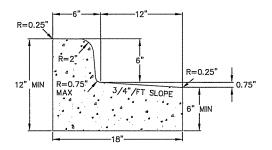18" CONCRETE CURB AND GUTTER NOT TO SCALE

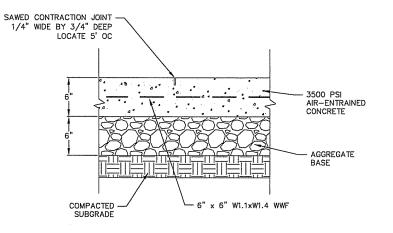




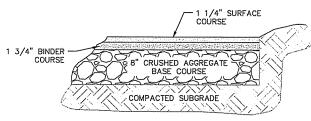

PARKING LOT



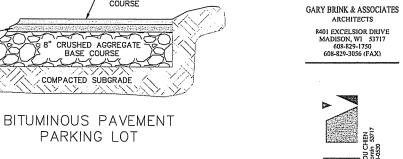





ARK TOWNE DEVELOPMENT 2 GAMMON PLACE, SUITE 300 DISON, W 53719 20 GAMIMON PLACE

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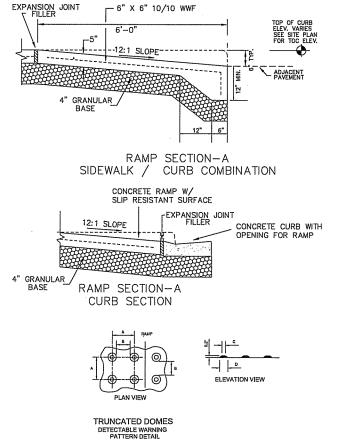
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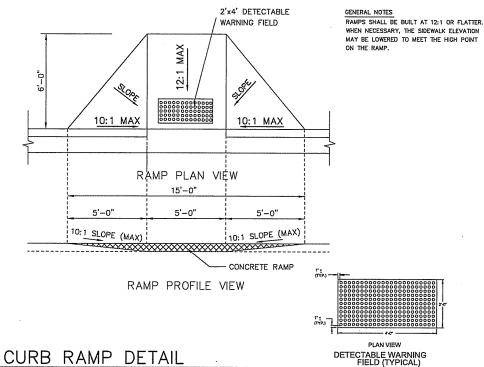
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CONSTRUCTION **DETAILS**


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NOT TO SCALE



			Plant List			
key	qty.	botanical name	common name	planting size	root cond.	mature size
			shade trees			
Amiy	4	Acer miyabei 'Morton'	State Street Maple	2.5" cal.	В&В	50' x 40'
Pcal	2	Pyrus calleryana 'Cleveland Select'	Cleveland Select Pear	2.5" cal.	B&B	35' x 15'
Qrub	2	Quercus rubra	Red Oak	2.5" cal.	B&B	wi native
Umor	4	Ulmus 'Morton Glossy'	Triumph Elm	2.5" cal.	B&B	55' x 45'
			deciduous shrubs			
Dlon	36	Diervilla lonicera	Dwarf Bush-Honeysuckle	#5	cont.	3' x 4'
Raro	20	Rhus aromatica 'Gro-low'	Gro-low Sumac	#5	cont.	30' x 6'
Vcas	12	Viburnum cassinoides	Witherod Viburnum	#5	cont.	4' x 5'
			evergreen shrubs			
Jhor	20	Juniperus horizontalis 'Wisconsin'	Wisconsin Juniper	#5	cont.	8" x 5'
Tmed	6	Taxus x media 'Everlow'	Everlow Yew	#5	cont.	30" x 4'
Tocc	3	Thuja occidentalis 'Holmstrup'	Holmstrup Arb	5' ht.	cont.	14' x 3'
			perennials			
Hste	11	Hemerocallis 'Stella d'Oro'	Stella D'Oro Daylily	#1	cont.	18" x 18"

LANDSCAPING REQUIREMENTS: CITY OF MADISON

Total Developed Area: 43,527.6 SF Developed Area / 300 SF= 145.1 Landscape Units Landscape Units x 5 landscape points = 725.5 Total Points Required

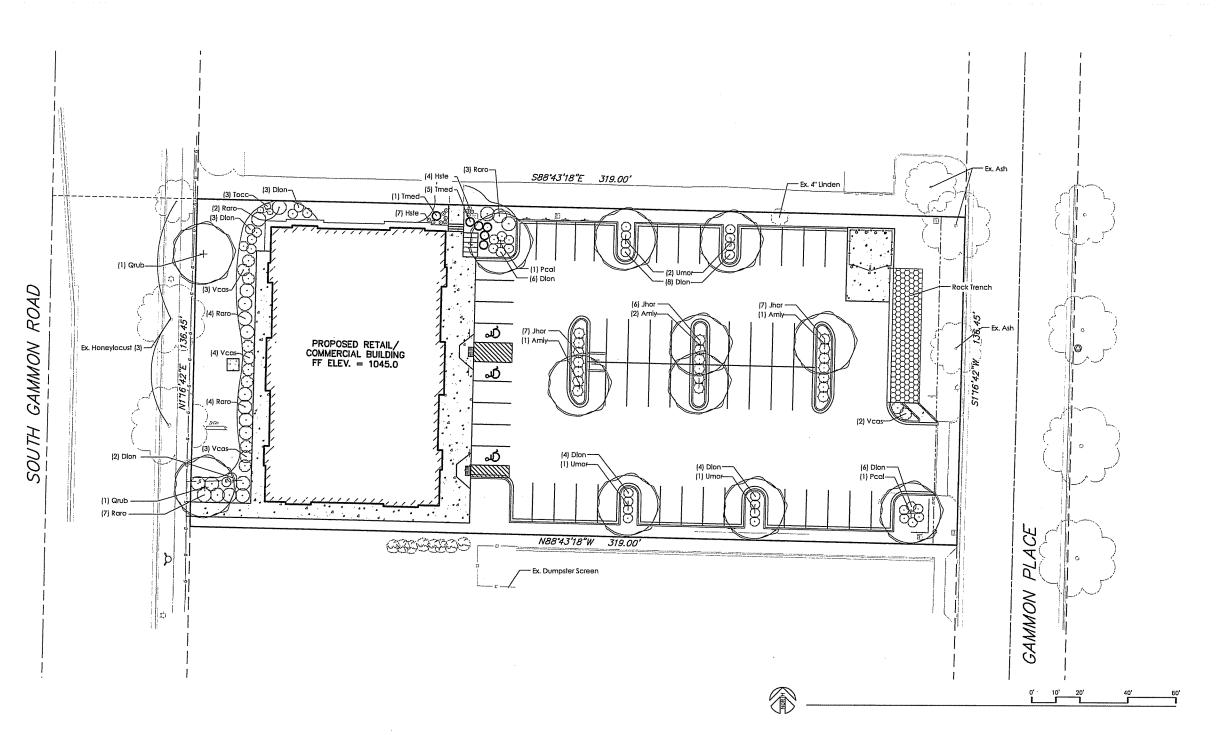Credit for Existing Landscape: 105 Points

Overstory Deciduous Tree: 3 x 35 points = 105

Total for Proposed Landscape: 665 Points

 Overstory Deciduous Tree:
 12 x 35 points = 420

 Ornamental Tree:
 0 x 15 points = 0

 Evergreen Tree:
 0 x 15 points = 0

 Deciduous Shrub:
 68 x 2 points = 136

 Evergreen Shrub:
 29 x 3 points = 87

 Perennial:
 11 x 2 points = 22

Total Points Provided: 770 Points

GENERAL NOTES:

All plantings shall conform to quality requirements as per ANSI Z60.1.

 All plant material shall be true to the species, variety and size specified, nursery grown in accordance with good horticultural practices, and under climactic conditions similar to those of the project site.

3. Contact Landscape Architect, in writing, to request and plant material substitutions due to availability issues.

4. All disturbed areas, unless otherwise noted, to be seeded with Madison Parks Mix by Olds Seed Company or equivalent, per manufacturer's specified application rates. All seeded areas are to be watered daily to maintain adequate soil moisture for proper germination. After vigorous growth is established, apply ½" water twice weekly until final acceptance.
5. All plants shall be guaranteed to be in healthy and flourishing condition during the growing season

5. All plants shall be guaranteed to be in healthy and flourishing condition during the growing season following installation. All plant material shall be guaranteed for one year from the time of installation.
6. Contractor shall provide a suitable amended topsoil blend for all planting areas where soil conditions are unsuitable for plant growth. Topsoil shall conform to quality requirements as per Section 625.2(1) of the Standard Specifications for Highway Construction. Provide a minimum of 12" of topsoil in all planting areas and 6" of topsoil in areas to be seeded/sodded.

7. Landscape beds to be mulched with undyed shredded hardwood bark mulch to 3" depth min.

8. Landscape beds to be edged with black vinyl edging, Black Diamond or equal.

Protect existing trees from damage due to construction activity.



GARY BRINK & ASSOCIATES
ARCHITECTS

8401 EXCELSIOR DRIVE MADISON, WI 53717 608-829-1750 608-829-3056 (FAX)

Vierbicher

Janners | engineers | advisors | REDSBURG - MADIXON - PRANRE DU CHIEN | PROPERTIES |


PROJECT:
420 GAMMON PLACE
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420 GAMMON PLACE
MADISON, WI 53719
CLENT:
PARK TOWNE DEVELOPMENT
402 GAMMON PLACE, SUITE 300
MADISON, WI 53719

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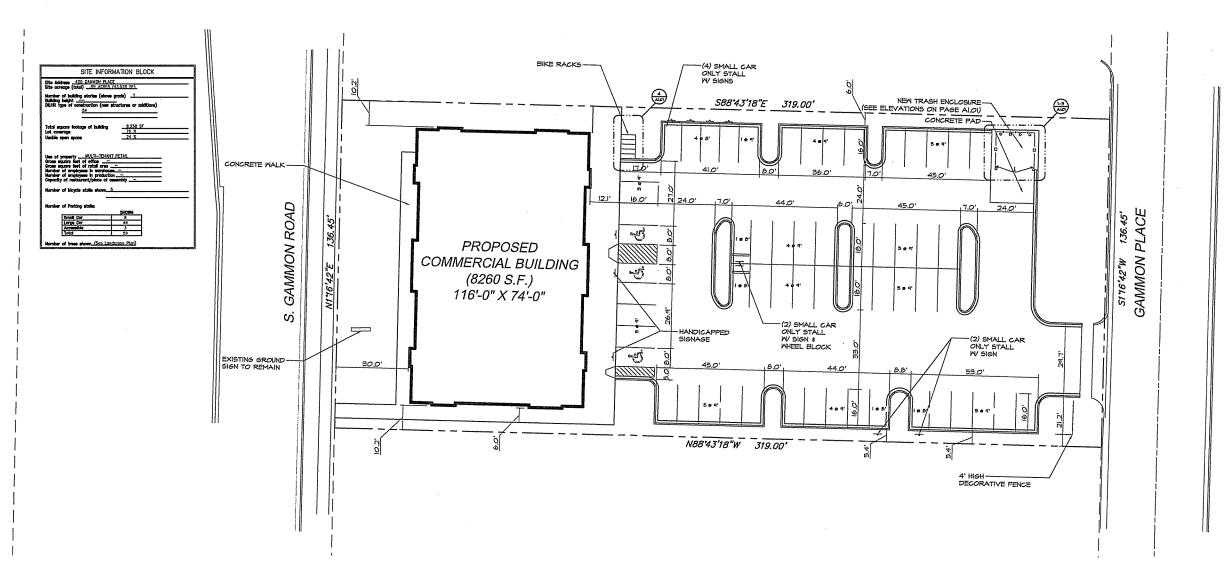
> LANDSCAPE PLAN

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DEVELOPMENT PROJECT: 420 GAMMON PLACE 1.1ENT:
PARK TOWNE I
02 GAMMON PLACE, SUITE 300
IADISON, WI 53719

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PROJECT: 201211 DRAWN BY: KD DATE: SCALE: AS NOTED

PRELIMINAR Ø5.23.2ØB BUBMITTAL *06.0*5.2013

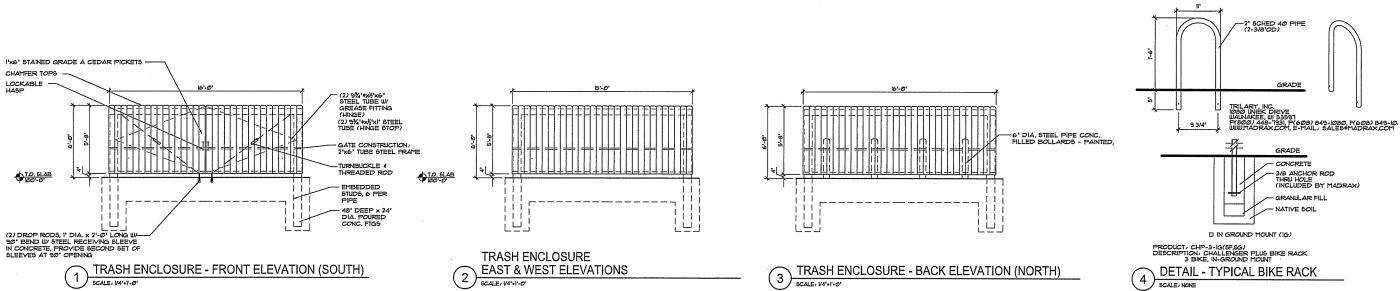
REVISED SITE PLAN 06242013

SITE PLAN

A1.01

SITE PLAN

8401 EXCELSIOR DRIVE MADISON, WI 53717 608-829-1750 608-829-3056 (FAX)

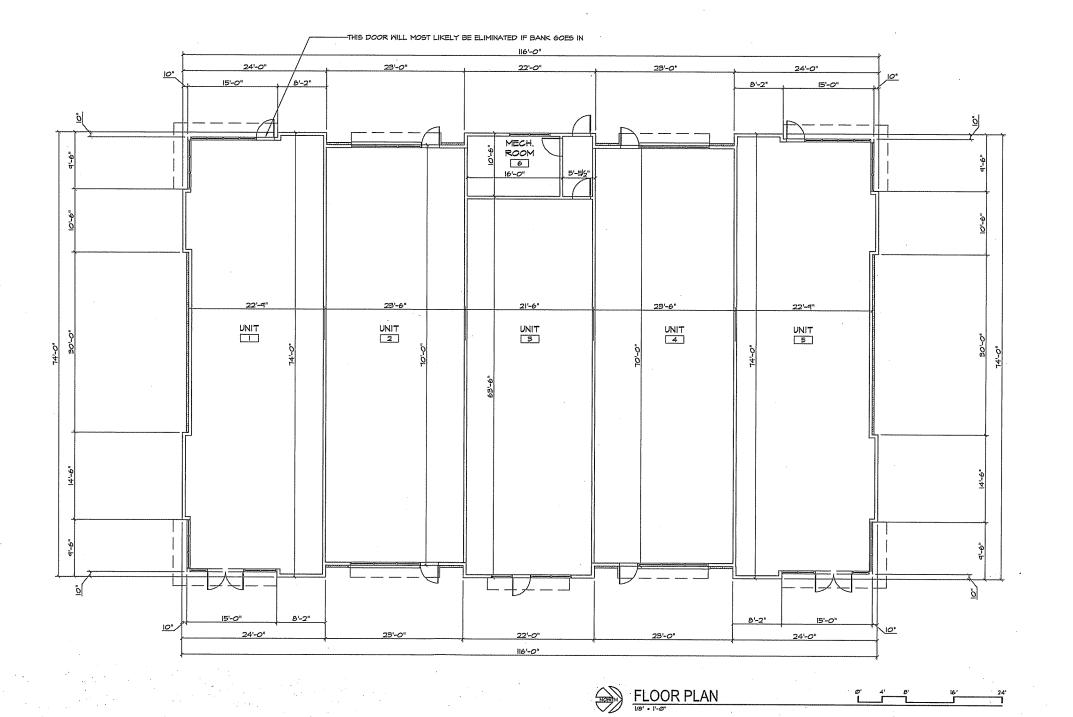



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DRAWN BY:

FLOOR PLAN

A2.01



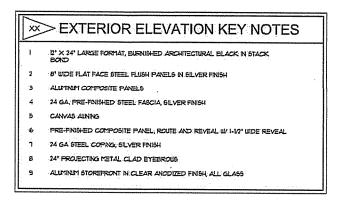

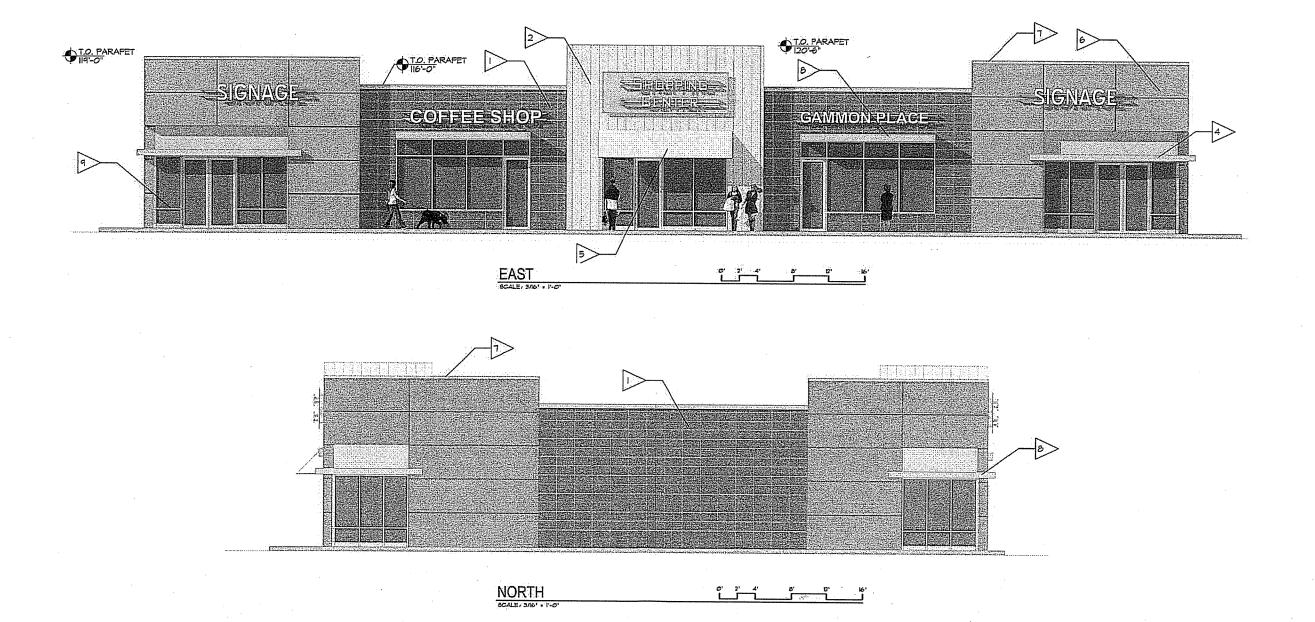

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8401 EXCELSIOR DRIVE MADISON, WI 53717 .608-829-1750 608-829-3056 (FAX)

IADISON, WI 53717 608-829-1750 608-829-3056 (FAX)

20 GAMMON PLACE
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ARK TOWNE DEVELOPMENT
OSON, WI 53719
OSON, WI 53719

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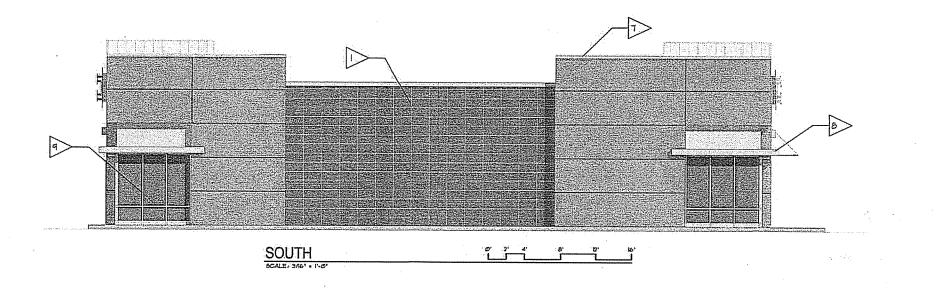
PROJECT: 201211
DRAWN BY: KD
DATE:
SCALE: AS NOTED
PRELINARY 0923203

EXTERIOR ELEVATIONS

A6.01

- 2' X 24' LARGE FORMAT, BURNISHED ARCHITECTURAL BLACK IN STACK BOXD
- 8' UIDE FLAT FACE STEEL FLUSH PANELS IN SILVER FINISH
- 24 GA, FRE-FNISHED STEEL FASCIA, SILVER FINISH
- PRE-FINISHED COMPOSITE PANEL, ROUTE AND REVEAL W/1-1/2" WIDE REVEAL
- 24 GA STEEL COPNG, SILVER FINISH
- 24' PROJECTING METAL CLAD EYEBROUS
- ALLMINIM STOREFRONT IN CLEAR ANODIZED FINISH, ALL GLASS







GARY BRINK & ASSOCIATES ARCHITECTS

8401 EXCELSIOR DRIVE MADISON, WI 53717 608-829-1750 608-829-3056 (FAX)

PARK TOWNE DEVELOPMENT 102 GAMMON PLACE, SUITE 300 PROJECT:
420 GAMMON PLACE
420 GAMMON PLACE
MADISON, WI 53719

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DATE: SCALE:

06.253.53

AS NOTED

EXTERIOR **ELEVATIONS**

A6.02