# APPLICATION FOR URBAN DESIGN COMMISSION REVIEW AND APPROVAL

AGENDA ITEM #	
<b>Project</b> #	

DATE SUBMITTED: May	y 1, 2013	Action Requested Informational Presentation
UDC MEETING DATE: May	y 8, 2013	Initial Approval and/or Recommendation x Final Approval and/or Recommendation
PROJECT ADDRESS: 1924	Atwood Avenue	
ALDERMANIC DISTRICT: Marsha Rummel- District #6		
OWNER/DEVELOPER (Parts	ners and/or Principals)	ARCHITECT/DESIGNER/OR AGENT:
Scott Lewis/CMI Manageme	ent, Inc.	Knothe & Bruce Architects, LLC
121 S. Pinckney Street, Suite	200	7601 University Avenue, Suite 201
Madison, WI 53703		Middleton, Wisconsin 53562
CONTACT PERSON: J. Randy Bruce/Knothe & Bruce Architects, LLC		
Address: 7601 Un	iversity Avenue, Suite 201	
Middlete	on, Wisconsin 53562	
Phone: <u>608-836</u>	-3690	
Fax:608-836	-6934	
E-mail address: <u>rbruce@</u>	knothebruce.com	
TYPE OF PROJECT:  (See Section A For:)  X Planned Unit Development (PUD)  — General Development Plan (GDP)  x Specific Implementation Plan (SIP)  — Planned Community Development (PCD)  — General Development Plan (GDP)  — Specific Implementation Plan (SIP)  — Planned Residential Development (PRD)  — New Construction or Exterior Remodeling in an Urban Design District* (A public hearing is required as well as a fee)  — School, Public Building or Space (Fee may be required)  — New Construction or Addition to or Remodeling of a Retail, Hotel, or Motel Building Exceeding 50,000 Sq.Ft.  — Planned Commercial Site  (See Section B for:)		
New Construction or Exterior Remodeling in C4 District (Fee required)		
(See Section C for:)  R.P.S.M. Parking Variance	e (Fee required)	
(See Section D for:)  — Comprehensive Design Re — Street Graphics Variance*		
— Other *Public Hearing Required (Subm	nission Deadline 3 Weeks in Ac	Ivance of Meeting Date)



March 20, 2013

Mr. Bill Fruhling
Department of Planning & Development
City of Madison
215 Martin Luther King Jr. Blvd.
PO Box 2985
Madison, Wisconsin 53701

Re:

Letter of Intent

PUD-SIP Submittal 1924 Atwood Ave. Madison, WI

Dear Mr. Fruhling,

The following is submitted together with the plans, application and zoning text for staff, Plan Commission and Common Council consideration of approval.

#### Organizational structure:

Owner:

CMI Management, Inc.

121 S. Pinckney St, Suite 200

Madison, WI 53703 (608) 256-4200 Contact: Scott Lewis

scott@cmimanagement.net

Engineer:

Vierbicher Associates, Inc.

999 Fourier Drive, Suite 201

Madison, WI 53717 (608) 826-0532 Contact: Joe Doyle idoy@vierbicher.com Architect:

Knothe & Bruce Architects, LLC

7601 University Ave, Ste 201

Middleton, WI 53562 (608) 836-3690 (608) 836-6934 Fax Contact: Randy Bruce rbruce@knothebruce.com

Landscape Design:

ndscape Ken Saiki Design

303 S. Paterson St. Suite 1

Madison, WI 53703 (608)251-3600

Contact: Abbie Moilien amoilien@ksd-la.com

Letter of Intent 1924 Atwood Avenue March 20, 2013 Page 2 of 3

#### Introduction:

The subject development is located on Atwood Avenue just east of South First Street and is part of a two-phase PUD-GDP. The first phase of the development, located just southwest of the subject site, is a 39-unit apartment building with first floor retail and office space. This second phase of the development is a four story 50-unit apartment building with underground parking.

The site is currently occupied by a parking lot. To the northeast of the proposed site is an existing single family house and to the northwest of the proposed site is an active railroad track and a future pedestrian/bike corridor. Across the street on Atwood lies the Trinity Lutheran Church and associated parking lot.

The original PUD-GDP was approved in 2004 which provided for 39 dwelling units in Phase 1 and 50 dwelling units in Phase 2. A PUD-SIP for the first phase was submitted soon after the GDP for the first phase of the development consisting of 39 dwelling units.

#### **Project Description:**

The proposed development is a 4-story, 50-unit apartment building with a mix of efficiency, one bedroom, one bedroom plus den, and two bedroom apartments, with 49 underground parking stalls.

## Site Development Data:

### Densities:

Lot Area 36,870 sf or 0.846 acres

Dwelling Units 50 units

Lot Area per Dwelling Unit 737 sf

Density 59 du/acre

#### **Dwelling Unit Mix:**

 Studio Apartments
 6

 One-Bedroom
 33

 One-Bedroom + Den
 2

 Two-Bedroom
 9

 Total
 50

Building Height: 4 Stories

Floor Area:

Gross Floor Area 46,238 sf Floor Area Ratio: 1.25

Vehicle Parking Stalls:

Underground49 Stalls (incl. 1 accessible)Surface5 Stalls (incl. 1 accessible)Total Parking54 Stalls (incl. 2 accessible)

Letter of Intent 1924 Atwood Avenue March 20, 2013 Page 3 of 3

# Bicycle Parking Stalls:

Underground 42 Stalls
Surface 10 Stalls
Total Bike Parking 52 Stalls

# **Project Schedule:**

Construction is scheduled to begin in August 2013 and will be completed in August 2014.

# Social & Economic Impacts:

This development will have a positive social and economic impact. The proposed development will provide much needed housing to the neighborhood and the added residents will support the local business district. Construction of the buildings will also provide economic employment for local businesses and trades people.

Thank you for your time in reviewing our proposal.


Very Truly Yours,


J. Randy Bruce, AIA Managing Member Zoning Text PUD-SIP 1924 Atwood Avenue March 20, 2013

**Legal Description:** Lot 2, Certified Survey Map Number 11334 as recorded in Volume 68 of Certified Survey Maps, on Pages 291-296 as Document Number 4024297, Dane County Registry, located in the SE¼-SW¼ of Section 06, and the NE¼-NW¼ of Section 07, all in Township 07 North, Range 10 East, City of Madison, Dane County, Wisconsin. Said description contains 36,857 square feet or 0.846 acres more or less.

- A. **Statement of Purpose:** This zoning district is established to allow for a mixed-use development with 89 dwelling units and approximately 7,775 square feet of commercial space.
- B. **Permitted Uses:** Following are permitted uses within this P.U.D.
  - 1. Multifamily residential uses as shown on the approved plans.
  - 2. Uses as allowed in the TSS District.
  - 3. Accessory uses including but not limited to:
    - a. Accessory uses directly associated with those permitted uses, including parking for residents and guests.
    - b. Temporary buildings for storage of building materials and equipment for construction purposes when on the same lot as a principle use for a period of time not to exceed the duration of such construction.
- C. Lot Area: As shown on the approved plans.
- D. Height Regulations: As shown on the approved plans.
- E. Yard Regulations: As shown on the approved plans.
- F. Landscaping: Site landscaping will be provided as shown on the approved plans
- G. **Usable Open Space Requirements:** Usable open space will be provided as shown on the approved plans.
- H. Parking & Loading: Off-street parking shall be provided as shown on the approved plans.
- I. *Family Definition:* The family definition shall coincide with the definition in the TR-U2 zoning district.
- J. **Signage:** Signage will be allowed as approved.
- K. Alterations and Revisions: No alteration or revision of the Planned Unit Development shall be permitted unless approved by the City Plan Commission, however, the zoning administrator may issue permits for minor alterations or additions which are approved by the Architectural Review Committee, Director of Planning and Development and the alderperson of the district and are compatible with the concept approved by the City Plan Commission.



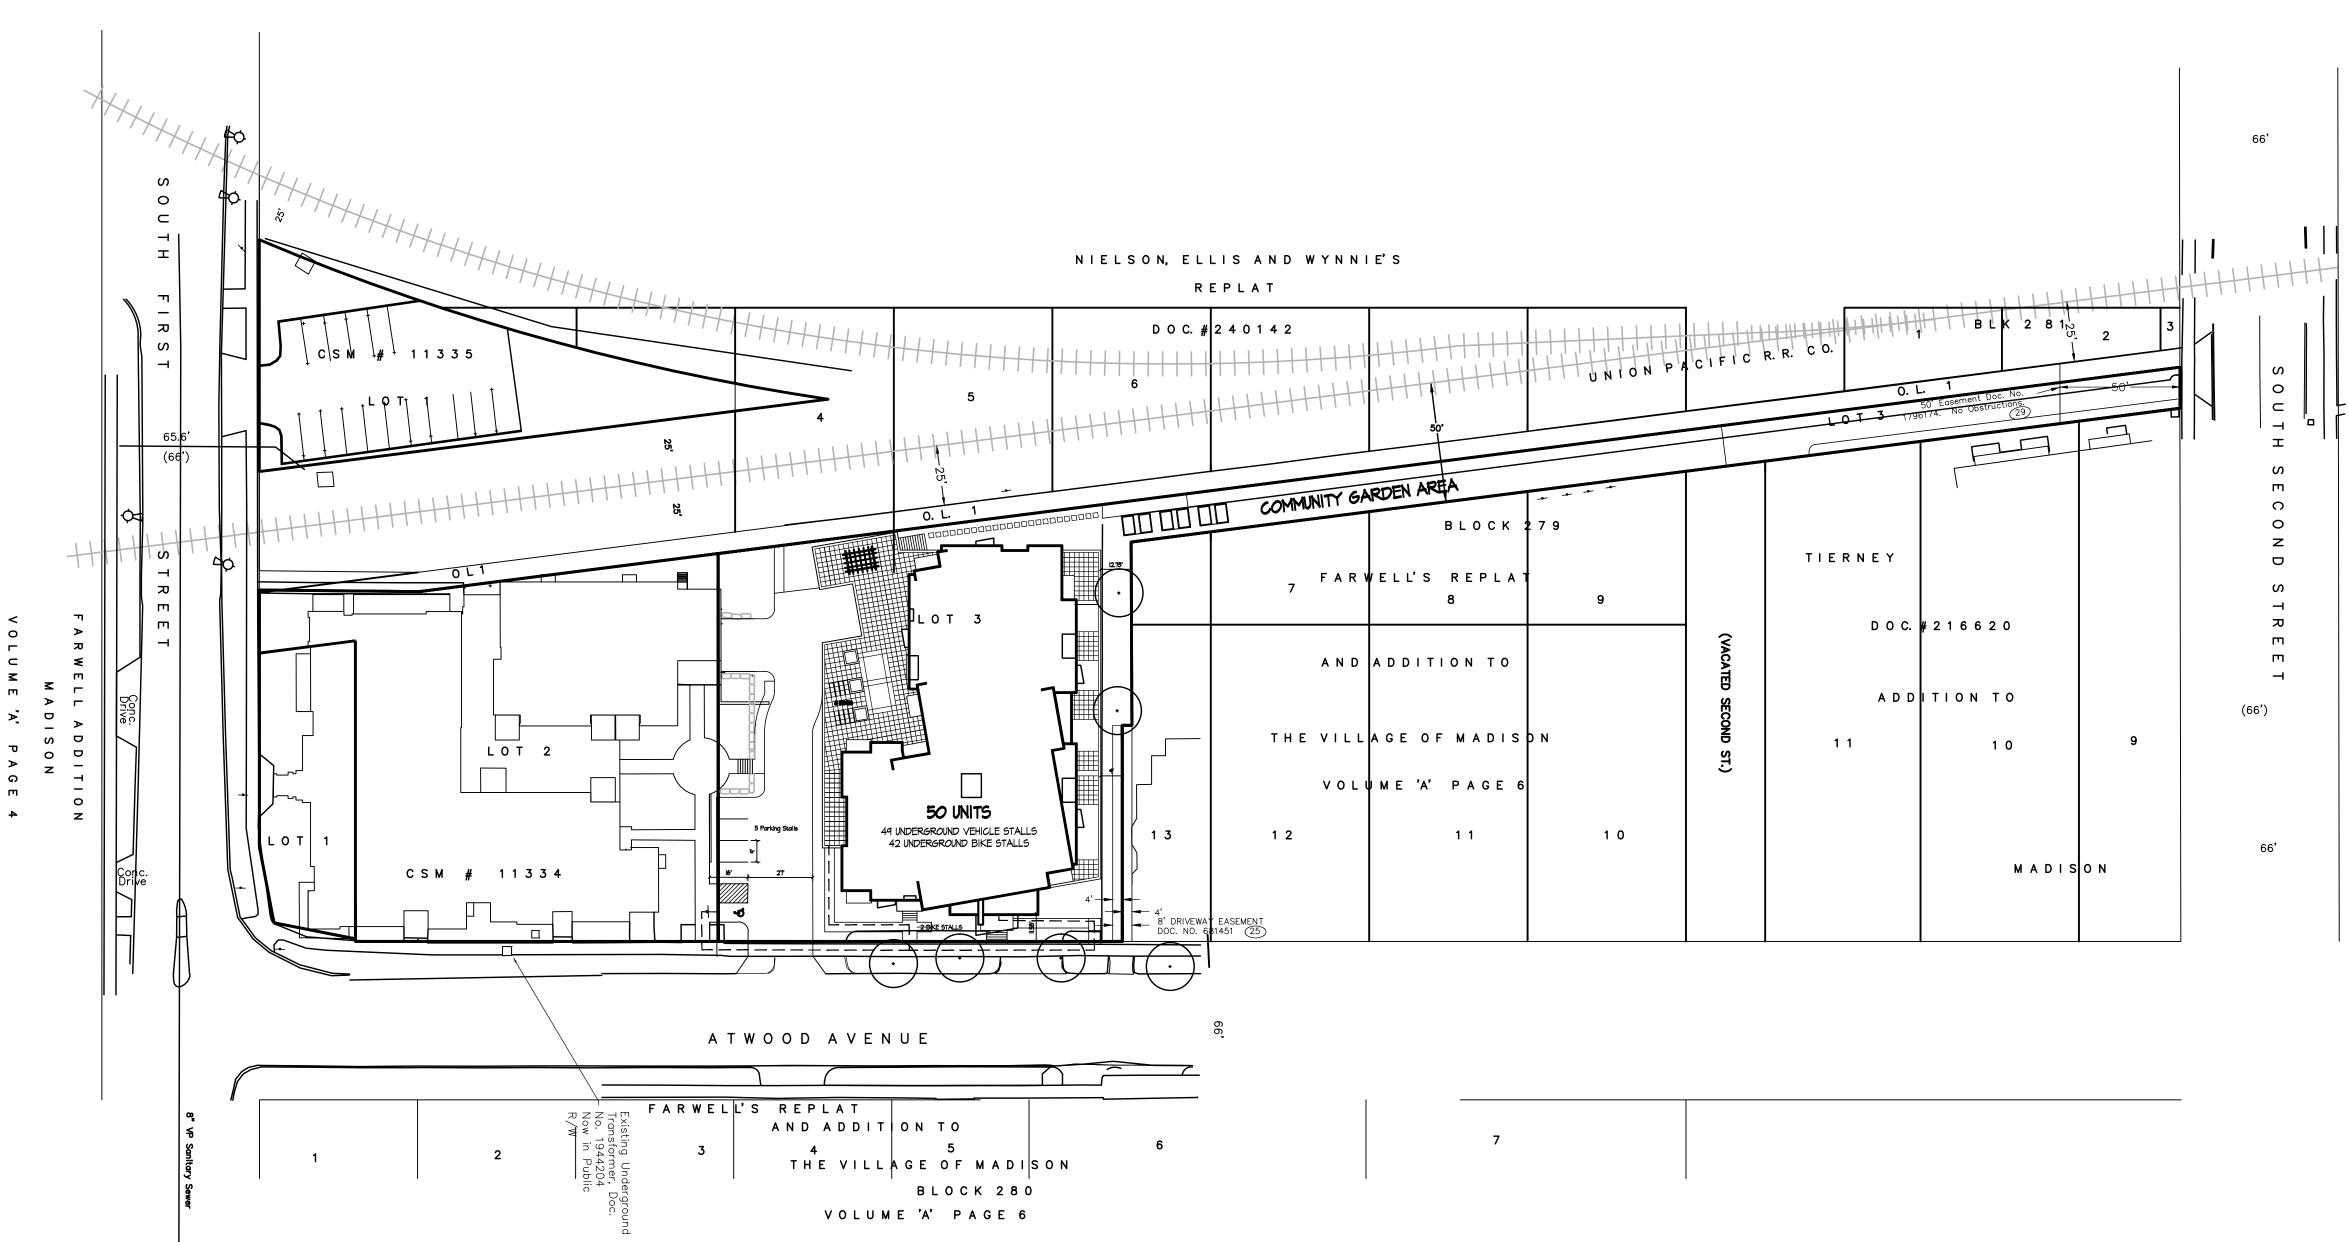

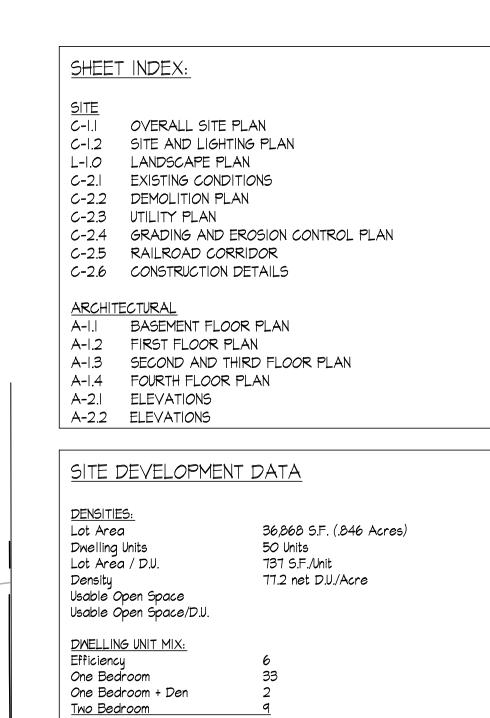

49 Stalls

5 Stalls 54 Stalls

52

1.08 Stalls/D.U.

Total

VEHICLE PARKING

Underground

BIKE PARKING

<u>Underground</u>

<u>Surface</u> Total

Ratio

Surface

Total

ARCHITECTS
7601 University Avenue Suite 201
Middleton, Wisconsin 53562
608-836-3690 Fax 836-6934

Consultant

Notes
-


Revisions PUD-SIP Submittal - March 20, 2013

Project Title
Atwood Avenue

1924 Atwood Avenue
Drawing Title

Overall Site Plan

This document contains confidential or proprietary information of Knothe & Bruce Architects. Neither the document nor the information herein is to be reproduced, distributed, used, or disclosed, either in whole or in part, except as specifically authorized by Knothe & Bruce Architects. Knothe & Bruce Architects is a Limited Liability Company of Wisconsin.

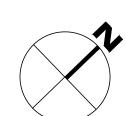

Overall Site Plan





7601 University Avenue Suite 201 Middleton, Wisconsin 53562 608-836-3690 Fax 836-6934

Revisions

PUD-SIP Submittal - March 20, 2013

Project Title


Atwood Avenue


1924 Atwood Avenue
Drawing Title
Site Plan


Project No.


Drawing No.


A-1.X

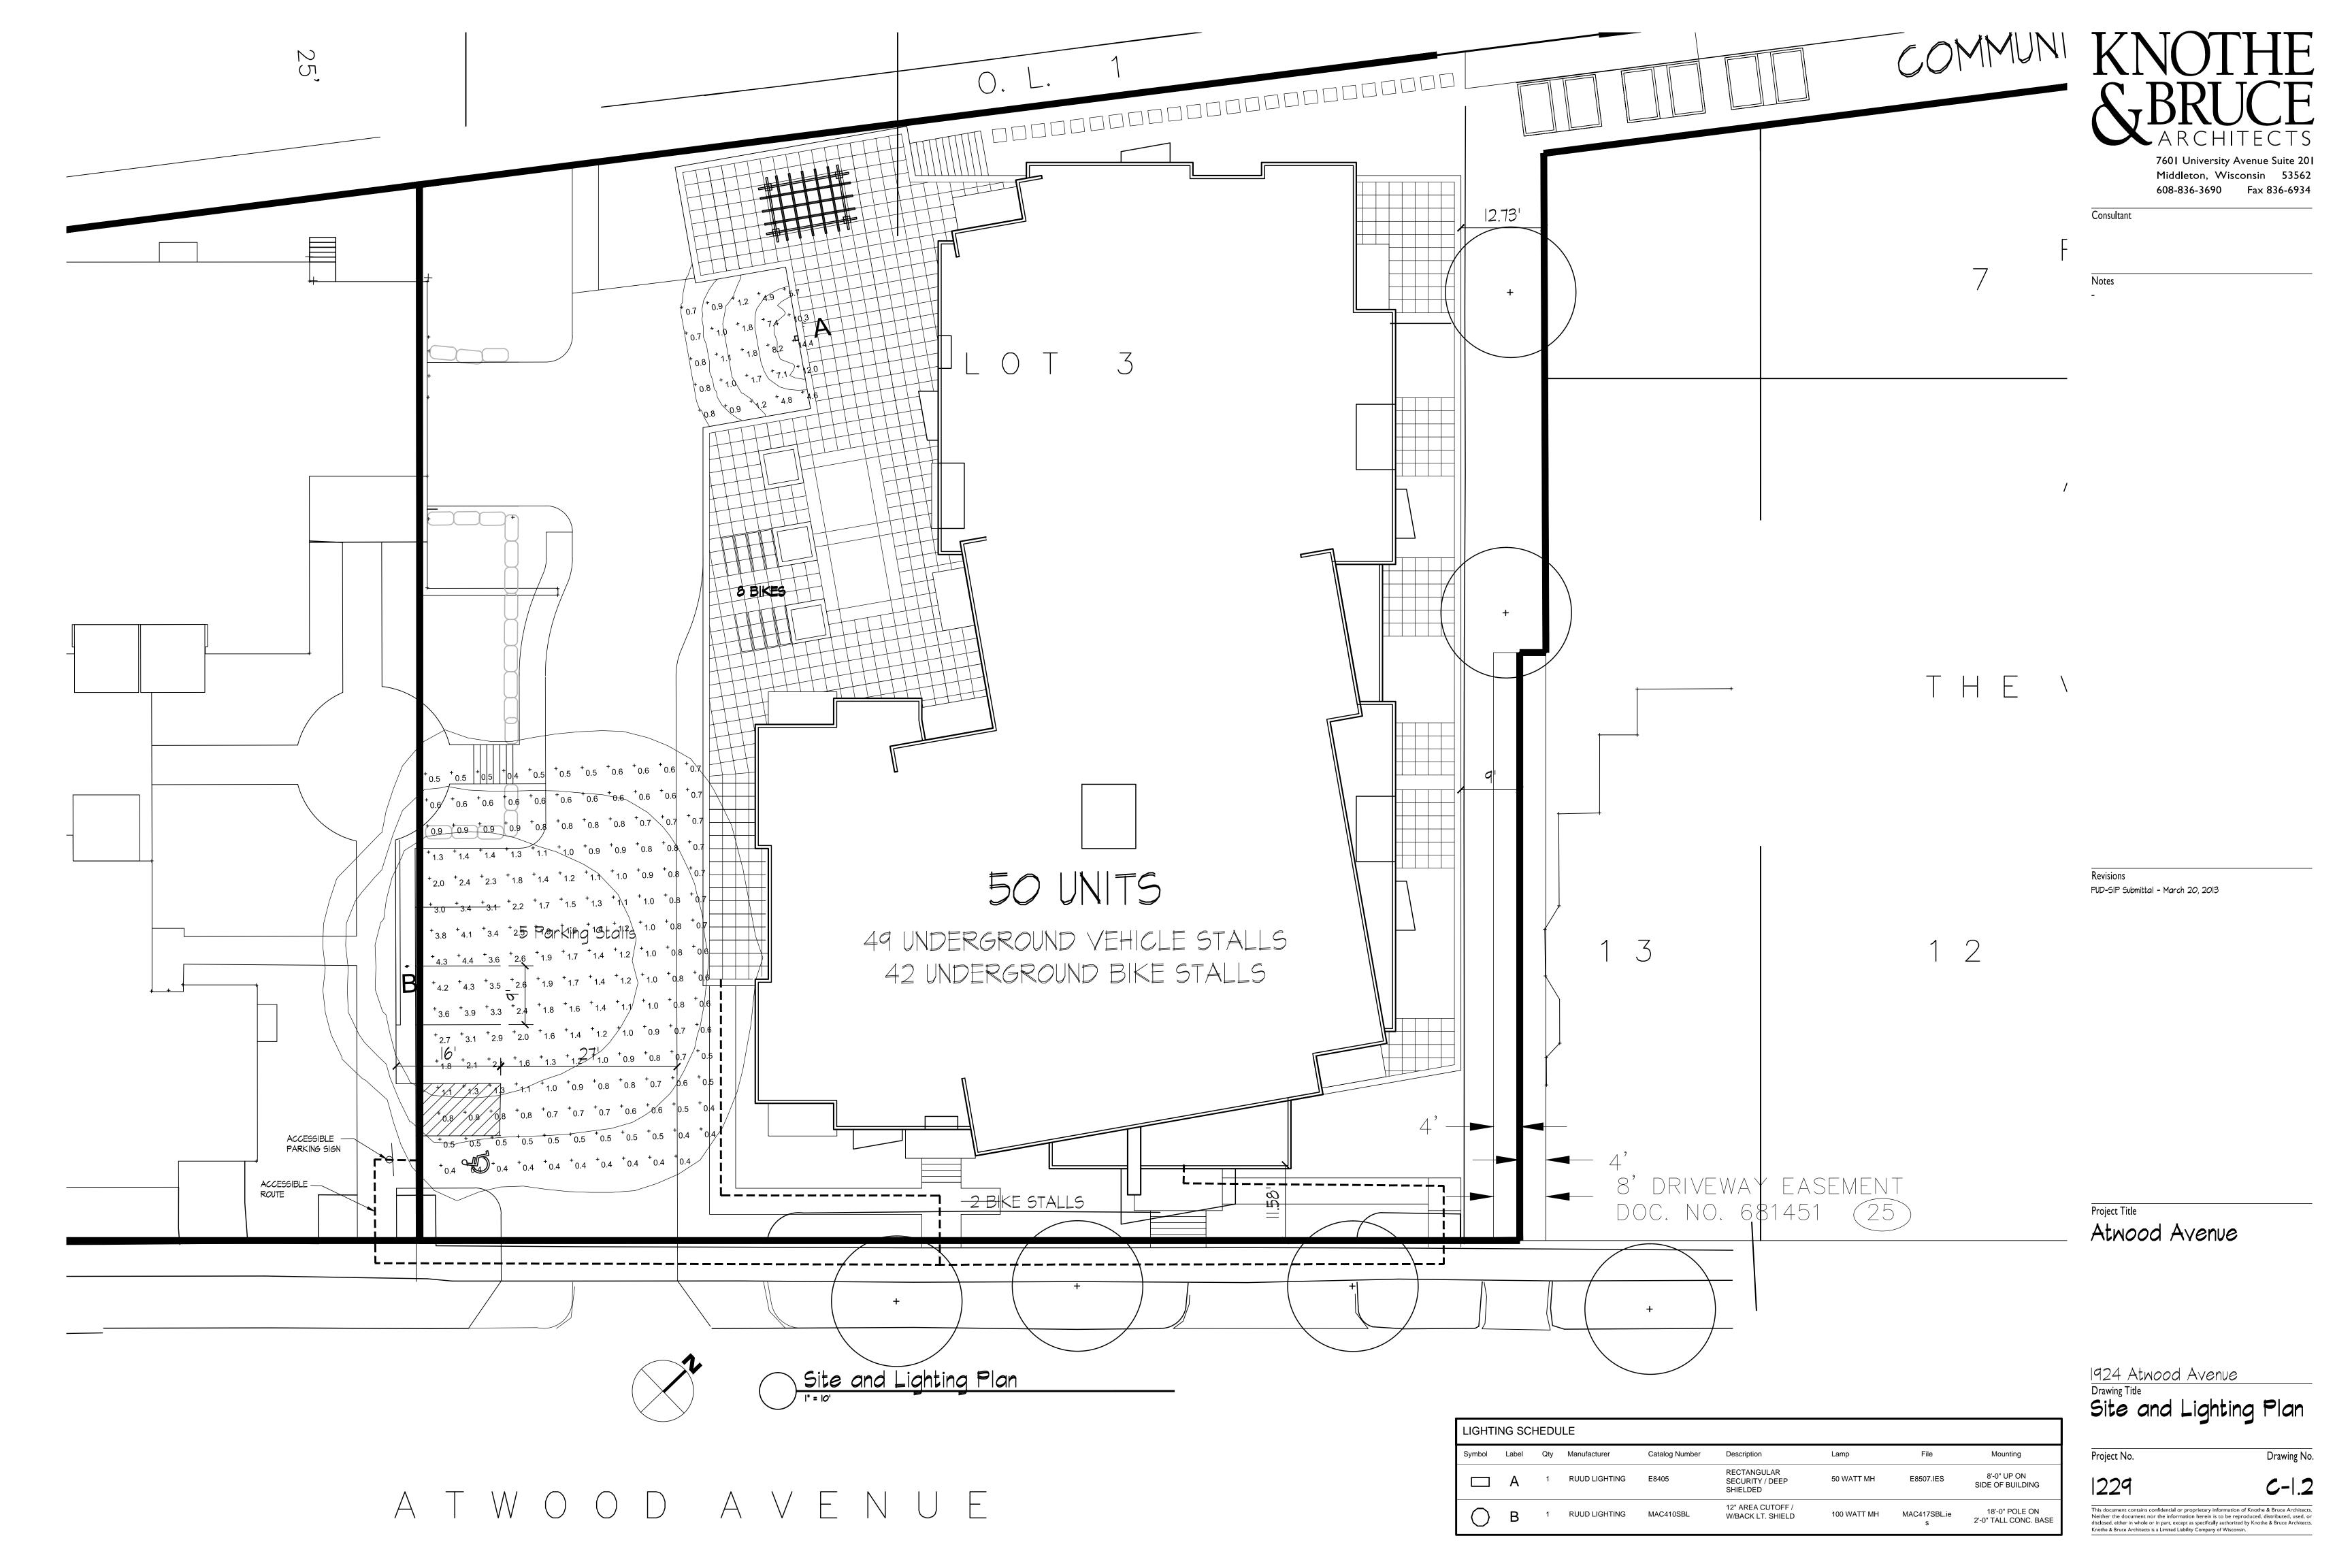


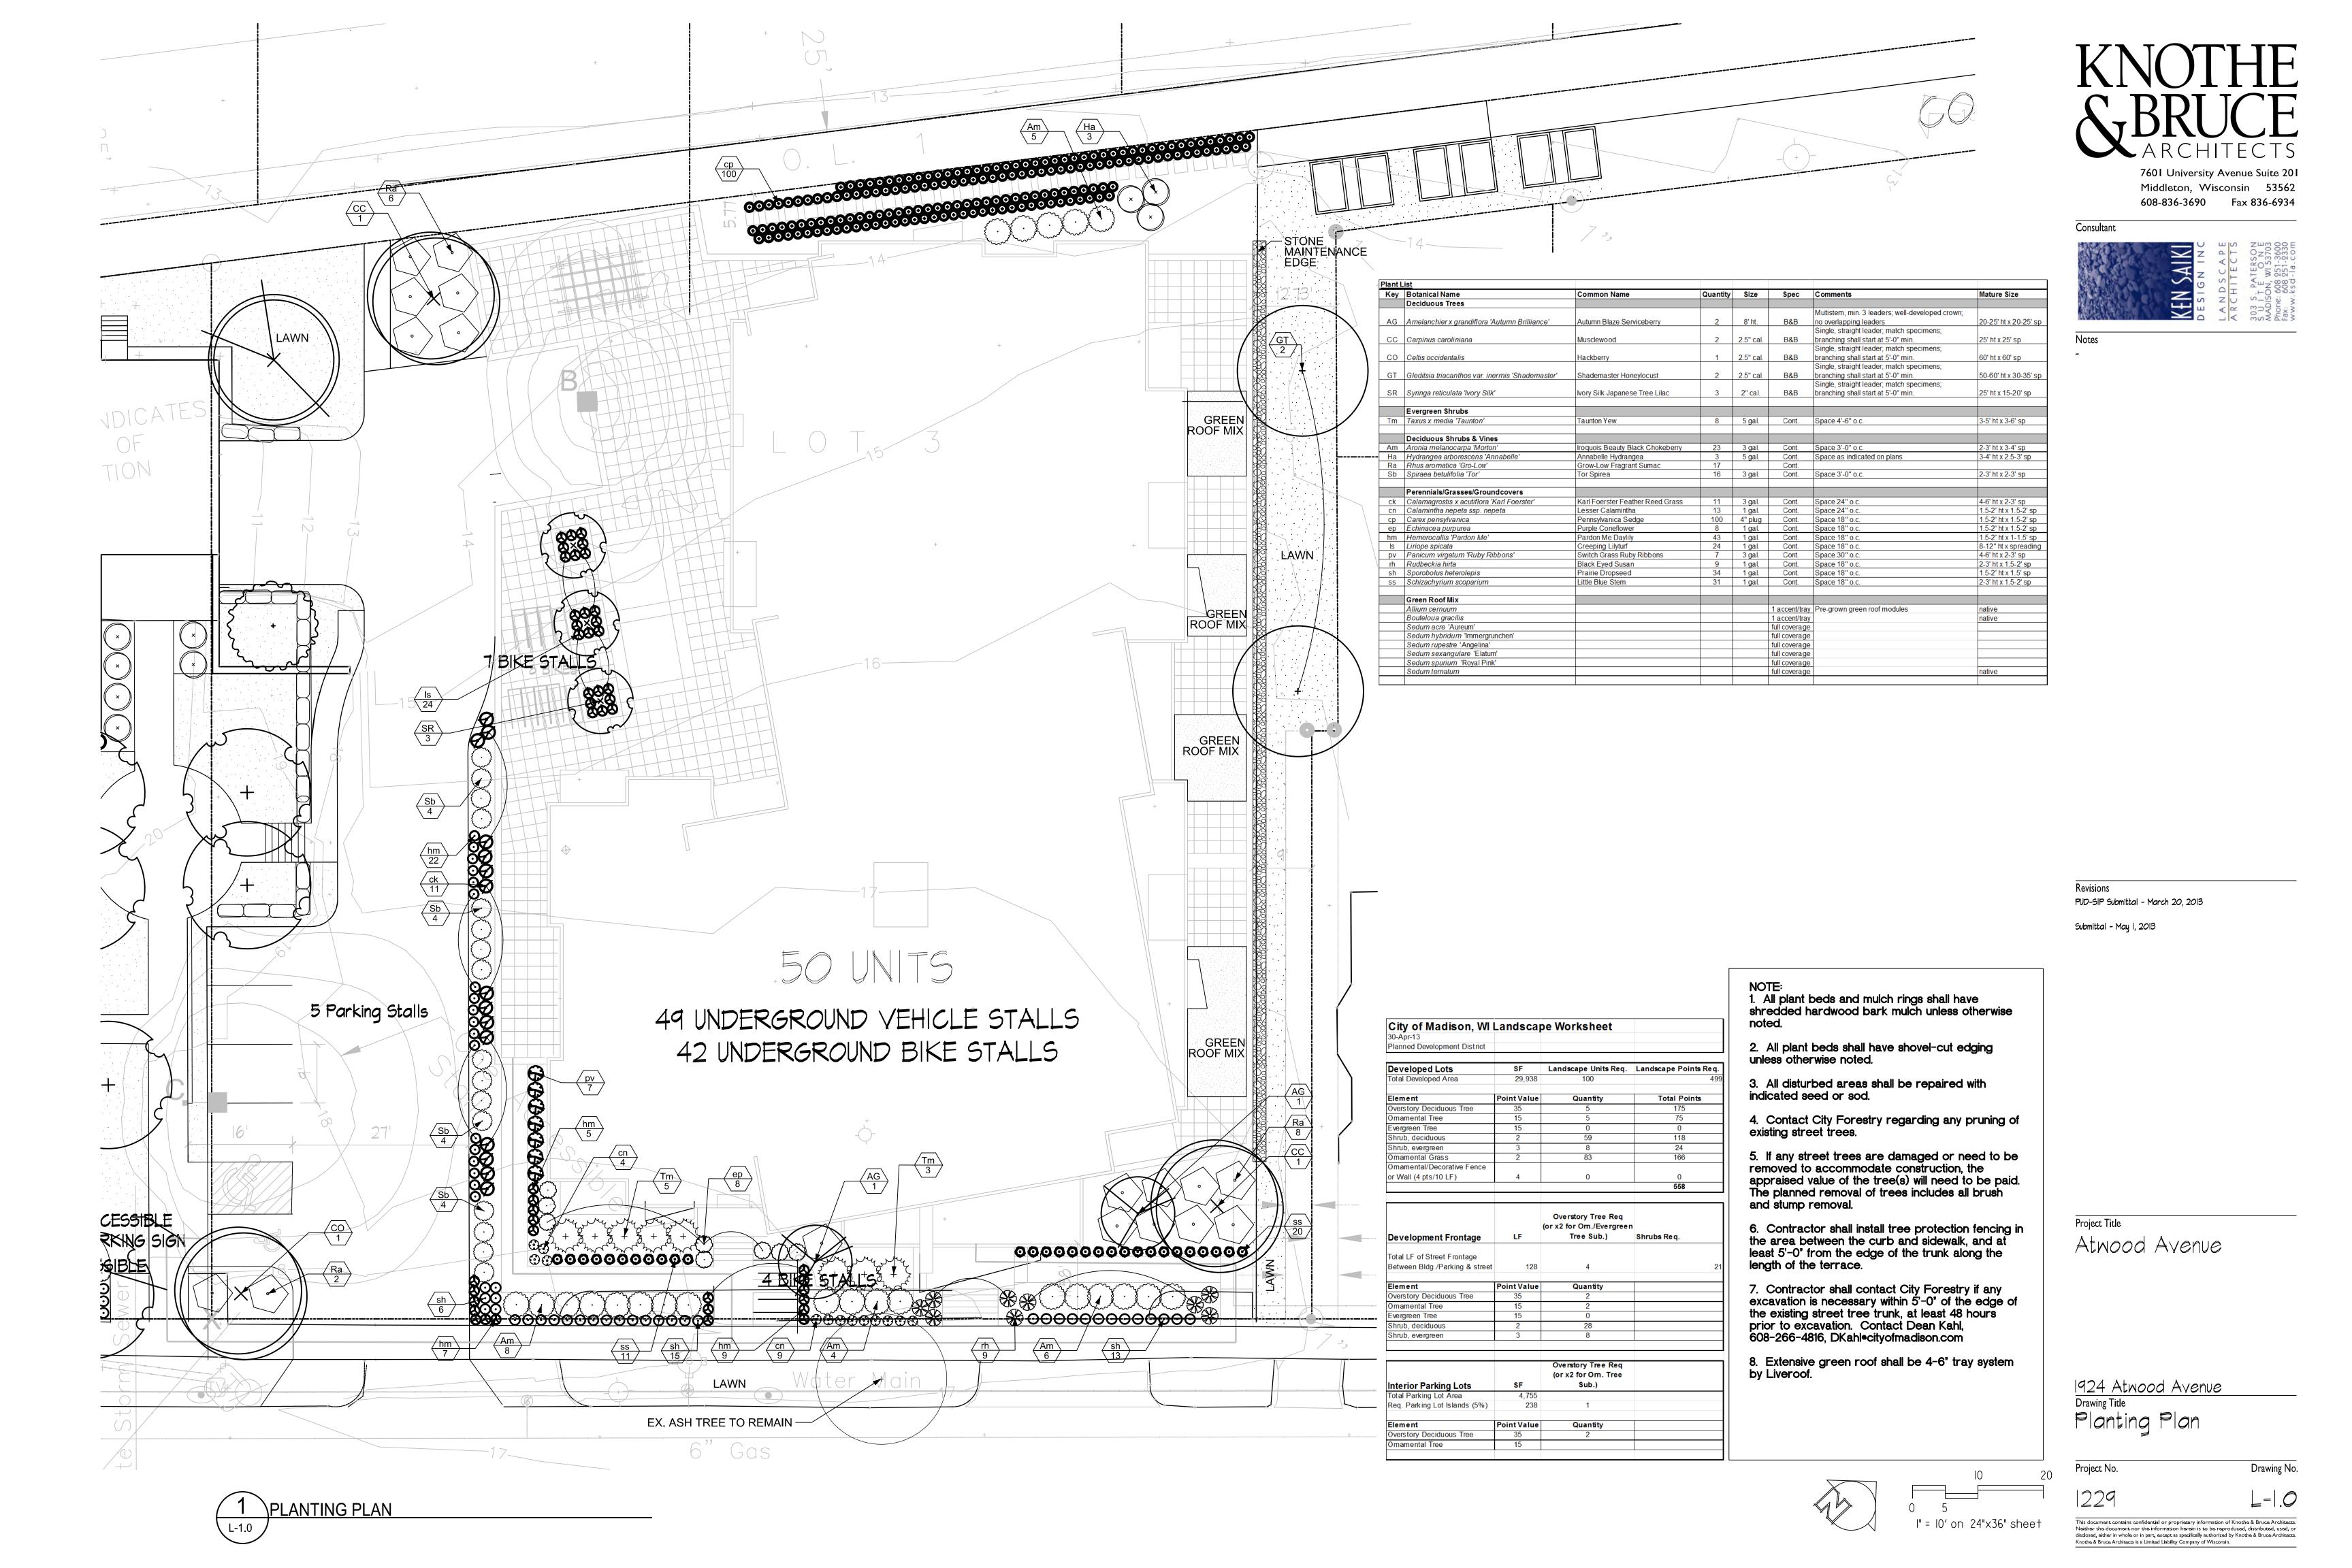


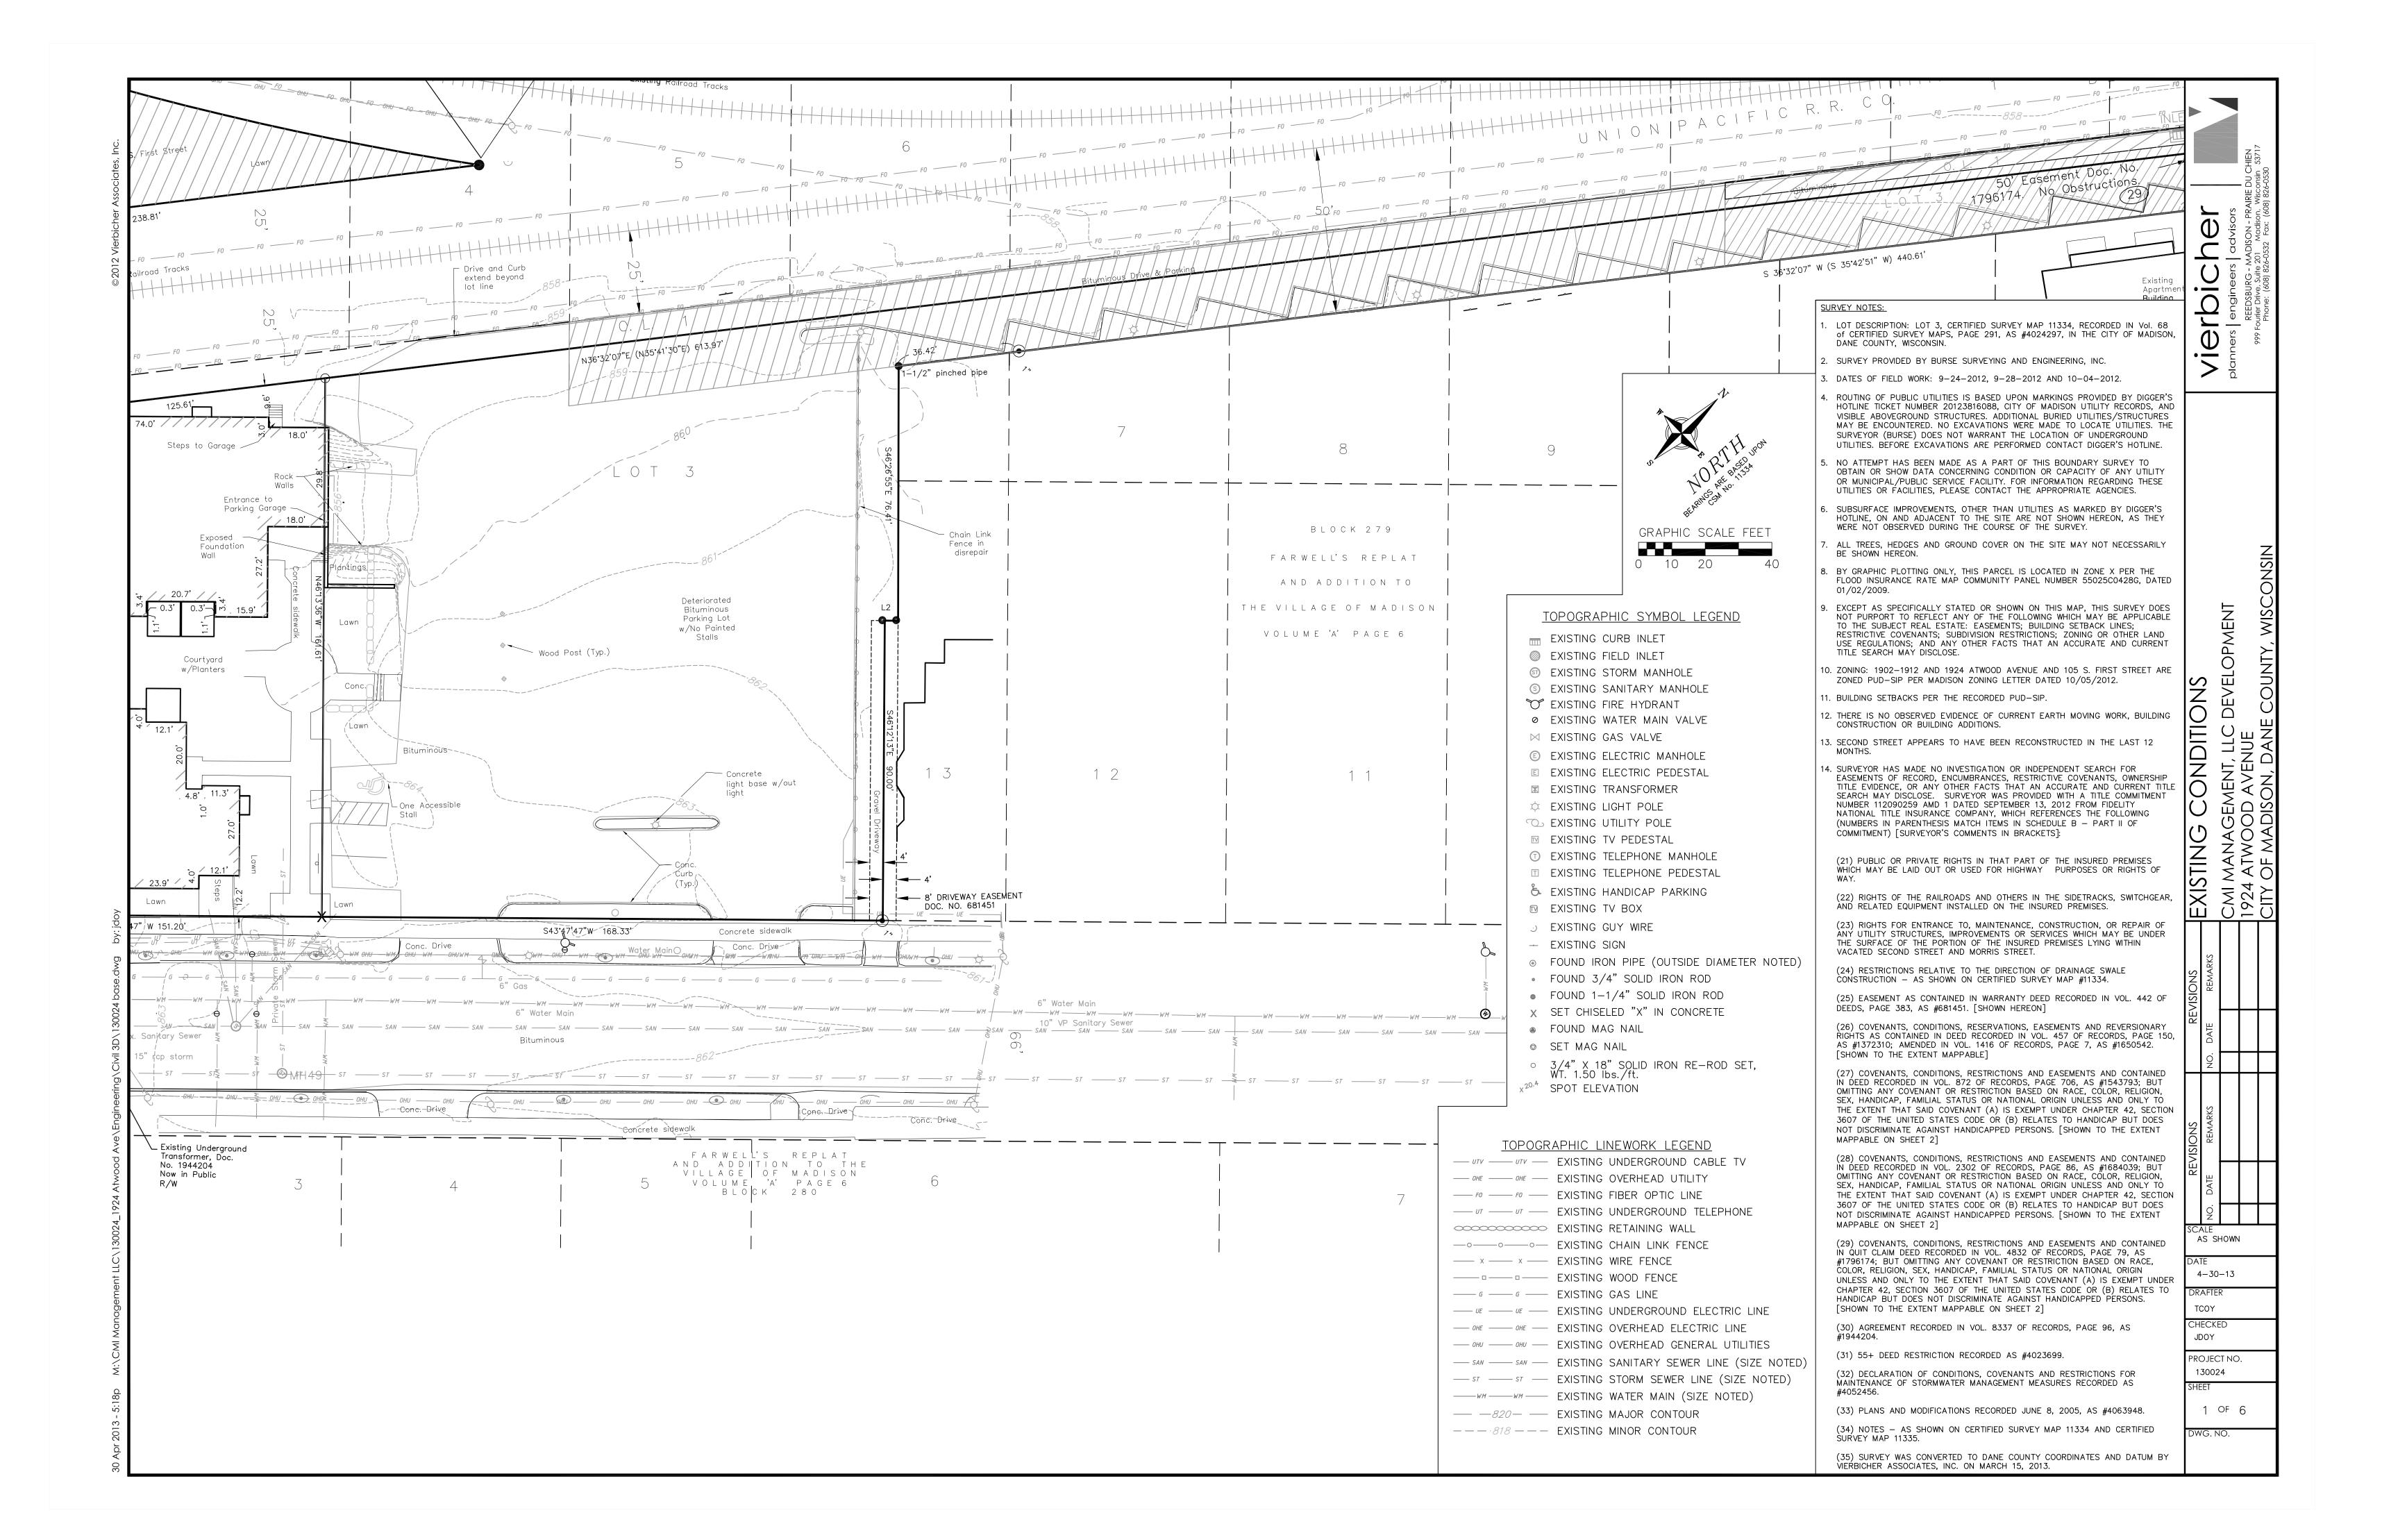

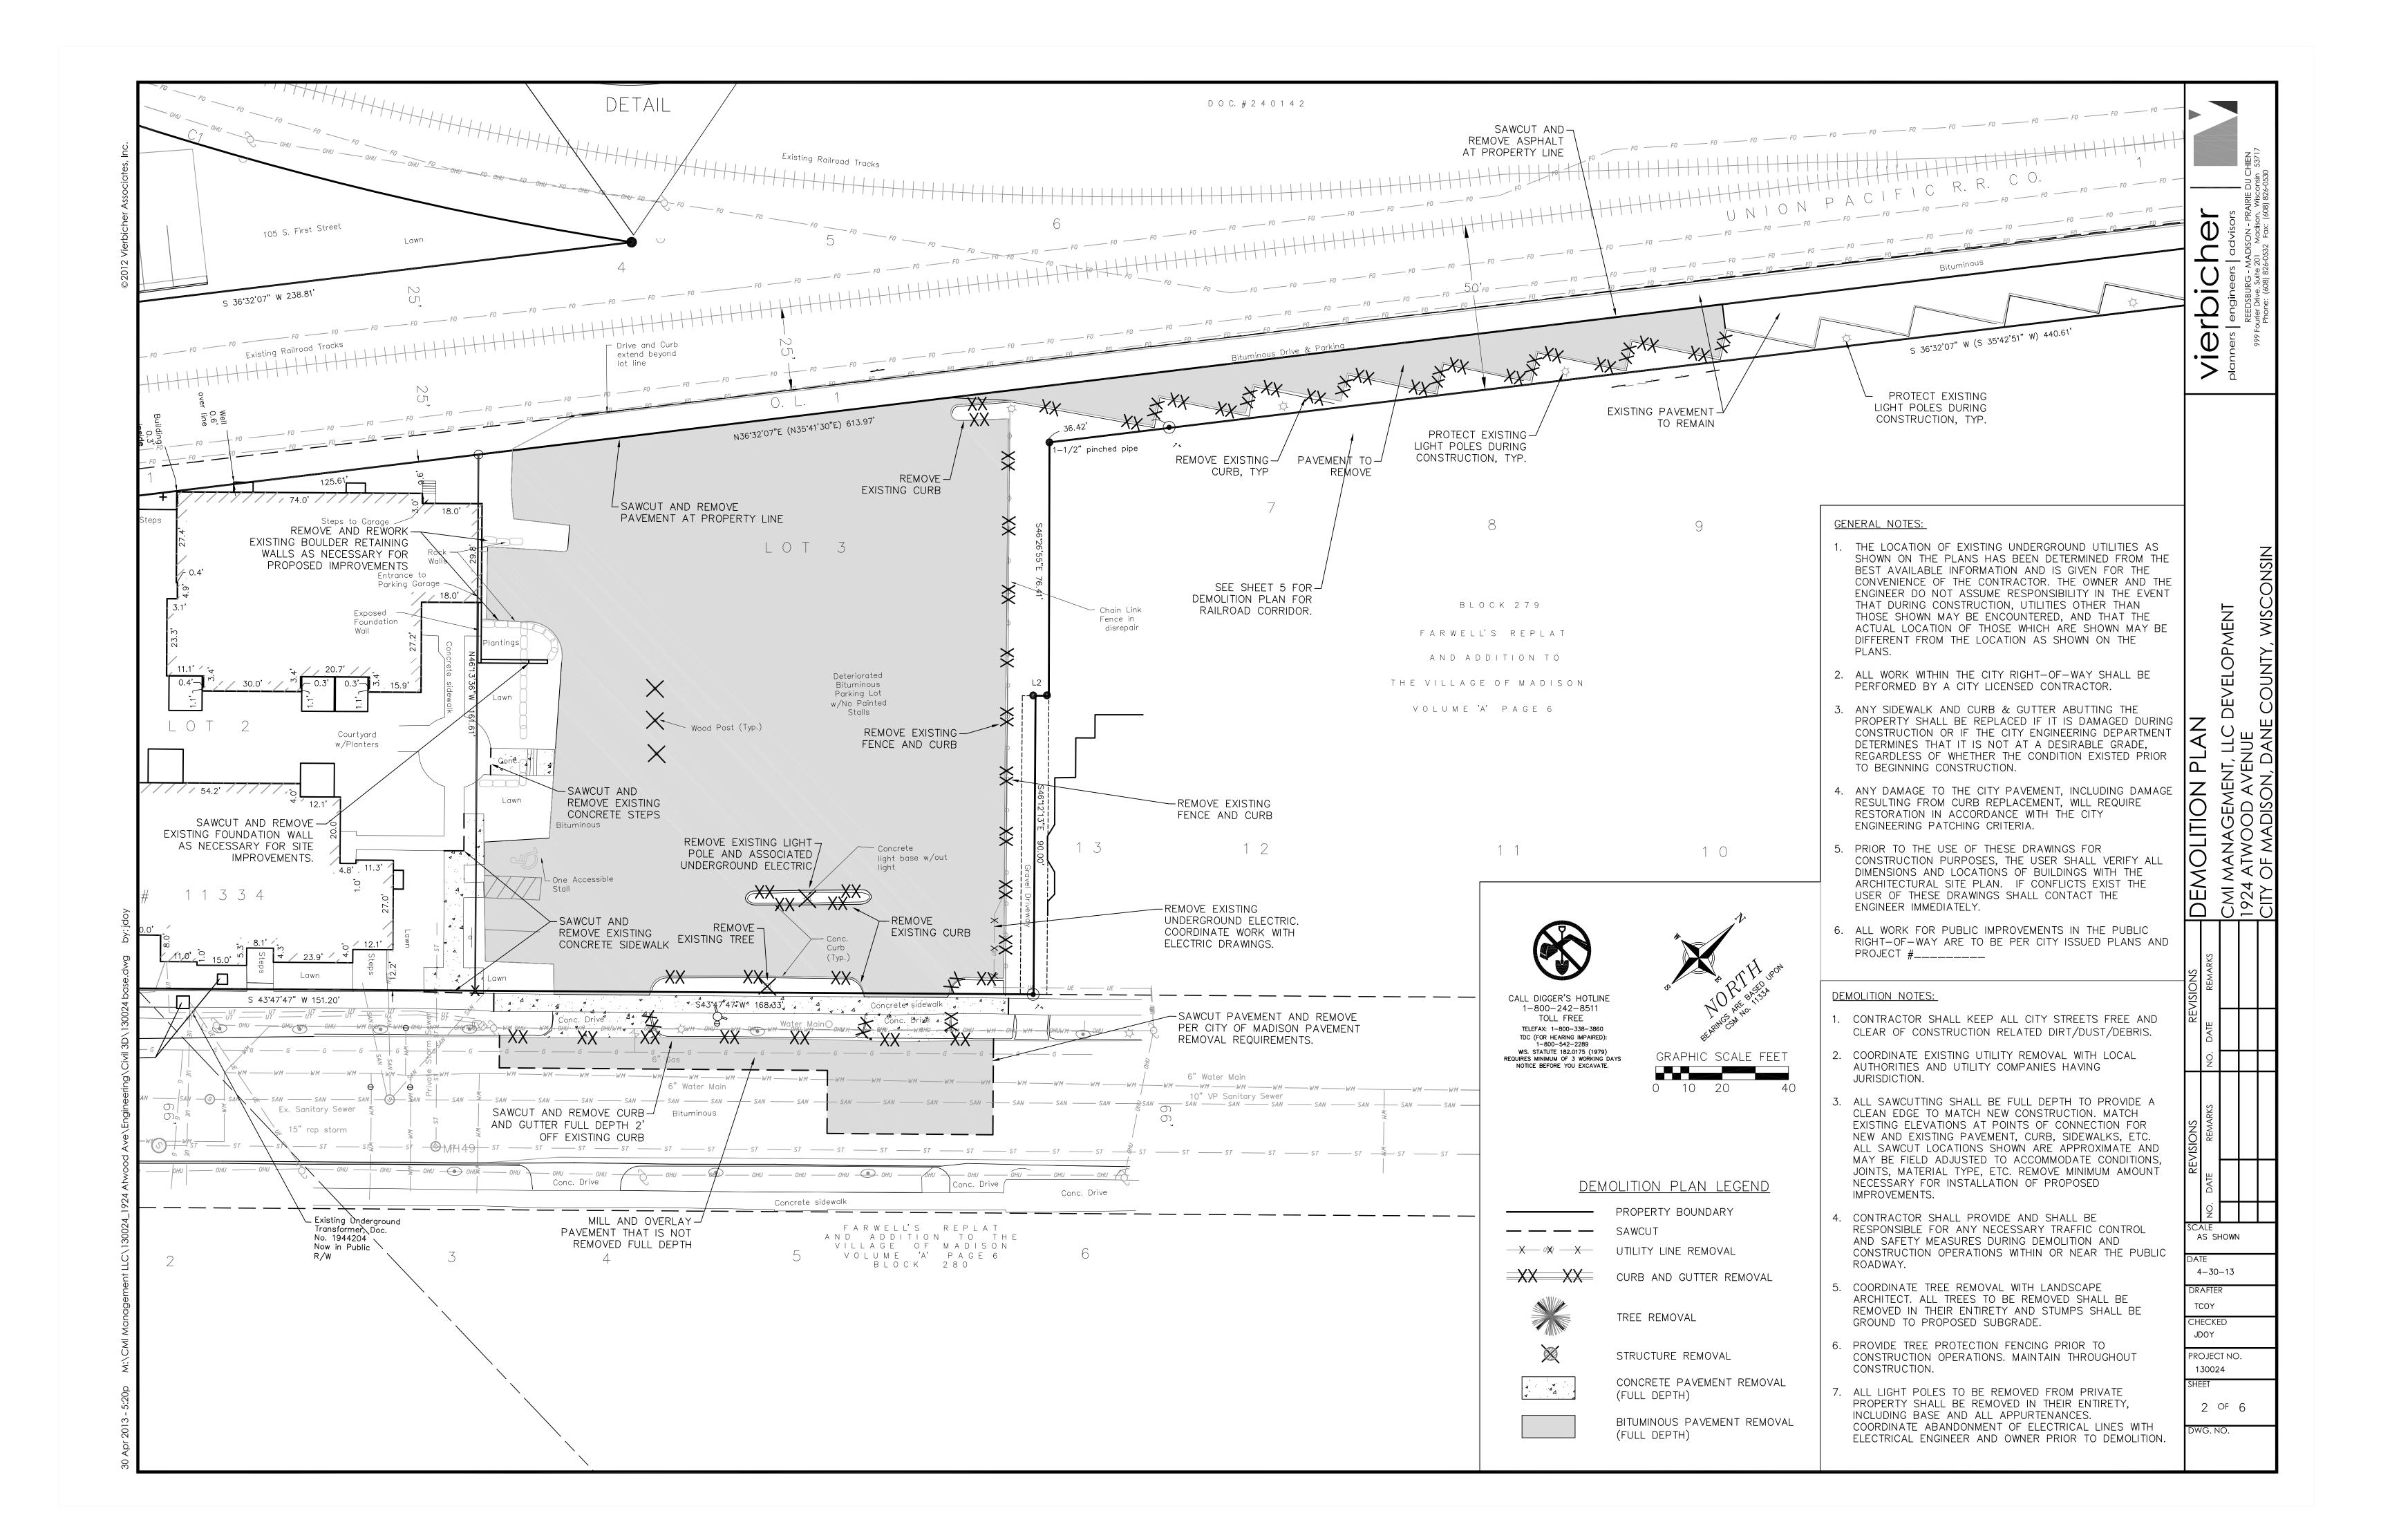


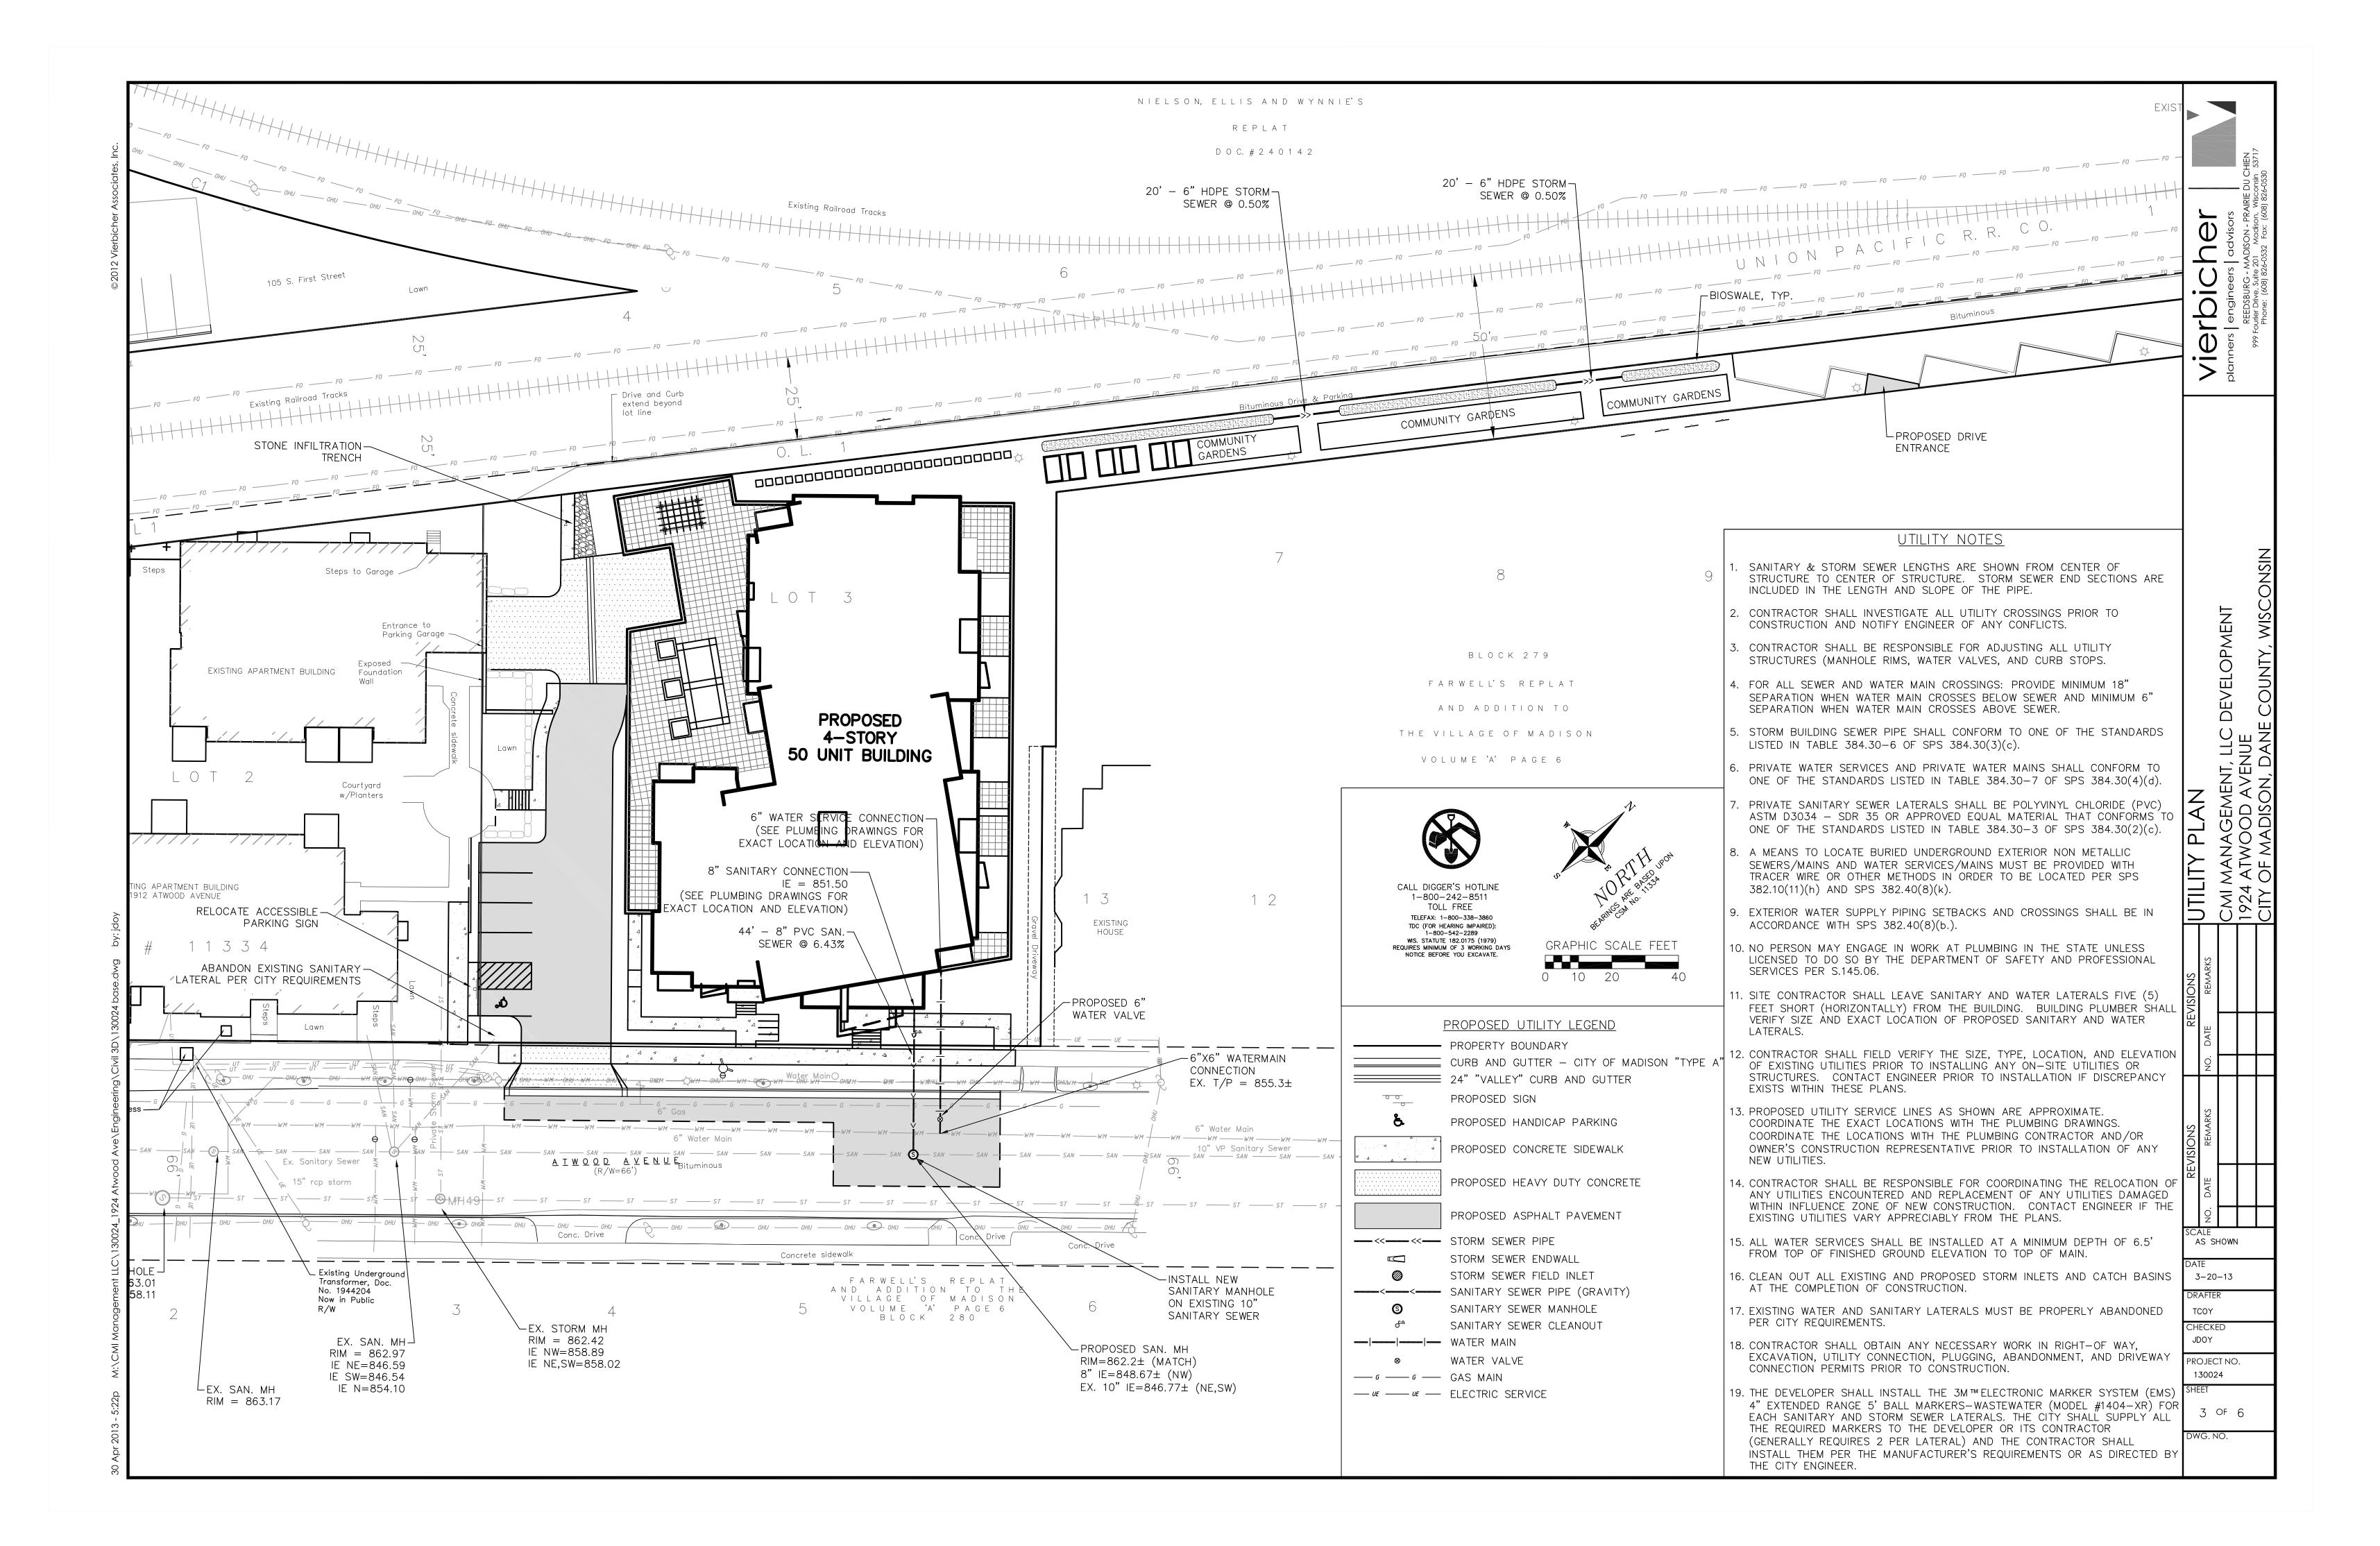

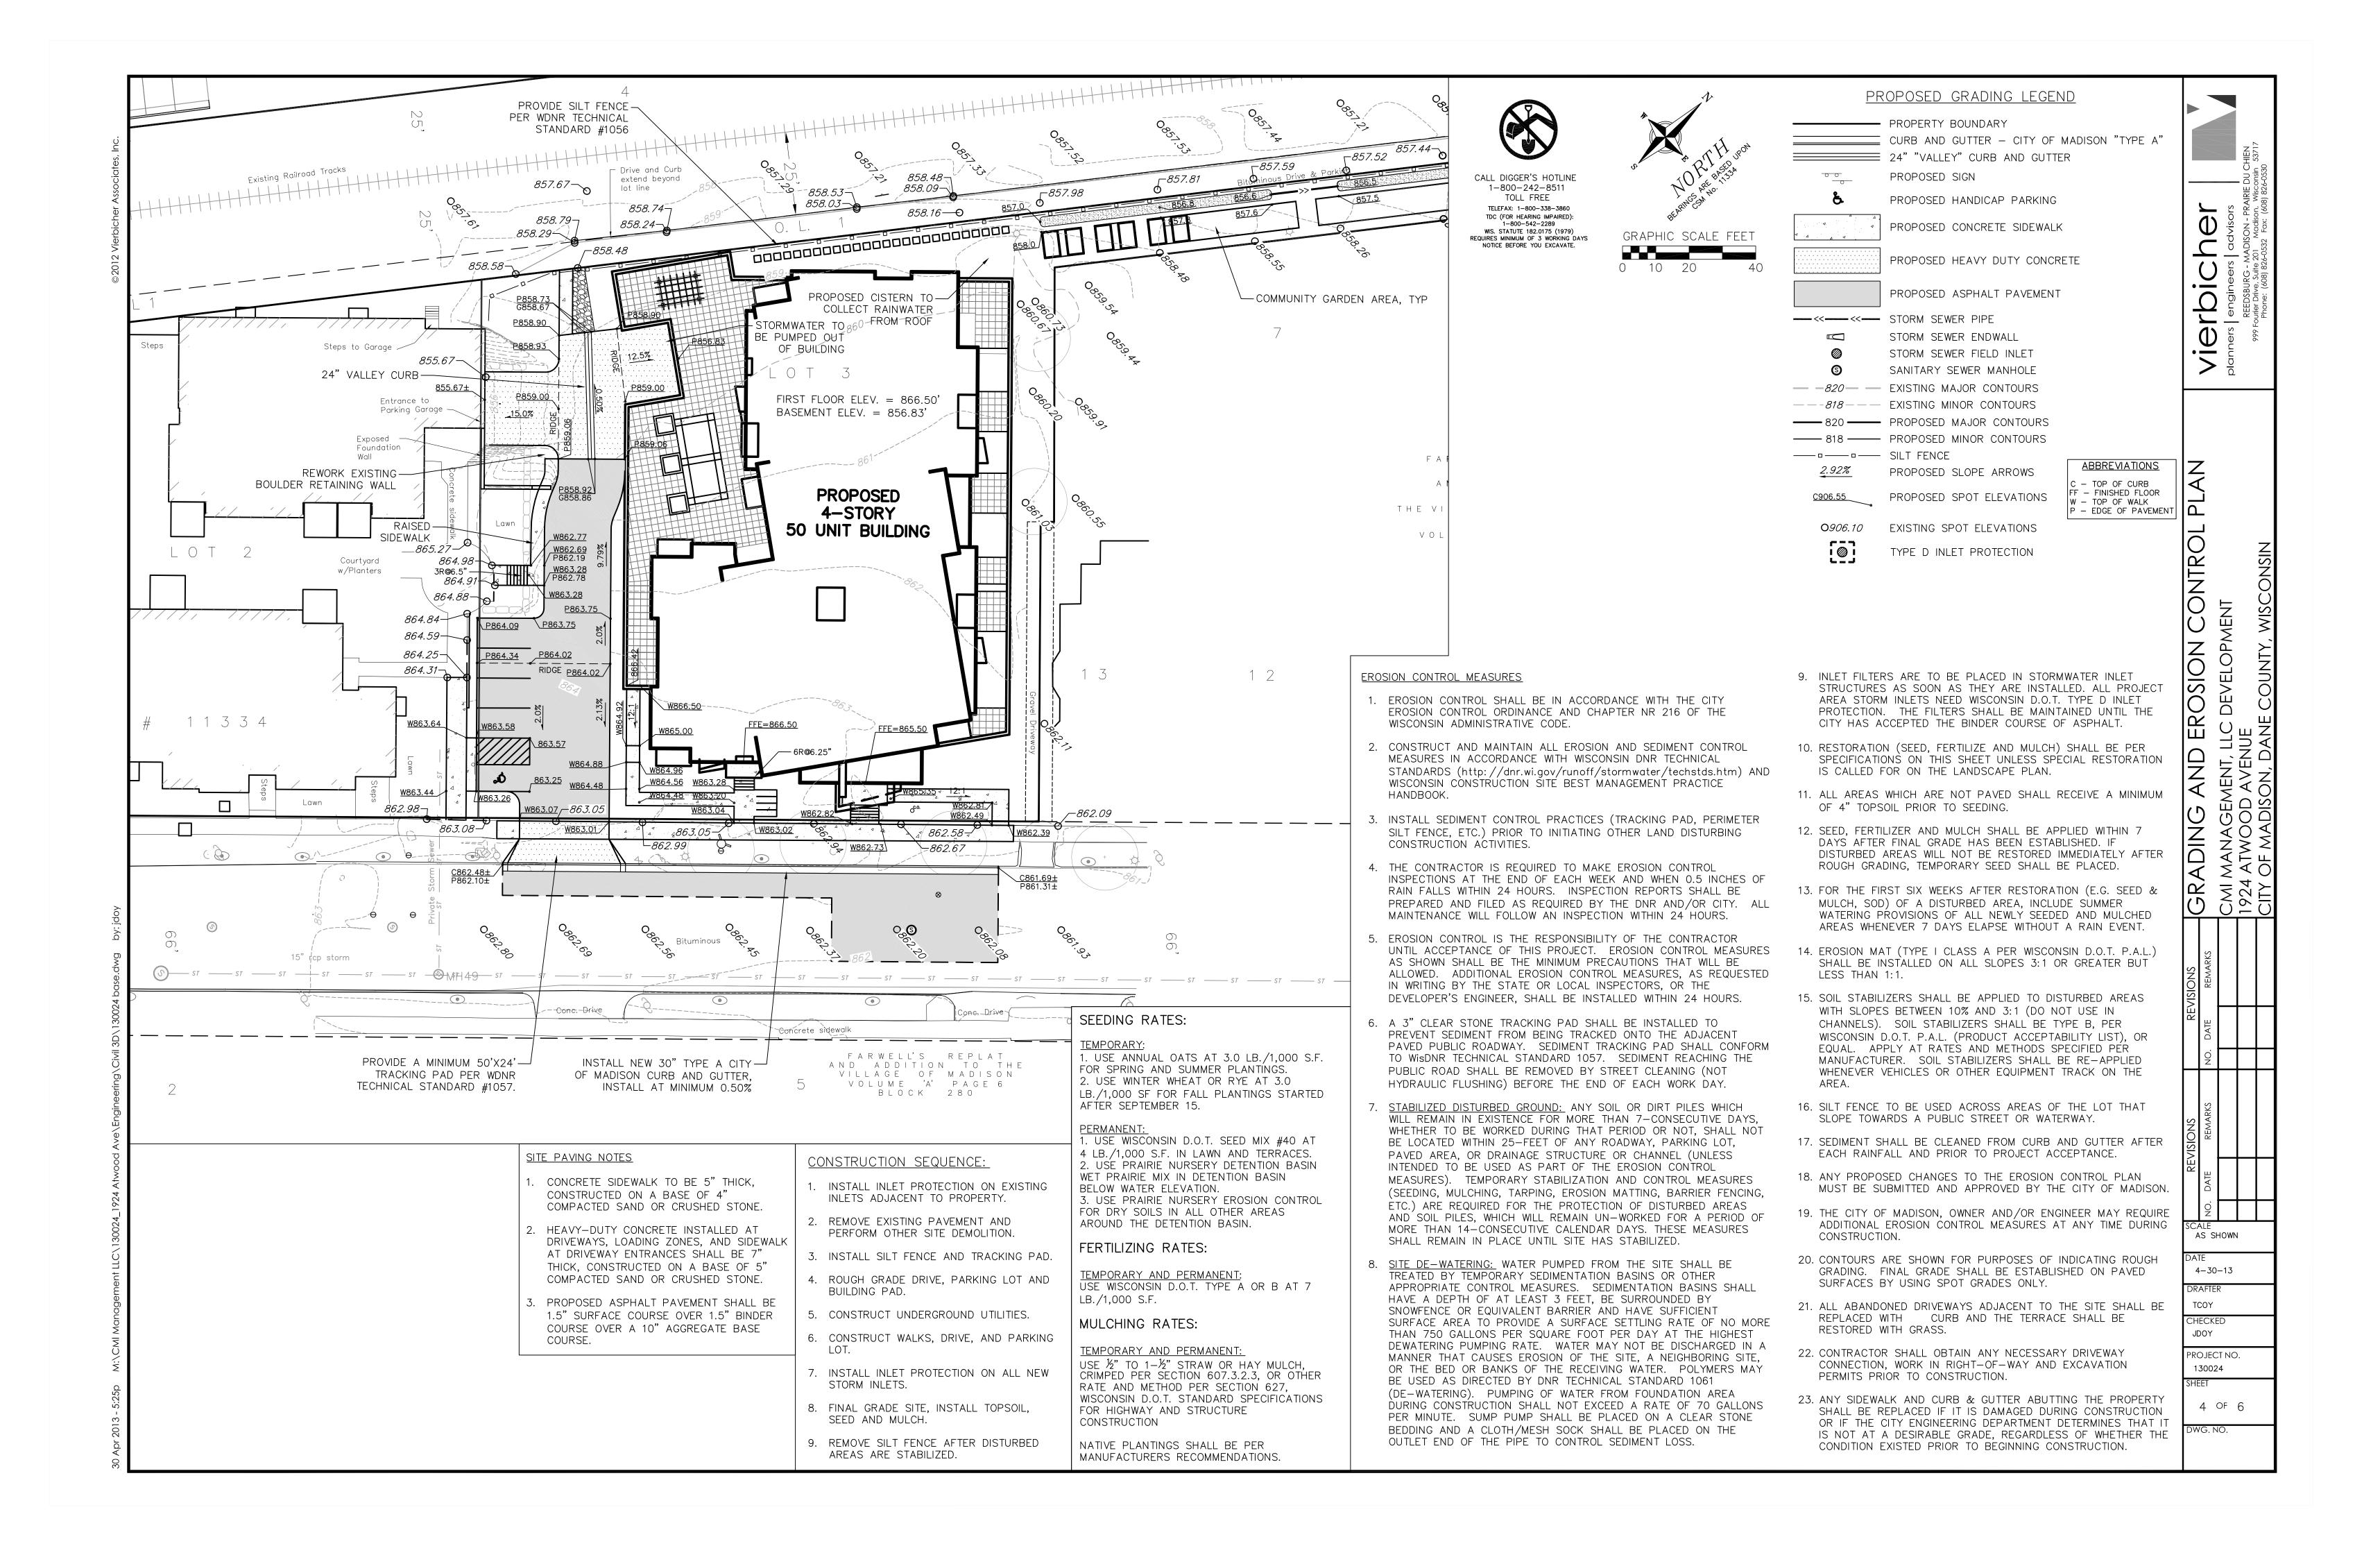

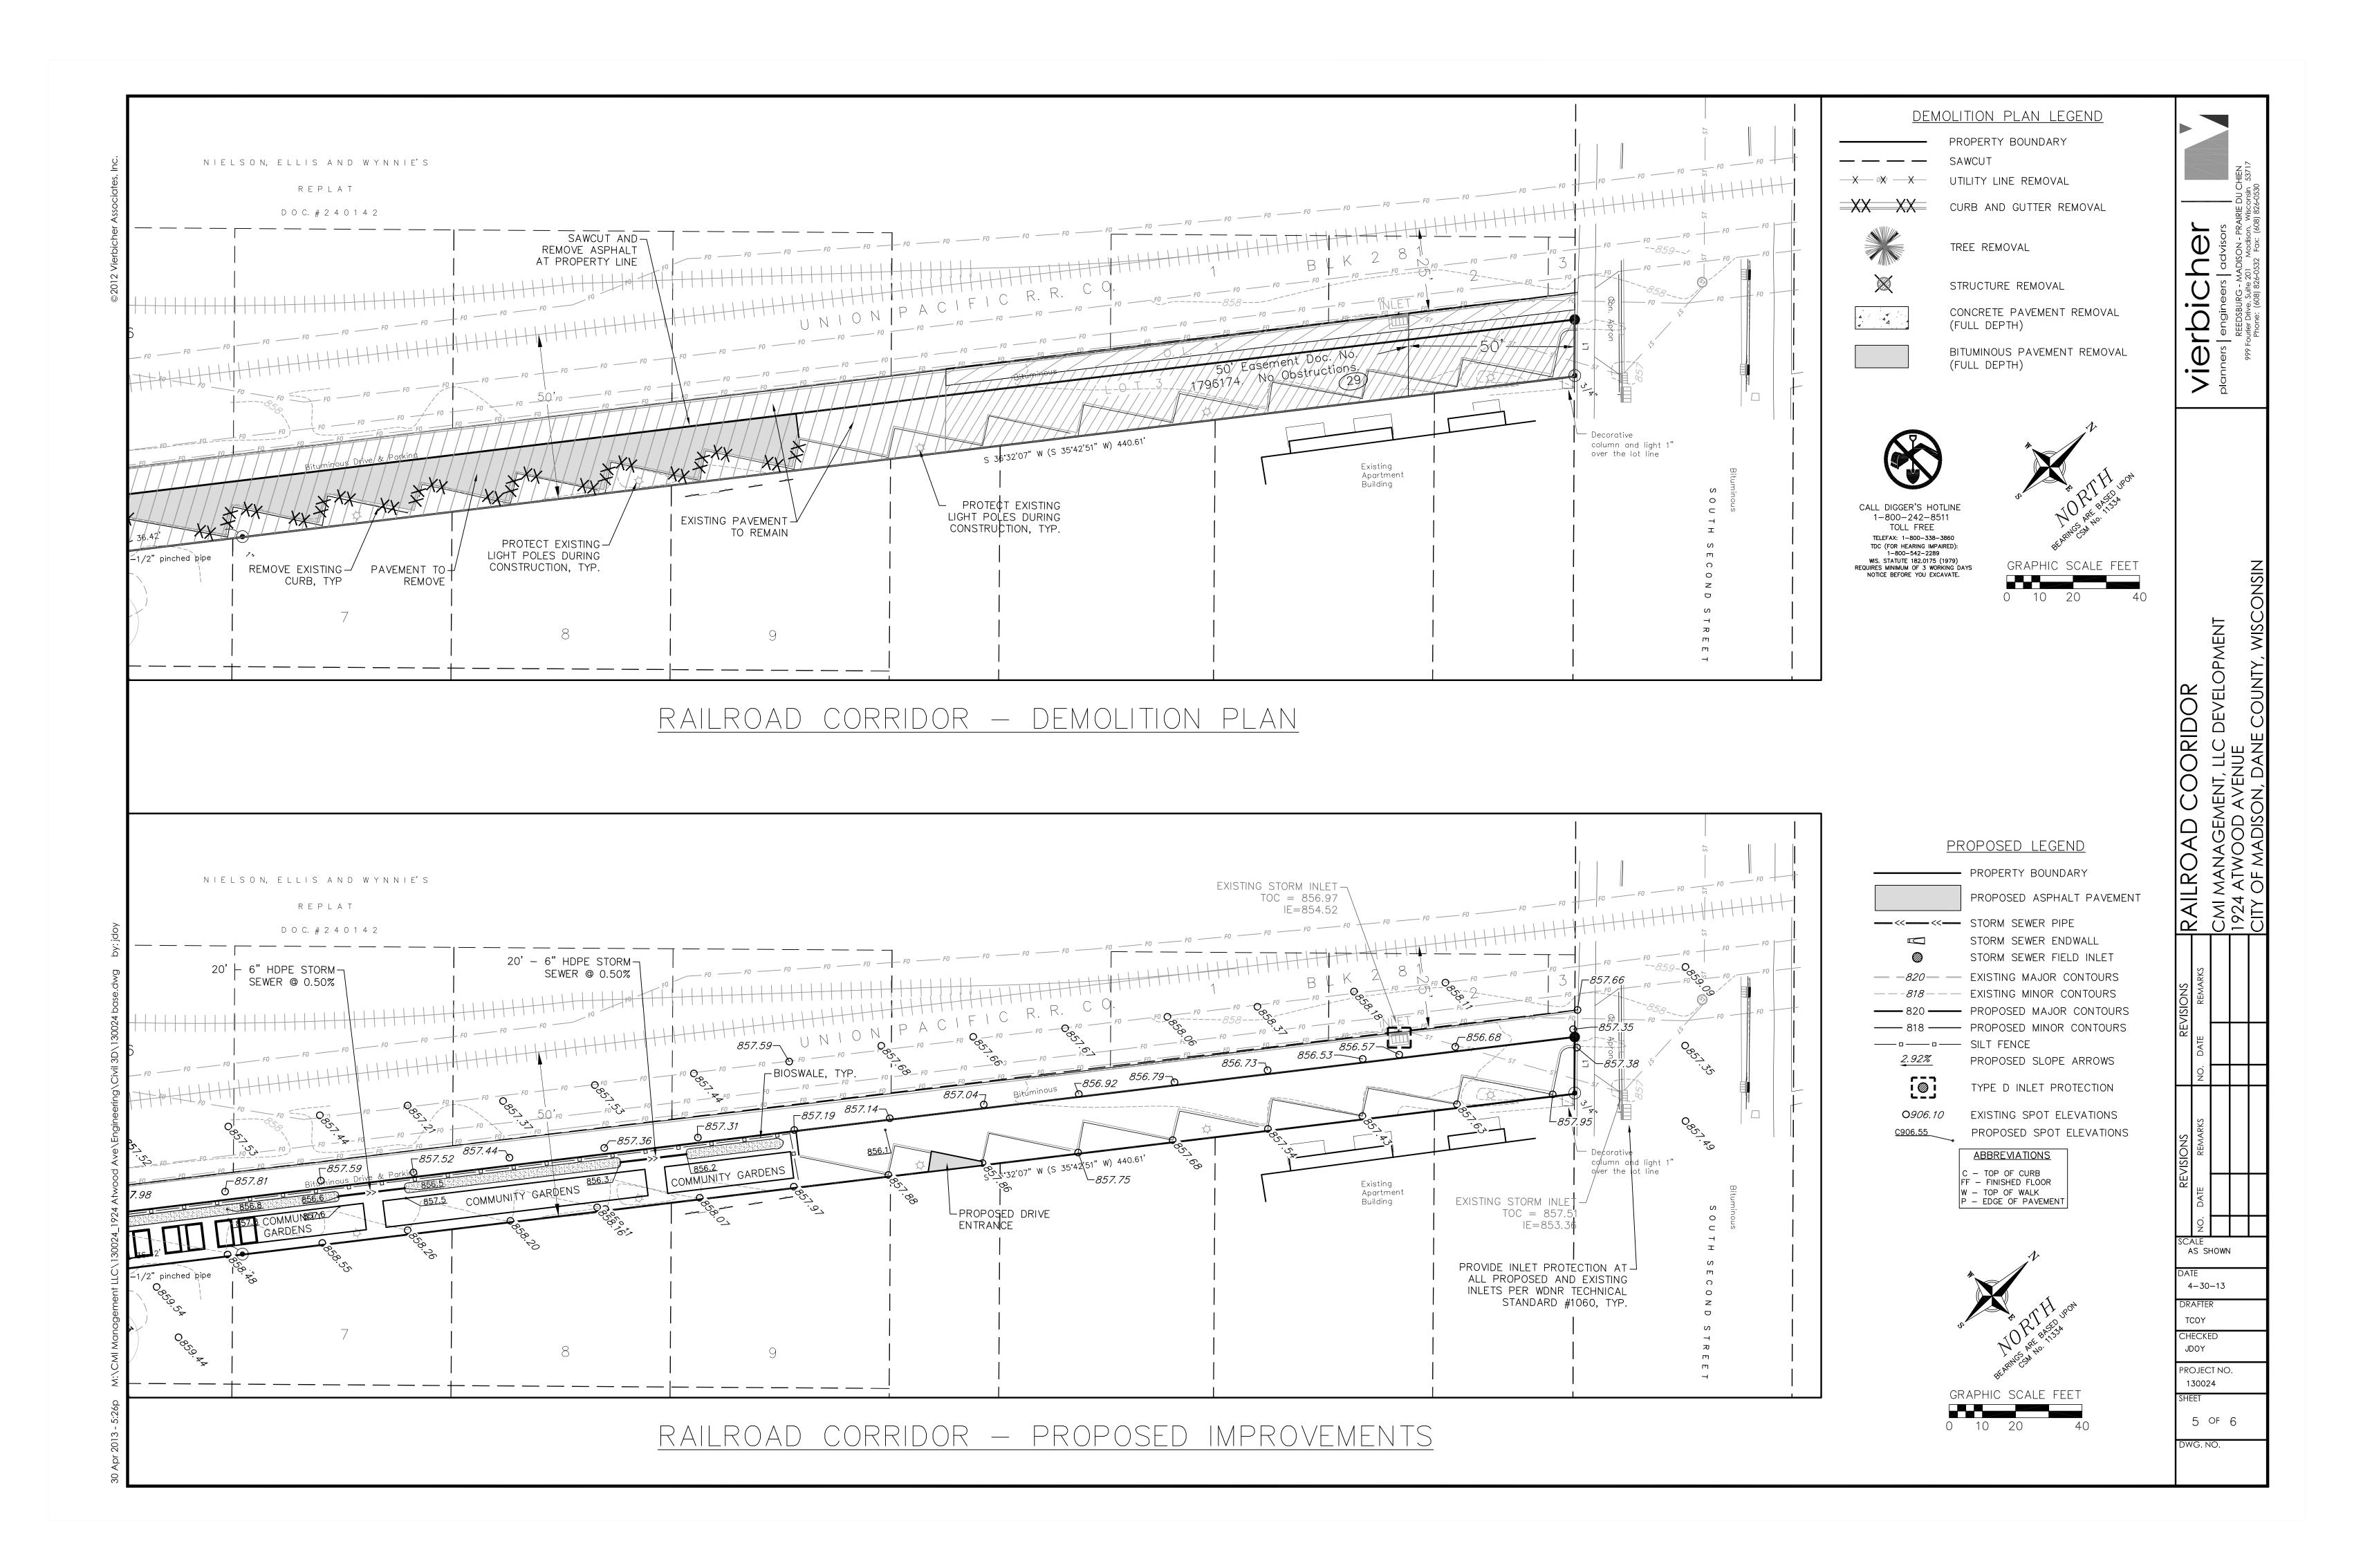



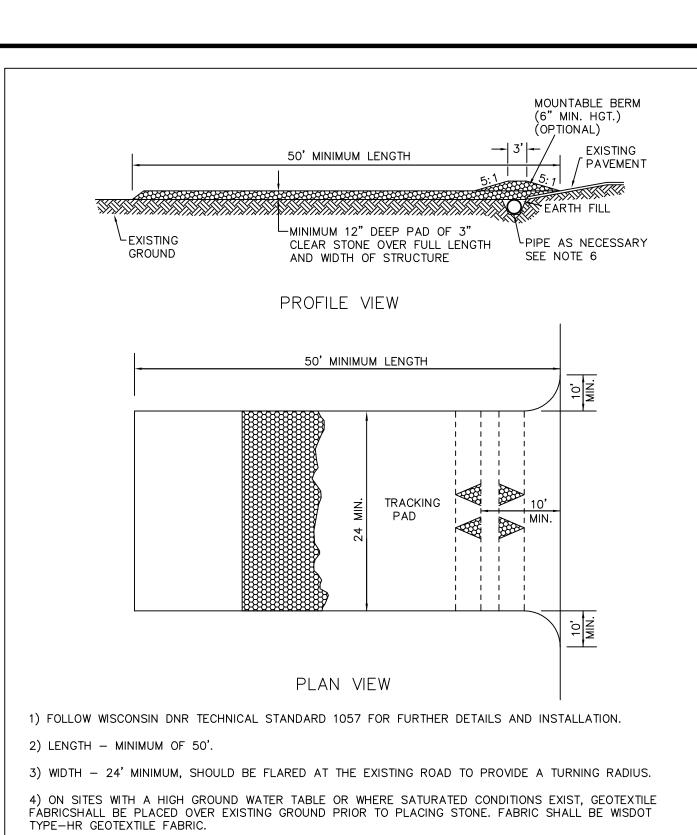

5) STONE - CRUSHED 3" CLEAR STONE SHALL BE PLACED AT LEAST 12" DEEP OVER THE ENTIRE LENGTH AND WIDTH OF ENTRANCE.


6) SURFACE WATER - ALL SURFACE WATER FLOWING TO OR DIVERTED TOWARDS CONSTRUCTION ENTRANCES SHALL BE PIPED THROUGH THE ENTRANCE. MAINTAINING POSITIVE DRAINAGE. PIPE INSTALLED THROUGH THE STABILIZED CONSTRUCTION ENTRANCE SHALL BE PROTECTED WITH A MOUNTABLE BERM WITH 5:1 SLOPES AND MINIMIUM OF 6" STONE OVER THE PIPE. PIPE SHALL BE SIZED ACCORDING TO THE DRAINAGE REQUIREMENTS. WHEN THE ENTRANCE IS LOCATED AT A HIGH SPOT AND HAS NO DRAINAGE TO CONVEY A PIPE SHALL NOT BE NECESSARY. THE MINIMUM PIPE DIAMETER SHALL BE 6". CONTRACTOR SHALL BE RESPONSIBLE FOR THE MAINTENANCE OF SAID PIPE.

7) LOCATION - A STABILIZED CONSTRUCTION ENTRANCE SHALL BE LOCATED WHERE CONSTRUCTION TRAFFIC ENTERS AND/OR LEAVES THE CONSTRUCTION SITE. VEHICLES LEAVING THE SITE MUST TRAVEL OVER THE ENTIRE LENGTH OF THE TRACKING PAD.

> STONE CONSTRUCTION ENTRANCE SCALE: NOT TO SCALE


INLET PROTECTION DEVICES SHALL BE MAINTAINED OR REPLACED AT DIRECTION OF THE ENGINEER. THE MANUFACTURED ALTERNATIVES APPROVED AND LISTED ON THE DEPARTMENT'S EROSION CONTROL PRODUCT ACCEPTABILITY LIST MAY BE SUBSTITUTED. WHEN REMOVING OR MAINTAINING INLET PROTECTION, CARE SHALL BE TAKEN SO THAT THE SEDIMENT TRAPPED ON THE GEOTEXTILE FABRIC DOES NOT FALL INTO THE INLET. ANY MATERIAL FALLING INTO THE INLET MUST BE REMOVED IMMEDIATELY.

DO NOT INSTALL INLET PROTECTION TYPE D IN INLETS SHALLOWER THAN 30", MEASURED FROM THE BOTTOM OF THE INLET TO THE TOP OF THE GRATE. TRIM EXCESS FABRIC IN THE FLOW LINE TO WITHIN 3" OF THE GRATE. THE INSTALLED BAG SHALL HAVE A MINIMUM SIDE CLEARANCE, BETWEEN THE INLET WALLS AND THE BAG, MEASURED AT THE BOTTOM OF THE OVERFLOW HOLES, OF 3". WHERE NECESSARY THE CONTRACTOR SHALL CINCH THE BAG, USING PLASTIC ZIP TIES, TO ACHIEVE THE 3" CLEARANCE. THE TIES SHALL BE PLACED AT A MAXIMUM OF 4" FROM THE BOTTOM OF

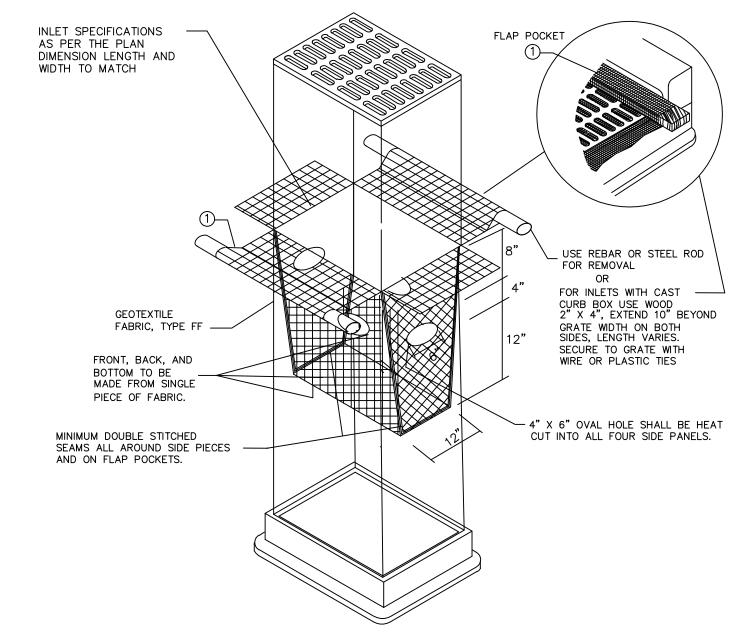


WISDOT TYPE INLET PROTECTION SCALE: NOT TO SCALE

CASTING SHALL BE 1/4" BELOW

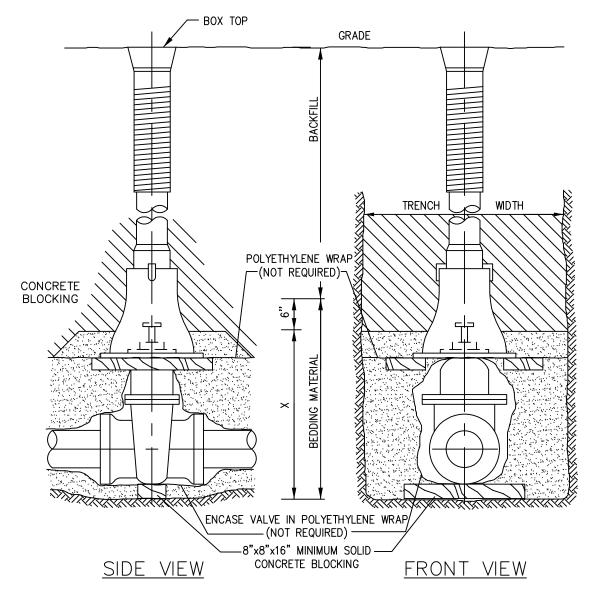

PIPE DIA. X=SETTING INCHES INCHES 8 21 12

STANDARD GATE VALVE BOX SETTING SCALE: NOT TO SCALE

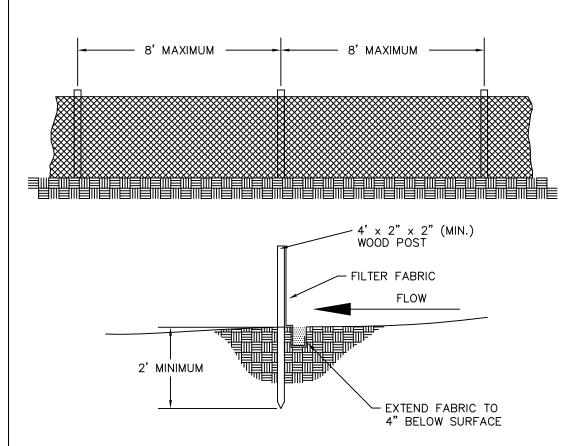

<u>G</u>

• —

ETAIL DEVEL

ONSTRUC MI MANAGE 24 ATWOOL TY OF MADIS

AS SHOWN

4-30-13

TCOY

JDOY

HECKED

PROJECT NO.

6 OF 6


130024


WG. NO.


1. DRIVE STAKES INTO THE GROUND AT LEAST 24" DEEP. STAKE SPACING TO BE PER MANUFACTURERS RECOMMENDATIONS BUT IN NO CASE, MORE THAN 8' BETWEEN STAKES.


- 2. EXCAVATE A 4" x 6" DEEP TRENCH UPSLOPE ALONG THE LINE OF STAKES. 3. STAPLE FILTER MATERIAL ON UPSLOPE SIDE OF STAKES AND EXTEND IT INTO THE TRENCH. WHEN JOINTS ARE NECESSARY, OVERLAP MATERIAL BETWEEN TWO STAKES AND FASTEN SECURELY.
- 4. BACKFILL AND COMPACT THE EXCAVATED SOIL.


SILT FENCE CONSTRUCTION DETAIL SCALE: NOT TO SCALE

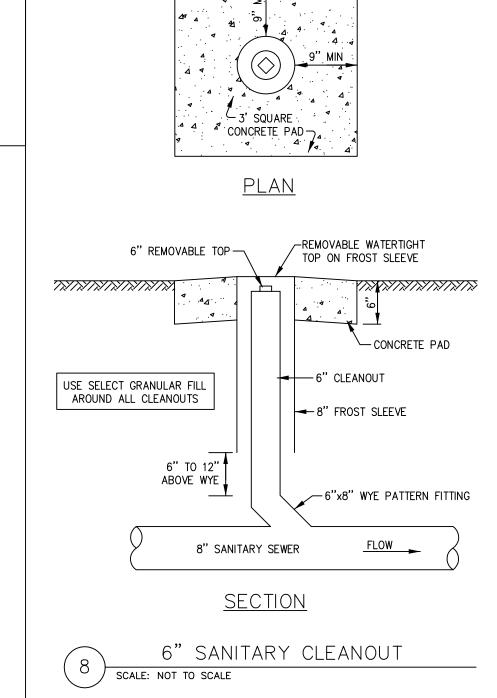

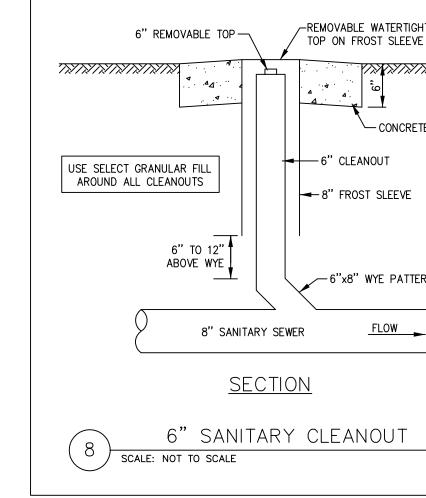


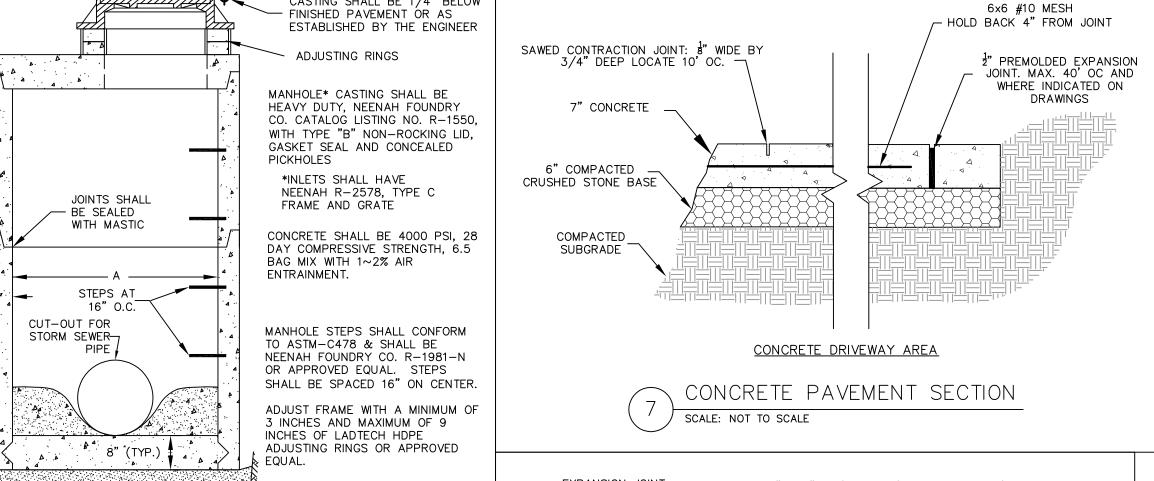


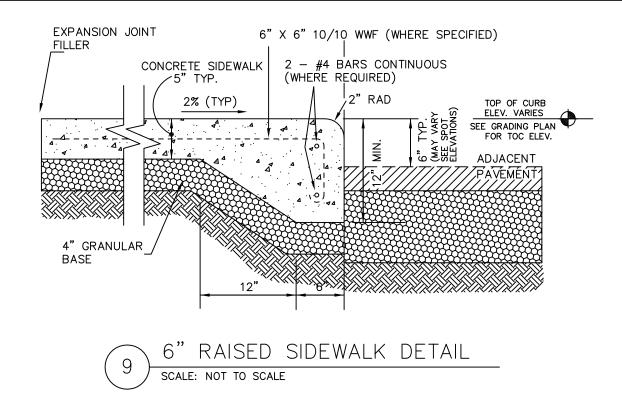

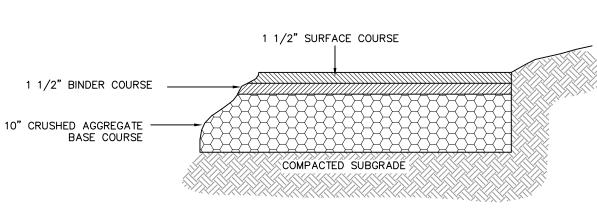


SITE BITUMINOUS PAVEMENT SECTION

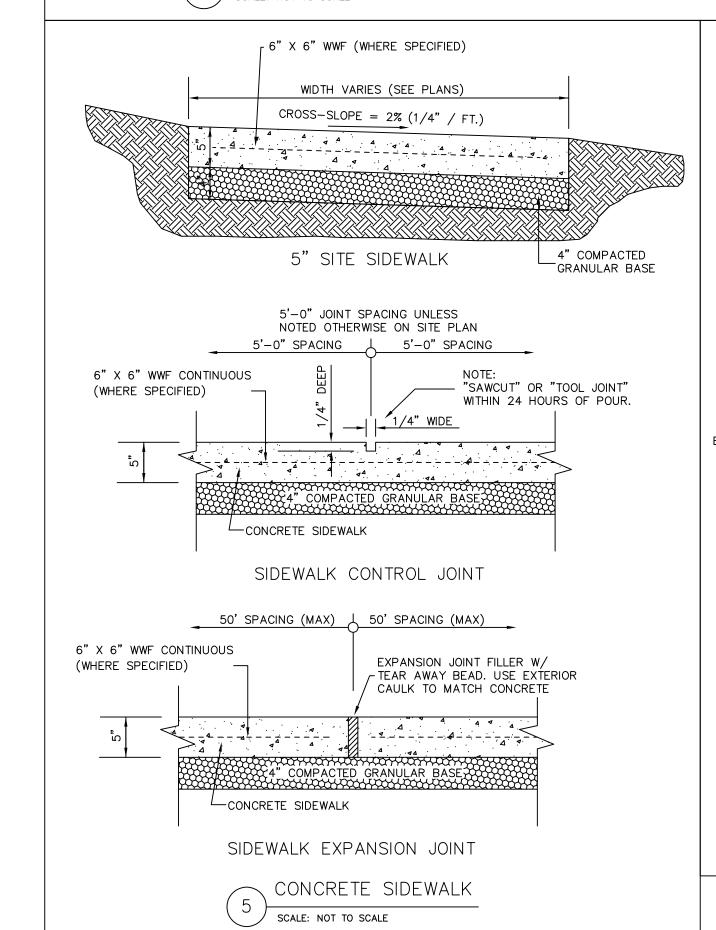

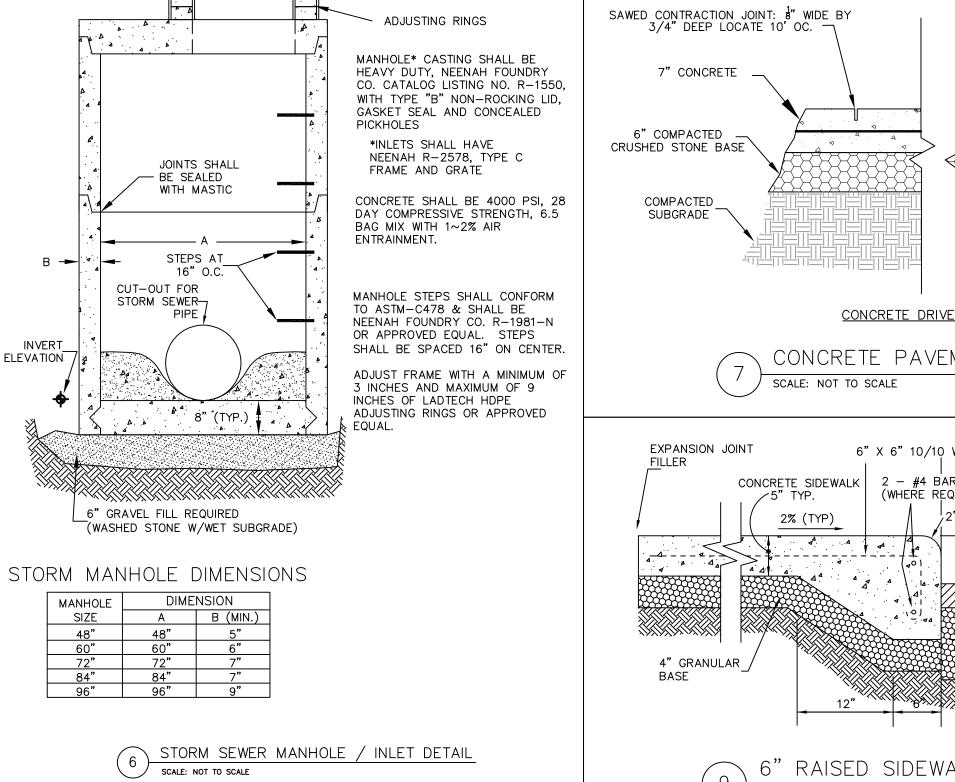

SCALE: NOT TO SCALE

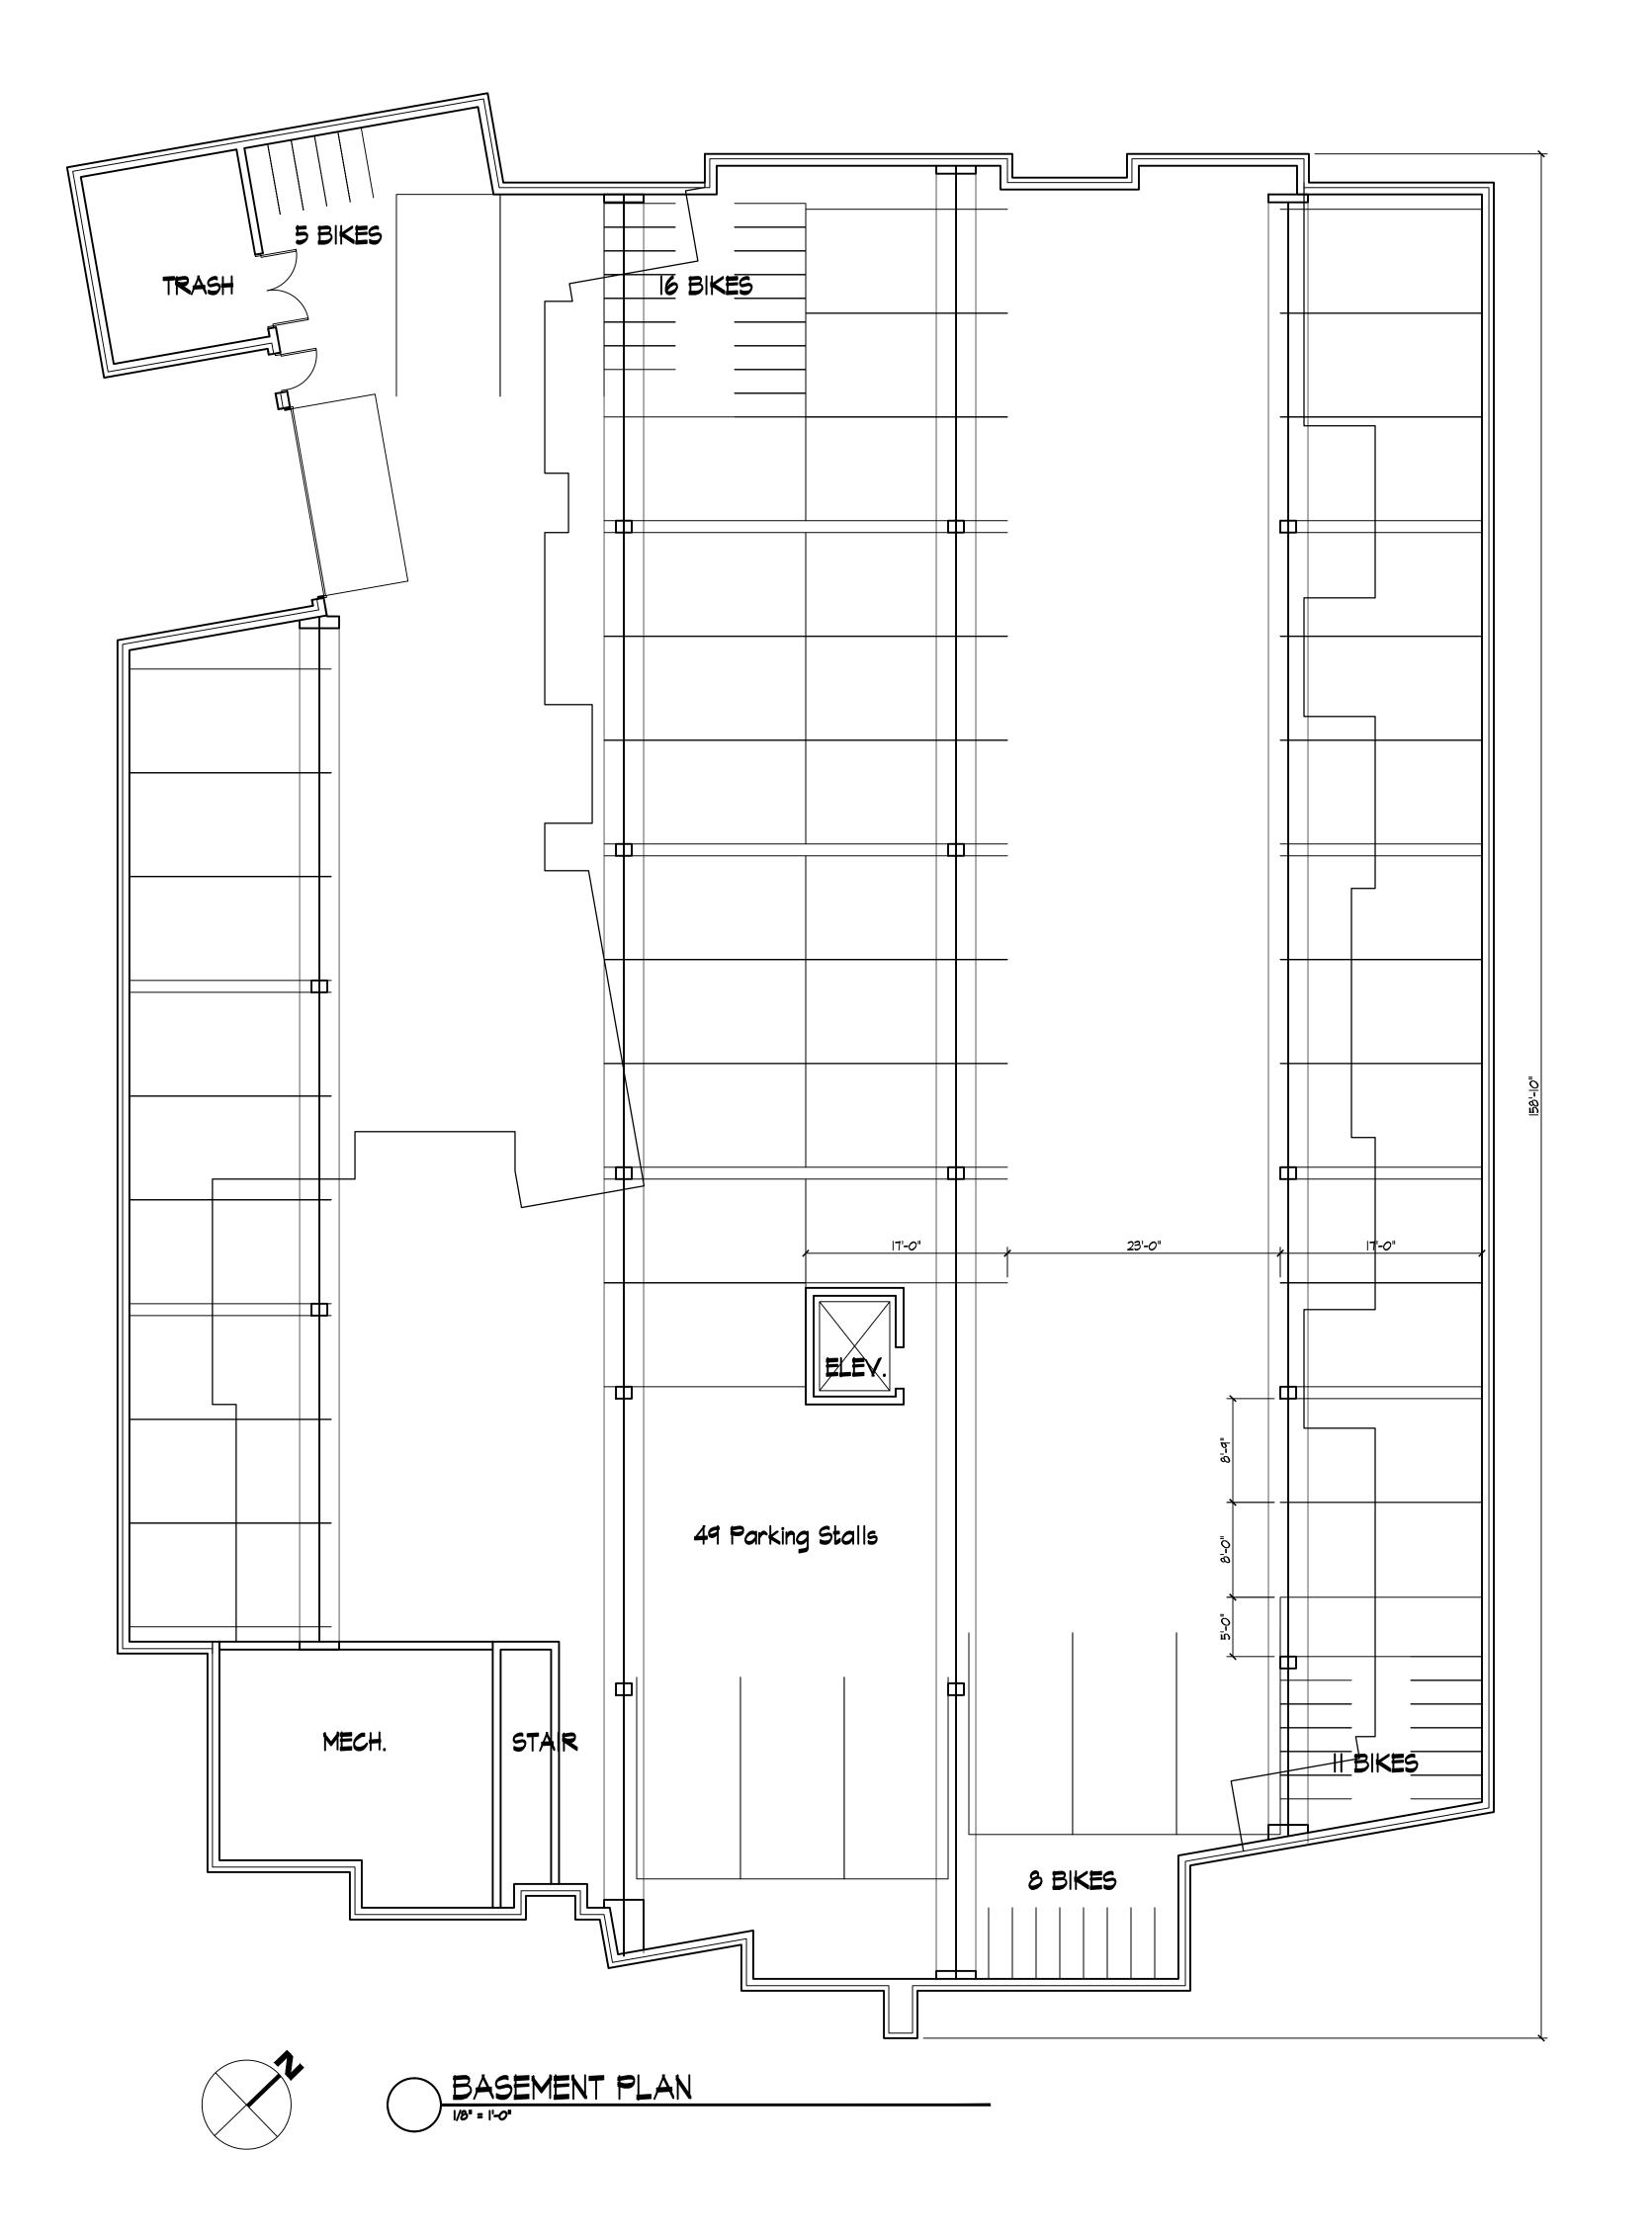



Revisions

SIP Submittal - March 20, 2013


Project Title
Atwood Avenue

1924 Atwood Ave.
Drawing Title
Basement Plan

Project No.

Drawing No.

A-I.I

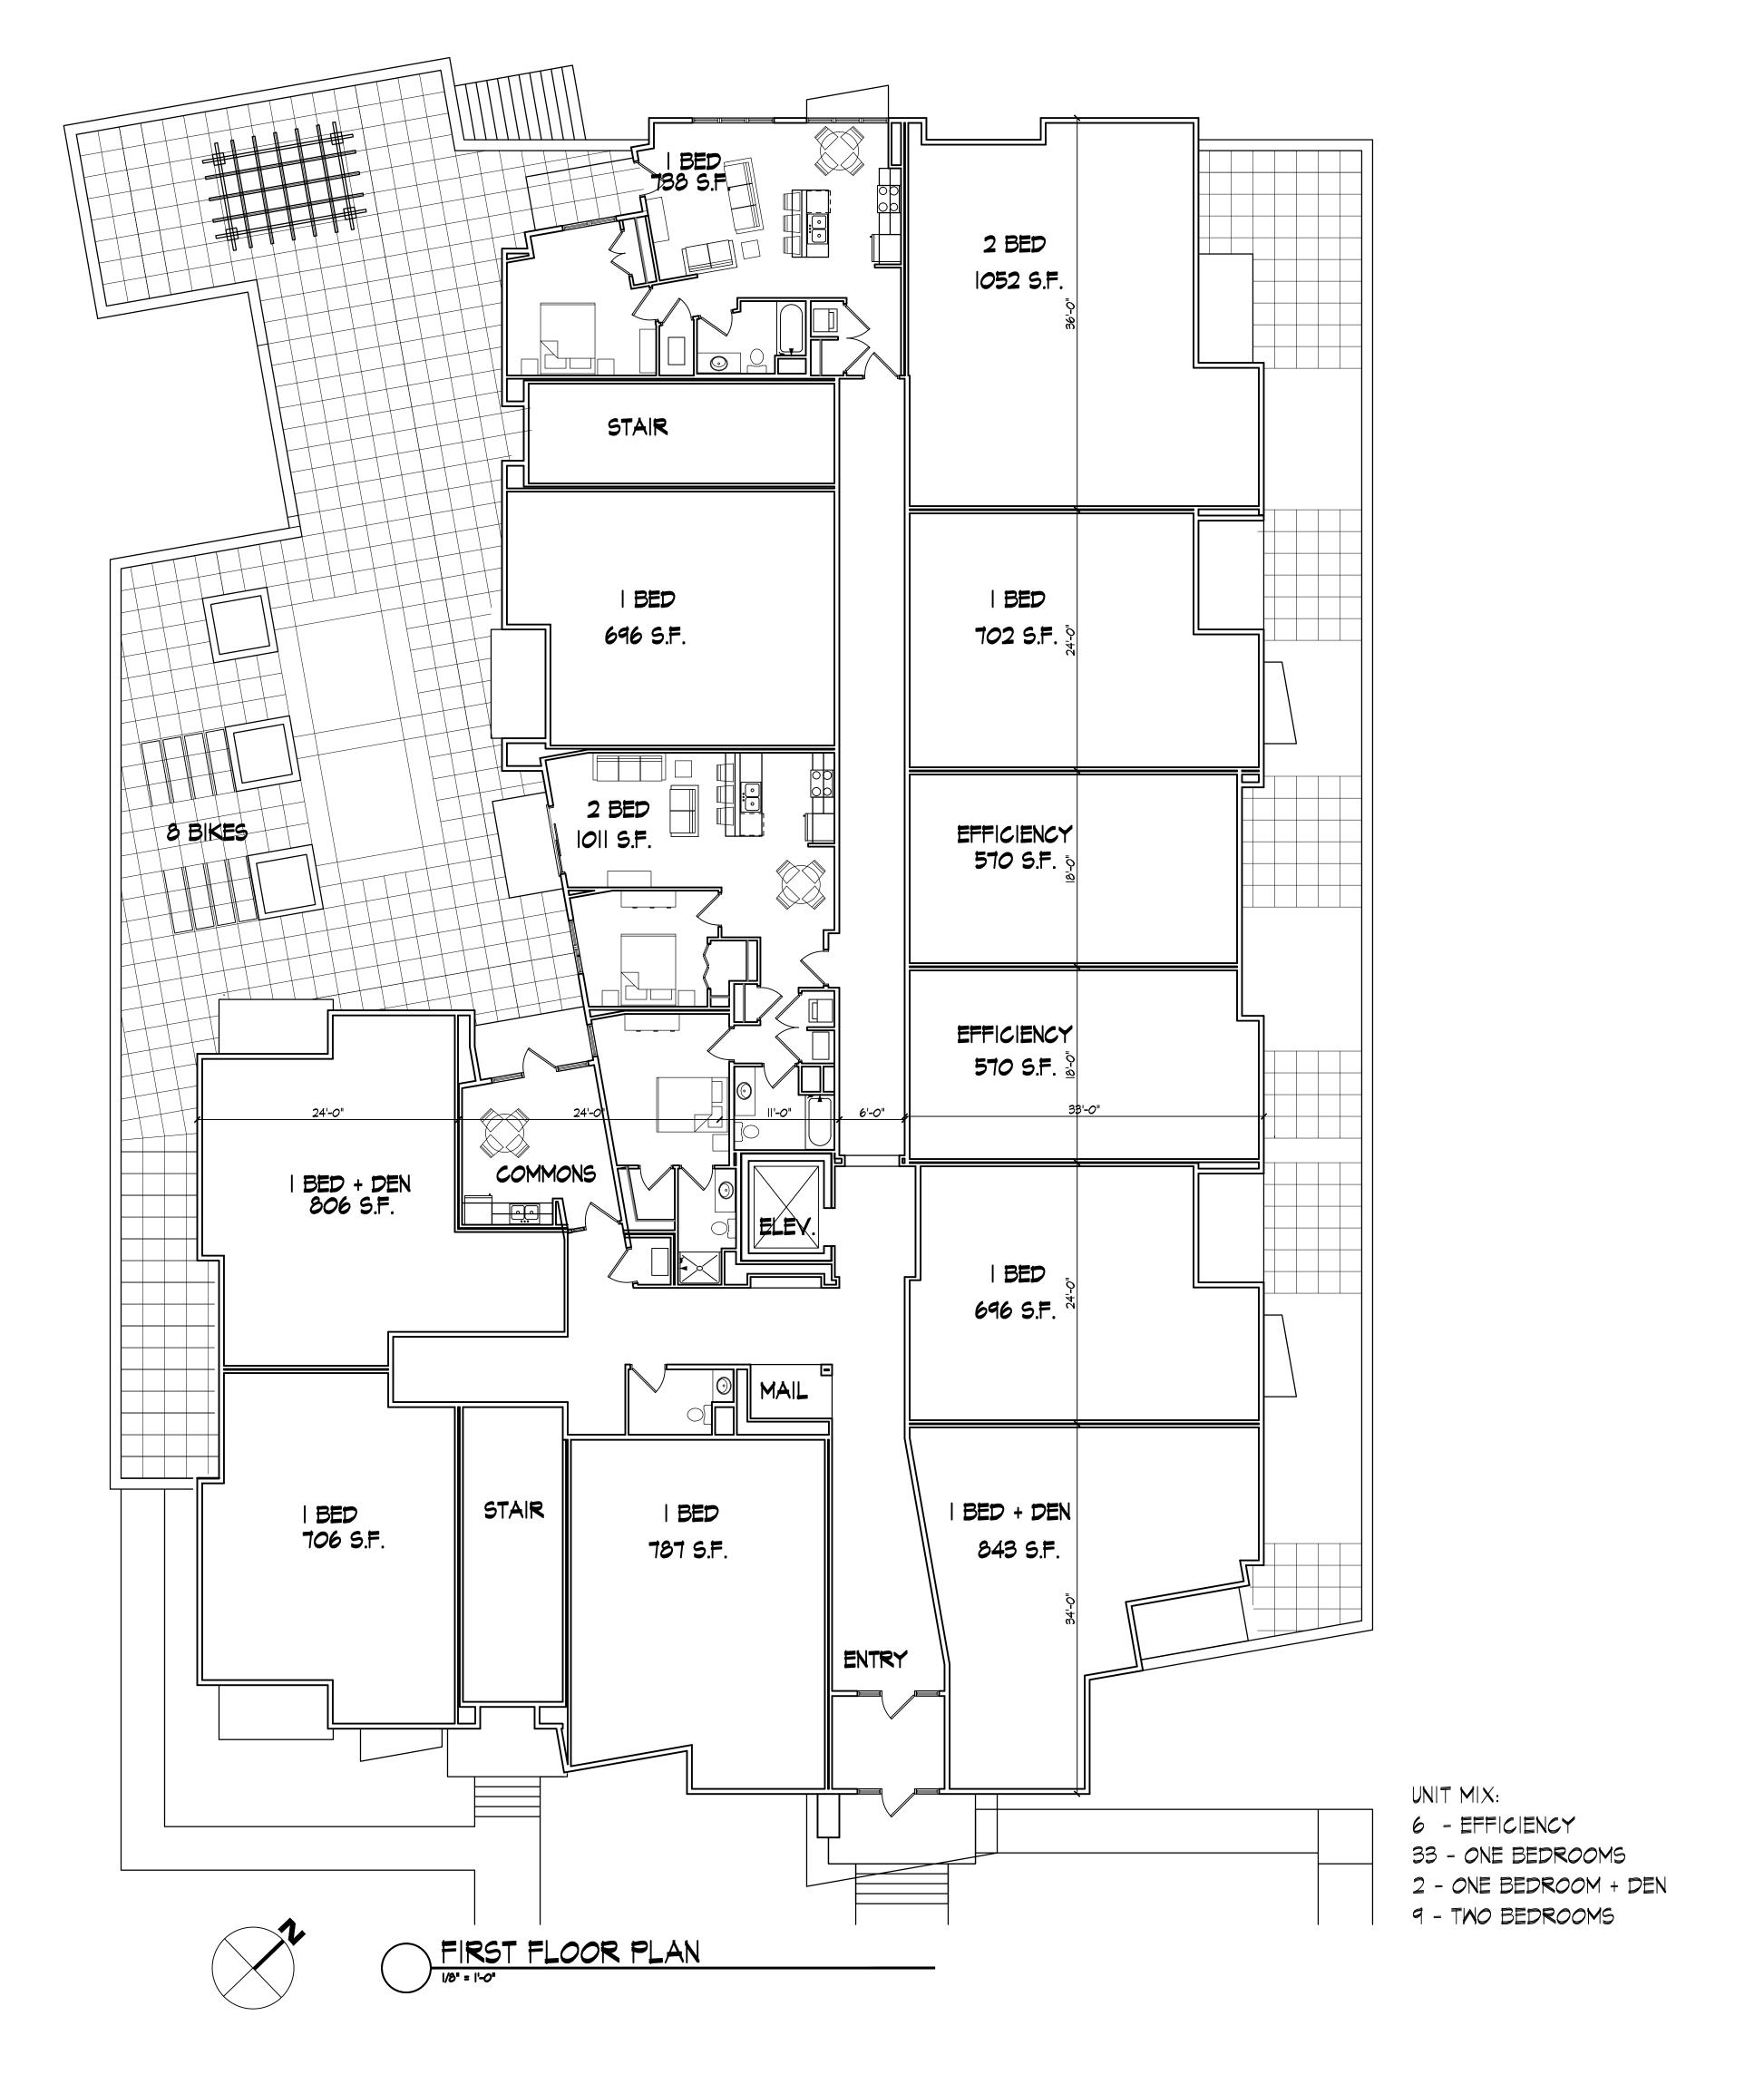



Revisions

SIP Submittal - March 20, 2013

Project Title

Atmood Avenue


1924 Atwood Ave.

Drawing Title

First Floor Plan

Project No. Drawing No.

A-1.2

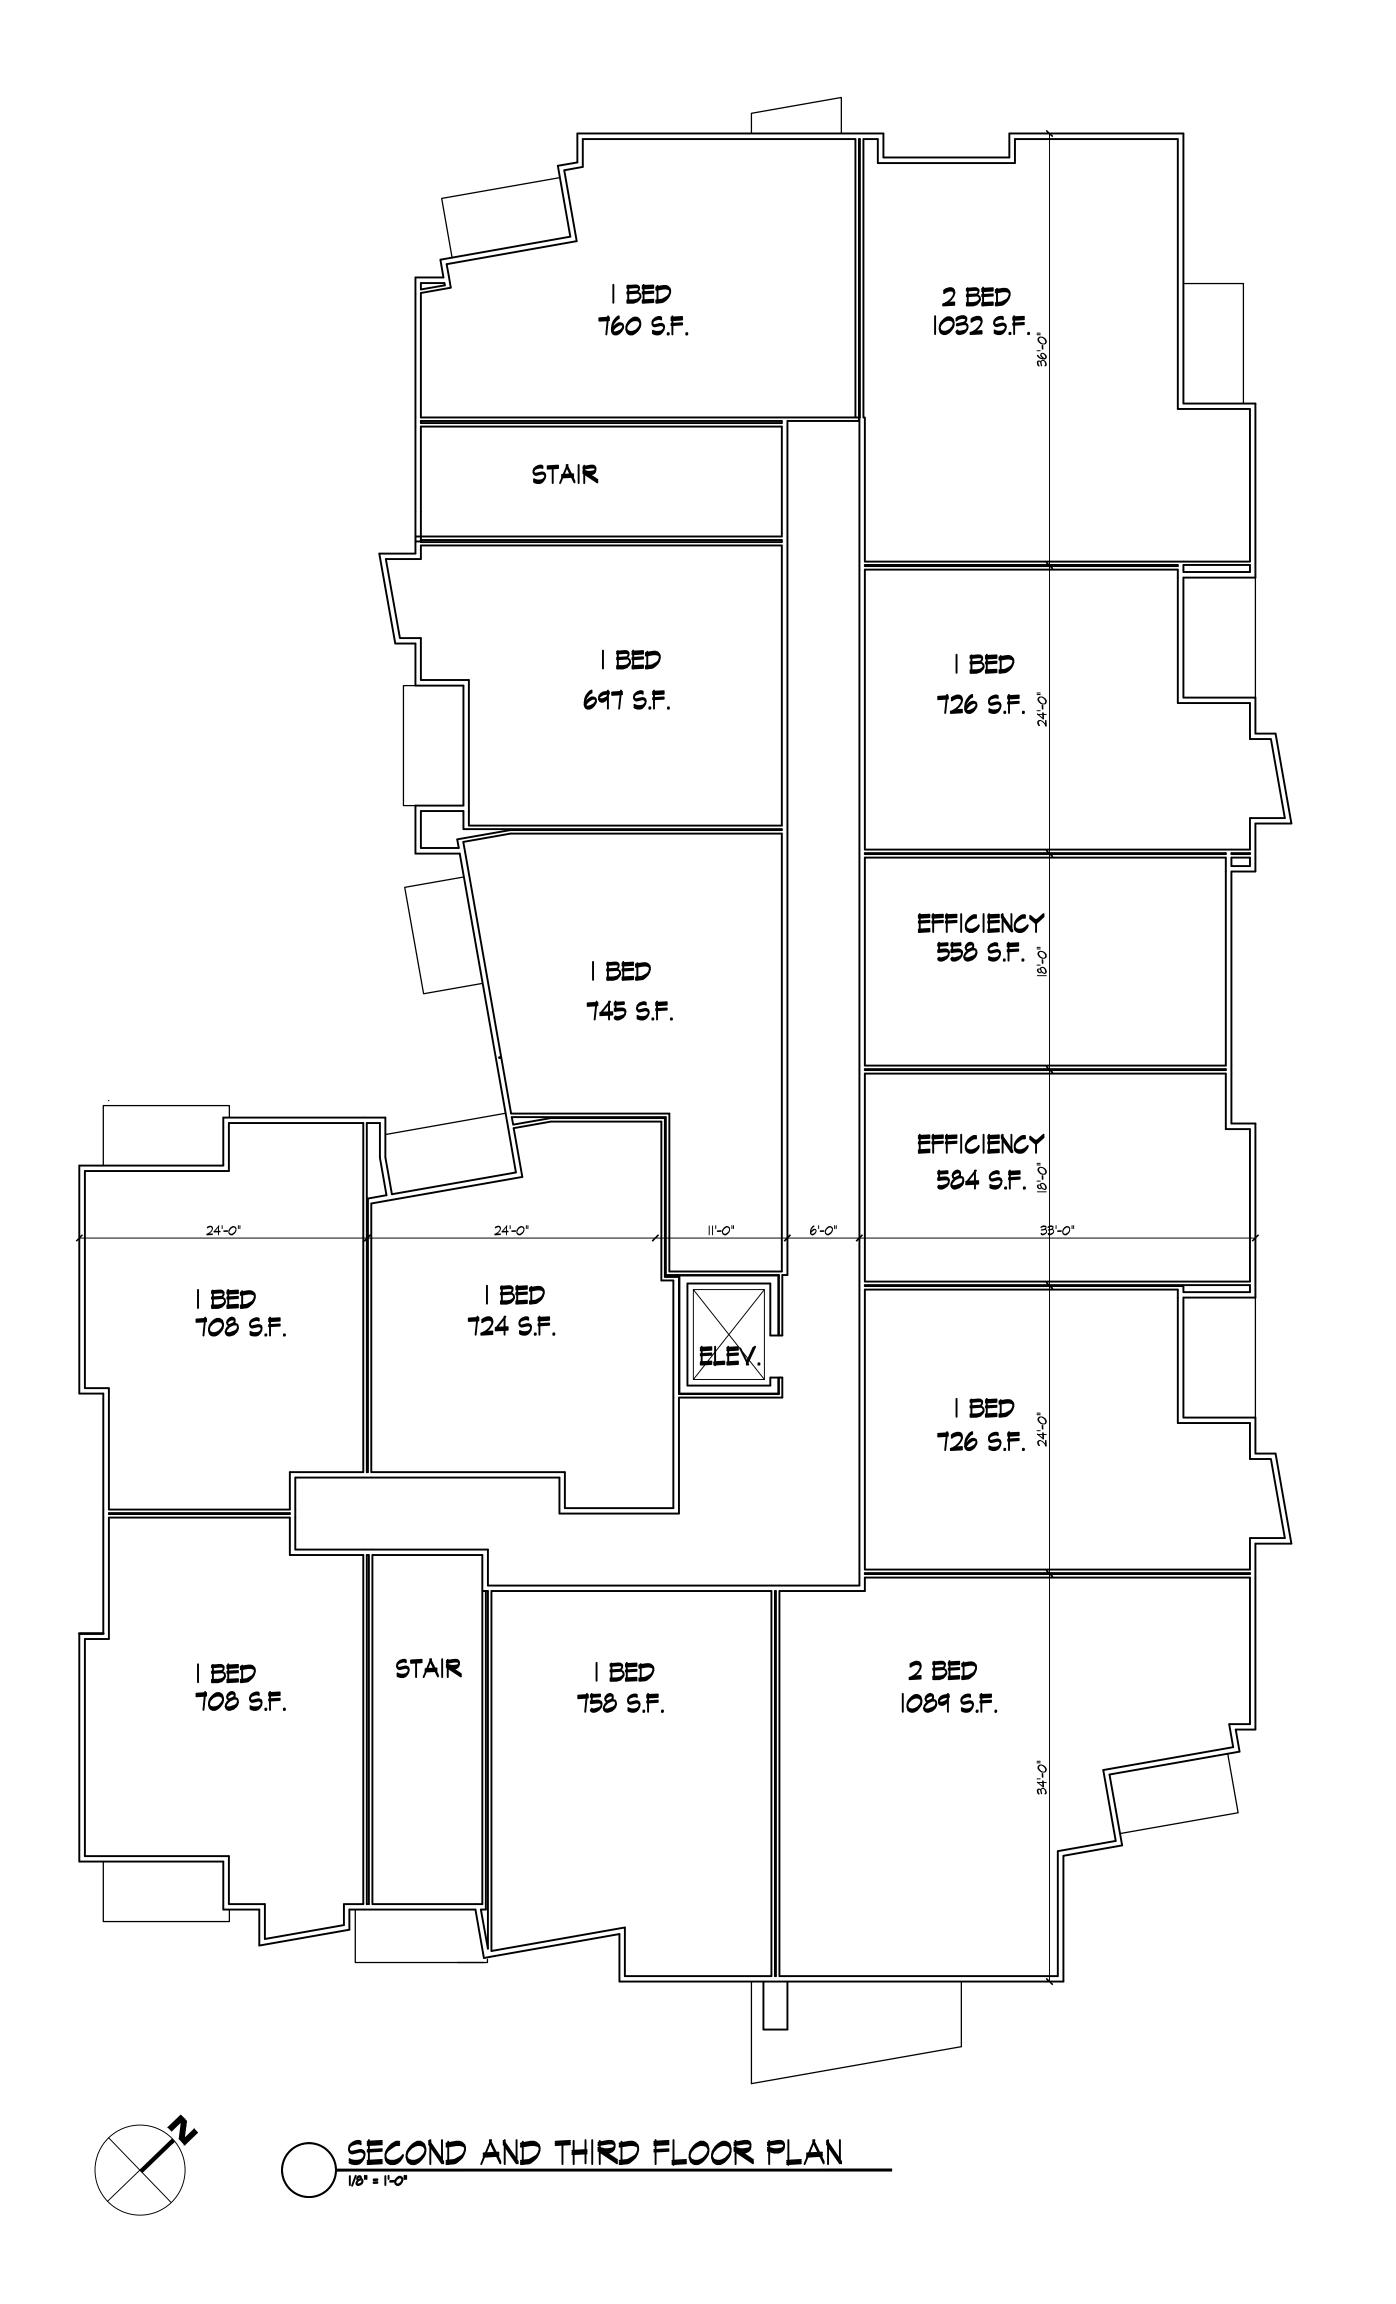



Revisions

SIP Submittal - March 20, 2013


Project Title

Atmood Avenue

1924 Atwood Ave.
Drawing Title
Second/Third Floor Plan

Project No. Drawing No.

A-1.3

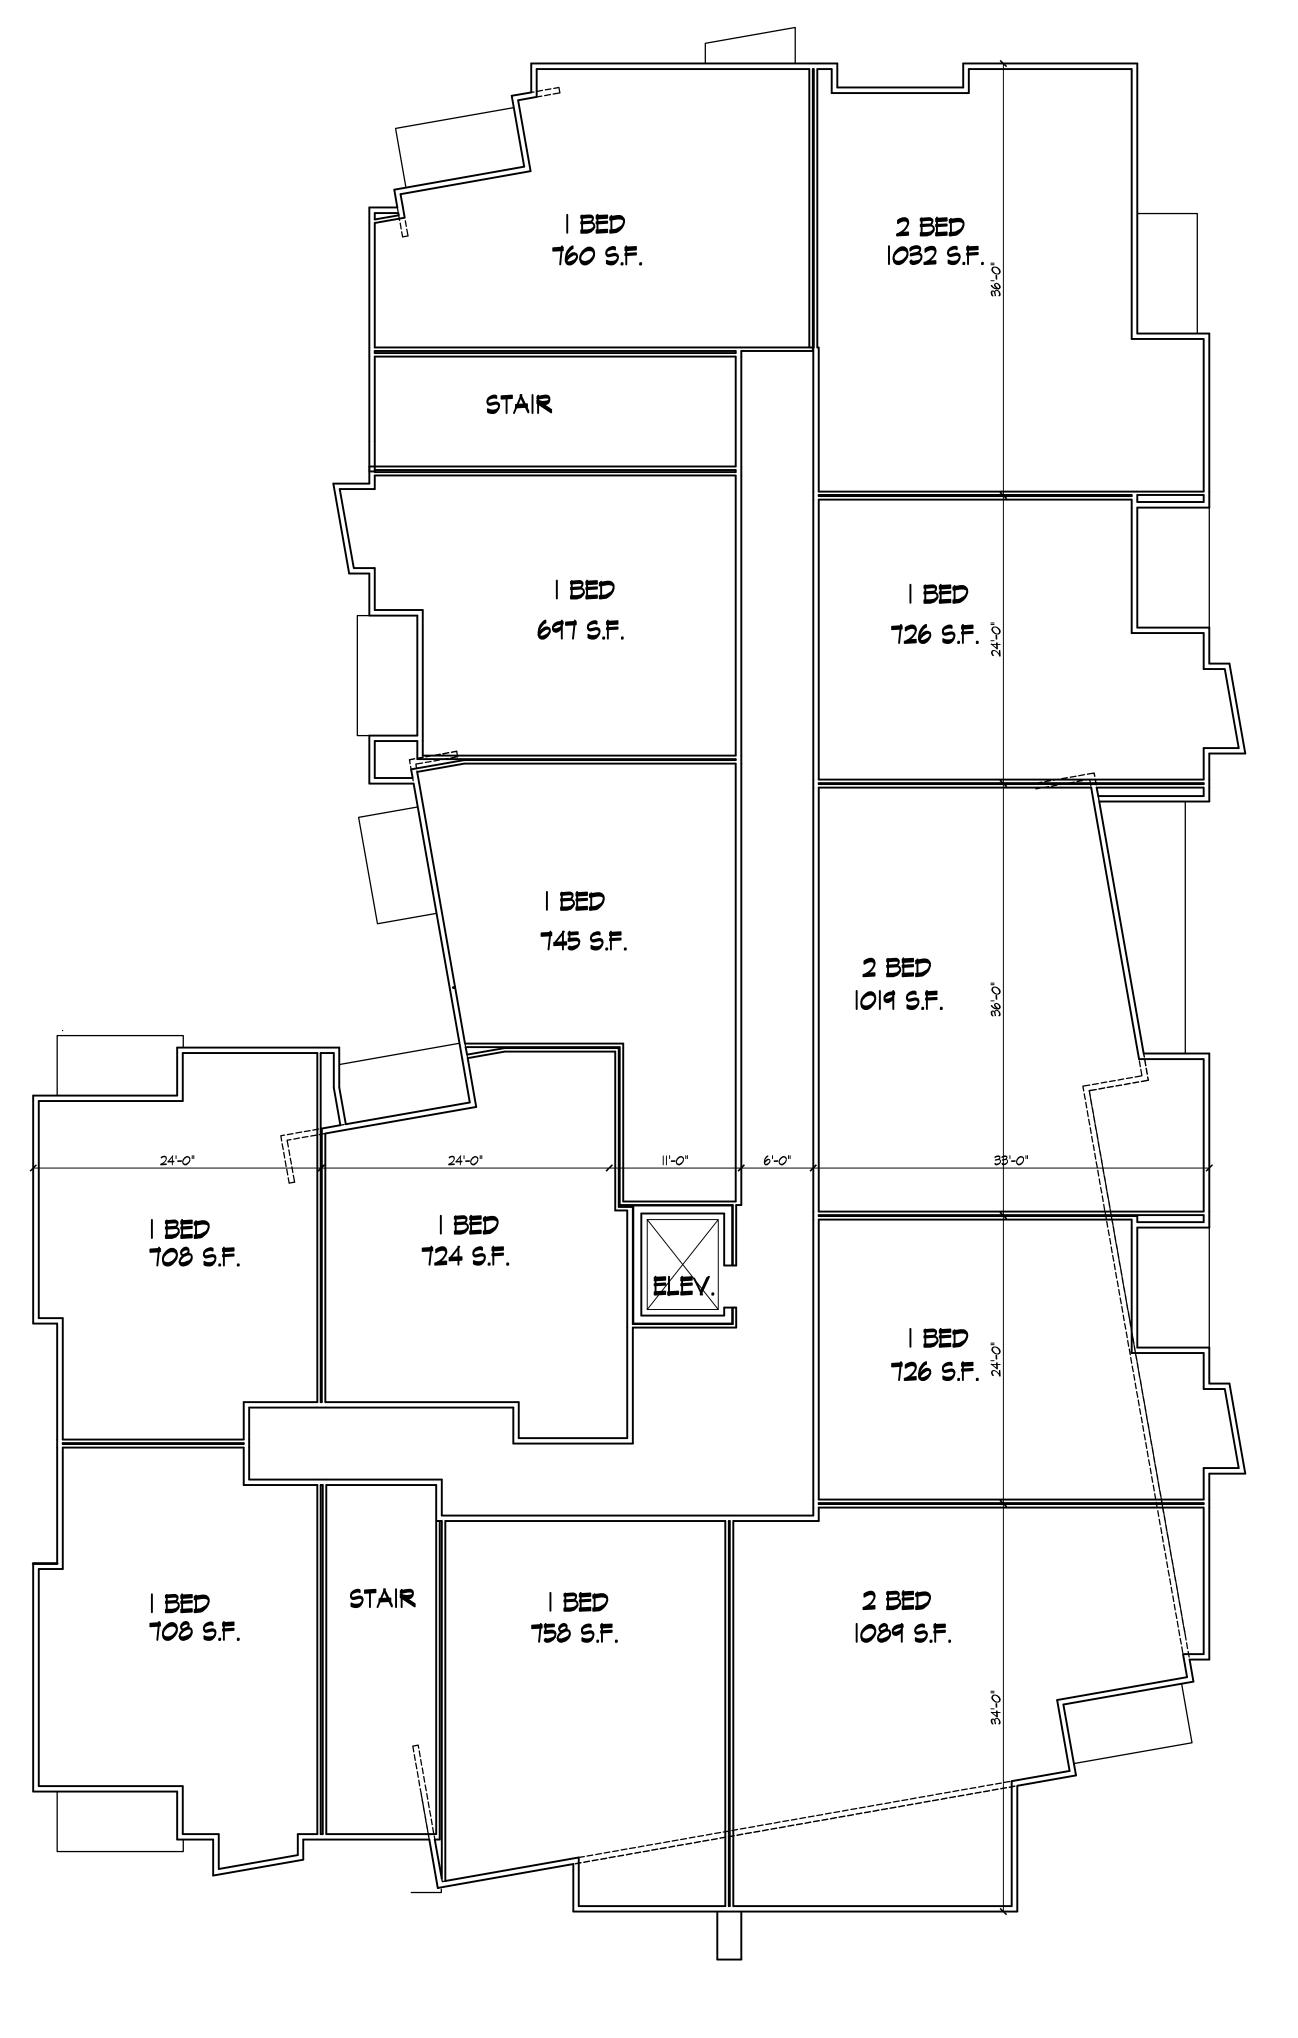







Revisions

SIP Submittal - March 20, 2013

Project Title
Atwood Avenue

1924 Atwood Ave.

Drawing Title

Fourth Floor Plan

Project No. Drawing No.


A-1.4



SOUTHEAST ELEVATION



NORTHEAST ELEVATION | |/8" = 1'-0"

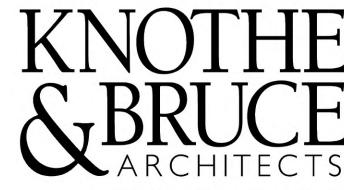

7601 University Avenue Suite 201 Middleton, Wisconsin 53562 608-836-3690 Fax 836-6934

Consultant

Revisions

SIP Submittal - March 20, 2013

Project Title

Atmood Avenue

1924 Atwood Ave.
Drawing Title
Elevations

Project No.

This document contains confidential or proprietary information of Knothe & Bruce Architects.

Drawing No.

A-2.1

Neither the document nor the information herein is to be reproduced, distributed, used, or disclosed, either in whole or in part, except as specifically authorized by Knothe & Bruce Architects. Knothe & Bruce Architects is a Limited Liability Company of Wisconsin.



NORTHWEST ELEVATION



SOUTHWEST ELEVATION



608-836-3690 Fax 836-6934

Consultant

Revisions SIP Submittal - March 20, 2013

Project Title

Atwood Avenue

1924 Atwood Ave.
Drawing Title
Elevations

Project No.

Drawing No.

A-2.2

1229

This document contains confidential or proprietary information of Knothe & Bruce Architects.

Neither the document nor the information herein is to be reproduced, distributed, used, or disclosed, either in whole or in part, except as specifically authorized by Knothe & Bruce Architects. Knothe & Bruce Architects is a Limited Liability Company of Wisconsin.



Perspective View

Atwood Avenue

KNOTHE

BRUCE

architects

Project # 1229 May 1, 2013