# DATE SUBMITTED: February 27, 2013

# **APPLICATION FOR URBAN DESIGN COMMISSION**

**REVIEW AND APPROVAL** 

| AGENDA ITEM# |  |
|--------------|--|
| Project #    |  |
| Legistar #   |  |

**Action Requested** 

**Informational Presentation** 

| UDC MEETING DATE: March 6, 2013  | Initial Approval and/or Recommendation Final Approval and/or Recommendation                    |
|--|--|
| PROJECT ADDRESS: 5302 Tancho Drive   | & 5101 American Parkway  |
| ALDERMANIC DISTRICT: District 17   |  |
| OWNER/DEVELOPER (Partners and/or Prin Fiduciary Real Estate Development                                  | ncipals) ARCHITECT/DESIGNER/OR AGENT: JLA Architects + Planners  5325 Wall Street - Suite 2700 |
| 789 North Water Street – Suite 200   | 5325 Wall Street - Suite 2700  |
| 789 North Water Street - Suite 200  Milwaukee, Wisconsin 53202   | — Madison, Wisconsin 53718 ————  |
| CONTACT PERSON: Joseph Lee (JLA Archi  |  |
| CONTACT PERSON: Joseph Lee (JLA Archi Address: 5325 Wall Street - Sui                                    | te 2700  |
| Madison, Wisconsin 5   | 53718  |
| Phone: 608.241.9500  |  |
| Fax:   |  |
| E-mail address: <u>jlee@jla-ap.com</u>   |  |
| well as a fee) School, Public Building or Space (Fee n   | SIP) D) OP) SIP) SIP) O) ing in an Urban Design District * (A public hearing is required as    |
| (See Section B for:) New Construction or Exterior Remodeli   | ing in C4 District (Fee required)  |
| (See Section C for:) R.P.S.M. Parking Variance (Fee require  | ed)  |
| (See Section D for:)  Comprehensive Design Review* (Fee reguired Street Graphics Variance* (Fee required | <b>A</b> '   |
| Other  |  |
| *Public Hearing Required (Submission Deadlin   | ue 3 Weeks in Advance of Meeting Date)   |

Where fees are required (as noted above) they apply with the first submittal for either initial or final approval of a project.

Public Hearing Required (Submission Deadline 3 Weeks in Advance of Meeting Date)



INTENDED USE – Ideal for parking areas, street lighting, walkways and car lots.

**CONSTRUCTION** — Rugged, die-cast, soft corner aluminum housing with 0.12" nominal wall thickness. Die-cast door frame has impact-resistant, tempered, glass lens that is fully gasketed with one-piece tubular silicone.

Finish: Standard finish is dark bronze (DDB) polyester powder finish, with other architectural colors available.

OPTICS - Anodized, aluminum reflectors: IES full cutoff distributions R2 (asymmetric), R3 (asymmetric), R4 (forward throw) and RSS (square) are interchangeable. High-performance anodized, segmented aluminum reflectors IES full cutoff distributions SR2 (asymmetric), SR3 (asymmetric) and SR4SC (forward throw, sharp cutoff). High-performance reflectors attach with tool-less fasteners and are rotatable and interchangeable.

**ELECTRICAL** – Ballast: High pressure sodium: 70-150W is high reactance, high power factor. Constant wattage  $autotransformer for 200-400W. \ Metal\ halide: 70-150W is\ high\ reactance, high\ power\ factor\ and\ is\ standard\ with$ pulse-start ignitor technology. "SCWA" not required. Constant wattage autotransformer for 175-400W. Super CWA (pulse start ballast), 88% efficient and EISA legislation compliant, is required for metal halide 151-400W (SCWA  $option) for \, US \, shipments \, only. \, CSA, \, NOM \, or \, INTL \, required \, for \, probe \, start \, shipments \, outside \, of \, the \, US. \, Pulse-start \, shipments \, outside \,$ ballast (SCWA) required for 200W, 320W, or 350W. Ballast is 100% factory-tested.

Socket: Porcelain, horizontally oriented medium base socket for 70-150M. Mogul base socket for 175M and above, and 70-400S, with copper alloy, nickel-plated screw shell and center contact. UL listed 1500W, 600V.

LISTINGS – UL Listed (standard). CSA Certified (see Options). UL listed for 25°C ambient and wet locations. IP65 rated in accordance with standard IEC 529.

Specifications subject to change without notice.

Catalog Number Notes Туре OA1 & OA2



**Soft Square Lighting** 

Specifications

EPA: 1.2 ft.2

\*Weight: 35.9 lbs (16.28 kg)

Length: 17-1/2 (44.5) Width: 17-1/2" (44.5)


Depth: 7-1/8 (18.1)

All dimensions are inches (centimeters)

unless otherwise specified.

\*Weight as configured in example below.

METAL HALIDE: 70-400W HIGH PRESSURE SODIUM: 70-400W 20'TO 35' MOUNTING

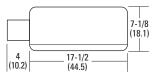

For shortest lead times, configure product using **bolded options**.

ORDERINGINFORMATION

Example: KAD 400M R3 TB SCWA SPD04 LPI

| KAD    |   |   |   |  |   |  |   |  |                      |  |
|--------|---|---|---|--|---|--|---|--|----------------------|--|
| Series | Wattage   | _   |   | Distribution   |   | Voltage  | Ballast   | Mounting <sup>12</sup>   |                      |  |
| KAD    | Metal halide<br>70M <sup>1,2</sup> <b>250M<sup>5</sup></b><br>100M <sup>1</sup> 320M <sup>4</sup><br>150M 350M <sup>3,4</sup><br>175M <sup>3</sup> <b>400M<sup>5,6</sup></b><br>200M <sup>4</sup> | High pressure sodium¹ 70S 100S 150S 250S 400S | Ceramic<br>metal<br>halide<br>70MHC <sup>1,2</sup><br>100MHC <sup>1</sup><br>150MHC | Standard reflectors  R2 IES type II asymmetric?  R3 IES type III asymmetric?  R4 IES type IV forward throw?  R55 IES type V square | High performance reflectors <sup>8</sup> SR2 IES type II asymmetric <sup>7</sup> SR3 IES type III asymmetric <sup>7</sup> SR4SC IES type IV forward throw | 120<br>208°<br>240°<br><b>277</b><br><b>347</b><br><b>480°</b><br><b>TB¹°</b><br>23050HZ¹¹ | (blank) Magnetic ballast  CWI Contant wattage isolated   SCWA Super CWA pulse-start ballast  NOTE: For shipments to U.S. territories, SCWA must be specified to comply with EISA. | Ships in fixture carton  SPD Square pole  RPD Round pole  WBD Wall bracket  WWD Wood or pole wall  Ships separately 13,14  DAD12P Degree arm (pole)  DAD12WB Degree arm (wall)  WBA Decorative wall bracket 15  KMA Mast arm external fitter  KTMB Twin mounting bar | 6 6" arm<br>9 9" arm |  |

| Option | S  |       |   |      |                                     | Finish <sup>20</sup> |               | Lamp <sup>21</sup> |   |
|--------|--|-------|---|------|-------------------------------------|----------------------|---------------|--------------------|---|
| Shippe | ed installed in fixture                    | QRSTD | QRS time delay <sup>18</sup>            | Ship | ped separately <sup>13</sup>        | (blank)              | Dark bronze   | LPI                | Lamp included                                       |
| SF     | Single fuse (120, 277, 347V) <sup>16</sup> | WTB   | Terminal wiring block <sup>17</sup>     | HS   | House side shield                   | DWH                  | White         | L/LP               | Less lamp   |
| DF     | Double fuse (208, 240, 480V) <sup>16</sup> | CSA   | CSA Certified                           | PE1  | NEMA twist-lock PE (120, 208, 2407) | DBL                  | Black         |                    |   |
| PD     | Power tray <sup>17</sup>                   | INTL  | Available MH for probe start shipping   | PE3  | NEMA twist-lock PE (347V)           | DMB                  | Medium bronze |                    | (.  |
| PER    | NEMA twist-lock receptacle only            |       | outside the U.S.                        | PE4  | NEMA twist-lock PE (480V)           | DNA                  | Natural       |                    | ATTAN.  |
|        | (no photocontrol)                          | REGC1 | California Title 20, effective 1/1/2010 | PE7  | NEMA twist-lock PE (277V)           |                      | aluminum      |                    | NIGHTTIME "<br>FRIENDLY                             |
| QRS    | Quartz restrike system <sup>18</sup>       |       |   | SC   | Shorting cap for PER option         |                      |               | Car                | raistent with LEED® goals<br>Green Globes™ criteria |
|        |  |       |   | VG   | Vandal guard <sup>19</sup>          |                      |               | fo                 | light pollution reduction                           |
|        |  |       |   | WG   | Wire guard <sup>19</sup>            |                      |               |                    |   |

### Notes

- 1 Not available with SCWA
- Not available with 480V.
- These wattages do not comply with California Title 20 regulations.
- Must be ordered with SCWA.
- These wattages require the REGC1 option to be chosen for shipments into California for Title 20 compliance. 250M REGC1 in not available in 347 or 480V.
- Reduced jacket ED28 required for SR2, SR3 and SR4SC optics.
- House-side shield available.
- High performance reflectors not available with QRSTD.
- Must specify CWI for use in Canada.
- 10 Optional multi-tap ballast (120, 208, 240, 277V; in Canada: 120, 277, 347V).
- 11 Consult factory for available wattages

- 12 9" arm is required when two or more luminaires are oriented on a 90° drilling pattern.
- 13 May be ordered as an accessory.
- 14 Must specify finish when ordered as an accessory.
- 15 Available with SPD04 and SPD09.
- 16 Must specicy voltage. N/A with TB. 17 Only available with SR2, SR3 and SR4SC optics.
- 18 Max allowable wattage lamp included.
- 19 Prefix with KAD when ordered as an accessory. 20 See www.lithonia.com/archcolors for additional color options.
- 21 Must be specified, L/LP not available with MHC.
- 22 Must use RPD09.

# Accessories: Tenon Mounting Slipfitter (RPxx required.) Order as seperate catalog number. Must be used with pole mounting.


| Number of fixtures   |         |         |                       |                       |                       |                       |  |  |  |  |
|--|---------|---------|-----------------------|-----------------------|-----------------------|-----------------------|--|--|--|--|
| <u>Tenon O.D. One Two@180° Two@90° Three@120° Three@90° Four@90'</u> |         |         |                       |                       |                       |                       |  |  |  |  |
| 2-3/8"   | T20-190 | T20-280 | T20-290 <sup>22</sup> | T20-320 <sup>22</sup> | T20-390 <sup>22</sup> | T20-490 <sup>22</sup> |  |  |  |  |
| 2-7/8"   | T25-190 | T25-280 | T25-290 <sup>22</sup> | T25-320               | T25-390 <sup>22</sup> | T25-490 <sup>22</sup> |  |  |  |  |
| 4  | T35-190 | T35-280 | T35-290 <sup>22</sup> | T35-320               | T35-390 <sup>22</sup> | T35-490 <sup>22</sup> |  |  |  |  |

OUTDOOR KAD-M-S

# KAD Metal Halide, Arm-mounted Soft Square Cutoff

Coefficient of Utilization **Initial Footcandles** 

# KAD 400M R2 Test no. 1193083101P **ISOILLUMINANCE PLOT (Footcandle)**

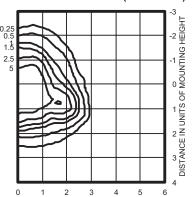


400W pulse start metal halide lamp, rated 38000 lumens. Footcandle values based on 20' mounting height.

Classification: Type II, Short, Full Cutoff

### KAD 400M R3 Test no. 1192040902P

### **ISOILLUMINANCE PLOT (Footcandle)**

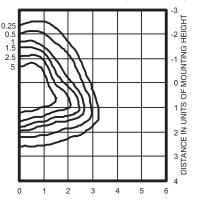


400W pulse start metal halide lamp, rated 38,000 lumens. Footcandle values based on 20' mounting height.

Classification: Type II, Short, Full Cutoff

### KAD 400M R4 Test no. 1191110101P


### **ISOILLUMINANCE PLOT (Footcandle)**

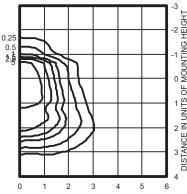

Classification: Unclassified (Type III, Very Short), Full Cutoff

# KAD 400M R4HS Test no. 1192061101P

### **ISOILLUMINANCE PLOT (Footcandle)**

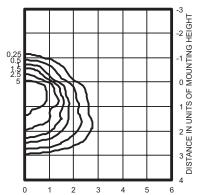

400W pulse start metal halide lamp, rated 38,000 lumens. Footcandle values based on 20'

mounting height. Classification: Unclassified (Type III, Very Short), Full

# **Mounting Height Correction Factor**

mounting height.

KAD 400M R5S Test no. 1194040801P **ISOILLUMINANCE PLOT (Footcandle)** 

FANCE IN UNITS OF MOUNTING HEIGHT

(Multiply the fc level by the correction factor)

25 ft. = 0.64 35 ft. = 0.32


40 ft. = 0.25

 $\frac{\text{Existing Mounting Height}}{\text{New Mounting Height}}\right)^2 = \text{Correction Factor}$ 

400W pulse start metal halide lamp, rated 38000

Classification: Unclassified (Type NC, Very Short), Full Cutoff

lumens. Footcandle values based on 201

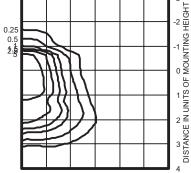

400W pulse start metal halide lamp, rated 38,000 lumens. Footcandle values based on 20' mounting height.

### Notes

- 1 Photometric data for other distributions can be accessed at www.lithonia.com.
- 2 Tested to current IES and NEMA standards under stabilized laboratory conditions. Various operating factors can cause differences between laboratory data and actual field measurements. Dimensions and specifications on this sheet are based on the most current available data and are subject to change without notice.
- 3 For electrical characteristics, consult outdoor technical data specification sheets on www.lithonia.com.





**CONSTRUCTION** — Weldable-grade, hot-rolled, commercial-quality carbon steel tubing with a minimum yield of 55,000 psi (11-gauge), or 50,000 psi (7gauge). Uniform wall thickness of .125" or .188". Shaft is one-piece with a fulllength longitudinal high-frequency electric resistance weld. Uniformly square in cross-section with flat sides, small corner radii and excellent torsional qualities. Available shaft widths are 4, 5 and 6 inches.

Anchor base is fabricated from hot-rolled carbon steel plate conforming to ASTM A36, that meets or exceeds a minimum-yield strength of 36,000 psi. Base plate and shaft are circumferentially welded top and bottom. Base cover is finished to match pole.

A handhole having nominal dimensions of 3" x 5" for all shafts. Included is a cover with attachment screws.

Top cap provided with all drill-mount poles.


Fasteners are high-strength galvanized, zinc-plated or stainless steel.

Finish: Must specify finish.

Grounding: Provision located immediately inside handhole rim. Grounding hardware is not included (provided by others).


Anchor Bolts: Top portion of anchor bolt is galvanized per ASTM A-153. Made of steel rod having a minimum yield strength of 55,000 psi.

Catalog Number Notes Type OA1 & OA2

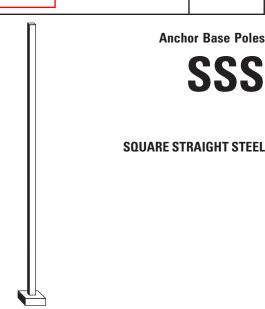


# ORDERING INFORMATION

Lead times will vary depending on options selected. Consult with your sales representative. Example: SSS 20 5C DM19 DDB

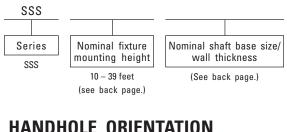

# HANDHOLE ORIENTATION

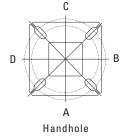

- 1 When ordering tenon mounting and drill mounting for the same pole, follow this example: DM28/T20. The combination includes a
- The drilling template to be used for a particular luminaire depends on the luminaire that is used. Refer to the Technical Data Section of the Outdoor Binder for Drilling Templates.
- 3 Insert "1" or "2" to designate fixture size; e.g. DM19AST2.
- 4 Specify location and orientation when ordering option.

Specify the height in feet above base of pole. For 1st "x": Example: 5ft = 5 and 20ft = 20

For 2nd "x": Specify orientation from handhole (A,B,C,D) Refer to the Handhole Orientation diagram above.

- 5 Horizontal arm is 18" x 2-3/8" O.D. tenon standard.
- 6 Combination of tenon-top and drill mount includes extra handhole.
- Additional colors available; see www.lithonia.com/archcolors or Architectural Colors brochure (Form No. 794.3). Powder finish standard.

Tenon mounting PT Open top T20 2-3/8" O.D. (2" NPS) 2-7/8" O.D. (2-1/2" NPS) 3-1/2" O.D. (3" NPS) T35 4" O.D. (3-1/2" NPS) Drill mounting<sup>2</sup> DM19 1 at 90° DM28 2 at 180° DM28PL 2 at 180° with one side plugged DM29 2 at 90° DM39 3 at 90° DM49 4 at 90° AERIS™/OMERO™ Drill mounting<sup>2</sup> DM19AS 1 at 90° DM28AS 2 at 180° DM29AS 2 at 90° DM39AS 3 at 90° DM49AS 4 at 90° AERIS™ Suspend drill mounting<sup>2,3</sup> DM19AST\_ 1 at 90°


Mounting<sup>1</sup>

DM28AST\_ 2 at 180° DM29AST\_ 2 at 90° DM39AST\_ 3 at 90° DM49AST\_ 4 at 90° OMERO™ Suspend drill mounting<sup>2,3</sup> DM19MRT\_ 1 at 90° DM28MRT\_ 2 at 180° DM29MRT\_ 2 at 90° DM39MRT 3 at 90° DM49MRT\_ 4 at 90°


Options Finish7 Shipped installed Standard colors L/AB Less anchor bolts DDB Dark bronze VD Vibration damper DWH White TP Tamper proof DBL Black Horizontal arm bracket (1 fixture)<sup>4,5</sup> DMB Medium bronze DNA Natural aluminum FDLxx Festoon outlet less GALV Galvanized finish electrical4 Classic colors CPL12 xx 1/2" coupling4 DSS Sandstone CPL34 xx 3/4" coupling4 DGC Charcoal gray CPL1 xx 1" coupling4 DTG Tennis green NPL12xx 1/2" threaded nipple4 DBR Bright red NPL34xx 3/4" threaded nipple4 DSB Steel blue NPL1 xx 1" threaded nipple4 Architectural colors EHHxx Extra handhole<sup>4,6</sup> (powder finish)7


Sheet #: Pole-SSS PL-320 Outdoor

|                   |                                   |                              | 7                             | ГЕСН  | IICA      | L INF                   | ORM       | ATION          | ١          |                |                         |                                |                                  |
|-------------------|-----------------------------------|------------------------------|-------------------------------|-------|-----------|-------------------------|-----------|----------------|------------|----------------|-------------------------|--------------------------------|----------------------------------|
|                   |                                   |                              |                               |       |           | EPA (ft²) with 1.3 gust |           |                |            |                |                         |                                |                                  |
| Catalog<br>Number | Nominal<br>shaft<br>length (feet) | Pole Shaft<br>Size (in x ft) | Wall<br>Thickness<br>(inches) | Gauge | 80<br>mph | Max.<br>weight          | 90<br>mph | Max.<br>weight | 100<br>mph | Max.<br>weight | Bolt Circle<br>(inches) | Bolt Size<br>(in. x in. x in.) | Approximate ship weight (pounds) |
| SSS 10 4C         | 10                                | 4.0 x 10.0                   | 0.125                         | 11    | 30.6      | 765                     | 23.8      | 595            | 18.9       | 473            | 89                      | 3/4 x 18 x 3                   | 75                               |
| SSS 12 4C         | 12                                | 4.0 x 12.0                   | 0.125                         | 11    | 24.4      | 610                     | 18.8      | 470            | 14.8       | 370            | 89                      | 3/4 x 18 x 3                   | 90                               |
| SSS 14 4C         | 14                                | 4.0 x 14.0                   | 0.125                         | 11    | 19.9      | 498                     | 15.1      | 378            | 11.7       | 293            | 89                      | 3/4 x 18 x 3                   | 100                              |
| SSS 16 4C         | 16                                | 4.0 x 16.0                   | 0.125                         | 11    | 15.9      | 398                     | 11.8      | 295            | 8.9        | 223            | 89                      | 3/4 x 18 x 3                   | 115                              |
| SSS 18 4C         | 18                                | 4.0 x 18.0                   | 0.125                         | 11    | 12.6      | 315                     | 9.2       | 230            | 6.7        | 168            | 89                      | 3/4 x 18 x 3                   | 125                              |
| SSS 20 4C         | 20                                | 4.0 x 20.0                   | 0.125                         | 11    | 9.6       | 240                     | 6.7       | 167            | 4.5        | 150            | 89                      | 3/4 x 18 x 3                   | 140                              |
| SSS 20 4G         | 20                                | 4.0 x 20.0                   | 0.188                         | 7     | 14.0      | 350                     | 11.0      | 275            | 8.0        | 200            | 89                      | 3/4 x 30 x 3                   | 198                              |
| SSS 20 5C         | 20                                | 5.0 x 20.0                   | 0.125                         | 11    | 17.7      | 443                     | 12.7      | 343            | 9.4        | 235            | 1012                    | 1 x 36 x 4                     | 185                              |
| SSS 20 5G         | 20                                | 5.0 x 20.0                   | 0.188                         | 7     | 28.1      | 703                     | 21.4      | 535            | 16.2       | 405            | 1012                    | 1 x 36 x 4                     | 265                              |
| SSS 25 4C         | 25                                | 4.0 x 25.0                   | 0.125                         | 11    | 4.8       | 150                     | 2.6       | 100            | 1.0        | 50             | 89                      | 3/4 x 18 x 3                   | 170                              |
| SSS 25 4G         | 25                                | 4.0 x 25.0                   | 0.188                         | 7     | 10.8      | 270                     | 7.7       | 188            | 5.4        | 135            | 89                      | 3/4 x 30 x 3                   | 245                              |
| SSS 25 5C         | 25                                | 5.0 x 25.0                   | 0.125                         | 11    | 9.8       | 245                     | 6.3       | 157            | 3.7        | 150            | 1012                    | 1 x 36 x 4                     | 225                              |
| SSS 25 5G         | 25                                | 5.0 x 25.0                   | 0.188                         | 7     | 18.5      | 463                     | 13.3      | 333            | 9.5        | 238            | 1012                    | 1 x 36 x 4                     | 360                              |
| SSS 30 4G         | 30                                | 4.0 x 30.0                   | 0.188                         | 7     | 6.7       | 168                     | 4.4       | 110            | 2.6        | 65             | 89                      | 3/4 x 30 x 3                   | 295                              |
| SSS 30 5C         | 30                                | 5.0 x 30.0                   | 0.125                         | 11    | 4.7       | 150                     | 2.0       | 50             |            |                | 1012                    | 1 x 36 x 4                     | 265                              |
| SSS 30 5G         | 30                                | 5.0 x 30.0                   | 0.188                         | 7     | 10.7      | 267                     | 6.7       | 167            | 3.9        | 100            | 1012                    | 1 x 36 x 4                     | 380                              |
| SSS 30 6G         | 30                                | 6.0 x 30.0                   | 0.188                         | 7     | 19.0      | 475                     | 13.2      | 330            | 9.0        | 225            | 1113                    | 1 x 36 x 4                     | 520                              |
| SSS 35 5G         | 35                                | 5.0 x 35.0                   | 0.188                         | 7     | 5.9       | 150                     | 2.5       | 100            |            |                | 1012                    | 1 x 36 x 4                     | 440                              |
| SSS 35 6G         | 35                                | 6.0 x 35.0                   | 0.188                         | 7     | 12.4      | 310                     | 7.6       | 190            | 4.2        | 105            | 1113                    | 1 x 36 x 4                     | 540                              |
| SSS 39 6G         | 39                                | 6.0 x 39.0                   | 0.188                         | 7     | 7.2       | 180                     | 3.0       | 75             |            |                | 1113                    | 1 x 36 x 4                     | 605                              |

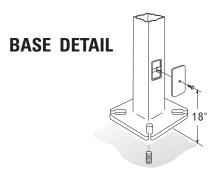

|                       |                            |                                |                | Pole Data               |                         |                                       |
|-----------------------|----------------------------|--------------------------------|----------------|-------------------------|-------------------------|---------------------------------------|
| Shaft<br>base<br>size | Bolt<br>circle<br><b>A</b> | Bolt<br>projection<br><b>B</b> | Base<br>square | Template<br>description | Anchor bolt description | Anchor bolt<br>and template<br>number |
| 4"C                   | 8-1/2"                     | 2-3/4"-4"                      | 8"             | ABTEMPLATE PJ50004      | AB18-0                  | ABSSS-4C                              |
| 4"G                   | 8-1/2"                     | 2-3/4"-4"                      | 8"             | ABTEMPLATE PJ50004      | AB30-0                  | ABSSS-4G                              |
| 5"                    | 10"-12"                    | 3-3/8"-4"                      | 11"            | ABTEMPLATE PJ50010      | AB36-0                  | ABSSS-5                               |
| 6"                    | 11"-13"                    | 3-3/8"-4"                      | 12-1/2"        | ABTEMPLATE PJ50011      | AB36-0                  | N/A                                   |

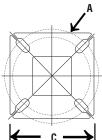

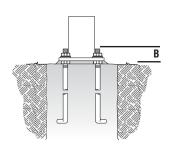

# IMPORTANT INSTALLATION NOTES:

- Do not erect poles without having fixtures installed.
- Factory-supplied templates must be used when setting anchor bolts. Lithonia Lighting will not accept claim for incorrect anchorage placement due to failure to use Lithonia Lighting factory templates.
- If poles are stored outside, all protective wrapping must be removed immediately upon delivery to prevent finish damage.
- Lithonia Lighting is not responsible for the foundation design.

### IMPORTANT:

• These specifications are intended for general purposes only. Lithonia reserves the right to change material or design, without prior notice, in a continuing effort to upgrade its products.



**Lithonia Lighting** 

Outdoor

One Lithonia Way, Conyers, GA 30012 Phone: 770-922-9000 Fax: 770-918-1209 www.lithonia.com



**INTENDED USE**— For building- and wall-mounted applications.

**CONSTRUCTION** — Rugged, die-cast, single-piece aluminum housing. Die-cast door frame has a 1/8" thick tempered glass lens. Door frame is fully gasketed with one-piece solid silicone.

**OPTICS** — Segmented reflectors for superior uniformity and control. Reflectors are interchangeable. Three full cutoff distributions available: FT (forward throw), MD (medium throw) and WT (wide throw).

**ELECTRICAL** — Ballast: 50W-150W utilizes a high reactance, high power factor ballast. Metal halide 150W and  $below\,are\,standard\,with\,pulse-start\,technology.\,35S\,utilizes\,a\,reactance\,high\,power factor\,ballast.\,175W\,utilizes\,areactance\,high\,power factor\,ballast.\,175W\,utilizes\,areact$  $a constant-wattage \, autotransformer \, ballast. \, CSA, NOM \, or \, INTL \, required \, for \, probe \, start \, shipments \, outside \, of the \, including the constant and including the con$ US for 175M. Not available 175M SCWA. Ceramic metal halide lamps are recommended for use in applications where superior color rendition, lumen maintenance and longer lamp life are desired.

Quick disconnect plug easily disconnects reflector from ballast. Ballasts are 100% factory-tested.

Socket: Porcelain, medium-base socket with copper alloy, nickel-plated screw shell and center contact. UL listed 660W, 600V 4KV pulse rated.

Finish: Standard finish is textured dark bronze (DDBT) corrosion-resistant polyester powder finish. Additional architectural colors are available. Striping is also available.

INSTALLATION — Universal mounting mechanism with integral mounting support allows fixture to hinge down. Bubble level provides correct alignment with each installation.

LISTINGS — UL Listed (standard). CSA Certified (see Options). Suitable for wet locations (damp location listed in lens-up orientation). WLU option offers wet location listing in up orientation (see Options). IP65 rated. 25°C ambient. ELED: U.S. Patent No. 7,737,640.

Note: Specifications subject to change without notice.

| Catalog<br>Number |          |  |
|-------------------|----------|--|
| Notes             |          |  |
|                   |          |  |
| Туре              | OB1 &OB2 |  |



**Decorative Wall-Mounted Lighting** 

METAL HALIDE: 50W-175W HIGH PRESSURE SODIUM: 35W-150W

**Specifications** Length: 16-1/4 (41.2) Depth: 9-1/8 (23.2) Overall Height: 7-1/4 (18.4) \*Weight: 30 lbs (13.6 kg)

7-1/4 16-1/4 (41.2)

All dimensions are inches (centimeters) unless otherwise indicated.

### ORDERING INFORMATION

OUTDOOR

For shortest lead times, configure product using **standard options** (shown in bold).

Example: WST 100M FT TB LPI

|   | WST<br>Series | Wattage/source   | Distribution  | Voltage  | Ballast   | Mounting   | Options  |
|---|---------------|--|---|--|---|--|--|
| 1 | WST           | High pressure sodium         Metal halide metal sodium         Ceramic metal halide metal halide           355¹         70M         50MfC           50S         100M         70MHC           70S         150M         100MHC           100S         175M²         150MHC | FT Forward throw MD Medium throw (coated lamp std.) WT Wide throw | 120<br>208 <sup>3</sup><br>240 <sup>3</sup><br>277<br>347<br>TB <sup>4</sup><br>23050HZ <sup>5</sup> | (blank) Magnetic ballast CWI Constant wattage isolated  Pulse Start SCWA Super CSA pulse start ballaste | ( <b>blank</b> ) Surface mount Shipped separately <sup>7</sup> BBW Surface mount back box UT5 Uptilt 5 degrees | Shipped installed in fixture  SF Single fuse (120, 277, 347V) <sup>8</sup> DF Double fuse (208, 240V) <sup>8</sup> DC12 Emergency circuit 12-volt (35W lamp included) <sup>9</sup> 2DC12 Emergency circuit 12-volt (two 35W lamps included) <sup>9</sup> DC2012 Emergency circuit 12-volt (20W lamp included) <sup>9</sup> 2DC2012 Emergency circuit 12-volt (two 20W lamps included) <sup>9</sup> |

| Options           | (continued)   |                                  |  |                   |   | Finish <sup>16</sup>               |  | Lamp <sup>1</sup> | 3                          |
|-------------------|---|----------------------------------|--|-------------------|---|------------------------------------|--|-------------------|----------------------------|
| 2ELED  DFL EC IBS | Emergency LED secondary source battery pack with time delay (-4°F min. operating temperature) <sup>10</sup> Emergency LED secondary source (two modules) battery pack with time delay (-4°F min. operating temperature) <sup>10</sup> Diffusing lens Emergency circuit <sup>11,12</sup> Internal backlight shield <sup>13</sup> Photoelectric cell-button type (n/a TB) <sup>14</sup> | QRS<br>WLU<br>CSA<br>NOM<br>INTL | Quartz restrike system <sup>11, 15</sup> Wet location door for up orientation CSA certified NOM certified <sup>5</sup> International shipment for 175M | Shipp<br>WG<br>VG | ed separately <sup>14</sup><br>Wire guard<br>Vandal guard | (blank) DSST DNAT DWHG DBLB CR CRT | Dark bronze, textured Sandstone, textured Natural aluminum, textured White, textured Black, textured Corrosion-resistance Non-stick protective coating <sup>17</sup> | LPI<br>L/LP       | Lamp included<br>Less lamp |

### Notes

- These wattages do not comply with California Title 20 regulations.
- Must specify CWI for use in Canada.
- Optional multi-tap ballast (120, 208, 240, 277V); (120, 277, 347V in Canada; ships as 120V/347V).
- Consult factory for available wattages
- Available with 150M or 150MHC only
- May be ordered as an accessory with prefix "WS". Must specify finish.
- Not available with DC options.
- Not available with ELED, SF, DF, EC or QRS.
- Maximum wattage 100M, 70S. Must specify 120V or 277V. Not available with QRS, EC or DC.
- Maximum allowable wattage lamp included.
- Not available with ELED, QRS or DCs.

- Not available with medium throw (MD, MDU, MDU5) distributions.
- Must be ordered with fixture; cannot be field installed.
- Not available with ELED, EC or DCs.
- See www.lithonia.com/archcolors for additional color options.
- Black finish only.
- Must be specified. L/LP not available with MHC.



sistent with LEED® goals Green Globes™ criteria light pollution reduction

<sup>\*</sup>Weight as configured in example below.



### **INTENDED USE**

Provides general illumination for outdoor use in residential and light commercial applications. Ideal for driveways, walkways, and play areas creating an inviting exterior space as well as providing safety and security.

### **ATTRIBUTES**

Bring old-world elegance outdoors with the Kingsly post top. Available in a black finish with frosted seeded glass diffuser or antique bronze with amber glass diffuser, both have a dusk-to-dawn photocell for added energy efficiency. Matching finish pole top fitter is designed to fit a 3" diameter pole. The Kingsly post top provides a wide spread even illumination for safety and security. Designed for outdoor use only. Should not be used in areas with limited ventilation or high ambient temperatures.

Includes (1) 26W compact full spiral tube 4-pin 2700K fluorescent lamp for energy efficiency, superior color rendering and long life.

Standard with residential-grade electronic ballast (120 volt, 60Hz) ensures no flickering and quiet operation. Starts instantly down to 0°F (-18°C).

Use with non-dimmable switches only.


All mounting hardware included.

### LISTING

CUL listed to US and Canadian safety standards and suitable for wet locations. ENERGY STAR  $^{\rm e}$  qualified.

### WARRANTY

Guaranteed for two years against mechanical defects in manufacture.

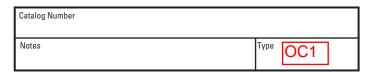

**Outdoor Decorative** 

# Kingsly Post Top

Compact Fluorescent






### **DIMENSIONS**


| Nominal<br>Size |  |        | Number<br>of Lamps          | (A) Width inches (cm) | (B) Height inches (cm) |  |
|-----------------|--|--------|-----------------------------|-----------------------|------------------------|--|
| 11"             |  | ODPT12 | (1) 26W compact full spiral | 11-1/2" (29.2)        | 20-1/2" (52.1)         |  |

All dimensions are in inches (centimeters)

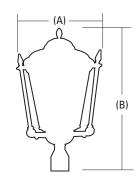

# ORDERING INFORMATION

Choose the boldface catalog nomenclature that best suits your needs and write it on the appropriate line. Order accessories and replacement parts as separate catalog numbers.

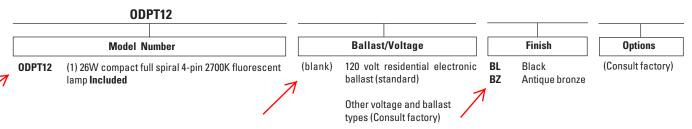

Example: **ODPT12 BL** 



### **INTENDED USE**

Provides general illumination for outdoor wall use in residential and light commercial applications. Ideal for entryways creating an inviting exterior space as well as providing safety and security.

### **ATTRIBUTES**

Bring old-world elegance outdoors with the Kingsly lantern. Offered in two sizes, each is available in a black finish with frosted seeded glass diffuser or antique bronze with amber glass diffuser, all have a dusk-to-dawn photocell for added energy efficiency. The Kingsly lantern provides a wide spread even illumination for safety and security. Designed for outdoor use only. Should not be used in areas with limited ventilation or high ambient temperature.

Includes (1) compact full spiral tube 4-pin 2700K fluorescent lamp for energy efficiency, superior color rendering and long life.

Standard with residential-grade electronic ballast (120 volt, 60Hz) ensures no flickering and quiet operation. Starts instantly down to 0°F (-18°C).

Use with non-dimmable switches only.

All mounting hardware included.

### LISTING

CUL listed to US and Canadian safety standards and suitable for wet locations. ENERGY  $STAR^{\oplus}$  qualified.

### WARRANTY


Guaranteed for two years against mechanical defects in manufacture.



**Outdoor Decorative** 

# Kingsly

# Lantern

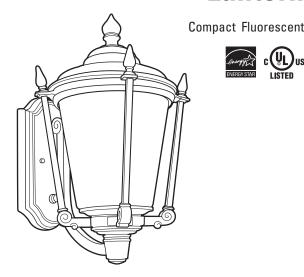


# **DIMENSIONS**

|   | Nominal<br>Size | Lamp<br>Configuration | Model<br>Number | Number<br>of Lamps          | (A) Width inches (cm) | (B) Height inches (cm) | (C) Extension*<br>inches (cm) |
|---|-----------------|-----------------------|-----------------|-----------------------------|-----------------------|------------------------|-------------------------------|
| 7 | Small           |                       | ODSL12          | (1) 13W compact full spiral | 7" (17.8)             | 14-1/4" (36.2)         | 9" (22.9)                     |
|   | Large           |                       | ODLL12          | (1) 26W compact full spiral | 11" (27.9)            | 19" (48.3)             | 13" (33.0)                    |


<sup>\*</sup> Maxium extension from wall

All dimensions are in inches (centimeters)

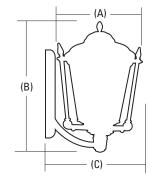


# ORDERING INFORMATION

Choose the boldface catalog nomenclature that best suits your needs and write it on the appropriate line. Order accessories and replacement parts as separate catalog numbers.

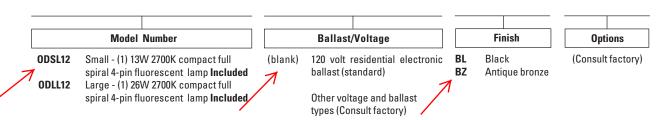

Example: ODSL12 BL

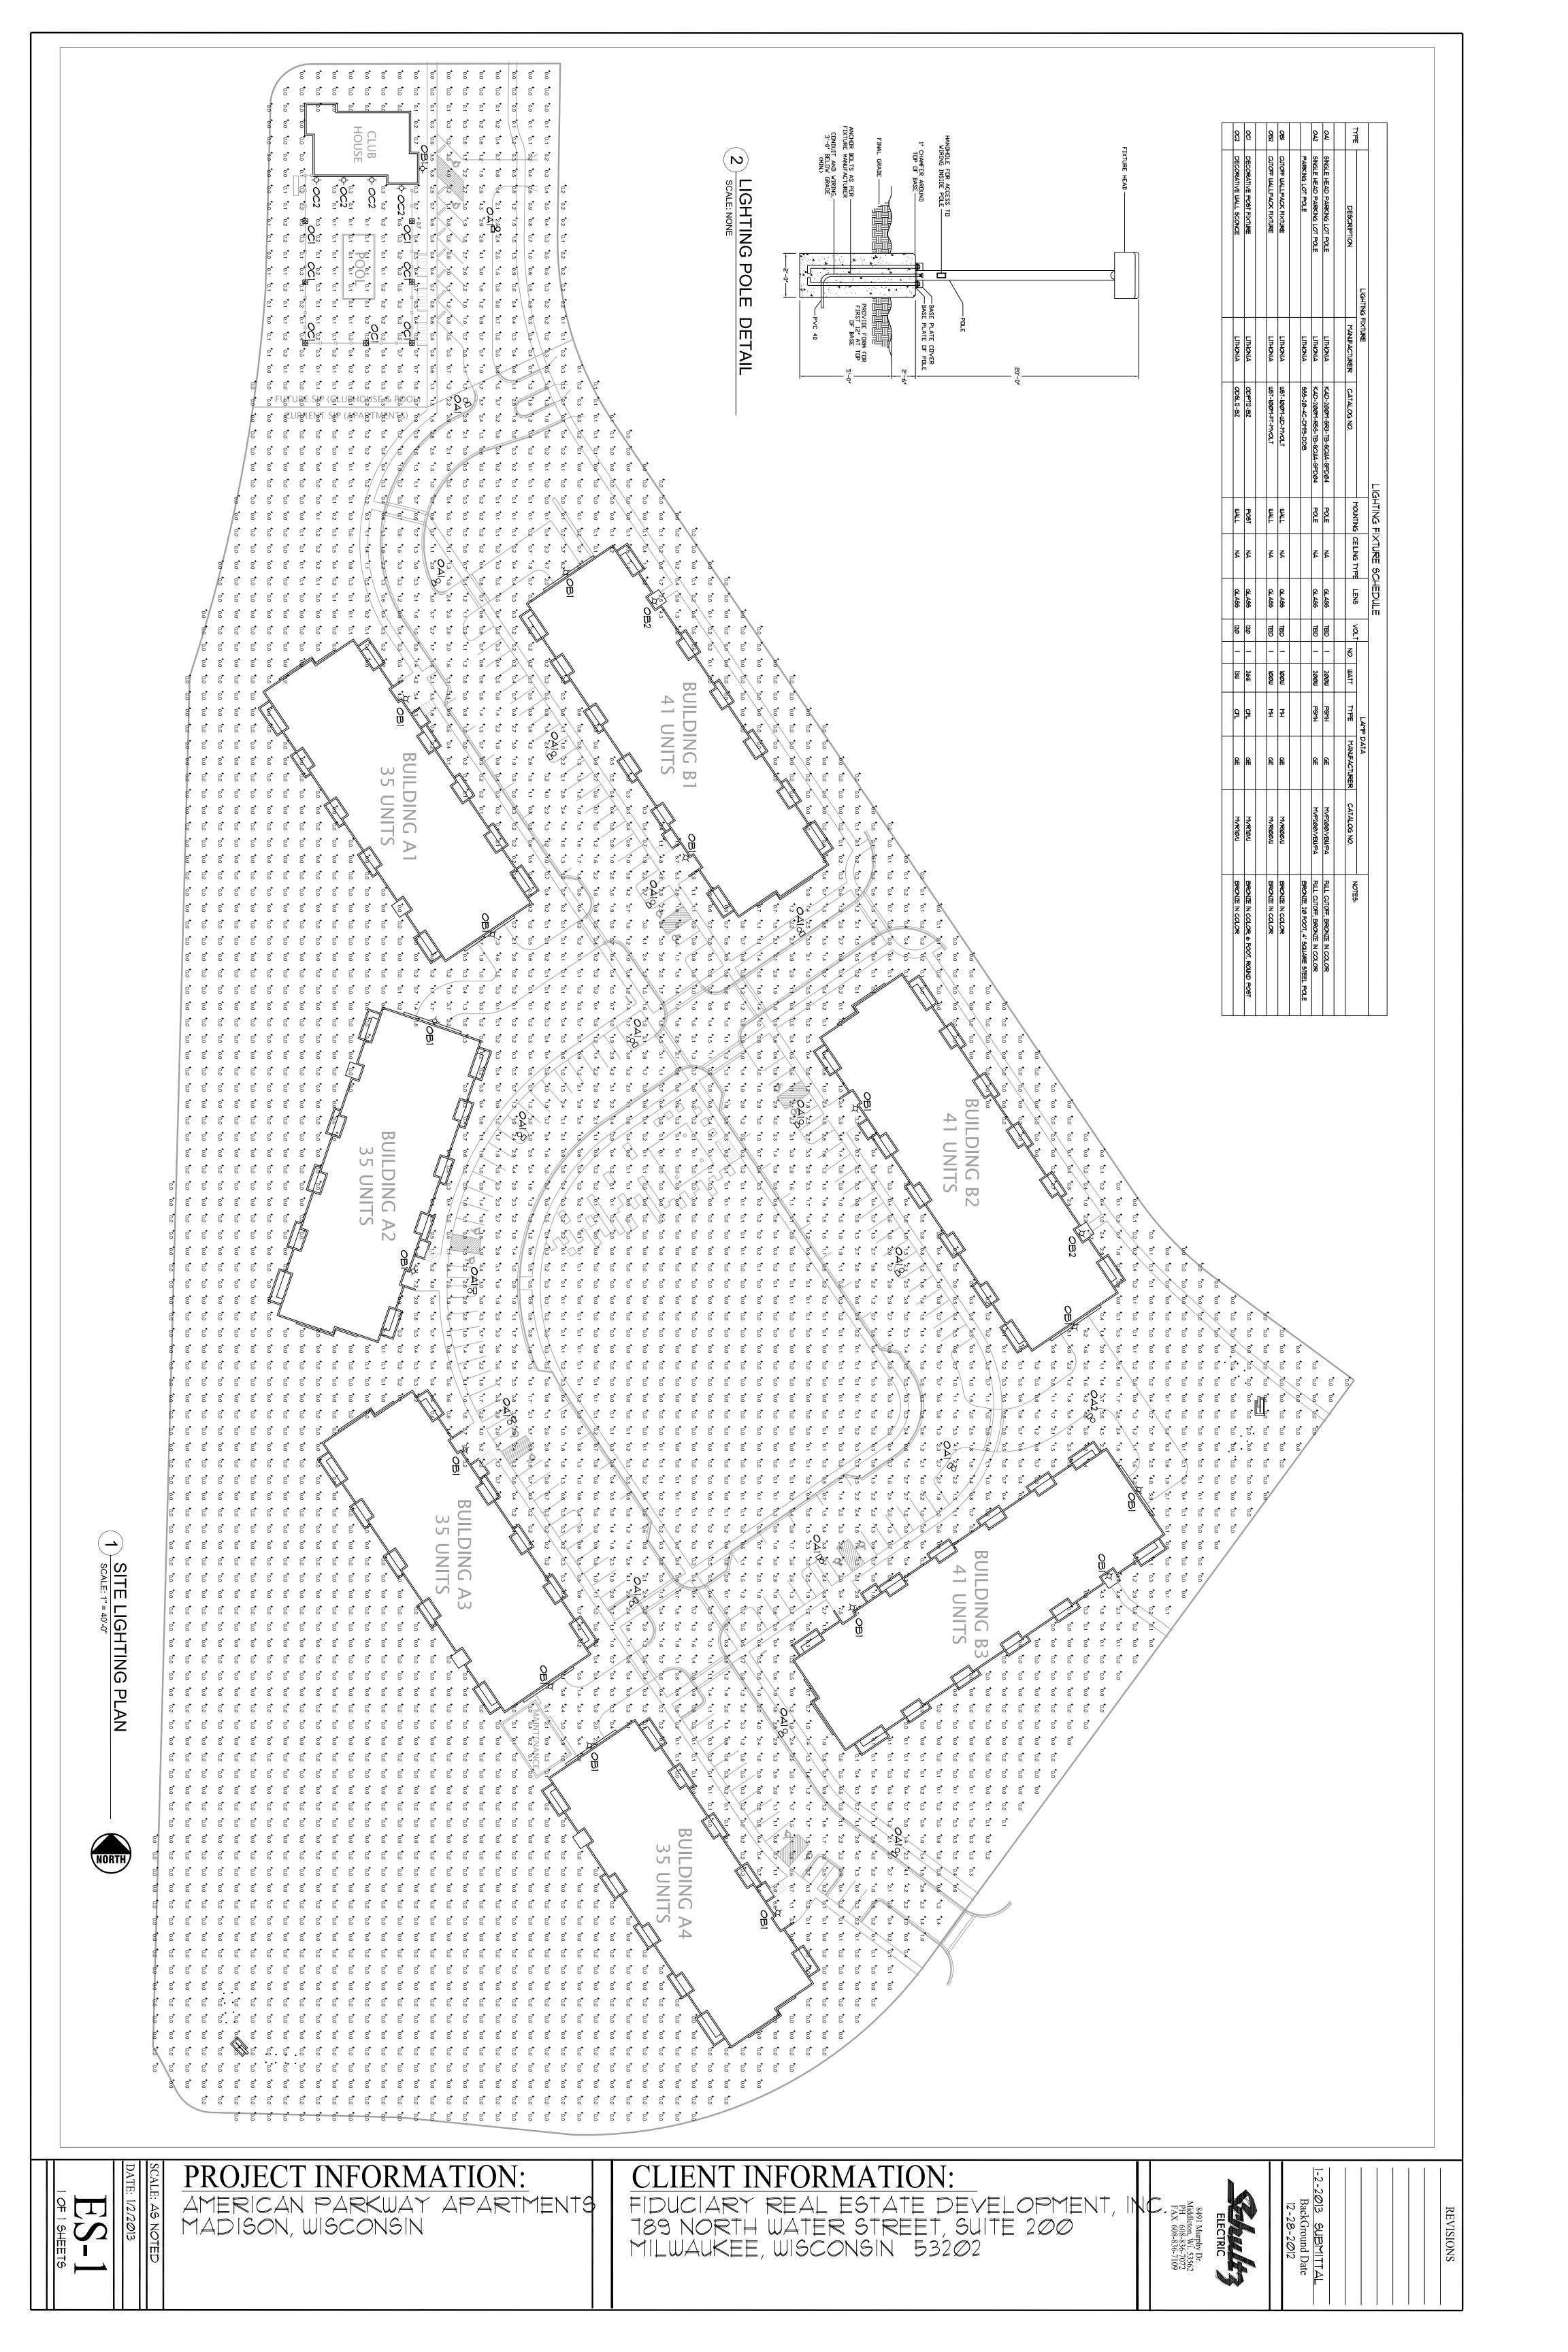

# THE AMERICAN PARKWAY APARTMENTS MADISON, WISCONSIN





City of Madison UDC Submittal – Final Approval

# **CONTENTS:**

- PREVIOUS GENERAL DEVELOPMENT PLANS
- SPECIFIC IMPLEMENTATION BOUNDARIES
- PROJECT LOCATION & GENERAL DESCRIPTION
- PROPOSED SIP ZONING TEXT
- SIP DEVELOPMENT DATA
- PROJECT IMPLEMENTATION
- APPENDIX 'A' Specific Implementation Plans
  - -SIP Civil Plans
  - -SIP Landscape Plans
  - -SIP Architectural Plans

# **PROJECT TEAM:**



FIDUCIARY REAL ESTATE DEVELOPMENT, INC

789 North Water Street - Suite 200 Milwaukee, Wisconsin 53202

Contact: Brett Miller

414.226.4535



JLA ARCHITECTS + PLANNERS

5325 Wall Street - Suite 2700 Madison, Wisconsin 53718

Contact: Joseph Lee

608.241.9500



JSD PROFESSIONAL SERVICES, INC.

161 Horizon Drive – Suite 101 Verona, Wisconsin 53593

Contact: Wade Wyse

608.848.5060

# PREVIOUS GENERAL DEVELOPMENT PLANS

THIS DOCUMENT SHALL SERVE AS AN AMENDED PLANNED UNIT DEVELOPMENT - GENERAL DEVELOPMENT PLAN (PUD/GDP) AND PLANNED UNIT DEVELOPMENT - SPECIFIC IMPLEMENTATION PLAN (PUD/SIP) TO THE PREVIOUSLY APPROVED GENERAL DEVELOPMENT PLAN:


 THE AMMENDED PUD/GDP FOR: 5302 TANCHO DRIVE AND 5101 AMERICAN PARKWAY - (LOT 1 CSM 11206) APPROVED BY COMMON COUNCIL ON NOVEMBER 4, 2003 AND FINAL SIGN OFF ON FEBRUARY 23, 2006.

# EXTENT OF THE GENERAL DEVELOPMENT PLAN AND SPECIFIC IMPLEMENTATION PLAN BOUNDARIES

This document shall serve as the following:

- **The General Development Plan** for the areas shown in red to the right.
- The Specific Implementation Plan for the area shown in red to the right.

# **PROJECT LOCATION & GENERAL DESCRIPTION**

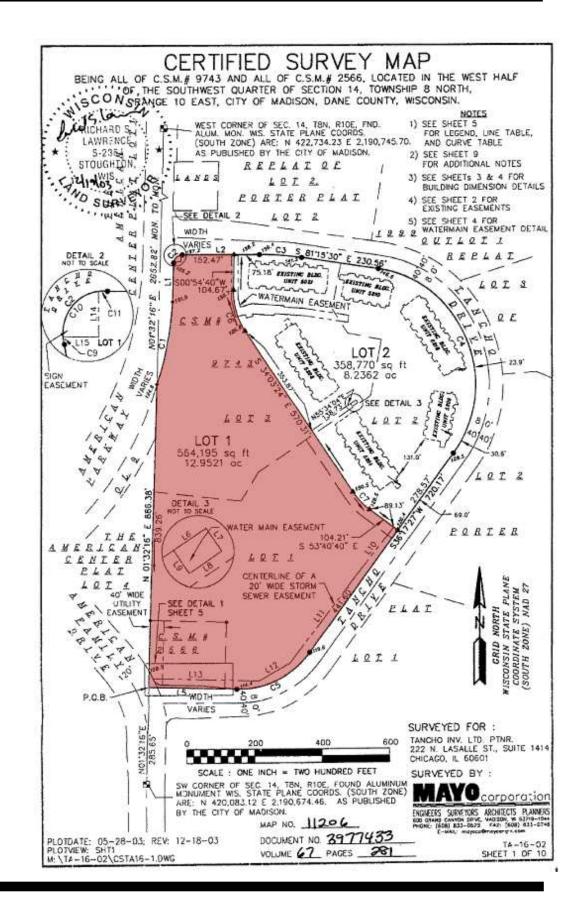

# **LOCATION**

Located in the American Family campus on Madison's east side, the proposed project is the development of Lot 1 of CSM 11206 bounded by American Parkway, Tancho Drive and Chauser Drive.

# **EXISTING CONDITIONS**


The subject property, Lot 1 of CSM 11206, is currently undeveloped. It is located adjacent to The Barrington Apartments which were developed on Lot 2 of CSM 11206 under the previous GDP that gained approval in 2003 and encompassed both Lot 1 and Lot 2 of CSM 11206.

# **PROJECT DESCRIPTION**

The development is to be comprised of 263 market-rate apartments located in seven buildings utilizing two building types: three buildings are to be 41 units and four buildings are to be 35 units each. A mix of unit types are being provided that range from studio to three bedroom units.

The development also includes such features as

- a separate clubhouse and pool
- a large central green to provide recreational space to the immediate residents and the broader community.
- sidewalks throughout to connect all buildings and amenities in a pedestrian friendly environment
- underground parking for cars and bicycles.

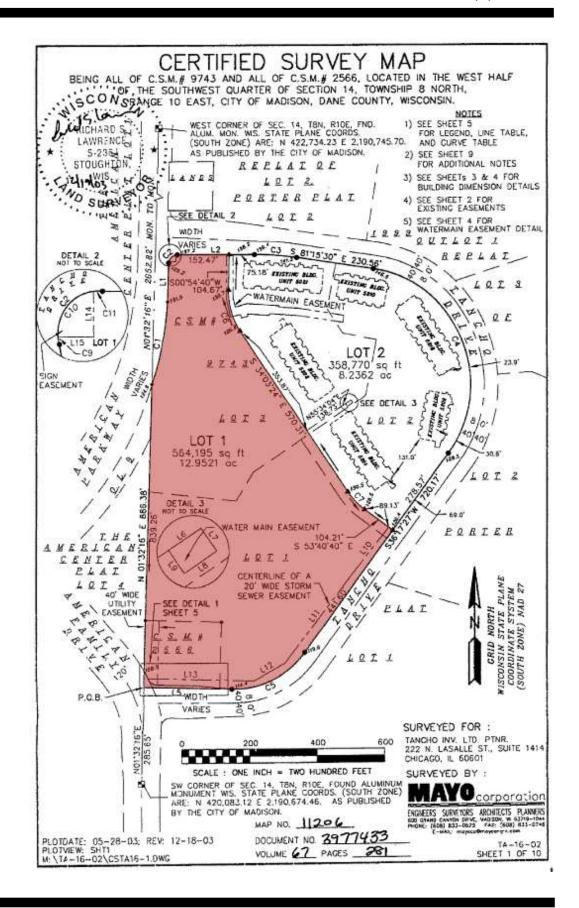

# PROPOSED SIP ZONING TEXT

**Project:** AMERICAN PARKWAY APARTMENTS

Lot 1 of CSM 11206 Madison, Wisconsin 53715

# **Legal Description:**

The lands subject to this Planned Unit Development (PUD) shall include those described in Exhibit 'A', attached hereto.

# Lot Area:

LOT 1, C.S.M. No. 11206, LOCATED IN THE WEST HALF OF THE SOUTHWEST QUARTER OR SECTION 14, TOWNSHIP 8 NORTH, RANGE 10 EAST, CITY OF MADISON, DANE COUNTY, WISCONSIN

# A. Statement of Purpose:

This zoning district is established to allow for the construction of 3 story multi-dwelling unit residential buildings and a 2 story club house and related amenities.

# **B. Permitted Uses:**

The following uses are Permitted in this Planned Unit Development (PUD):

- 1. Medium Density multi-family residential development and accessory uses, including but not limited to swimming pool(s), patios, club house(s), recreation facilities, maintenance facilities, activity rooms and sales/marketing center.
- 2. The development shall consist of up to 273 dwelling units in up to nine buildings.

# C. Conditional Uses:

The following uses may be allowed in this Planned Unit Development (PUD) subject to the provisions of Madison General Ordinance - Section 28.12(11):

- 1. Those Uses that are stated as Conditional Uses in the R5 Zoning Districts per Madison General Ordinance Chapter 28 (Zoning).
- 2. Multiple Dwelling-Unit Buildings and those associated Accessory Uses shall be Permitted Uses per Section B(3) above.

# D. Floor Area Ratio:

The maximum Floor Area Ratio permitted with this Planned Unit Development (PUD) is 0.75

# E. Building Height:

In this Planned Unit Development (PUD), no building or structure shall exceed stories (3) nor forty-six (46) feet in height. Building Height shall be measured per Madison General Ordinance - Section 28.03(2).

# F. Yard Requirements:

The buildings shall be a minimum of thirty (30) feet apart (excluding accessory structures). The buildings shall be at no point closer than (10) feet to the private drive. The buildings shall be setback from the public street a minimum of fifteen (15) feet and a minimum of twenty (20) feet shall be provided from the back of sidewalks to garage doors.

# G. Usable Open Space:

Usable Open Space totaling no less than 1,100 s.f. per dwelling unit shall be provided. Balconies which are accessible only from dwelling units may be counted as Usable Open Space and may be counted for up to 100% of the required Usable Open Space. The minimum balcony size to be used in the Open Space calculations shall be 4'-0" x 8-0".

# H. Accessory Off-Street Parking & Loading:

In this Planned Unit Development (PUD), the following minimum Off-Street Parking & Loading facilities shall be provided:

- 1. Passenger Vehicles No Minimum Requirement
- 2. Bicycles <u>or</u> Motorized Scooters Shall have a combined minimum total of one (1) parking space per dwelling unit.
  - i) Bicycle spaces shall be 24"x72" (minimum)
  - ii) Motorized Scooter spaces shall be 30"x72" (minimum)
- 3. Off-Street Loading No Minimum Requirement

# <u>I. Signage:</u>

In this Planned Unit Development (PUD), signage shall be allowed as per Chapter 31 of the Madison General Ordinances - as compared to the R5 District, or signage shall be provided as shown on the recorded plans.

# J. Liahtina:

In this Planned Unit Development (PUD), lighting shall be provided as shown on the recorded plans.

# K. Landscaping:

In this Planned Unit Development (PUD), landscaping shall be provided as shown on the recorded plans.

# L. Alterations & Revisions:

No alteration or revision to this Planned Unit Development (PUD) shall be permitted unless approved by the City of Madison Plan Commission. However, the Zoning Administrator may issues permits for minor alterations and/or additions which are approved by both the Director of Planning & Development and the Alderperson of the District. These minor alterations and/or additions shall be compatible with the concept approved by the City of Madison Common Council.

# **DEVELOPMENT DATA**

# Specific Implementation Site Plan Data

At the time of this Specific Implementation Plan, of Lot 1 of CSM 11206 is as follows. The exact data (right) is subject to change slightly as the project's design is further developed. However, the final data shall meet all Specific Implementation Plan Zoning Standards (above).

Note: Open space is provided at 1,156 sf per unit excluding balconies.

| Bui | lding | <u>Plan</u> | <u>Data</u> |
|-----|-------|-------------|-------------|
|     |       |             |             |

At the time of this Specific Implementation Plan, of Lot 1 of CSM 11206 is as follows. The exact building data (below) is subject to change as the project's design is further developed. However, total unit count & density for the entire development shall be regulated by the approved Amended PUD/GDP & PUD/SIP.

| ZONING REQUIREMENT | SIP DESIGN VALUE | CALCULATIONS                    |       |
|--------------------|------------------|---------------------------------|-------|
| SITE DENSITY       | 20.31 Units/Acre | 263 Units / 12.952 AC. = 2      | 20.31 |
| BUILDING COVERAGE  | 18.5% of Parcel  | 104,550 S.F. / 564,189 S.F. = 1 | 18.5% |
| FLOOR AREA RATIO   | 55.0% of Parcel  | 310,400 S.F. / 564,189 S.F. = 5 | 55.0% |
| IMPERVIOUS SURFACE | 27.5% of Parcel  | 155,422 S.F. / 564,189 S.F. = 2 | 27.5% |
| OPEN SPACE         | 53.9% of Parcel  | 304,217 S.F. / 564,189 S.F. = 5 | 3.9%  |

| SPECIFIC | PECIFIC IMPLEMENTATION PLAN DATA (Project Completion) |              |              |        |         |         |       |               |  |  |  |  |  |  |
|----------|---|--------------|--------------|--------|---------|---------|-------|---------------|--|--|--|--|--|--|
|          | BUILDING  |              | P            | ARKING |         |         |       |               |  |  |  |  |  |  |
| NAME     | USE   | FOOTPRINT    | FLOOR AREA   | UNITS  | COVERED | SURFACE | TOTAL | RATIO         |  |  |  |  |  |  |
| A1       | Multi-Family Residential                              | 13,400 S.F.  | 40,200 S.F.  | 35     | 35      | 17      | 52    | 1.49 PER UNIT |  |  |  |  |  |  |
| A2       | Multi-Family Residential                              | 13,400 S.F.  | 40,200 S.F.  | 35     | 35      | 17      | 52    | 1.49 PER UNIT |  |  |  |  |  |  |
| A3       | Multi-Family Residential                              | 13,400 S.F.  | 40,200 S.F.  | 35     | 35      | 17      | 52    | 1.49 PER UNIT |  |  |  |  |  |  |
| A4       | Multi-Family Residential                              | 13,400 S.F.  | 40,200 S.F.  | 35     | 35      | 17      | 52    | 1.49 PER UNIT |  |  |  |  |  |  |
| B2       | Multi-Family Residential                              | 15,900 S.F.  | 47,700 S.F.  | 41     | 43      | 19      | 62    | 1.51 PER UNIT |  |  |  |  |  |  |
| В3       | Multi-Family Residential                              | 15,900 S.F.  | 47,700 S.F.  | 41     | 43      | 19      | 62    | 1.51 PER UNIT |  |  |  |  |  |  |
| B4       | Multi-Family Residential                              | 15,900 S.F.  | 47,700 S.F.  | 41     | 43      | 20      | 63    | 1.54 PER UNIT |  |  |  |  |  |  |
| C1       | Clubhouse - M.F. Accessory Uses                       | 3,250 S.F.   | 6,500 S.F.   | 0      | 0       | 8       | 8     | N/A           |  |  |  |  |  |  |
| TOTALS   |   | 104,550 S.F. | 310,400 S.F. | 263    | 269     | 134     | 403   | 1.53 PER UNIT |  |  |  |  |  |  |

| <b>BUILDING DATA</b> | RESIDE   | NTIAL    | BUILDIN | NG TYPE  | E 'A' |          |      Ĭ             |
|----------------------|----------|----------|---------|----------|-------|----------|------|-----------|---------|----------|------------------|----------|---------|---------|---------|---------|---------|----------|--------|----------|---------|----------|----------------|-------------------|---------|----------|---------|---------|--------|----------|---------|---------|-------|--------|--------|---------|---------------|
|                      | Unit A   | - Studio | Unit B  | 1 - 1 BR | Unit  | 32 - 1BR | Unit | B3 - 1 BR | Unit B4 | 4 - 1 BR | Unit B           | 5 - 1 BR | Unit C1 | - 1BR+D | Unit C2 | - 1BR+D | Unit D1 | L - 2 BR | Unit D | 2 - 2 BR | Unit D3 | 3 - 2 BR | Unit D4        | 4 - 2BR           | Unit E1 | - 2 BR+D | Unit E2 | - 2BR+D | Unit F | L - 3 BR | Unit F2 | - 2BR+D | Total | Units  | Common | Duildie | ng Totals     |
|                      | 573      | S.F.     | 759     | S.F.     | 80    | 5 S.F.   |      | 0 S.F.    | 751     | S.F.     | 0                | S.F.     | 851     | S.F.    | 0       | S.F.    | 1156    | S.F.     | 1217   | 7 S.F.   | 1195    | S.F.     | 0              | S.F.              | 0       | S.F.     | 0       | S.F.    | 1390   | S.F.     | 0       | S.F.    | 999   | A.S.F. | Space  | Bulluli | ig rotals     |
|                      | Qty.     | Area     | Qty.    | Area     | Qty.  | Area     | Qty. | Area      | Qty.    | Area     | Qty.             | Area     | Qty.    | Area    | Qty.    | Area    | Qty.    | Area     | Qty.   | Area     | Qty.    | Area     | Qty.           | Area              | Qty.    | Area     | Qty.    | Area    | Qty.   | Area     | Qty.    | Area    | Qty.  | Area   | Space  | Area    | Efficiency    |
| Floor 3              | 1        | 573      | 2       | 1,518    | 2     | 1,610    | -    |           | -       | -        | -                | 2        | 1       | 851     | -       | -       | 2       | 2,312    | 2      | 2,434    | 1       | 1,195    | -              | -                 | 2       | 2        | -       |         | 1      | 1,390    | 2       | 2       | 12    | 11,883 | 1,472  | 13,355  | 89.0%         |
| Floor 2              | 1        | 573      | 2       | 1,518    | 2     | 1,610    | -    | -         | -       | -        |                  | -        | 1       | 851     | -       |         | 2       | 2,312    | 2      | 2,434    | 1       | 1,195    | -              | -                 | -       | -        |         | -       | 1      | 1,390    | -       | -       | 12    | 11,883 | 1,472  | 13,355  | 89.0%         |
| Floor 1              |          | -        | 2       | 1,518    | 2     | 1,610    | -    |           | 1       | 751      | -                | 2        | -       | -       | -       | 127     | 2       | 2,312    | 2      | 2,434    | 1       | 1,195    | -              | 120               | -       | =        |         | -       | 1      | 1,390    | -       | -       | 11    | 11,210 | 2,145  | 13,355  | 83.9%         |
| Totals               | 2        | 1,146    | 6       | 4,554    | 6     | 4,830    | -    | 7.0       | 1       | 751      | 1. <del>1.</del> | -        | 2       | 1,702   | (=)     | 1,7.1   | 6       | 6,936    | 6      | 7,302    | 3       | 3,585    | 3 <del>7</del> | 1. <del>1</del> . | -       | -        | -       | 1724    | 3      | 4,170    | -       | -       | 35    | 34,976 | 5,089  |         | 87.3%         |
|                      | 5.7%     |          | 17.1%   | 5        | 17.19 | 6        | 0.09 | %         | 2.9%    |          | 0.0%             | 1        | 5.7%    |         | 0.0%    |         | 17.1%   |          | 17.1%  | 6        | 8.6%    |          | 0.0%           |                   | 0.0%    |          | 0.0%    |         | 8.6%   |          | 0.0%    |         | 100%  |        |        | 1,145   | s.f. per unit |
| Unit Breakdown       | Studios: | 5.7%     |         |          |       |          |      |           |         | 1 B      | edrooms:         | 37.1%    |         |         | 1BR+D:  | 5.7%    |         |          |        |          |         | 2 Be     | edrooms:       | 42.9%             |         | 2 Bedro  | om+Den: | 0.0%    |        | 3 B      | edroom: | 8.6%    | 100%  |        |        |         |               |

| <b>BUILDING DATA -</b> | RESIDE   | NTIAL    | BUILDIN | NG TYPE  | E 'B'  |          |        |------------------------|----------|----------|---------|----------|--------|----------|--------|----------|--------|----------|----------|----------|---------|---------|---------|---------|--------|----------|--------|----------|--------|----------|----------|---------|---------|---------|---------|---------|--------|----------|---------|---------|------|---------|-----------------|---------|---------------|
|                        | Unit A   | - Studio | Unit B  | 1 - 1 BR | Unit E | 32 - 1BR | Unit B | 3 - 1 BR | Unit B | 4 - 1 BR | Unit B   | 5 - 1 BR | Unit C1 | - 1BR+D | Unit C2 | - 1BR+D | Unit D | 1 - 2 BR | Unit D | 2 - 2 BR | Unit D | 3 - 2 BR | Unit D   | 4 - 2BR | Unit E1 | 2 BR+D  | Unit E2 | - 2BR+D | Unit F | 1 - 3 BR | Unit F2 | - 2BR+D | Tota | I Units | Common          | Duildie | ng Totals     |
|                        | 573      | S.F.     | 759     | S.F.     | 805    | S.F.     | C      | S.F.     | 751    | S.F.     | 0        | S.F.     | 851     | S.F.    | 0       | S.F.    | 1150   | 6 S.F.   | 1217   | 7 S.F.   | 1199   | S.F.     | 0        | S.F.    | 0       | S.F.    | 0       | S.F.    | 1390   | S.F.     | (       | S.F.    | 1022 | A.S.F.  | Common<br>Space | bulluii | ig rotals     |
|                        | Qty.     | Area     | Qty.    | Area     | Qty.   | Area     | Qty.   | Area     | Qty.   | Area     | Qty.     | Area     | Qty.    | Area    | Qty.    | Area    | Qty.   | Area     | Qty.   | Area     | Qty.   | Area     | Qty.     | Area    | Qty.    | Area    | Qty.    | Area    | Qty.   | Area     | Qty.    | Area    | Qty. | Area    | Space           | Area    | Efficiency    |
| Floor 3                | 1        | 573      | 2       | 1,518    | 2      | 1,610    | -      | -        |        | 120      | -        | -        | 1       | 851     | 141     | -       | 4      | 4,624    | 2      | 2,434    | 1      | 1,195    | -        | -       | 2       | 2       | -       | -       | 1      | 1,390    | -       | ~       | 14   | 14,195  | 1,680           | 15,875  | 89.4%         |
| Floor 2                | 1        | 573      | 2       | 1,518    | 2      | 1,610    | -      |          | -      | 170      | 17       | -        | 1       | 851     | -       |         | 4      | 4,624    | 2      | 2,434    | 1      | 1,195    | 17       | 16      | -       |         | -       | -       | 1      | 1,390    | -       | -       | 14   | 14,195  | 1,680           | 15,875  | 89.4%         |
| Floor 1                | -        | (+)      | 2       | 1,518    | 2      | 1,610    | -      |          | 1      | 751      | 7.0      | - 4      | -       | -       | -       |         | 4      | 4,624    | 2      | 2,434    | 1      | 1,195    | -        | -       | -       | -       | -       | -       | 1      | 1,390    | -       | -       | 13   | 13,522  | 2,353           | 15,875  | 85.2%         |
| Totals                 | 2        | 1,146    | 6       | 4,554    | 6      | 4,830    | -      | -        | 1      | 751      | -        | -        | 2       | 1,702   |         | -       | 12     | 13,872   | 6      | 7,302    | 3      | 3,585    | -        | 1.5     | -       | -       | -       | -       | 3      | 4,170    | -       | -       | 41   | 41,912  | 5,713           | 47,625  | 88.0%         |
|                        | 4.9%     |          | 14.6%   |          | 14.6%  | 5        | 0.0%   | 6        | 2.4%   |          | 0.0%     | ó        | 4.9%    |         | 0.0%    |         | 29.3%  | 6        | 14.6%  | 6        | 7.3%   | ó        | 0.0%     |         | 0.0%    |         | 0.0%    |         | 7.3%   |          | 0.0%    | 6       | 100% |         |                 | 1,162   | s.f. per unit |
| Unit Breakdown         | Studios: | 4.9%     |         |          |        |          |        |          |        | 1 B      | edrooms: | : 31.7%  |         |         | 1BR+D:  | 4.9%    |        |          |        |          |        | 2 B      | edrooms: | 51.2%   | 5       | 2 Bedro | om+Den: | 0.0%    |        | 3 E      | Bedroom | : 7.3%  | 100% |         |                 |         |               |

NOTE: Final Unit Counts, Types, Mix, and Sizes are subject to change. The Total Unit Count & Density for Entire Development shall be regulated by the Approved PUD/GDP Package and subsequently Approved PUD/SIP Packages.

# PROJECT IMPLEMENTATION

As of the date of this submission, it is anticipated that the project will be developed according to the following schedule

# Phase 1

Shall include storm water management; construction of buildings 'A1', 'B1', 'B2 and the club house.

Construction Start: 5/1/13 Occupancy: 2/1/14

# Phase 2


Construction of buildings 'A2', 'B3' and the central green.

Construction Start: 4/1/14 Occupancy: 2/1/15

# Phase 3

Construction of buildings 'A3', 'A4'.

Construction Start: 4/1/15 Occupancy: 2/1/16

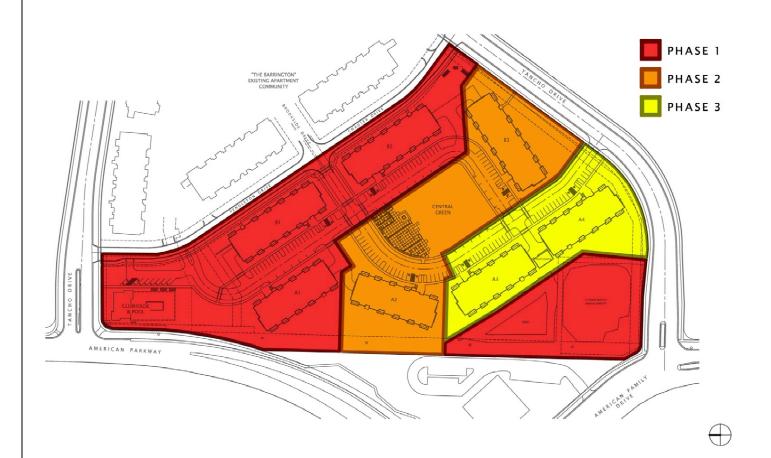

# APPENDIX 'A' SUBMITTAL PLANS

| SPECIFIC | IMPLEMENTATION PLAN             | DATA (Pro    | ject Comple  | etion) |       |     |     |               |
|----------|---------------------------------|--------------|--------------|--------|-------|-----|-----|---------------|
|          | BUILDING                        |              | P            | ARKING |       |     |     |               |
| NAME     | USE                             | COVERED      | SURFACE      | TOTAL  | RATIO |     |     |               |
| A1       | Multi-Family Residential        | 13,400 S.F.  | 40,200 S.F.  | 35     | 35    | 17  | 52  | 1.49 PER UNIT |
| A2       | Multi-Family Residential        | 13,400 S.F.  | 40,200 S.F.  | 35     | 35    | 17  | 52  | 1.49 PER UNIT |
| А3       | Multi-Family Residential        | 13,400 S.F.  | 40,200 S.F.  | 35     | 35    | 17  | 52  | 1.49 PER UNIT |
| A4       | Multi-Family Residential        | 13,400 S.F.  | 40,200 S.F.  | 35     | 35    | 17  | 52  | 1.49 PER UNIT |
| B2       | Multi-Family Residential        | 15,900 S.F.  | 47,700 S.F.  | 41     | 43    | 19  | 62  | 1.51 PER UNIT |
| В3       | Multi-Family Residential        | 15,900 S.F.  | 47,700 S.F.  | 41     | 43    | 19  | 62  | 1.51 PER UNIT |
| B4       | Multi-Family Residential        | 15,900 S.F.  | 47,700 S.F.  | 41     | 43    | 20  | 63  | 1.54 PER UNIT |
| C1       | Clubhouse - M.F. Accessory Uses | 3,250 S.F.   | 6,500 S.F.   | 0      | 0     | 8   | 8   | N/A           |
| TOTALS   |                                 | 104,550 S.F. | 310,400 S.F. | 263    | 269   | 134 | 403 | 1.53 PER UNIT |

| ZONI              | NG REQUIREMENT | SIP DESIGN VALUE |         | CAL     | CULATION | S      |       |
|-------------------|----------------|------------------|---------|---------|----------|--------|-------|
| SITE DENSITY      |                | 20.31 Units/Acre | 263     | Units / | 12.952   | AC. =  | 20.31 |
| BUILDING COV      | VERAGE         | 18.5% of Parcel  | 104,550 | S.F. /  | 564,189  | S.F. = | 18.5% |
| FLOOR AREA F      | RATIO          | 55.0% of Parcel  | 310,400 | S.F. /  | 564,189  | S.F. = | 55.0% |
| IMPERVIOUS S      | SURFACE        | 27.5% of Parcel  | 155,422 | S.F. /  | 564,189  | S.F. = | 27.5% |
| <b>OPEN SPACE</b> |                | 53.9% of Parcel  | 304,217 | S.F. /  | 564,189  | S.F. = | 53.9% |

| <b>BUILDING DAT</b> | A - RESIDENTIAL | <b>BUILDING TY</b> | PE 'A'        |           |      |---------------------|-----------------|--------------------|---------------|-----------|------|----------------|----------|----------|----------------|--------|------------------|----------------|--------|-----------|----------------|-----------|------------------|------------|----------|---------|---------------|---------|----------|----------------|---------|------|--------|--------|---------|---------------|
|                     | Unit A - Studio | Unit B1 - 1 BF     | Unit B2 - 1BR | Unit B3 - | 1 BR | Unit B4 - 1 BR | Unit B   | 5 - 1 BR | Unit C1 - 1BR- | D Unit | 2 - 1BR+D        | Unit D1 - 2 BR | Unit [ | 02 - 2 BR | Unit D3 - 2 B  | R Unit    | D4 - 2BR         | Unit E1    | - 2 BR+D | Unit E2 | - 2BR+D       | Unit F1 | 1 - 3 BR | Unit F2        | - 2BR+D | Tota | Units  | Common | Duildi  | ng Totals     |
|                     | 573 S.F.        | 759 S.F.           | 805 S.F.      | 0 S.      | F.   | 751 S.F.       | C        | S.F.     | 851 S.F.       |        | 0 S.F.           | 1156 S.F.      | 121    | 7 S.F.    | 1195 S.F.      |           | 0 S.F.           | (          | 0 S.F.   | 0       | S.F.          | 1390    | S.F.     | 0              | S.F.    | 999  | A.S.F. | Space  |         |               |
|                     | Qty. Area       | Qty. Area          | Qty. Area     | Qty.      | Area | Qty. Area      | Qty.     | Area     | Qty. Are       | a Qty. | Area             | Qty. Area      | Qty.   | Area      | Qty. Are       | a Qty.    | Area             | Qty.       | Area     | Qty.    | Area          | Qty.    | Area     | Qty.           | Area    | Qty. | Area   | Space  | Area    | Efficiency    |
| Floor 3             | 1 573           | 2 1,5:             | 2 1,610       | -         | -    |                | 14       | -        | 1 8            | 51 -   | -                | 2 2,312        | 2      | 2,434     | 1 1,1          | 95 -      | -                | -          | -        | 14      | -             | 1       | 1,390    | 14             | -       | 12   | 11,883 | 1,472  | 13,355  | 89.0%         |
| Floor 2             | 1 573           | 2 1,5:             | 18 2 1,610    | -         | -    |                | -        | -        | 1 8            | 51 -   | -                | 2 2,312        | 2      | 2,434     | 1 1,1          | 95 -      | -                | -          | -        | -       | -             | 1       | 1,390    | -              | -       | 12   | 11,883 | 1,472  | 13,355  | 89.09         |
| Floor 1             |                 | 2 1,5:             | 2 1,610       | -         | -    | 1 751          | -        | -        | -              | -      | -                | 2 2,312        | 2      | 2,434     | 1 1,1          | 95 -      | =                | 12         | -        | -       | 144           | 1       | 1,390    | -              | -       | 11   | 11,210 | 2,145  | 13,355  | 83.9%         |
| Totals              | 2 1,140         | 6 4,5              | 6 4,830       | -         | -    | 1 751          | _        | -        | 2 1,7          | 02 -   | -                | 6 6,936        | 6      | 7,302     | 3 3,5          | 85 -      | -                | 7 <u>-</u> | -        | -       | -             | 3       | 4,170    | 32             | -       | 35   | 34,976 | 5,089  | 40,065  | 87.39         |
|                     | 5.7%            | 17.1%              | 17.1%         | 0.0%      |      | 2.9%           | 0.0%     | ó        | 5.7%           | 0.0    | %                | 17.1%          | 17.19  | 6         | 8.6%           | 0.0       | %                | 0.0%       | 6        | 0.0%    |               | 8.6%    |          | 0.0%           |         | 100% |        |        | 1,145   | s.f. per unit |
| Unit Breakdown      | Studios: 5.7    | 6                  |               |           |      | 1 B            | Bedrooms | : 37.1%  |                | 1BR+   | D: 5.7%          | 6              |        |           |                | 2 Bedroom | s: 42.9%         | 6          | 2 Bedro  | om+Den: | 0.0%          |         | 3 E      | Bedroom:       | 8.6%    | 100% |        |        |         |               |
|                     |                 | <b>BUILDING DAT</b> | A - RESIDENTIAL | <b>BUILDING TY</b> | PE 'B'        |           |      |                     | Unit A - Studio | Unit B1 - 1 BF     | Unit B2 - 1BR | Unit B3 - | 1 BR | Unit B4 - 1 BR | Unit B   | 5 - 1 BR | Unit C1 - 1BR- | D Unit | 2 - 1BR+D        | Unit D1 - 2 BR | Unit [ | 02 - 2 BR | Unit D3 - 2 BI | R Unit    | D4 - 2BR         | Unit E1    | - 2 BR+D | Unit E2 | - 2BR+D       | Unit F1 | 1 - 3 BR | Unit F2        | - 2BR+D | Tota | Units  | Common | Duildi  | ng Totals     |
|                     | 573 S.F.        | 759 S.F.           | 805 S.F.      | 0 S.      | F.   | 751 S.F.       | C        | S.F.     | 851 S.F.       |        | 0 S.F.           | 1156 S.F.      | 121    | 7 S.F.    | 1195 S.F.      |           | 0 S.F.           | (          | 0 S.F.   | 0       | S.F.          | 1390    | S.F.     | 0              | S.F.    | 1022 | A.S.F. | Space  | Bulluli | ilg Totals    |
|                     | Qty. Area       | Qty. Area          | Qty. Area     | Qty.      | Area | Qty. Area      | Qty.     | Area     | Qty. Are       | a Qty. | Area             | Qty. Area      | Qty.   | Area      | Qty. Are       | a Qty.    | Area             | Qty.       | Area     | Qty.    | Area          | Qty.    | Area     | Qty.           | Area    | Qty. | Area   | Space  | Area    | Efficiency    |
| Floor 3             | 1 573           | 2 1,5:             | 2 1,610       | -         | -    |                | -        | -        | 1 8            | 51 -   | -                | 4 4,624        | 2      | 2,434     | 1 1,1          | 95 -      | -                | -          | -        | -       | -             | 1       | 1,390    | -              | -       | 14   | 14,195 | 1,680  | 15,875  | 89.4%         |
| Floor 2             | 1 573           | 2 1,5:             | 2 1,610       | -         | -    |                | -        | -        | 1 8            | 51 -   | -                | 4 4,624        | 2      | 2,434     | 1 1,1          | 95 -      | -                |            | -        | -       | -             | 1       | 1,390    | -              | -       | 14   | 14,195 | 1,680  | 15,875  | 89.4%         |
| Floor 1             | 7 7             | 2 1,5:             | 2 1,610       | -         | -    | 1 751          | -        | -        | 170            | -      | : <del>=</del> : | 4 4,624        | 2      | 2,434     | 1 1,1          | 95 -      | ± <del>7</del> . | 12         | -        | -       | -             | 1       | 1,390    | : <del>-</del> | -       | 13   | 13,522 | 2,353  | 15,875  | 85.29         |
| Totals              | 2 1,140         | 6 4,5              | 6 4,830       | -         |      | 1 751          | -        | -        | 2 1,7          | 02 -   | <del>-</del>     | 12 13,872      | 6      | 7,302     | 3 3,5          | 85 -      | -                | 17         | -        | -       | <del></del> . | 3       | 4,170    | -              | -       | 41   | 41,912 | 5,713  | 47,625  | 88.09         |
|                     | 4.9%            | 14.6%              | 14.6%         | 0.0%      |      | 2.4%           | 0.0%     | 6        | 4.9%           | 0.0    | %                | 29.3%          | 14.69  | 6         | 7.3%           | 0.0       | %                | 0.0%       | 6        | 0.0%    |               | 7.3%    |          | 0.0%           |         | 100% |        |        | 1,162   | s.f. per unit |

NOTE: Final Unit Counts, Types, Mix, and Sizes are subject to change. The Total Unit Count & Density for Entire Development shall be regulated by the Approved PUD/GDP Package and subsequently Approved PUD/SIP Packages.

# MASTERPLAN NOTES

# PARKING NOTES:

1) VEHICULAR COVERED PARKING COUNTS ARE MINIMUM. SURFACE PARKING COUNTS ARE MAXIMUM. COVERED BICYCLE PARKING SHALL BE PROVIDED IN THE LOWER LEVEL OF EACH RESIDENTIAL BUILDING BY INDIVIDUAL STORAGE LOCKERS OR WALL/CEILING HOOKS ABOVE AUTOMOBILE SPACES.


# LANDSCAPING NOTE:

1) ALL LANDSCAPING ELEMENTS SHOWN ON THIS MASTERPLAN ARE CONCEPTUAL ONLY. SEE LANDSCAPE PLANS FOR INFORMATION AND DETAILS REGARDING THE ACTUAL LANDSCAPING FOR THIS PROJECT.

# **EXTERIOR SITE LIGHTING:**

1) ALL EXTERIOR LIGHTGING SHALL BE ESTABLISHED, DIRECTED, AND MAINTAINED SO AS NOT TO BE CAST DIRECTLY ON PUBLIC RIGHTS-OF-WAY OR NEIGHBORING PROPERTIES - OR BE LIGHTED IN INTENSITY OR COLORS SERIOUSLY DISTURBING TO NEIGHBORING PROPERTIES.

MONUMENT SIGN

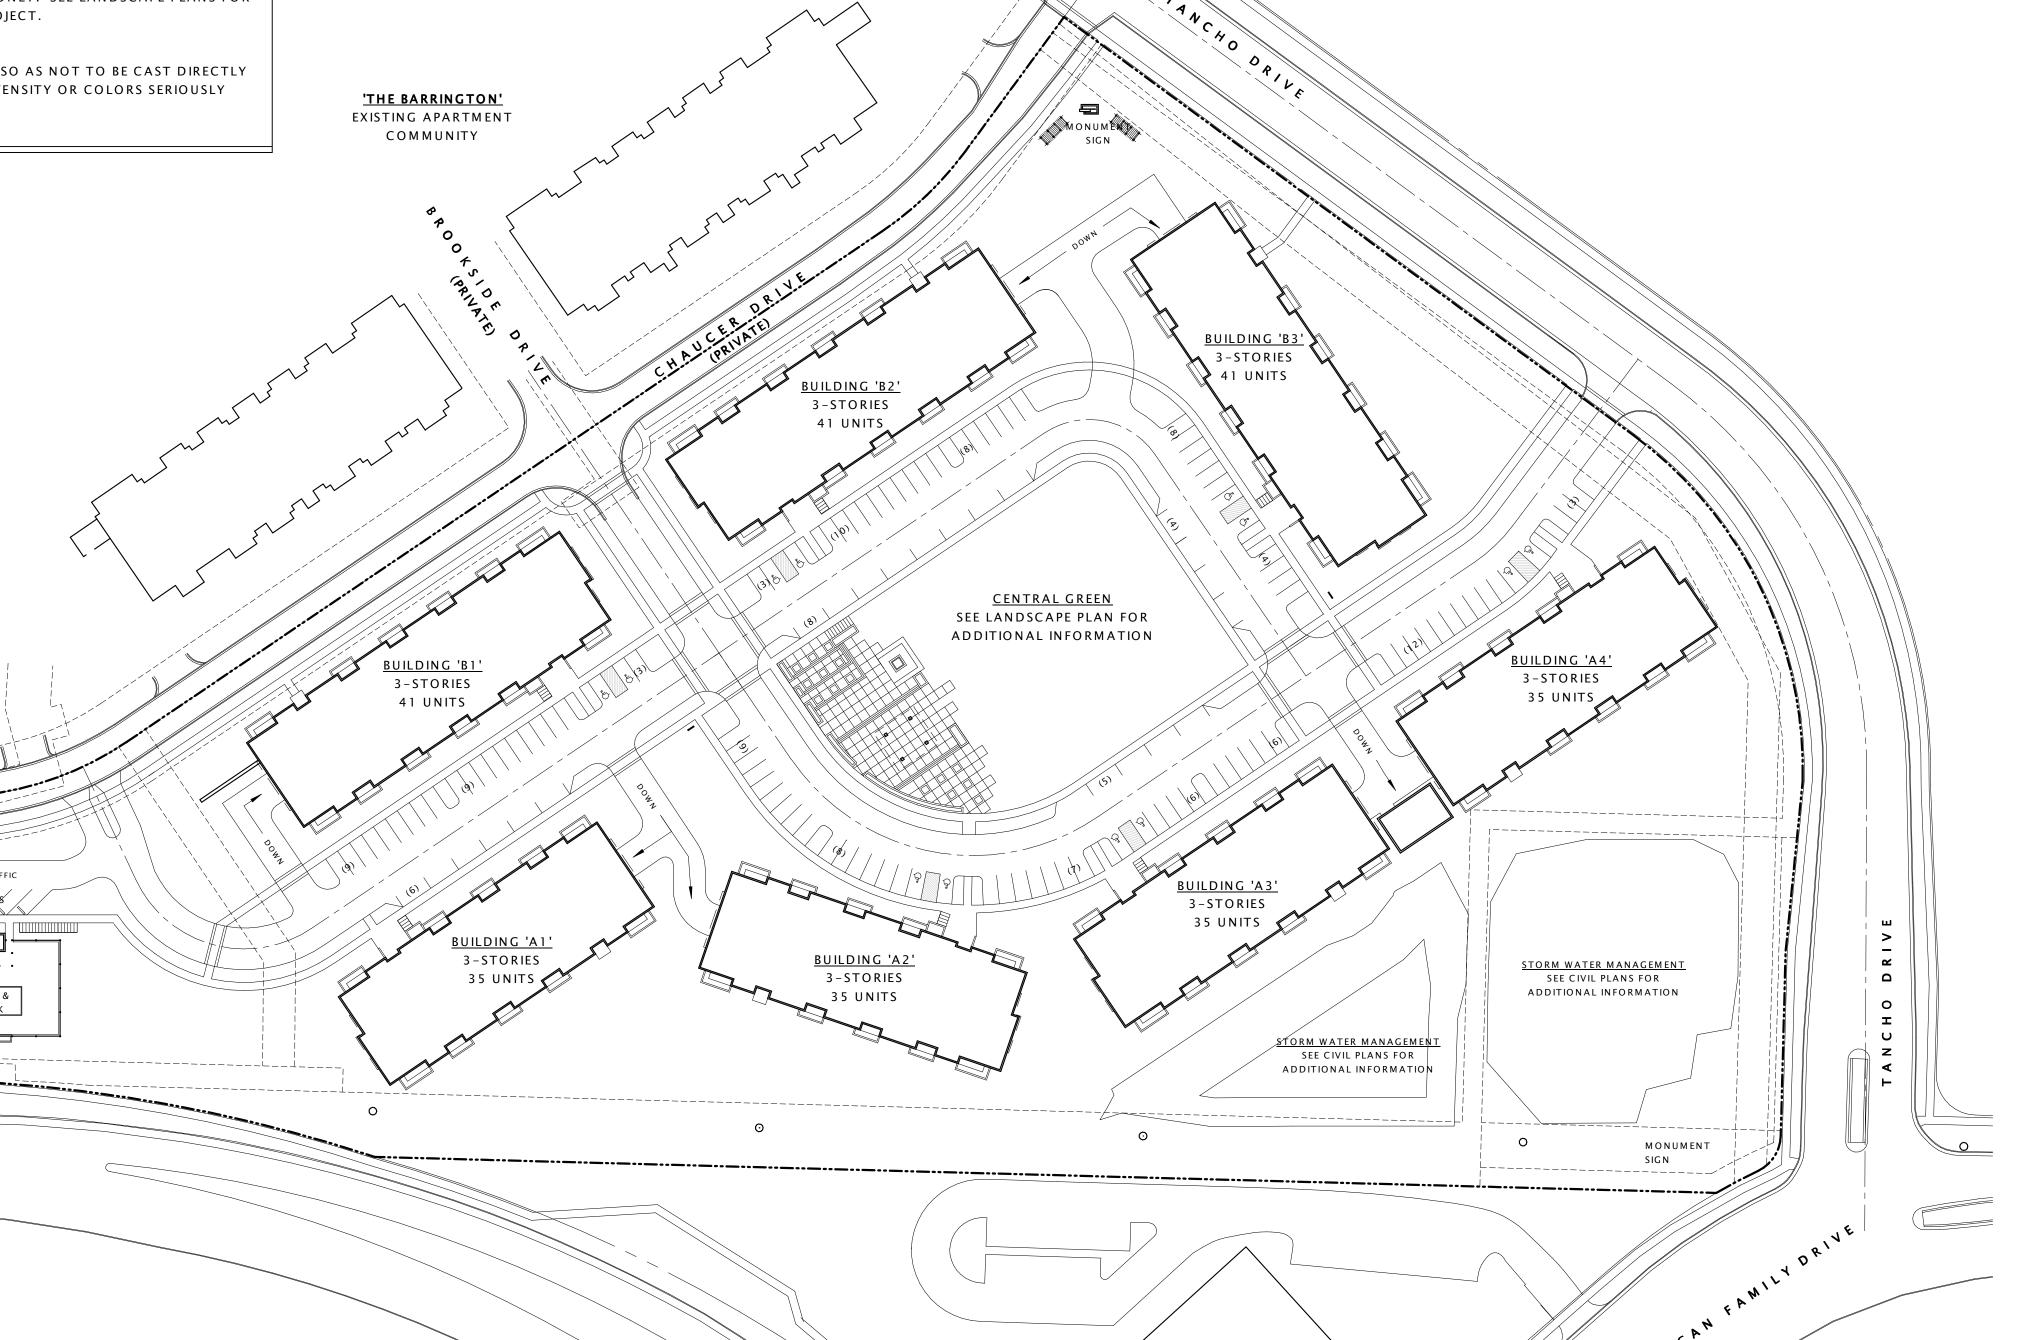

JOSEPH LEE + ASSOCIATES
5325 wall street - suite 2700
madison, wisconsin 53718
608.241.9500

JLA PROJECT NUMBER: 11-0919-01

3 Bedroom: 7.3% **100%** 

2 Bedroom+Den: 0.0%



FIDUCIARY REAL
ESTATE
DEVELOPMENT, INC.

AMERICAN PARKWAY

APARTMENTS

# PROGRESS DOCUMENTS

These documents reflect progress and intent and may be subject to change, including additional detail. These are not final construction documents and should not be used for final bidding or construction-related purposes.

| DATEO        | F ISSUANCE        | January 18, 2013 |  |  |  |  |  |  |  |  |  |
|--------------|-------------------|------------------|--|--|--|--|--|--|--|--|--|
|              | Revision Schedule |                  |  |  |  |  |  |  |  |  |  |
| Mark         | Description       | on Date          |  |  |  |  |  |  |  |  |  |
| nan pasengan |                   |                  |  |  |  |  |  |  |  |  |  |


SHEET TITLE


DEVELOPMENT MASTERPLAN

SHEET NUMBER

ASP-100


AMERICAN PARKWAY

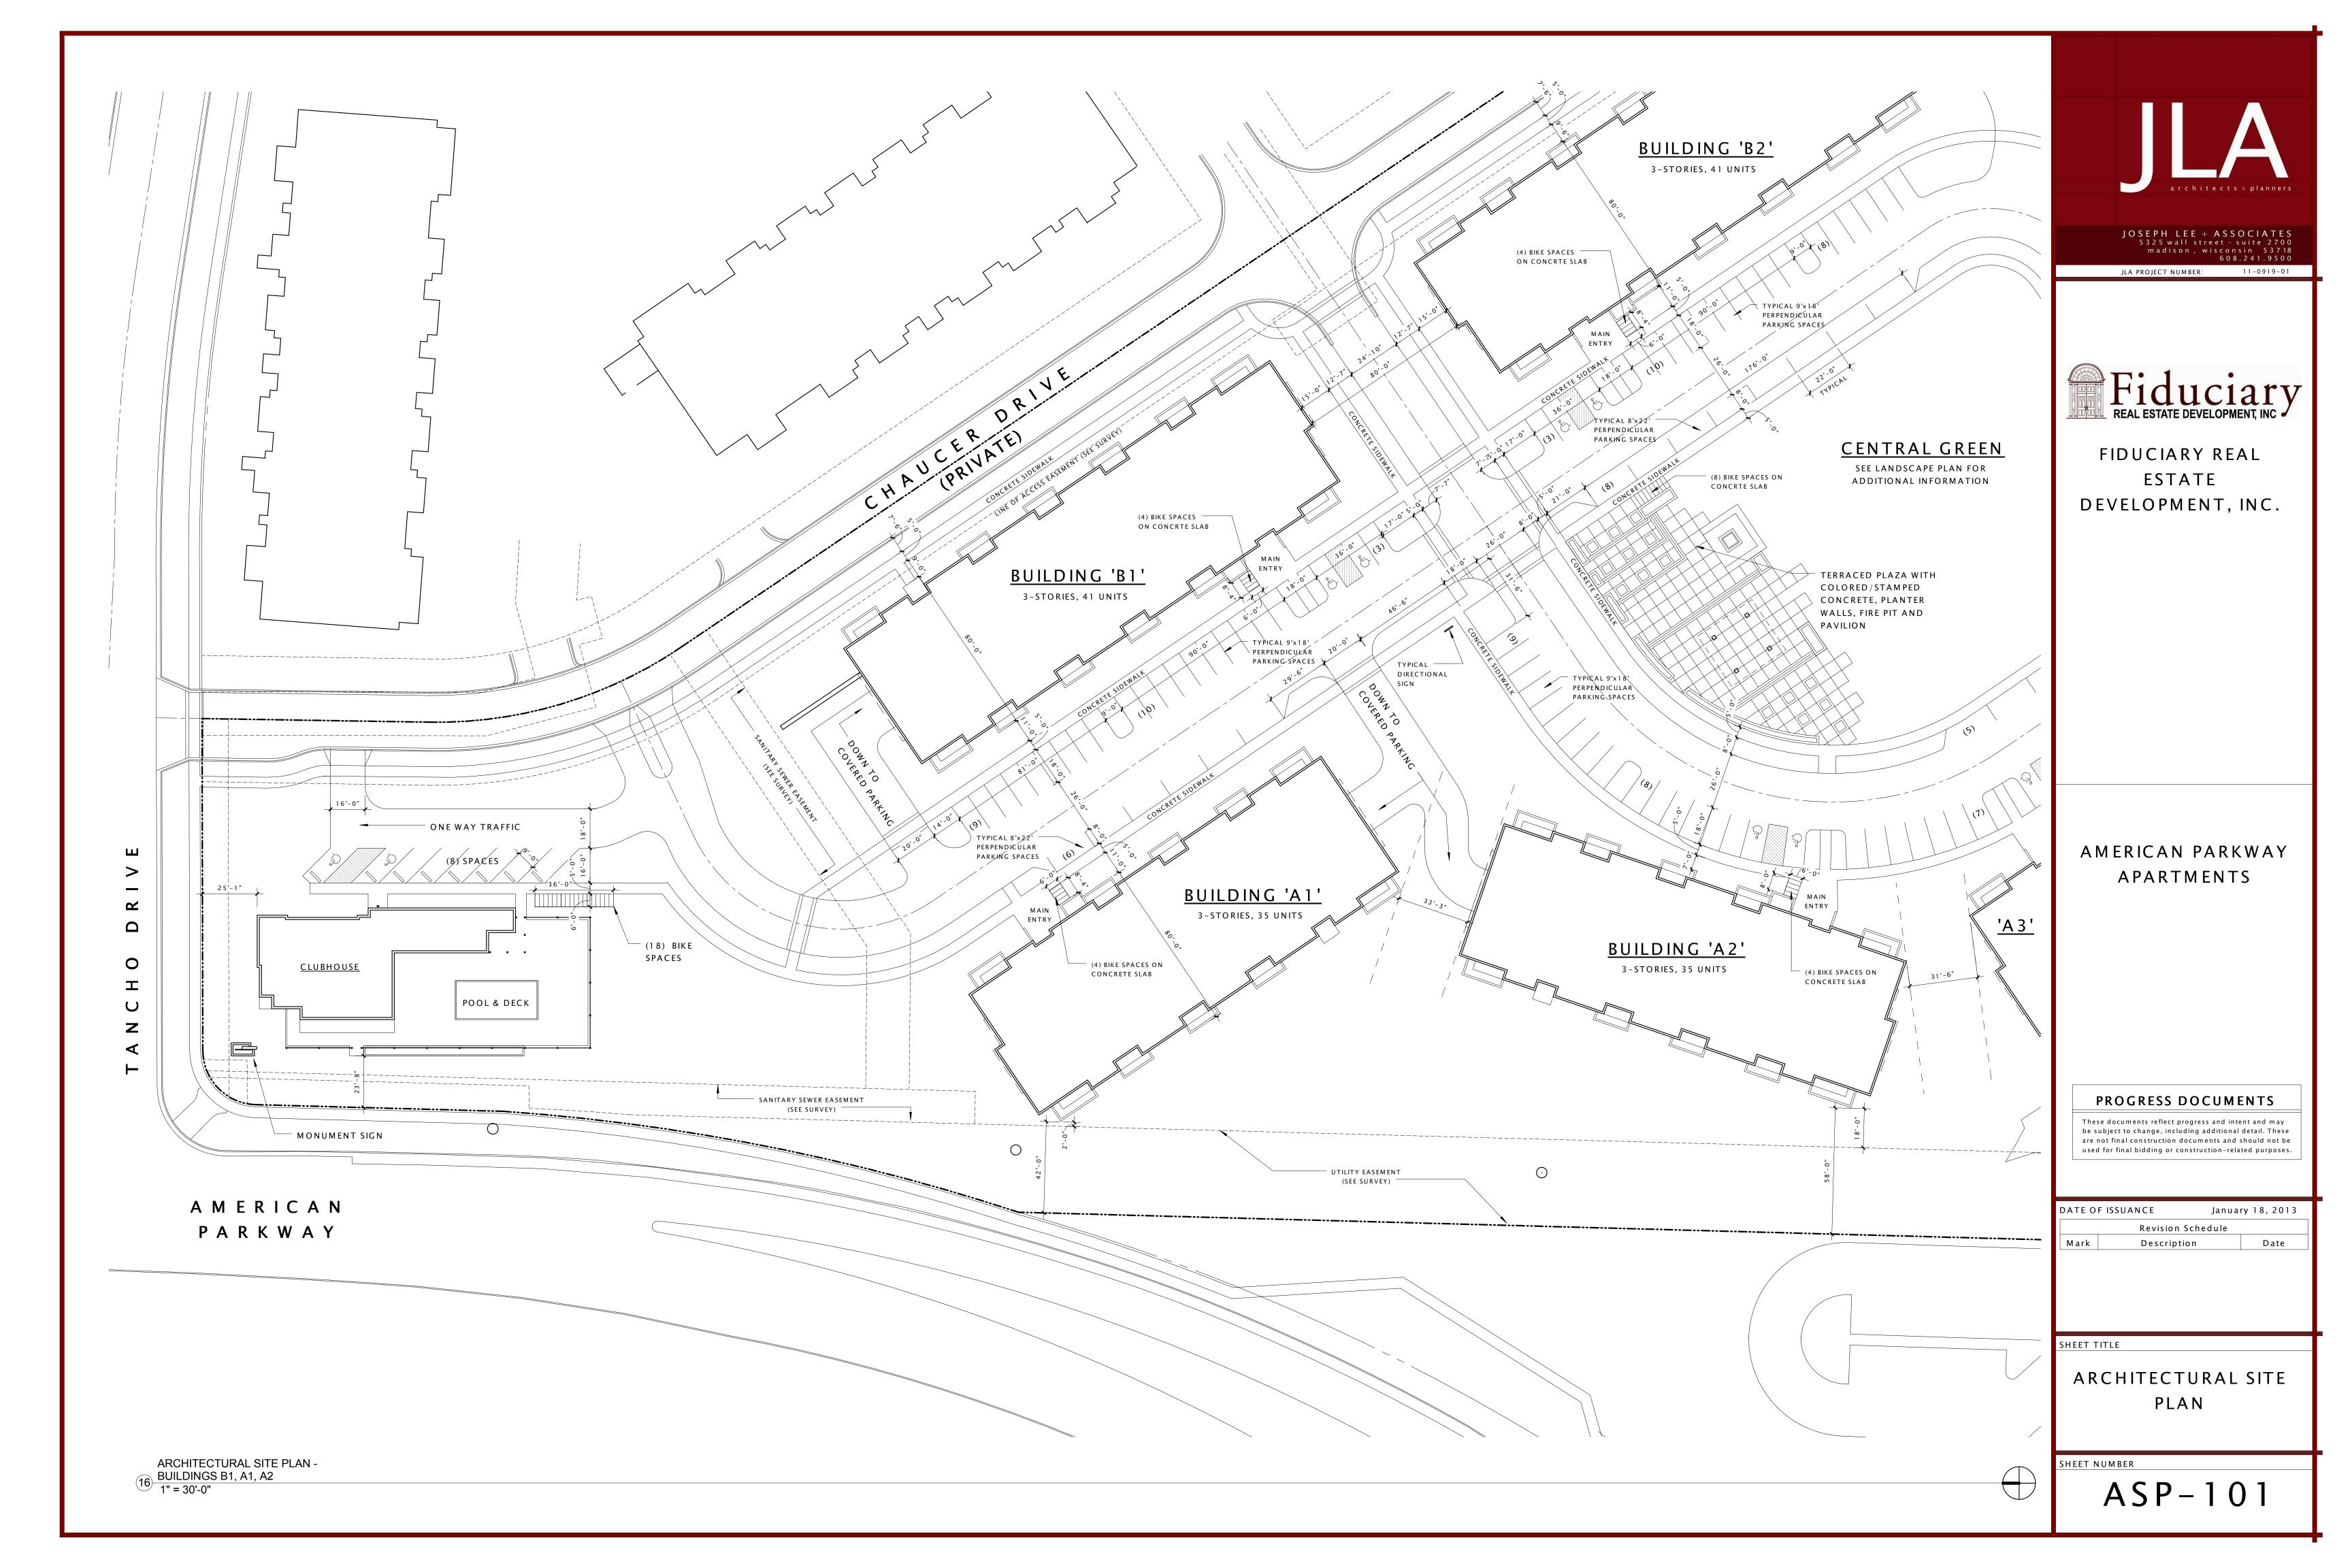


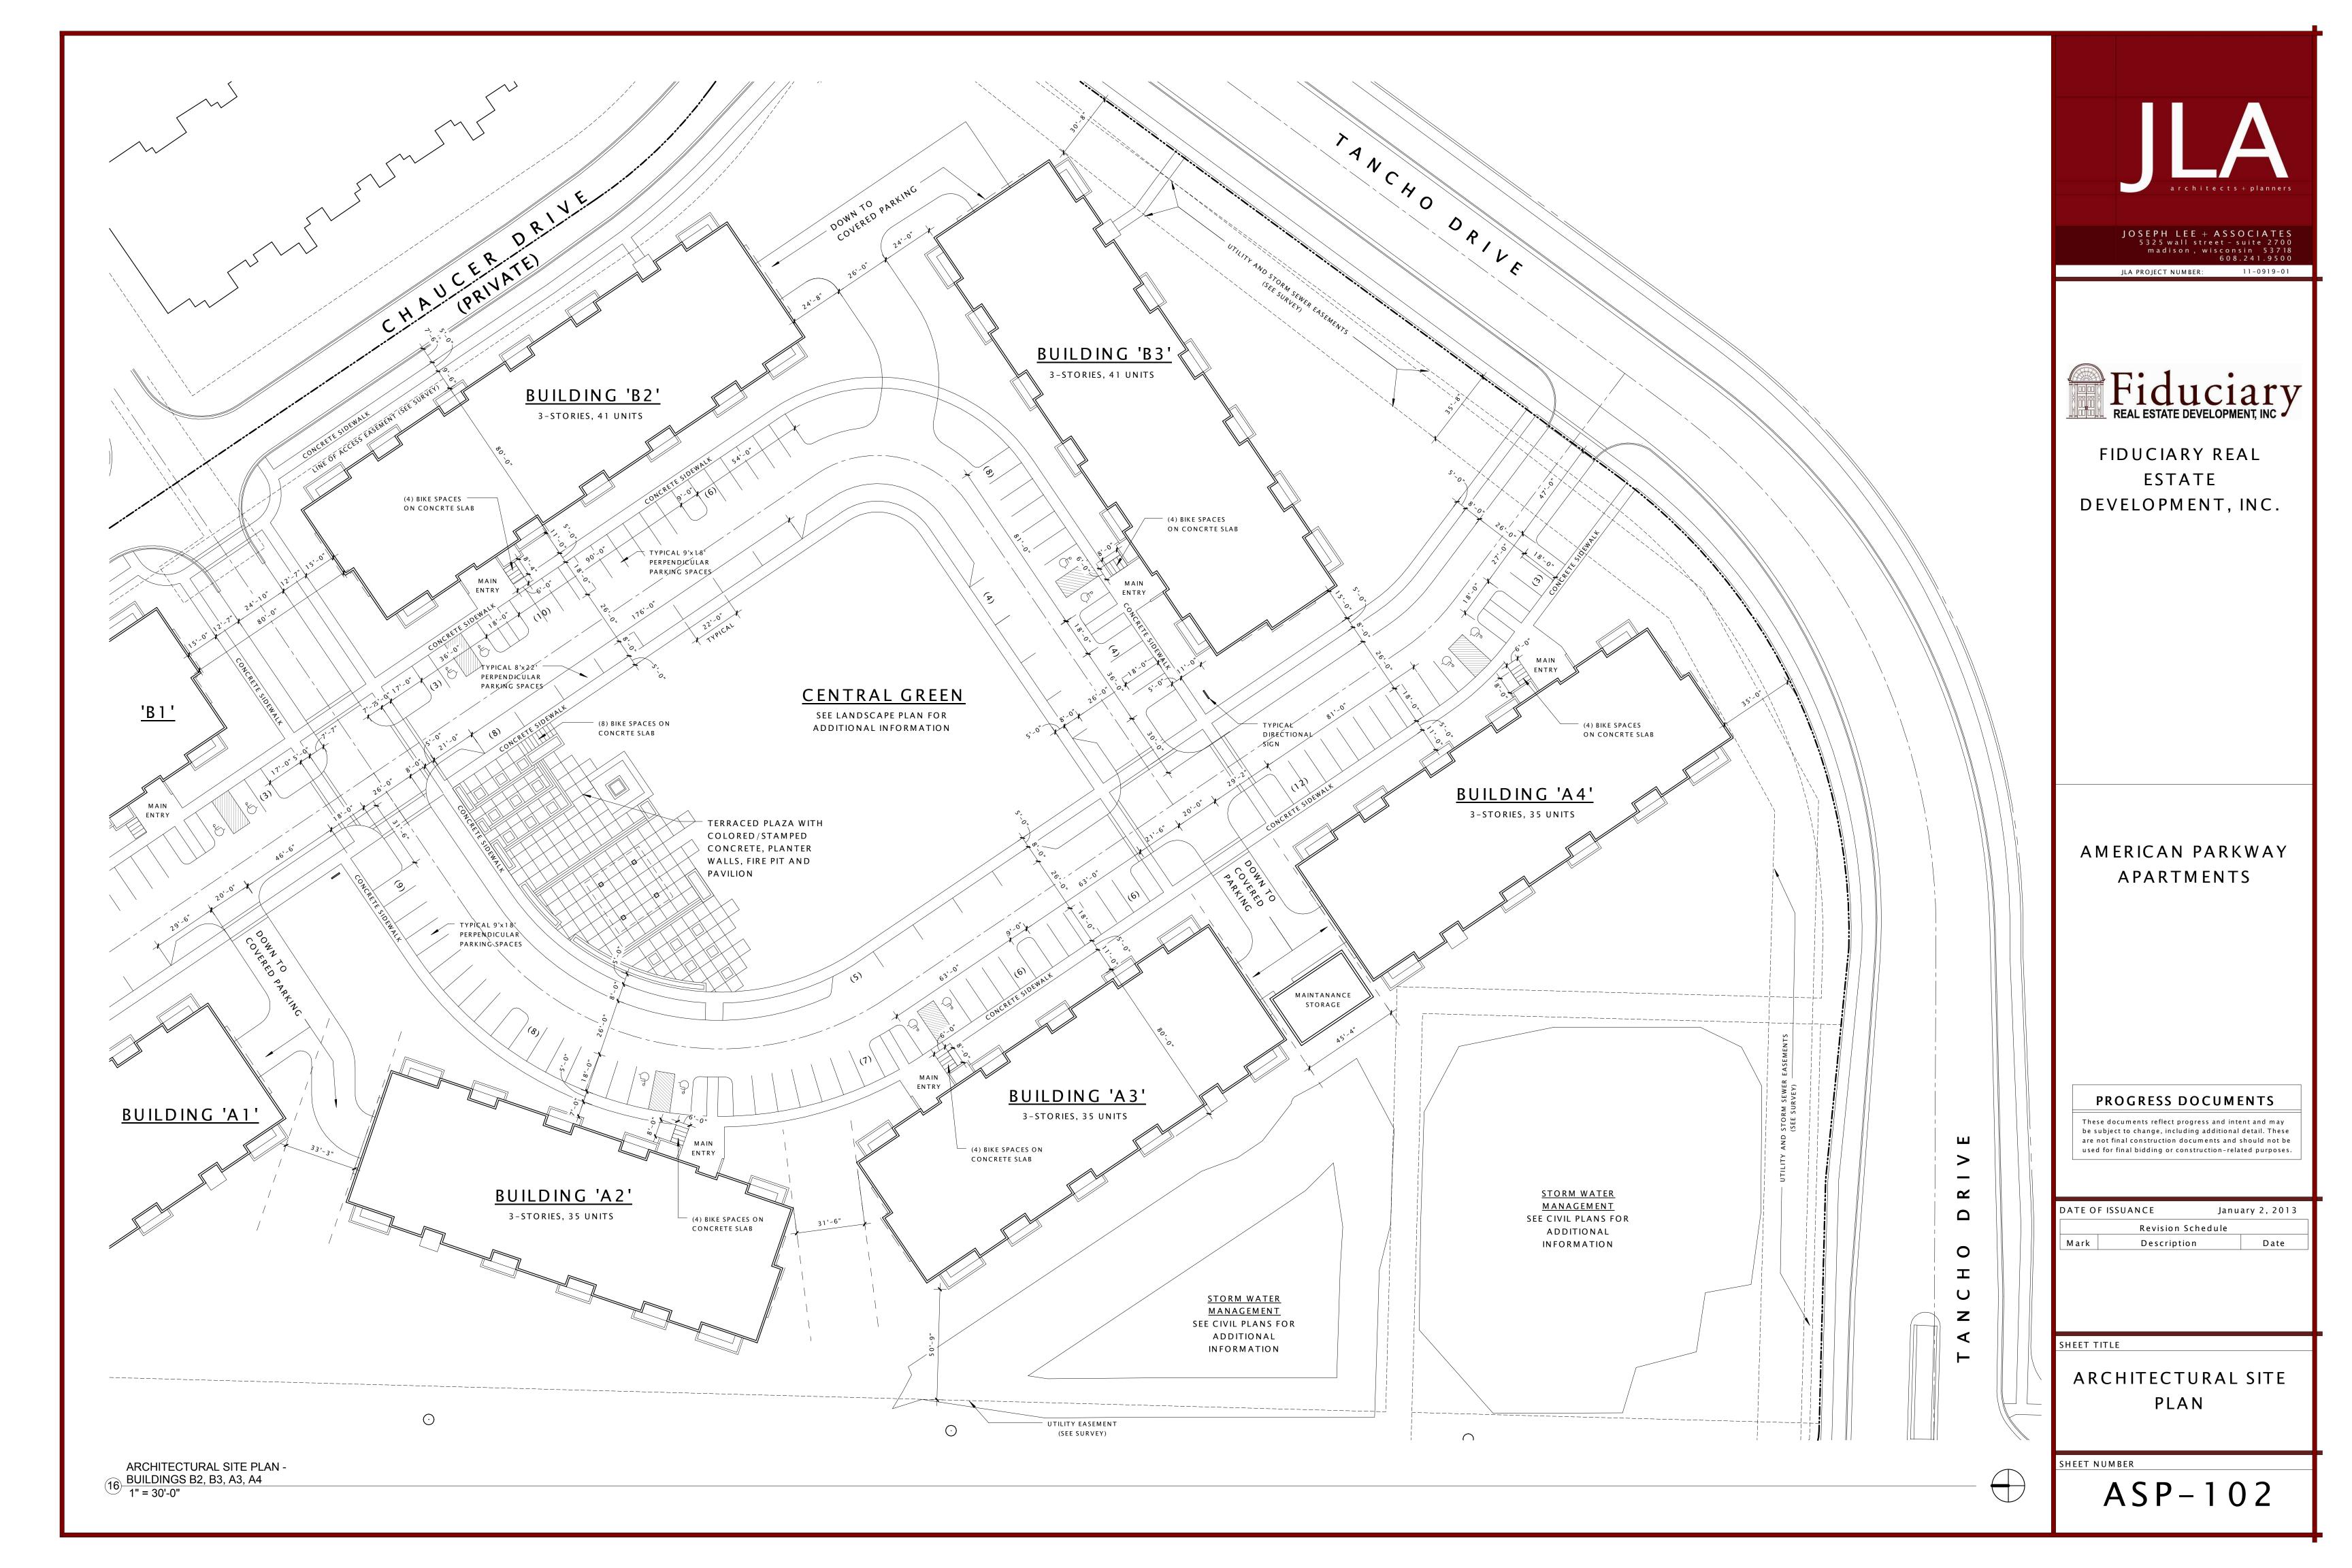


# EXTERIOR BIKE RACKS

EXTERIOR BIKE RACKS SHALL BE 'DERO CAMPUS - S4' OR EQUAL WITH IN-GROUND MOUNT (SHOWN IN PHOTO) & STAINLESS STEEL FINISH. ONE 'S4' RACK SHALL BE LOCATED AT THE ENTRY OF EACH RESIDENTIAL BUILDING AS NOTED ON THE PLANS.

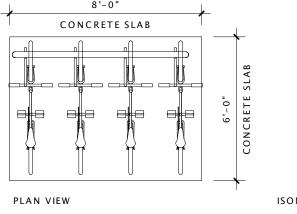

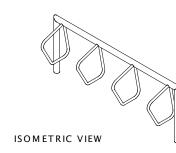

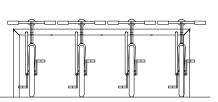




SIDE VII









6 MONUMENT SIGNS 1/2" = 1'-0" 1 DIRECTIONAL SIGNS 1/2" = 1'-0"

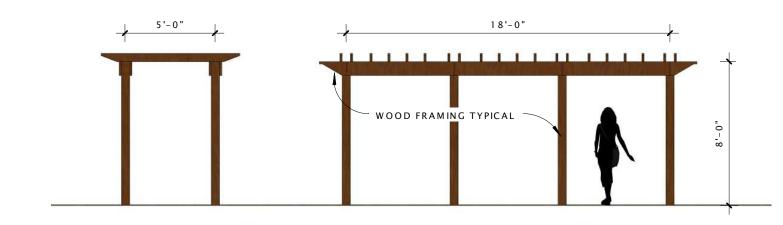


3 TRELLIS DETAIL
3/16" = 1'-0"

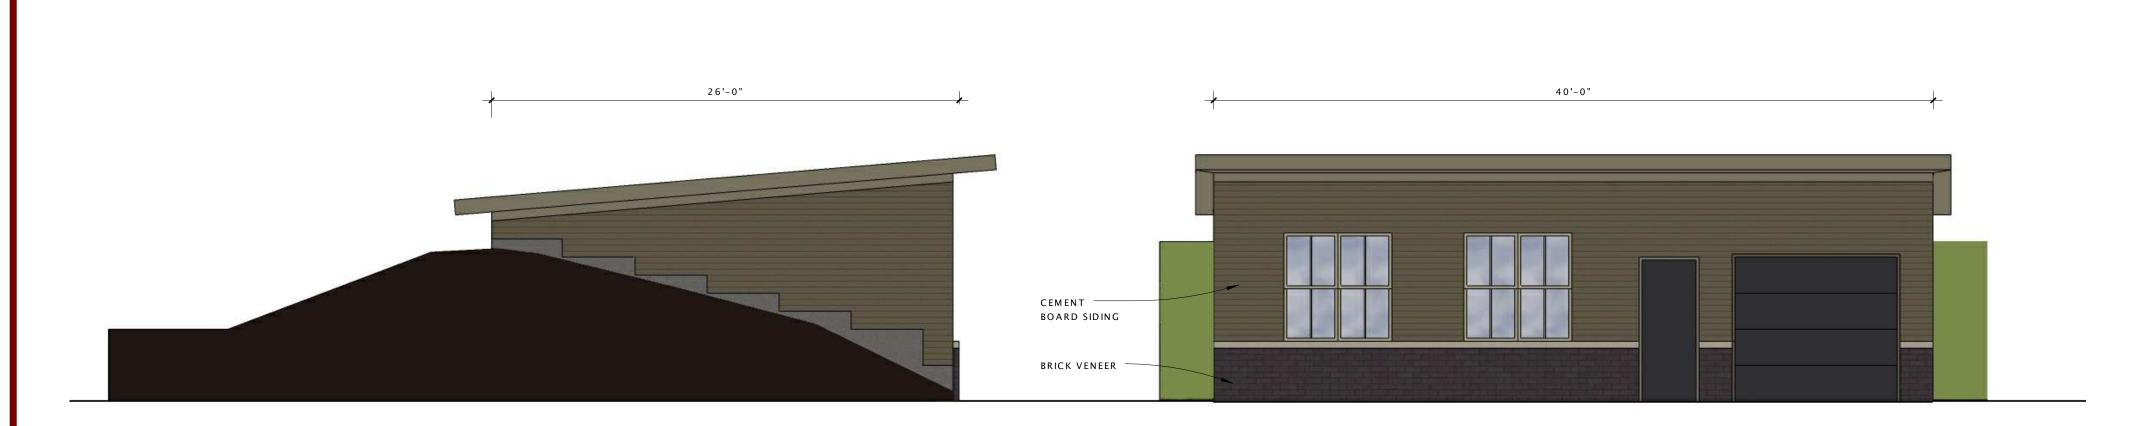

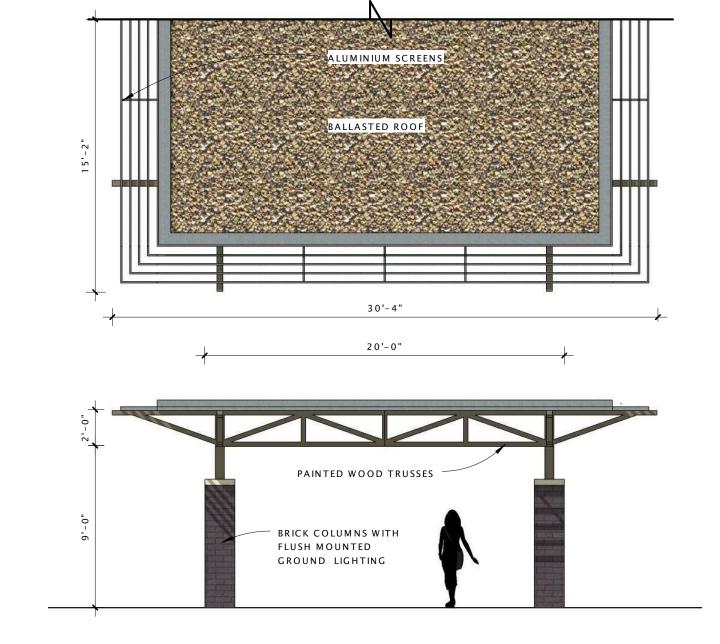

MAINTENANCE BUILDING
3/16" = 1'-0"

2 PAVILION 3/16" = 1'-0"

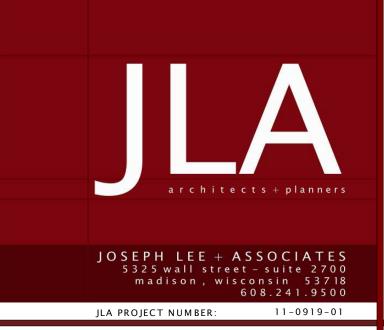



FIDUCIARY REAL
ESTATE
DEVELOPMENT, INC.

AMERICAN PARKWAY
APARTMENTS

PROGRESS DOCUMENTS

These documents reflect progress and intent and may be subject to change, including additional detail. These are not final construction documents and should not be used for final bidding or construction-related purposes.


| DATE O | F ISSUANCE  | January 2, 2013 |
|--------|-------------|-----------------|
|        | Revision Sc | hedule          |
| Mark   | Descriptio  | n Date          |

SHEET TITLE

SITE DETAILS

SHEET NUMBER

ASP-103

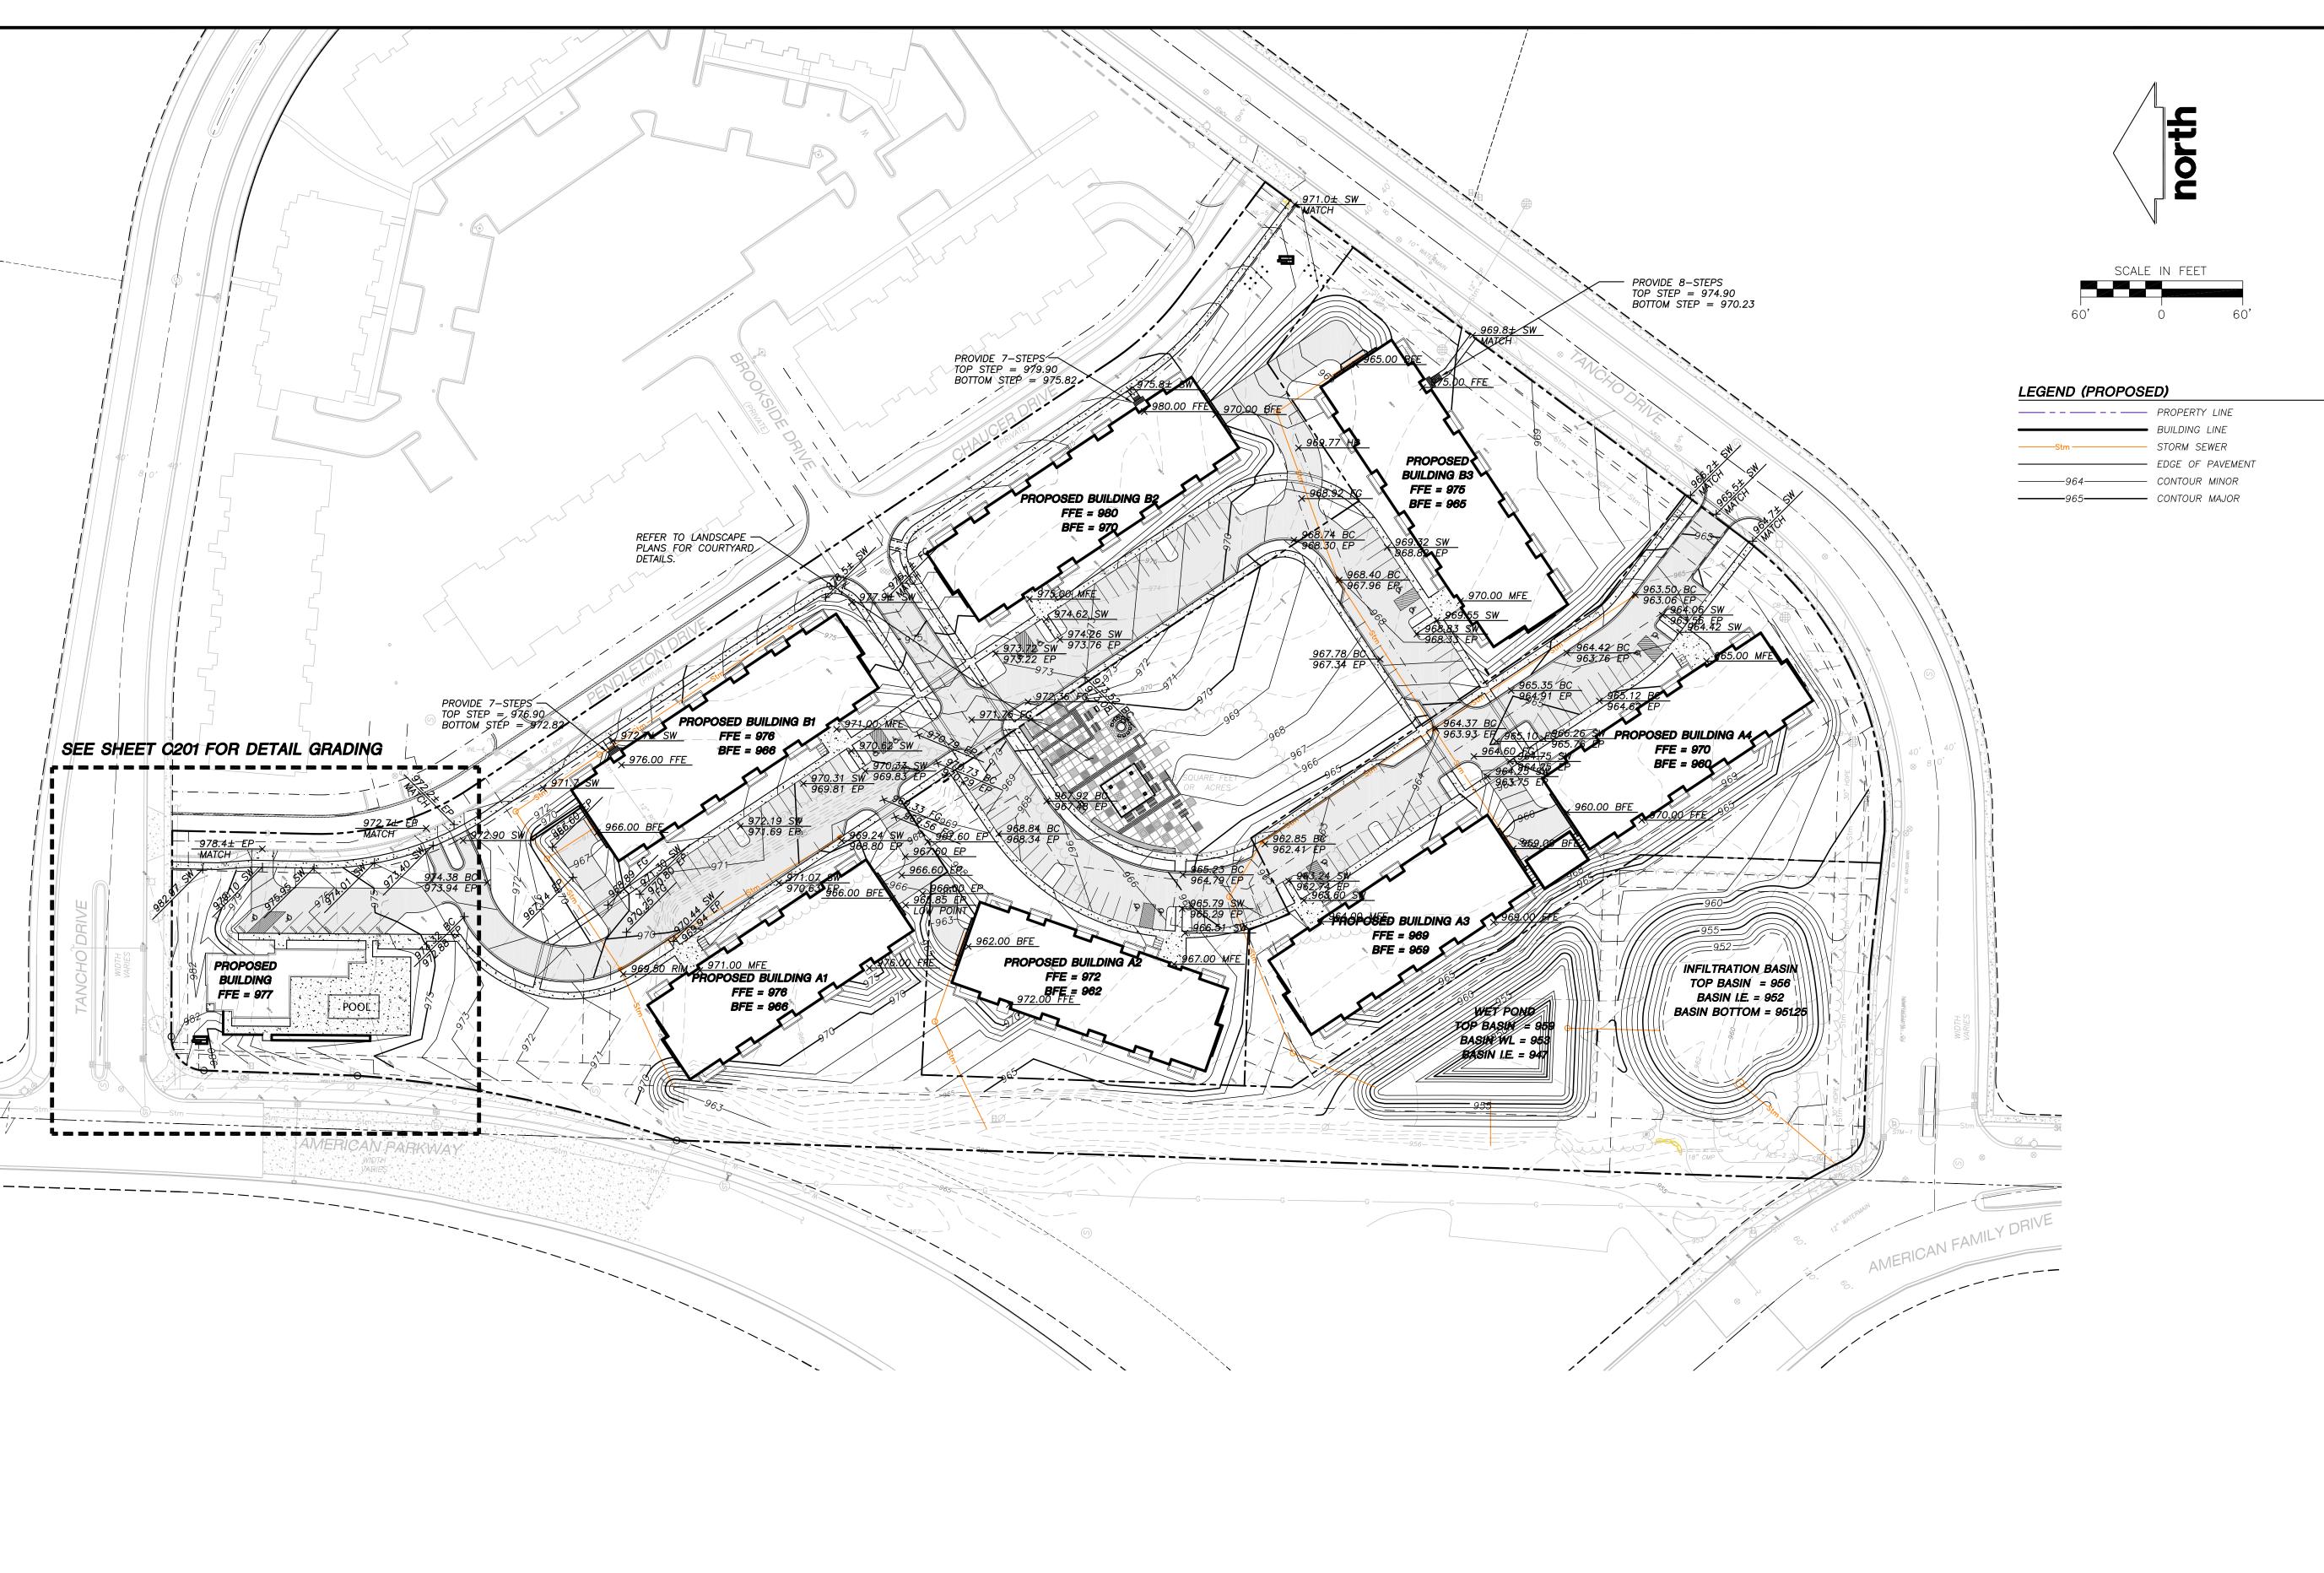



"BUILDING RELATIONSHIPS WITH A COMMITMENT TO CLIENT SATISFACTION THROUGH TRUST, QUALITY AND EXPERIENCE"

- CIVIL ENGINEERING
- SURVEYING & MAPPING
- CONSTRUCTION SERVICES
- WATER RESOURCES PLANNING & DEVELOPMENT
- TRANSPORTATION ENGINEERING
- STRUCTURAL ENGINEERING LANDSCAPE ARCHITECTURE

MADISON REGIONAL OFFICE 161 HORIZON DRIVE, SUITE 101 VERONA, WISCONSIN 53593

608.848.5060 PHONE 608.848.2255 FAX

MADISON MILWAUKEE KENOSHA APPLETON 🗕 www.jsdinc.com 🗕

SERVICES PROVIDED TO:

FIDUCIARY

REAL ESTATE DEVELOPMENT, INC.

789 N. WATER ST. STE. 200 MILWAUKEE, WI 53202

AMERICAN PARKWAY APARTMENTS

11-4523

10-15-12

PROJECT LOCATION: CITY OF MADISON DANE COUNTY, WI

JSD PROJECT NO.:

SEAL/SIGNATURE:

DESIGN: DOS

ALTHOUGH EVERY EFFORT HAS BEEN MADE IN PREPARING THESE PLANS AND CHECKING THEM FOR ACCURACY, THE CONTRACTOR AND SUBCONTRACTORS MUST CHECK ALL DETAIL AND DIMENSIONS OF THEIR TRADE AND BE RESPONSIBLE FOR THE SAME.


| DRAWN: DOS       |     | 10-15    | -12   |
|------------------|-----|----------|-------|
| APPROVED: WPV    | V   | <u>-</u> |       |
| PLAN MODIFICATIO | NS: | DA       | ATE:  |
| CITY OF MADISON  |     | 11-2     | 27-12 |
| CITY OF MADISON  |     | 01-0     | )2-13 |
| CITY OF MADISON  |     | 02-2     | 27-13 |
|                  |     |          |       |
|                  |     |          |       |




Toll Free (800) 242-8511 Milwaukee Area (414) 259-1181 Hearing Impaired TDD (800) 542-2289 www.DiggersHotline.com

SHEET TITLE:

GRADING PLAN

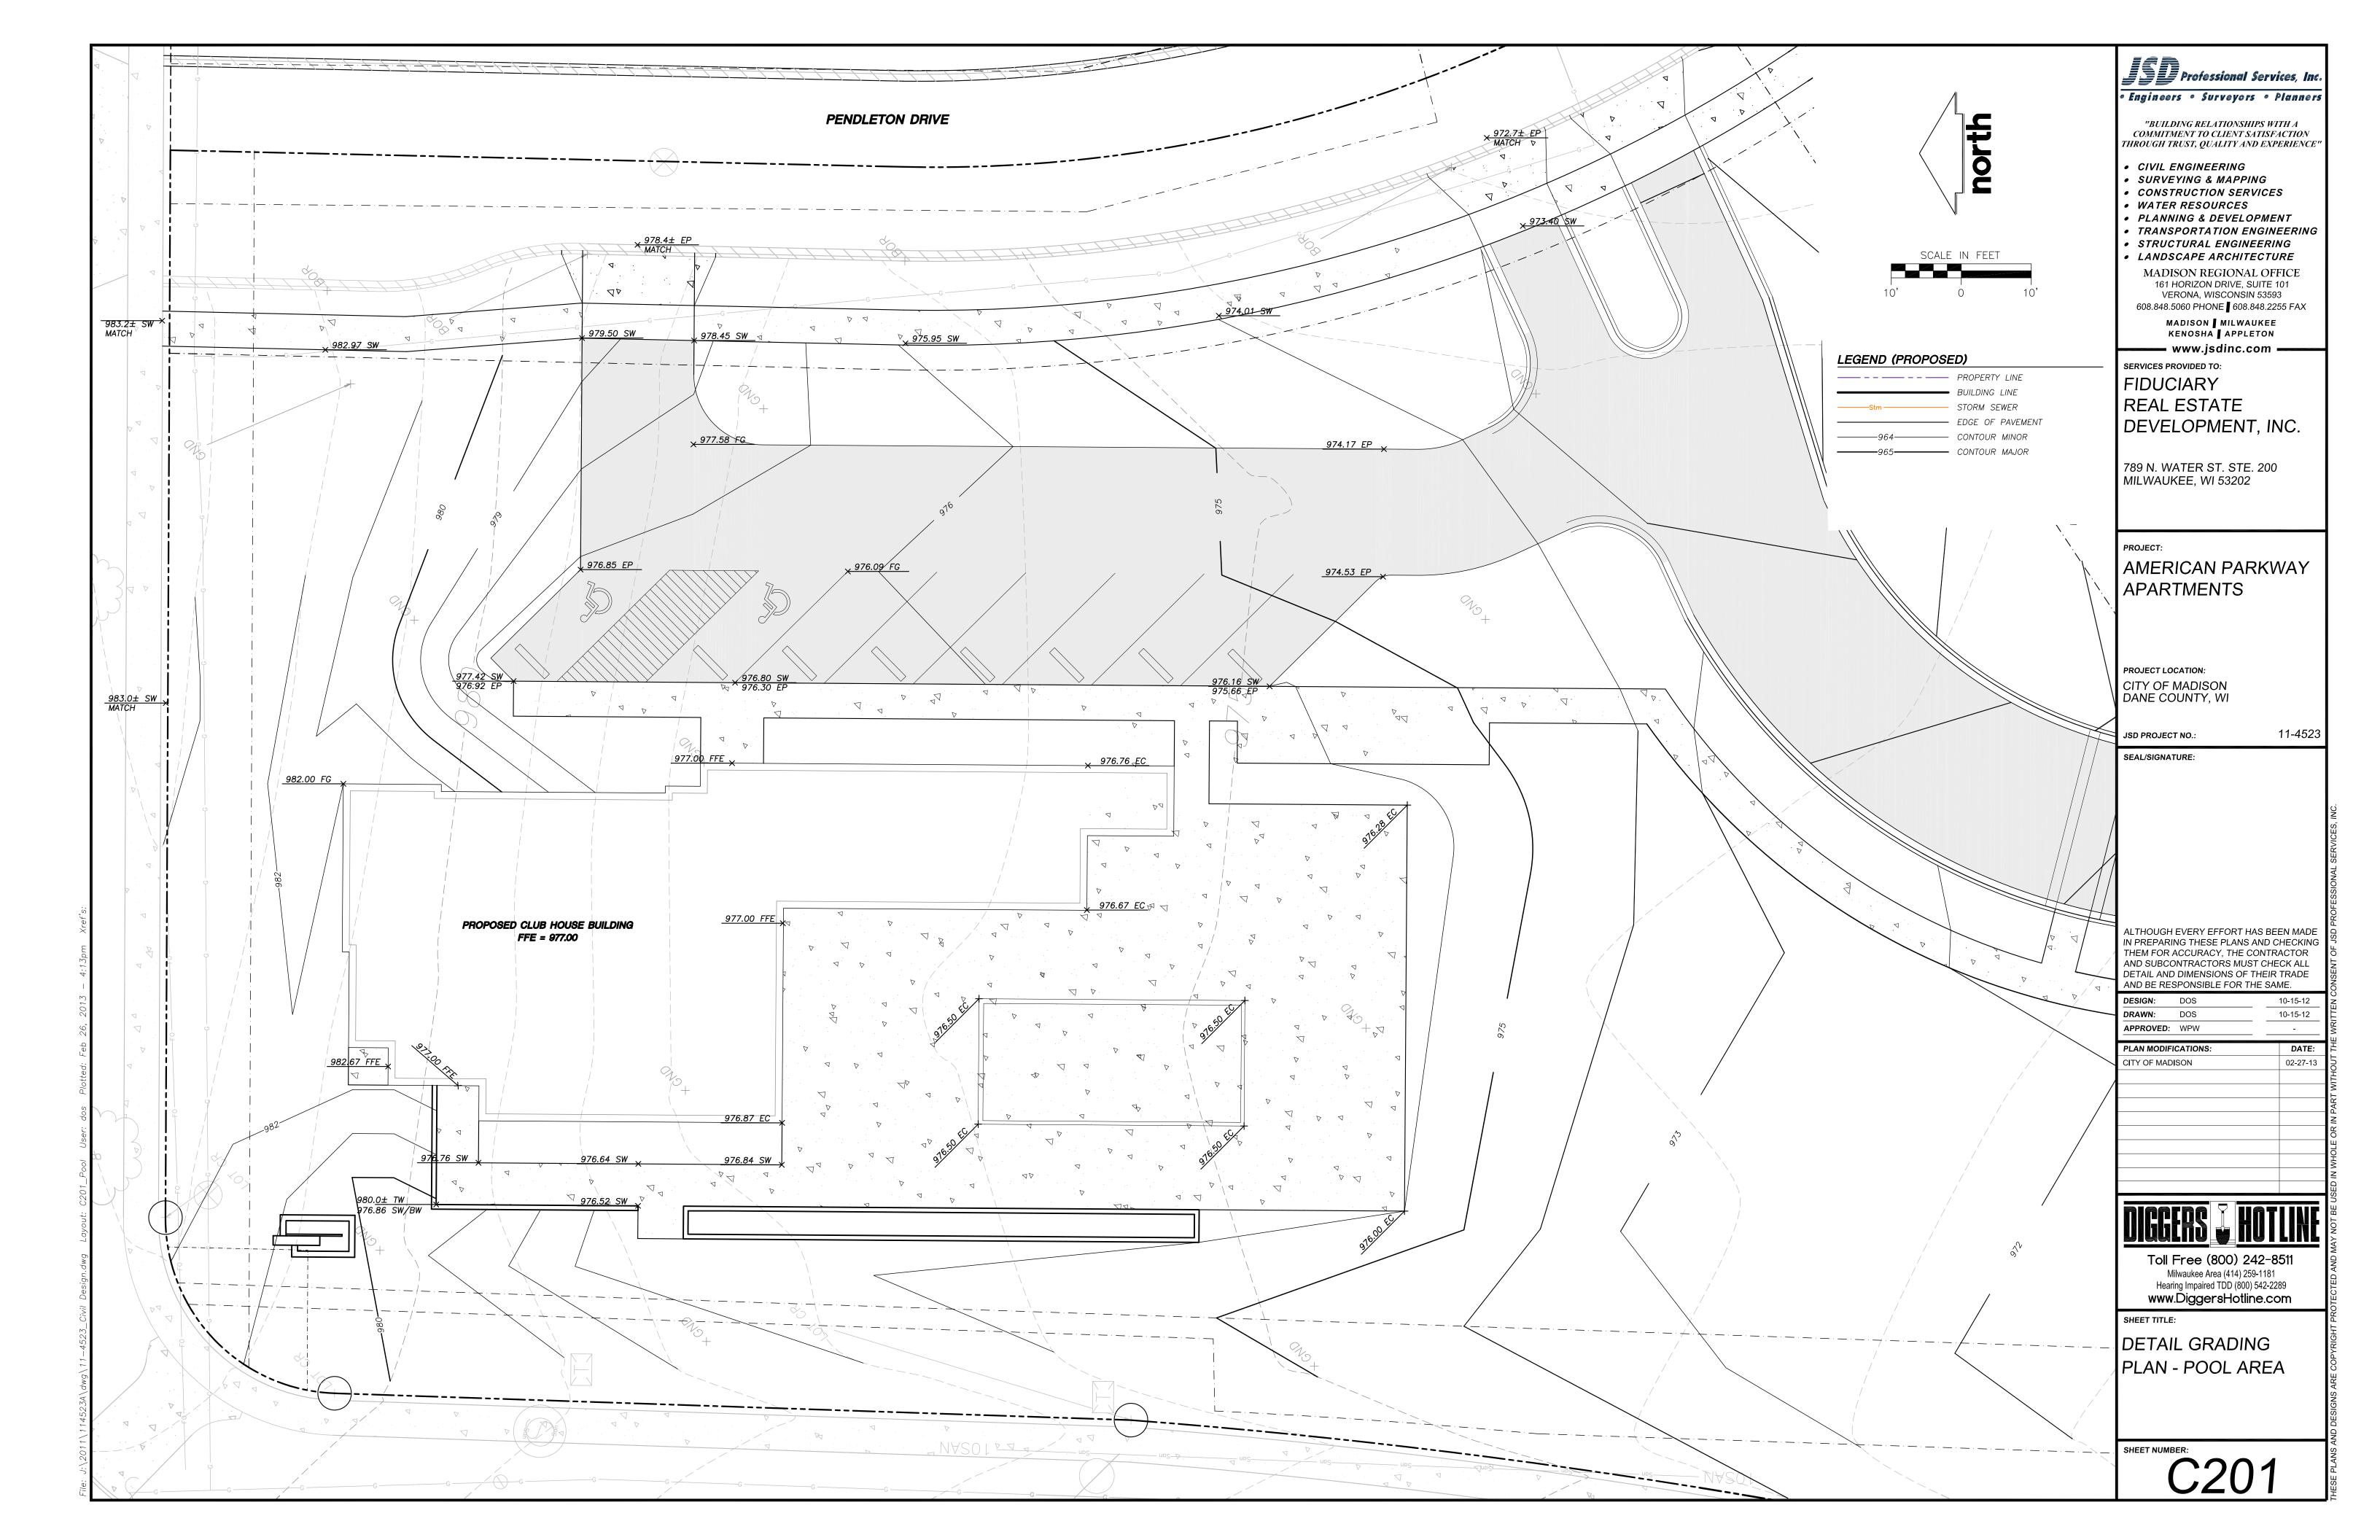

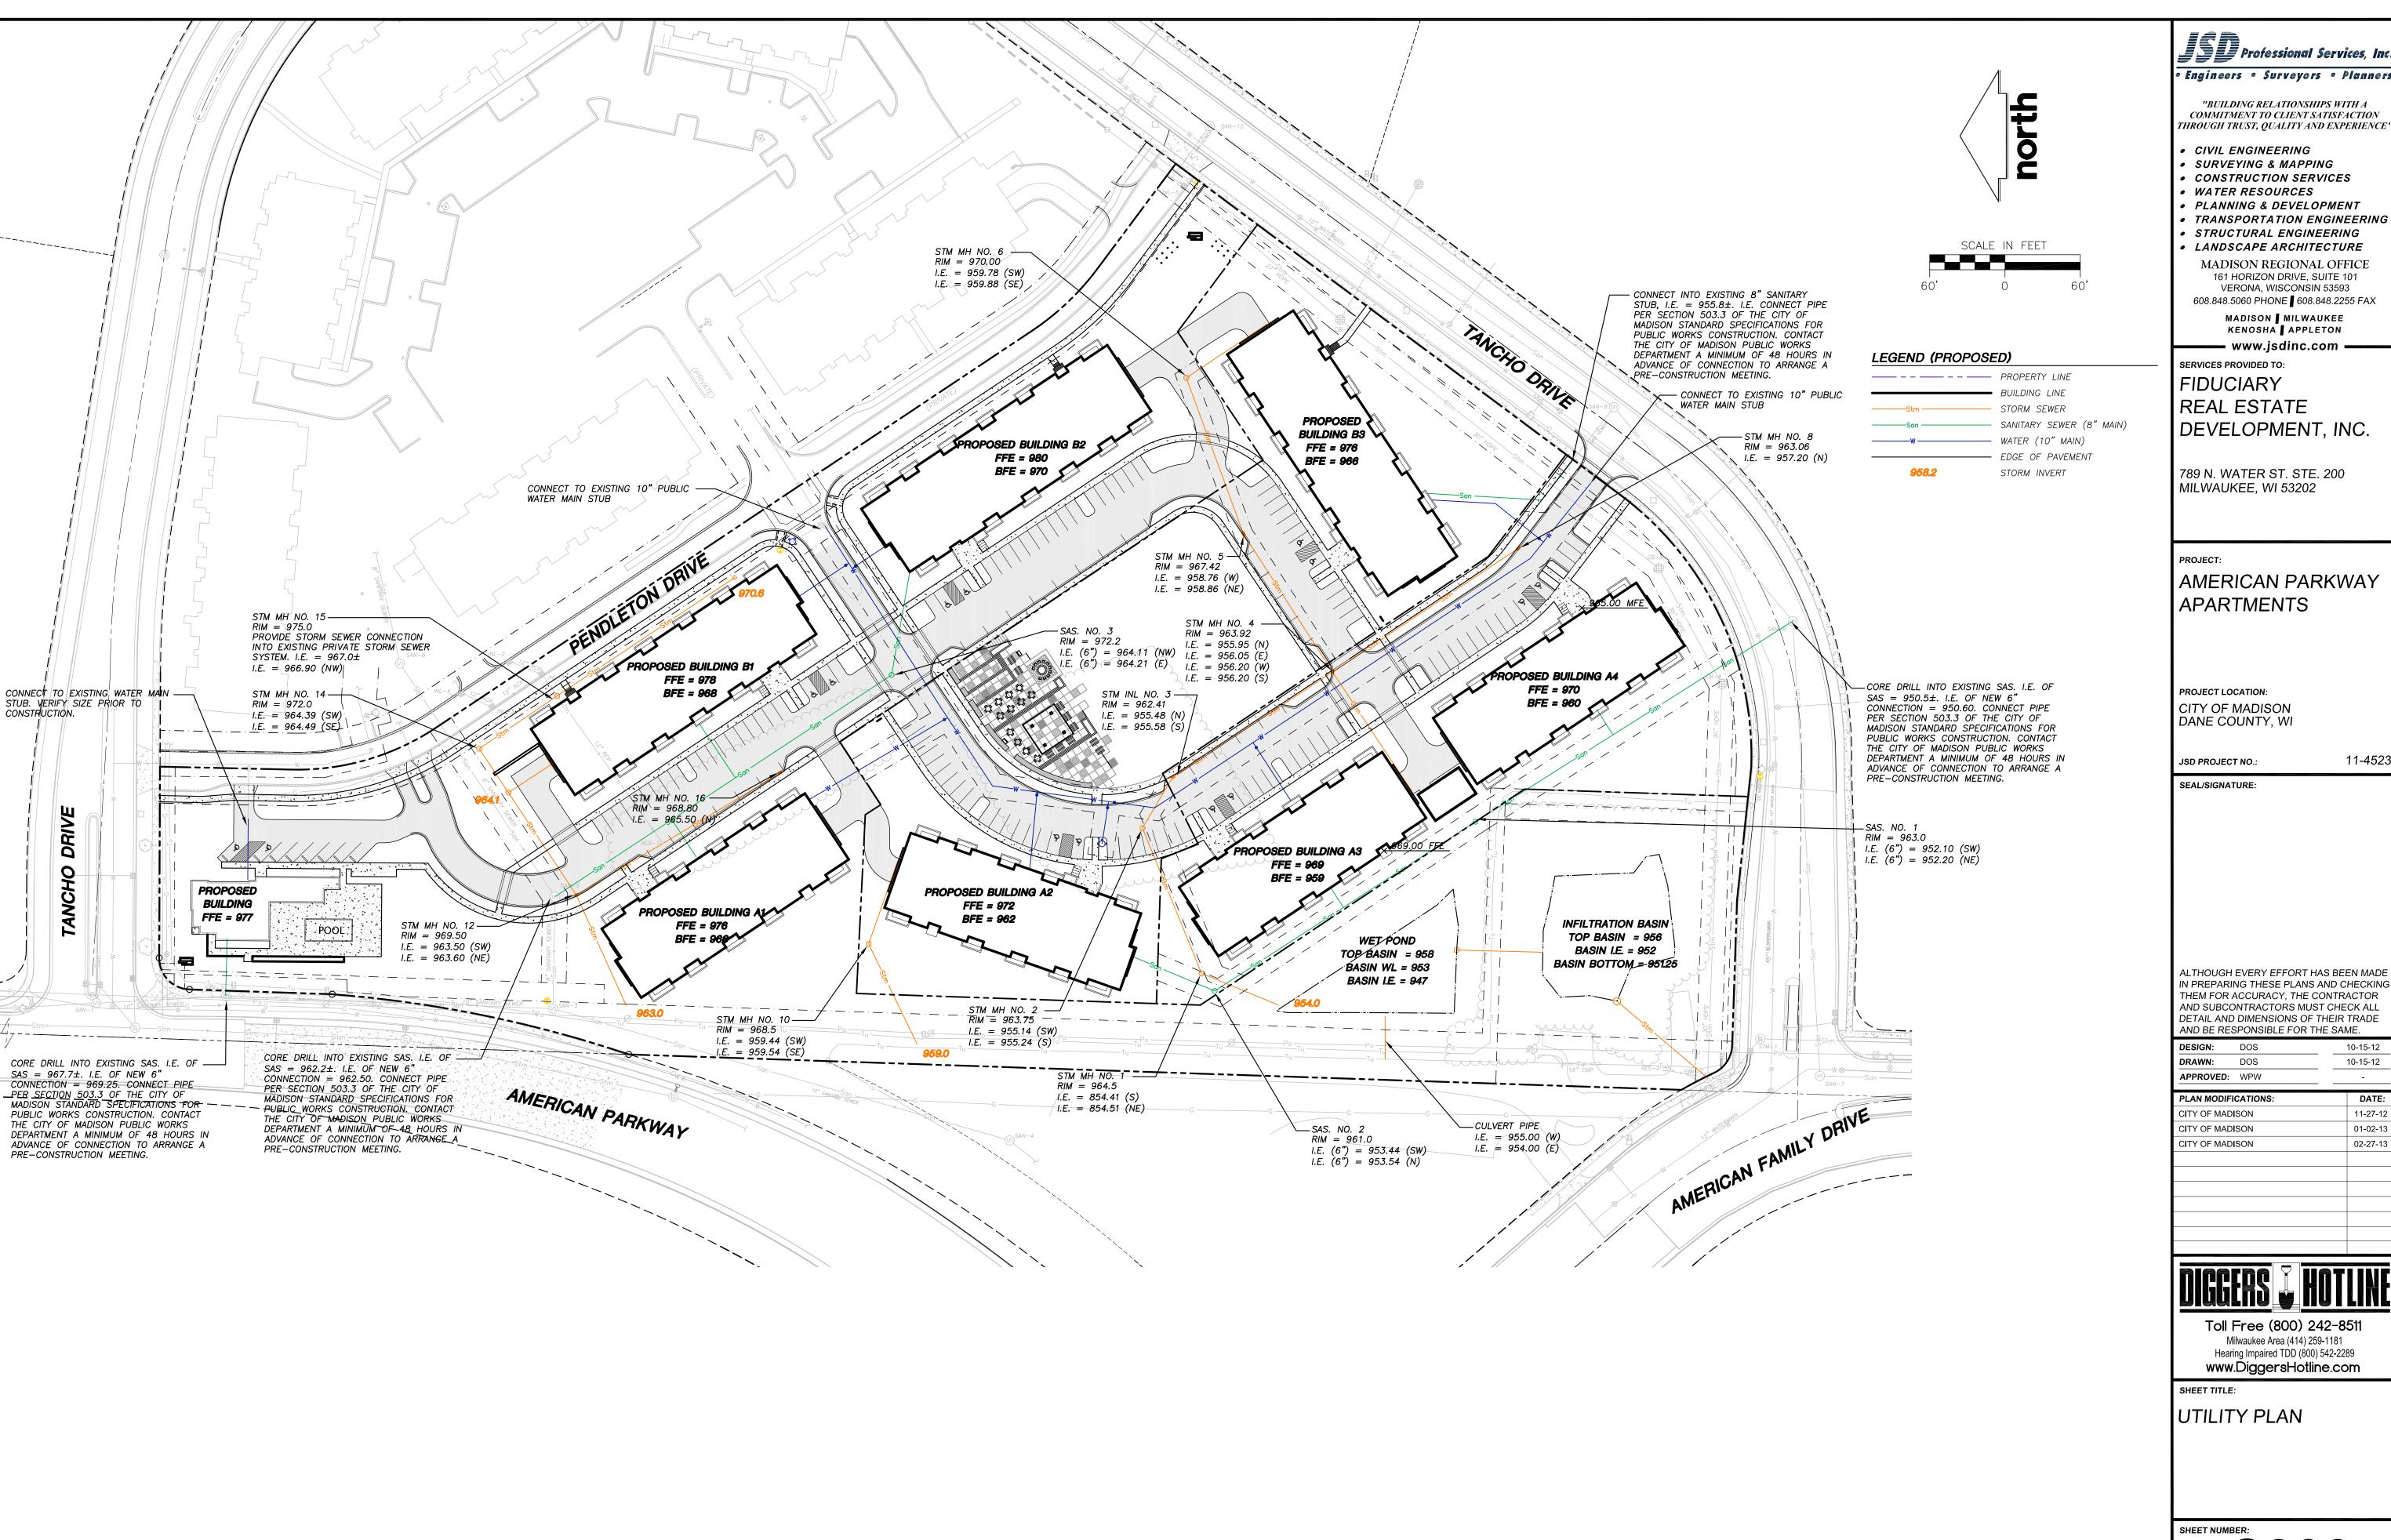

**ISD** Professional Services, Ind

"BUILDING RELATIONSHIPS WITH A COMMITMENT TO CLIENT SATISFACTION

- TRANSPORTATION ENGINEERING
- MADISON REGIONAL OFFICE

161 HORIZON DRIVE, SUITE 101 VERONA, WISCONSIN 53593

MADISON MILWAUKEE KENOSHA APPLETON

ALTHOUGH EVERY EFFORT HAS BEEN MADE IN PREPARING THESE PLANS AND CHECKING THEM FOR ACCURACY, THE CONTRACTOR AND SUBCONTRACTORS MUST CHECK ALL DETAIL AND DIMENSIONS OF THEIR TRADE


11-4523

10-15-12

| DRAWN: DOS          | 10-15-12 |
|---------------------|----------|
| APPROVED: WPW       |          |
| PLAN MODIFICATIONS: | DATE:    |
| CITY OF MADISON     | 11-27-12 |
| CITY OF MADISON     | 01-02-13 |
| CITY OF MADISON     | 02-27-13 |
|                     |          |



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**ISD** Professional Services, Inc.

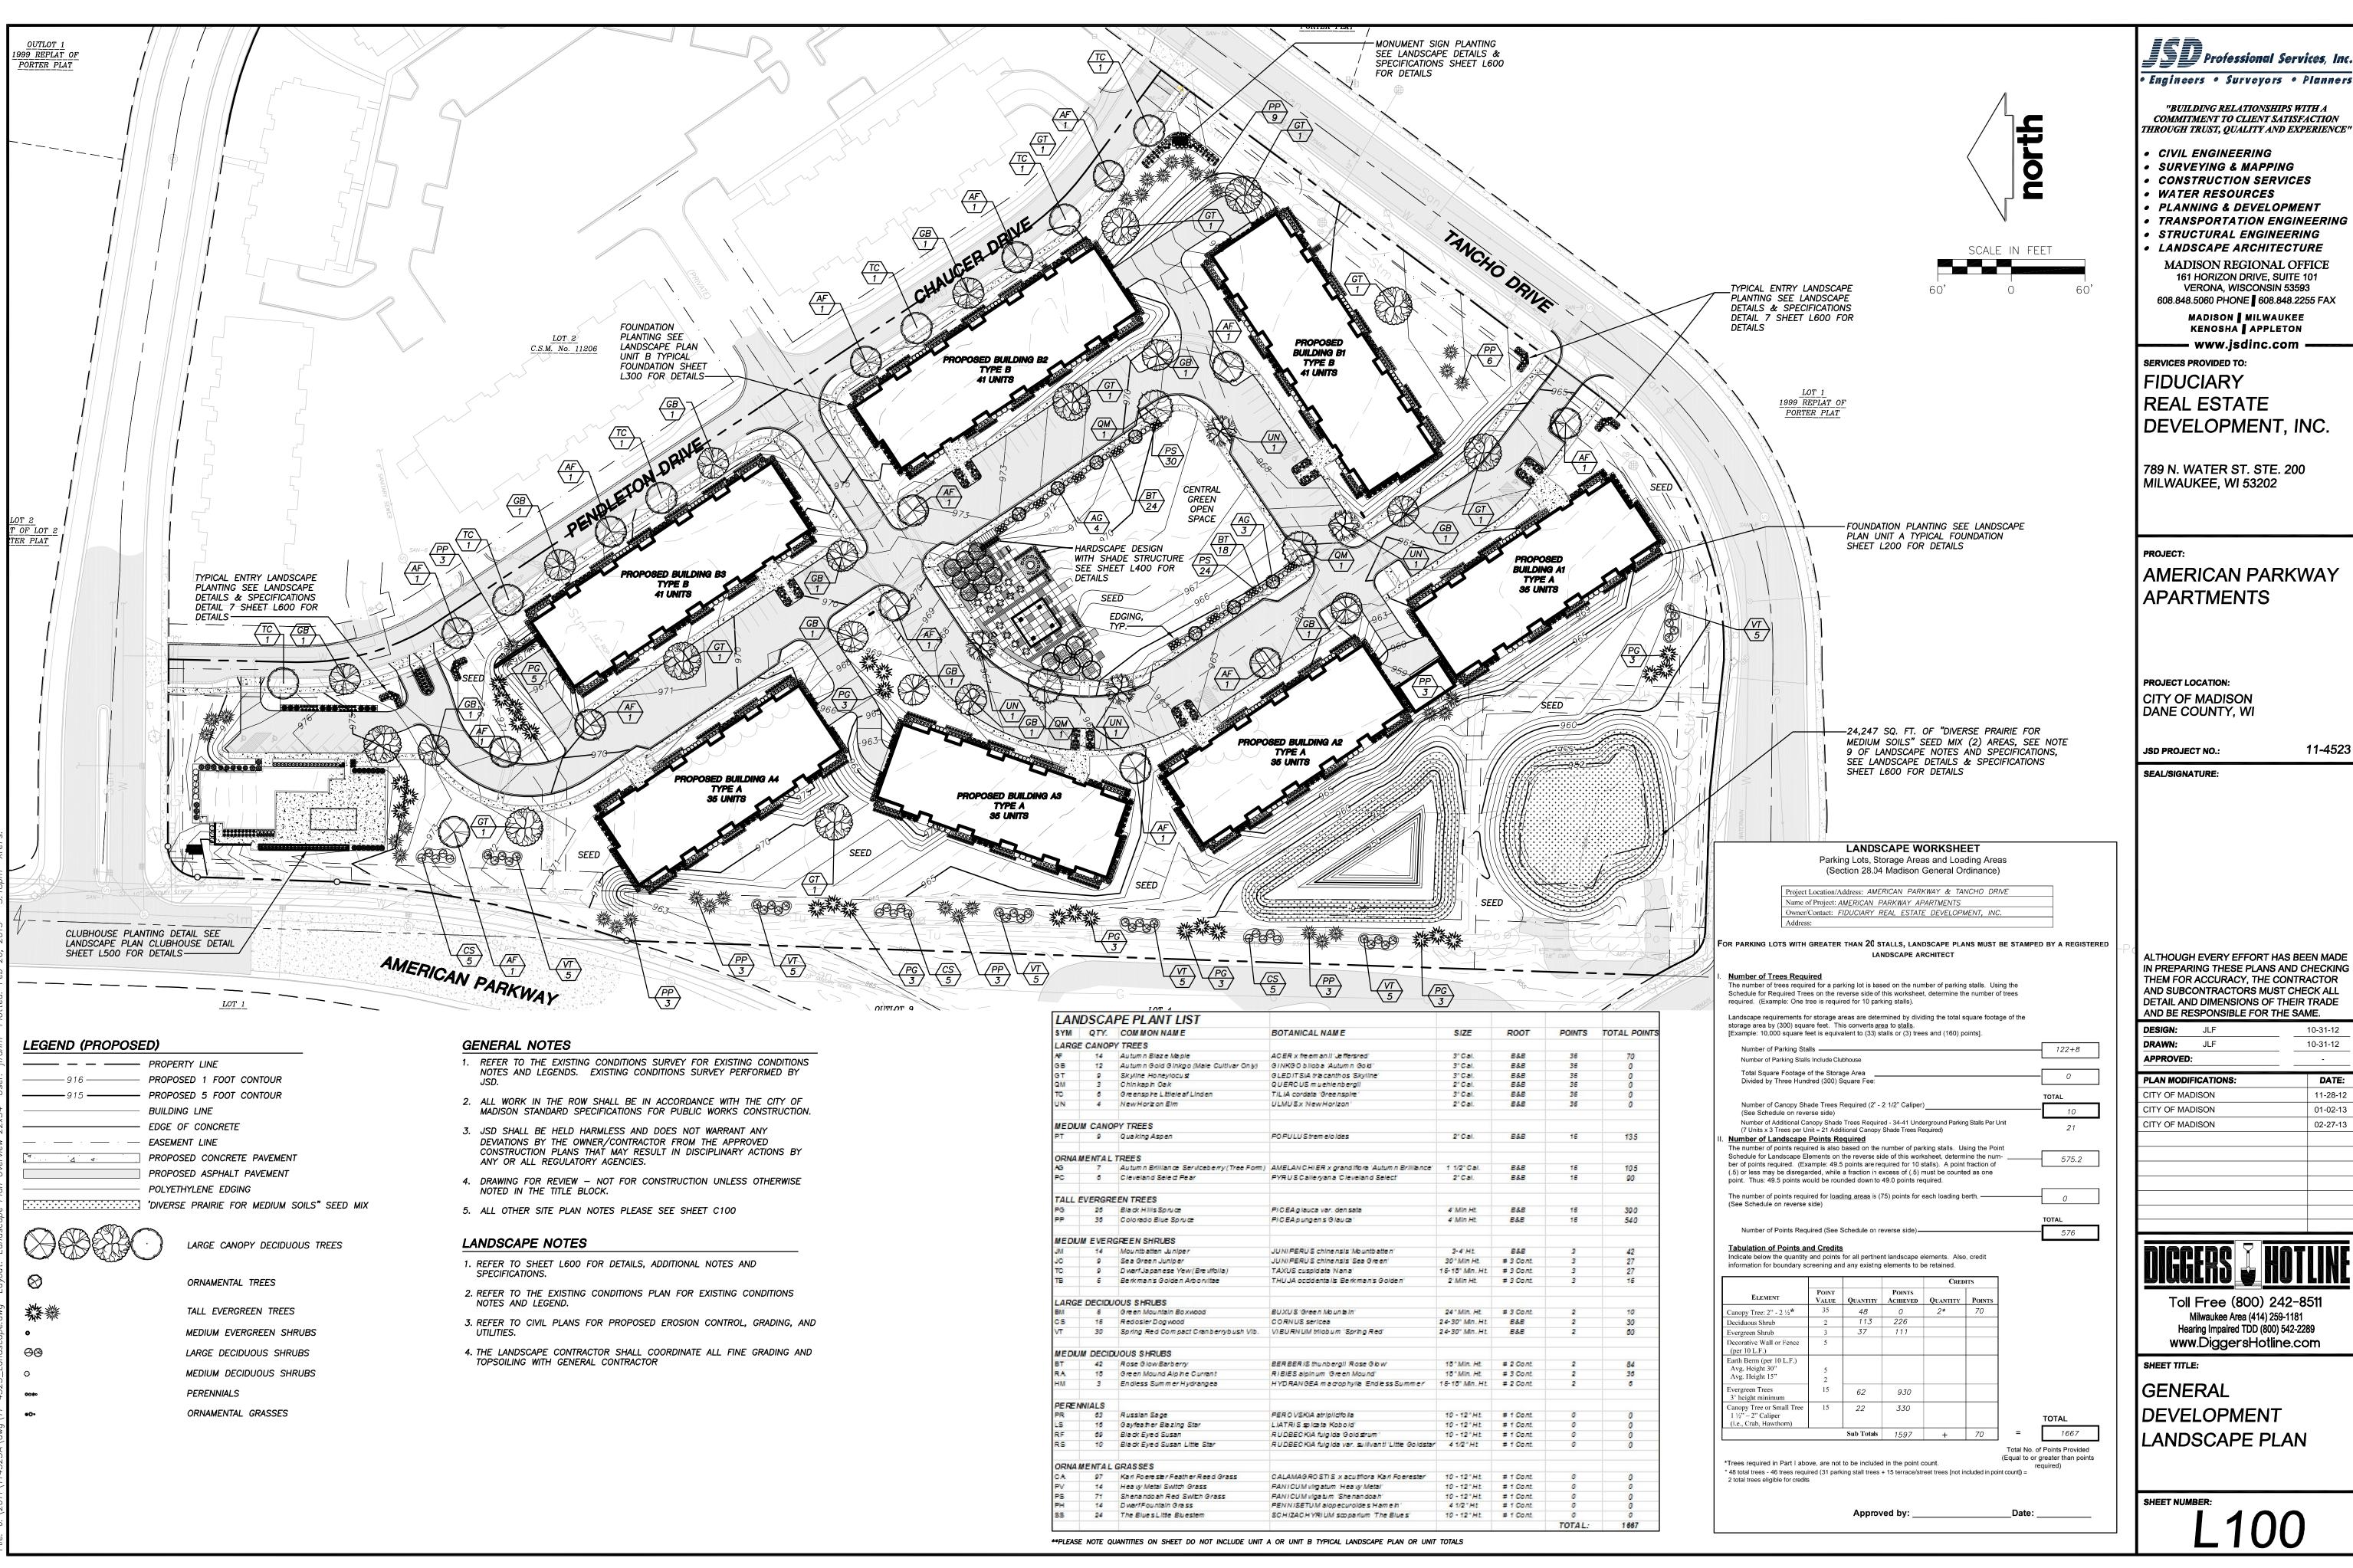"BUILDING RELATIONSHIPS WITH A COMMITMENT TO CLIENT SATISFACTION

- TRANSPORTATION ENGINEERING
- STRUCTURAL ENGINEERING
- MADISON REGIONAL OFFICE 161 HORIZON DRIVE, SUITE 101


VERONA, WISCONSIN 53593 608.848.5060 PHONE 608.848.2255 FAX


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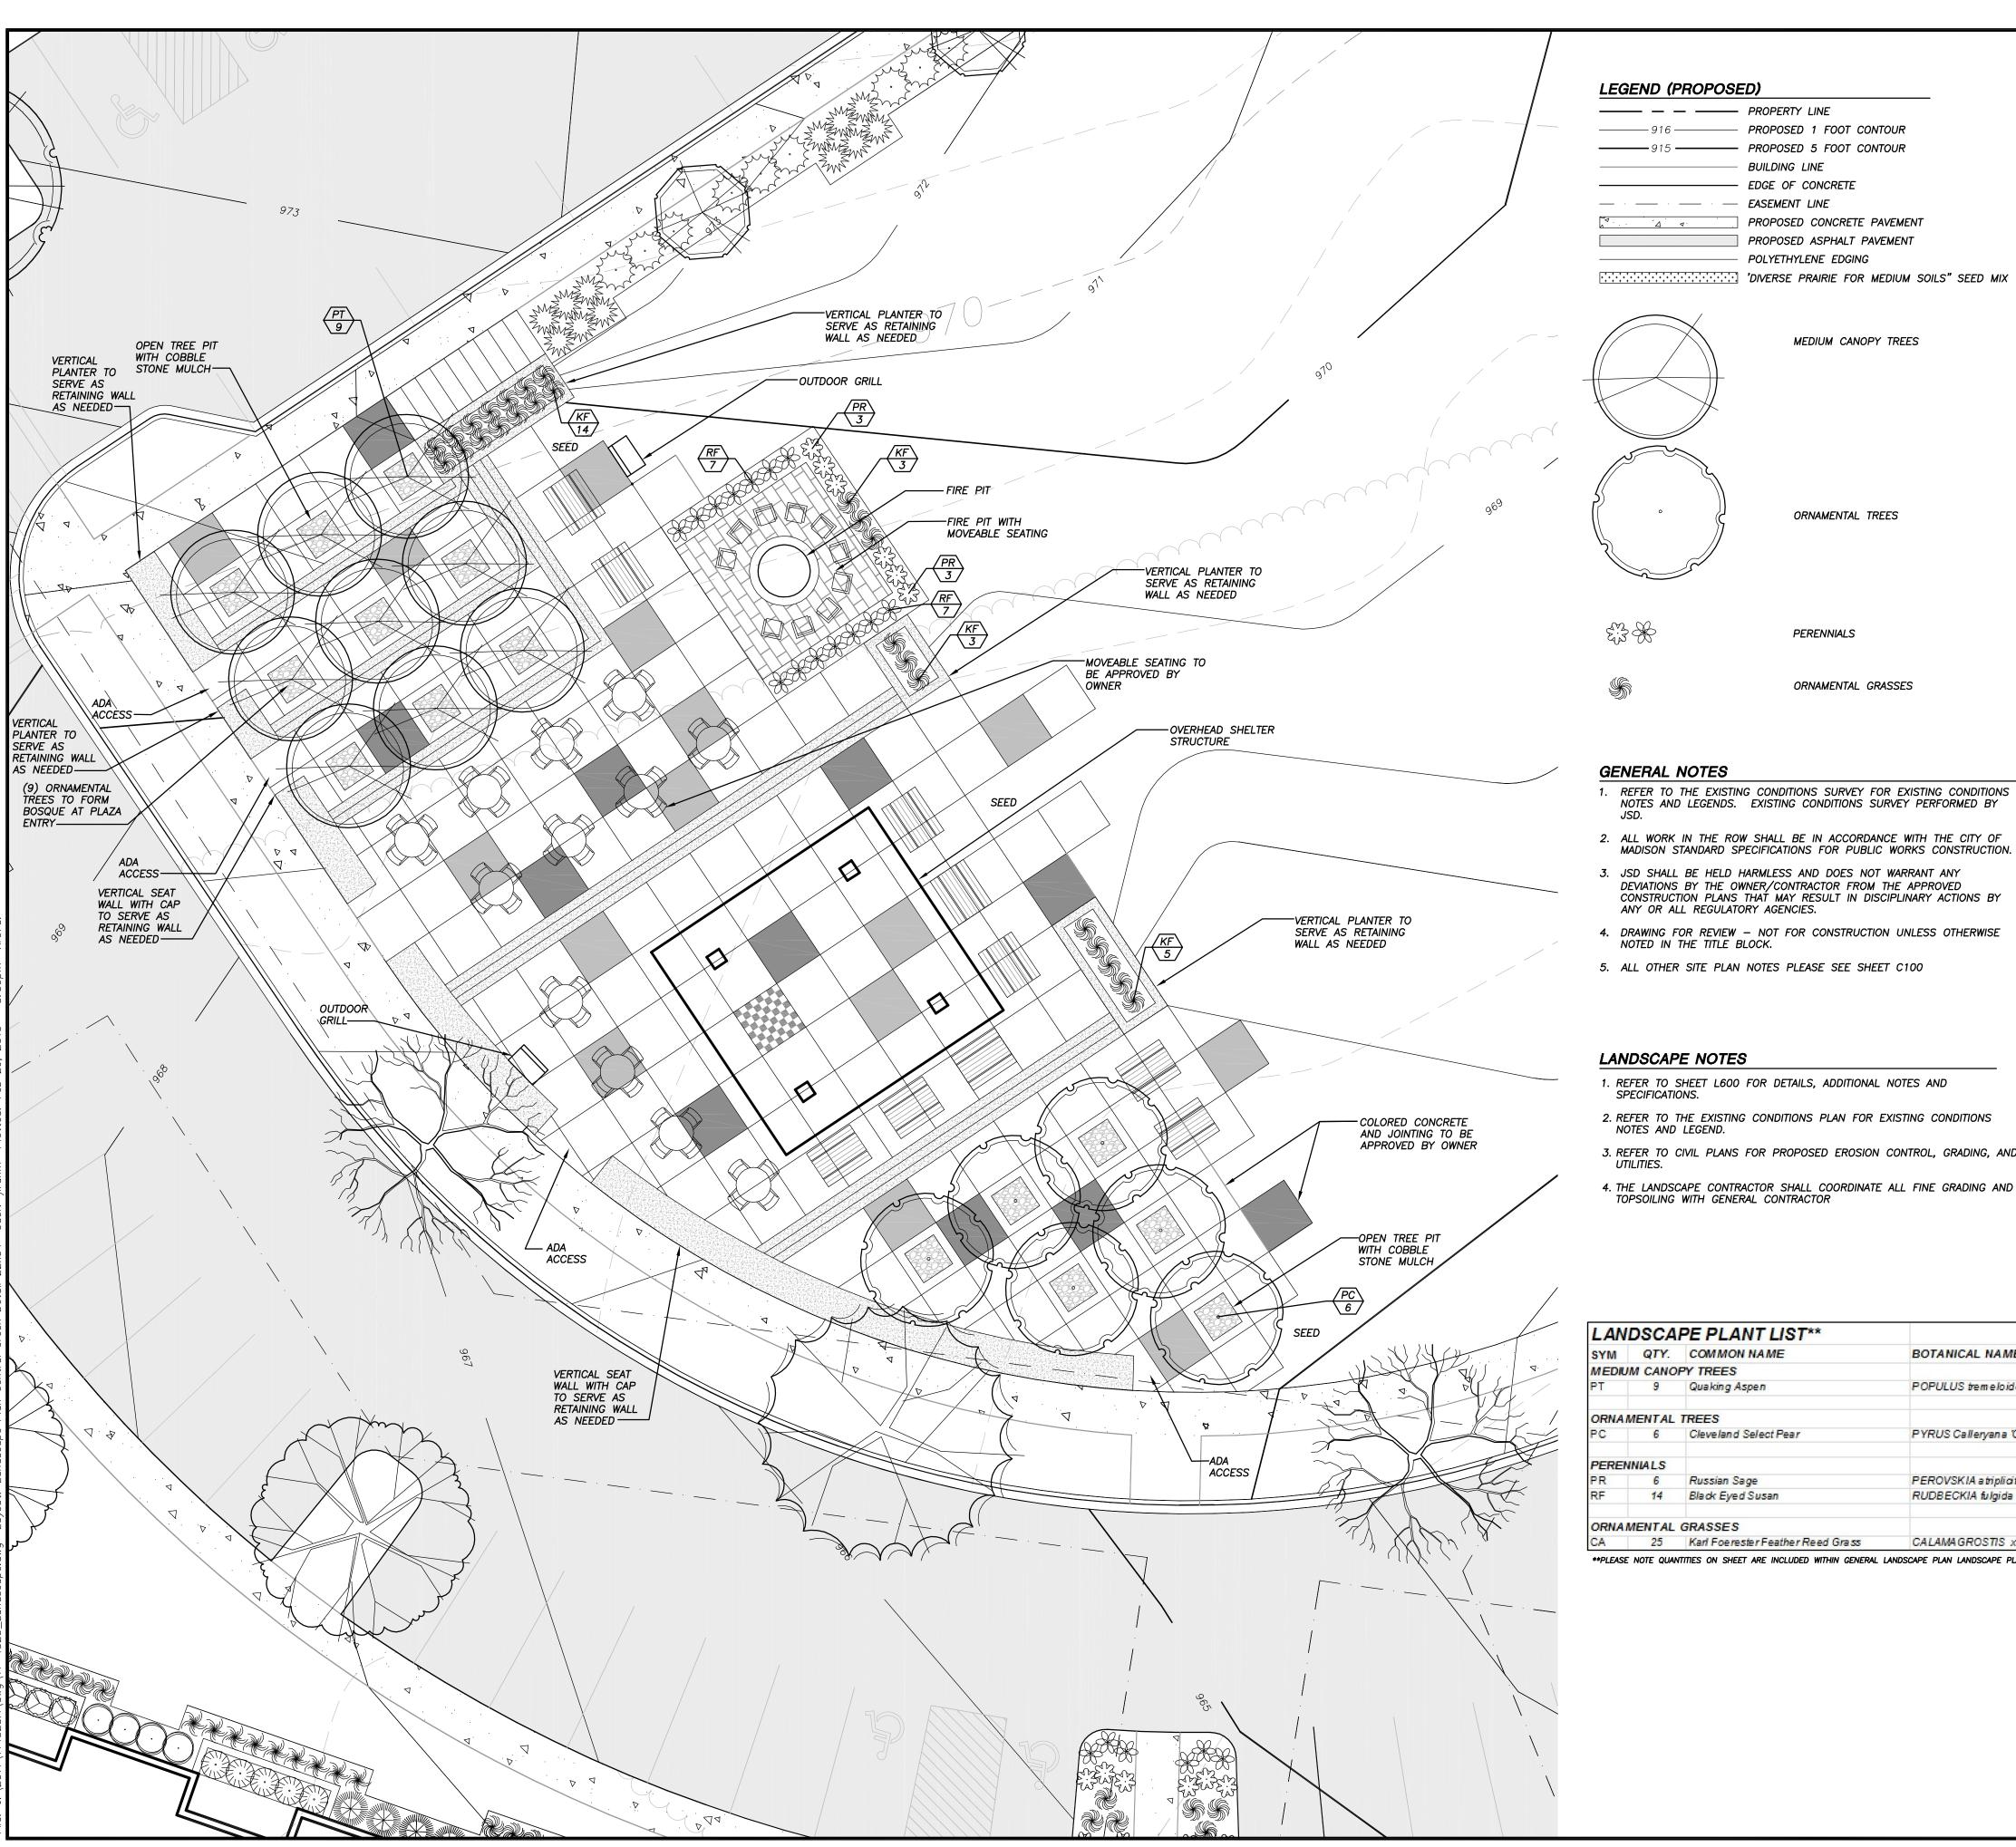
10-31-12 10-31-12

DATE: 11-28-12 01-02-13 02-27-13

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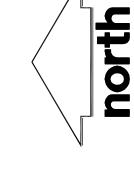




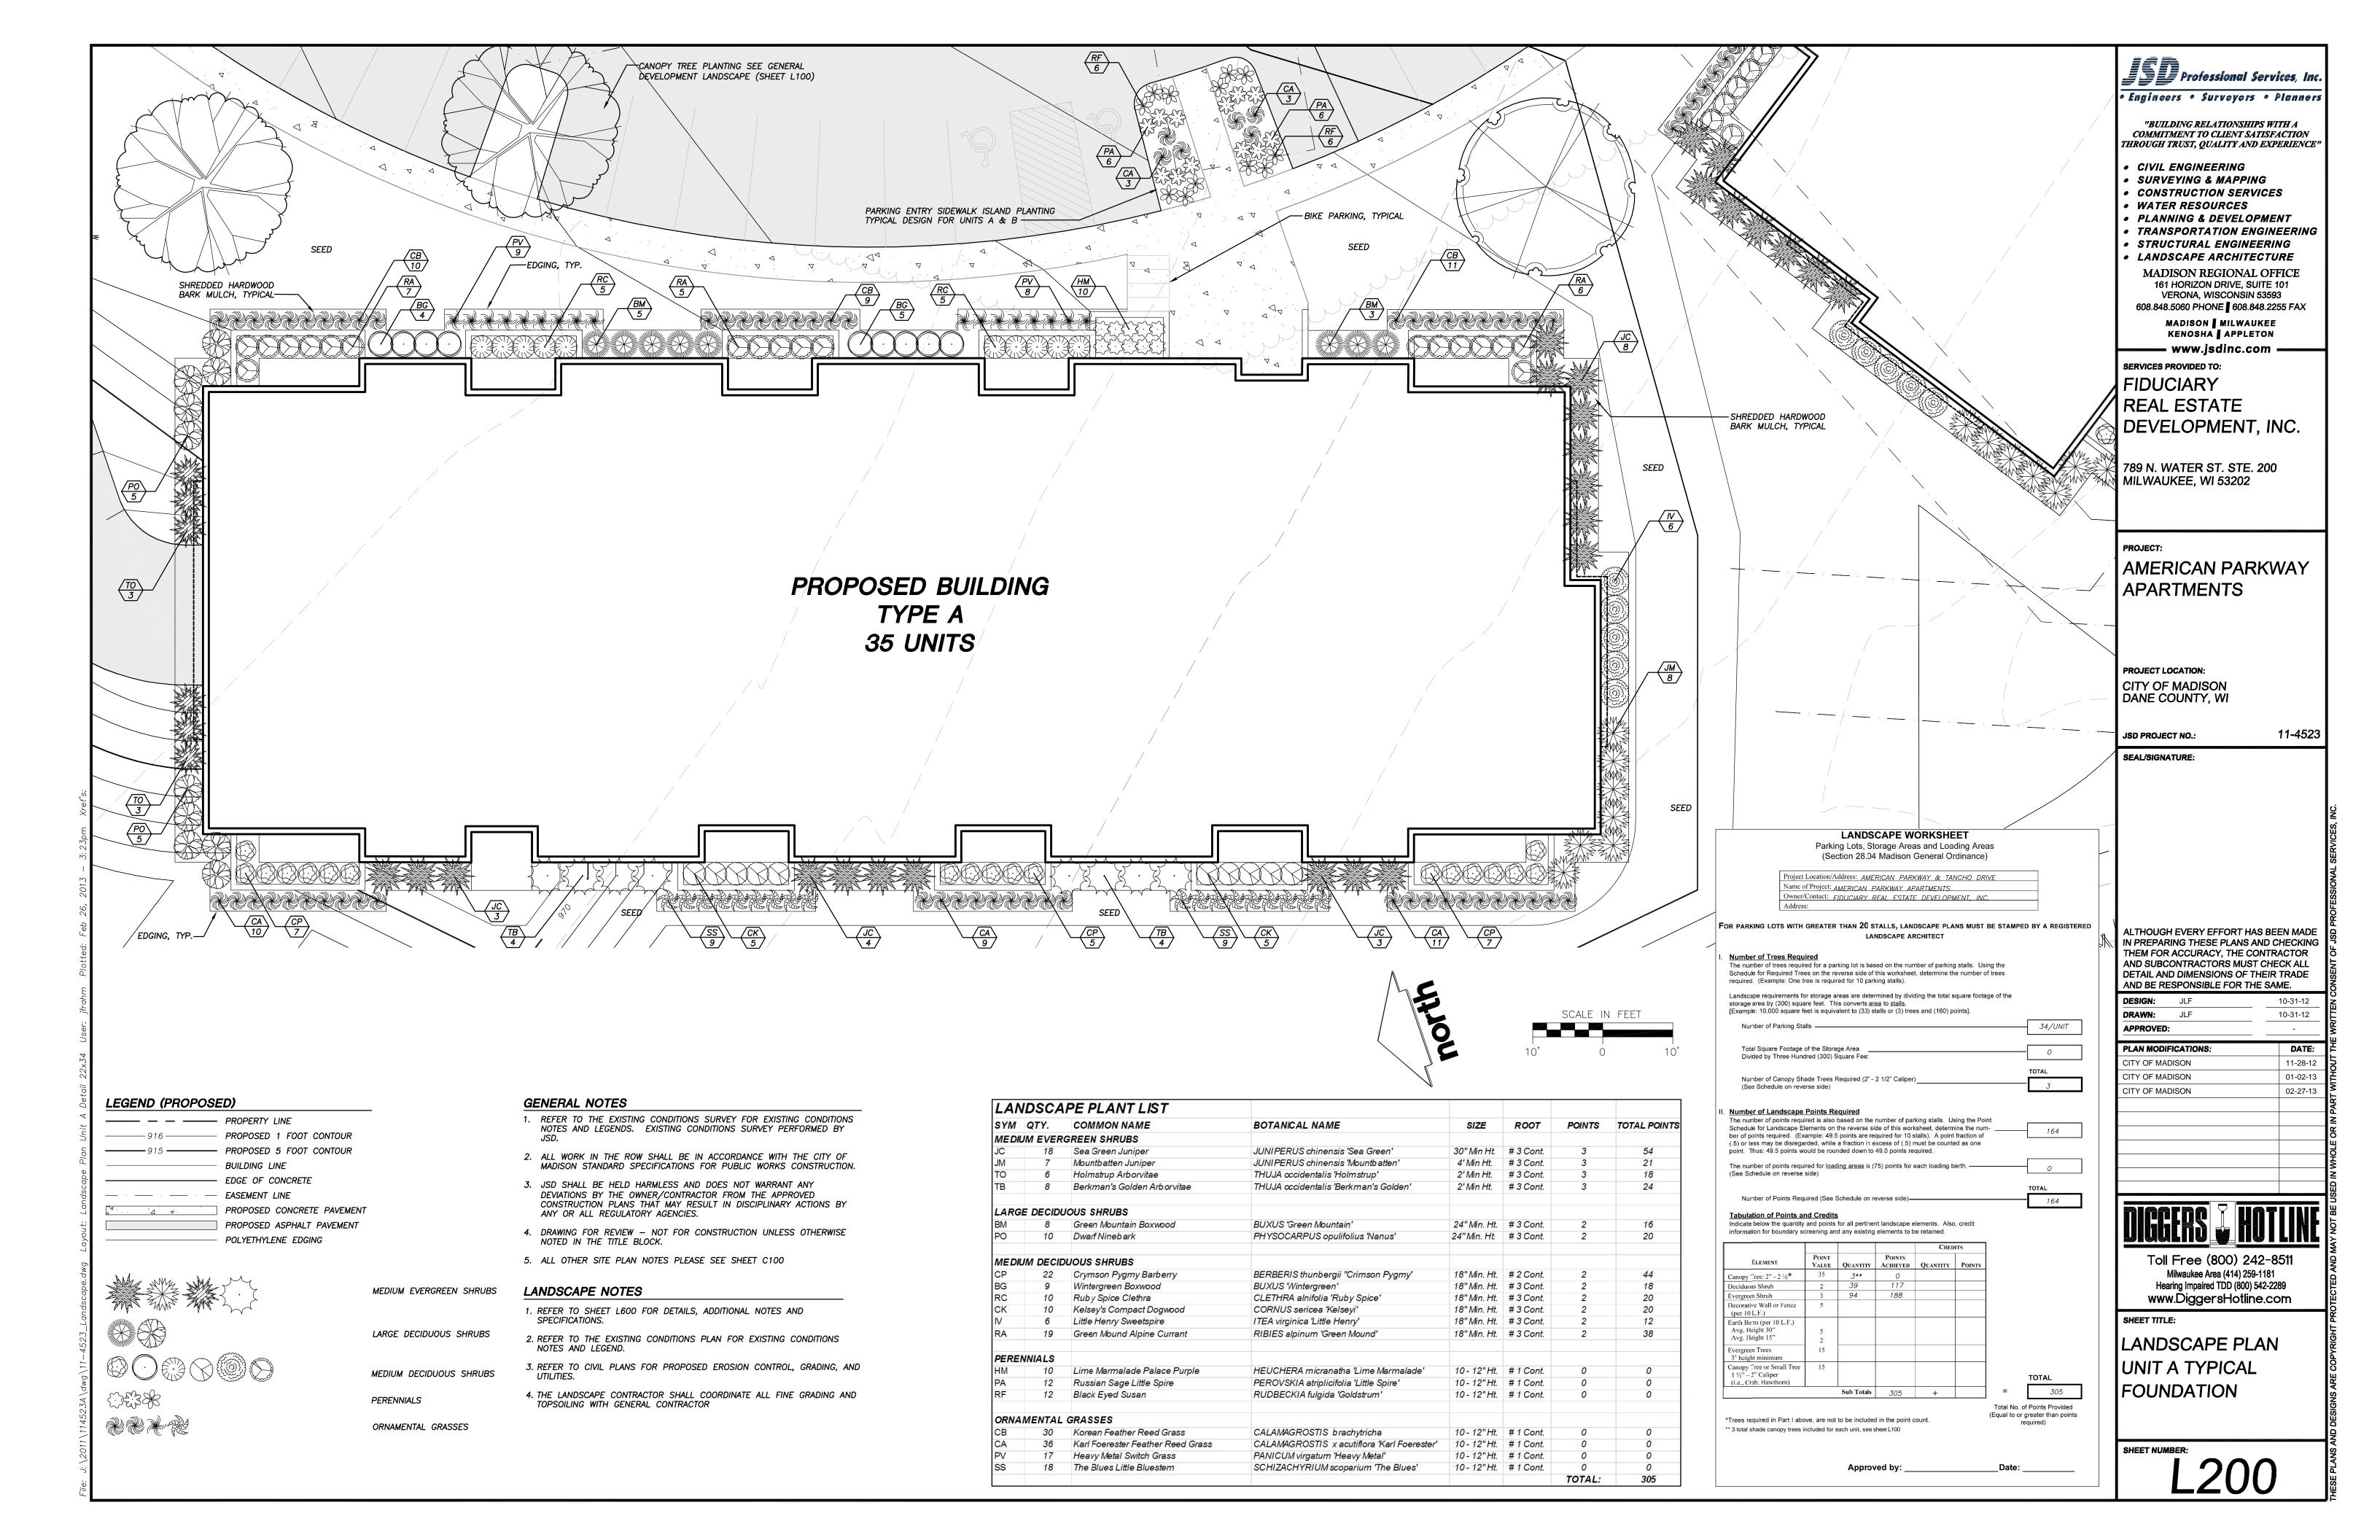

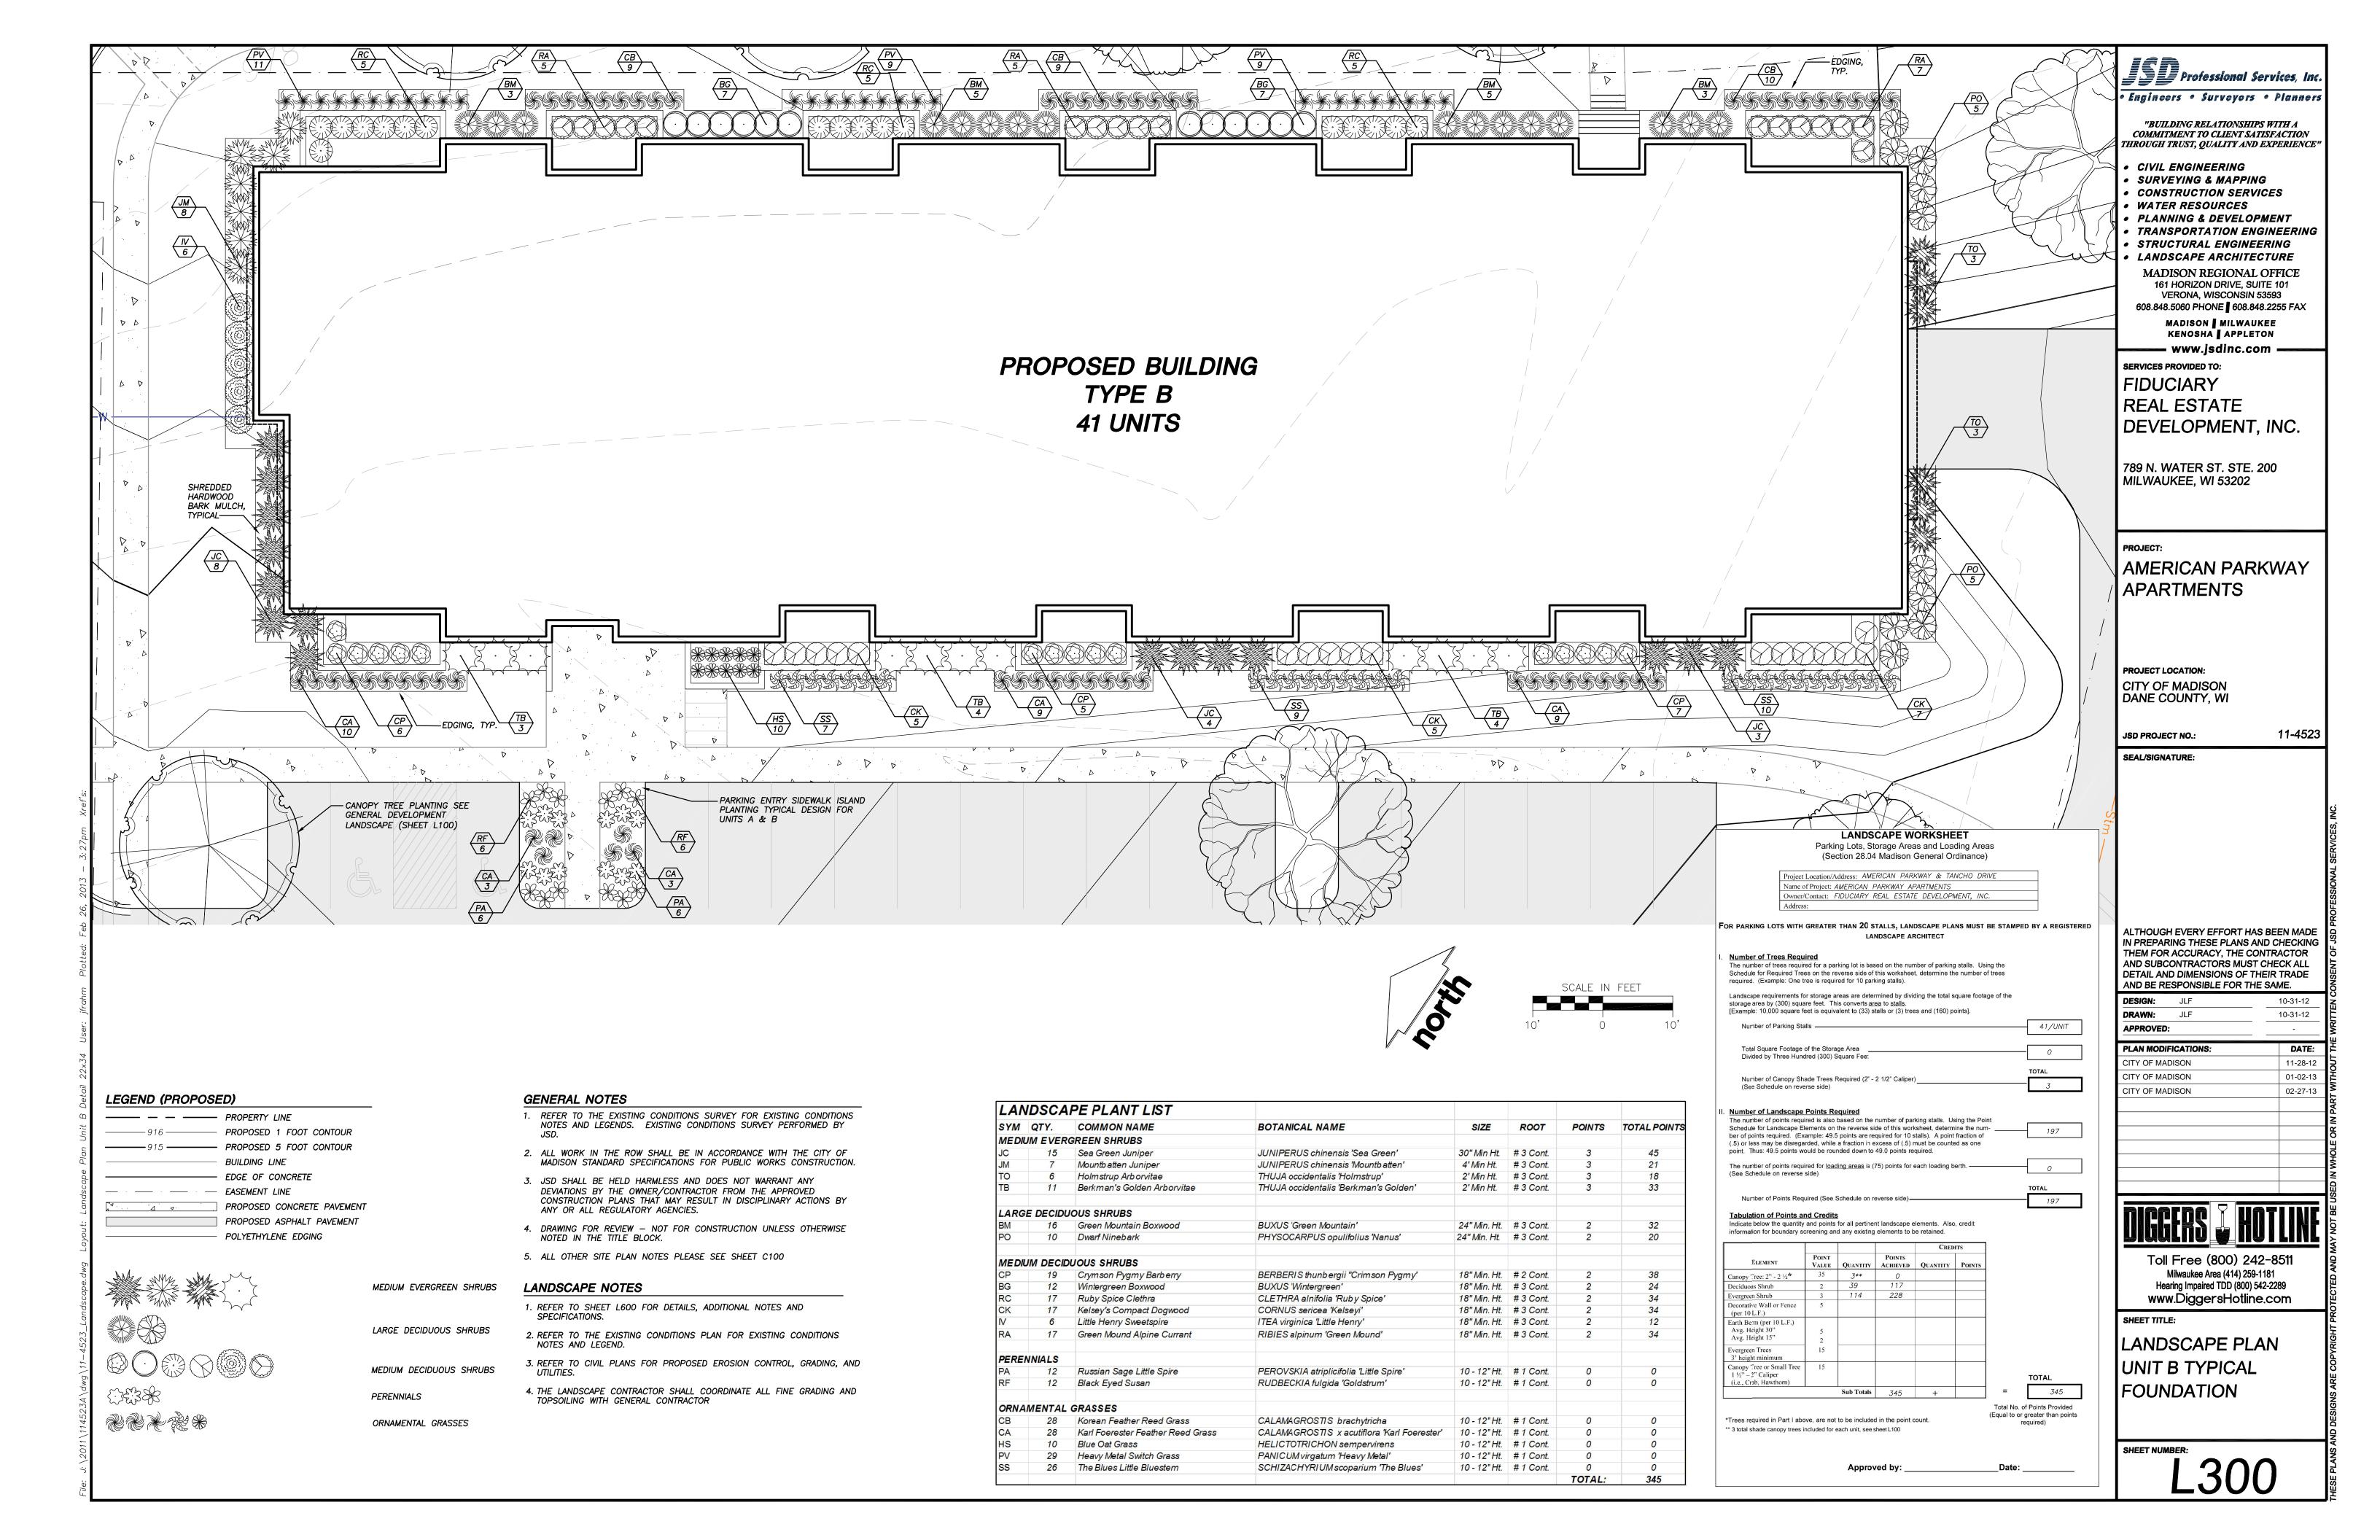LEGEND (PROPOSED)

----- PROPERTY LINE ----- PROPOSED 1 FOOT CONTOUR 915 — PROPOSED 5 FOOT CONTOUR BUILDING LINE — EDGE OF CONCRETE --- -- EASEMENT LINE PROPOSED CONCRETE PAVEMENT PROPOSED ASPHALT PAVEMENT - POLYETHYLENE EDGING





MEDIUM CANOPY TREES

ORNAMENTAL TREES

PERENNIALS

ORNAMENTAL GRASSES

# GENERAL NOTES

- 1. REFER TO THE EXISTING CONDITIONS SURVEY FOR EXISTING CONDITIONS NOTES AND LEGENDS. EXISTING CONDITIONS SURVEY PERFORMED BY
- ALL WORK IN THE ROW SHALL BE IN ACCORDANCE WITH THE CITY OF MADISON STANDARD SPECIFICATIONS FOR PUBLIC WORKS CONSTRUCTION.
- 3. JSD SHALL BE HELD HARMLESS AND DOES NOT WARRANT ANY DEVIATIONS BY THE OWNER/CONTRACTOR FROM THE APPROVED CONSTRUCTION PLANS THAT MAY RESULT IN DISCIPLINARY ACTIONS BY ANY OR ALL REGULATORY AGENCIES.
- 4. DRAWING FOR REVIEW NOT FOR CONSTRUCTION UNLESS OTHERWISE NOTED IN THE TITLE BLOCK.
- 5. ALL OTHER SITE PLAN NOTES PLEASE SEE SHEET C100

# LANDSCAPE NOTES

- 1. REFER TO SHEET L600 FOR DETAILS, ADDITIONAL NOTES AND
- 2. REFER TO THE EXISTING CONDITIONS PLAN FOR EXISTING CONDITIONS NOTES AND LEGEND.
- 3. REFER TO CIVIL PLANS FOR PROPOSED EROSION CONTROL, GRADING, AND
- 4. THE LANDSCAPE CONTRACTOR SHALL COORDINATE ALL FINE GRADING AND TOPSOILING WITH GENERAL CONTRACTOR

| LAN   | DSCA    | PE PLANT LIST**                   |  |             |           |        |              |
|-------|---------|-----------------------------------|--|-------------|-----------|--------|--------------|
| SYM   | QTY.    | COMMON NAME                       | BOTANICAL NAME                               | SIZE        | ROOT      | POINTS | TOTAL POINTS |
| MEDIL | JM CANO | PY TREES                          |  |             |           |        |              |
| PT    | 9       | Quaking Aspen                     | POPULUS tremeloides                          | 2" Cal.     | B&B       | 0      | 0            |
| ORNA  | MENTAL  | TREES                             |  |             |           |        |              |
| PC    | 6       | Cleveland Select Pear             | PYRUS Calleryana 'Cleveland Select'          | 2 1/2" Cal. | B&B       | 15     | 135          |
| PEREI | NNIALS  |                                   |  |             |           |        |              |
| PR    | 6       | Russian Sage                      | PEROVSKIA atriplicifolia                     | 10 - 12"Ht. | # 1 Cont. | 0      | 0            |
| RF    | 14      | Black Eyed Susan                  | RUDBECKIA fulgida 'Goldstrum'                | 10 - 12"Ht. | # 1 Cont. | 0      | 0            |
| ORNA  | MENTAL  | GRASSES                           |  |             |           |        |              |
| CA    | 25      | Karl Foerester Feather Reed Grass | CALAMAGROSTIS x a cutiflora 'Karl Foerester' | 10 - 12"Ht. | # 1 Cont. | 0      | 0            |

\*\*PLEASE NOTE QUANTITIES ON SHEET ARE INCLUDED WITHIN GENERAL LANDSCAPE PLAN LANDSCAPE PLANT LIST



"BUILDING RELATIONSHIPS WITH A COMMITMENT TO CLIENT SATISFACTION THROUGH TRUST, QUALITY AND EXPERIENCE"

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MADISON REGIONAL OFFICE 161 HORIZON DRIVE, SUITE 101 VERONA, WISCONSIN 53593

608.848.5060 PHONE 608.848.2255 FAX MADISON MILWAUKEE KENOSHA APPLETON

— www.jsdinc.com —

SERVICES PROVIDED TO: **FIDUCIARY** REAL ESTATE DEVELOPMENT, INC.

789 N. WATER ST. STE. 200 MILWAUKEE, WI 53202

PROJECT:

**AMERICAN PARKWAY** APARTMENTS

11-4523

PROJECT LOCATION: CITY OF MADISON DANE COUNTY, WI

SEAL/SIGNATURE:

JSD PROJECT NO.:

ALTHOUGH EVERY EFFORT HAS BEEN MADE IN PREPARING THESE PLANS AND CHECKING THEM FOR ACCURACY, THE CONTRACTOR AND SUBCONTRACTORS MUST CHECK ALL DETAIL AND DIMENSIONS OF THEIR TRADE AND BE RESPONSIBLE FOR THE SAME.

DESIGN: JLF 10-31-12 10-31-12 DRAWN: JLF APPROVED:


PLAN MODIFICATIONS: DATE: 11-28-12 CITY OF MADISON CITY OF MADISON 01-02-13 CITY OF MADISON 02-27-13





Toll Free (800) 242-8511 Milwaukee Area (414) 259-1181 Hearing Impaired TDD (800) 542-2289 www.DiggersHotline.com

SHEET TITLE:

LANDSCAPE PLAN CENTRAL GREEN DETAIL

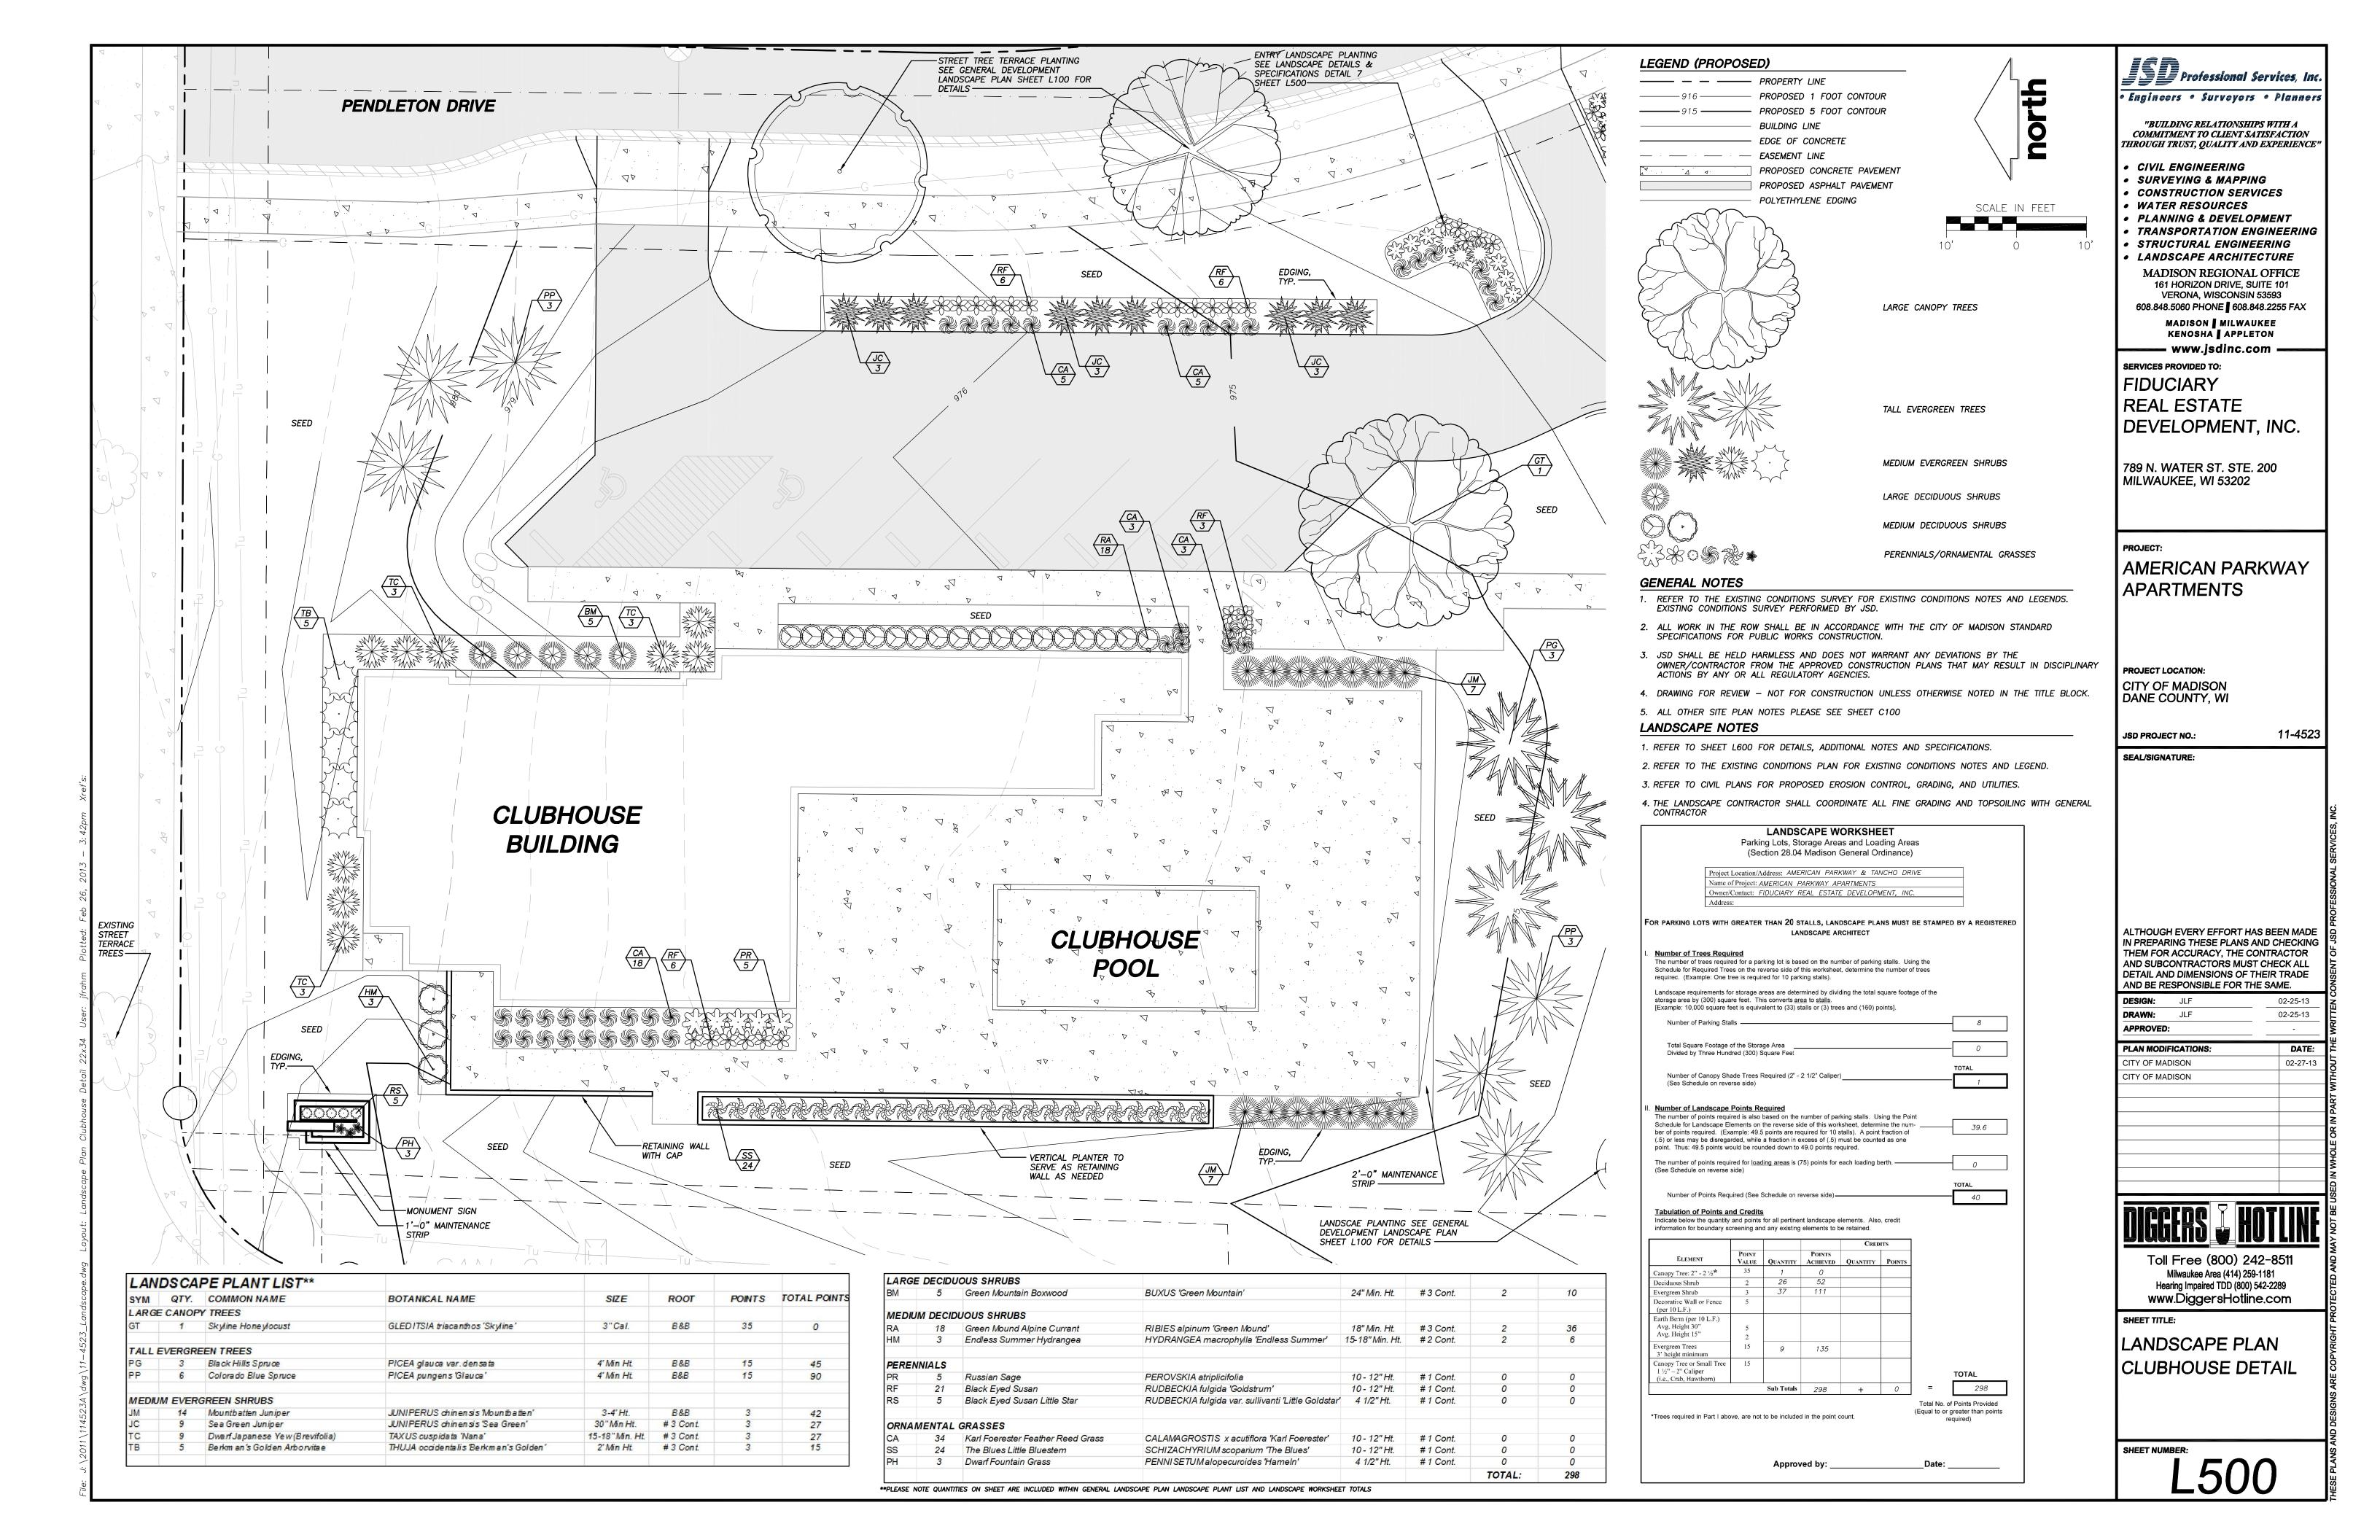

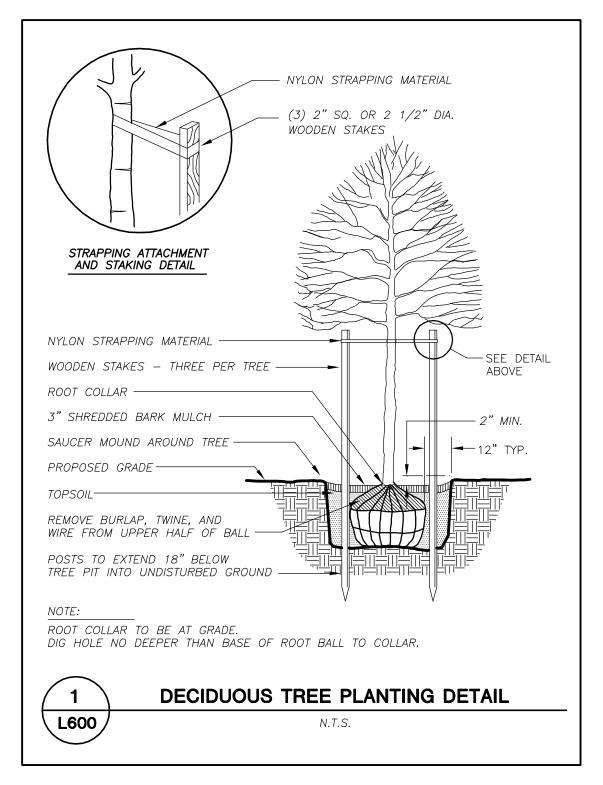

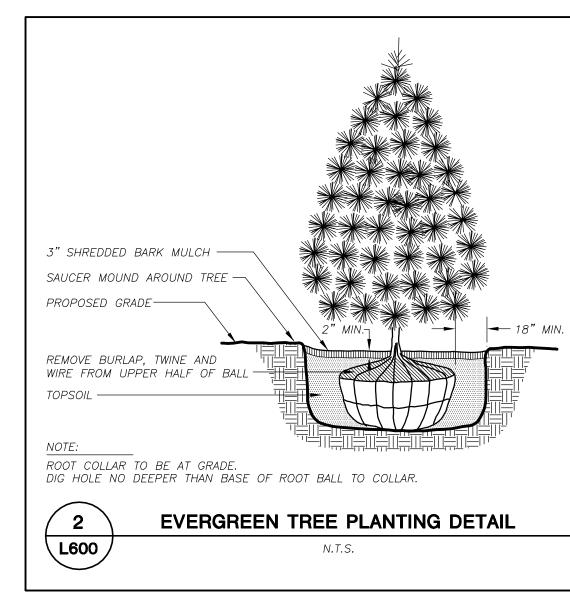



# LANDSCAPE NOTES & SPECIFICATIONS


- 1. GENERAL: ALL WORK IN THE R-O-W AND PUBLIC EASEMENTS SHALL BE IN ACCORDANCE WITH THE CITY OF MADISON REQUIREMENTS. JSD SHALL BE HELD HARMLESS AND DOES NOT WARRANT ANY DEVIATIONS BY THE OWNER/CONTRACTOR FROM THE APPROVED CONSTRUCTION PLANS THAT MAY RESULT IN DISCIPLINARY ACTIONS BY ANY OR ALL REGULATORY AGENCIES. LOCATE ALL UTILITIES PRIOR TO CONSTRUCTION. THE CONTRACTOR IS RESPONSIBLE FOR REPAIRING ANY DAMAGE DONE TO UTILITIES. CONTRACTOR MUST CALL 1-800-382-5544 FOR UTILITY LOCATIONS AT LEAST THREE DAYS PRIOR TO DIGGING. HAND DIG AND INSTALL ALL PLANTS THAT ARE NEAR EXISTING UTILITIES. PROTECT PREVIOUSLY INSTALLED WORK OF OTHER TRADES. CONTRACTOR IS RESPONSIBLE FOR STAKING THE PLANT MATERIALS FOR REVIEW BY OWNER PRIOR TO DIGGING AND PLACEMENT. THE LANDSCAPE CONTRACTOR SHALL COORDINATE ALL FINE GRADING AND RESTORATION WITH THE GRADING CONTRACTOR.
- 2. DELIVERY AND HANDLING: DO NOT DELIVER MORE PLANT MATERIALS THAN CAN BE PLANTED IN ONE DAY. DELIVER PLANTS WITH LEGIBLE IDENTIFICATION LABELS. PROTECT PLANTS DURING DELIVERY AND DO NOT PRUNE PRIOR TO DELIVERY. ALL TREES AND SHRUBS SHALL BE PLANTED ON THE DAY OF DELIVERY; IF THIS IS NOT POSSIBLE, PROTECT THAT STOCK NOT PLANTED BY STORING STOCK IN A SHADED AREA PROTECTING THE ROOT MASS WITH WET SOIL, MOSS OR OTHER SUITABLE MEDIA AND KEEPING WELL WATERED. DO NOT REMOVE CONTAINER GROWN STOCK FROM CONTAINERS BEFORE TIME OF PLANTING. DO NOT PICK UP CONTAINER OR BALLED PLANTS BY STEM OR ROOTS. ALL PLANTS SHALL BE LIFTED AND HANDLED FROM THE BOTTOM OF THE BALL. PERFORM ACTUAL PLANTING ONLY WHEN WEATHER AND SOIL CONDITIONS ARE SUITABLE IN ACCORDANCE WITH LOCALLY ACCEPTED PRACTICES.
- 3. GUARANTEE: THE CONTRACTOR SHALL GUARANTEE ALL PLANTS THROUGH ONE (1) YEAR AFTER ACCEPTANCE BY OWNER. PLANTS SHALL BE ALIVE AND IN GOOD HEALTHY AND FLOURISHING CONDITION AT THE END OF THE GUARANTEE PERIOD. THE CONTRACTOR SHALL REPLACE WITHOUT COST TO THE OWNER ANY PLANTS THAT ARE DEAD OR NOT IN A VIGOROUS THRIVING CONDITION. REPLACEMENT PLANTS SHALL BE OF THE SAME KIND AND SIZE AS ORIGINALLY SPECIFIED UNLESS OTHERWISE DIRECTED BY OWNER. RESTORE BEDS AS NECESSARY FOLLOWING PLANT REPLACEMENT, INCLUDING BUT NOT LIMITED TO BEDS, EDGING, MULCH, GRASS, ETC. REPAIR DAMAGE TO OTHER PLANTS OR LAWNS DURING PLANT REPLACEMENT AT NO COST TO OWNER. CONTRACTOR SHALL PROVIDE A TWO (2)—YEAR STRAIGHTENING GUARANTEE FOR ALL TREES.
- 4. MATERIALS PLANTS: ALL PLANTS SHALL CONFORM TO THE AMERICAN STANDARD FOR NURSERY STOCK ANSI Z60.1—2004. PLANTS SHALL BE TRUE TO SPECIES AND VARIETY SPECIFIED AND NURSERY GROWN IN ACCORDANCE WITH GOOD HORTICULTURAL PRACTICES UNDER CLIMATIC CONDITIONS SIMILAR TO THOSE IN THE LOCALITY OF THE PROJECT FOR AT LEAST 2 YEARS. PLANTS SHALL BE FRESHLY DUG (DURING THE MOST RECENT FAVORABLE HARVEST SEASON). PLANTS SHALL BE SO TRAINED IN DEVELOPMENT AND APPEARANCE AS TO BE UNQUESTIONABLY SUPERIOR IN FORM, COMPACTNESS, AND SYMMETRY. PLANTS SHALL BE SOUND, HEALTHY, VIGOROUS, WELL BRANCHED AND DENSELY FOLIATED WHEN IN LEAF, AND FREE OF DISEASE AND INSECTS (ADULT EGGS, PUPAE OR LARVAE). THEY SHALL HAVE HEALTHY, WELL—DEVELOPED ROOT SYSTEMS AND SHALL BE FREE FROM PHYSICAL DAMAGE OR OTHER CONDITIONS THAT WOULD PREVENT THRIVING GROWTH. PLANTS SHALL BE OF THE HIGHEST QUALITY, HAVE TYPICAL GROWTH HABITS FOR THEIR SPECIES, BE SOUND, HEALTHY, VIGOROUS AND FREE OF INJURY. PARKWAY TREES AND PARKING LOT TREES SHALL HAVE A MINIMUM BRANCHING HEIGHT OF SIX (6) FEET ABOVE THE GROUND TO ALLOW ADEQUATE VISUAL AND PHYSICAL CLEARANCE.
- 5. MATERIALS SOIL: PLANTING SOIL/COMPACTED TOPSOIL SHALL MEET THESE REQUIREMENTS:
- SEEDED AREAS = 7"
   PARKING ISLANDS = 20"
- 3. TREE RINGS AND PITS = SEE DETAILS

PLANTING SOIL TO BE A MINIMUM 6" DEPTH, UNLESS OTHERWISE SPECIFIED AS ABOVE OR ON DETAILS. TOPSOIL TO BE CLEAN, FRIABLE LOAM FROM LOCAL SOURCE, FREE FROM STONES OR DEBRIS OVER 3/4" IN DIAMETER, AND FREE FROM TOXINS. TOPSOIL SHALL HAVE A PH BETWEEN 6 AND 7. TOPSOIL AND PLANTING SOIL SHALL BE TESTED TO CONFORM TO THESE SPECIFICATIONS AND SHALL BE AMENDED TO MEET THESE SPECIFICATIONS. DO NOT PLACE FROZEN OR MUDDY TOPSOIL. APPLY SOIL AMENDMENTS TO ALL LANDSCAPE BEDS PER SOIL TEST.

- 6. MATERIALS EDGING: EDGING SHALL BE 5" DEEP, BLACK, POLYETHYLENE EDGING EXCEPT FOR TREE RINGS. ALL DECIDUOUS, ORNAMENTAL TREES NOT WITHIN EDGED LANDSCAPE BEDS SHALL BE INSTALLED WITH A 5' DIAMETER TREE RING WITH SHOVEL CUT EDGING 5" IN DEPTH.
- 7. SEEDING: ALL DISTURBED AREAS SHALL BE SEEDED AS SPECIFIED IN THESE NOTES.
- 8. MATERIALS SEED: ALL LAWN SEED SHALL BE EARTH CARPET'S 'BOULEVARD' OR OWNER APPROVED EQUIVALENT AS APPROVED BY THE OWNER'S REPRESENTATIVE, INSTALLED PER MANUFACTURER'S RECOMMENDATIONS. IN ADDITION TO LAWN SEED, ANNUAL RYE SHALL BE APPLIED TO ALL DISTURBED AREAS AT A RATE OF 1 1/2 LBS PER 1000 SQUARE FEET. FERTILIZE AND MULCH PER MANUFACTURER'S RECOMMENDATIONS.
- 9. MATERIALS SEED: BIORETENTION AREA DESIGNATED TO RECEIVE PRAIRIE SEED MIX IS TO BE SEEDED WITH "DIVERSE PRAIRIE FOR MEDIUM SOILS" SEED MIX (ITEM NO. 50012) AS
  PROVIDED BY PRAIRIE NURSERY, P.O. BOX 306, WESTFIELD, WISCONSIN, 53964, TEL. 608—296—3679. INSTALL SEED WITH SUPPLEMENTAL MATERIALS AND AMENDMENTS AS RECOMMENDED BY
  SEED SUPPLIER AND AT RATES AND OPTIMUM TIMES OF THE YEAR AS RECOMMENDED BY THE SEED SUPPLIER TO ENSURE SUCCESSFUL GERMINATION AND SEED/ROOT ZONE GROWTH
  DEVELOPMENT.
- 10. MATERIALS FERTILIZER AND MULCH: TREE RINGS AND BIORETENTION AREA SHALL RECEIVE 3" DEPTH, FINELY SHREDDED, WEED FREE, HARDWOOD BARK MULCH (DYE—FREE) OVER ENTIRE BED, UNLESS OTHERWISE SPECIFIED ON PLANS. FERTILIZER SHALL BE IN ACCORDANCE WITH APPLICABLE LOCAL, COUNTY AND STATE OF WISCONSIN REQUIREMENTS.
- 11. MATERIALS FERTILIZER AND MULCH: PARKING ISLAND AREAS ONLY SHALL RECEIVE 1 ½ INCH DECORATIVE WASHED STONE SPREAD TO A DEPTH OF THREE INCHES. OWNER SHALL APPROVE COLOR, TEXTURE AND SIZE EXAMPLE PRIOR TO INSTALLATION. AN APPROVED PROFESSIONAL GRADE WOVEN FABRIC WEED BARRIER SHALL BE INSTALLED PRIOR TO MULCH INSTALLATION. NO PLASTIC (IMPERVIOUS BARRIERS ACCEPTED) EX. BLACK VISQUEEN. FERTILIZER SHALL BE IN ACCORDANCE WITH APPLICABLE LOCAL, COUNTY AND STATE OF WISCONSIN REQUIREMENTS.
- 12. MATERIALS FERTILIZER AND MULCH: ALL PLANTING BED AREAS SHALL RECEIVE 1 ½ INCH DECORATIVE WASHED STONE SPREAD TO A DEPTH OF THREE INCHES. OWNER SHALL APPROVE COLOR, TEXTURE AND SIZE EXAMPLE PRIOR TO INSTALLATION. AN APPROVED PROFESSIONAL GRADE WOVEN FABRIC WEED BARRIER SHALL BE INSTALLED PRIOR TO MULCH INSTALLATION. NO PLASTIC (IMPERVIOUS BARRIERS ACCEPTED) EX. BLACK VISQUEEN. FERTILIZER SHALL BE IN ACCORDANCE WITH APPLICABLE LOCAL, COUNTY AND STATE OF WISCONSIN REQUIREMENTS.
- 13. PRUNING: THE CONTRACTOR SHALL PRUNE ALL TREES AND REPAIR ANY INJURIES THAT OCCURRED DURING THE PLANTING PROCESS. DOUBLE LEADERS, DEAD BRANCHES, AND LIMBS DAMAGED OR BROKEN DURING THE PLANTING PROCESS SHALL BE PRUNED. THIS SHALL BE THE ONLY PRUNING ALLOWED AT PLANTING. PRUNING SHALL CONFORM TO AMERICAN STANDARD FOR TREE CARE OPERATIONS, ANSI A300. PRUNE TREES IN ACCORDANCE WITH NAA GUIDELINES. DO NOT TOP TREES. PRUNE SHRUBS ACCORDING TO STANDARD HORTICULTURAL PRACTICES. ON CUTS OVER 3/4" IN DIAMETER AND BRUISES OR SCARS ON BARK, TRACE THE INJURED CAMBIUM LAYER BACK TO LIVING TISSUE AND REMOVE. SMOOTH AND SHAPE WOUNDS SO AS NOT TO RETAIN WATER AND COAT THE TREATED AREA WITH AN APPROVED ANTISEPTIC TREE PAINT.
- 14. CLEANUP: DISPOSE OF EXCESS SOIL. REMOVE ALL CUTTINGS AND WASTE MATERIALS. SOIL, BRANCHES, BINDING AND WRAPPING MATERIALS, REJECTED PLANTS, OR OTHER DEBRIS RESULTING FROM ANY PLANTING SHALL BE PROMPTLY CLEANED UP AND REMOVED. THE WORK AREA SHALL BE KEPT SAFE AND NEAT AT ALL TIMES UNTIL THE CLEANUP OPERATION IS COMPLETED. UNDER NO CONDITION SHALL THE ACCUMULATION OF SOIL, BRANCHES OR OTHER DEBRIS BE ALLOWED UPON A PUBLIC PROPERTY IN SUCH A MANNER AS TO RESULT IN A PUBLIC HAZARD. LIKEWISE, UNDER NO CIRCUMSTANCES SHALL ANY DEBRIS OR INCIDENTAL MATERIALS BE ALLOWED UPON ADJACENT PRIVATE PROPERTY.
- 15. MAINTENANCE: (CONTRACTOR) FOR ALL PLANTINGS, BUFFER AREAS AND SEEDED LAWN AREAS: THE CONTRACTOR SHALL MAINTAIN ALL PLANTINGS AND LAWN AREAS FOR AT LEAST A PERIOD OF 30 DAYS, OR UNTIL FINAL ACCEPTANCE FROM THE OWNER. THE CONTRACTOR IS RESPONSIBLE FOR ADEQUATELY WATERING PLANTS AND LAWN DURING THIS 30 DAY ESTABLISHMENT PERIOD. CONTRACTOR IS RESPONSIBLE FOR THE ESTABLISHMENT OF HEALTHY VIGOROUS PLANT MATERIALS AND LAWN/TURFGRASS GROWTH. CONTRACTOR IS ALSO RESPONSIBLE FOR ANY PRUNING OF PLANT MATERIALS, AND SHAPING AND/OR REPLACEMENT OF DEFICIENT BARK MULCH DURING THIS PERIOD. LONG TERM PLANT MATERIALS AND LAWN/TURFGRASS MAINTENANCE AND ANY PROGRAM FOR SUCH IS THE RESPONSIBILITY OF THE OWNER. ALL PLANTINGS AND LAWN'TURFGRASS AREAS SHALL BE MAINTAINED IN A MANICURED CONDITION.
- 16. MAINTENANCE: (OWNER) THE OWNER IS RESPONSIBLE FOR THE CONTINUED MAINTENANCE, REPAIR AND REPLACEMENT OF ALL LANDSCAPING MATERIALS AND BARRIERS AS NECESSARY FOLLOWING THE ONE (1) YEAR PLANT GUARANTEE PERIOD.

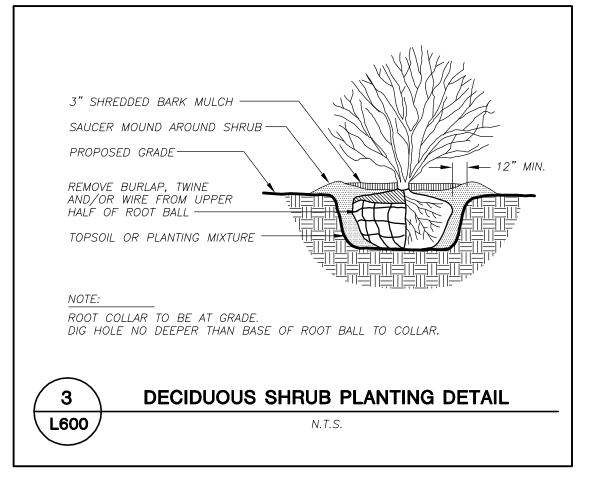


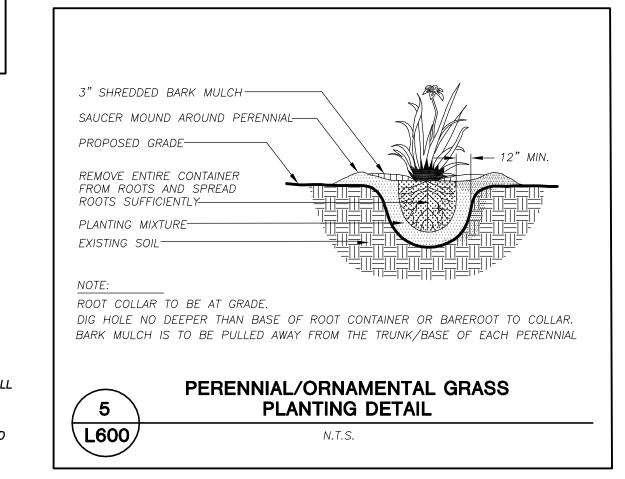


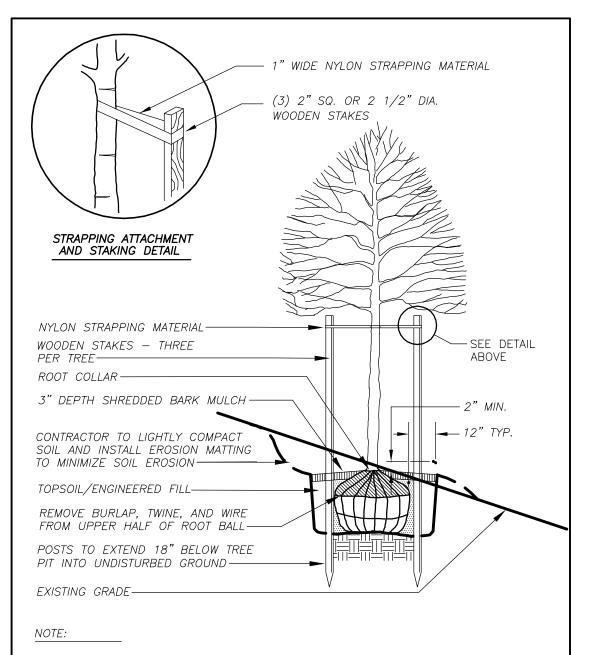


CONTRACTOR SHALL CREATE 'SHELF' IN SIDE OF SLOPE AS SHOWN FOR PLANTS INSTALLED IN BIORETENTION AREA ONLY.
 CONTRACTOR SHALL STABILIZE SOIL UPSLOPE OF SHELF TO MINIMIZE EROSION.
 ROOT COLLAR TO BE INSTALLED AT GRADE.
 CONFIRM THAT ROOT FLAIR IS EXPOSED.
 DIG HOLE NO DEEPER THAN BASE OF ROOT BALL TO COLLAR.



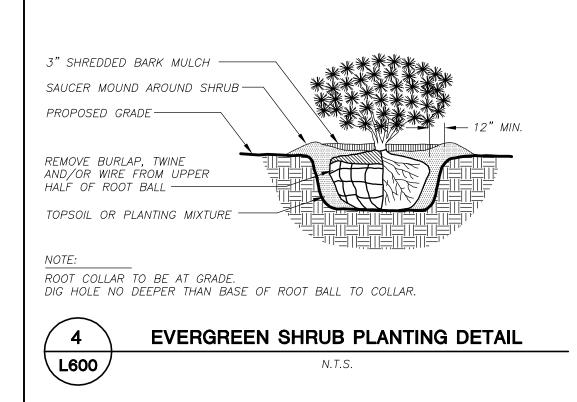

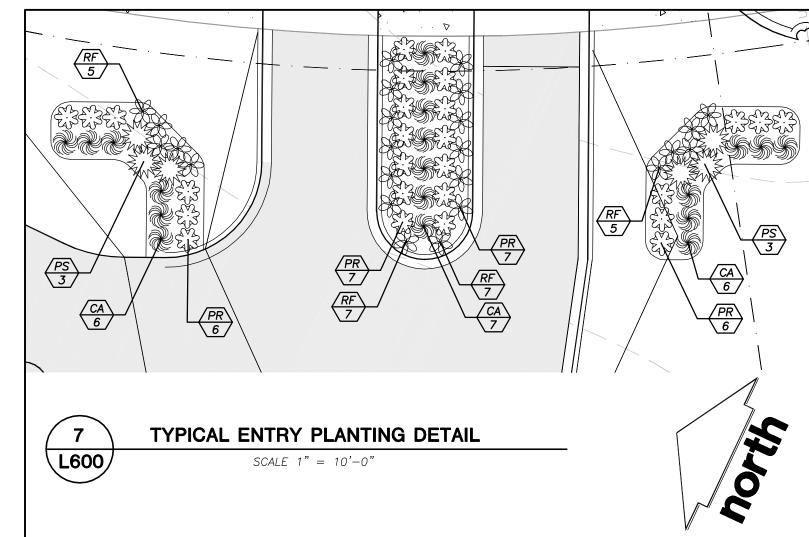

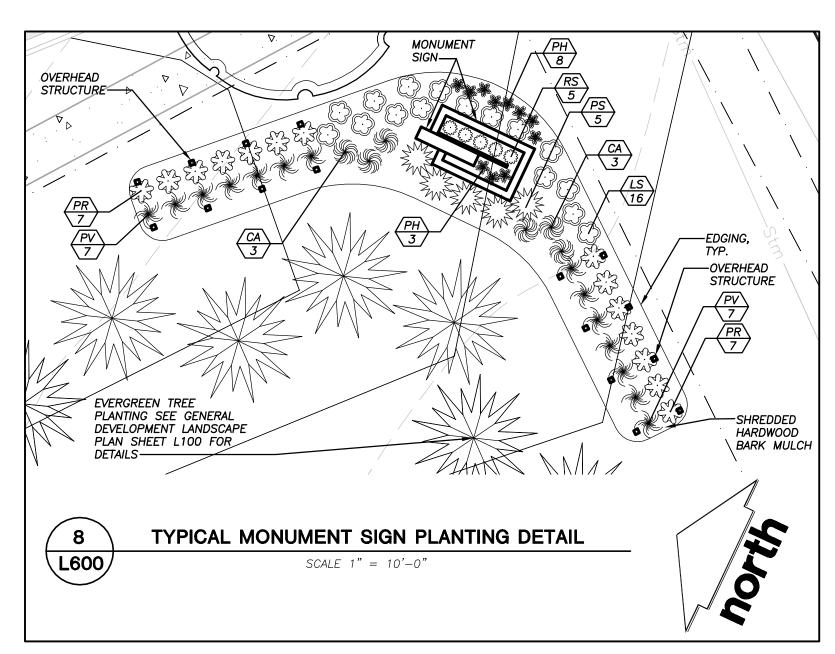



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- TRANSPORTATION ENGINEERING
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   LANDSCAPE ARCHITECTURE
   MADISON RECIONAL OFFICE

MADISON REGIONAL OFFICE

161 HORIZON DRIVE, SUITE 101

VERONA, WISCONSIN 53593

608.848.5060 PHONE ■ 608.848.2255 FAX

SERVICES PROVIDED TO:
FIDUCIARY
REAL ESTATE
DEVELOPMENT, INC.

789 N. WATER ST. STE. 200 MILWAUKEE, WI 53202

PROJECT:

AMERICAN PARKWAY APARTMENTS

PROJECT LOCATION:
CITY OF MADISON
DANE COUNTY WI

DANE COUNTY, WI

JSD PROJECT NO.: SEAL/SIGNATURE:

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11-4523

 DESIGN:
 JLF
 10-31-12

 DRAWN:
 JLF
 10-31-12

 APPROVED:

PLAN MODIFICATIONS:DATE:CITY OF MADISON11-28-12CITY OF MADISON01-02-13CITY OF MADISON02-27-13



Toll Free (800) 242-8511

Milwaukee Area (414) 259-1181


Hearing Impaired TDD (800) 542-2289


www.DiggersHotline.com


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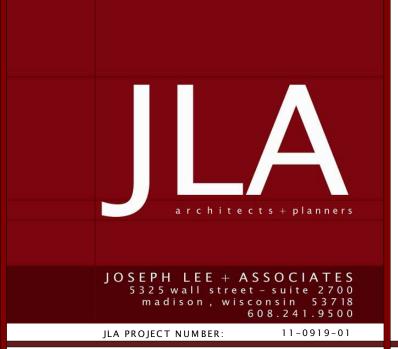
LANDSCAPE
DETAILS &
SPECIFICATIONS

HEET NUMBER:



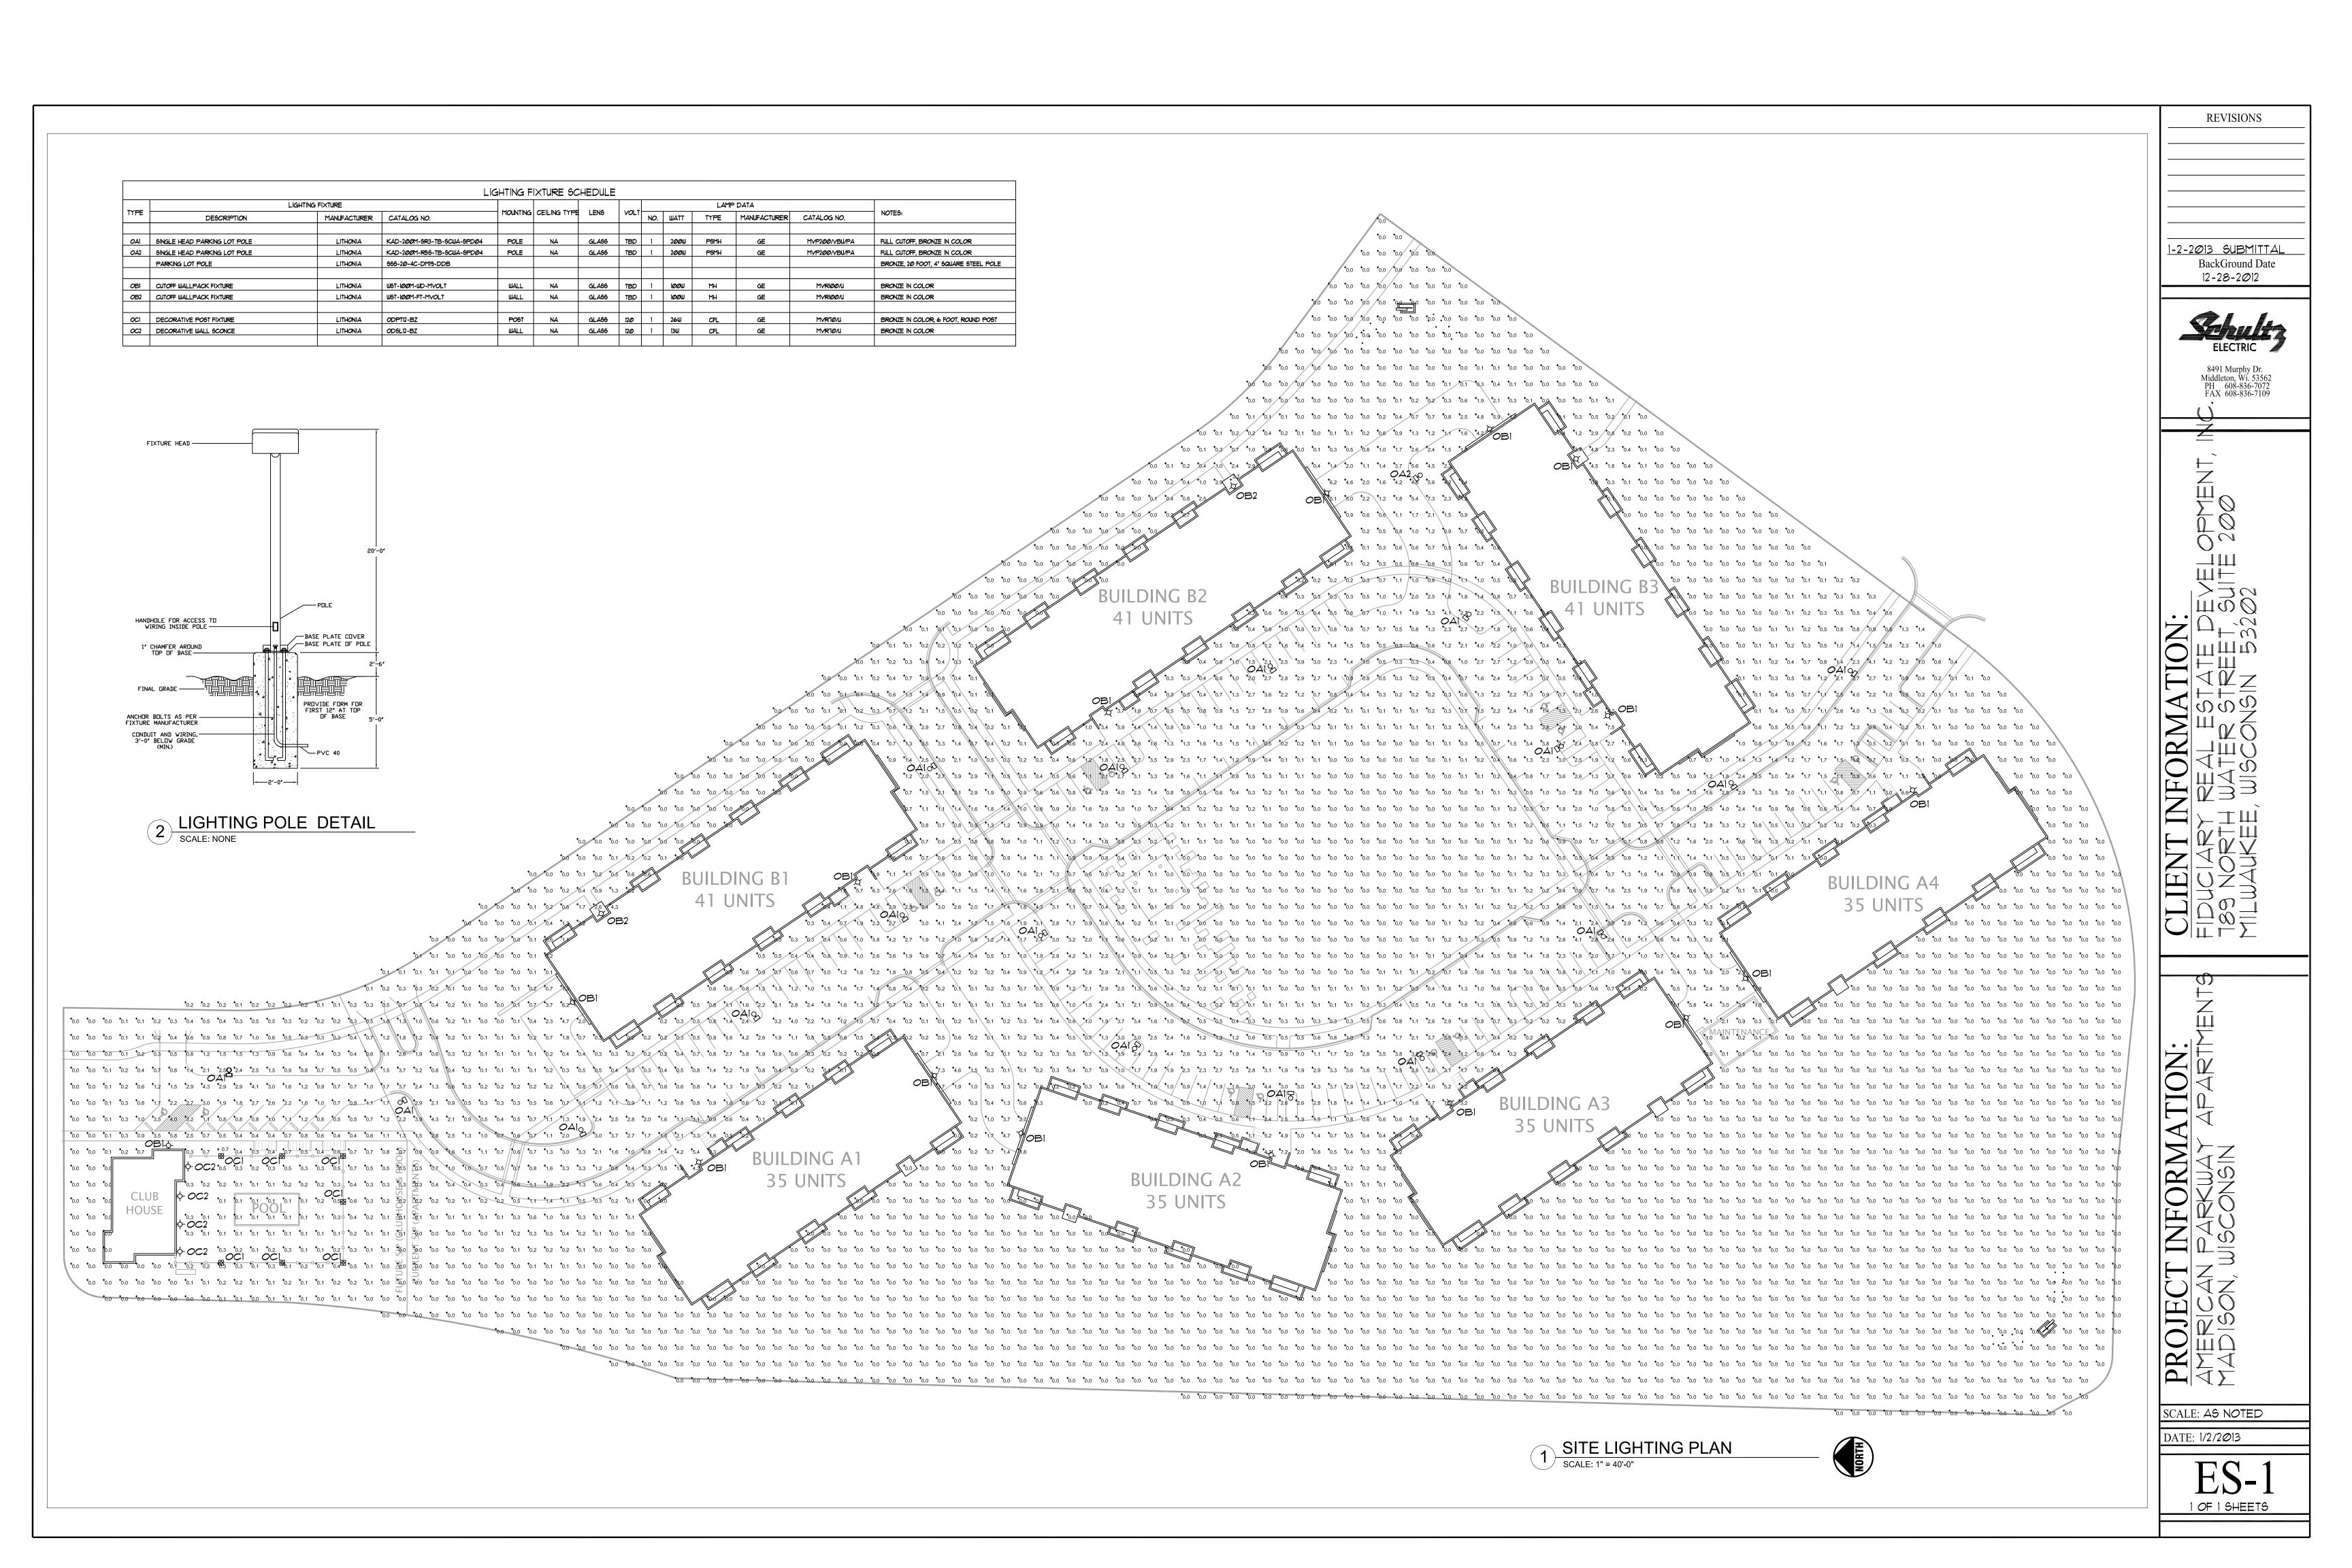

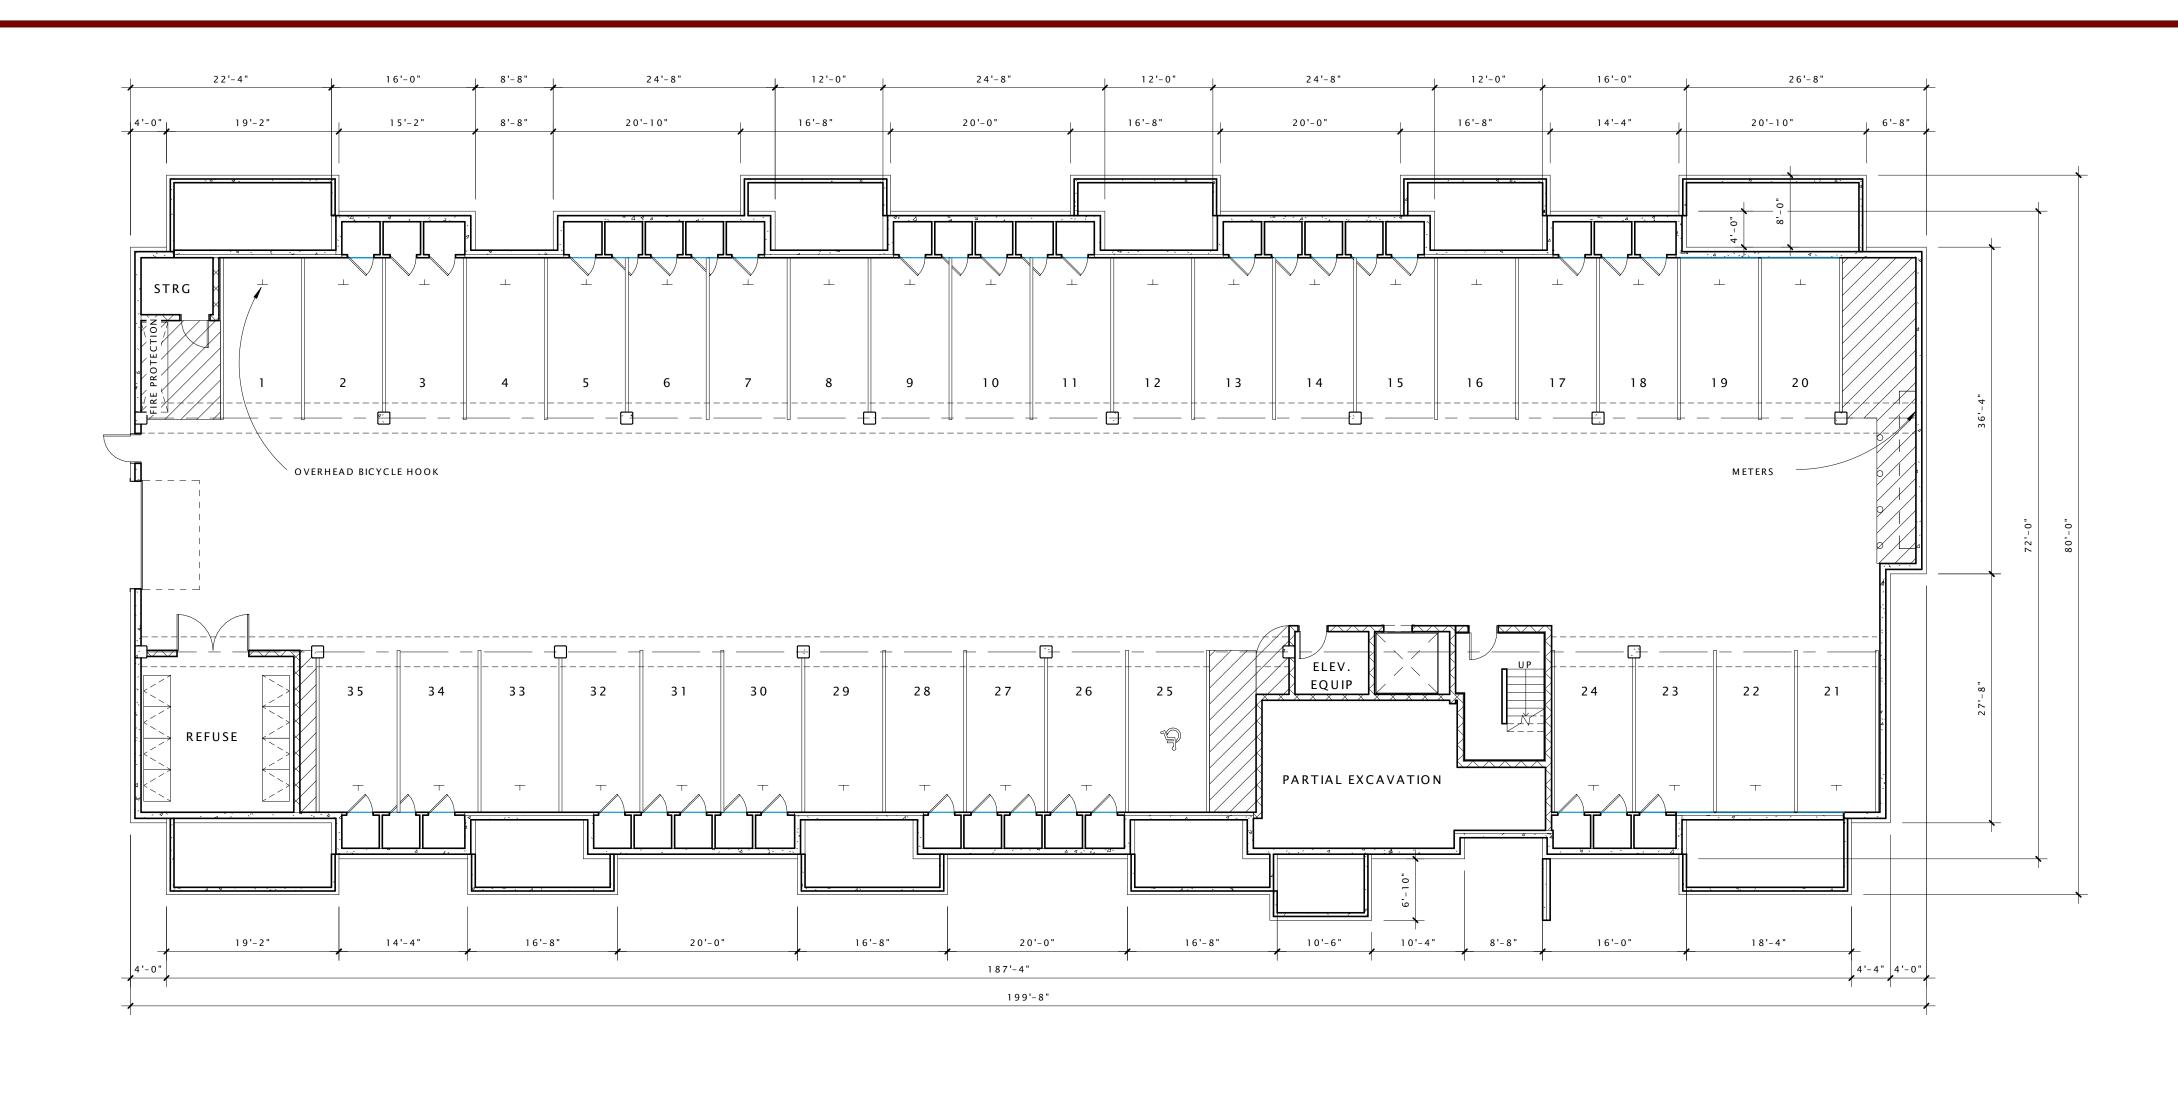

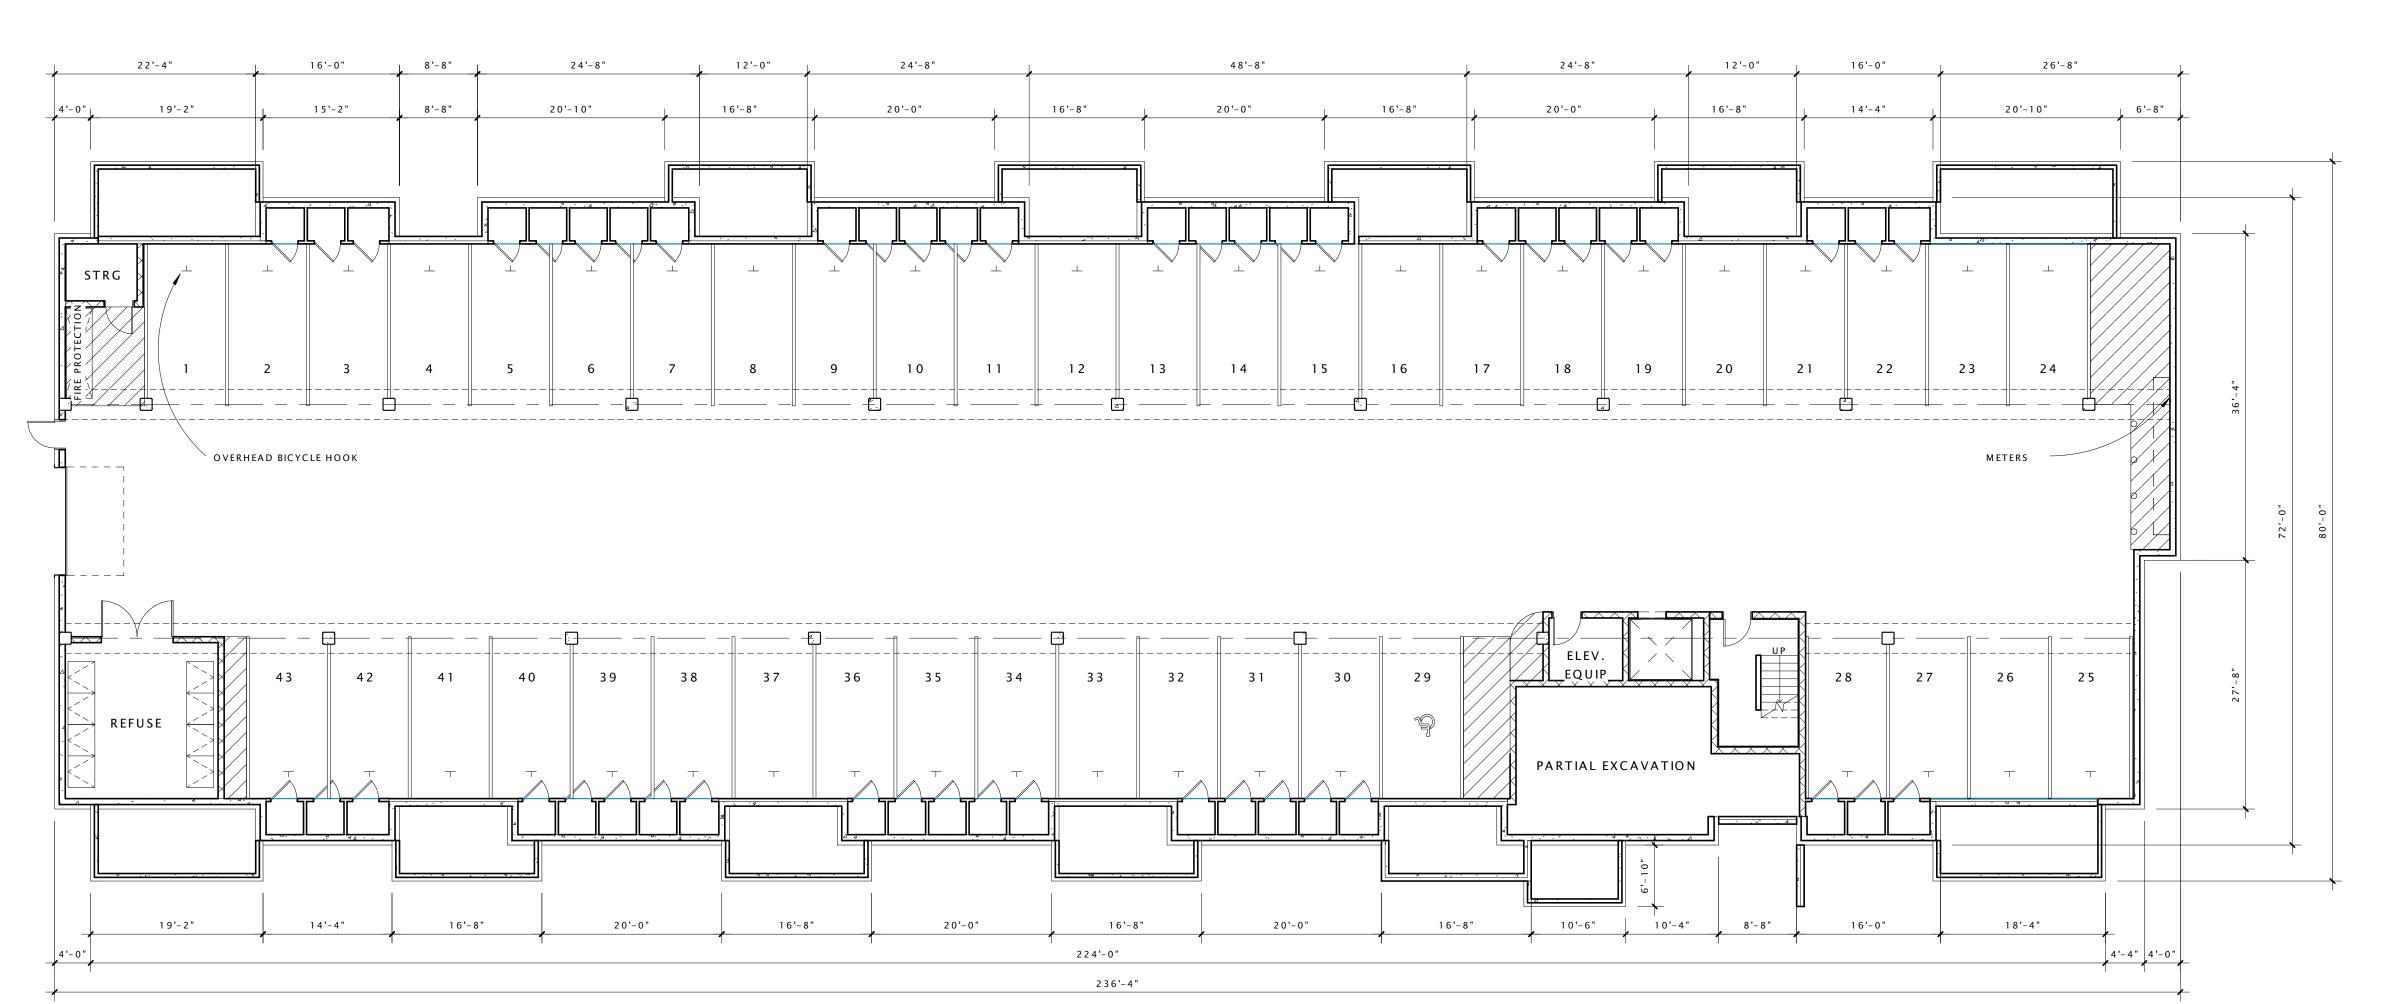



FIDUCIARY REAL ESTATE DEVELOPMENT, INC.

AMERICAN PARKWAY

APARTMENTS

PROGRESS DOCUMENTS

These documents reflect progress and intent and may be subject to change, including additional detail. These are not final construction documents and should not be used for final bidding or construction-related purposes.


| DATEO | F ISSUANCE        | 11/14/2012 |  |
|-------|-------------------|------------|--|
|       | Revision Schedule |            |  |
| Mark  | Description       | Date       |  |
|       |                   |            |  |

SHEET TITLE

LOWER LEVEL PLAN

SHEET NUMBER


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BUILDING TYPE A
(35 UNITS)

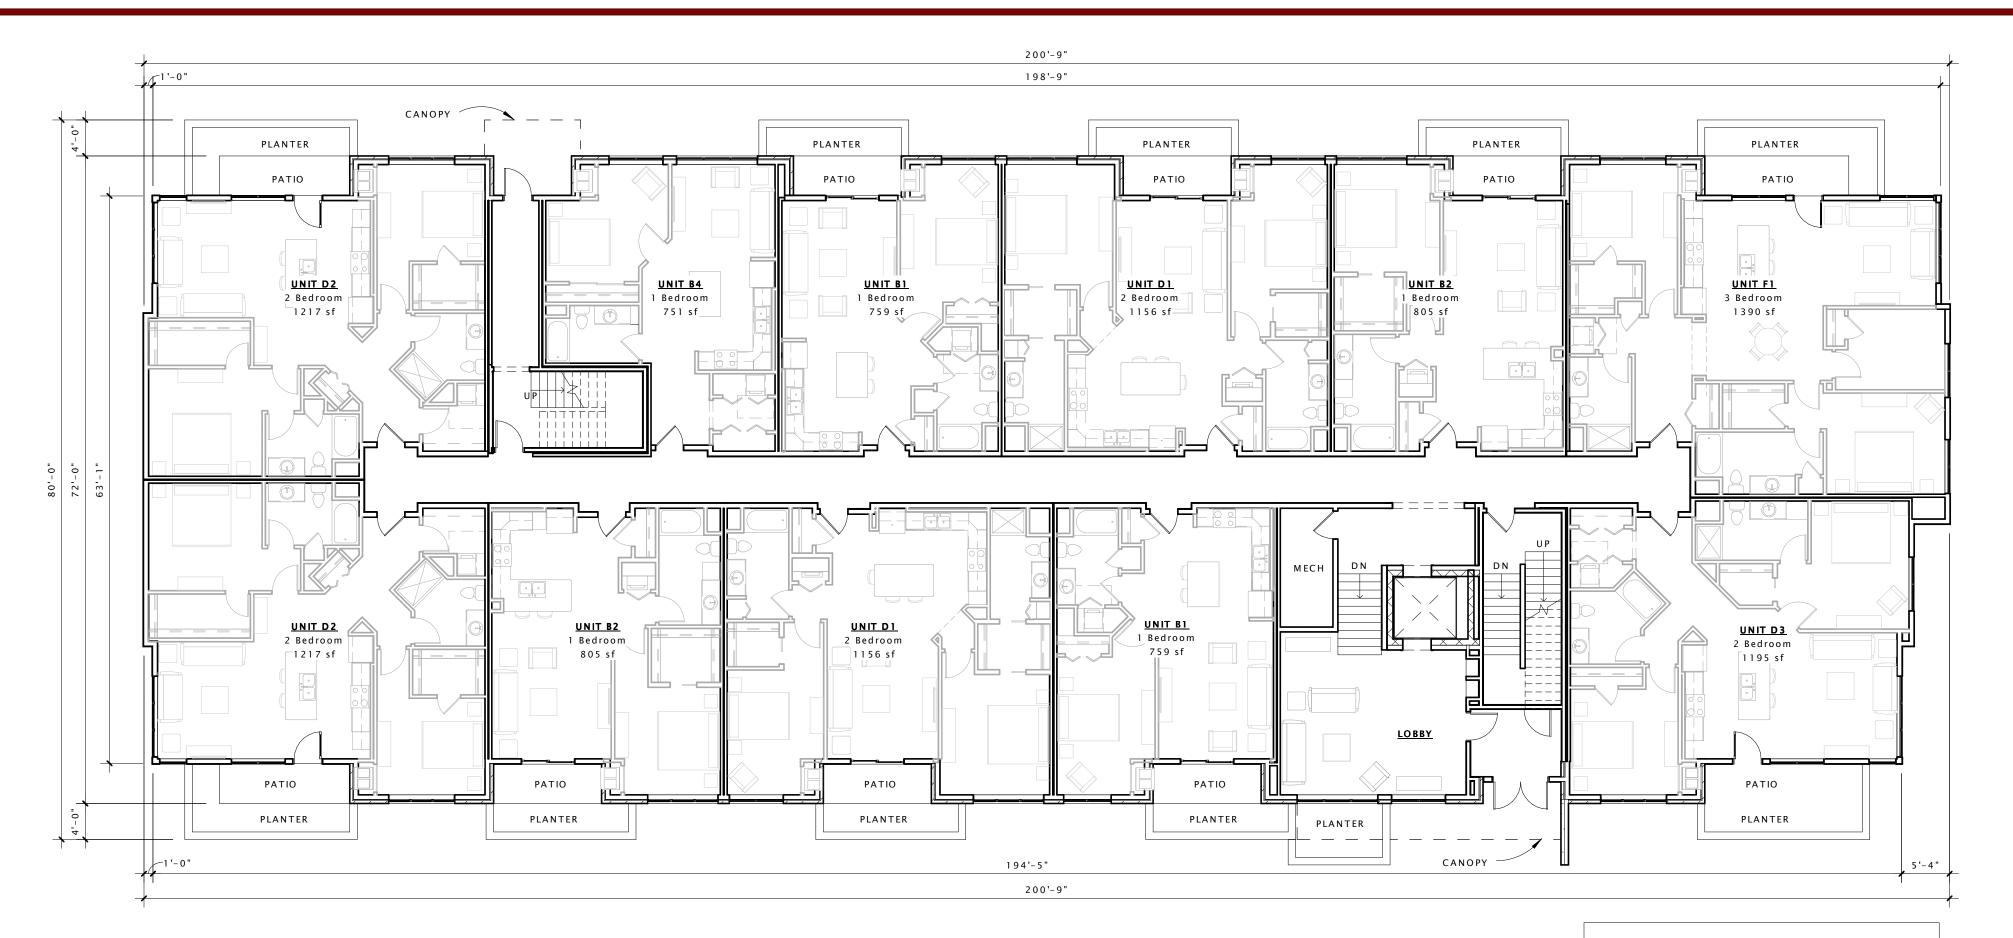

BUILDING TYPE B (41 UNITS)



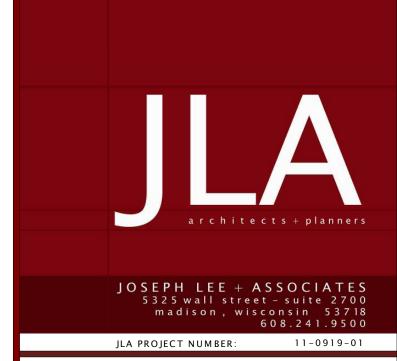

FIDUCIARY REAL ESTATE DEVELOPMENT, INC.

AMERICAN PARKWAY

APARTMENTS

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DATE OF ISSUANCE 11/14/2012

Revision Schedule

Mark Description Date

SHEET TITLE

FIRST FLOOR PLAN

SHEET NUMBER

A 1 0 1


16 FIRST FLOOR PLAN
3/32" = 1'-0"



BUILDING TYPE A
(35 UNITS)



BUILDING TYPE B
(41 UNITS)

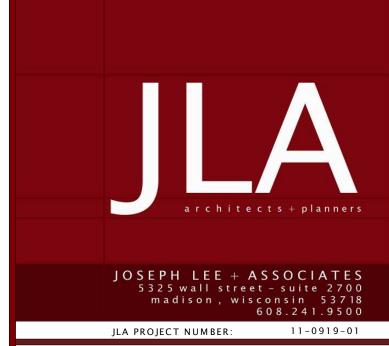



FIDUCIARY REAL
ESTATE
DEVELOPMENT, INC.

AMERICAN PARKWAY
APARTMENTS

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Revision Schedule


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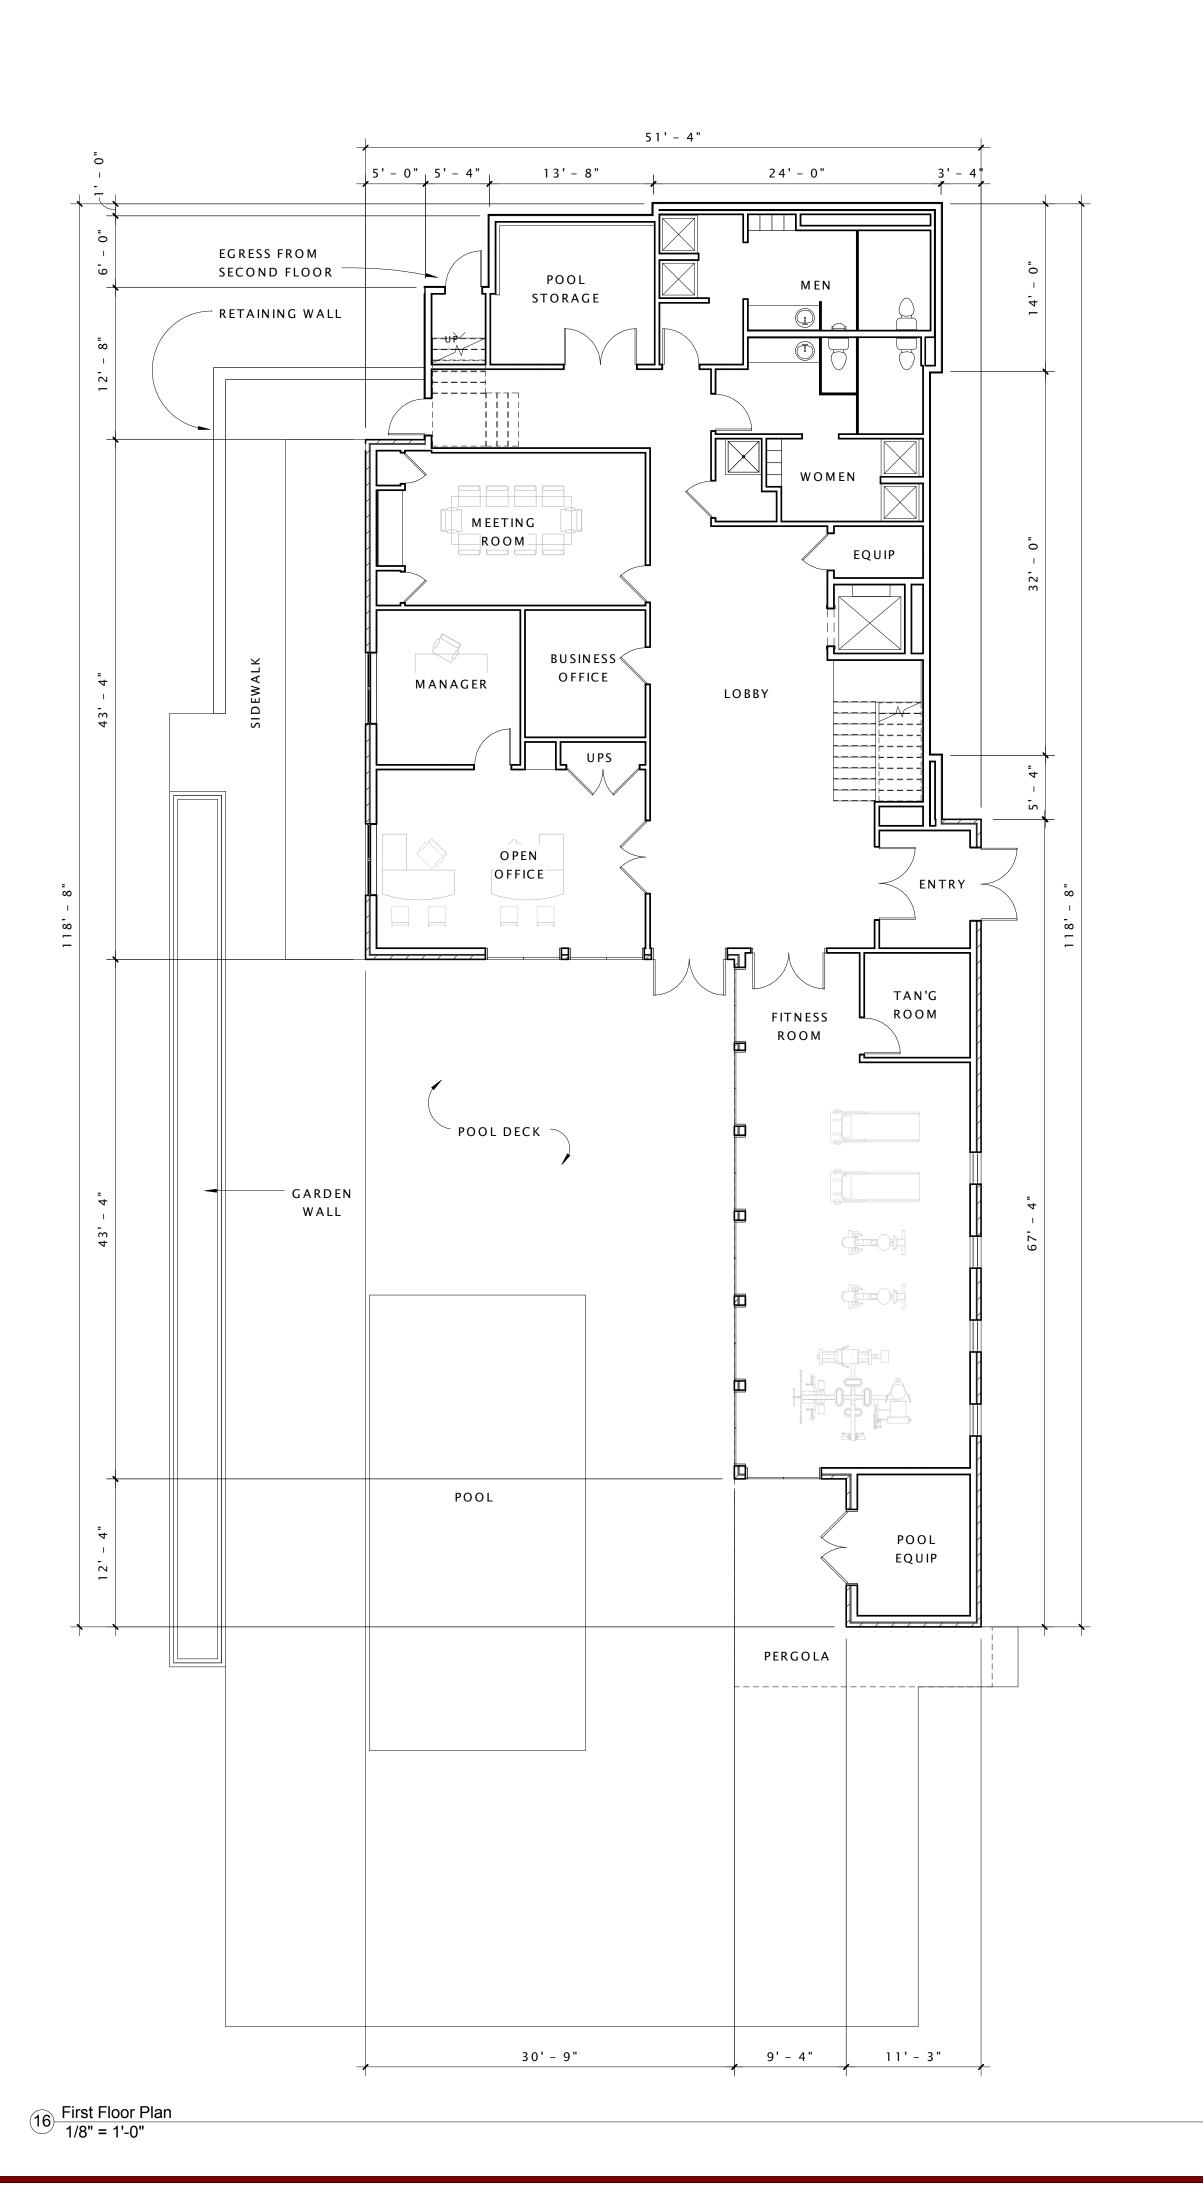
SECOND AND THIRD FLOOR PLANS

SHEET NUMBER

A 1 0 2



1 Second Floor Plan
1/8" = 1'-0"

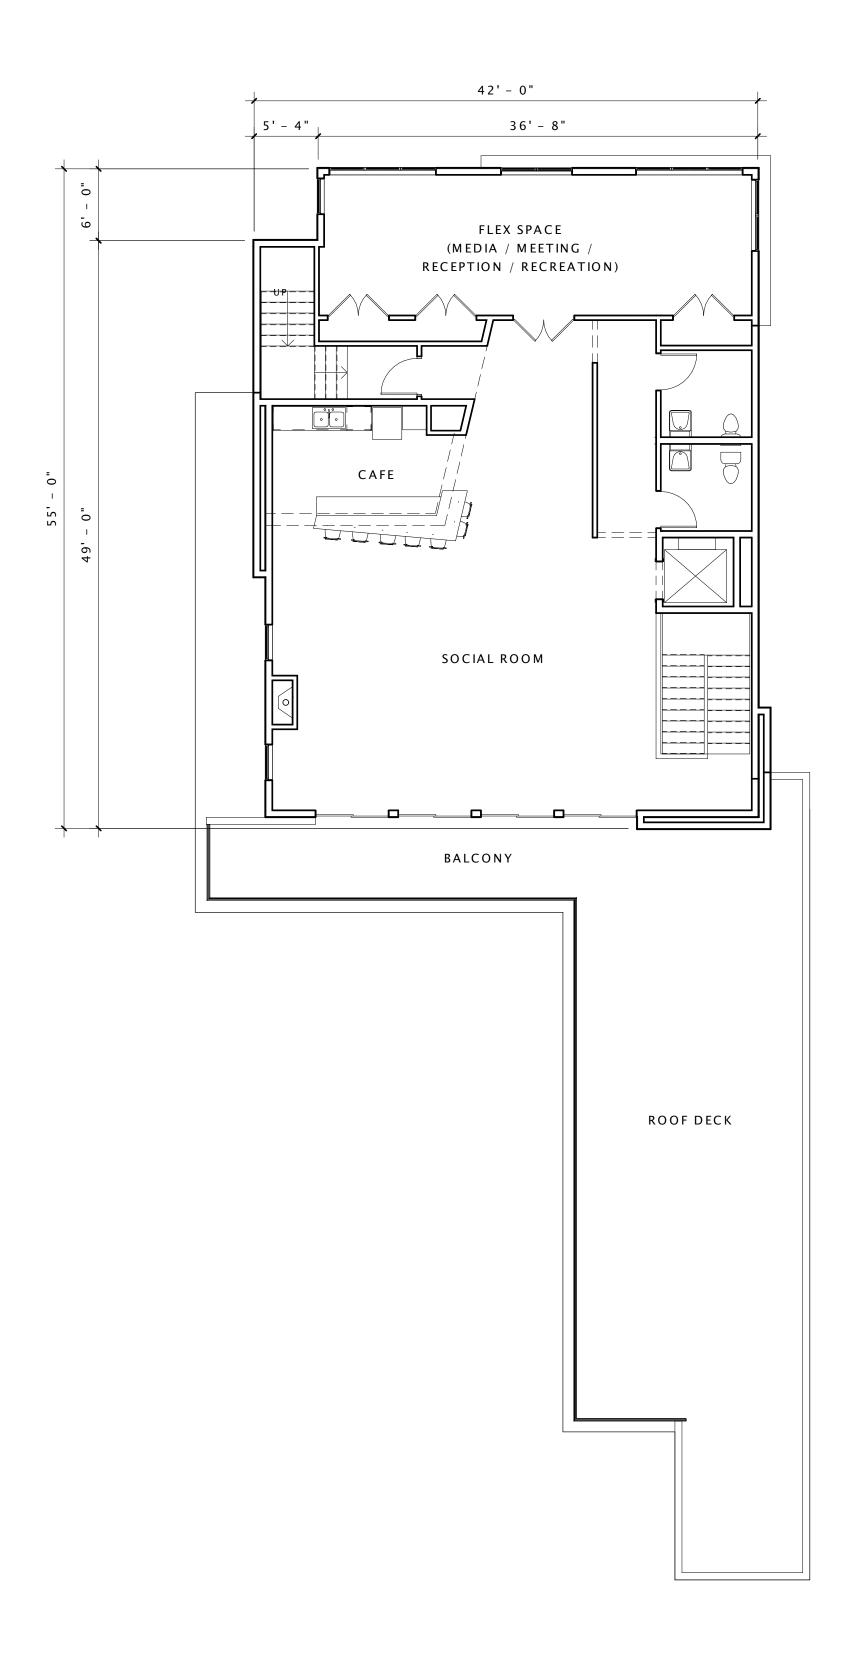





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DEVELOPMENT, INC.

AMERICAN PARKWAY

APARTMENTS

PROGRESS DOCUMENTS

These documents reflect progress and intent and may be subject to change, including additional detail. These are not final construction documents and should not be used for final bidding or construction-related purposes.

DATE OF ISSUANCE February 27, 2013

Revision Schedule

Mark Description Date

SHEET TITLE

CLUB HOUSE

SHEET NUMBER

A 1 0 3



1 Building A - Front Elevation 3/32" = 1'-0"



2 Building A - Back Elevation 3/32" = 1'-0"

End Elevation - Garage
3/32" = 1'-0"



3 Typical End Elevation 3/32" = 1'-0"





FIDUCIARY REAL
ESTATE
DEVELOPMENT, INC.

AMERICAN PARKWAY

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| DATEO | F ISSUANCE        | 01/02/2013 |  |
|-------|-------------------|------------|--|
|       | Revision Schedule |            |  |
| Mark  | Description       | Date       |  |
|       |                   | ·          |  |

SHEET TITLE


BUILDING A EXTERIOR ELEVATIONS

SHEET NUMBER





1 Building B - Back Elevation 3/32" = 1'-0"

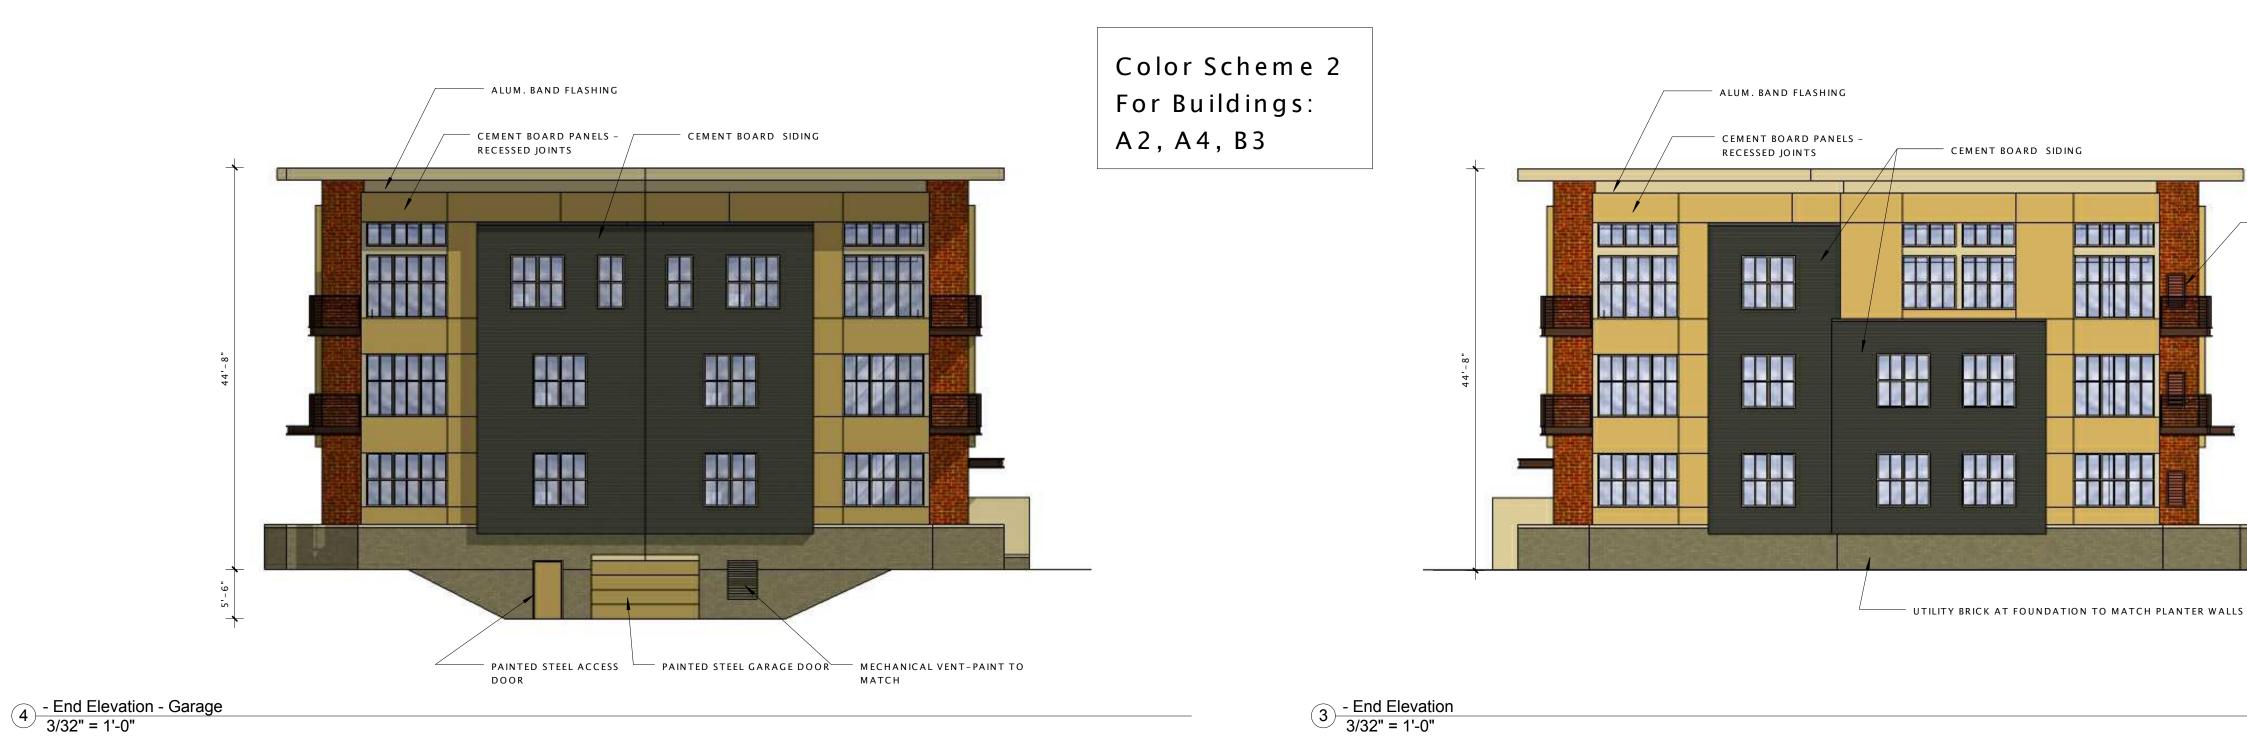



11-0919-01



JLA PROJECT NUMBER:

FIDUCIARY REAL
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| Mark   | Description       | Date       |
|        |                   |            |

SHEET TITLE

MECHANICAL VENTS -

PAINT TO MATCH

BUILDING B EXTERIOR ELEVATIONS

SHEET NUMBER



1 Building A - Front Elevation 3/32" = 1'-0"



2 Building A - Back Elevation 3/32" = 1'-0"

End Elevation - Garage
3/32" = 1'-0"



3 Typical End Elevation 3/32" = 1'-0"





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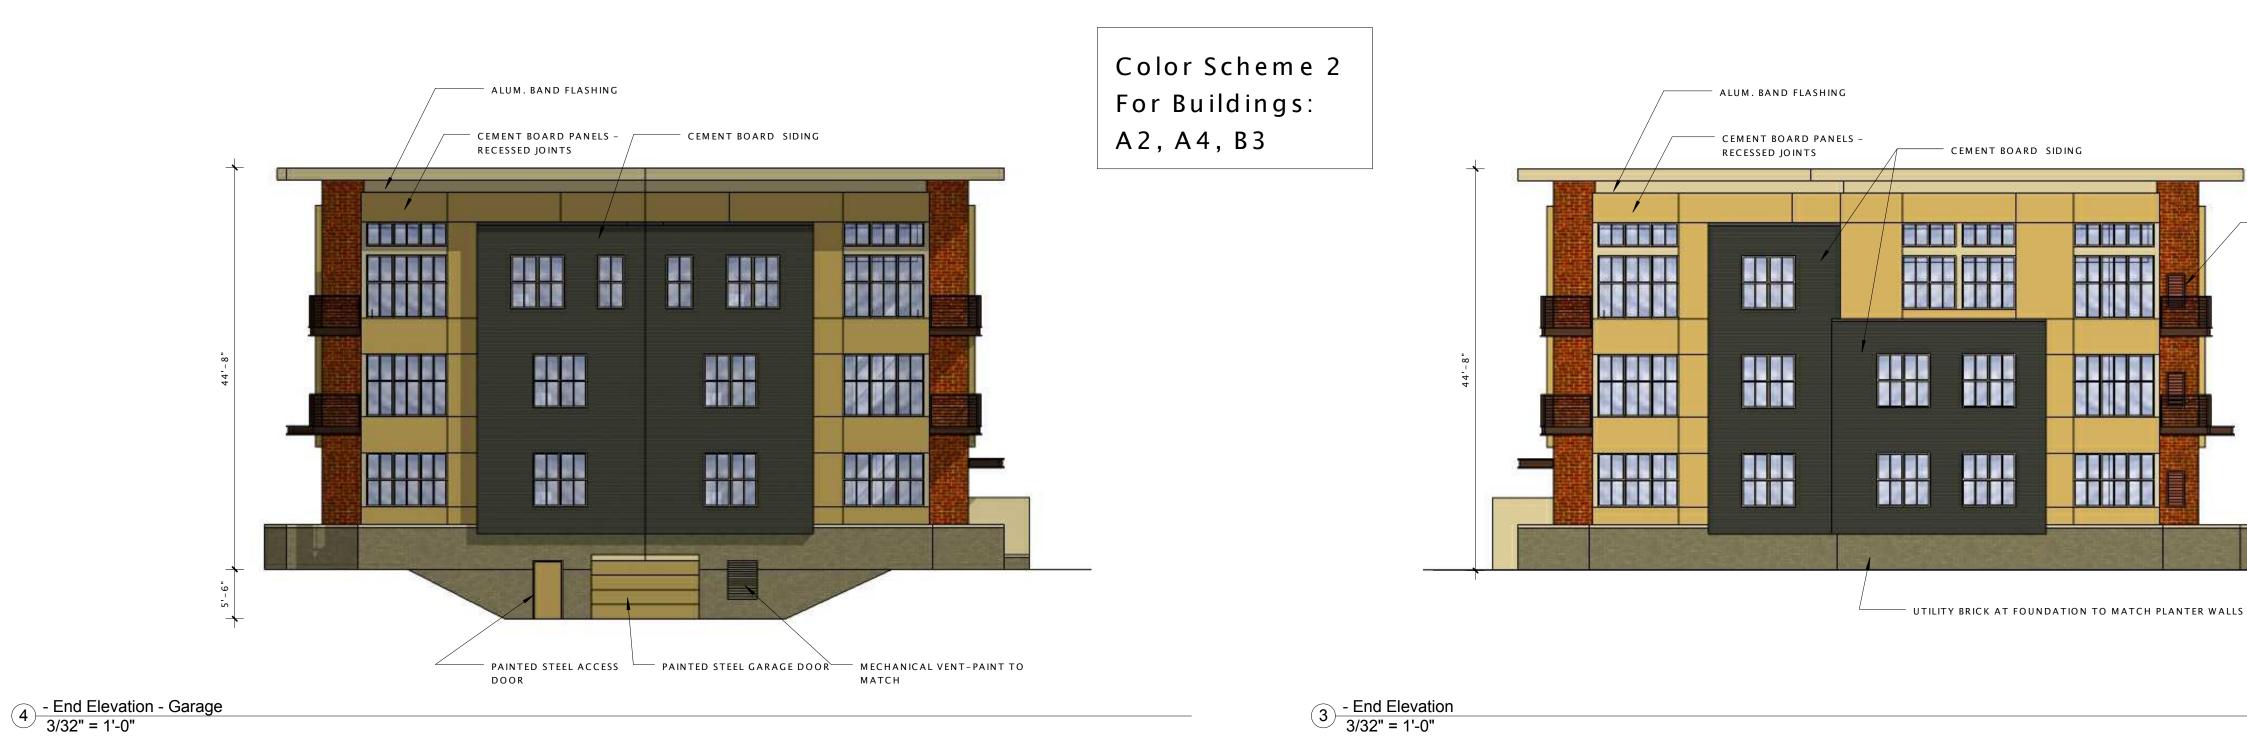
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1 Building B - Back Elevation 3/32" = 1'-0"





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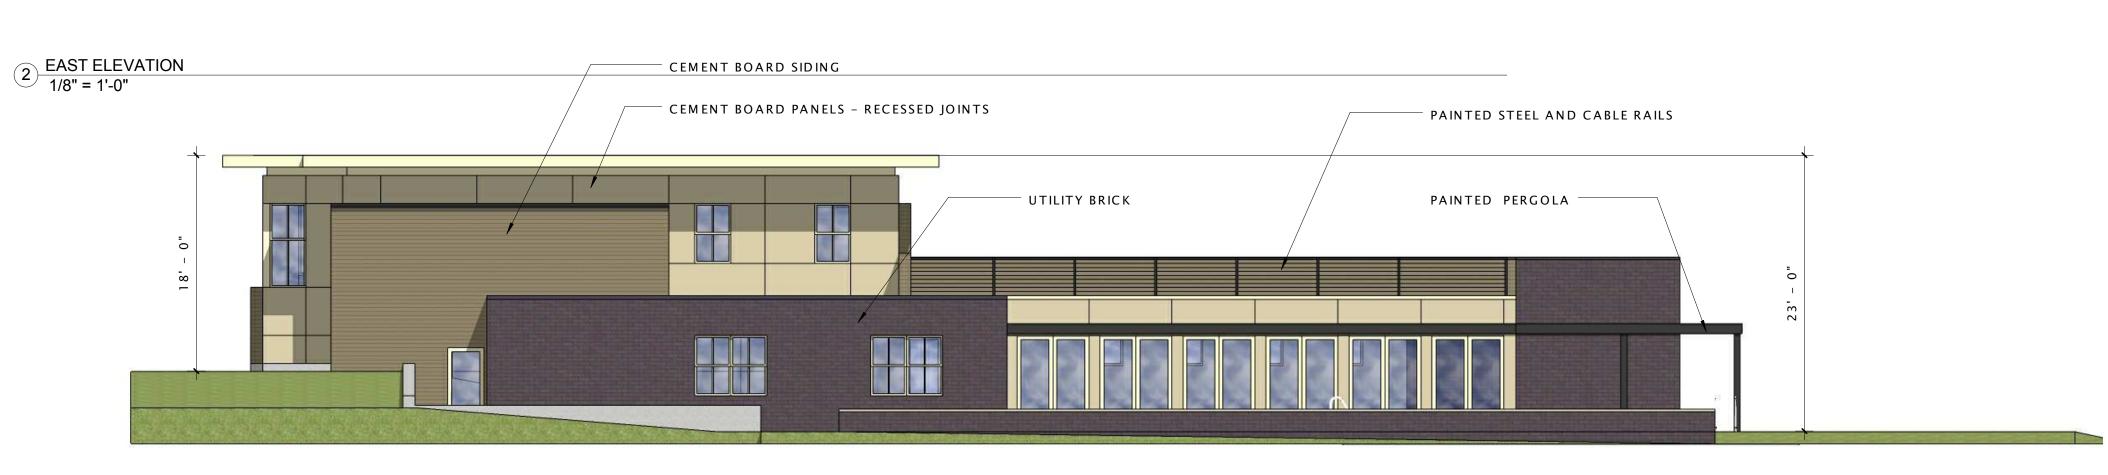
MECHANICAL VENTS -

PAINT TO MATCH

BUILDING B EXTERIOR ELEVATIONS

SHEET NUMBER






WEST ELEVATION
1/8" = 1'-0"



3 SOUTH ELEVATION
1/8" = 1'-0"



1 NORTH ELEVATION 1/8" = 1'-0"

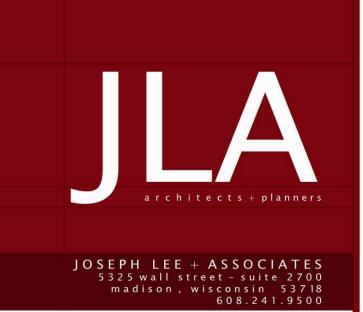

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