

URBAN DESIGN COMMISSION APPLICATION CITY OF MADISON

This form may also be completed online at: http://www.cityofmadison.com/planning/documents/UDCapplication.pdf

215 Martin Luther King Jr. Blvd; Room LL-100 PO Box 2985; Madison, Wisconsin 53701-2985 Phone: 608.266.4635 | Facsimile: 608.267.8739

Please complete all sections of the application, including the desired meeting date and the type of action requested.

Date Submitted: October 12, 2016		☐ Informational Pre	esentation
JDC Meeting Date: October 26, 2016		☐ Initial Approval	
Combined Schedule Plan Commission Date (if applicable): Novem	ber 07, 2016		
1. Project Address: 604 S. Point Road Project Title (if any): Lot 3 of 1000 Oaks Plat 2. This is an application for (Check all that apply to this UDC application ✓ New Development ☐ Alteration to an Existing or Pr	n):	Development	
A. Project Type: Project in an Urban Design District* (public hearing-\$300 fee Project in the Downtown Core District (DC) or Urban N Suburban Employment Center (SEC) or Campus Instituted Planned Development (PD) General Development Plan (GDP) Specific Implementation Plan (SIP) Planned Multi-Use Site or Planned Residential Complete	/lixed-Use District (U tional District (CI) or	=	
 B. Signage: Comprehensive Design Review* (public hearing-\$300 fee) Signage Exception(s) in an Urban Design District (public C. Other: Please specify: 		s Variance* (public hearin	ig-\$300 fee)
3. Applicant, Agent & Property Owner Information:			
Applicant Name: Randy Bruce	Company: Knothe &	& Bruce Architects,	LLC
Street Address: 7601 University Ave., Suite 201 Felephone: (608) 836-3690 Fax: ()		on	Zip: WI
Project Contact Person: Same as applicant	Company:		
Street Address:			
elephone:() Fax:()			
Project Owner (if not applicant): John McKenzie Street Address: 9201 Waterside Dr. Felephone: (608) 836-3800 Fax: ()	City/State: Middleto Email: johni	on, WI nc300@yahoo.cor	zip: <u>53562</u> n
1. Applicant Declarations:	•	·	
A. Prior to submitting this application, the applicant is required to discuss the application was discussed with <u>UDC Info Meeting</u> on on	August 17, 2016		
 The applicant attests that all required materials are included in this submit he application deadline, the application will not be placed on an Urban Desi 			n is not provided by
Name of Applicant Randy Bruce	Relationship to Propert	y Architect	
Authorized Signature Kang M	Date October 12	2, 2016	

5. Submission Requirements

Application: Each submittal must include 14 collated paper copies (11" x 17" max.) and an electronic copy of all application materials. The electronic copy must include individual Adobe Acrobat PDF files compiled either on a non-returnable CD-ROM submitted with the paper copies, or in an e-mail sent to: UDCApplications@cityofmadison.com

The transmittal shall include the name of the project, address, and applicant. Applicants unable to provide the materials electronically should contact the Secretary of the Urban Design Commission at 267-8740 for assistance. For an application to be considered complete and scheduled for a UDC meeting, both the paper copies and electronic copy need to be submitted prior to the application deadline. Late materials will not be accepted. An application is required for each UDC appearance. For projects also requiring Plan Commission approval, applicants must have submitted an accepted application for Plan Commission consideration prior to obtaining any formal action (initial or final approval) from the UDC. All plans must be easily read when reduced.

<u>Fees</u>: Fees are required to be paid with the first application for either initial or final approval of a project, unless the project is part of the combined application process involving the Urban Design Commission in conjunction with Plan Commission and/or Common Council consideration. Make checks payable to City Treasurer, Madison, Wisconsin.

<u>Project Plans</u>: The items listed below are minimal application requirements for the type of approval indicated. Please note that the UDC and/or staff may require additional information in order to have a complete understanding of the project.

1.	Info	ormational Presentation
		Locator Map
		Brief Narrative Description of the Project, Site Plan, and 2-dimensional images of proposed buildings or structures. Additional information may provide for a greater level of feedback from the Commission.
		Contextual site information, including photographs and layout of adjacent buildings/structures
		Any and all relevant plans and information on which feedback from the UDC is requested.
2.	<u>Init</u>	ial Approval
		Locator Map
		Contextual site information, including photographs and layout of adjacent buildings/structures
		Site Plan showing location of existing and proposed buildings, walks, drives, bike lanes, bike parking, and existing trees over 18" diameter
		Landscape Plan and Plant List
		Building Elevations for all building sides
		PD text and letter of intent (if applicable)
3.	<u>Fina</u>	al Approval
	X	Locator Map
	X	Site Plan showing location of existing and proposed buildings
	X	Grading Plan
	X	Landscape Plan
	X	Plant List, including scientific name, size at planting, quantity and root condition for each species.
	X	Building Elevations for all building sides, colored with shadow lines, including exterior building materials and colors.
		Proposed Signage
	X	Lighting Plan, including fixture cut sheets and photometrics plan
	X	Utility/HVAC equipment location and screening details
	\mathbf{x}	PD text and letter of intent (if applicable)
	X	Samples of the exterior building materials (presented at the UDC meeting)

<u>Signage</u>: The items listed below are minimal application requirements for the type of approval indicated. Please note that the UDC and/or staff may require additional information in order to have a complete understanding of the project.

1.	<u>Initial Approval</u>	
	☐ Locator Map	
	☐ Signage as it relates to the Sign Control Ordinan Signage	ce provisions for Variances or Comprehensive Design Review of
	☐ Site Plan (show location of all existing and proposition which existing signs, if any, are to be removed)	osed buildings, and all existing and proposed signage, specifying
	☐ Scale drawing of each proposed sign, including a	wning graphics
	☐ Photographs of site	
2.	Final Approval	
	☐ Locator Map	
	☐ Signage as it relates to the Sign Control Ordinan Signage	ce provisions for Variances or Comprehensive Design Review of
	☐ Site Plan (show location of all existing and proposition which existing signs, if any, are to be removed)	osed buildings, and all existing and proposed signage, specifying
	☐ Scale drawing of each proposed sign, including a	wning graphics
	☐ Description and/or samples of materials and col	ors for each proposed sign
	☐ Photographs of site	
	☐ Context of signs in surrounding parcels, in addit	on to the site being discussed

*NOTE: If supplemental perspective renderings are provided, an emphasis should be placed on providing pedestrian/automobile scale viewsheds, in addition to the other required graphics.

*NOTE: If applying for final approval without having received initial approval, all materials required for initial approval will be required.

NOTICE REGARDING LOBBYING ORDINANCE: If you are seeking approval of a development that has over 40,000 square feet of non-residential space, or a residential development of over 10 dwelling units, or if you are seeking assistance from the City with a value of \$10,000 (including grants, loans, TIF, or similar assistance), then you likely are subject to Madison's lobbying ordinance (Sec. 2.40, MGO). You are required to register and report your lobbying. Please consult the City's Clerk's Office for more information. Failure to comply with the lobbying ordinance may result in fines.



September 07, 2016

Ms. Heather Stouder Department of Planning & Development City of Madison 215 Martin Luther King Jr. Blvd PO Box 2985 Madison, Wisconsin 53701

Re:

Letter of Intent

Rezoning SR-V2 to TR-U1 and Conditional Use 604 S. Point Rd. (Lots 3 of 1000 Oaks Plat)

Madison, WI

Dear Ms. Stouder:

The following is submitted together with the plans and application for staff for approval.

Organizational structure:

Owner:

John McKenzie

9201 Waterside Dr.

Middleton, WI 53562

608-836-3800

Contact: John McKenzie

Johnmc300@yahoo.com

Engineer: Vierbicher Associates, Inc

999 Fourier Drive Ste 201

Madison, WI 53717

608-826-0532

608-826-0530 fax

Contact: Joe Doyle jdoy@vierbicher.com Architect:

Knothe & Bruce Architects, LLC

7601 University Avenue, Ste 201

Middleton, WI 53562

608-836-3690

Contact: Greg Held

gheld@knothebruce.com

Landscape

Design:

Olson Toon Landscaping

4387 Schwartz Rd.

Middleton, WI 53562

(608) 827-9401 Contact: Mike Makris

mike@olsontoon.com

Introduction:

The proposed site is Lot 3, 1000 Oaks Plat, located on the west side of Madison at the southwest corner of South Point Road and Harvest Moon Lane. The site is currently zoned SR-V2 and we are proposing to rezone it to TR-U1 with a conditional-use approval for a multifamily building complex. In the future the Owner will also be proposing a development on Lot 2, 1000 Oaks Plat which lies immediately west of the subject property.

Project Description:

Lot 3 contains 274 apartments in a series of two to four-story apartment buildings with underground parking. The buildings are arranged around a series of outdoor courts and common amenities with an extensive community building serving as the social center of the development. The exterior architecture is well articulated, using a combination of stone and composite wood siding for an appealing and durable exterior. The buildings contain a range of studio, one, two and two bedroom plus den apartments.

Site Development Data:

				٠.	٠			
D	\sim	n	_	18	٠	_	•	٠
	_		`			_	`	
_	_		_			_	-	۰

Lot Area 312,938 S.F./ 7.18 acres

Dwelling Units 274 units
Lot Area / D.U. 1,142 S.F./unit
Density 38.1 units/acre

Usable Open Space 92,134 S.F. (336 S.F./unit)

Lot Coverage 191,483 S.F. (61%)

Building Height 2-4 stories

5 5						
Dwelling Unit Mix: Efficiency One Bedroom One Bedroom + Den Two bedroom Two Bedroom + Den	Bldg #1 6 28 4 12 0	#2 8 32 0 15 5	#3 8 32 0 15 5	#4 6 28 4 12 0	#5 6 30 0 12 6	Total 34 150 8 66 16
Total Dwelling Units	50	60	60	50	54	274
Vehicle Parking Stalls: Underground Surface Total	50 20 70	60 34 94	60 35 95	50 20 70	52 26 78	272 135 407
Parking Ratio	1.5 stalls/u	nit				
Bicycle Parking: Garage – wall mount Garage – floor mount Surface Surface-Guest	0 46 5 5	0 54 6 6	0 54 6 6	0 46 5	13 36 6 6	13 236 28 28
Total	56	66	66	56	48	305

Letter of Intent – Rezoning 604 S. Point Rd. (Lot 3 of 1000 Oaks Plat) September 07, 2016 Page 3 of 3

Project Schedule:

The project construction will be phased over 3 to 5 years as market conditions dictate. Construction will start with Building 1 in spring 2017 with completion in Spring 2018. The construction start on Building 2 and the clubhouse is planned to follow soon thereafter in summer 2017 with completion scheduled for summer 2018.

Thank you for your time reviewing our proposal.

Sincerely,

Greg Held, AIA

604 S. Point Road

Cree Edge™ Series

LED Area/Flood Luminaire

Product Description

The Cree Edge™ Series has a slim, low profile design. Its rugged cast aluminum housing minimizes wind load requirements and features an integral, weathertight LED driver compartment and high performance aluminum heat sinks. Various mounting choices: Adjustable Arm, Direct Arm, Direct Arm Long, or Side Arm (details on page 2). Includes a leaf/debris guard.

Applications: Parking lots, walkways, campuses, car dealerships, office complexes, and internal roadways

Performance Summary

Patented NanoOptic® Product Technology

Made in the U.S.A. of U.S. and imported parts

CRI: Minimum 70 CRI

CCT: 4000K (+/- 300K), 5700K (+/- 500K) standard


Limited Warranty[†]: 10 years on luminaire/10 years on Colorfast DeltaGuard[®] finish

*See http://lighting.cree.com/warranty for warranty terms

Accessories

Field-Installed	
Bird Spikes	Backlight Control Shields
XA-BRDSPK	XA-20BLS-4
Hand-Held Remote	- Four-pack
XA-SENSREM	- Unpainted stainless steel
- For successful implementation of the programmable multi-level	
ontion, a minimum of one hand-held remote is required	

DA Mount

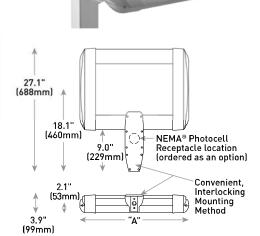

LED Count (x10)	Dim. "A"	Weight
02	12.1" (306mm)	21 lbs. (10kg)
04	12.1" (306mm)	24 lbs. (11kg)
06	14.1" [357mm]	27 lbs. [12kg]
08	16.1" [408mm]	28 lbs. (13kg)
10	18.1" [459mm]	32 lbs. (15kg)
12	20.1" [510mm]	34 lbs. (15kg)
14	22.1" (560mm)	37 lbs. [17kg]
16	24.1" (611mm)	41 lbs. [19kg]

AA/DL/SA Mount - see page 22 for weight & dimensions

Ordering Information

Example: ARE-EDG-2M-AA-12-E-UL-SV-350

						E				
Product	Optic			Mounting*	LED Count (x10)	Series	Voltage	Color Options	Drive Current	Options
ARE- EDG	2M Type II Medium 2MB Type II Medium W/BLS 2MP Type II Medium W/Partial BLS 3M Type III Medium	3MB Type III Medium w/BLS 3MP Type III Medium w/Partial BLS 4M Type IV Medium 4MB Type IV Medium w/BLS	4MP Type IV Medium w/Partial BLS 5M Type V Medium 5S Type V Short	AA Adjustable Arm DA Direct Arm DL Direct Long Arm SA Side Arm - Available with 20-60 LEDs	02 04 06 08 10 12 14	E	UL Universal 120-277V UH Universal 347-480V	BK Black BZ Bronze SV Silver WH White	350 350mA 525 525mA 700 700mA - Available with 20- 60 LEDs	DIM 0-10V Dimming
FLD- EDG	25 25° Flood 40 40° Flood	70° Flood SN Sign	N6 NEMA® 6							ML Multi-Level - Refer to ML spec sheet for details - Intended for downlight applications at 0° tilt P Photocell - Refer to ML spec sheet for availability with ML options - Available with UL voltage only - Refer to ML spec sheet for availability with ML options

^{*} Reference EPA and pole configuration suitability data beginning on page 19 NOTE: Price adder may apply depending on configuration

T (800) 236-6800 F (262) 504-5415






Rev. Date: V3 08/03/2016




T (800) 473-1234 F (800) 890-7507

All published luminaire photometric testing performed to IESNA LM-79-08 standards by a NVLAP accredited laboratory. To obtain an IES file specific to your project consult: http://lighting.cree.com/products/outdoor/area/cree-edge-series-1

3MB

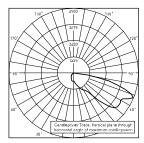

CSA Test Report #: 6448 ARE-EDG-3MB-**-06-E-UL-700 Initial Delivered Lumens: 7,740

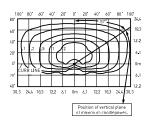

ARE-EDG-3MB-**-12-E-UL-525-40K Mounting Height: 25' (7.6m) A.F.G. Initial Delivered Lumens: 12,420 Initial FC at grade

Type III Med	Type III Medium Distribution w/BLS					
	4000K		5700K			
LED Count (x10)	Initial Delivered Lumens*	BUG Ratings** Per TM-15-11	Initial Delivered Lumens'	BUG Ratings** Per TM-15-11		
350mA						
02	1,499	B1 U0 G1	1,557	B1 U0 G1		
04	2,999	B1 U0 G1	3,114	B1 U0 G1		
06	4,446	B1 U0 G1	4,617	B1 U0 G1		
08	5,929	B1 U0 G2	6,157	B1 U0 G2		
10	7,393	B1 U0 G2	7,677	B1 U0 G2		
12	8,872	B1 U0 G2	9,213	B1 U0 G2		
14	10,285	B1 U0 G2	10,680	B1 U0 G2		
16	11,754	B1 U0 G3	12,206	B1 U0 G3		
525mA	'					
02	2,099	B1 U0 G1	2,180	B1 U0 G1		
04	4,198	B1 U0 G1	4,359	B1 U0 G1		
06	6,225	B1 U0 G2	6,464	B1 U0 G2		
08	8,300	B1 U0 G2	8,619	B1 U0 G2		
10	10,350	B1 U0 G2	10,748	B1 U0 G2		
12	12,420	B1 U0 G3	12,898	B1 U0 G 3		
14	14,398	B1 U0 G 3	14,952	B2 U0 G 3		
16	16,455	B2 U0 G3	17,088	B2 U0 G3		
700mA						
02	2,564	B1 U0 G1	2,662	B1 U0 G1		
04	5,127	B1 U0 G2	5,325	B1 U0 G2		
06	7,603	B1 U0 G2	7,896	B1 U0 G2		

^{*} Initial delivered lumens at 25°C (77°F). Actual production yield may vary between -10 and +10% of initial delivered lumens


Canada: www.cree.com/canada

lumens


** For more information on the IES BUG (Backlight-Uplight-Glare) Rating visit: www.ies.org/PDF/Erratas/TM-1511BugRatingsAddendum.pdf. Valid with no tilt

All published luminaire photometric testing performed to IESNA LM-79-08 standards by a NVLAP accredited laboratory. To obtain an IES file specific to your project consult: http://lighting.cree.com/products/outdoor/area/cree-edge-series-1

4M

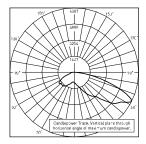

CSA Test Report #: 6438 ARE-EDG-4M-**-06-E-UL-700-40K Initial Delivered Lumens: 11,367

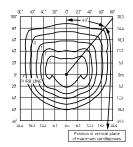

ARE-EDG-4M-**-12-E-UL-525-40K Mounting Height: 25' [7.6m] A.F.G. Initial Delivered Lumens: 17,710 Initial FC at grade

Type IV Med	Type IV Medium Distribution					
	4000K		5700K			
LED Count (x10)	Initial Delivered Lumens'	BUG Ratings** Per TM-15-11	Initial Delivered Lumens'	BUG Ratings** Per TM-15-11		
350mA						
02	2,138	B1 U0 G1	2,220	B1 U0 G1		
04	4,276	B1 U0 G1	4,440	B1 U0 G1		
06	6,340	B2 U0 G2	6,584	B2 U0 G2		
80	8,454	B2 U0 G2	8,779	B2 U0 G2		
10	10,542	B2 U0 G2	10,947	B2 U0 G2		
12	12,650	B3 U0 G3	13,137	B3 U0 G3		
14	14,665	B3 U0 G3	15,229	B3 U0 G3		
16	16,760	B3 U0 G3	17,405	B3 U0 G3		
525mA	'			'		
02	2,993	B1 U0 G1	3,108	B1 U0 G1		
04	5,986	B2 U0 G1	6,216	B2 U0 G2		
06	8,876	B2 U0 G2	9,218	B2 U0 G2		
08	11,835	B2 U0 G2	12,290	B3 U0 G3		
10	14,759	B3 U0 G 3	15,326	B3 U0 G3		
12	17,710	B3 U0 G 3	18,391	B3 U0 G3		
14	20,531	B3 U0 G 3	21,321	B3 U0 G3		
16	23,464	B3 U0 G3	24,367	B4 U0 G3		
700mA						
02	3,656	B1 U0 G1	3,796	B1 U0 G1		
04	7,311	B2 U0 G2	7,593	B2 U0 G2		
06	10,842	B2 U0 G2	11,259	B2 U0 G2		


^{*} Initial delivered lumens at 25°C (77°F). Actual production yield may vary between -10 and +10% of initial delivered lumens

Canada: www.cree.com/canada


lumens

** For more information on the IES BUG (Backlight-Uplight-Glare) Rating visit: www.ies.org/PDF/Erratas/TM-1511BugRatingsAddendum.pdf. Valid with no tilt

All published luminaire photometric testing performed to IESNA LM-79-08 standards by a NVLAP accredited laboratory. To obtain an IES file specific to your project consult: http://lighting.cree.com/products/outdoor/area/cree-edge-series-1

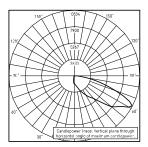

CSA Test Report #: 6449 ARE-EDG-4MB-**-12-E-UL-525-40K Initial Delivered Lumens: 13,155

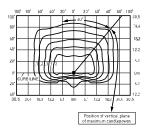

ARE-EDG-4MB-**-12-E-UL-525-40K Mounting Height: 25' [7.6m] A.F.G. Initial Delivered Lumens: 13,340 Initial FC at grade

Type IV Medium Distribution w/BLS					
	4000K		5700K		
LED Count (x10)	Initial Delivered Lumens*	BUG Ratings** Per TM-15-11	Initial Delivered Lumens*	BUG Ratings** Per TM-15-11	
350mA					
02	1,610	B0 U0 G1	1,672	B0 U0 G1	
04	3,221	B1 U0 G1	3,345	B1 U0 G1	
06	4,776	B1 U0 G1	4,959	B1 U0 G1	
80	6,368	B1 U0 G2	6,613	B1 U0 G2	
10	7,941	B1 U0 G2	8,246	B1 U0 G2	
12	9,529	B1 U0 G2	9,895	B1 U0 G2	
14	11,046	B1 U0 G2	11,471	B1 U0 G2	
16	12,624	B1 U0 G2	13,110	B1 U0 G2	
525mA					
02	2,254	B0 U0 G1	2,341	B0 U0 G1	
04	4,509	B1 U0 G1	4,682	B1 U0 G1	
06	6,686	B1 U0 G2	6,943	B1 U0 G2	
08	8,915	B1 U0 G2	9,258	B1 U0 G2	
10	11,117	B1 U0 G2	11,544	B1 U0 G2	
12	13,340	B1 U0 G2	13,853	B2 U0 G2	
14	15,465	B2 U0 G2	16,060	B2 U0 G 3	
16	17,674	B2 U0 G3	18,354	B2 U0 G3	
700mA					
02	2,754	B0 U0 G1	2,860	B0 U0 G1	
04	5,507	B1 U0 G1	5,719	B1 U0 G2	
06	8,167	B1 U0 G2	8,481	B1 U0 G2	


 $^{^{\}star}$ Initial delivered lumens at 25 $^{\circ}$ C (77 $^{\circ}$ F). Actual production yield may vary between -10 and +10% of initial delivered



lumens


** For more information on the IES BUG (Backlight-Uplight-Glare) Rating visit: www.ies.org/PDF/Erratas/TM-1511BugRatingsAddendum.pdf. Valid with no tilt

AA Mount

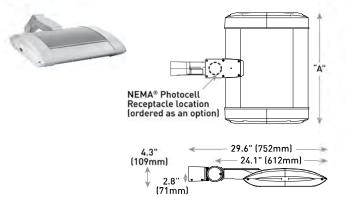


LED Count (x10)	Dim. "A"	Weight
02	12.1" [306mm]	21 lbs. (10kg)
04	12.1" [306mm]	24 lbs. (11kg)
06	14.1" [357mm]	27 lbs. (12kg)
08	16.1" [408mm]	28 lbs. (13kg)
10	18.1" [459mm]	32 lbs. (15kg)
12	20.1" (510mm)	34 lbs. (15kg)
14	22.1" (560mm)	37 lbs. [17kg]
16	24.1" (611mm)	41 lbs. [19kg]

DL Mount

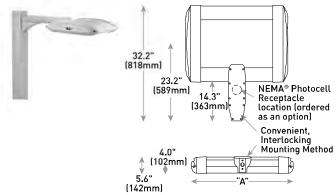

LED Count (x10)	Dim. "A"	Weight
02	12.1" (306mm)	23 lbs. [10kg]
04	12.1" (306mm)	26 lbs. [12kg]
06	14.1" (357mm)	29 lbs. (13kg)
08	16.1" [408mm]	30 lbs. (14kg)
10	18.1" [459mm]	34 lbs. (15kg)
12	20.1" (510mm)	36 lbs. (16kg)
14	22.1" (560mm)	42 lbs. [19kg]
16	24.1" (611mm)	44 lbs. [20kg]

SA Mount

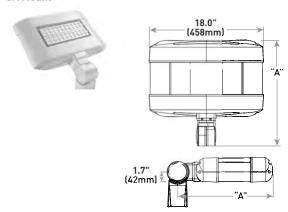

LED Count (x10)	Dim. "A"	Weight
02	16.0" [406mm]	25 lbs. (11kg)
04	18.0" [457mm]	26 lbs. (12kg)
06	20.0" [508mm]	28 lbs. (13kg)

© 2016 Cree, Inc. and/or one of its subsidiaries. All rights reserved. For informational purposes only. Content is subject to change. Patent www.cree.com/patents. Cree®, NanoOptic®, and Colorfast DeltaGuard® are registered trademarks, and Cree Edge $^{\text{TM}}$ and the Cree logo are trademarks of Cree, Inc. The UL logo is a registered trademark of UL LLC. NEMA $^{\text{SM}}$ is a registered trademark of the National Electrical Manufacturers Association. The DLC QPL logo is a registered trademark of Northeast Energy Efficiency Partnerships, Inc.



Cree Edge™ Series

LED High Output Area/Flood Luminaire featuring Cree TrueWhite® Technology

Product Description

The Cree Edge™ High Output Area/Flood luminaire is designed to deliver high lumen packages with precise optical control. The unit features a slim, low profile design that minimizes wind load and a rugged die cast aluminum adjustable arm that mounts to a horizontal or vertical 2" (51mm) IP, 2.375-2.50" (60-64mm) O.D. steel tenon. Tenon length must be a minimum of 3.75" (95mm). The direct mount bracket accessory allows for further mounting flexibility. Available with Cree TrueWhite® Technology, the Cree Edge™ High Output helps to beautifully render true colors and deliver value beyond energy savings.

Applications: Auto dealerships, parking lots, campuses, facade lighting, high-mast and general site lighting applications

Performance Summary

Utilizes Cree TrueWhite® Technology on 5000K Luminaires

Patented NanoOptic® Product Technology

Made in the U.S.A. of U.S. and imported parts

CRI: Minimum 70 CRI [4000K & 5700K]; 90 CRI (5000K)

CCT: 4000K (+/- 300K), 5000K (+/- 300K), 5700K (+/- 500K) standard

Limited Warranty[†]: 10 years on luminaire/10 years on Colorfast DeltaGuard[®] finish

Accessories

Field-Installed		
Bird Spikes XA-BRDSPKXAK12 - 120 LED XA-BRDSPKXAK24 - 240 LED	Backlight Control Shields XA-30BLS-4 - Four-pack for 120 LED - Unpainted stainless steel XA-30BLS-8	
	- Eight-pack for 240 LED - Unpainted stainless steel	

Ordering Information

Example: ARE-EHO-2M-HV-12-E-UL-SV-700


604 S. Point Road




HV Mount (shown in horizontal position)



120 LED

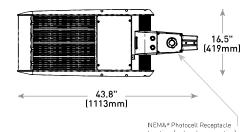

240 LED

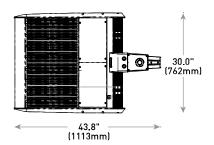

LED Count (x10)	Weight
12	45.3 lbs. (20.5kg)
24	80.5 lbs. (36.5kg)

HV Mount (shown in Vertical position)Direct Mount Bracket- see page 13 for weight & dimensions

				HV		E							
Product	Optic			Mounting	LED Count (x10)	Series	Voltage	Color Options	Drive Current	Options	ions		
ARE-EHO	ZM Type II Medium 2MB Type II Medium W/BLS 3M Type III Medium 15 15 Flood 25 Flood	3MB Type III Medium W/BLS 4M Type IV Medium 4MB Type IV Medium W/BLS 40 40 70 70° Flood	5M Type V Medium 5S Type V Short AF Automotive Frontline- Optic™ SN Sign N6 NEMA® 6	HV Horizontal/ Vertical Tenon - For EHO-UNV direct mount bracket, refer to Tenons & Brackets on page 12	12 24	E	UL Universal 120-277V UH Universal 347-480V	BK Black BZ Bronze SV Silver WH White	700 700mA 1000 1000mA	DIM 0-10V Dimming - Control by others - Refer to Dimming spec sheet for details - Can't exceed specified drive current F Fuse - When code dictates fusing, use time detay fuse - Refer to M_Spec sheet for availability with ML options - Not available with UH voltage ML Multi-Level - Refer to M_Spec sheet for details - Intended for downlight applications at 0° tilt - Not available with UH voltage or 240 LEDs with 1000mA drive current	R NEMA® Photocell Receptacle - 3-pin receptacte per ANSI C136.10 - Intended for downlight applications with maximum 45° tilt - Consult factory for vertical tenon application - Photocell and shorting cap by others - Refer to ML spec sheet for availability with ML options 400 K Color Temperature - Minimum 70 CRI - Color temperature per luminaire 50K 5000K Color Temperature - Minimum 90 CRI - Utilizes Cree TrueWhite® Technology - Color temperature per		

NOTE: Price adder may apply depending on configuration












Rev. Date: V7 05/20/2016




^{*}See http://lighting.cree.com/warranty for warranty terms

All published luminaire photometric testing performed to IESNA LM-79-08 standards by a NVLAP accredited laboratory. To obtain an IES file specific to your project consult: www.cree.com/Lighting/Tools-and-Support/Exterior-IES-Configuration-Tool

4M

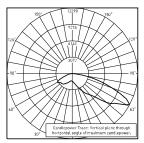

ITL Test Report #: 77685 ARE-EHO-4M-**-12--E-UL-700-50K Initial Delivered Lumens: 19,507

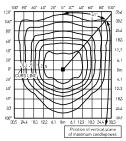


ARE-EH0-4M-**-24--E-UL-1000-40K Mounting Height: 25 (7.6m) A.F.G. Initial Delivered Lumens: 61,352 Initial FC at grade


Type IV Medium Distribution									
LED Count (x10)	4000K		5000K		5700K	5700K			
	Initial Delivered Lumens*	BUG Ratings** Per TM-15-11	Initial Delivered Lumens*	BUG Ratings** Per TM-15-11	Initial Delivered Lumens*	BUG Ratings** Per TM-15-11			
700mA									
12	22,829	B3 U1 G3	18,088	B3 U1 G3	23,707	B3 U1 G3			
24	45,687	B5 U1 G4	36,199	B4 U1 G4	47,445	B5 U1 G4			
1000mA	1000mA								
12	30,656	B4 U1 G4	24,289	B3 U1 G3	31,835	B4 U1 G4			
24	61,352	B5 U1 G5	48,609	B5 U1 G5	63,711	B5 U1 G5			

^{*} Initial delivered lumens at 25°C (77°F). Actual production yield may vary between -10 and +10% of initial delivered lumens

4MB

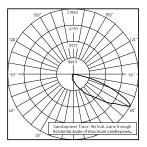

ITL Test Report #: 78734 ARE-EHO-4MB-**-12-E-UL-1000-40K Initial Delivered Lumens: 25,113

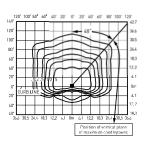

ARE-EHO-4MB-**-24-E-UL-1000-40K Mounting Height: 25 (7.6m) A.F.G. Initial Delivered Lumens: 46,213 Initial FC at grade

Type IV Medium w/BLS Distribution									
LED Count (x10)	4000K		5000K		5700K				
	Initial Delivered Lumens*	BUG Ratings** Per TM-15-11	Initial Delivered Lumens*	BUG Ratings** Per TM-15-11	Initial Delivered Lumens*	BUG Ratings** Per TM-15-11			
700mA	700mA								
12	17,196	B2 U1 G3	13,625	B1 U1 G2	17,857	B2 U1 G3			
24	34,414	B2 U1 G4	27,266	B2 U1 G4	35,738	B3 U1 G4			
1000mA									
12	23,092	B2 U1 G3	18,296	B2 U1 G3	23,980	B2 U1 G4			
24	46,213	B3 U1 G5	36,615	B3 U1 G4	47,990	B3 U1 G5			

^{*} Initial delivered lumens at 25°C (77°F). Actual production yield may vary between -10 and +10% of initial delivered lumens

^{**} For more information on the IES BUG (Backlight-Uplight-Glare) Rating visit: www.ies.org/PDF/Erratas/TM-15-11BugRatingsAddendum.pdf, Valid with no tilt


[&]quot;umens
"* For more information on the IES BUG (Backlight-Uplight-Glare) Rating visit:
www.ies.org/PDF/Erratas/TM-15-11BugRatingsAddendum.pdf, Valid with no tilt

HV Mount [shown in vertical position] 120 LED 16.5" [419mm] 240 LED 33.6" [853mm] 30.0" [762mm]

Direct Mount Bracket (accessory sold separately)

120 LED

(853mm)

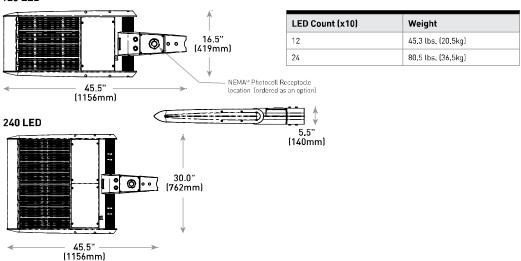

Weight

45.3 lbs. (20.5kg)

80.5 lbs. (36.5kg)

Canada: www.cree.com/canada

Cree Edge™ Series

LED Security Wall Pack Luminaire

Product Description

The Cree Edge™ wall mount luminaire has a slim, low profile design. The luminaire end caps are made from rugged die cast aluminum with integral, weathertight LED driver compartments and high performance aluminum heat sinks specifically designed for LED applications. Housing is rugged aluminum. Includes a lightweight mounting box for installation over standard and mud ring single gang J-Boxes. Secures to wall with four 3/16" (5mm) screws (by others). Conduit entry from top, bottom, sides and rear. Allows mounting for uplight or downlight. Designed and approved for easy through-wiring. Includes leaf/debris guard.

Applications: General area and security lighting

Performance Summary

Patented NanoOptic® Product Technology

Made in the U.S.A. of U.S. and imported parts

CRI: Minimum 70 CRI

CCT: 4000K (+/- 300K), 5700K (+/- 500K) standard


Limited Warranty*: 10 years on luminaire/10 years on Colorfast DeltaGuard® finish

Accessories

Field-Installed	
Bird Spikes	Hand-Held Remote
XA-BRDSPK	XA-SENSREM
	 For successful implementation of the programmable multi-level option, a minimum of one hand-held remote is required

604 S. Point Road



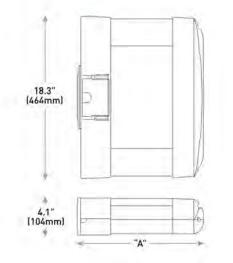

LED Count (x10)	Dim. "A"	Weight
02	9.9" (251mm)	20 lbs. [9.1kg]
04	11.9" (303mm)	22 lbs. [10.0kg]
06	13.9" (353mm)	25 lbs. [11.3kg]
08	15.9" [404mm]	27 lbs. [12.2kg]
10	17.9" (455mm)	31 lbs. (14.1kg)
12	19.9" (505mm)	32 lbs. (14.5kg)

Ordering Information

Example: SEC-EDG-2M-WM-06-E-UL-SV-700

SEC-EDG		WM		E				
Product	Optic	Mounting	Count (x10)	Series	Voltage	Color Options	Drive Current	Options
SEC-EDG	2M Type II Medium 2MB Type II Medium w/BLS 2S Type II Short 2SB Type II Short w/BLS 3M Type III Medium 3MB Type III Medium 4MB Type IV Medium 4MB Type IV Medium w/BLS	WM Wall Mount	02 04 06 08 10 12	E	UL Universal 120-277V UH Universal 347-480V 34 347V	BK Black BZ Bronze SV Silver WH White	350 350mA 525 525mA -Available with 20-80 LEDs 700 700mA -Available with 20-60 LEDs	DIM 0-10V Dimming - Control by others - Refer to Dimming spec sheet for details - Can't exceed specified drive current F Fuse - Refer to ML spec sheet for availability with ML option - Available with UL voltage only - When code dictates fusing, use time delay fuse ML Multi-Level - Refer to ML spec sheet for details - Intended for downlight applications of 0° tilt P Photocell - Refer to ML spec sheet for availability with ML option - Must specify UL or 34 voltage PML Programmable Multi-Level - Refer to PML spec sheet for details - Intended for downlight applications of 0° tilt 40K 4000K Color Temperature - Minimum 70 CRI - Color temperature per luminaire









See http://lighting.cree.com/warranty for warranty terms

All published luminaire photometric testing performed to IESNA LM-79-08 standards by a NVLAP accredited laboratory. To obtain an IES file specific to your project consult: http://lighting.cree.com/products/outdoor/wall-mount/cree-edge-series-5


4M

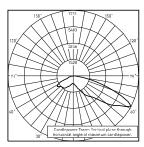

ITL Test Report #: 78793 SEC-EDG-4M-**-06-E-UL-700-40K Initial Delivered Lumens: 11,607

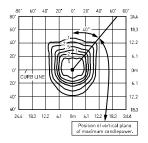


SEC-EDG-4M-**-08-E-UL-525-40K Mounting Height: 10' (3.0m) A.F.G. Initial Delivered Lumens: 11,835 Initial FC at grade

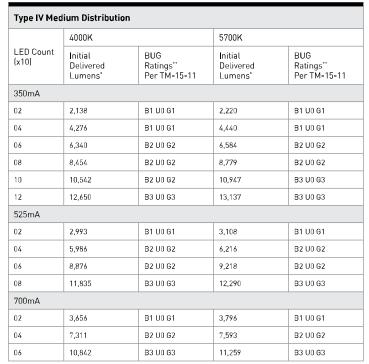

4MB

CSA Test Report #: 6449 ARE-EDG-4MB-**-12-E-UL-525-40K Initial Delivered Lumens: 13,155

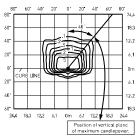

SEC-EDG-4MB-**-08-E-UL-525-40K Mounting Height: 10 (3.0m) A.F.G. Initial Delivered Lumens: 8,915 Initial FC at grade

Type IV Medium Distribution w/BLS							
	4000K		5700K				
LED Count (x10)	Initial Delivered Lumens*	BUG Ratings** Per TM-15-11	Initial Delivered Lumens*	BUG Ratings** Per TM-15-11			
350mA							
02	1,610	B0 U0 G1	1,672	B0 U0 G1			
04	3,221	B1 U0 G1	3,345	B1 U0 G1			
06	4,776	B1 U0 G1	4,959	B1 U0 G1			
08	6,368	B1 U0 G2	6,613	B1 U0 G2			
10	7,941	B1 U0 G2	8,246	B1 U0 G2			
12	9,529	B1 U0 G2	9,895	B1 U0 G2			
525mA							
02	2,254	B0 U0 G1	2,341	B0 U0 G1			
04	4,509	B1 U0 G1	4,682	B1 U0 G1			
06	6,686	B1 U0 G2	6,943	B1 U0 G2			
08	8,915	B1 U0 G2	9,258	B1 U0 G2			
700mA							
02	2,754	B0 U0 G1	2,860	B0 U0 G1			
04	5,507	B1 U0 G1	5,719	B1 U0 G2			
06	8,167	B1 U0 G2	8,481	B1 U0 G2			

Canada: www.cree.com/canada

© 2016 Cree, Inc. and/or one of its subsidiaries. All rights reserved. For informational purposes only. Content is subject to change. Patent www.cree.com/patents. Cree®, NanoOptic®, and Colorfast DeltaGuard® are registered trademarks, and the Cree logo and Cree Edge[™] are trademarks of Cree, Inc. The UL logo is a registered trademark of UL LLC. The DLC QPL logo is a registered trademarks of Northeast Energy Efficiency Partnerships, Inc.




^{*} Initial delivered lumens at 25°C (77°F)

** For more information on the IES BUG (Backlight-Uplight-Glare) Rating visit:
www.ies.org/PDF/Erratas/TM-15-11BugRatingsAddendum.pdf

^{*} Initial delivered lumens at 25°C (77°F)

** For more information on the IES BUG (Backlight-Uplight-Glare) Rating visit: www.ies.org/PDF/Erratas/TM-15-11BugRatingsAddendum.pdf



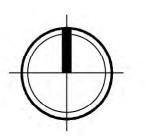






Site Plan
Lot 3 of 1000 Oaks Plat
604 S. Point Rd., Madison, WI
October 12, 2016



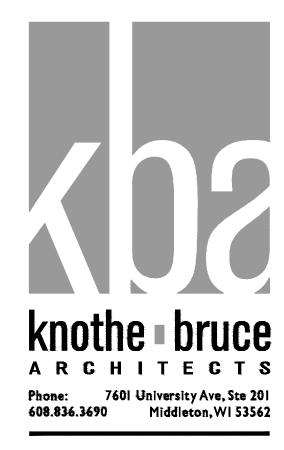

ISSUED Issued for Land Use: September 07, 2016 Issued for Land Use Supplement: Sept 12, 2016

PROJECT TITLE

Lot 3 of 1000 Oaks Plat

604 S. Point Rd. Madison, WI


SHEET TITLE
Site Plan

SHEET NUMBER





PROJECT NO.

1621 © Knothe & Bruce Architects, LLC

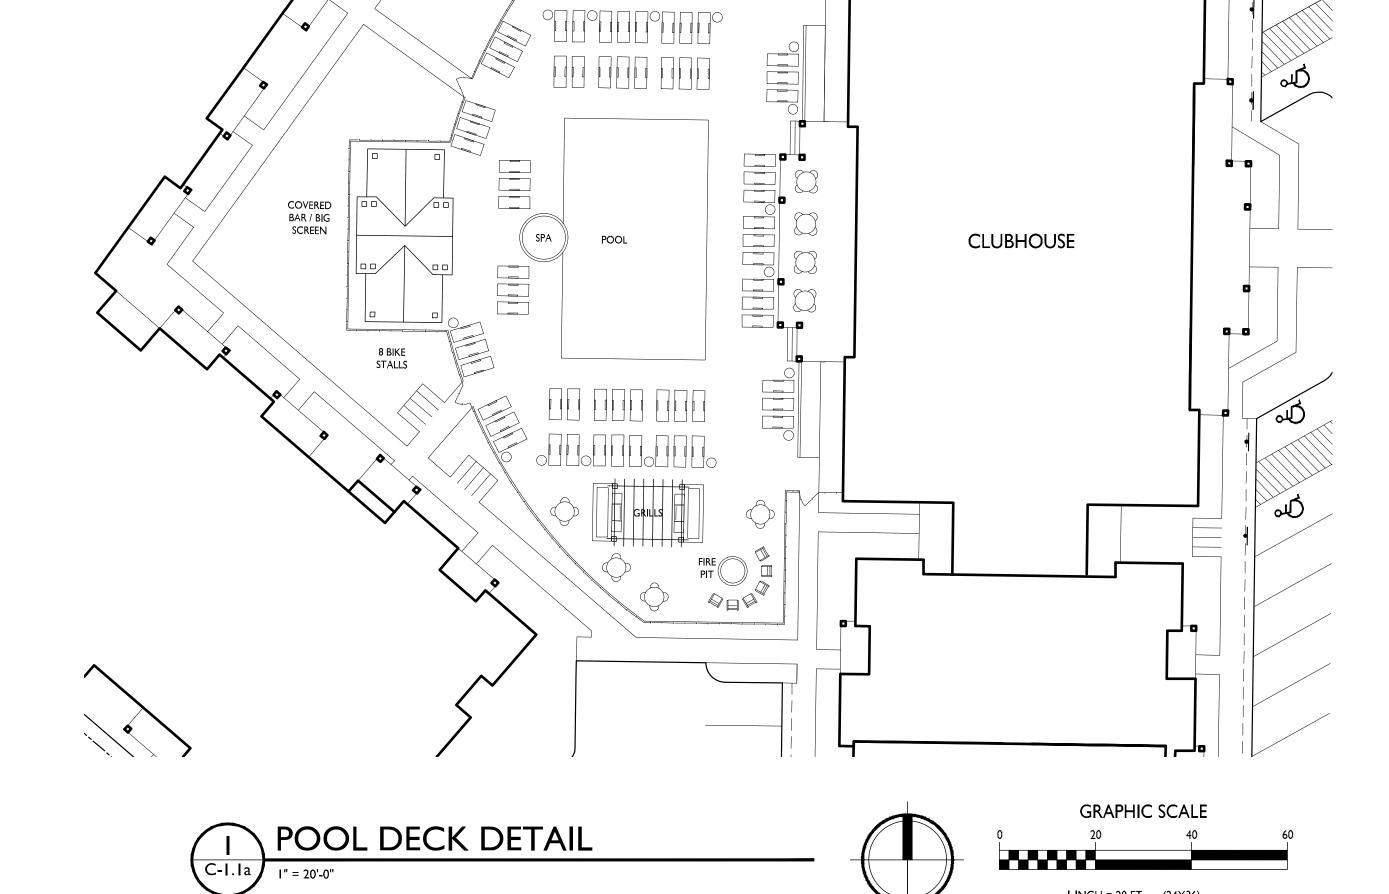

I INCH = 20 FT (24X36)

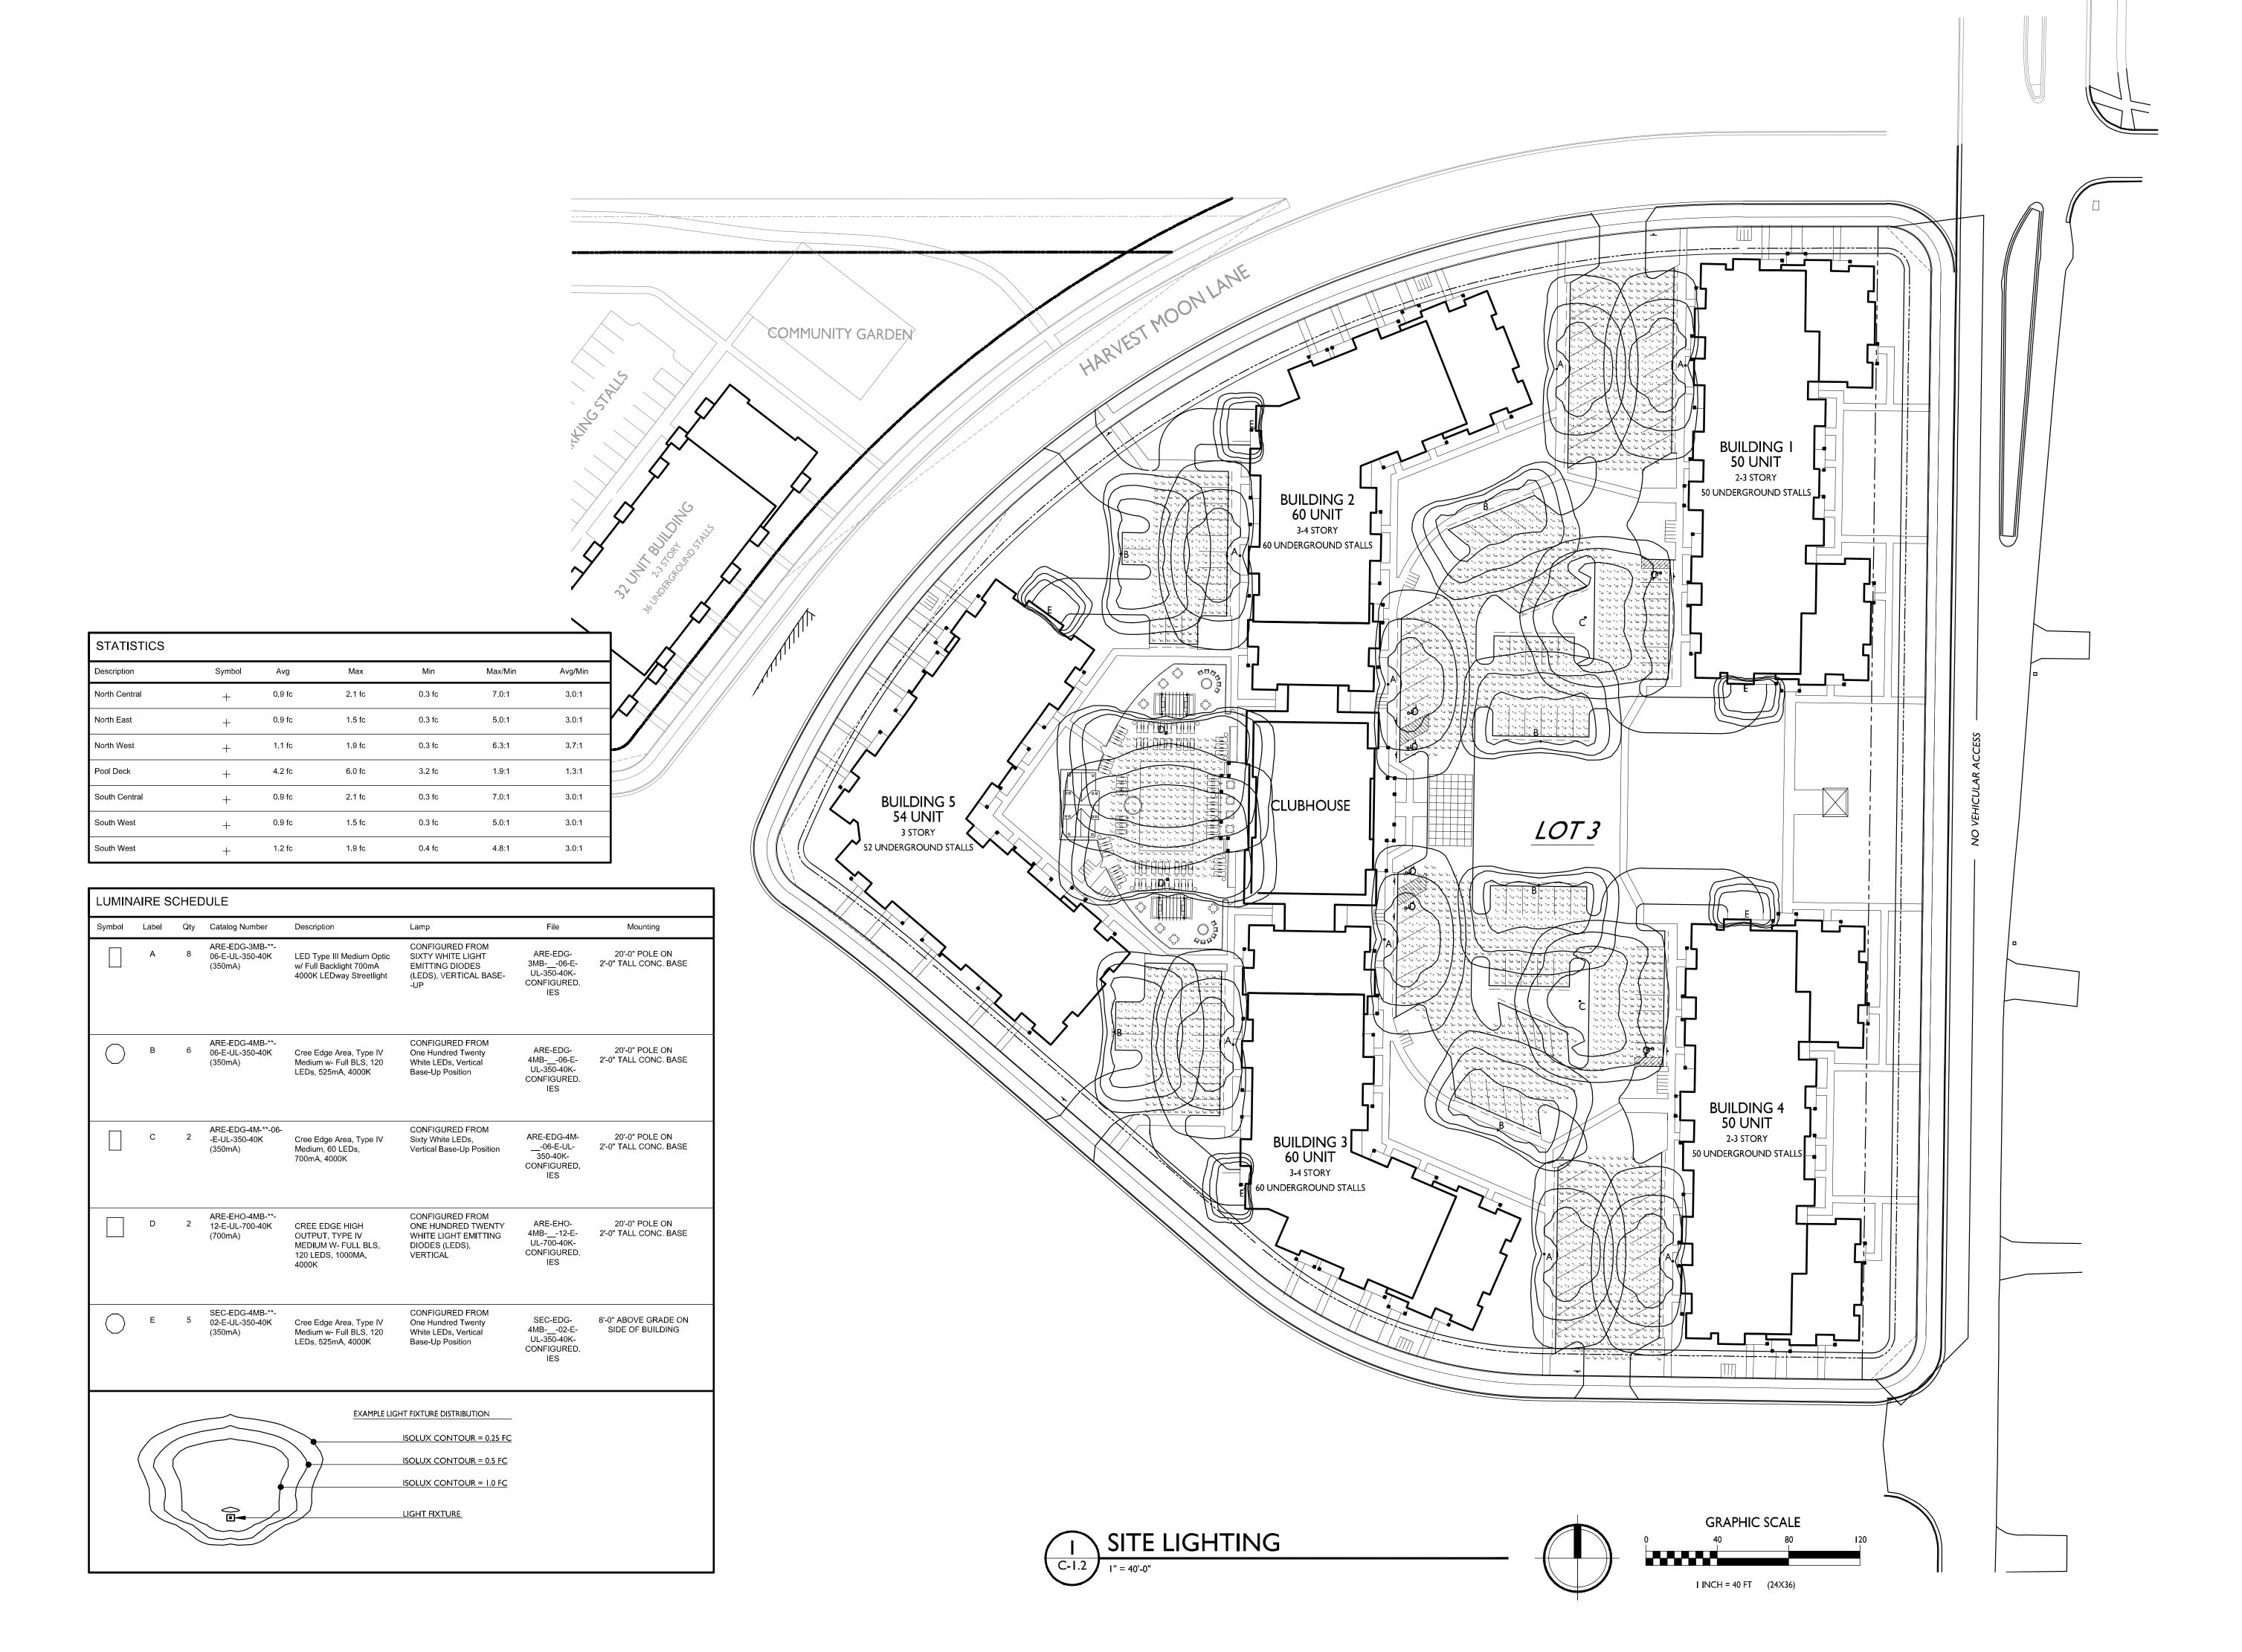

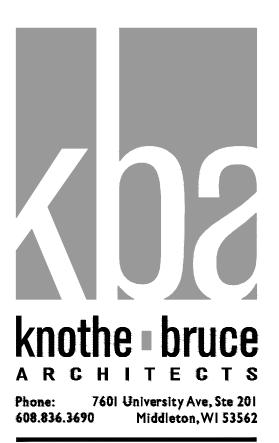


ISSUED Issued for Land Use: September 07, 2016 Issued for UDC - October 12, 2016

PROJECT TITLE Lot 3 of 1000 Oaks Plat

604 S. Point Rd. Madison, WI SHEET TITLE Site Lighting

SHEET NUMBER

PROJECT NO.

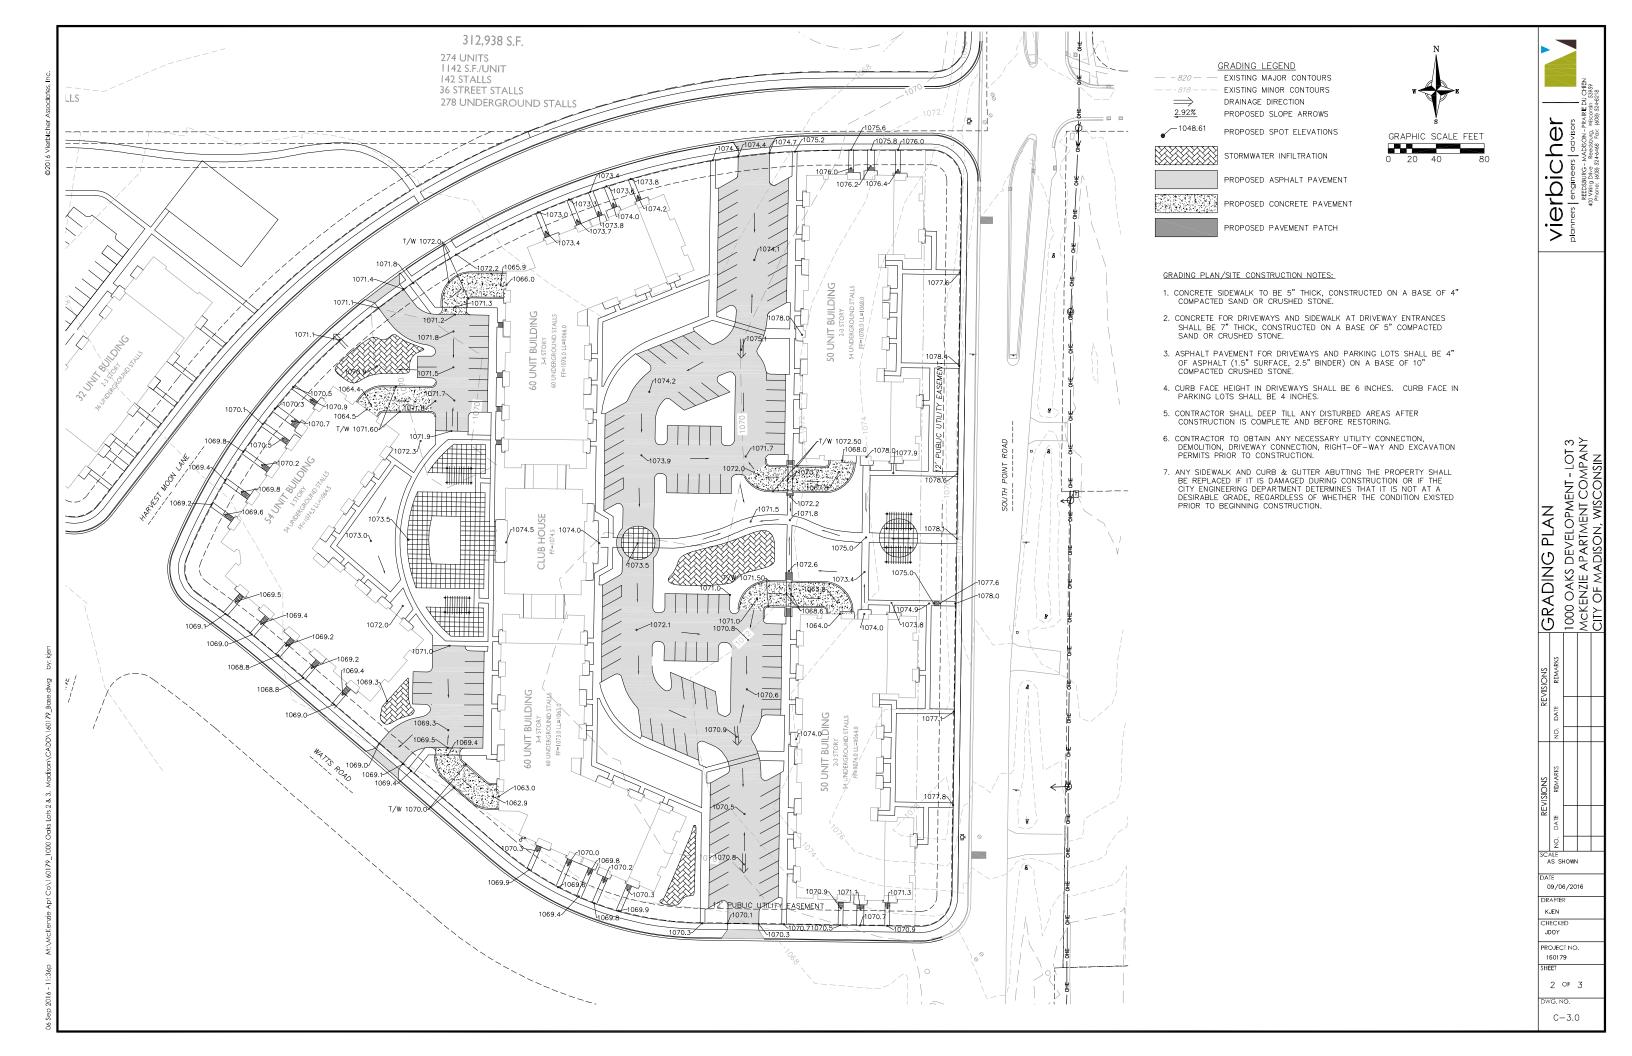

and the state of t		SUBTOTAL	0	SUBTOTAL	3550
Ornamental / decorativefencing or wall (per 10 ln. ft.)	4		0		0
Ornamental Grasses 18" or 3 gallon container)	2		0		0
Shrub, evergreen (18" or 3 gallon container)	3		0		ò
Shrub, deciduous (18" or 3 gal. container)	2		0		0
Evergreen Tree (3 feet tall)	15		0	11	165
Ornamental Tree (1.5" caliper)	15		0	39	585
Overstory deciduous tree (2.5" caliper)	35		0	80	2800
PLANT TYPE (MINIMUM SIZE)	POINTS VALUE	QUANTITY	POINTS	QUANTITY	POINTS
	CREDITS FOR EXISTING LANDSCAPING		71017 11117	PROPOSED LANDSCAPING	
LANDSCAPE POINTS CALCULATION		ODEDITO FOR	EVICTING	ppers	055
Required Landscape Points (Units x 5 points)	3432				
Required Landscape Units (Total / 300 sq ft)	686				
Total Developed Square Footage	205,905				

	Scientific Name	Common Name	Size	Quantity	Root
OVERS	TORY DECIDUOUS TREES				
AF	Acer x freemanii 'Jeffersred'	Autumn Blaze Maple	2.5"	13	B&B
BN	Betula nigra	River Birch	2.5"	6	B&B
CO	Celtis occidentalis	Common Hackberry	2.5"	8	B&B
GB	Ginkgo biloba 'Autumn Gold'	Autumn Gold Ginkgo	2.5"	7	B&B
GD	Gymnocladus diocus	Kentucky Coffeetree	2.5"	6	B&B
GT	Gleditsia triacanthos var. inermis 'Skyline'	Skyline Honeylocust	2.5"	8	B&B
QB	Quercus bicolor	Swamp White Oak	2.5"	6	B&B
QM	Quercus muehlenbergii	Chinquapin Oak	2.5"	10	B&B
TA	Tilia americana 'Redmond'	Greenspire Littleleaf Linden	2.5"	7	B&B
UH	Ulmus 'Homestead'	New Horizon Elm	2.5"	8	B&B
ORNAM	ENTAL TREES				
CC	Crataegus crus-galli var. inermis 'Cruzam'	Crusader Thornless Cockspur Hawthorn	2"	13	B&B
PC	Pyrus calleryana 'Chanticleer'	Chanticleer Callery Pear	1.75"	21	B&B
SR	Syringa reticulata	Japanese Tree Lilac	2"	10	
EVERGI	REEN TREES				
PG	Picea glauca var. densata	Black Hills Spruce	6'	10	B&B

GENERAL NOTES:

BARK MULCH TO BE BROWN DYED, RECYCLED HARDWOOD, WITH PRE-EMERGENT HERBICIDE.
WASHED STONE TO BE 1.5" CAPITOL WASHED WITH WEED BARRIER FABRIC.
BED EDGING TO BE DIMEX EDGEPRO BLACK LANDSCAPE EDGING

STREET TREE NOTES:

• EXISTING TERRACE TREES TO REMAIN.

BIKE PARKING AND AMENITIES NOTES:

• SEE SITE PLAN FOR DETAILED LAYOUT

TALL DECIDUOUS SHRUBS				
Cornus stolonifera 'Baileyi'	Bailey Red Twigged Dogwood	36"	Cont.	
Euonymus alatus 'Compactus'	Compact Burningbush	36"	Cont.	
Viburnum lantana 'Mohican'	Mohican Viburnum	36"	Cont.	
Syringa meyeri 'Palibin'	Palibin Lilac	36"	Cont.	Γ
MEDIUM DECIDUOUS SHRUE Cornus sericea 'Alleman's Compact'	Allemans Compact Dogwood	24"	Cont.	Γ
Cornus sericea 'Alleman's Compact'		24"	Cont.	Γ
Hydrangea macrophylla 'All Summer Beauty'	All Summer Beauty Hydrangea	24"	Cont.	L
Hydrangea arborescens 'Annabelle'	Annabelle Hydrangea	24"	Cont.	
	Ailiabelle Hydrangea			
Aronia melanocarpa variety elata	Glossy Black Chokeberry	24"	Cont.	

Forsythia viridissima 'Bronxensis'	Bronxensis Dwarf Forsythia	18"	Cont.
Weigela florida 'Minuet'	Minuet Weigela	18"	Cont.
Spirea japonica 'Neon Flash'	Neon Flash Spirea	18"	Cont.
Spirea japonica 'Shirobana'	Shirobana Spirea	18"	Cont.
		24"	Cont
MEDIUM EVERGREEN SHR Taxus x media 'Tauntonii'	UBS Taunton Yew	24"	Cont.
Taxus x media 'Tauntonii'	Taunton Yew	24"	Cont.
MEDIUM EVERGREEN SHR Taxus x media 'Tauntonii' LOW EVERGREEN SHRUBS Juniperus horizontalis 'Prince of Wales'	Taunton Yew	24"	Cont.

NTAL GRASSES		
Autumn Joy Sedum	#1	Cont.
Fanal Astilbe	#1	Cont.
Goblin Blanketflower	#1	Cont.
Hameln Dwarf Fountain Grass	#1	Cont.
Karl Foerster Reed Grass	#1	Cont.
Krossa Regal Hosta	#1	Cont.
Paprika Yarrow	#1	Cont.
Pardon Me Daylily	#1	Cont.
Rozanne Geranium	#1	Cont.
Zagreb Coreopsis	#1	Cont.
	Fanal Astilbe Goblin Blanketflower Hameln Dwarf Fountain Grass Karl Foerster Reed Grass Krossa Regal Hosta Paprika Yarrow Pardon Me Daylily Rozanne Geranium	Autumn Joy Sedum #1 Fanal Astilbe #1 Goblin Blanketflower #1 Hameln Dwarf Fountain Grass #1 Karl Foerster Reed Grass #1 Krossa Regal Hosta #1 Paprika Yarrow #1 Pardon Me Daylily #1 Rozanne Geranium #1



3570 Pioneer Road Verona, WI 53593 PH: (608) 827-9401 FAX: (608) 827-9402 WEB: www.olsontoon.com

> 1000 OAKS South Point Road


PRELIMINARY LANDSCAPE PLAN

Date: 9/7/16
Scale: 1" = 40'-0"
Designer: mm
Job # 6566

Seal:
To protect against legal liability, the plans presented herein are "schematic," and should not be outsourced as "biddable" or "construction documents" unless approved by the Landscape Designer. This is not an original document unless stamped in

Revisions: 2016.10.12 mm

Reference Name: McKenzie Apartments - 1000 Oaks

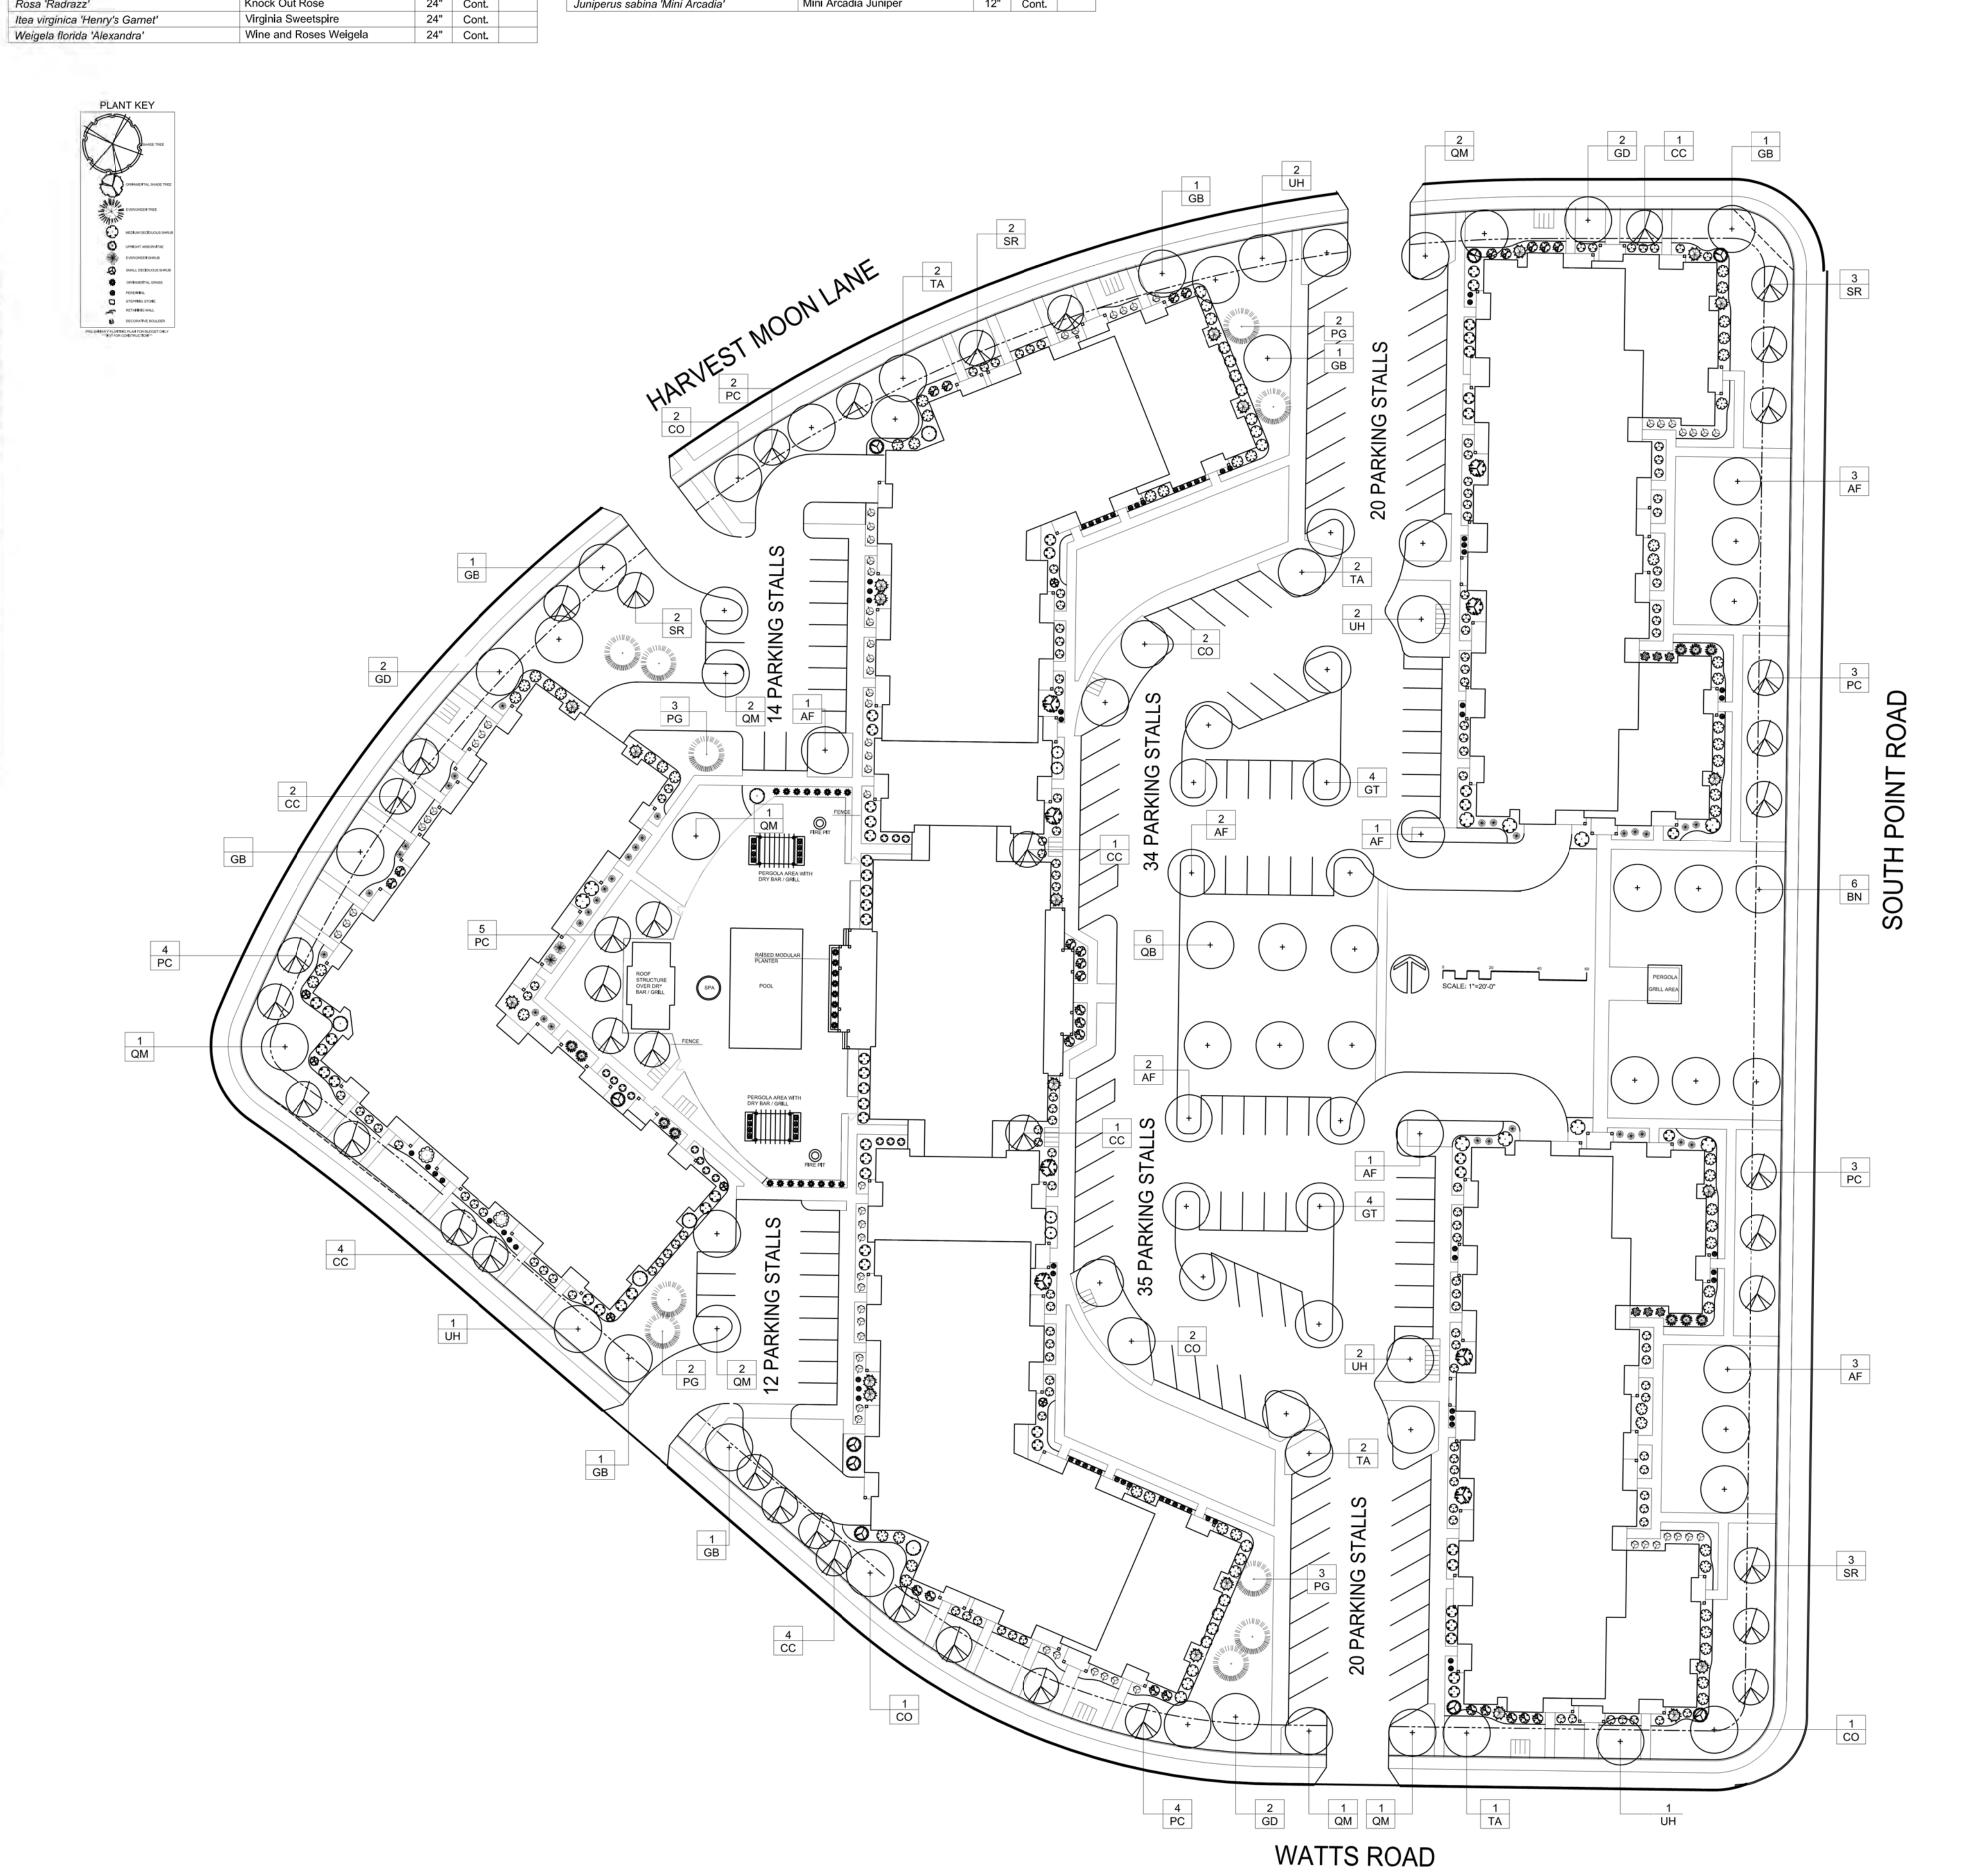







ISSUED

Issued for Land Use - September 7, 2016
Issued for Land Use Supplement - Sept. 12, 2016

BUILDING I EAST ELEVATION ALONG SOUTH POINT ROAD



BUILDING I NORTH ELEVATION ALONG HARVEST MOON LANE

EXTERIOR MATERIAL SCHEDULE		
ROOF	GAF BURNT SIENNA	
MASONRY	NSVI "WOODLAND"	
MASONRY ACCENTS	EDWARDS CAST STONE DC-018	
HORIZONTAL SIDING	COMPOSITE - ENDURING BRONZE SW7055	
SHAKE SIDING	COMPOSITE - UMBER RUST SW9100	
FASCIA / SOFFIT / TRIM	COMPOSITE - ROYCROFT SUEDE SW2842	
WINDOWS	WEATHER-SHIELD TAN	
RAILING	ALUMINUM - BRONZE	
BUILDING ENTRANCES	ALUMINUM STOREFRONT - BRONZE	

PROJECT TITLE

Lot 3 of 1000

Oaks Plat

604 S. Point Rd. Madison, WI

SHEET TITLE
Elevations -


Elevations Building I

SHEET NUMBER

A-2.1

PROJECT NO. 1621
© Knothe & Bruce Architects, LLC

EXTERIOR MATERIAL SCHEDULE		
ROOF	GAF BURNT SIENNA	
MASONRY	NSVI "WOODLAND"	
MASONRY ACCENTS	EDWARDS CAST STONE DC-018	
HORIZONTAL SIDING	COMPOSITE - ENDURING BRONZE SW7055	
SHAKE SIDING	COMPOSITE - UMBER RUST SW9100	
FASCIA / SOFFIT / TRIM	COMPOSITE - ROYCROFT SUEDE SW2842	
WINDOWS	WEATHER-SHIELD TAN	
RAILING	ALUMINUM - BRONZE	
BUILDING ENTRANCES	ALUMINUM STOREFRONT - BRONZE	

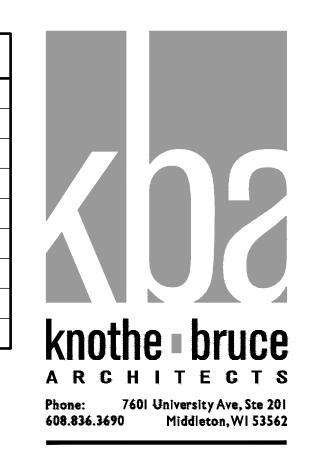









PROJECT TITLE

Lot 3 of 1000 Oaks Plat

604 S. Point Rd. Madison, WI


SHEET TITLE Elevations -Building I

SHEET NUMBER

A-2.2

PROJECT NO.

EXTERIOR MATERIAL SCHEDULE		
ROOF	GAF BURNT SIENNA	
MASONRY	NSVI "WOODLAND"	
MASONRY ACCENTS	EDWARDS CAST STONE DC-018	
HORIZONTAL SIDING	COMPOSITE - ENDURING BRONZE SW7055	
shake siding	COMPOSITE - UMBER RUST SW9100	
FASCIA / SOFFIT / TRIM	COMPOSITE - ROYCROFT SUEDE SW2842	
WINDOWS	WEATHER-SHIELD TAN	
RAILING	ALUMINUM - BRONZE	
BUILDING ENTRANCES	ALUMINUM STOREFRONT - BRONZE	

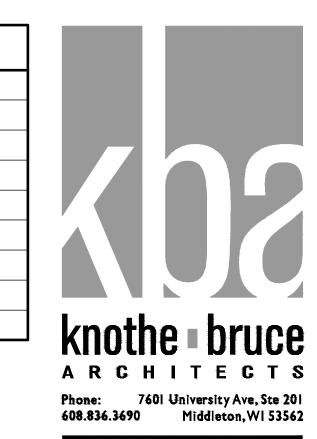



Issued for Land Use - September 7, 2016 Issued for Land Use Supplement - Sept. 12, 2016

BUILDING 2/CLUBHOUSE EAST ELEVATION



BUILDING 2/CLUBHOUSE NORTHEAST ELEVATION 1/8"=1'-0"

TYPICAL MATERIALS —ASPHALT SHINGLES HEAVY TIMBER/COMPOSITE BRACKETS HORIZONTAL COMPOSITE SIDING —COMPOSITE TRIM —COMPOSITE SHAKES —ALUMINUM RAILINGS —CAST STONE SILLS & BANDS -STONE VENEER

604 S. Point Rd. Madison, WI SHEET TITLE

PROJECT TITLE

Oaks Plat

Lot 3 of 1000

Elevations -Building 2


SHEET NUMBER

A-2.1

PROJECT NO.

BUILDING 2/CLUBHOUSE SOUTHEAST ELEVATION

EXTERIOR MATERIAL SCHEDULE		
GAF BURNT SIENNA		
NSVI "WOODLAND"		
EDWARDS CAST STONE DC-018		
COMPOSITE - ENDURING BRONZE SW7055		
COMPOSITE - UMBER RUST SW9100		
COMPOSITE - ROYCROFT SUEDE SW2842		
WEATHER-SHIELD TAN		
ALUMINUM - BRONZE		
ALUMINUM STOREFRONT - BRONZE		

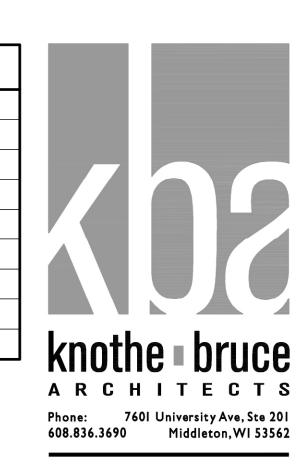



BUILDING 2 NORTHWEST ELEVATION ALONG HARVEST MOON LANE 1/8"=1'-0"


PROJECT TITLE Lot 3 of 1000 Oaks Plat

604 S. Point Rd. Madison, WI SHEET TITLE Elevations -Building 2

SHEET NUMBER

A-2.2

PROJECT NO.

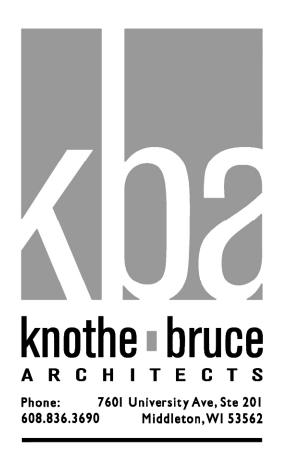



Issued for Land Use - September 7, 2016
Issued for Land Use Supplement - Sept. 12, 2016

PROJECT TITLE Lot 3 of 1000 Oaks Plat

BUILDING 2 & 3/CLUBHOUSE EAST ELEVATION

EXTERIOR MATERIAL SCHEDULE		
ROOF	GAF BURNT SIENNA	
MASONRY	NSVI "WOODLAND"	
MASONRY ACCENTS	EDWARDS CAST STONE DC-018	
HORIZONTAL SIDING	COMPOSITE - ENDURING BRONZE SW7055	
SHAKE SIDING	COMPOSITE - UMBER RUST SW9100	
FASCIA / SOFFIT / TRIM	COMPOSITE - ROYCROFT SUEDE SW2842	
WINDOWS	WEATHER-SHIELD TAN	

ALUMINUM - BRONZE

ALUMINUM STOREFRONT - BRONZE

RAILING

BUILDING ENTRANCES

604 S. Point Rd. Madison, WI SHEET TITLE


Elevations -Building 2 & 3

SHEET NUMBER

A-2.3

PROJECT NO. © Knothe & Bruce Architects, LLC

EXTERIOR MATERIAL SCHEDULE		
ROOF	GAF BURNT SIENNA	
MASONRY	NSVI "WOODLAND"	
MASONRY ACCENTS	EDWARDS CAST STONE DC-018	
HORIZONTAL SIDING	COMPOSITE - ENDURING BRONZE SW7055	
SHAKE SIDING	COMPOSITE - UMBER RUST SW9100	
FASCIA / SOFFIT / TRIM	COMPOSITE - ROYCROFT SUEDE SW2842	
WINDOWS	WEATHER-SHIELD TAN	
RAILING	ALUMINUM - BRONZE	
BUILDING ENTRANCES	ALUMINUM STOREFRONT - BRONZE	

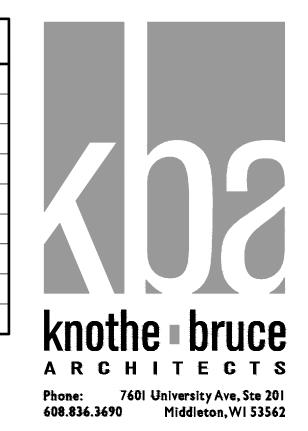



ISSUED
Issued for Land Use - September 7, 2016
Issued for Land Use Supplement - Sept. 12, 2016

PROJECT TITLE

Lot 3 of 1000

Oaks Plat

604 S. Point Rd. Madison, WI

SHEET TITLE
Elevations Building 3

SHEET NUMBER

A-2.1

PROJECT NO. 162 | Contract of the line of






BUILDING 3 NORTHEAST ELEVATION BUILDING 3
SOUTHEAST ELEVATION

1/8"=1'-0"

EXTERIOR MATERIAL SCHEDULE		
ROOF	GAF BURNT SIENNA	
MASONRY	NSVI "WOODLAND"	
MASONRY ACCENTS	EDWARDS CAST STONE DC-018	
HORIZONTAL SIDING	COMPOSITE - ENDURING BRONZE SW7055	
SHAKE SIDING	COMPOSITE - UMBER RUST SW9100	
FASCIA / SOFFIT / TRIM	COMPOSITE - ROYCROFT SUEDE SW2842	
WINDOWS	WEATHER-SHIELD TAN	
RAILING	ALUMINUM - BRONZE	
BUILDING ENTRANCES	ALUMINUM STOREFRONT - BRONZE	

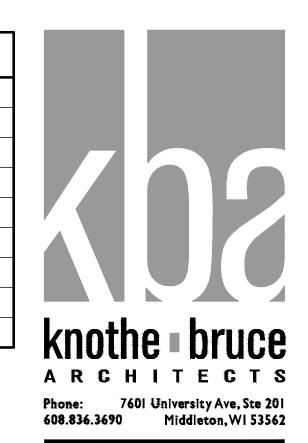



ISSUED
Issued for Land Use - September 7, 2016
Issued for Land Use Supplement - Sept. 12, 2016

PROJECT TITLE

Lot 3 of 1000

Oaks Plat

604 S. Point Rd. Madison, WI

Elevations Building 3

SHEET NUMBER

A-2.2


© Knothe & Bruce Architects, LLC

1621

PROJECT NO.



EXTERIOR MATERIAL SCHEDULE		
ROOF	gaf burnt sienna	
MASONRY	NSVI "WOODLAND"	
MASONRY ACCENTS	EDWARDS CAST STONE DC-018	
HORIZONTAL SIDING	COMPOSITE - ENDURING BRONZE SW7055	
SHAKE SIDING	COMPOSITE - UMBER RUST SW9100	
FASCIA / SOFFIT / TRIM	COMPOSITE - ROYCROFT SUEDE SW2842	
WINDOWS	WEATHER-SHIELD TAN	
RAILING	ALUMINUM - BRONZE	
BUILDING ENTRANCES	ALUMINUM STOREFRONT - BRONZE	

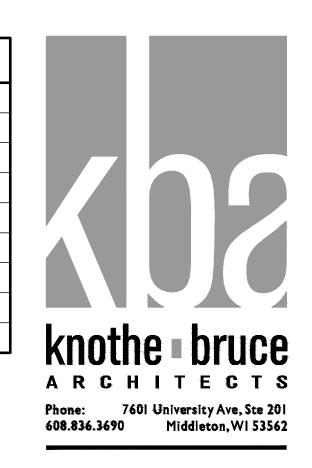



Issued for Land Use - September 7, 2016 Issued for Land Use Supplement - Sept. 12, 2016

BUILDING 4 EAST ELEVATION ALONG SOUTH POINT ROAD



PROJECT TITLE

Lot 3 of 1000 Oaks Plat

604 S. Point Rd. Madison, WI

SHEET TITLE


Elevations -Building 4

SHEET NUMBER

A-2.1

PROJECT NO.

EXTERIOR MATERIAL SCHEDULE		
ROOF	gaf burnt sienna	
MASONRY	NSVI "WOODLAND"	
MASONRY ACCENTS	EDWARDS CAST STONE DC-018	
HORIZONTAL SIDING	COMPOSITE - ENDURING BRONZE SW7055	
SHAKE SIDING	COMPOSITE - UMBER RUST SW9100	
FASCIA / SOFFIT / TRIM	COMPOSITE - ROYCROFT SUEDE SW2842	
WINDOWS	WEATHER-SHIELD TAN	
RAILING	ALUMINUM - BRONZE	
BUILDING ENTRANCES	ALUMINUM STOREFRONT - BRONZE	

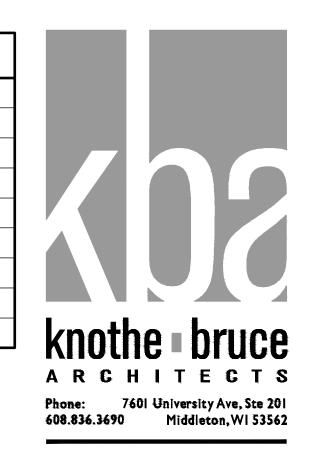



BUILDING 4
WEST ELEVATION



BUILDING 4 SOUTH ELEVATION ALONG WATTS ROAD

PROJECT TITLE Lot 3 of 1000 Oaks Plat

604 S. Point Rd. Madison, WI

SHEET TITLE

Elevations -Building 4

SHEET NUMBER

A-2.2

PROJECT NO.

1621



BUILDING 5
SOUTHWEST ELEVATION ALONG WATTS ROAD

1/8" '= 1'-0"

EXTERIOR MATERIAL SCHEDULE		
ROOF	GAF BURNT SIENNA	
MASONRY	NSVI "WOODLAND"	
MASONRY ACCENTS	EDWARDS CAST STONE DC-018	
HORIZONTAL SIDING	COMPOSITE - ENDURING BRONZE SW7055	
SHAKE SIDING	COMPOSITE - UMBER RUST SW9100	
FASCIA / SOFFIT / TRIM	COMPOSITE - ROYCROFT SUEDE SW2842	
WINDOWS	WEATHER-SHIELD TAN	
RAILING	ALUMINUM - BRONZE	
BUILDING ENTRANCES	ALUMINUM STOREFRONT - BRONZE	



BUILDING 5 SOUTHEAST ELEVATION



ISSUED

Issued for Land Use - September 7, 2016
Issued for Land Use Supplement - Sept. 12, 2016

PROJECT TITLE

Lot 3 of 1000

Oaks Plat

604 S. Point Rd. Madison, WI

SHEET TITLE
Flevation


Elevations -Building 5

SHEET NUMBER

A-2.1

PROJECT NO. 1621

EXTERIOR MATERIAL SCHEDULE		
ROOF	GAF BURNT SIENNA	
MASONRY	NSVI "WOODLAND"	
MASONRY ACCENTS	EDWARDS CAST STONE DC-018	
HORIZONTAL SIDING	COMPOSITE - ENDURING BRONZE SW7055	
SHAKE SIDING	COMPOSITE - UMBER RUST SW9100	
FASCIA / SOFFIT / TRIM	COMPOSITE - ROYCROFT SUEDE SW2842	
WINDOWS	WEATHER-SHIELD TAN	
RAILING	ALUMINUM - BRONZE	
BUILDING ENTRANCES	ALUMINUM STOREFRONT - BRONZE	

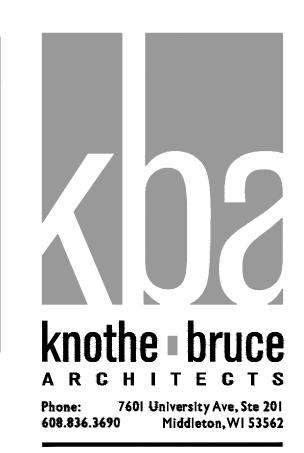



ISSUED Issued for Land Use - September 7, 2016 Issued for Land Use Supplement - Sept. 12, 2016

BUILDING 5 NORTHWEST ELEVATION 1/8"=1'-0"



PROJECT TITLE Lot 3 of 1000 Oaks Plat

604 S. Point Rd. Madison, WI

SHEET TITLE Elevations -Building 5

SHEET NUMBER

A-2.2

PROJECT NO.