### EXISTING SITE PHOTOS:



View Facing Site from South



View facing site from West



### Adjacent site to North



Adjacent Site to South



Aerial View facing NE

# PENNSYLVANIA AVENUE STORAGE BUILDING

# MADISON SQUARE STORAGE, LLC

2230 Pennsylvania Ave Madison, WI 53704

PROJECT TEAM

MADISON SQUARE STORAGE, LLC 902 WILLIAMSON STREET MADISON, WI 53703

OWNER:

CONTACT: ERIC WELCH EMAIL: PAINTINGERICWELCH@GMAIL.COM PHONE: 608-770-4020

ARCHITECT:

ANGUS-YOUNG 555 SOUTH RIVER STREET JANESVILLE, WI 53548

CONTACT: BRANDON ADLER EMAIL: B.ADLER@ANGUSYOUNG.COM PHONE: 608-756-2326

STRUCTURAL ENGINEER: ANGUS-YOUNG

555 SOUTH RIVER STREET

JANESVILLE, WI 53548

CONTACT: CAMERON HEERON EMAIL: C.HEERON@ANGUSYOUNG.COM PHONE: 608-756-2326

LANDSCAPE ARCHITECT:


ANGUS-YOUNG 555 SOUTH RIVER STREET JANESVILLE, WI 53548

CONTACT: KATIE UDELL EMAIL: K.UDELL@ANGUSYOUNG.COM PHONE: 608-756-2326

CIVIL ENGINEER: WYSER ENGINEERING 300 EAST FRONT STREET

MOUNT HOREB, WI 53572

CONTACT: ADAM WATKINS EMAIL: ADAMWATKINS@WYSERENGINEERING.COM PHONE: 608-473-1864

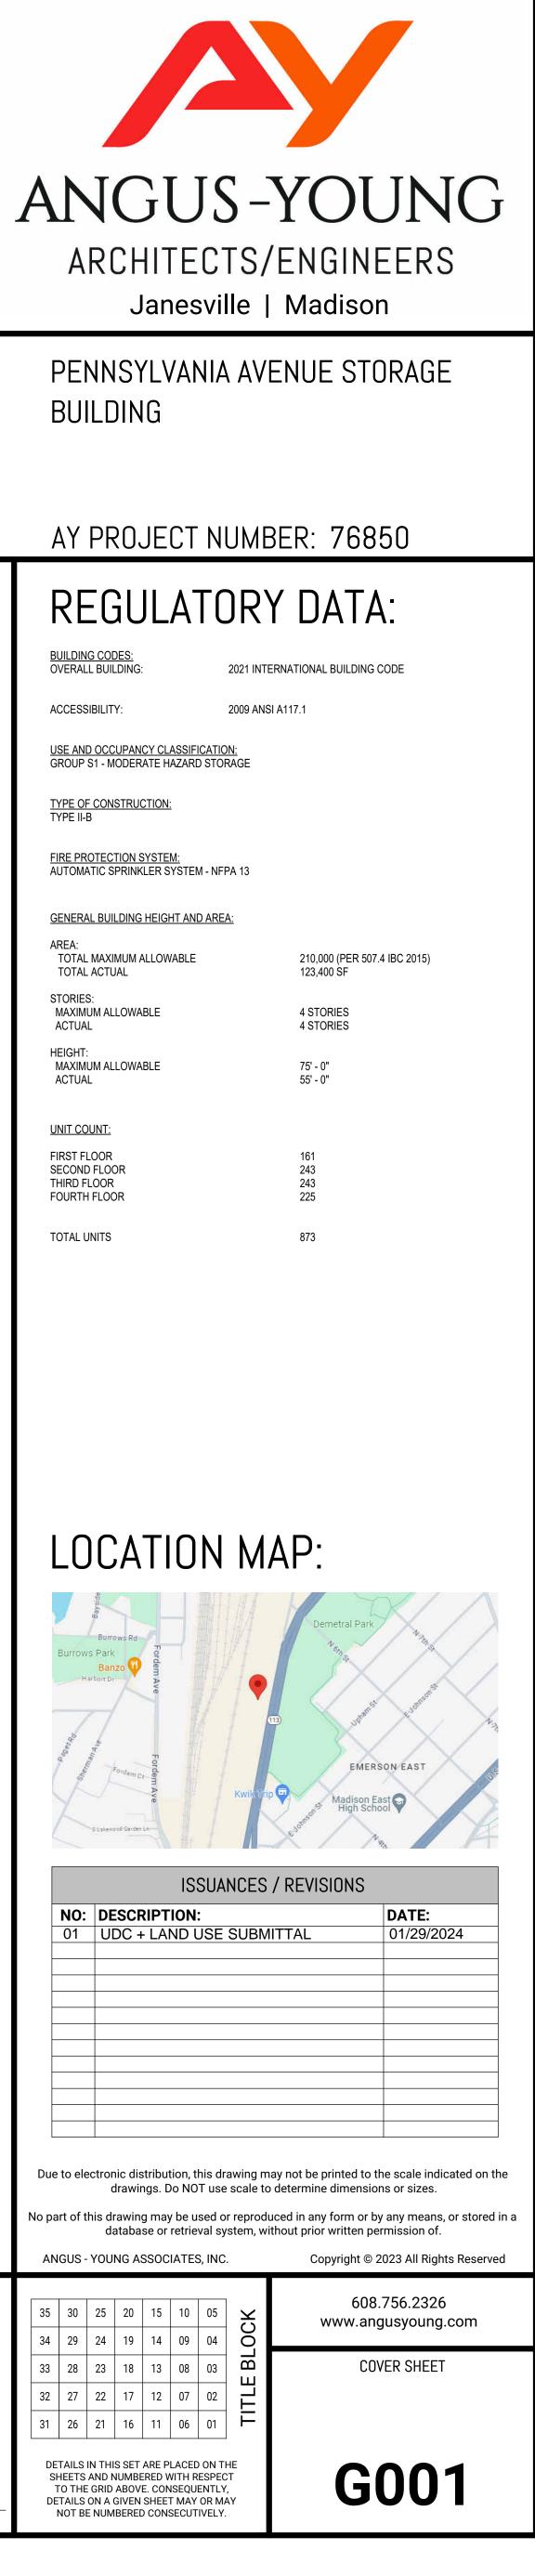


# SHEET INDEX: ALTA/NSPS LAND TITLE SURVEY C001 SITE PLAN C100 FIRE APPARATUS ACCESS PLAN **GRADING & EROSION CONTROL PLAN** C200 DETAIL GRADING PLAN C201 UTILITY PLAN C300 C400 DETAILS LANDSCAPE LANDSCAPE PLAN \_100 ELECTRICAL ES01 SITE LIGHTING PHOTOMETRIC CALCULATIONS ARCHITECTURAL FIRST FLOOR PLAN A101 SECOND FLOOR PLAN THIRD FLOOR PLAN FOURTH FLOOR PLAN ROOF PLAN **EXTERIOR ELEVATIONS - COLOR EXTERIOR ELEVATIONS - COLOR** EXTERIOR ELEVATIONS- B&W A403 A404 EXTERIOR ELEVATIONS - B&W 2 BUILDING SECTIONS **RENDERS 1** RENDERS 2 A003 RENDERS 3 A004 RENDERS 4 A005 PRELIMINARY NOT FOR CONSTRUCTION SCHEMATIC DESIGN SIGN-OFF THESE DRAWINGS HAVE BEEN REVIEWED BY THE OWNER AND ARE ACCEPTED WITH THE CORRECTIONS INDICATED. THE DESIGN CONCEPTS: SITE IMPROVEMENTS; LAYOUT OF WALLS, DOORS AND WINDOWS ON THE FLOOR PLANS; BUILDING SCALE, APPEARANCE AND EXTERIOR MATERIALS WERE REVIEWED. THE CONSTRUCTION BUDGET HAS BEEN REVIEWED AND IS ACCEPTABLE. WITH THIS APPROVAL. THE OWNER ACKNOWLEDGES THE

Date

COMPLETION OF THE SCHEMATIC DESIGN PHASE OF THE PROJECT AND DIRECTS THE ARCHITECT TO PROCEED WITH THE DESIGN DEVELOPMENT

PHASE.

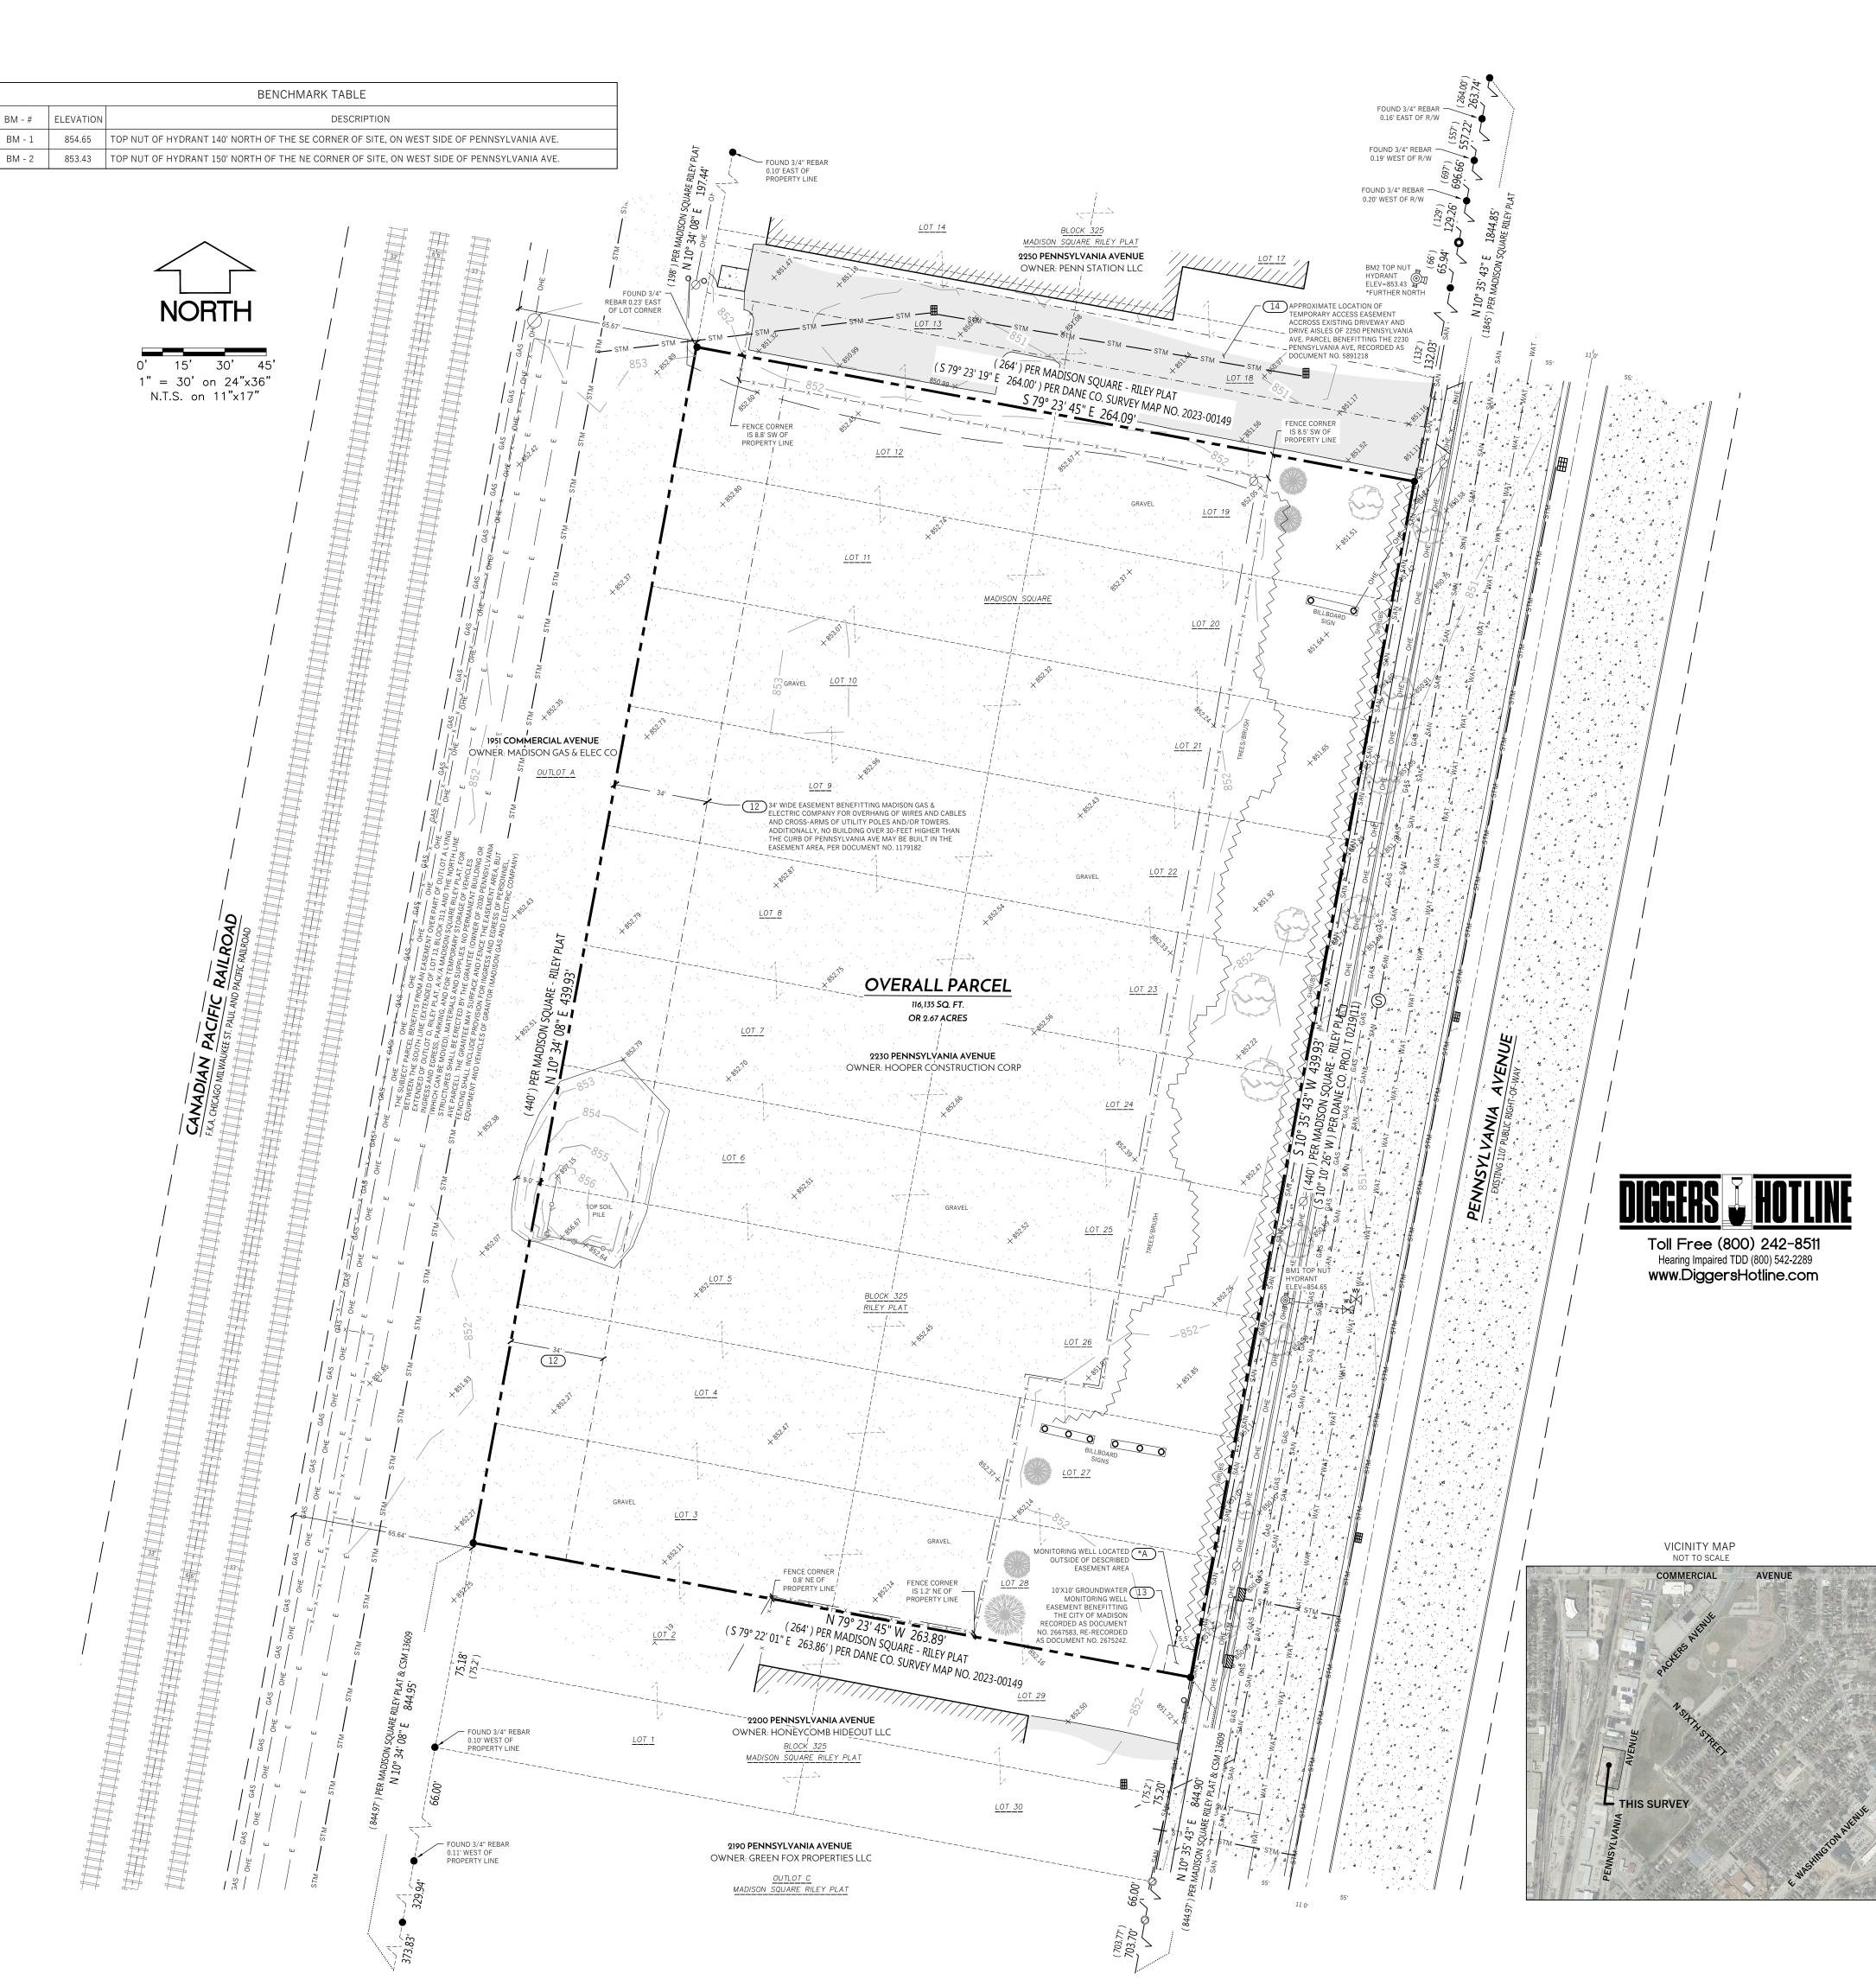

# LEGEND

٢	FOUND PLSS MONUMENT TYPE NOTED		PROPERTY LINE
0	FOUND 1" IRON PIPE		PLATTED LINE
•			RIGHT-OF-WAY LINE
•	FOUND 3/4" REBAR		CENTERLINE
$\oslash$	FOUND RAILROAD SPIKE	············	SECTION LINE
		· ·	EASEMENT LINE
	SIGN	///////////////////////////////////////	BUILDING FOOTPRINT
0	BOLLARD		EDGE OF CONCRETE
S	SANITARY MANHOLE		EDGE OF ASPHALT
9	SANITART MANHOLE	-000	RAILING
GM GV	GAS METER	- 000000000000000-	STONE WALL
₩ ₩	GAS VALVE	SAN SAN	SANITARY SEWER
	FIRE HYDRANT	WAT WAT	WATER MAIN
WV		STM STM	STORM SEWER
$\bowtie$	WATER VALVE	——— GAS ——— GAS ———	NATURAL GAS LINE
	INLETS	COMM COMM	COMMUNICATION LINE
Ø	UTILITY POLE	— E — E —	ELECTRIC LINE
EM	ELECTRICAL METER	OHE OHE	OVERHEAD ELECTRIC LINE
		$ \left[ \frac{2\pi i - 2\pi i -$	GRAVEL
AC	AIR CONDITIONING UNIT		ASPHALT PAVEMENT
MH	COMMUNICATION MANHOLE		CONCRETE PAVEMENT
C.	DECIDUOUS TREE	<u> </u>	CONTOUR MAJOR
		<u> </u>	CONTOUR MINOR

## **GENERAL NOTES**

1. FIELD WORK PERFORMED BY WYSER ENGINEERING, LLC. ON JUNE 12TH & 13TH, 2023.

- 2. NORTH REFERENCE FOR THIS EXISTING CONDITIONS SURVEY AND MAP ARE BASED ON THE WISCONSIN COORDINATE REFERENCE SYSTEM, NAD 83 (2011) WISCRS DANE, GRID NORTH. THE WESTERLY RIGHT-OF-WAY OF PENNSYLVANIA AVENUE BEARS S 10°35' 43" W
- 3. ELEVATIONS ARE BASED ON THE NORTH AMERICAN VERTICAL DATUM OF 1988 (NAVD88)(12(B) ADJ).
- 4. SUBSURFACE UTILITIES AND FIXTURES SHOWN ON THIS MAP HAVE BEEN APPROXIMATED BY LOCATING SURFACE FEATURES AND ACCESSORIES,
- DIGGERS HOTLINE FIELD MARKINGS AND EXISTING MAPS AND RECORDS.
  5. BEFORE EXCAVATION, APPROPRIATE UTILITY COMPANIES SHOULD BE CONTACTED. FOR EXACT LOCATION OF UNDERGROUND UTILITIES, CONTACT DIGGERS HOTLINE, AT 1.800.242.8511 OR 811
- 6. THIS PARCEL IS SUBJECT TO ALL EASEMENTS AND AGREEMENTS, BOTH RECORDED AND UNRECORDED.
- 7. FEATURES HAVE BEEN LOCATED BY SURVEYOR IN FIELD THAT MAY HAVE ADVERSE TITLE ELEMENTS. AS TO WHICH ELEMENT- ENCROACHMENT, CLAIM OF UNRECORDED EASEMENT, PRESCRIPTIVE EASEMENT, AND SO FORTH CAN NOT BE DETERMINED BY SURVEYOR.

### NOTES REGARDING ALTA TABLE A REQUIREMENTS

- ITEM 3: ALL OF THE SUBJECT PARCEL LIES IN "ZONE X" AREAS DETERMINED TO BE BELOW THE 0.2% ANNUAL CHANCE FLOODPLAIN PER NATIONAL FLOOD INSURANCE PROGRAM, FLOOD INSURANCE RATE MAP NO. 55025C0426H DATED SEPTEMBER 17, 2014.
- ITEM 7: NO BUILDINGS WERE OBSERVED ON THE SUBJECT PARCEL AT THE TIME OF THIS SURVEY.
- ITEM 9: NO PARKING STALLS WERE OBSERVED ON THE SUBJECT PARCEL AT THE TIME OF THIS SURVEY.
- ITEM 11(a): NO PLANS OR REPORTS WERE PROVIDED BY THE CLIENT. DIGGER'S HOTLINE WAS CALLED TO MARK UTILITIES.

ITEM 16: THERE WAS NO EVIDENCE OF EARTHWORK OR BUILDING CONSTRUCTION AT THE TIME OF THIS SURVEY.

# NOTES REGARDING SCHEDULE B - PART II

PER TITLE COMMITMENT FILE NO. NCS-1179641-MAD DATED: MAY 16, 2023 AT 7:30 A.M. ANY FACTS, RIGHTS, INTERESTS, OR CLAIMS THAT ARE NOT SHOWN BY THE PUBLIC RECORDS BUT THAT COULD BE ASCERTAINED BY AN INSPECTION OF THE LAND OR BY MAKING INQUIRE OF PERSONS IN POSSESSION OF THE LAND.

- 2 EASEMENTS, CLAIMS OF EASEMENTS OR ENCUMBRANCES THAT ARE NOT SHOWN BY THE PUBLIC RECORDS.
- ANY ENCROACHMENT, ENCUMBRANCE, VIOLATION, VARIATION, OR ADVERSE CIRCUMSTANCE AFFECTING THE TITLE INCLUDING DISCREPANCIES, CONFLICT IN BOUNDARY LINES, SHORTAGES IN AREA, OR ANY OTHER FACTS THAT WOULD BE DISCLOSED BY AN ACCURATE AND COMPLETE LAND SURVEY OF THE LAND, AND THAT ARE NOT SHOWN BY THE PUBLIC RECORDS.
   ONE OF THESE ITEMS 1-3 MAY AFFECT THE SUBJECT PROPERTY AND IS PLOTTED HEREON. AS TO WHICH ADVERSE TITLE ELEMENT, CLAIM OF EASEMENT, ENCROACHMENT OR ETC. CANNOT BE DETERMINED BY SURVEYOR.
   (\*A) MONITORING WELL LOCATED OUTSIDE OF DESCRIBED EASEMENT AREA.
- 9 RIGHTS AND EASEMENTS IF ANY, IN AND TO ANY AND ALL RAILROAD SWITCHES, SIDETRACKS, SPUR TRACKS AND RIGHTS OF WAY LOCATED UPON OR APPURTENANT TO THE SUBJECT PREMISES. PER RIGHT OF WAY EASEMENTS DOCUMENT RECORDED IN VOLUME 458, PAGE 489, AS DOCUMENT NO. 1178125 (ALSO EXCEPTION NO. 11 NOTED BELOW), THE SUBJECT PARCEL HAS A RIGHT OF WAY EASEMENT FOR RAILWAY SIDE TRACK PURPOSES, VEHICLE AND PEDESTRIAN TRAVEL THROUGH, AND FOR THE
- IN JULY 16, 1903 IN VOLUME 03, PAGE 9 AS DOCUMENT NO. 253138, BUT DELETING AN COVENANT, CONDITION, CONDITION OR RESTRICTION INDICATING A PREFERENCE, LIMITATION OR DISCRIMINATION BASED ON RACE, COLOR, RELIGION, SEX, HANDICAP, FAMILIAL STATUS OR NATIONAL ORIGIN TO THE EXTENT SUCH COVENANTS, CONDITIONS OR RESTRICTIONS VIOLATE 42 USC 3604(c). THIS ITEM DOES AFFECT THE SUBJECT PARCEL, BUT THERE ARE NO SUCH MATTERS TO BE PLOTTED HEREON.
- 11 TERMS, CONDITIONS, RESTRICTIONS AND PROVISIONS RELATING TO THE USE AND MAINTENANCE OF THE RIGHT OF WAY EASEMENTS RECORDED ON FEBRUARY 08, 1967 IN VOLUME 458, PAGE 489, AS DOCUMENT NO. 1178125. THE SUBJECT PARCEL HAS A RIGHT OF WAY EASEMENT FOR RAILWAY SIDE TRACK PURPOSES, VEHICLE AND PEDESTRIAN TRAVEL THROUGH, AND FOR THE CONSTRUCTION AND MAINTENANCE OF UNDERGROUND UTILITIES OVER A PORTION OF OUTLOT A, MADISON SQUARE RILEY PLAT, BEING 25 FEET IN WIDTH AND ADJACENT TO LOTS 9-13, BLOCK 313 OF SAID RILEY PLAT. SAID PORTION OF OUTLOT A IS PART OF A PARCEL APPROXIMATELY 1600 FEET SOUTH WITH AN ADDRESS OF 2010 PENNSYLVANIA AVENUE, AND IS OWNED AT PRESENT BY CAH CO LLC. PLOTTING OFF-SITE EASEMENTS AS OUTLINED IN ITEM 18 OF THE RECEIVED TABLE A WAS NOT SELECTED, SO THIS ITEM IS NOT PLOTTED HEREON.
- UTILITY EASEMENT TO MADISON GAS AND ELECTRIC COMPANY, A CORPORATION, DATED DECEMBER 30, 1966, RECORDED/FILED FEBRUARY 28, 1967, IN VOLUME 459 OF MISC, PAGE 165, AS DOCUMENT NO. 1179182. THIS ITEM DOES AFFECT THE SUBJECT PARCEL AND IS PLOTTED HEREON.
- 13 EASEMENT FOR GROUNDWATER MONITORING WELL GRANTED TO CITY OF MADISON, A MUNICIPAL CORPORATION BY HOOPER CONSTRUCTION CORPORATION RECORDED IN MARCH 31, 1995 AS VOLUME 29584, PAGE 1 AS DOCUMENT NO. 2667583. THE ABOVE DOCUMENT WAS RE-RECORDED MAY 11, 1995 IN/AS VOLUME 29827, PAGE 45 AS DOCUMENT NO. 2675242 OF OFFICIAL RECORDS. THIS ITEM DOES AFFECT THE SUBJECT PARCEL AND IS PLOTTED HEREON.
- 14 TERMS, CONDITIONS, RESTRICTIONS AND PROVISIONS RELATING TO THE USE AND MAINTENANCE OF THE ACCESS EASEMENT AGREEMENT RECORDED ON MARCH 16, 2023, AS DOCUMENT NO. 5891218. THIS ITEM DOES AFFECT THE SUBJECT PARCEL AND IS PLOTTED HEREON.
- 15 TERMS AND PROVISIONS OF AN UNRECORDED LEASE DATED APRIL 01, 1999, BY AND BETWEEN UNDISCLOSED AS LESSOR AND ADAMS OUTDOOR ADVERTISING AS LESSER, AS DISCLOSED BY A MEMORANDUM OF SIGN SITE LEASE RECORDED OCTOBER 30, 2012 AS DOCUMENT NO. 4927539 OF OFFICIAL RECORDS. THIS ITEM DOES AFFECT THE SUBJECT PARCEL, BUT IS NOT PLOTTED HEREON AS IT IS BLANKET IN NATURE. THERE ARE MULTIPLE BILLBOARDS ON THE SUBJECT PARCEL AND THEY HAVE BEEN PLOTTED HEREON.

# LEGAL DESCRIPTION AS FURNISHED

LOTS THREE (3), FOUR (4), FIVE (5), SIX (6), SEVEN (7), EIGHT (8), NINE (9), TEN (10), ELEVEN (11), TWELVE (12), NINETEEN (19), TWENTY (20), TWENTY-ONE (21), TWENTY-TWO (22), TWENTY-THREE (23), TWENTY-FOUR (24), TWENTY-FIVE (25), TWENTY-SIX (26), TWENTY-SEVEN (27), AND TWENTY-EIGHT (28), BLOCK THREE HUNDRED TWENTY-FIVE (325), MADISON SQUARE RILEY PLAT, CITY OF MADISON, DANE COUNTY, WISCONSIN. THE ABOVE DESCRIBED PARCEL CONTAINS 116,135 SQUARE FEET OR 2.67 ACRES




TO: WILLIAM BUTCHER, ERIC WELCH, HOOPER CORPORATION, A WISCONSIN CORPORATION AS SUCCESSOR BY MERGER TO THE MATERIALS AND EQUIPMENT CO., A WISCONSIN CORPORATION, AND FIRST AMERICAN TITLE INSURANCE COMPANY
THIS IS TO CERTIFY THAT THIS MAP OR PLAT AND THE SURVEY ON WHICH IT IS BASED WERE MADE IN ACCORDANCE WITH THE 2021 MINIMUM STANDARD DETAIL REQUIREMENTS FOR ALTA/NSPS LAND TITLE SURVEYS, JOINTLY ESTABLISHED AND ADOPTED BY ALTA AND NSPS, AND INCLUDES ITEMS 1, 2, 3, 4, 7(a), 7(b)(1), 7(b)(2), 7(c), 8, 9, 11(a), 13, 14, 16, AND 19 OF TABLE A THEREOF.


THE FIELD WORK WAS COMPLETED ON JUNE 12-13, 2023 DATE OF PLAT OR MAP: JULY, 14, 2023.

IN ACCORDANCE WITH SECTION 3.B OF THE 2021 MINIMUM STANDARD DETAIL REQUIREMENTS FOR ALTA/NSPS LAND TITLE SURVEYS, ADDITIONAL CERTIFICATION BELOW TO FULFILL WISCONSIN ADMINISTRATIVE CODE, A-E 7 - MINIMUM STANDARDS FOR PROPERTY SURVEYS IN WISCONSIN. ITEM A-E 7.05(8) I, ZACHARY M. REYNOLDS, WISCONSIN PROFESSIONAL LAND SURVEYOR S-3223, DO HEREBY CERTIFY THAT THIS SURVEY AND MAP IS CORRECT TO THE BEST OF MY KNOWLEDGE AND BELIEF WITH THE INFORMATION PROVIDED, BY THE ORDER OF THOSE LISTED HEREON, AND THAT THIS SURVEY COMPLIES WITH A-E 7 OF THE WISCONSIN ADMINISTRATIVE CODE.

ZACHARY M. REYNOLDS, S-3223 WISCONSIN PROFESSIONAL LAND SURVEYOR



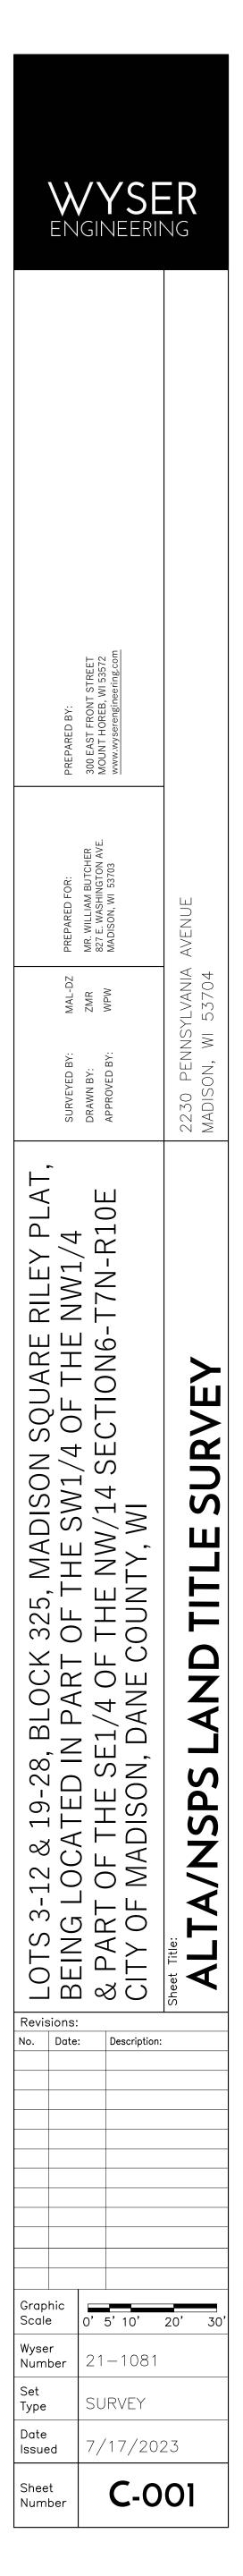

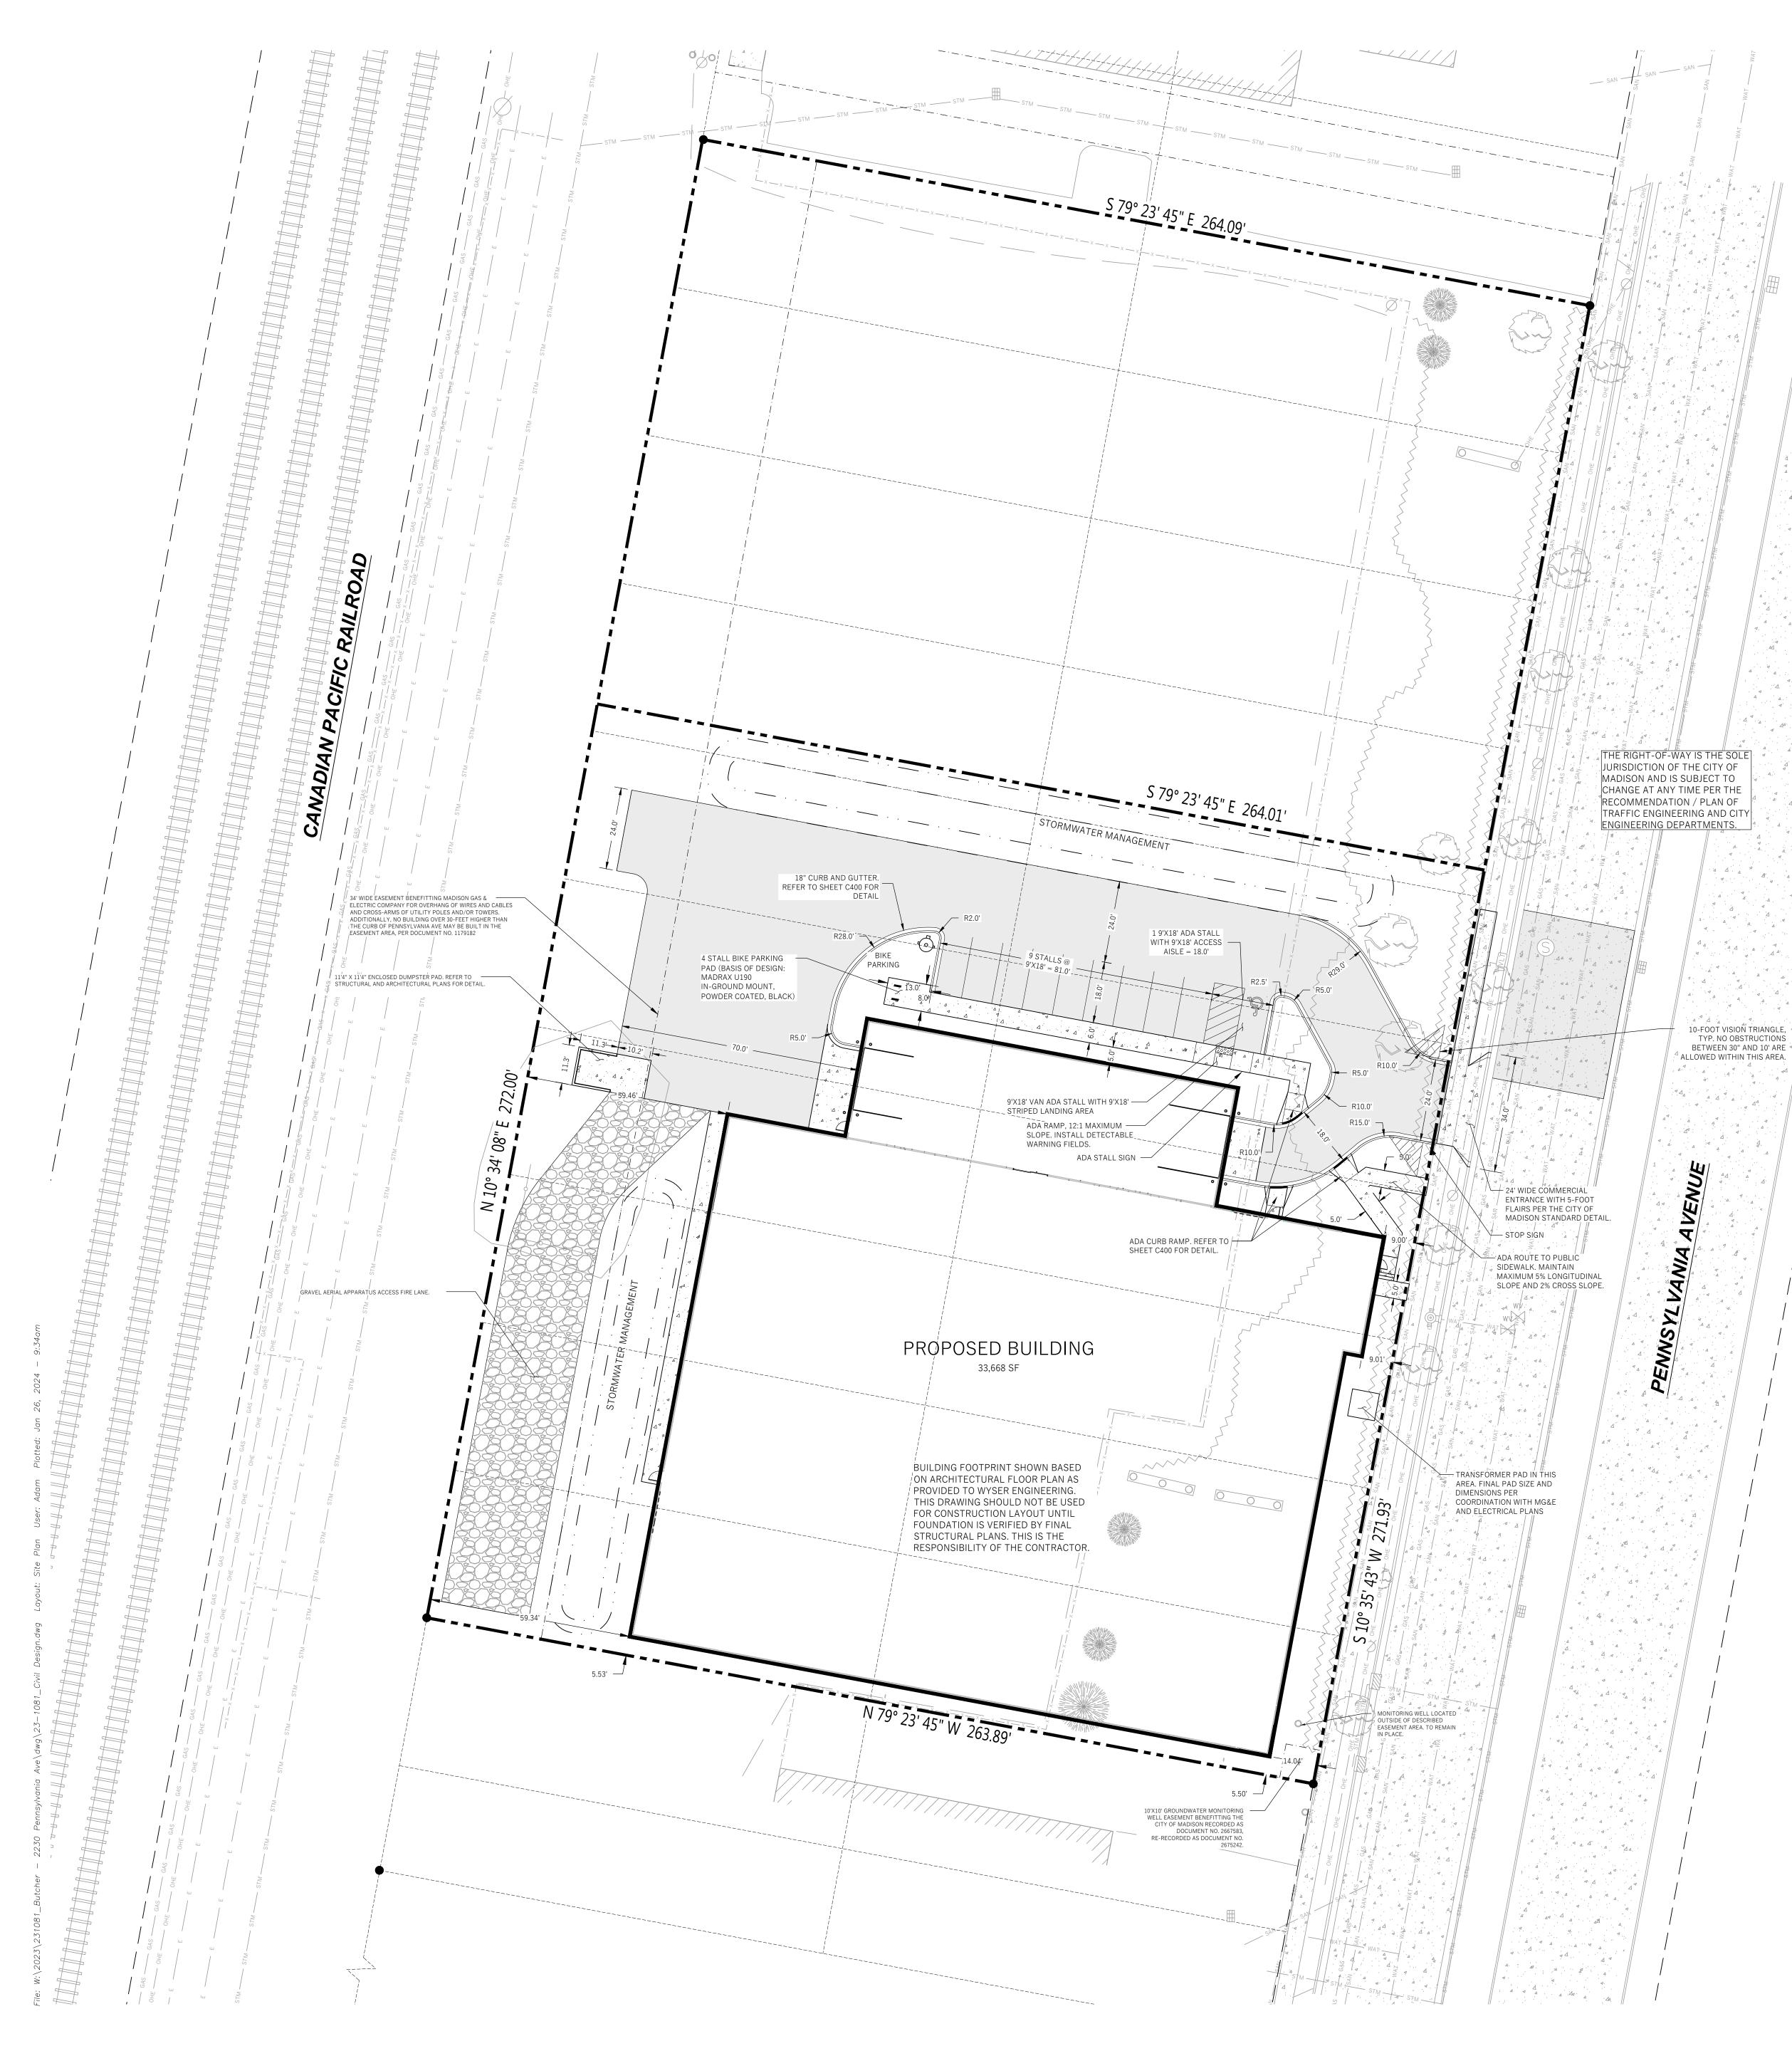



	PROPOSED PROPERTY BOUNDARY
·····	EASEMENT
	BUILDING FOOTPRINT
	18" CURB AND GUTTER
	ASPHALT PAVEMENT
<u>م</u>	CONCRETE PAVEMENT
· · · · · ·	STORMWATER TREATMENT FACILITY



# **GENERAL NOTES**

1.1

1:1

- 1. UNDERLYING SITE CONTOURS AND INFORMATION BASED ON TOPOGRAPHIC & UTILITY DATA AS SURVEYED BY WYSER ENGINEERING ON JUNE 12 AND 13, 2023. WYSER ENGINEERING SHALL NOT BE HELD RESPONSIBLE FOR ANY ERRORS OR OMISSIONS THAT MAY ARISE AS A RESULT OF ERRONEOUS OR INCOMPLETE INFORMATION PROVIDED BY OTHERS. CONTRACTOR TO CONFIRM ALL ELEVATIONS, GENERAL DRAINAGE AND EARTHWORK REQUIREMENTS PRIOR TO CONSTRUCTION.
- 2. THE BENCHMARK LOCATIONS ARE SHOWN FOR REFERENCE ONLY ON THIS PLAN. THE BENCHMARKS SHALL BE VALIDATED BY LICENSED LAND SURVEYOR PRIOR TO CONSTRUCTION. CONTRACTOR ASSUMES RISK ASSOCIATED WITH BENCHMARK ELEVATIONS UNTIL CONFIRMED.
- 3. CONTRACTOR TO OBTAIN APPROPRIATE PERMITS FOR STREET OPENINGS & TO WORK WITHIN THE CITY'S LAND AND EASEMENTS AS REQUIRED.
- 4. WYSER ENGINEERING SHALL BE HELD HARMLESS AND DOES NOT WARRANT ANY DEVIATIONS BY THE OWNER OR CONTRACTOR FROM THE APPROVED CONSTRUCTION PLANS THAT MAY RESULT IN DISCIPLINARY ACTIONS BY REGULATORY AGENCIES.
- 5. IF ANY ERRORS, DISCREPANCIES, OR OMISSIONS WITHIN THE PLAN BECOME APPARENT, IT SHALL BE BROUGHT TO THE ATTENTION OF THE ENGINEER PRIOR TO CONSTRUCTION SO THAT CLARIFICATION OR REDESIGN MAY OCCUR.
- 6. ALL MUNICIPAL UTILITY CONNECTIONS, WORK IN ROW, PUBLIC OUTLOTS AND PUBLIC EASEMENTS SHALL BE IN ACCORDANCE WITH CITY OF MADISON STANDARD SPECIFICATIONS FOR PUBLIC WORKS CONSTRUCTION AND SEPARATE PLANS ISSUED BY THE CITY OF MADISON.

SITE INFORMATION BLOCK:

SITE ADDRESS: 2230 PENNSYLVANIA AVENUE SITE ACREAGE: 71,787 SQ.FT. (1.65 AC) USE OF PROPERTY: INDUSTRIAL ZONING: INDUSTRIAL - LIMITED (IL)

SETBACKS: FRONT YARD: 5 FEET REAR YARD: 30-FEET SIDE YARD: 5 FEET

TOTAL NUMBER OF PARKING STALLS: 10 NUMBER OF STALLS DESIGNATED ACCESSIBLE: 1 TOTAL NUMBER OF BIKE STALLS: 4

EXISTING IMPERVIOUS SURFACE AREA: 50,122 SQ.FT. ROOFTOP: 0 SQ.FT. PAVED: 54,641 SQ.FT. EXISTING LOT COVERAGE: 76.1%


NEW IMPERVIOUS SURFACE AREA: 53,054 SQ.FT. ROOFTOP: 33,668 SQ.FT.

PAVED: 15,338 SQ.FT. GRAVEL: 4,048 SQ.FT. PROPOSED LOT COVERAGE: 73.9%


MAXIMUM LOT COVERAGE 75%





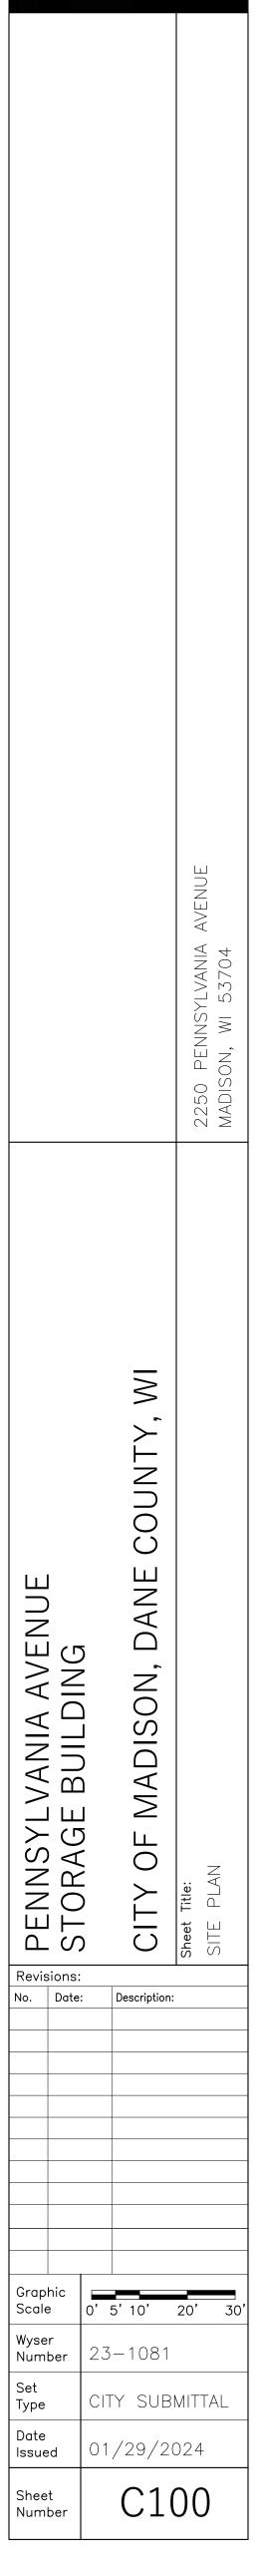



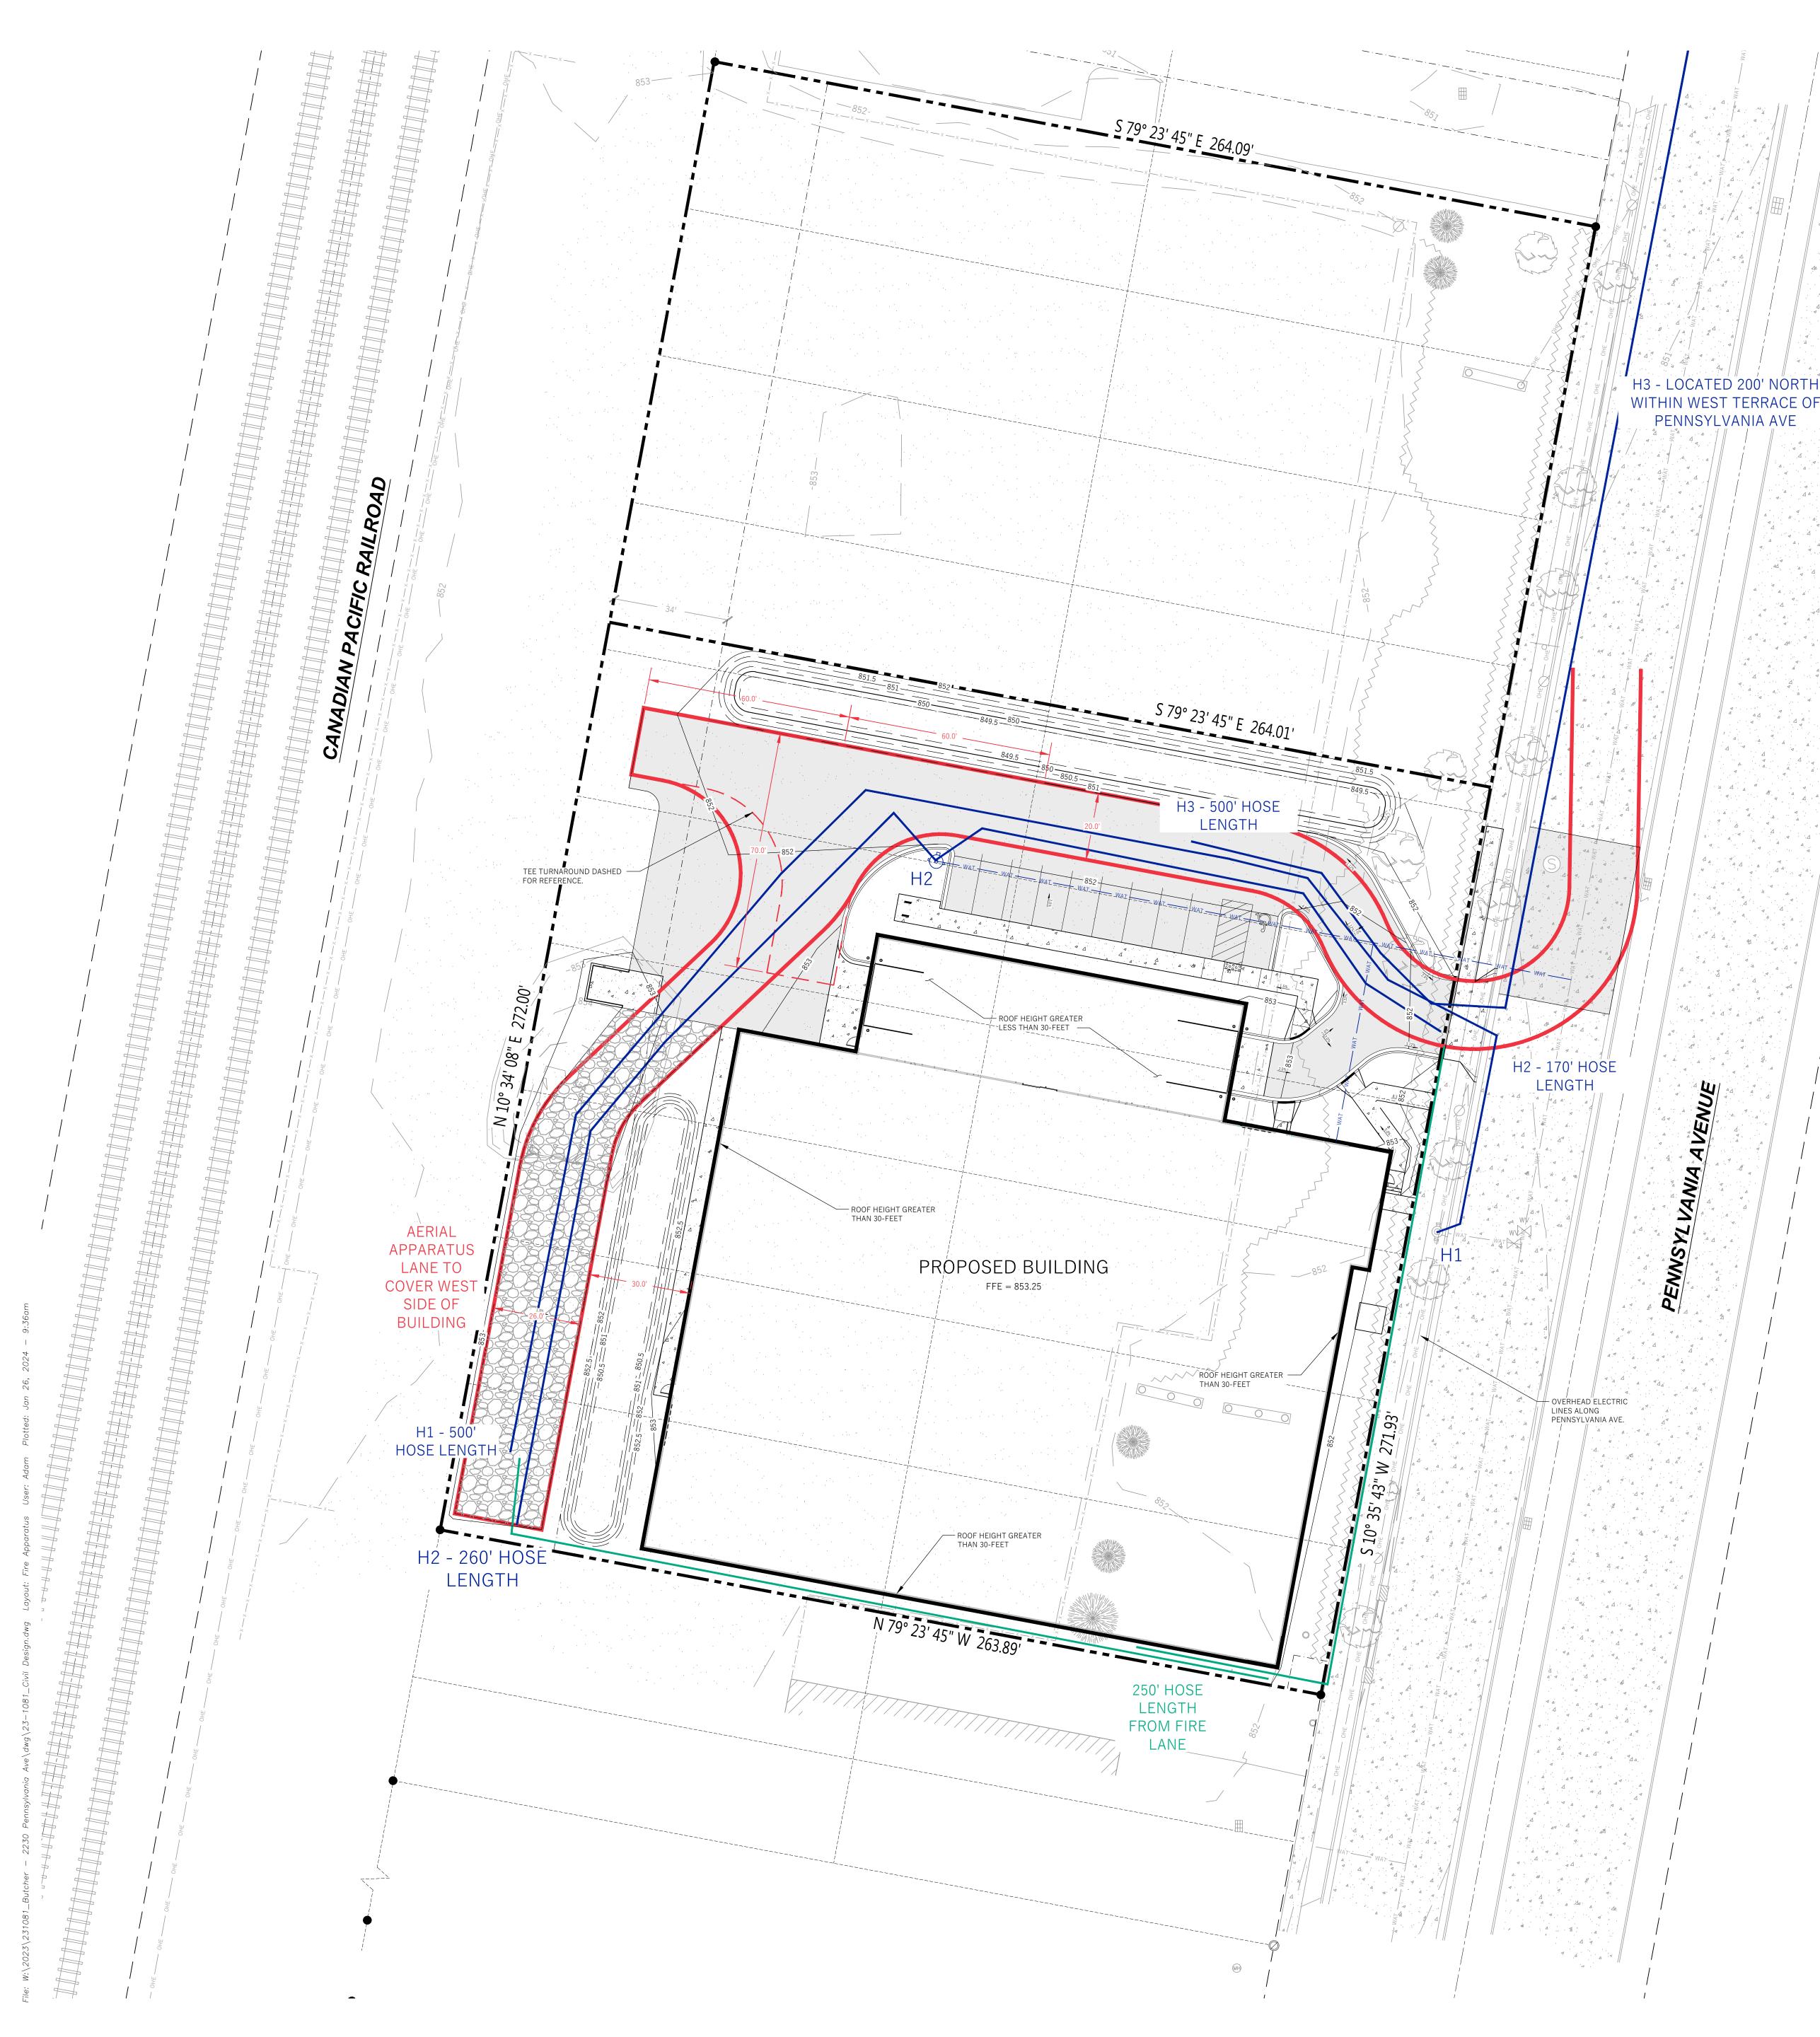





1 1

# **City of Madison Fire Department**

314 W Dayton Street, Madison, WI 53703 Phone: 608-266-4420 • Fax: 608-267-1100 • E-mail: fire@cityofmadison.com

Project Address: 2230 PENNSYLVANIA AVE Contact Name & Phone #: BRANDON ADLER - 608.756.2326

FIDE		THE	ACCESS	AND	FIDE	UVDD	ANT	WOD	VSUFL	27

FIRE APPARATUS ACCESS AND FIRE HYDRANT WORKS	<u>HEET</u>	
<ol> <li>Is the building completely protected by an NFPA 13 or 13R automatic fire sprinkler system? If non-sprinklered, fire lanes extend to within 150-feet of all portions of the exterior wall? If sprinklered, fire lanes are within 250-feet of all portions of the exterior wall?</li> </ol>	X Yes Ves X Yes	s [
<ul> <li>2. Is the fire lane constructed of concrete or asphalt, designed to support a minimum load of 85,000 lbs?</li> <li>a) Is the fire lane a minimum unobstructed width of at least 20-feet?</li> <li>b) Is the fire lane unobstructed with a vertical clearance of at least 13<sup>1</sup>/<sub>2</sub>-feet?</li> <li>c) Is the minimum inside turning radius of the fire lane at least 28-feet?</li> <li>d) Is the grade of the fire lane not more than a slope of 8%?</li> <li>e) Is the fire lane posted as fire lane? (Provide detail of signage.)</li> <li>f) Is a roll-able curb used as part of the fire lane? (Provide detail of curb.)</li> <li>g) Is part of a sidewalk used as part of the required fire lane? (Must support +85,000 lbs.)</li> </ul>	X Yes X Yes X Yes X Yes Yes Yes Yes Yes	
<ul><li>3. Is the fire lane obstructed by security gates or barricades? If yes:</li><li>a) Is the gate a minimum of 20-feet clear opening?</li><li>b) Is an approved means of emergency operations installed, key vault, padlock or key switch?</li></ul>	☐ Yes ☐ Yes ☐ Yes	s Ē
4. Is the Fire lane dead-ended with a length greater than 150-feet? 230' FROM CENTER OF TEE TURNAROUND If yes, does the area for turning around fire apparatus comply with the DEAD OF AERIAL APPARATUS LANE	⊃ X Yes X Yes	; [ ;& [
5. Is any portion of the building to be used for high-piled storage in accordance with IFC Chapter 3206.6 If yes, see IFC 3206.6 for further requirements.	☐ Yes	; []
<ul> <li>6. Is any part of the building greater than 30-feet above the grade plane?</li> <li>If yes, answer the following questions: <ul> <li>a) Is the aerial apparatus fire lane parallel to one entire side of the building and covering at least 25% of the perimeter?</li> <li>b) Is the near edge of the aerial apparatus fire lane between 15' and 30' from the building?</li> <li>c) Are there any overhead power or utility lines located across the aerial apparatus fire lane?</li> <li>d) Are there any tree canopies expected to grow across the aerial fire lane? (Based on mature canopy width of tree species)</li> </ul> </li> </ul>	X Yes X Yes Yes Yes	5 [ 5 [ 5 [ 5 [ 5 [
<ul><li>e) Does the aerial apparatus fire lane have a minimum unobstructed width of 26-feet?</li><li>f) Is the space between the aerial lane and the building free of trees exceeding 20' in heights?</li></ul>	X Yes X Yes	
<ul> <li>7. Are all portions of the required fire lanes within 500-feet of at least (2) hydrants?</li> <li>Note: Distances shall be measured along the path of the hose lay as it comes off the fire apparatus.</li> <li>a) Is the fire lane at least 26' wide for at least 20-feet on each side of the hydrants?</li> <li>b) Is there at least 40' between a hydrant and the building?</li> <li>C) Are the hydrant(s) setback no less than 5-feet nor more than 10-feet from the curb or edge of the street or fire lane?</li> </ul>	X Yes X Yes Ves X Yes	s [ s [
<ul> <li>d) Are hydrants located in parking lot islands a minimum of 3½-feet from the hydrant to the curb?</li> <li>e) Are there no obstructions, including but not limited to: power poles, trees, bushes, fences, posts located, or grade changes exceeding 1½-feet, within 5-feet of a fire hydrant?</li> <li>Note: Hydrants shall be installed and in-service prior to combustible construction on the project site.</li> </ul>	X Yes	
Attach an additional sheet if further explanation is required for any answers.		

This worksheet is based on MGO 34.503 and IFC 2021 Edition Chapter 5 and Appendix D; please see the codes for further information.






🗌 No	N/A
	X N/A
∐ No	∟ N/A
🗌 No	N/A
🗍 No	🗖 N/A
🗌 No	🗌 N/A
🗌 No	□ N/A
	$\square$ N/A
	$\mathbf{X} \mathbf{N}/\mathbf{A}$
∐ No ⊠ No	$\times$ N/A $\square$ N/A
K NO	∐ N/A
X No	<u>N/A</u>
🗌 No	X N/A
∐ No	X N/A
□ No	N/A
X No	$\square$ N/A
X No	□ N/A
🗌 No	N/A
🗌 No	□ N/A
No	N/A
No	
□ No □ No ⊠ No	□ N/A □ N/A □ N/A
No	
□ No □ No ⊠ No	□ N/A □ N/A □ N/A
□ No □ No ☑ No ☑ No	□ N/A □ N/A □ N/A □ N/A
□ No □ No ☑ No ☑ No □ No □ No	□ N/A □ N/A □ N/A □ N/A □ N/A □ N/A
□ No □ No ☑ No ☑ No □ No	□ N/A □ N/A □ N/A □ N/A □ N/A
□ No □ No ☑ No ☑ No □ No □ No	□ N/A □ N/A □ N/A □ N/A □ N/A □ N/A □ N/A
□ No	□ N/A □ N/A □ N/A □ N/A □ N/A □ N/A
□ No	<ul> <li>N/A</li> </ul>
□ No	<ul> <li>N/A</li> </ul>
□ No	<ul> <li>N/A</li> </ul>
□ No	<ul> <li>N/A</li> </ul>
□ No	<ul> <li>N/A</li> </ul>


Revised 06/2022



		2250 PENNSYLVANIA AVENUE Madison, wi 53704
PENNSYLVANIA AVENUE STORAGE BUILDING		Sheet Title: FIRE APPARATUS ACCESS PLAN
Graphic Scale	0' 5' 10'	20' 30'
Wyser Number Set Type Date Issued Sheet Number	23-1081 CITY SUE 01/29/2 C1(	024

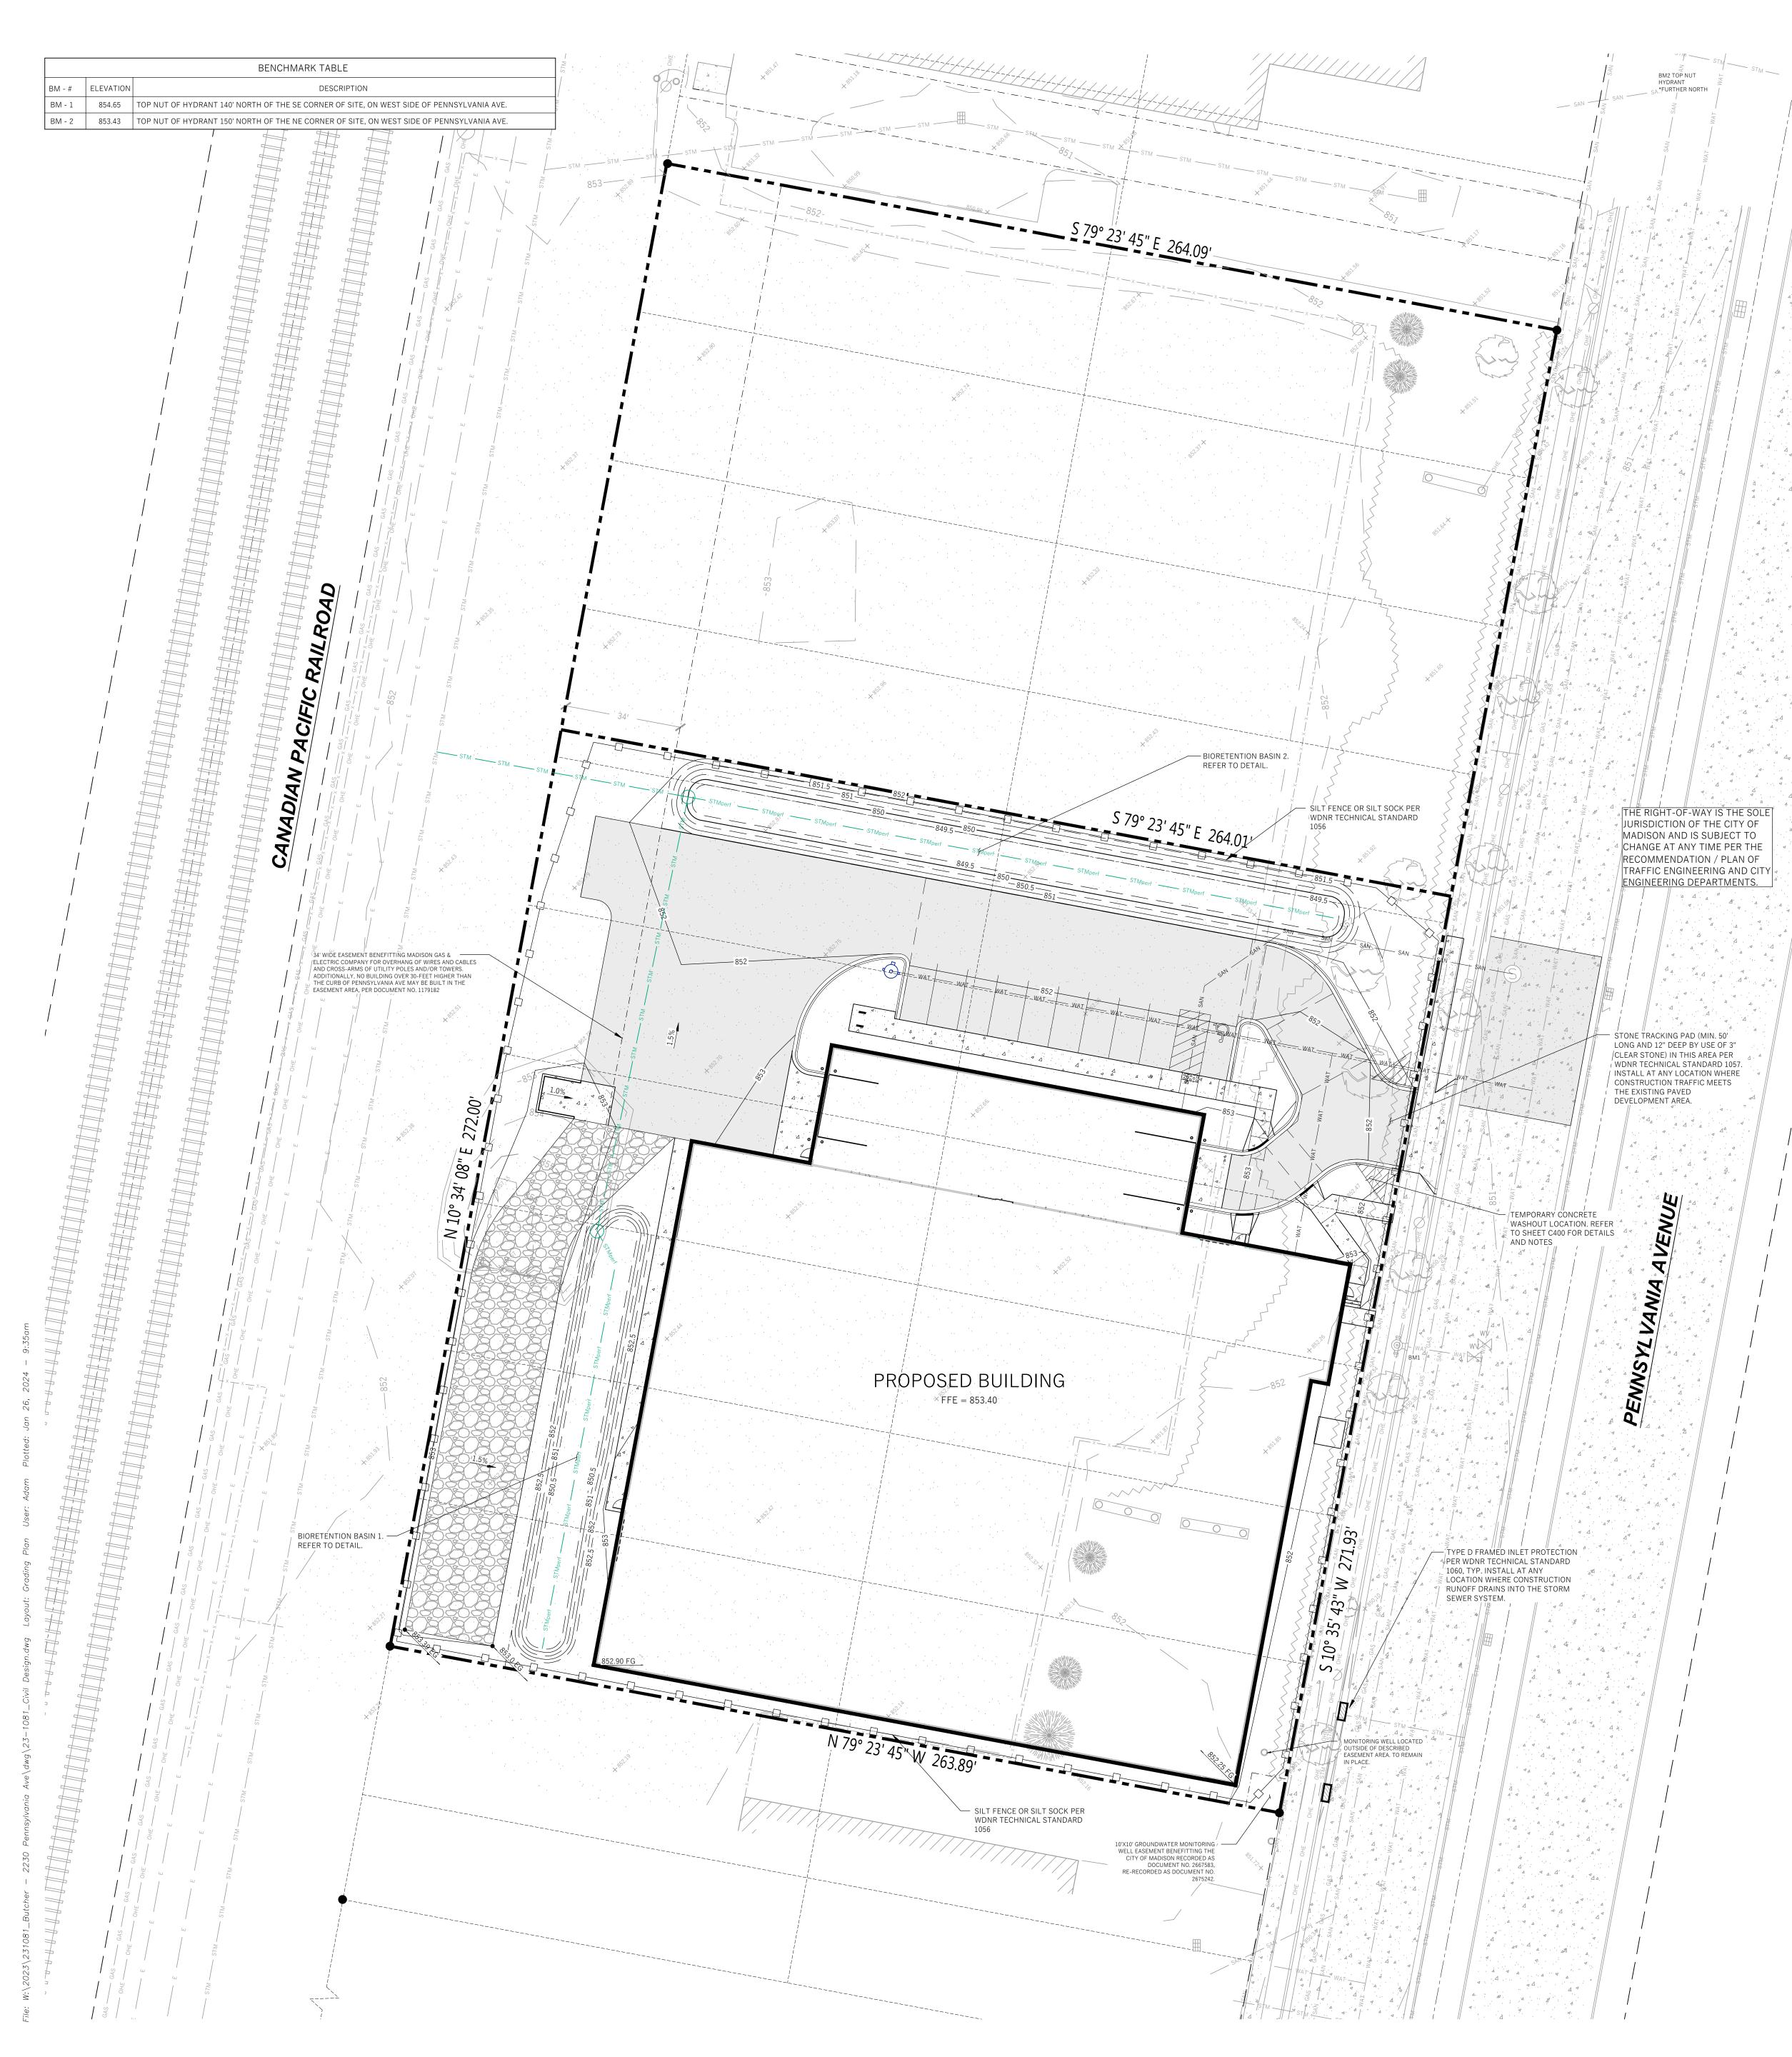

# LEGEND (PROPOSED)

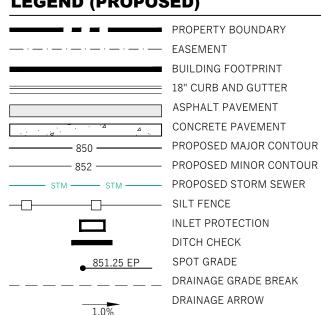

BUILDING FOOTPRINT 18" CURB AND GUTTER ASPHALT PAVEMENT CONCRETE PAVEMENT INLET PROTECTION DITCH CHECK DRAINAGE ARROW



# **GENERAL NOTES**

- 1. UNDERLYING SITE CONTOURS AND INFORMATION BASED ON TOPOGRAPHIC & UTILITY DATA AS SURVEYED BY WYSER ENGINEERING ON JUNE 12 AND 13, 2023. WYSER ENGINEERING SHALL NOT BE HELD RESPONSIBLE FOR ANY ERRORS OR OMISSIONS THAT MAY ARISE AS A RESULT OF ERRONEOUS OR INCOMPLETE INFORMATION PROVIDED BY OTHERS. CONTRACTOR TO CONFIRM ALL ELEVATIONS, GENERAL DRAINAGE AND EARTHWORK REQUIREMENTS PRIOR TO CONSTRUCTION.
- 2. THE BENCHMARK LOCATIONS ARE SHOWN FOR REFERENCE ONLY ON THIS PLAN. THE BENCHMARKS SHALL BE VALIDATED BY LICENSED LAND SURVEYOR PRIOR TO CONSTRUCTION. CONTRACTOR ASSUMES RISK ASSOCIATED WITH BENCHMARK ELEVATIONS UNTIL CONFIRMED.
- 3. CONTRACTOR TO OBTAIN APPROPRIATE PERMITS FOR STREET OPENINGS & TO WORK WITHIN THE CITY'S LAND AND EASEMENTS AS REQUIRED.
- 4. WYSER ENGINEERING SHALL BE HELD HARMLESS AND DOES NOT WARRANT ANY DEVIATIONS BY THE OWNER OR CONTRACTOR FROM THE APPROVED CONSTRUCTION PLANS THAT MAY RESULT IN DISCIPLINARY ACTIONS BY REGULATORY AGENCIES.
- ATTENTION OF THE ENGINEER PRIOR TO CONSTRUCTION SO THAT CLARIFICATION OR REDESIGN MAY OCCUR. 6. ALL MUNICIPAL UTILITY CONNECTIONS, WORK IN ROW, PUBLIC OUTLOTS AND PUBLIC EASEMENTS SHALL BE IN ACCORDANCE WITH CITY OF MADISON STANDARD SPECIFICATIONS FOR PUBLIC WORKS CONSTRUCTION AND SEPARATE PLANS ISSUED BY THE CITY OF MADISON.
- **CONSTRUCTION SITE EROSION CONTROL REQUIREMENTS** 1. POST WDNR CERTIFICATE OF PERMIT COVERAGE AND MUNICIPAL EROSION CONTROL PERMITS ON SITE AND MAINTAIN UNTIL CONSTRUCTION ACTIVITIES HAVE CEASED, THE SITE IS STABILIZED, AND A NOTICE OF TERMINATION IS FILED WITH WDNR.
- 2. KEEP A COPY OF THE CURRENT EROSION CONTROL PLAN ON SITE THROUGHOUT THE DURATION OF THE PROJECT. 3. ENGINEER / CITY OF MADISON / WDNR HAS THE RIGHT TO REQUIRE CONTRACTOR TO IMPLEMENT ADDITIONAL EROSION CONTROL MEASURES AS NECESSARY. CONTRACTOR MUST NOTIFY THE CITY OF MADISON BUILDING INSPECTOR TO SCHEDUAL A PRECONSTRUCTION MEETING FOR A MINIMUM OF TWO (2) WORKING DAYS IN ADVANCE OF ANY SOIL DISTURBANCE ACTIVITIES. CONTRACTOR IS REQUIRED TO PROVIDE WEEKLY INSPECTIONS TO THE CITY OF MADISON.
- 4. SUBMIT PLAN REVISIONS OR AMENDMENTS TO THE WDNR AT LEAST 5 DAYS PRIOR TO FIELD IMPLEMENTATION. 5. THE SITE CONTRACTOR IS RESPONSIBLE FOR ROUTINE SITE INSPECTIONS AT LEAST ONCE EVERY 7 DAYS AND WITHIN 24 HOURS AFTER A RAINFALL EVENT OF 0.5 INCHES OR GREATER. KEEP INSPECTION REPORTS ON-SITE AND MAKE THEM AVAILABLE UPON REQUEST.
- 6. INSPECT AND MAINTAIN ALL INSTALLED EROSION CONTROL PRACTICES UNTIL THE CONTRIBUTING DRAINAGE AREA HAS BEEN STABILIZED.
- 7. WHEN POSSIBLE: PRESERVE EXISTING VEGETATION (ESPECIALLY ADJACENT TO SURFACE WATERS), MINIMIZE LAND-DISTURBING CONSTRUCTION ACTIVITY ON SLOPES OF 20% OR MORE, MINIMIZE SOIL COMPACTION, AND PRESERVE TOPSOIL.
- 8. REFER TO THE WDNR STORMWATER CONSTRUCTION TECHNICAL STANDARDS AT http://dnr.wi.gov/topic/stormwater/standards/const\_standards.html.
- 9. INSTALL PERIMETER EROSION CONTROLS AND ROCK TRACKING PAD CONSTRUCTION ENTRANCE(S) PRIOR TO ANY LAND-DISTURBING ACTIVITIES, INCLUDING CLEARING AND GRUBBING, USE WONR TECHNICAL STANDARD STONE TRACKING PAD AND TIRE WASHING #1057 FOR ROCK CONSTRUCTION ENTRANCE(S)
- 10. INSTALL INLET PROTECTION PRIOR TO LAND-DISTURBING ACTIVITIES IN THE CONTRIBUTING DRAINAGE AREA AND/OR IMMEDIATELY UPON INLET INSTALLATION. COMPLY WITH WDNR TECHNICAL STANDARD STORM DRAIN INLET PROTECTION FOR CONSTRUCTION SITES #1060 AND DANE COUNTY REQUIREMENTS FOR FRAMED INLET PROTECTION.
- 11. CONTRACTOR TO PROVIDE SOLID LID OR METAL PLATE ON ALL OPEN MANHOLES DURING CONSTRUCTION TO MINIMIZE SEDIMENT FROM ENTERING THE STORM SEWER SYSTEM.
- EROSION CONTROL PER WDNR TECHNICAL STANDARD TEMPORARY GRADING PRACTICES FOR EROSION CONTROL #1067. 13. PERMITTING OF GROUNDWATER DEWATERING IS THE RESPONSIBILITY OF THE CONTRACTOR. GROUNDWATER DEWATERING IS SUBJECT
- TO A DNR WASTEWATER DISCHARGE PERMIT AND A DNR HIGH CAPACITY WELL APPROVAL IF CUMULATIVE PUMP CAPACITY IS 70 GPM OR MORE 14. PROVIDE ANTI-SCOUR PROTECTION AND MAINTAIN NON-EROSIVE FLOW DURING DEWATERING. PERFORM DEWATERING OF
- ACCUMULATED SURFACE RUNOFF IN ACCORDANCE WITH WDNR TECHNICAL STANDARD DE-WATERING #1061. 15. CONSTRUCT AND PROTECT THE BIOINFILTRATION BASIN AND VEGETATION FROM RUNOFF AND SEDIMENT DURING CONSTRUCTION.
- REFERENCE THE WDNR TECHNICAL STANDARD BIORETENTION FOR INFILTRATION # 1004. 16. INSTALL AND MAINTAIN SILT FENCING PER WDNR TECHNICAL STANDARD SILT FENCE #1056. REMOVE SEDIMENT FROM BEHIND SILT FENCES AND SEDIMENT BARRIERS BEFORE SEDIMENT REACHES A DEPTH THAT IS EQUAL TO ONE-HALF OF THE FENCE AND/OR BARRIER HEIGHT.
- 17. REPAIR BREAKS AND GAPS IN SILT FENCES AND BARRIERS IMMEDIATELY. REPLACE DECOMPOSING STRAW BALES (TYPICAL BALE LIFE IS 3 MONTHS). LOCATE, INSTALL, AND MAINTAIN STRAW BALES PER WDNR TECHNICAL STANDARD DITCH CHECKS #1062.
- 18. INSTALL AND MAINTAIN FILTER SOCKS IN ACCORDANCE WITH WDNR TECHNICAL STANDARD INTERIM MANUFACTURED PERIMETER CONTROL AND SLOPE INTERRUPTION PRODUCTS # 1071
- 19. IMMEDIATELY STABILIZE STOCKPILES AND SURROUND STOCKPILES AS NEEDED WITH SILT FENCE OR OTHER PERIMETER CONTROL IF STOCKPILES WILL REMAIN INACTIVE FOR 7 DAYS OR LONGER.
- 20. IMMEDIATELY STABILIZE ALL DISTURBED AREAS THAT WILL REMAIN INACTIVE FOR 14 DAYS OR LONGER. BETWEEN SEPTEMBER 15 AND OCTOBER 15: STABILIZE WITH MULCH, TACKIFIER, AND A PERENNIAL SEED MIXED WITH WINTER WHEAT, ANNUAL OATS, OR ANNUAL RYE, AS APPROPRIATE FOR REGION AND SOIL TYPE OCTOBER 15 THROUGH COLD WEATHER: STABILIZE WITH A POLYMER AND DORMANT SEED MIX, AS APPROPRIATE FOR REGION AND SOIL TYPE.
- 21. STABILIZE AREAS OF FINAL GRADING WITHIN 7 DAYS OF REACHING FINAL GRADE. 22. SWEEP/CLEAN UP ALL SEDIMENT/TRASH THAT MOVES OFF-SITE DUE TO CONSTRUCTION ACTIVITY OR STORM EVENTS BEFORE THE
- END OF THE SAME WORKDAY OR AS DIRECTED BY THE AUTHORITIES WITH JURISDICTION. SEPARATE SWEPT MATERIALS (SOILS AND TRASH) AND DISPOSE OF APPROPRIATELY. 23. THE CONTRACTOR IS RESPONSIBLE FOR CONTROLLING DUST PER WDNR TECHNICAL STANDARD DUST CONTROL ON CONSTRUCTION
- SITES # 1068. 24. PROPERLY DISPOSE OF ALL WASTE AND UNUSED BUILDING MATERIALS (INCLUDING GARBAGE, DEBRIS, CLEANING WASTES, OR OTHER
- CONSTRUCTION MATERIALS) AND DO NOT ALLOW THESE MATERIALS TO BE CARRIED BY RUNOFF INTO THE RECEIVING CHANNEL. 25. COORDINATE WITH THE AUTHORITIES WITH JURISDICTION TO UPDATE THE LAND DISTURBANCE PERMIT TO INDICATE THE ANTICIPATED OR LIKELY DISPOSAL LOCATIONS FOR ANY EXCAVATED SOILS OR CONSTRUCTION DEBRIS THAT WILL BE HAULED OFF-SITE FOR DISPOSAL. THE DEPOSITED OR STOCKPILED MATERIAL NEEDS TO INCLUDE PERIMETER SEDIMENT CONTROL MEASURES (SUCH AS SILT FENCE, HAY BALES, FILTER SOCKS, OR COMPACTED EARTHEN BERMS).
- 26. FOR NON-CHANNELIZED FLOW ON DISTURBED OR CONSTRUCTED SLOPES, PROVIDE CLASS CLASS I TYPE B EROSION CONTROL MATTING. INSTALL AND MAINTAIN PER WDNR TECHNICAL STANDARD NON-CHANNEL EROSION MAT #1052.
- 27. FOR CHANNELIZED FLOW ON DISTURBED OR CONSTRUCTED AREAS, PROVIDE CLASS II TYPE B EROSION CONTROL MATTING UNLESS OTHERWISE SPECIFIED ON THE PLAN. INSTALL AND MAINTAIN PER WDNR TECHNICAL STANDARD CHANNEL EROSION MAT #1053.
- 28. MAKE PROVISIONS FOR WATERING DURING THE FIRST 8 WEEKS FOLLOWING SEEDING OR PLANTING OF DISTURBED AREAS WHENEVER MORE THAN 7 CONSECUTIVE DAYS OF DRY WEATHER OCCUR. 29. THE CONTRACTOR IS RESPONSIBLE FOR COMPLYING WITH ALL APPLICABLE WDNR REMEDIATION AND WASTE MANAGEMENT
- KNOWN OR SUSPECTED SOIL AND/OR GROUNDWATER CONTAMINATION CAN BE FOUND ON WDNR'S BUREAU OF REMEDIATION AND REDEVELOPMENT RACKING SYSTEM (BRRTS) PUBLIC DATABASE AT: http://dnr.wi.gov/botw/ 30. INSTALL AND MAINTAIN A CONCRETE WASHOUT BASIN PER EPA 833-F-11-006: <a href="https://www3.epa.gov/npdes/pubs/concretewashout.pdf">https://www3.epa.gov/npdes/pubs/concretewashout.pdf</a> REQUIRE USE BY ALL CONCRETE CONTRACTORS. LIQUID MAY BE REUSED IN CONCRETE MIXING, EVAPORATED, OR DISPOSED OF AS

# **GRADING, SEEDING & RESTORATION NOTES**


1. ALL GRADES SHOWN ARE FINAL FINISHED SURFACE GRADES.

WASTEWATER.


- 2. AREAS TO BE SEEDED SHALL HAVE A MINIMUM 6 INCHES TOPSOIL UNLESS OTHERWISE NOTED.
- 3. AREAS NOT RESTORED WITH EROSION MATTING OR OTHER STABILIZATION MEASURES SHALL BE STABILIZED WITH MULCH.
- 4. APPLY ANIONIC POLYMER TO DISTURBED AREAS IF EROSION BECOMES PROBLEMATIC.
- OF "STANDARD SPECIFICATIONS FOR HIGHWAY AND STRUCTURE CONSTRUCTION" (WISDOT 2014) 6. PERMANENT SEEDING SHALL NOT OCCUR BETWEEN SEPTEMBER 15TH AND APRIL 15TH. ALTERNATE SEEDING/PLANTING METHODS AND/OR EROSION PROTECTION MAY BE NECESSARY FOR SEEDING/PLANTING THAT OCCURS DURING THAT TIME. COORDINATE WITH THE OWNER AS NECESSARY.
- 7. TEMPORARY STABILIZATION SHALL CONSIST OF ONE OR MORE OF THE FOLLOWING OPTIONS: a. TEMPORARY SEEDING CONSISTING OF ANNUAL RYE GRASS APPLIED AT A RATE OF 1.5 LBS PER 1000 SQUARE FEET, b. WISDOT PAL CLASS I TYPE B URBAN EROSION CONTROL MAT.



Number

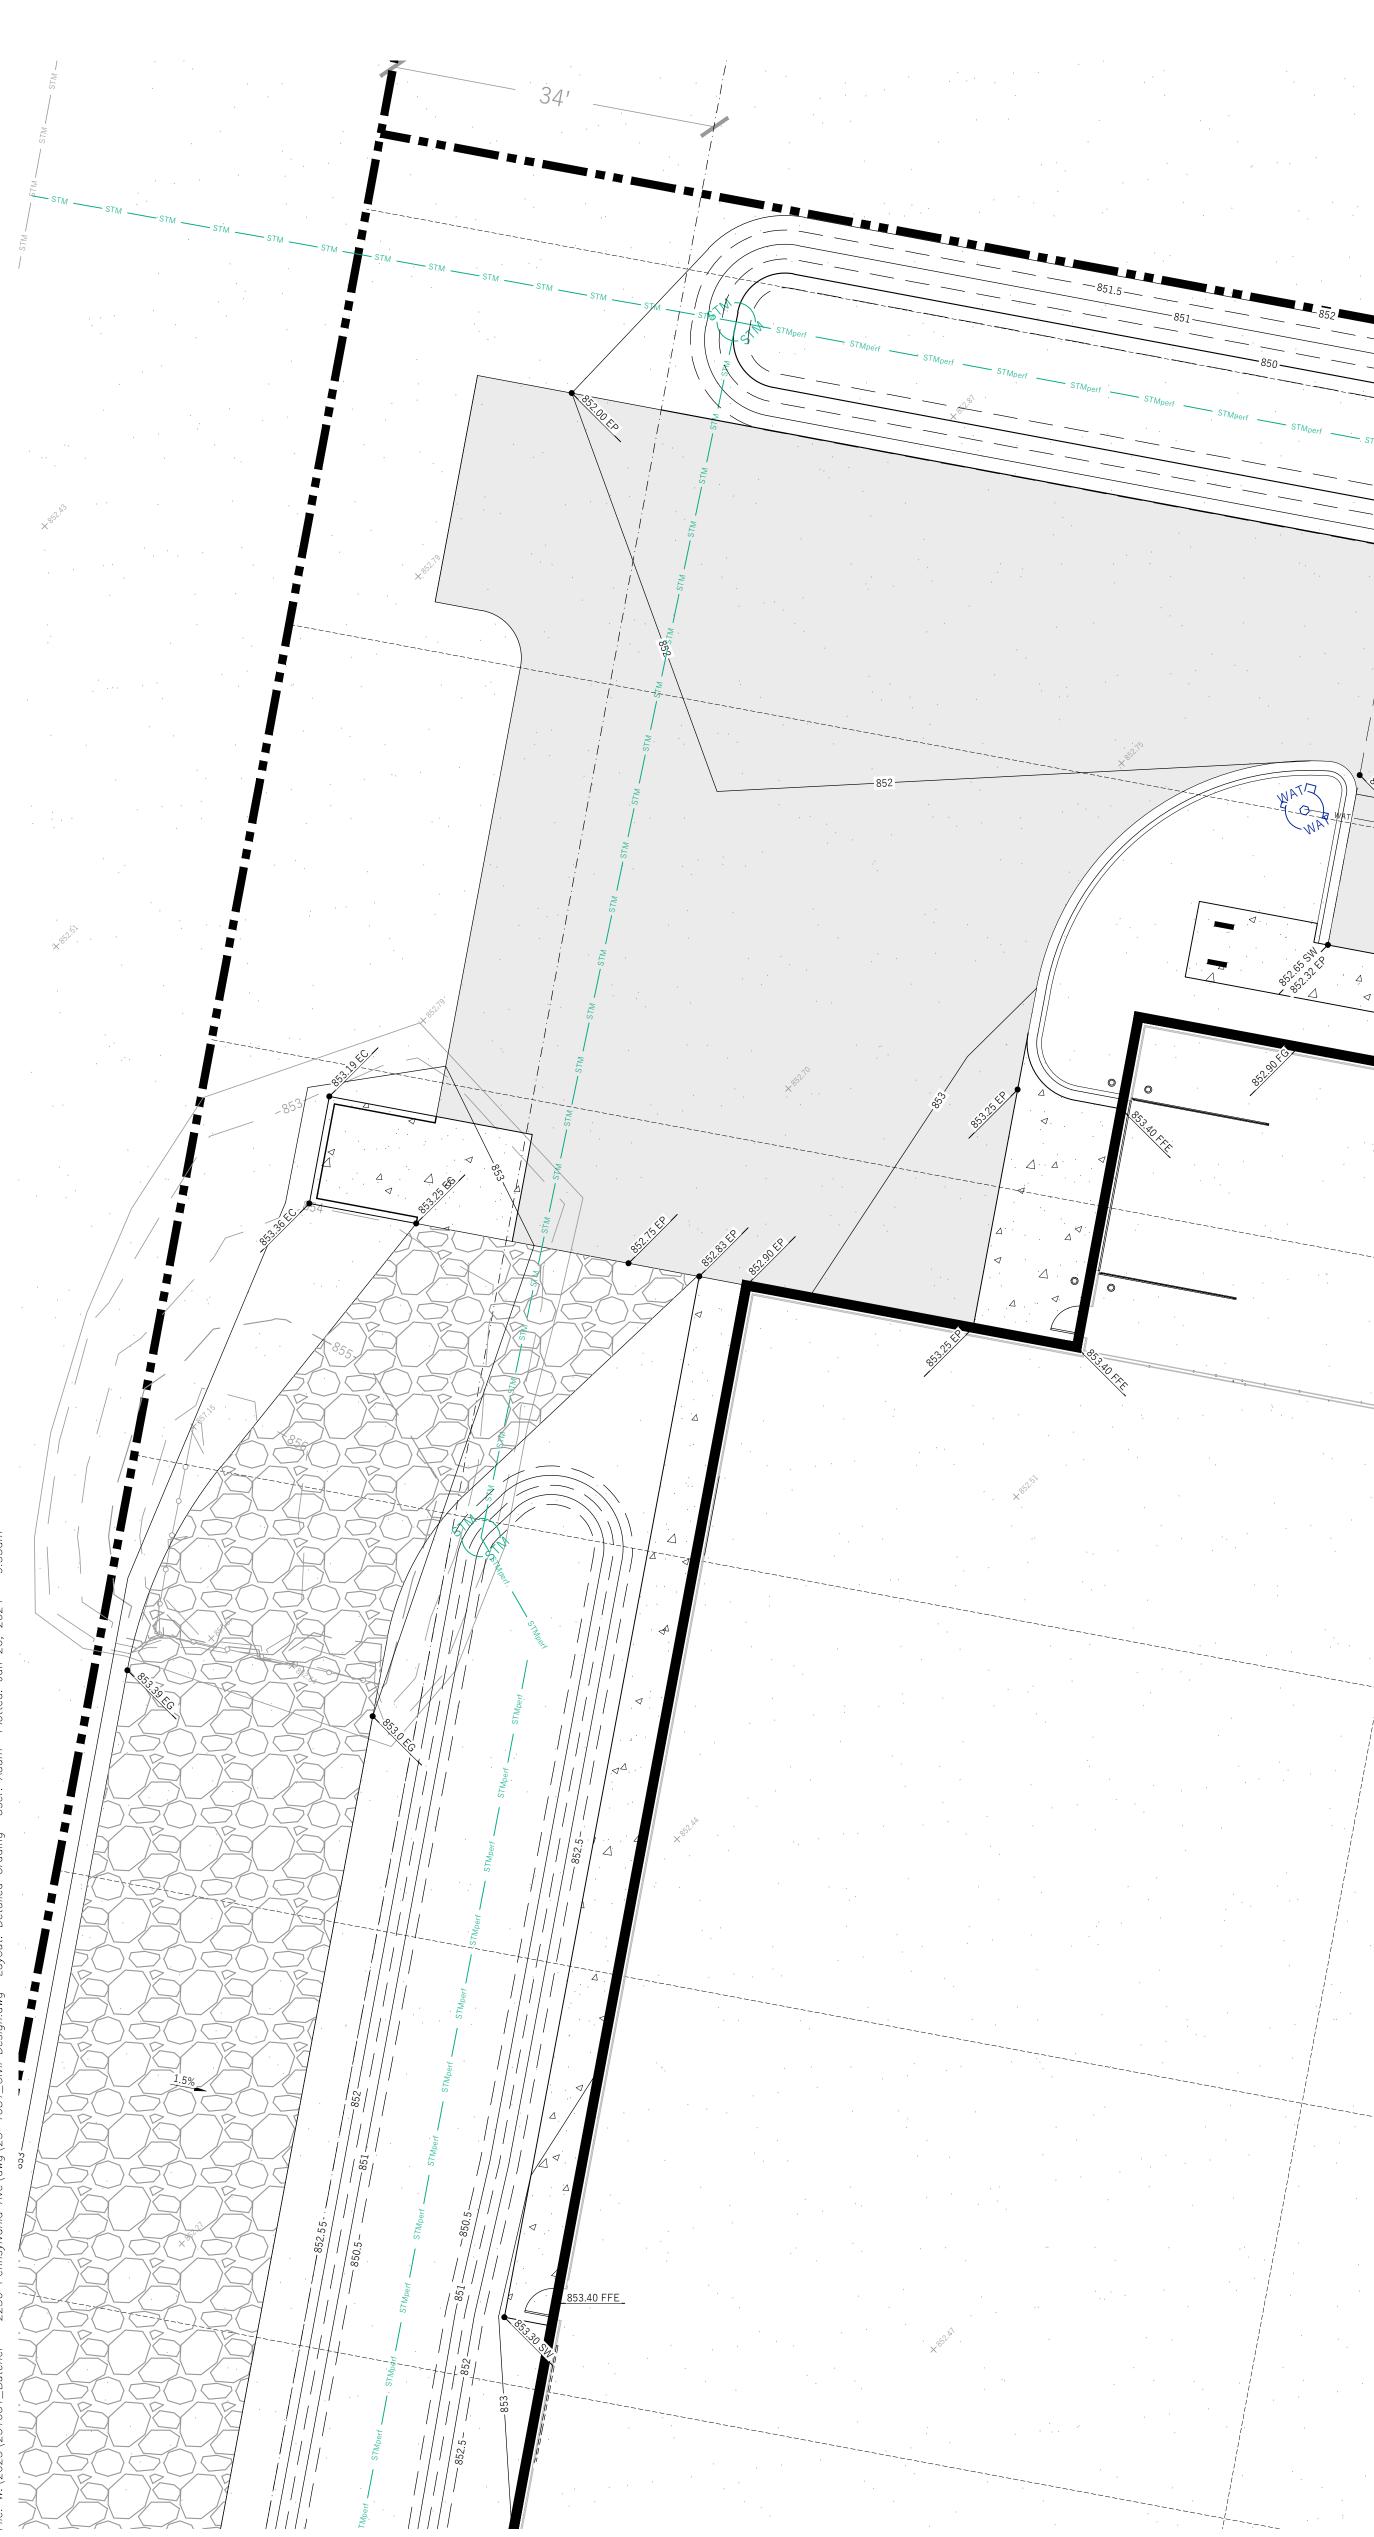


STORMWATE BASIN/NO. 2 INTA -4-0-14 HATI-WAT WAT WAT WAT WAT WAT WAT WAT  $\mathbf{h}$ t- WAT -✓ ∠ <sup>1</sup> 4" THICKENED EDGE SIDEWALK, TYP. SIDEWALK TO BE FLUSH WITH PAVEMENT AT ADA RAMPS. 853.11 SW PROPOSED BUILDING FFE = 853.40  $\bigcirc$   $\bigcirc$   $\bigcirc$ 

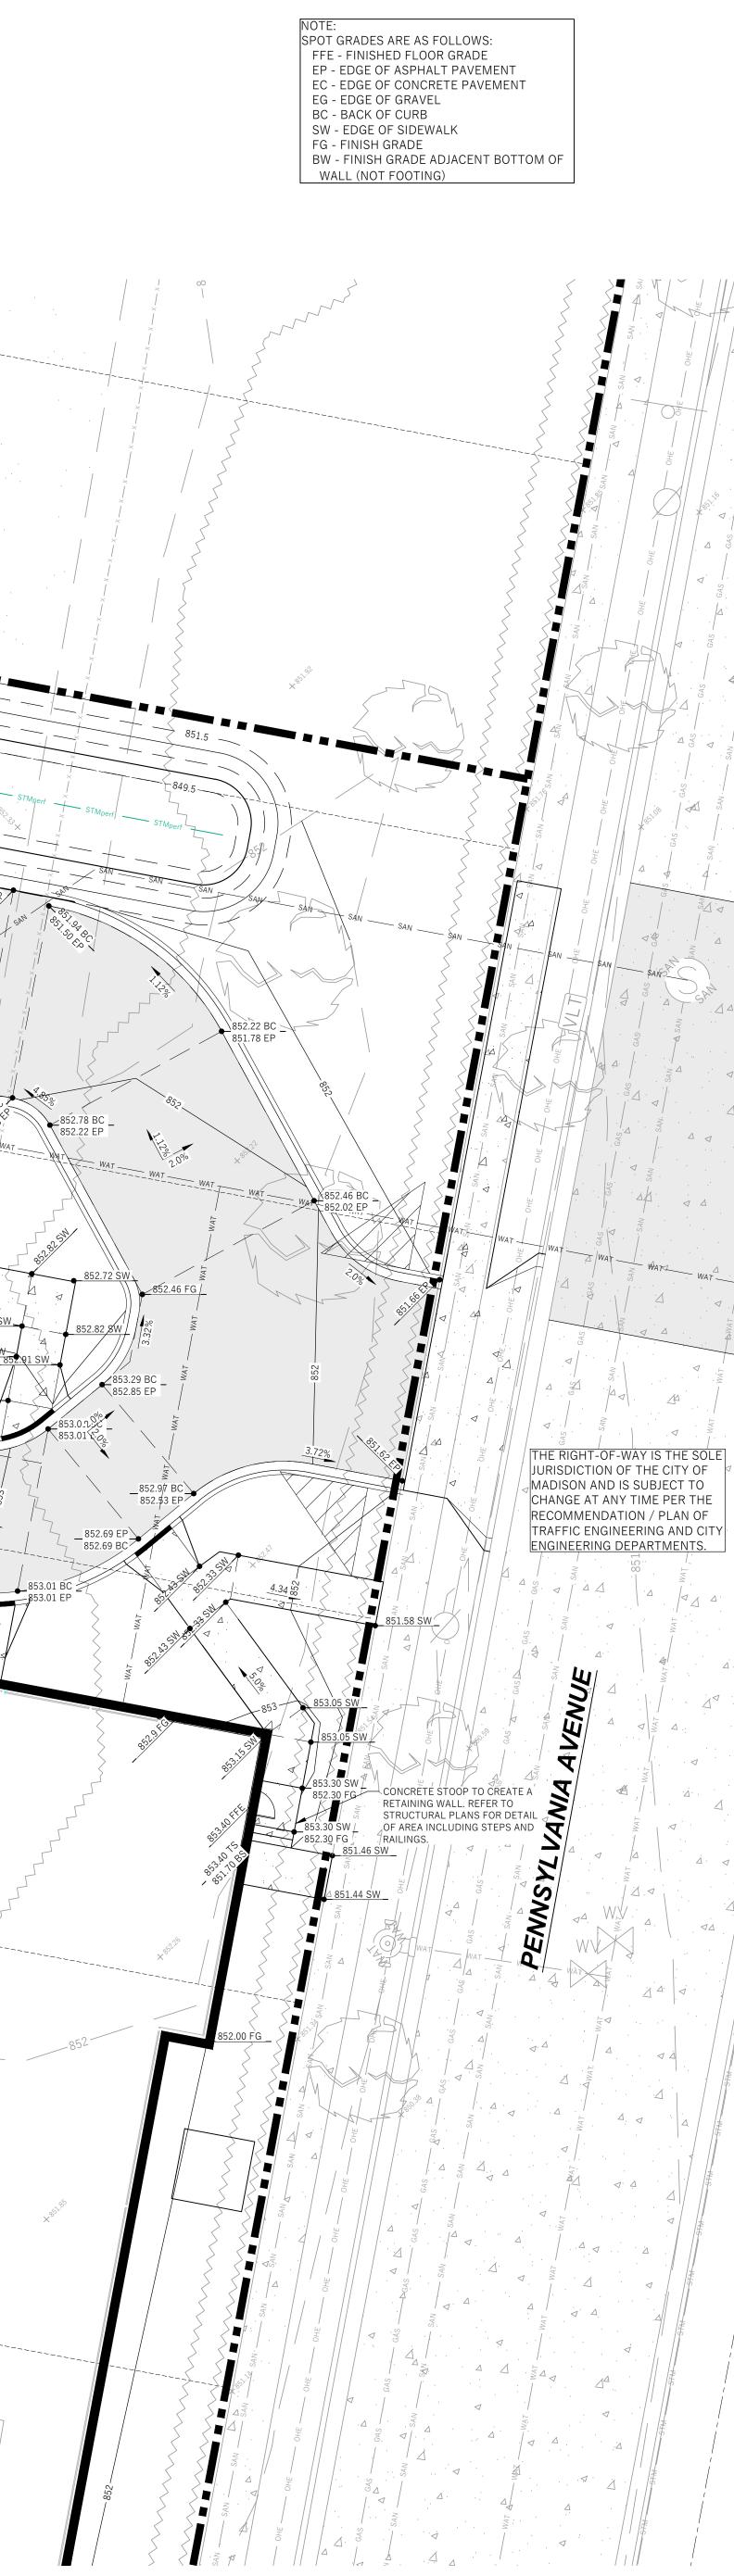

# LEGEND (PROPOSED)

	PROPERTY BOUNDAR
_ · _ · _ · _ · _ · _ · _ · _ · _	EASEMENT
	BUILDING FOOTPRINT
	18" CURB AND GUTTE
	ASPHALT PAVEMENT
	CONCRETE PAVEMEN
	PROPOSED MAJOR CO
852	PROPOSED MINOR CO
STM STM	PROPOSED STORM SE
851.25 EP	SPOT GRADE
	DRAINAGE GRADE BRE
1.0%	DRAINAGE ARROW

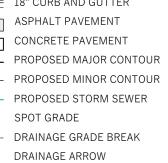


# **GENERAL NOTES**


- . UNDERLYING SITE CONTOURS AND INFORMATION BASED ON TOPOGRAPHIC & UTILITY DATA AS SURVEYED BY WYSER ENGINEERING ON JUNE 12 AND 13, 2023. WYSER ENGINEERING SHALL NOT BE HELD RESPONSIBLE FOR ANY ERRORS OR OMISSIONS THAT MAY ARISE AS A RESULT OF ERRONEOUS OR INCOMPLETE INFORMATION PROVIDED BY OTHERS. CONTRACTOR TO CONFIRM ALL ELEVATIONS, GENERAL DRAINAGE AND EARTHWORK REQUIREMENTS PRIOR TO CONSTRUCTION.
- 2. THE BENCHMARK LOCATIONS ARE SHOWN FOR REFERENCE ONLY ON THIS PLAN. THE BENCHMARKS SHALL BE VALIDATED BY LICENSED LAND SURVEYOR PRIOR TO CONSTRUCTION. CONTRACTOR ASSUMES RISK ASSOCIATED WITH BENCHMARK ELEVATIONS UNTIL CONFIRMED.
- CONTRACTOR TO OBTAIN APPROPRIATE PERMITS FOR STREET OPENINGS & TO WORK WITHIN THE CITY'S LAND AND EASEMENTS AS REQUIRED.
- 4. WYSER ENGINEERING SHALL BE HELD HARMLESS AND DOES NOT WARRANT ANY DEVIATIONS BY THE OWNER OR CONTRACTOR FROM THE APPROVED CONSTRUCTION PLANS THAT MAY RESULT IN DISCIPLINARY ACTIONS BY REGULATORY AGENCIES.
- IF ANY ERRORS, DISCREPANCIES, OR OMISSIONS WITHIN THE PLAN BECOME APPARENT, IT SHALL BE BROUGHT TO THE ATTENTION OF THE ENGINEER PRIOR TO CONSTRUCTION SO THAT CLARIFICATION OR REDESIGN MAY OCCUR. 6. ALL MUNICIPAL UTILITY CONNECTIONS, WORK IN ROW, PUBLIC OUTLOTS AND PUBLIC
- EASEMENTS SHALL BE IN ACCORDANCE WITH CITY OF MADISON STANDARD SPECIFICATIONS FOR PUBLIC WORKS CONSTRUCTION AND SEPARATE PLANS ISSUED BY THE CITY OF MADISON.







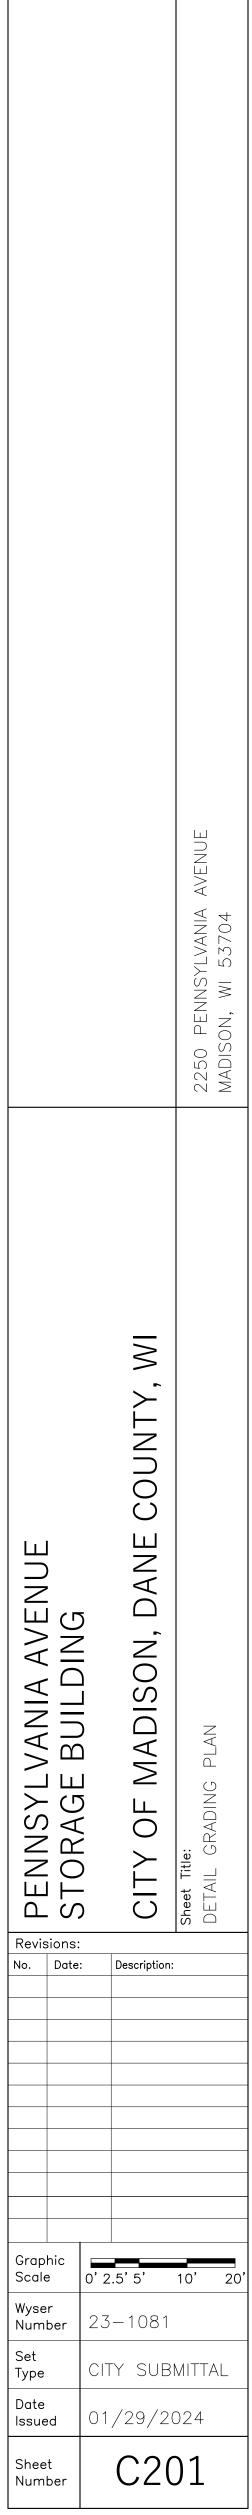

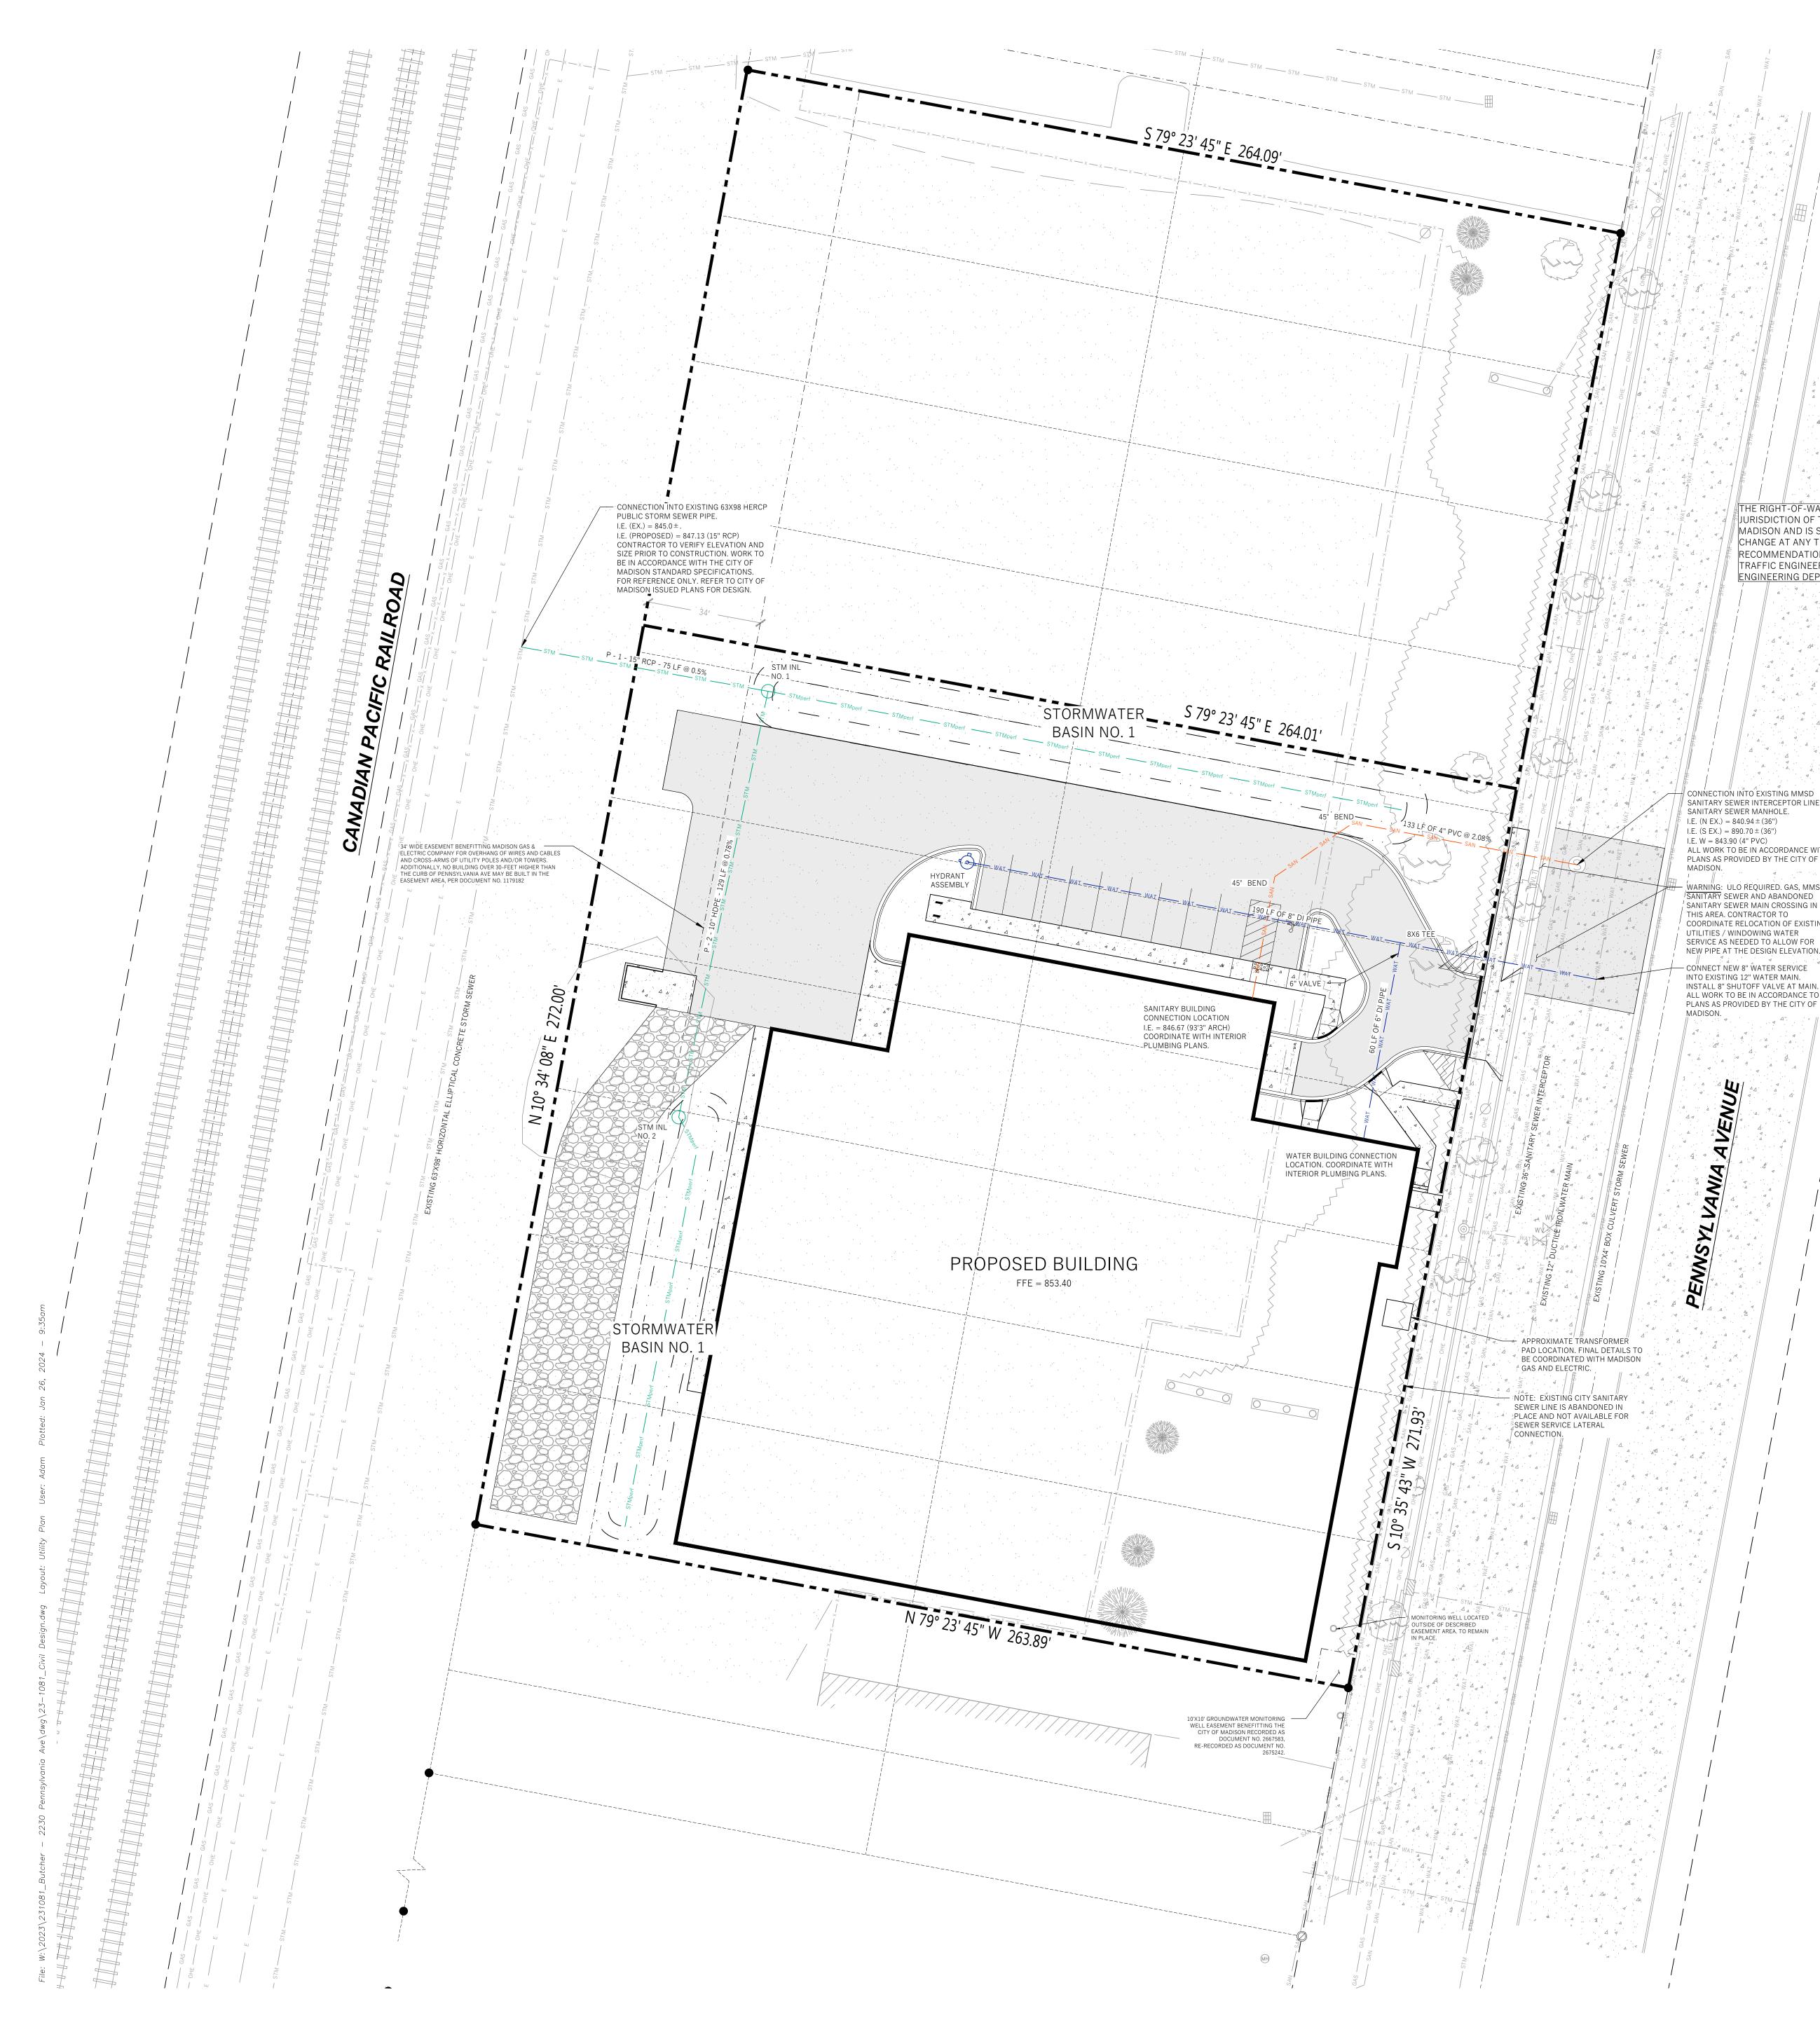

# LEGEND (PROPOSED)

	PROPOSED PROPERTY BOUNDARY
· · ·	EASEMENT
	BUILDING FOOTPRINT
	18" CURB AND GUTTER
	ASPHALT PAVEMENT
	CONCRETE PAVEMENT
WAT WAT	PROPOSED WATER MAIN
SAN SAN	PROPOSED SANITARY SEWER
STM STM	PROPOSED STORM SEWER
GAS GAS	PROPOSED GAS SERVICE (DESIGN BY OTHERS
— E — E —	PROPOSED ELECTRIC SERVICE (DESIGN BY OT
· · · ·	STORMWATER TREATMENT FACILITY
	DRAINAGE GRADE BREAK
1.0%	DRAINAGE ARROW

# **GENERAL NOTES**

1.0%

- 1. UNDERLYING SITE CONTOURS AND INFORMATION BASED ON TOPOGRAPHIC & UTILITY DATA AS SURVEYED BY WYSER ENGINEERING ON JUNE 12 AND 13, 2023. WYSER ENGINEERING SHALL NOT BE HELD RESPONSIBLE FOR ANY ERRORS OR OMISSIONS THAT MAY ARISE AS A RESULT OF ERRONEOUS OR INCOMPLETE INFORMATION PROVIDED BY OTHERS. CONTRACTOR TO CONFIRM ALL ELEVATIONS, GENERAL DRAINAGE AND EARTHWORK REQUIREMENTS PRIOR TO CONSTRUCTION.
- 2. THE BENCHMARK LOCATIONS ARE SHOWN FOR REFERENCE ONLY ON THIS PLAN. THE BENCHMARKS SHALL BE VALIDATED BY LICENSED LAND SURVEYOR PRIOR TO CONSTRUCTION. CONTRACTOR ASSUMES RISK ASSOCIATED WITH BENCHMARK ELEVATIONS UNTIL CONFIRMED. 3. CONTRACTOR TO OBTAIN APPROPRIATE PERMITS FOR STREET OPENINGS & TO WORK WITHIN
- THE CITY'S LAND AND EASEMENTS AS REQUIRED.
- 4. WYSER ENGINEERING SHALL BE HELD HARMLESS AND DOES NOT WARRANT ANY DEVIATIONS BY THE OWNER OR CONTRACTOR FROM THE APPROVED CONSTRUCTION PLANS THAT MAY RESULT IN DISCIPLINARY ACTIONS BY REGULATORY AGENCIES. 5. IF ANY ERRORS, DISCREPANCIES, OR OMISSIONS WITHIN THE PLAN BECOME APPARENT, IT SHALL
- BE BROUGHT TO THE ATTENTION OF THE ENGINEER PRIOR TO CONSTRUCTION SO THAT CLARIFICATION OR REDESIGN MAY OCCUR. 6. ALL MUNICIPAL UTILITY CONNECTIONS, WORK IN ROW, PUBLIC OUTLOTS AND PUBLIC
- EASEMENTS SHALL BE IN ACCORDANCE WITH CITY OF MADISON STANDARD SPECIFICATIONS FOR PUBLIC WORKS CONSTRUCTION AND SEPARATE PLANS ISSUED BY THE CITY OF MADISON.

# UTILITY NOTES

- FIELD. 2. LENGTHS OF ALL UTILITIES ARE TO CENTER OF STRUCTURES OR FITTINGS AND MAY VARY
- SLIGHTLY FROM PLAN. LENGTHS SHALL BE VERIFIED IN THE FIELD DURING CONSTRUCTION.
- 3. CONTRACTOR SHALL VERIFY ALL ELEVATIONS, LOCATIONS, AND SIZES OF SANITARY, WATER AND STORM LATERALS AND CHECK ALL UTILITY CROSSINGS FOR CONFLICTS.
- 4. THE PROPOSED IMPROVEMENTS MUST BE CONSTRUCTED IN ACCORDANCE WITH ENGINEERING PLANS DESIGNED TO MEET ORDINANCES AND REQUIREMENTS OF THE MUNICIPALITY AND WISDOT, WISDSPS, AND WDNR.
- 5. PRIOR TO CONSTRUCTION, THE CONTRACTOR IS RESPONSIBLE FOR: EXAMINING ALL SITES CONDITIONS RELATIVE TO THE CONDITIONS INDICATED ON THE ENGINEERING DRAWINGS. ANY DISCREPANCIES ARE TO BE REPORTED TO THE ENGINEER
- AND RESOLVED PRIOR TO THE START OF CONSTRUCTION. • OBTAINING ALL PERMITS INCLUDING PERMIT COSTS, TAP FEES, METER DEPOSITS, BONDS, AND ALL OTHER FEES REQUIRED FOR PROPOSED WORK TO OBTAIN OCCUPANCY.
- VERIFYING UTILITY ELEVATIONS AND NOTIFYING ENGINEER OF ANY DISCREPANCY. NO WORK SHALL BE PERFORMED UNTIL THE DISCREPANCY IS RESOLVED. NOTIFYING ALL UTILITIES PRIOR TO THE INSTALLATION OF ANY UNDERGROUND
- IMPROVEMENTS. NOTIFYING THE DESIGN ENGINEER AND MUNICIPALITY 48 HOURS PRIOR TO THE START OF CONSTRUCTION TO ARRANGE FOR APPROPRIATE CONSTRUCTION OBSERVATION.
- 9. THE CONTRACTOR IS RESPONSIBLE FOR PROVIDING THE ENGINEER WITH AS-BUILT CONDITIONS OF THE DESIGNATED IMPROVEMENTS IN ORDER THAT THE APPROPRIATE DRAWINGS CAN BE PREPARED, IF REQUIRED. ANY CHANGES TO THE DRAWINGS OR ADDITIONAL
- 10. ANY SANITARY SEWER, SANITARY SEWER SERVICES, WATER MAIN, WATER SERVICES, STORM SEWER, OR OTHER UTILITIES, WHICH ARE DAMAGED BY THE CONTRACTORS, SHALL BE REPAIRED TO THE OWNER'S SATISFACTION AT THE CONTRACTOR'S EXPENSE. NO BLASTING IS ALLOWED WITHIN 30 FEET OF EXISTING UTILITIES.
- 11. ALL PRIVATE INTERCEPTOR WATER MAIN AND WATER SERVICES SHALL BE INSTALLED WITH A 6'
- MINIMUM BURY. PROVIDE INSULATION ABOVE PIPES WITH LESS THAN 5' OF GROUND COVER. 12. GRANULAR BACKFILL MATERIALS ARE REQUIRED IN ALL UTILITY TRENCHES UNDER SIDEWALKS AND PROPOSED PAVED AREAS (UNLESS OTHERWISE SPECIFIED BY A GEOTECHNICAL ENGINEER). ALL UTILITY TRENCH BACKFILL SHALL BE COMPACTED PER SPECIFICATIONS. ALL PAVEMENT PATCHING SHALL COMPLY WITH THE CITY OF MADISON STANDARD SPECIFICATIONS. ADDITIONAL PAVEMENT MILLING AND OVERLAY MAY BE REQUIRED BY PERMIT
- 13. CONTRACTOR SHALL NOTIFY THE MUNICIPAL PUBLIC WORKS DEPARTMENT A MINIMUM OF 48 HOURS BEFORE CONNECTING TO PUBLIC UTILITIES.
- 14. ALL NON-METALLIC BUILDING SEWER AND WATER SERVICES MUST BE ACCOMPANIED BY MEANS OF LOCATING UNDERGROUND PIPE. TRACER WIRE VALVE BOXES SHALL BE INSTALLED ON ALL LATERALS AND AS INDICATED ON THESE PLANS.
- 15. ALL, EXTERIOR CLEANOUTS SHALL BE PROVIDED WITH A FROST SLEEVE IN ACCORDANCE WITH SPS 382.34(5)(a)b AND SPS 384.30(2)(c).
- 16. ALL PRIVATE PLUMBING MATERIALS SHALL CONFORM TO SPS 384.30. 17. ALL PRIVATE PIPE JOINTS SHALL BE INSTALLED PER SPS 384.40.
- 18. ALL PRIVATE WATER PIPE, INCLUDING DEPTH AND SERRATION REQUIREMENTS, SHALL BE IN ACCORDANCE WITH SPS 382.40(8).
- WHEN SCHEDULING THE WORK AND SHALL NOT RESTRICT ACCESS TO THE GAS MAIN CONTRACTOR OR OTHER UTILITY COMPANIES.
- 20. CONTRACTOR SHALL VERIFY AND COORDINATE ALL UTILITY CONNECTIONS WITH THE BUILDING PRIOR TO CONSTRUCTION.
- 21. THE CONTRACTOR SHALL CONDUCT HIS OPERATIONS SO AS TO BE IN CONFORMANCE WITH THE CITY EROSION CONTROL AND STORMWATER ORDINANCE, AND DNR ADMINISTRATIVE RULE NR 216 AT ALL TIMES.

THE RIGHT-OF-WAY IS THE SOLE JURISDICTION OF THE CITY OF MADISON AND IS SUBJECT TO CHANGE AT ANY TIME PER THE RECOMMENDATION / PLAN OF TRAFFIC ENGINEERING AND CITY ENGINEERING DEPARTMENTS.

CONNECTION INTO EXISTING MMSD SANITARY SEWER INTERCEPTOR LINE SANITARY SEWER MANHOLE. I.E. (N EX.) = 840.94 ± (36") I.E. (S EX.) = 890.70 ± (36") W = 843.90 (4" PV

ALL WORK TO BE IN ACCORDANCE WITH PLANS AS PROVIDED BY THE CITY OF

NING: ULO REQUIRED. GAS, MMSD SANITARY SEWER AND ABANDONED SANITARY SEWER MAIN CROSSING IN THIS AREA. CONTRACTOR TO COORDINATE RELOCATION OF EXISTING UTILITIES / WINDOWING WATER SERVICE AS NEEDED TO ALLOW FOR NEW PIPE AT THE DESIGN ELEVATION. CONNECT NEW 8" WATER SERVICE

ALL WORK TO BE IN ACCORDANCE TO PLANS AS PROVIDED BY THE CITY OF

T

DIGGERS 🕹 H Toll Free (800) 242-8511 -or- 811 Hearing Impaired TDD (800) 542-2289 www.DiggersHotline.com



THERS)


1. DIMENSIONS TAKE PRECEDENCE OVER SCALE. CONTRACTOR TO VERIFY ALL DIMENSIONS IN


ITEMS MUST BE REPORTED TO THE ENGINEER AS WORK PROGRESSES.


19. THE CONTRACTOR SHALL ALLOW 10 WORKING DAYS FOR THE CONSTRUCTION OF GAS MAINS







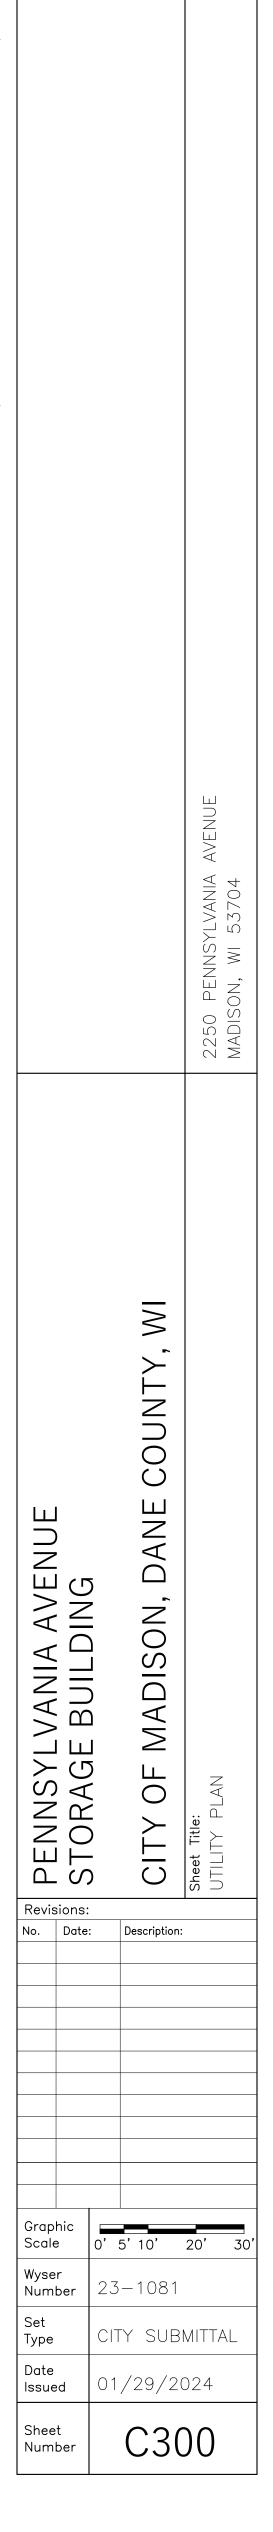

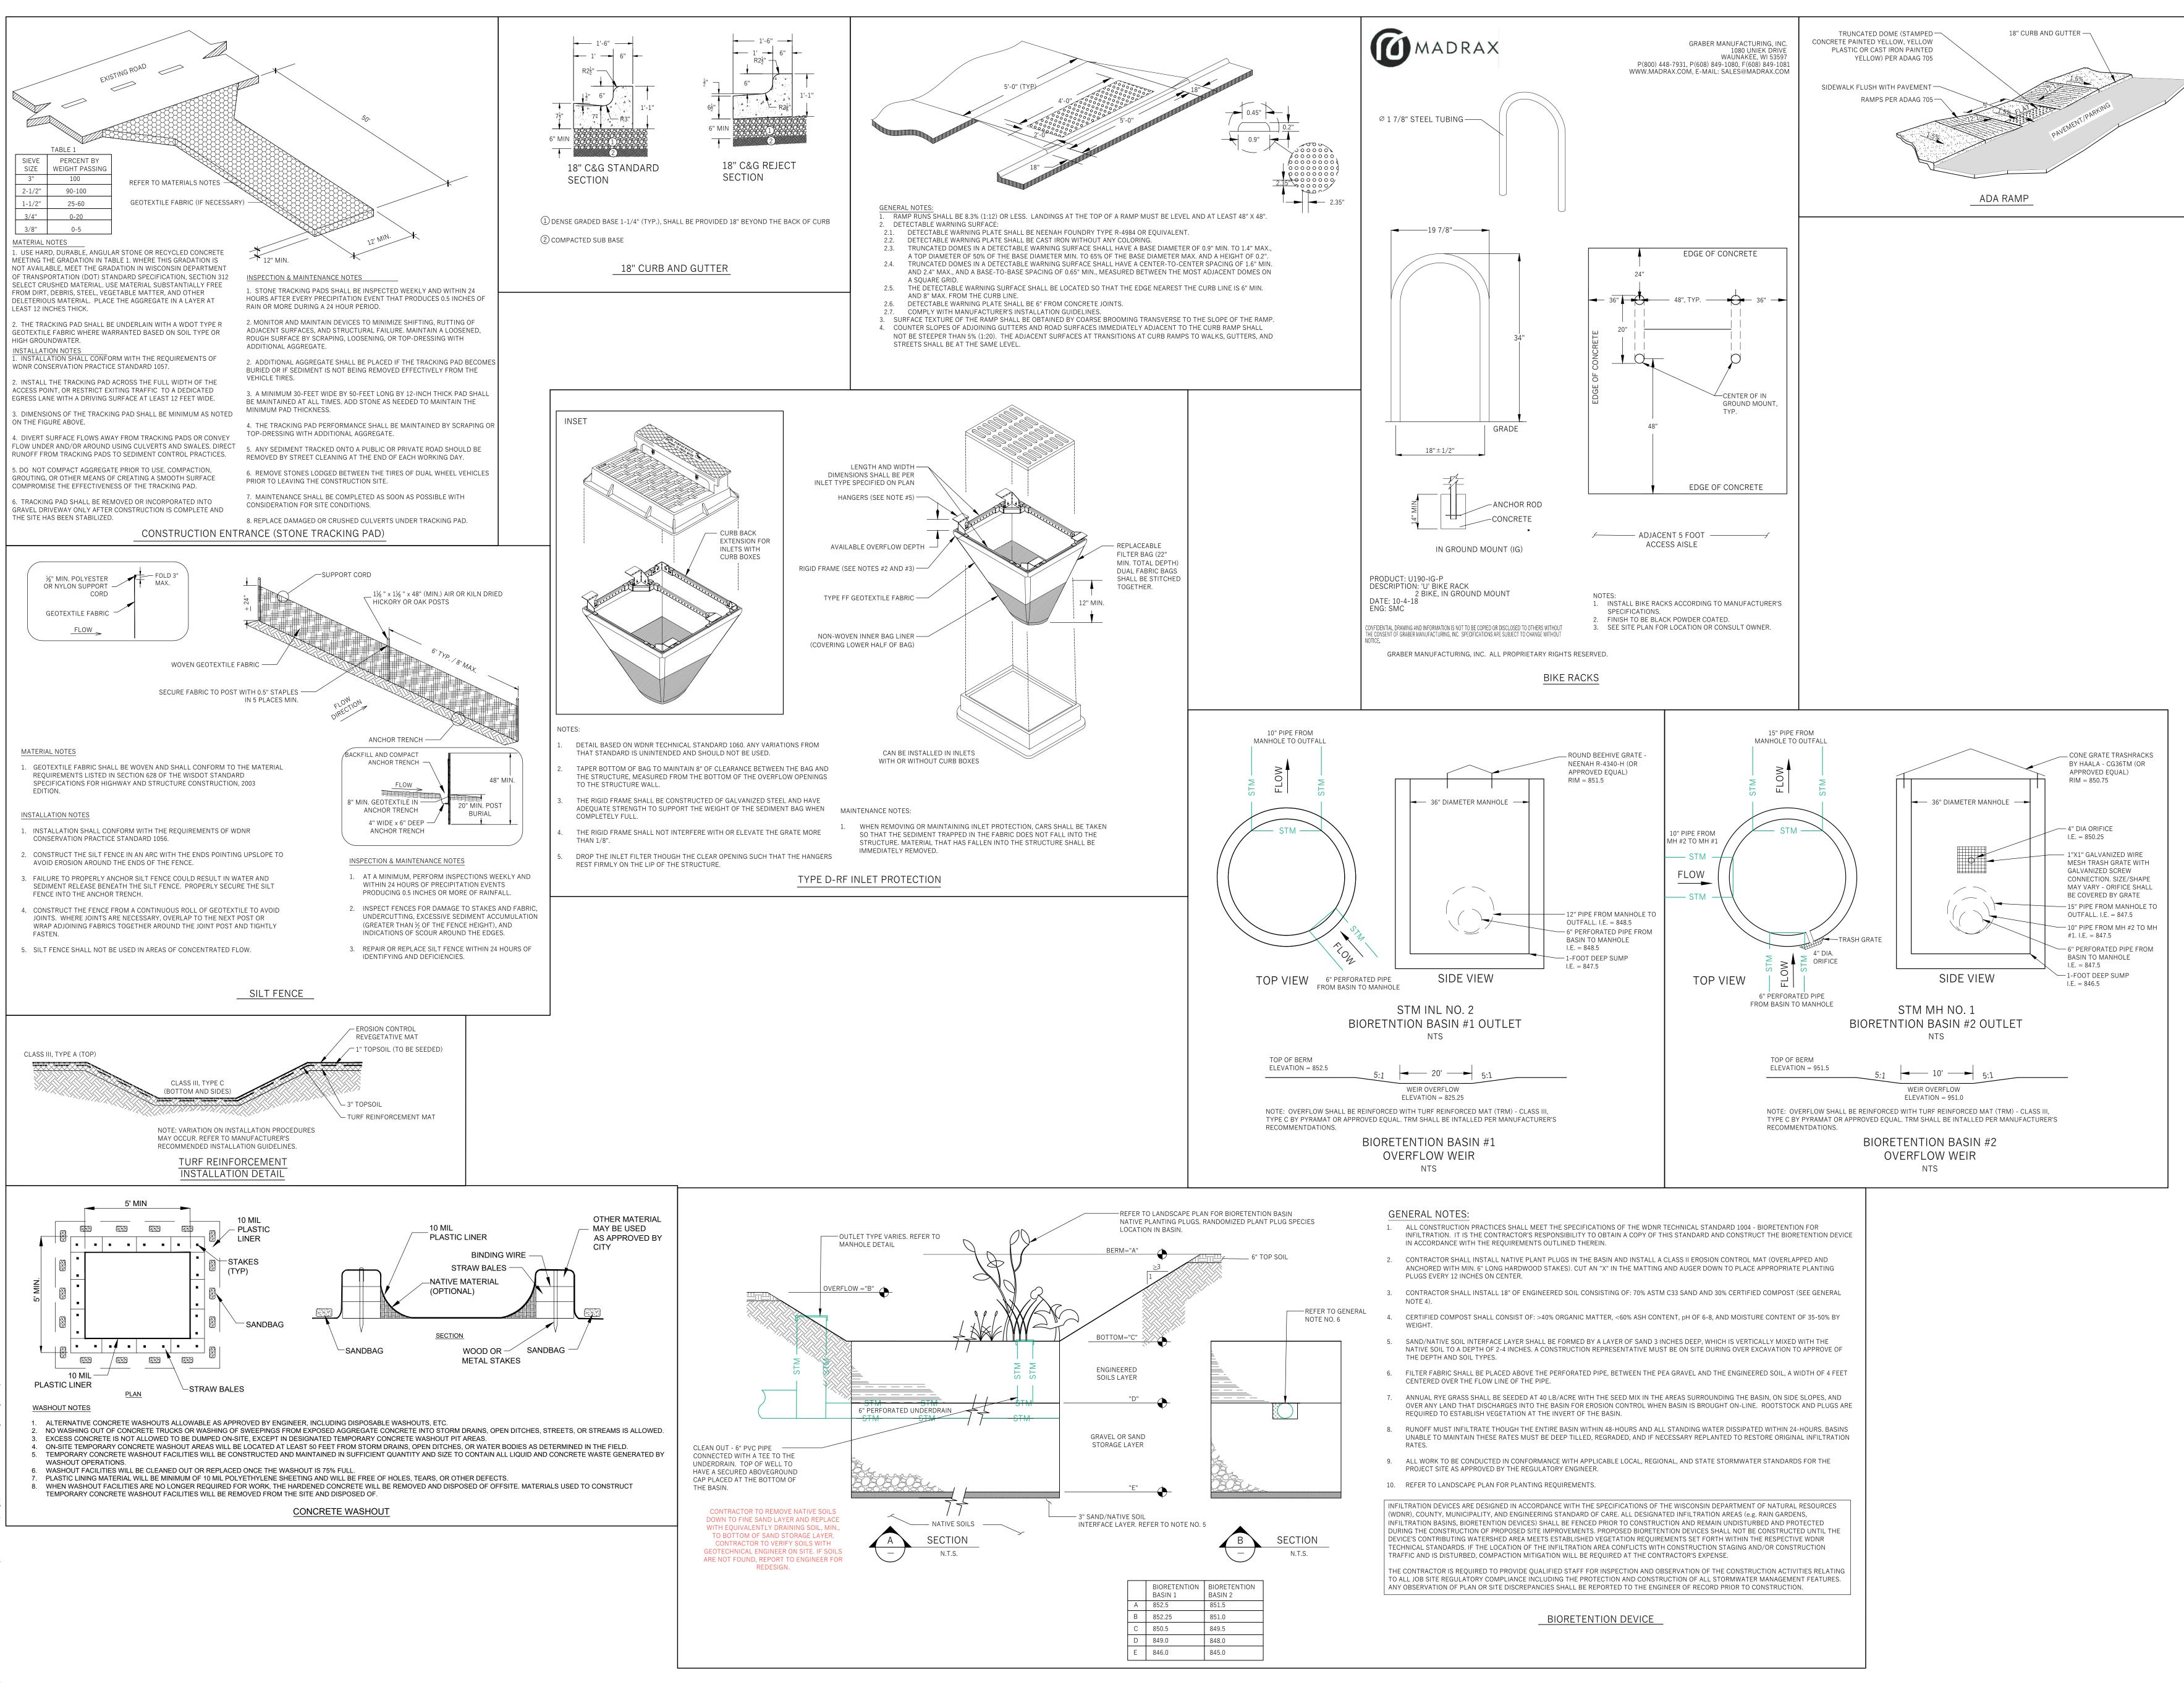

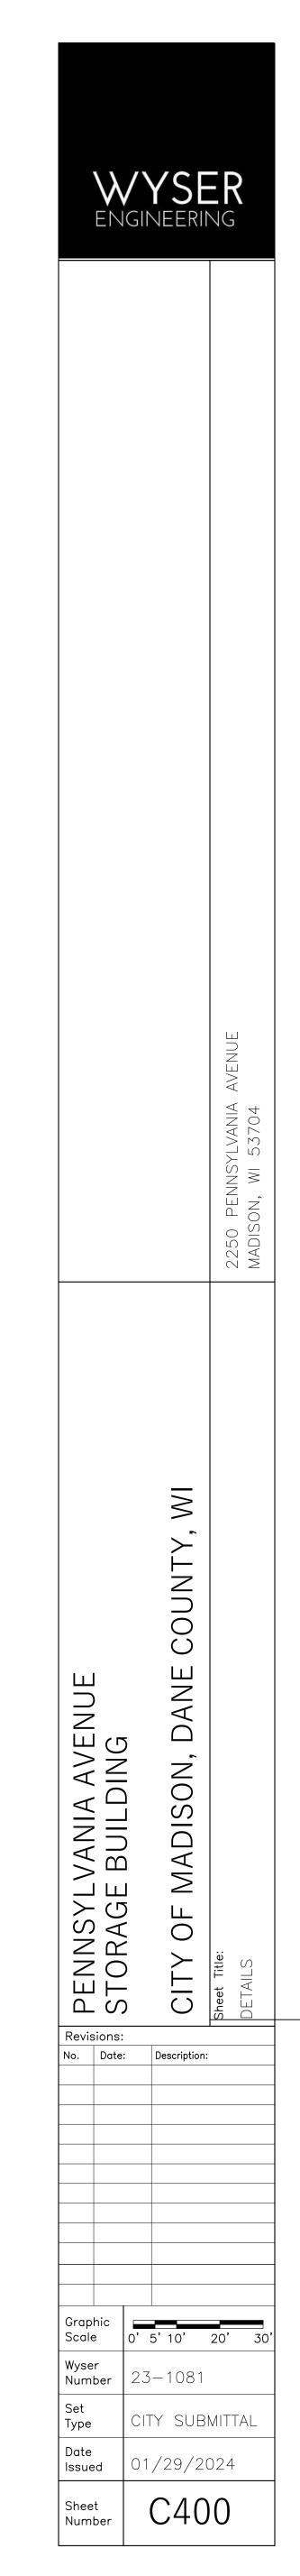

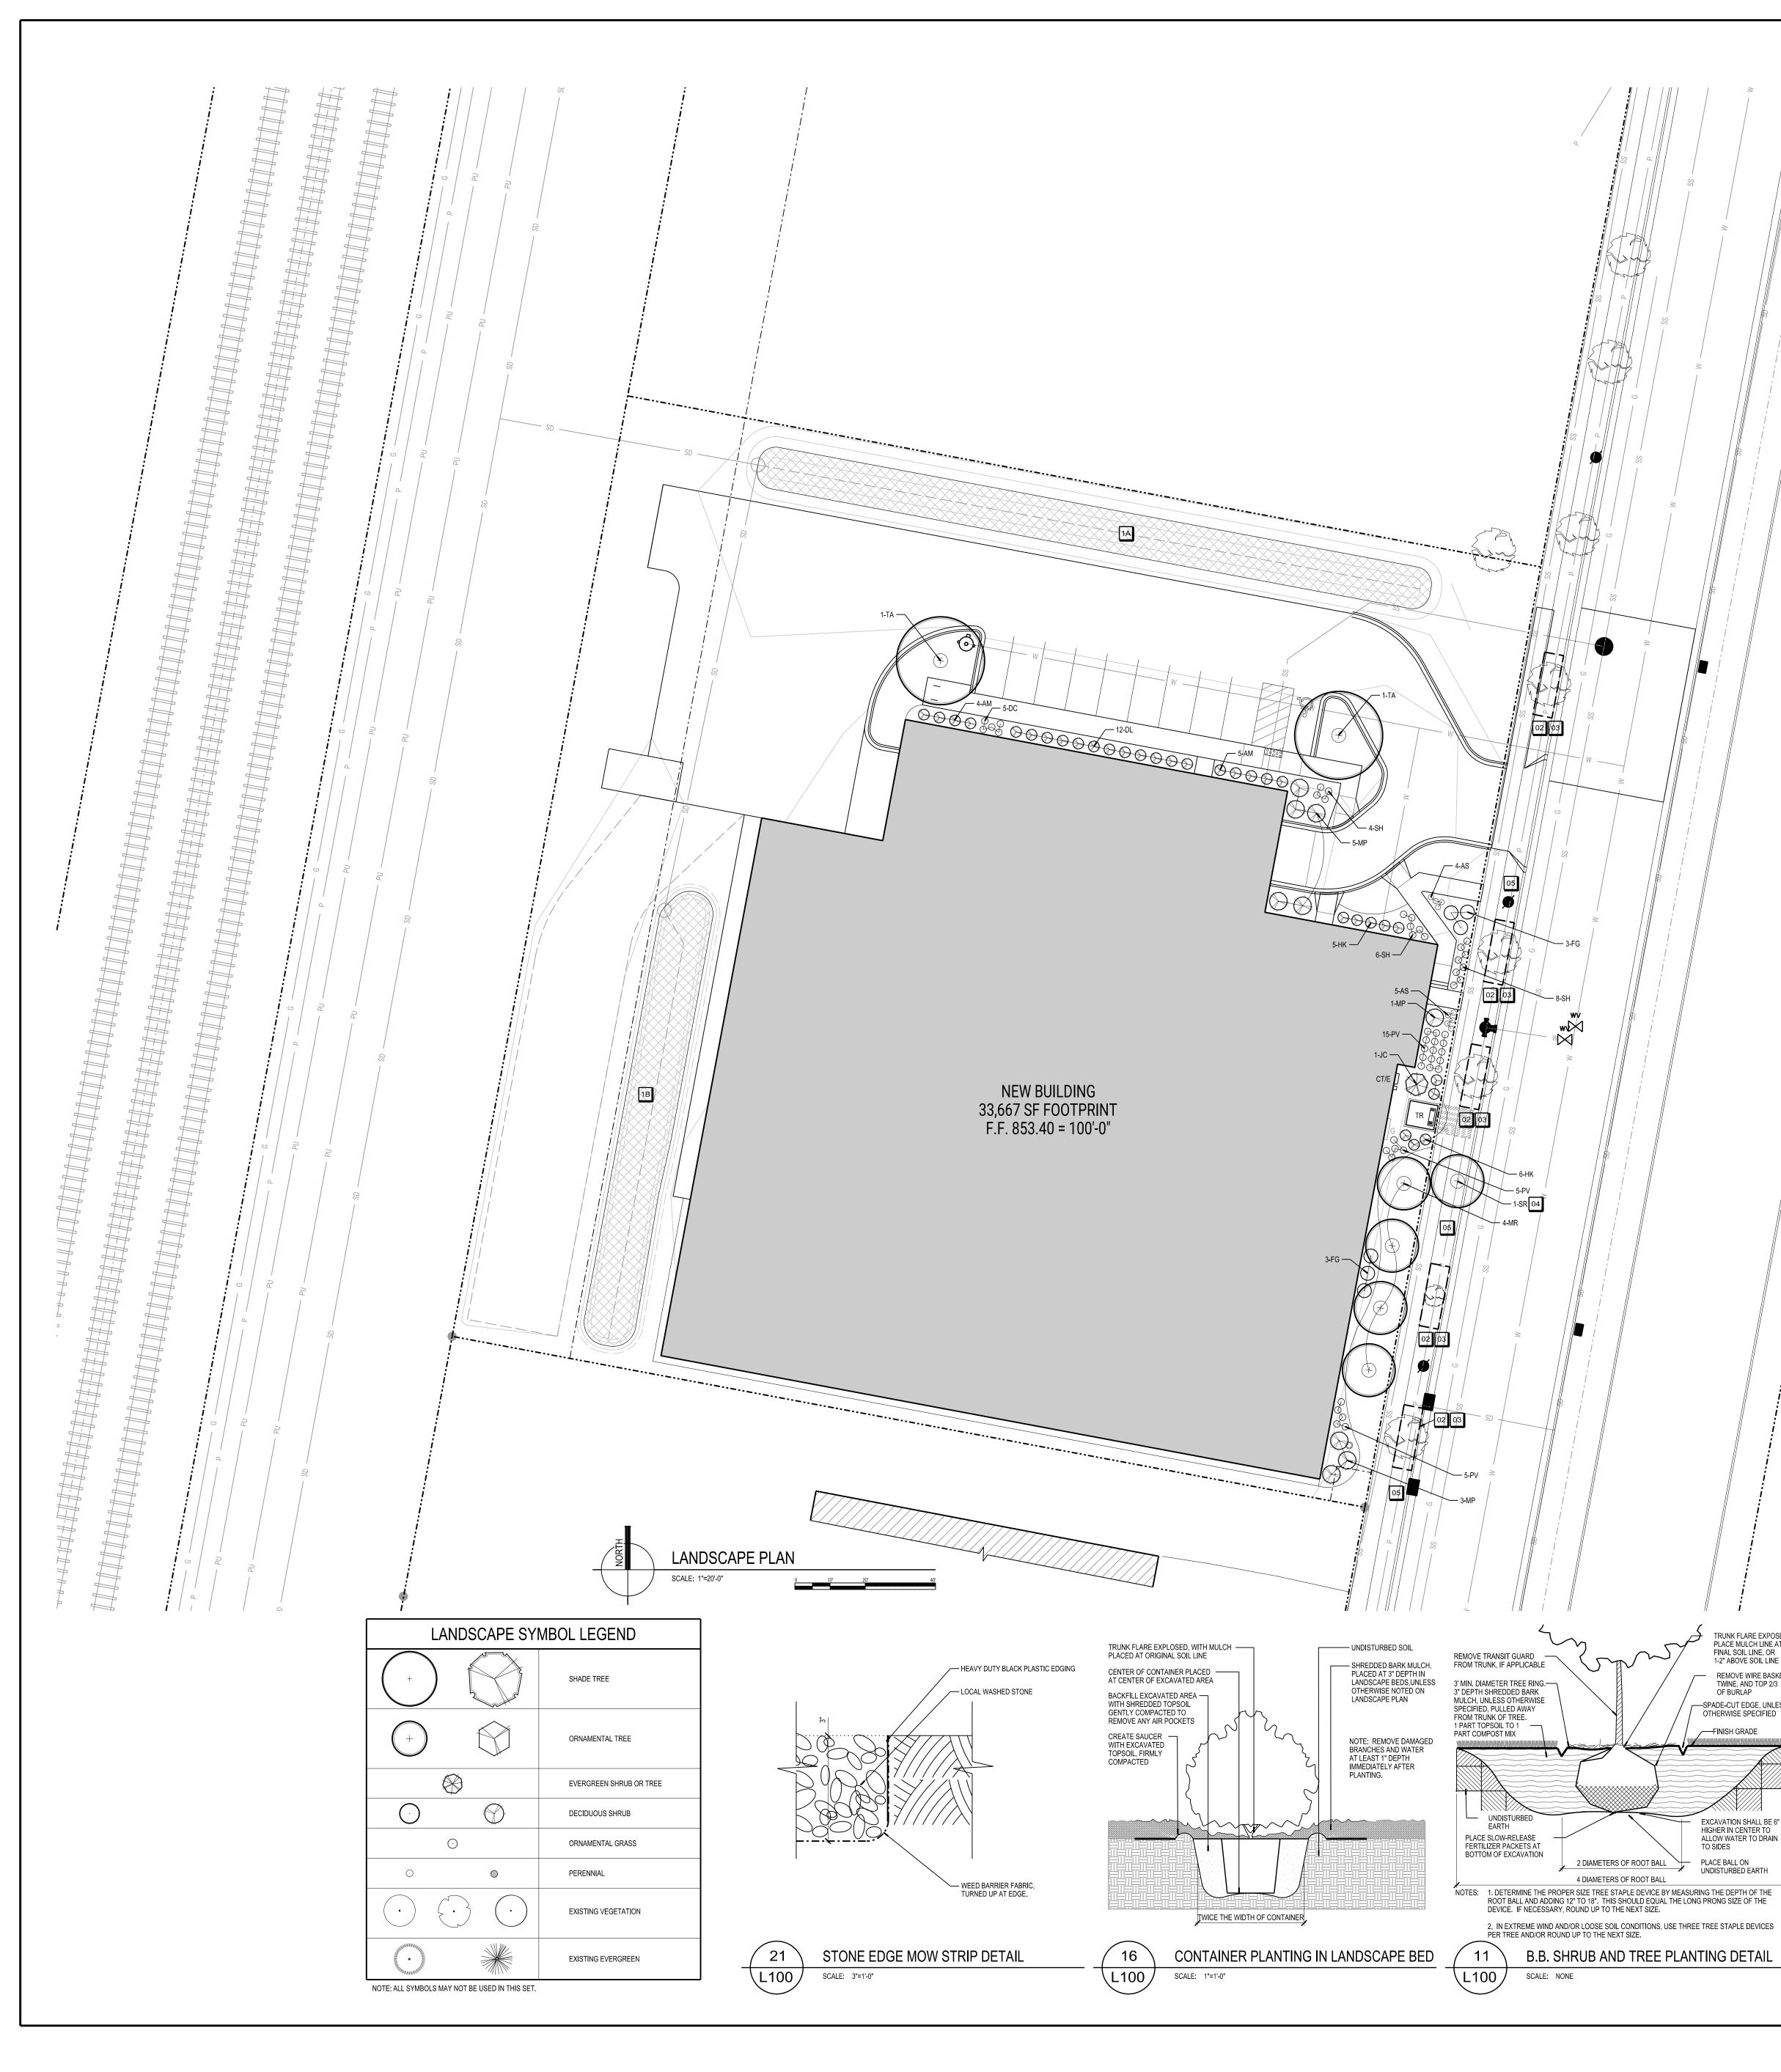

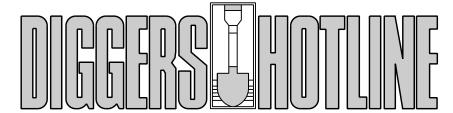

CALL TOLL FREE 1-800-242-8511 MILWAUKEE AREA 414-259-1181 FAX A LOCATE 1-800-338-3860 TDD (HEARING IMPAIRED) 1-800-542-2289 **ONLINE:** www.DiggersHotline.com WISCONSIN STATUE 182.0175 (1974) REQUIRES A MINIMUM OF THREE (3) WORKING DAYS NOTICE PRIOR TO EXCAVATION.

1A	NEW STORMWATER PLUG PLANTINGS: 2,300 SF: BASE MATRIX, PLANTED AT 12" O.C. AND INTERMIXED: 25% CAREX VULPINOIDES (FOX SEDGE) = 575 PLUGS 25% CAREX HYSTERICINA (PORCUPINE SEDGE) = 575 PLUGS 25% CHASMANTHIUM LATIFOLIUM (NORTHERN SEA OATS) = 575 PLUGS 25% SCHIZACHYRIUM SCOPARIUM (LITTLE BLUESTEM) = 575 PLUGS
	PLANT IN BETWEEN BASE MATRIX IN DRIFTS OF AT LEAST 4: 16 PLUGS ASCLEPIAS INCARNATA (SWAMP MILKWEED) 16 PLUGS PYNCANTHEMUM VIRGINIANUM (MOUNTAIN MINT) 16 PLUGS MONARDA FISTULOSA (WILD BERGAMOT) 16 PLUGS ECHINACEA PURPUREA (PURPLE CONEFLOWER)
1B	NEW STORMWATER PLUG PLANTINGS: 1,890 SF: BASE MATRIX, PLANTED AT 12" O.C. AND INTERMIXED: 25% CAREX VULPINOIDES (FOX SEDGE) = 470 PLUGS 25% CAREX HYSTERICINA (PORCUPINE SEDGE) = 470 PLUGS 25% CHASMANTHIUM LATIFOLIUM (NORTHERN SEA OATS) = 470 PLUGS 25% SCHIZACHYRIUM SCOPARIUM (LITTLE BLUESTEM) = 470 PLUGS
	PLANT IN BETWEEN BASE MATRIX IN DRIFTS OF AT LEAST 4: 16 PLUGS ASCLEPIAS INCARNATA (SWAMP MILKWEED) 16 PLUGS PYNCANTHEMUM VIRGINIANUM (MOUNTAIN MINT) 16 PLUGS MONARDA FISTULOSA (WILD BERGAMOT) 16 PLUGS ECHINACEA PURPUREA (PURPLE CONEFLOWER)
-	ON THIS PROJECT, STREET TREE PROTECTION ZONE FENCING IS REQUIRED. THE FENCING SHALL BE ERECTED BEFORE THE DEMOLITION, GRADING OR CONSTRUCTION BEGINS. THE FENCE SHALL INCLUDE THE ENTIRE WIDTH OF TERRACE AND, EXTEND AT LEAST 5 FEET ON BOTH SIDES OF THE OUTSIDE EDGE OF THE TREE TRUNK. DO NOT REMOVE THE FENCING TO ALLOW FOR DELIVERIES OR EQUIPMENT ACCESS THROUGH THE TREE PROTECTION ZONE.
03	ANY STREET TREE PRUNING SHALL BE COORDINATED WITH MADISON FORESTRY AT A MINIMUM OF TWO WEEKS PRIOR TO THE START OF CONSTRUCTION FOR THIS PROJECT. ALL PRUNING SHALL FOLLOW THE AMERICAN NATIONAL STANDARDS INSTITUTE (ANSI) A300 - PART 1 STANDARDS FOR PRUNING.
	AT LEAST ONE WEEK PRIOR TO STREET TREE PLANTING, CONTRACTOR SHALL CONTACT CITY FOREST AT 608-266-416 TO SCHEDULE INSPECTION AND APPROVAL OF NURSERY TREE STOCK AND REVIEW PLANTING SPECIFICATIONS WITH THE LANDSCAPER.
05	SOD ANY ROW DISTURBED DURING CONSTRUCTION.

LANDSCAPE GENERAL NOTES



- OF THE TREE OR WITHIN THE PROTECTION ZONE IS PROHIBITED. 15. SECTION 107.13(G) OF CITY OF MADISON STANDARD SPECIFICATIONS FOR PUBLIC WORKS CONSTRUCTION ADDRESSES SOIL COMPACTION NEAR STREET TREES AND SHALL BE FOLLOWED BY CONTRACTOR. THE STORAGE OF PARKED VEHICLES, CONSTRUCTION EQUIPMENT, BUILDING MATERIALS, REFUSE, EXCAVATED SPOILS OR DUMPING OF POISONOUS MATERIALS ON OR AROUND TREES AND ROOTS WITHIN FIVE (5) FEET OF THE TREE OR WITHIN THE PROTECTION ZONE IS PROHIBITED. 16. STREET TREE PRUNING SHALL BE COORDINATED WITH MADISON FORESTRY AT A MINIMUM OF TWO WEEKS PRIOR TO THE START OF CONSTRUCTION FOR THIS PROJECT. ALL PRUNING SHALL
- FOLLOW THE AMERICAN NATIONAL STANDARDS INSTITUTE (ANSI) A300 PART 1 STANDARDS FOR PRUNING 17. LANDSCAPE BEDS AND FRONT LAWN TO HAVE IRRIGATION SYSTEM, SYSTEM TO BE DESIGN-BUILD.



01/25/2024

# City of Madison Landscape Requirements

Total SF Developed Area (Paved Areas,		
Excluding Greenspace and Building)	19,386	sf
		Landscape
Site Zoned IL, Provide 1 landscape point		Points
per 100 sf Developed Area	194	Required


		Proposed Landscaping		
		Points		
Plant Type / Element	Points	Quantity	Achieved	
Overstory Deciduous Tree, 3" Cal. DBH	35	2	70	
Ornamental Tree, 1.5" Cal.	15	4	60	
Upright Evergreen Shrub, 3-4' H	10	1	10	
Shrub, Deciduous, #3 Gallon, 12-24" H	3	48	144	
Ornamental Grasses/Perennials, #1 Gallon	2	48	96	
Total Number of Points Provided: 380				

LANDSCAPE PLANT LEGEND						
SYMBOL	BOTANICAL NAME	COMMON NAME	INSTALLED SIZE	ROOT	MATURE SIZE	QTY
TREES:						
MR	Malus 'Royal Raindrops'	Royal Raindrops Crabapple	1.5" Cal.	B.B.	20' H x 15' W	4
SR	Syringa reticulata 'Ivory Silk'	lvory Silk Japanese Tree Lilac	2" Cal.	B.B.	20' H x 20' W	1
TA	Tilia americana 'Sentry'	Sentry American Linden	3" Cal.	B.B.	50' H x 25' W	2
SHRUBS:						
AM	Aronia melanocarpa 'Morton'	Iroquois Beauty Black Chokeberry	3' H	3 Gallon	3' H x 5' W	9
DL	Diervilla lonicera	Dwarf Bush Honeysuckle	18-24" H	3 Gallon	3-4' H x 3-4' W	12
FG	Fothergilla gardenii 'Beaver Creek'	Beaver Creek Dwarf Fothergilla	24" High	3 Gallon	3-4' H x 3-4' W	6
HK	Hypericum kalmianum	St. John's Wort	4-5 Gallon	3 Gallon	3-4' H x 3-4' W	11
JC	Juniperus chinensis 'Fairview'	Fairview Upright Juniper	4' High	B.B.	15' H x <mark>6-7' W</mark>	1
MP	Myrica pennsylvanica	Northern Bayberry	18" High	3 Gallon	4-5' H x 4-5' W	9
GRASSES	5:					
DC	Deschampsia cespitosa 'Goldschleier'	Goldschleier Tufted Hair Grass	1 Gallon		24" H / W	5
PV	Panicum virgatum 'Rotstrahlbusch'	Rotstrahlbusch Switch Grass	1 Gallon		4' H x 2' W	25
SH	Sporobolus heterlepis	Prairie Dropseed	1 Gallon		24" H x 24" W	18
PERENNIA	ALS:					
AS	Allium 'Summer Beauty'	Summer Beauty Onion	4.5" Pot		18" H x 12" W	9

TRUNK FLARE EXPOSED-PLACE MULCH LINE AT FINAL SOIL LINE, OR 1-2" ABOVE SOIL LINE REMOVE WIRE BASKET, TWINE, AND TOP 2/3 OF BURLAP OTHERWISE SPECIFIED -FINISH GRADE EXCAVATION SHALL BE 6" HIGHER IN CENTER TO ALLOW WATER TO DRAIN TO SIDES PLACE BALL ON

UNDISTURBED EARTH


A	ARCHITECTS/ENGINEER Janesville   Madison	
<b>NO:</b> 01	ISSUANCES / REVISIONS DESCRIPTION: UDC + LAND USE SUBMITTAL	<b>DATE:</b> 01/29/2024
:06:33 AM	Due to electronic distribution, this drawin	1/25/2024 g may
	not be printed to the scale indicated on drawings. Do NOT use scale to determ dimensions or sizes. No part of this drawing may be used	the ine or
	reproduced in any form or by any means stored in a database or retrieval syste without prior written permission of ANGUS - YOUNG ASSOCIATES, INC	s, or m,
	Copyright © 2023 All Rights Reser	ved
-	76850	
-	JAD	
-	DIVIA	
	KAU	
	KAU	
	каи <b>L100</b>	

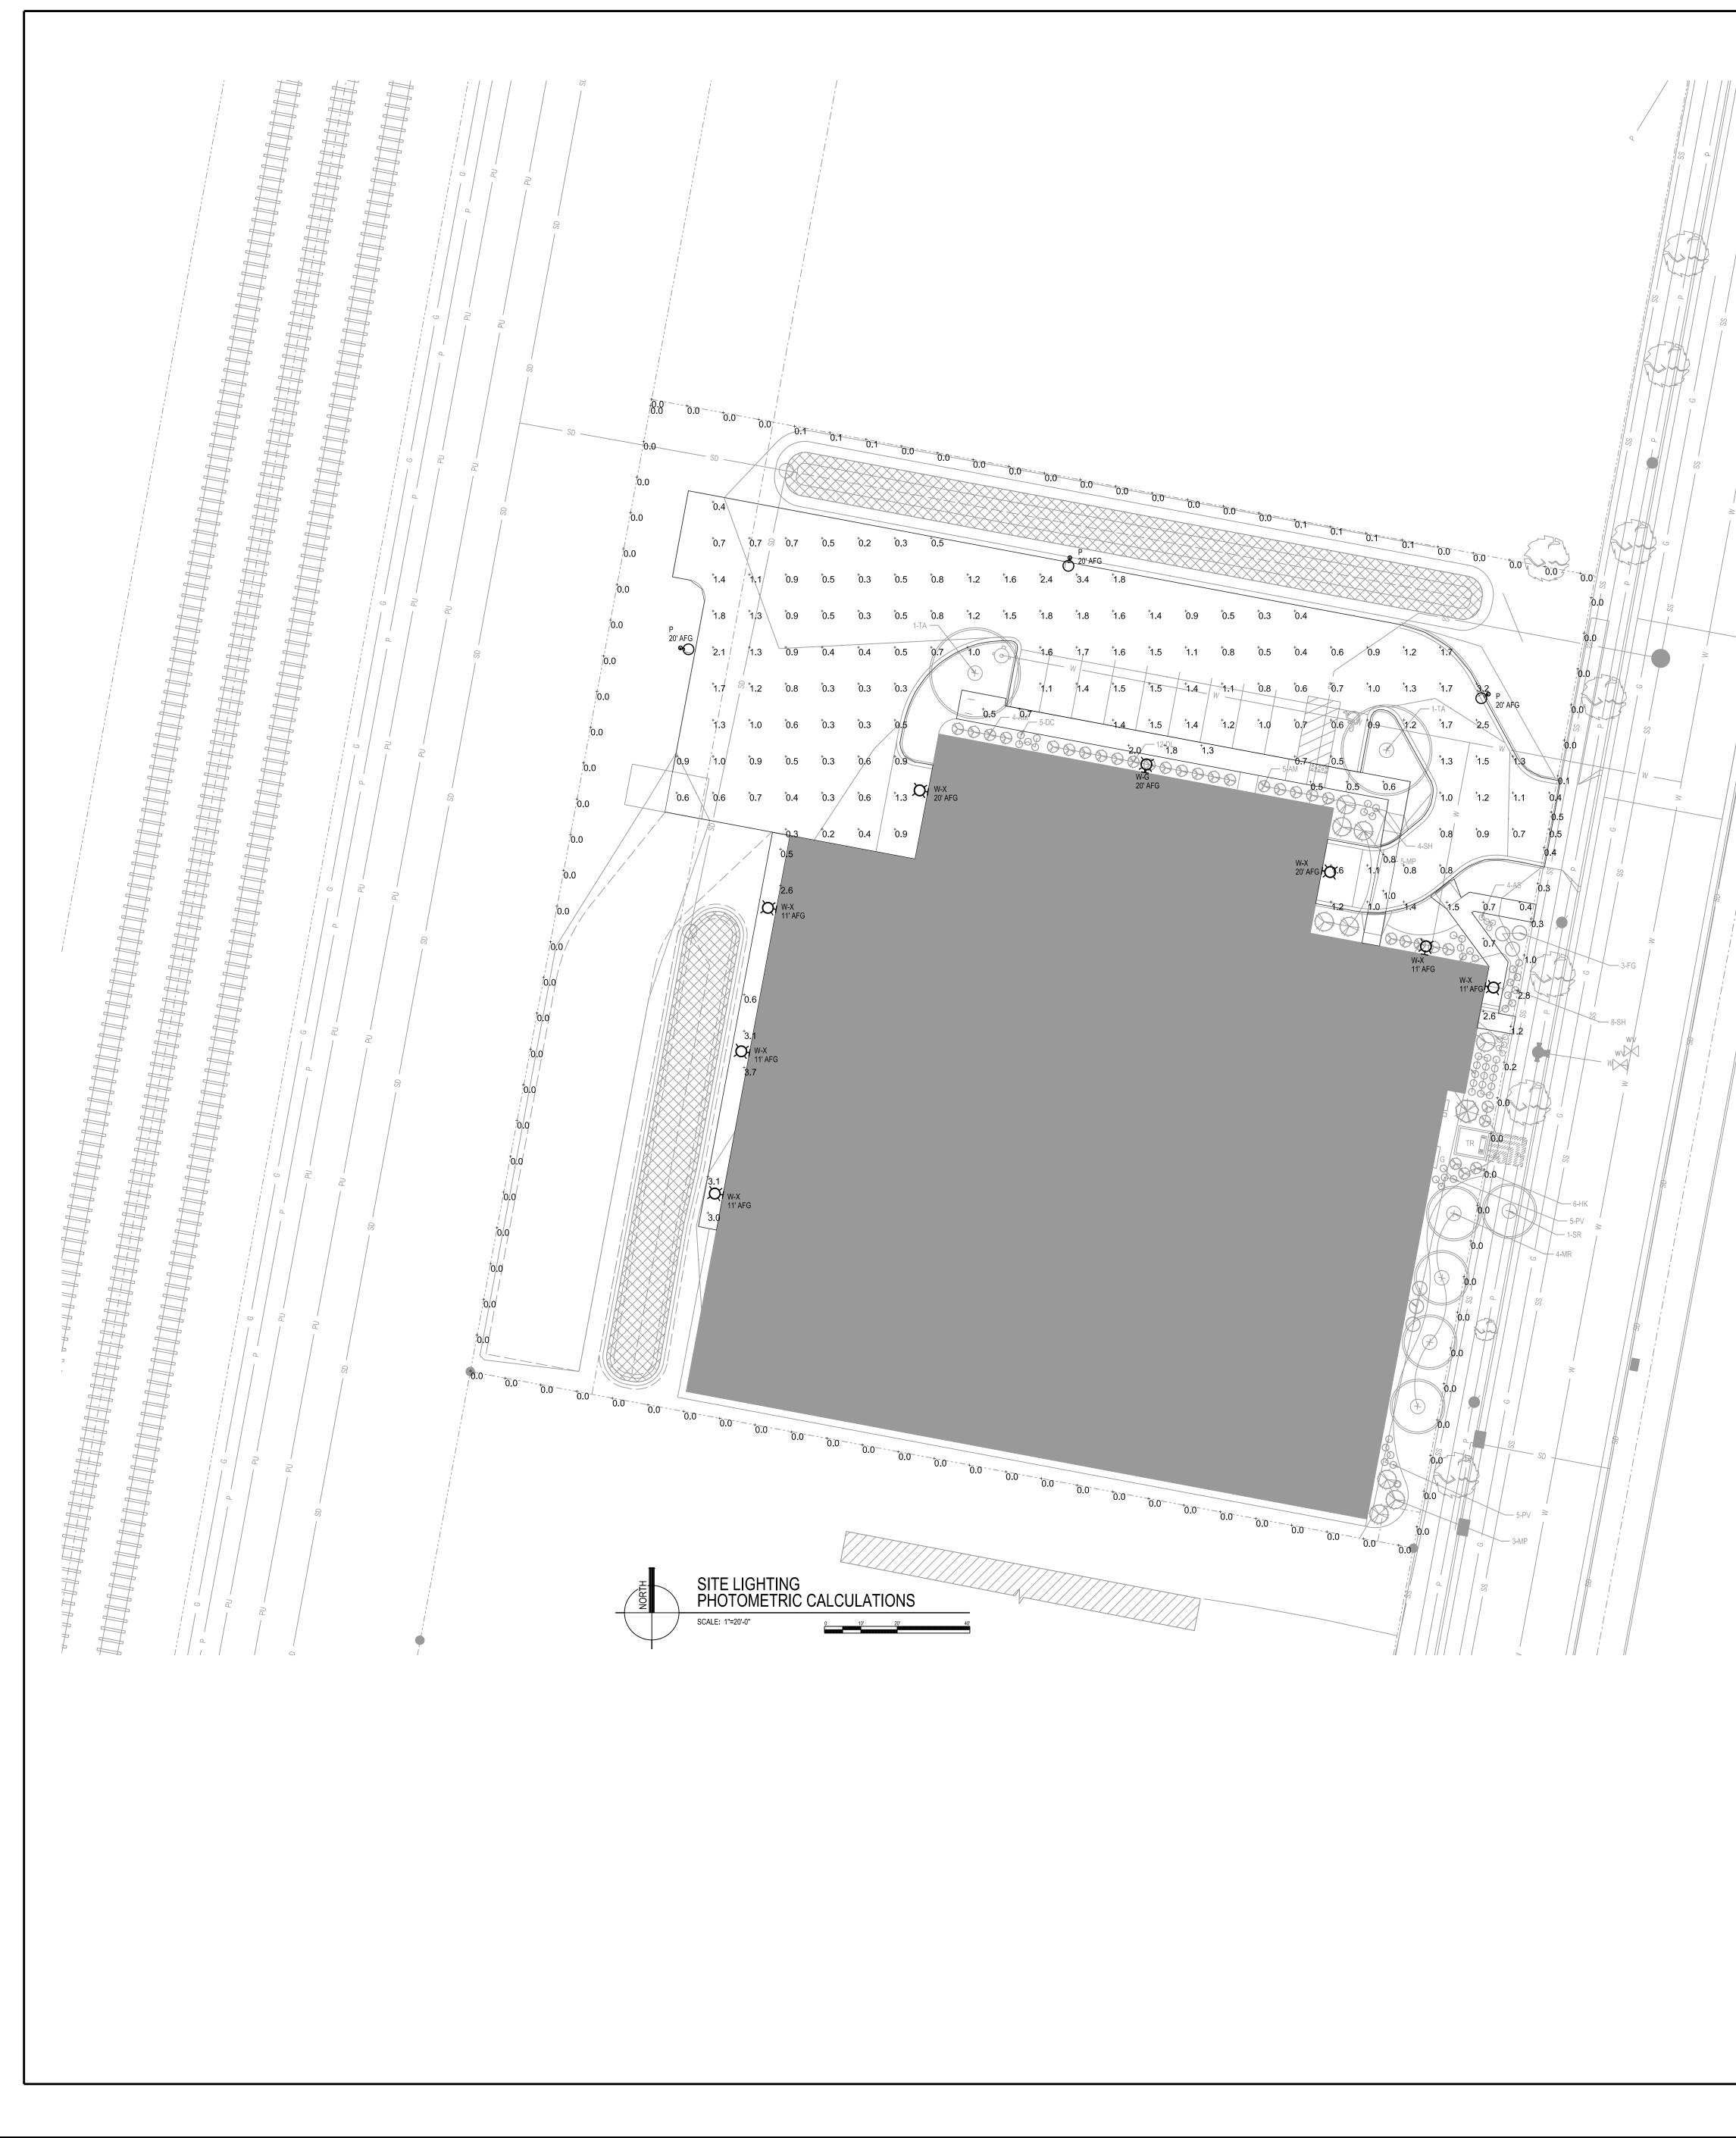

SCALE: 1"=20'-0"

sal X:\76850\cad\7

36"

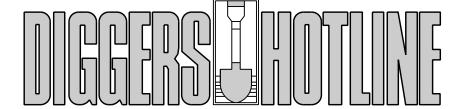


CALL TOLL FREE 1-800-242-8511 MILWAUKEE AREA 414-259-1181 FAX A LOCATE 1-800-338-3860 TDD (HEARING IMPAIRED) 1-800-542-2289 ONLINE: www.DiggersHotline.com WISCONSIN STATUE 182.0175 (1974) REQUIRES A MINIMUM OF THREE (3) WORKING DAYS NOTICE PRIOR TO EXCAVATION.


# SITE LIGHTING NOTES

- 1. PHOTOMETRIC CALCULATIONS SHOWN DO NOT INCLUDE CONTRIBUTIONS OF EXISTING TO REMAIN LIGHT FIXTURES OUTSIDE OF SCOPE OF WORK AND PROPERTY.
- EXTERIOR LIGHT FIXTURES ARE TO BE CONTROLLED VIA HOUSE TIMECLOCK AND PHOTOCELL.
- 3. ALL EXTERIOR LIGHT FIXTURES, POLES, AND ACCESSORIES ARE TO BE DARK BRONZE.
- 4. TYPE P FIXTURES ARE TO BE PROVIDED WITH 15'-0" POLES MOUNTED ON 3'-0" CONCRETE BASE, SEE TYPICAL POLE MOUNT BASE DETAIL.

Symbol	Label	Manufactur er	Catalog Number	Description	Lamp	Number Lamps	Lumens Per Lamp	Wattage
0	Ρ	COOPER LIGHTING SOLUTIONS - - McGRAW- EDISON (FORMERLY EATON)	GLEON-SA1A- -740-U-SL3- HSS	GALLEON AREA AND ROADWAY LUMINAIRE (1) 70 CRI, 4000K, 615mA LIGHTSQUAR E WITH 16 LEDS AND TYPE III SPILL LIGHT ELIMINATOR OPTICS WITH HOUSE SIDE SHIELD		16	261	34
	W-X	COOPER LIGHTING SOLUTIONS - - LUMARK (FORMERLY EATON)	XTOR1B-W	CROSSTOUR 12W WALL MOUNT LED	EATON LED 4000K	1	1396	12.2
	W-G	COOPER LIGHTING SOLUTIONS - - McGRAW- EDISON (FORMERLY EATON)	GWC-SA1A- 740-U-SL3- HSS	GALLEON WALL LUMINAIRE (1) 70 CRI, 4000K, 615mA LIGHTSQUAR E WITH 16 LEDS AND TYPE III SPILL LIGHT ELIMINATOR OPTICS WITH HOUSE SIDE SHIELD		16	266	34


Statistics										
Description	Symbol	Avg	Max	Min	Max/Min	Avg/Min				
EAST SIDEWALK	+	1.2 fc	2.6 fc	0.4 fc	6.5:1	3.0:1				
NORTH SIDEWALK	+	1.0 fc	2.0 fc	0.5 fc	4.0:1	2.0:1				
PARKING & DRIVEWAY	+	1.0 fc	3.4 fc	0.2 fc	17.0:1	5.0:1				
PROPERTY LINE	+	0.1 fc	2.8 fc	0.0 fc	N/A	N/A				
WEST SIDEWALK	+	2.4 fc	3.7 fc	0.5 fc	7.4:1	4.8:1				

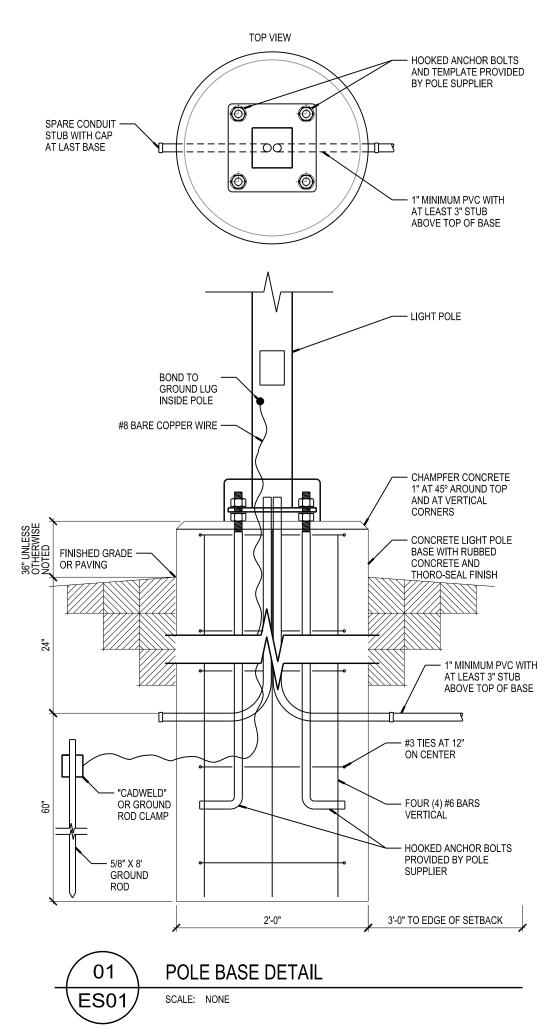


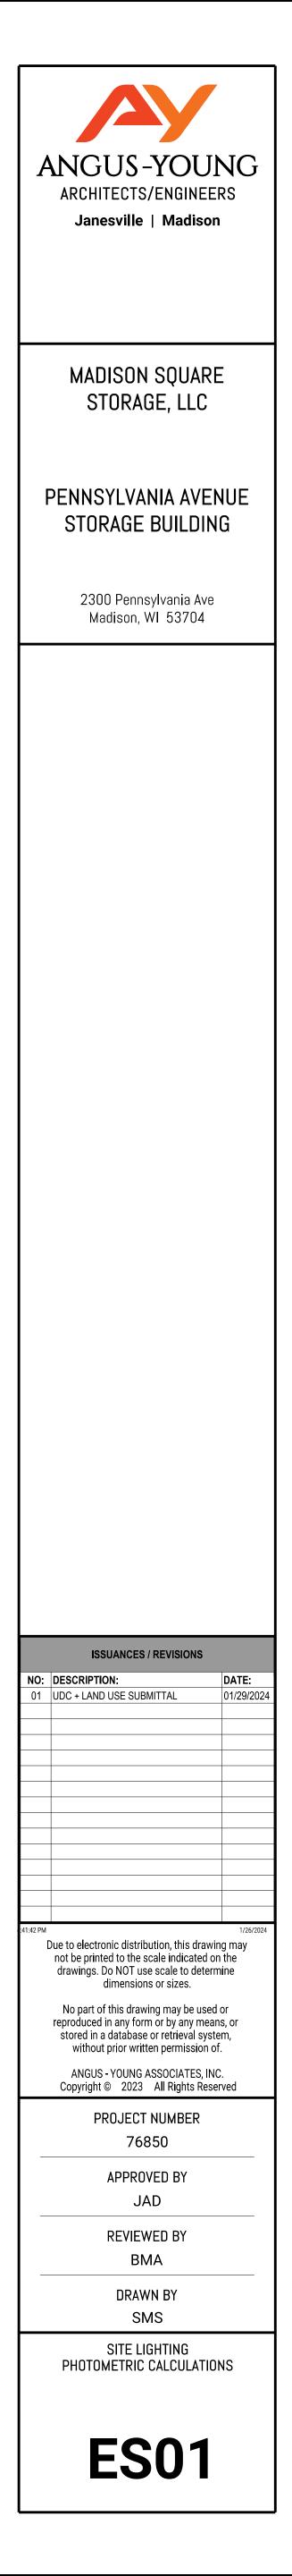






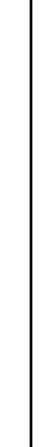

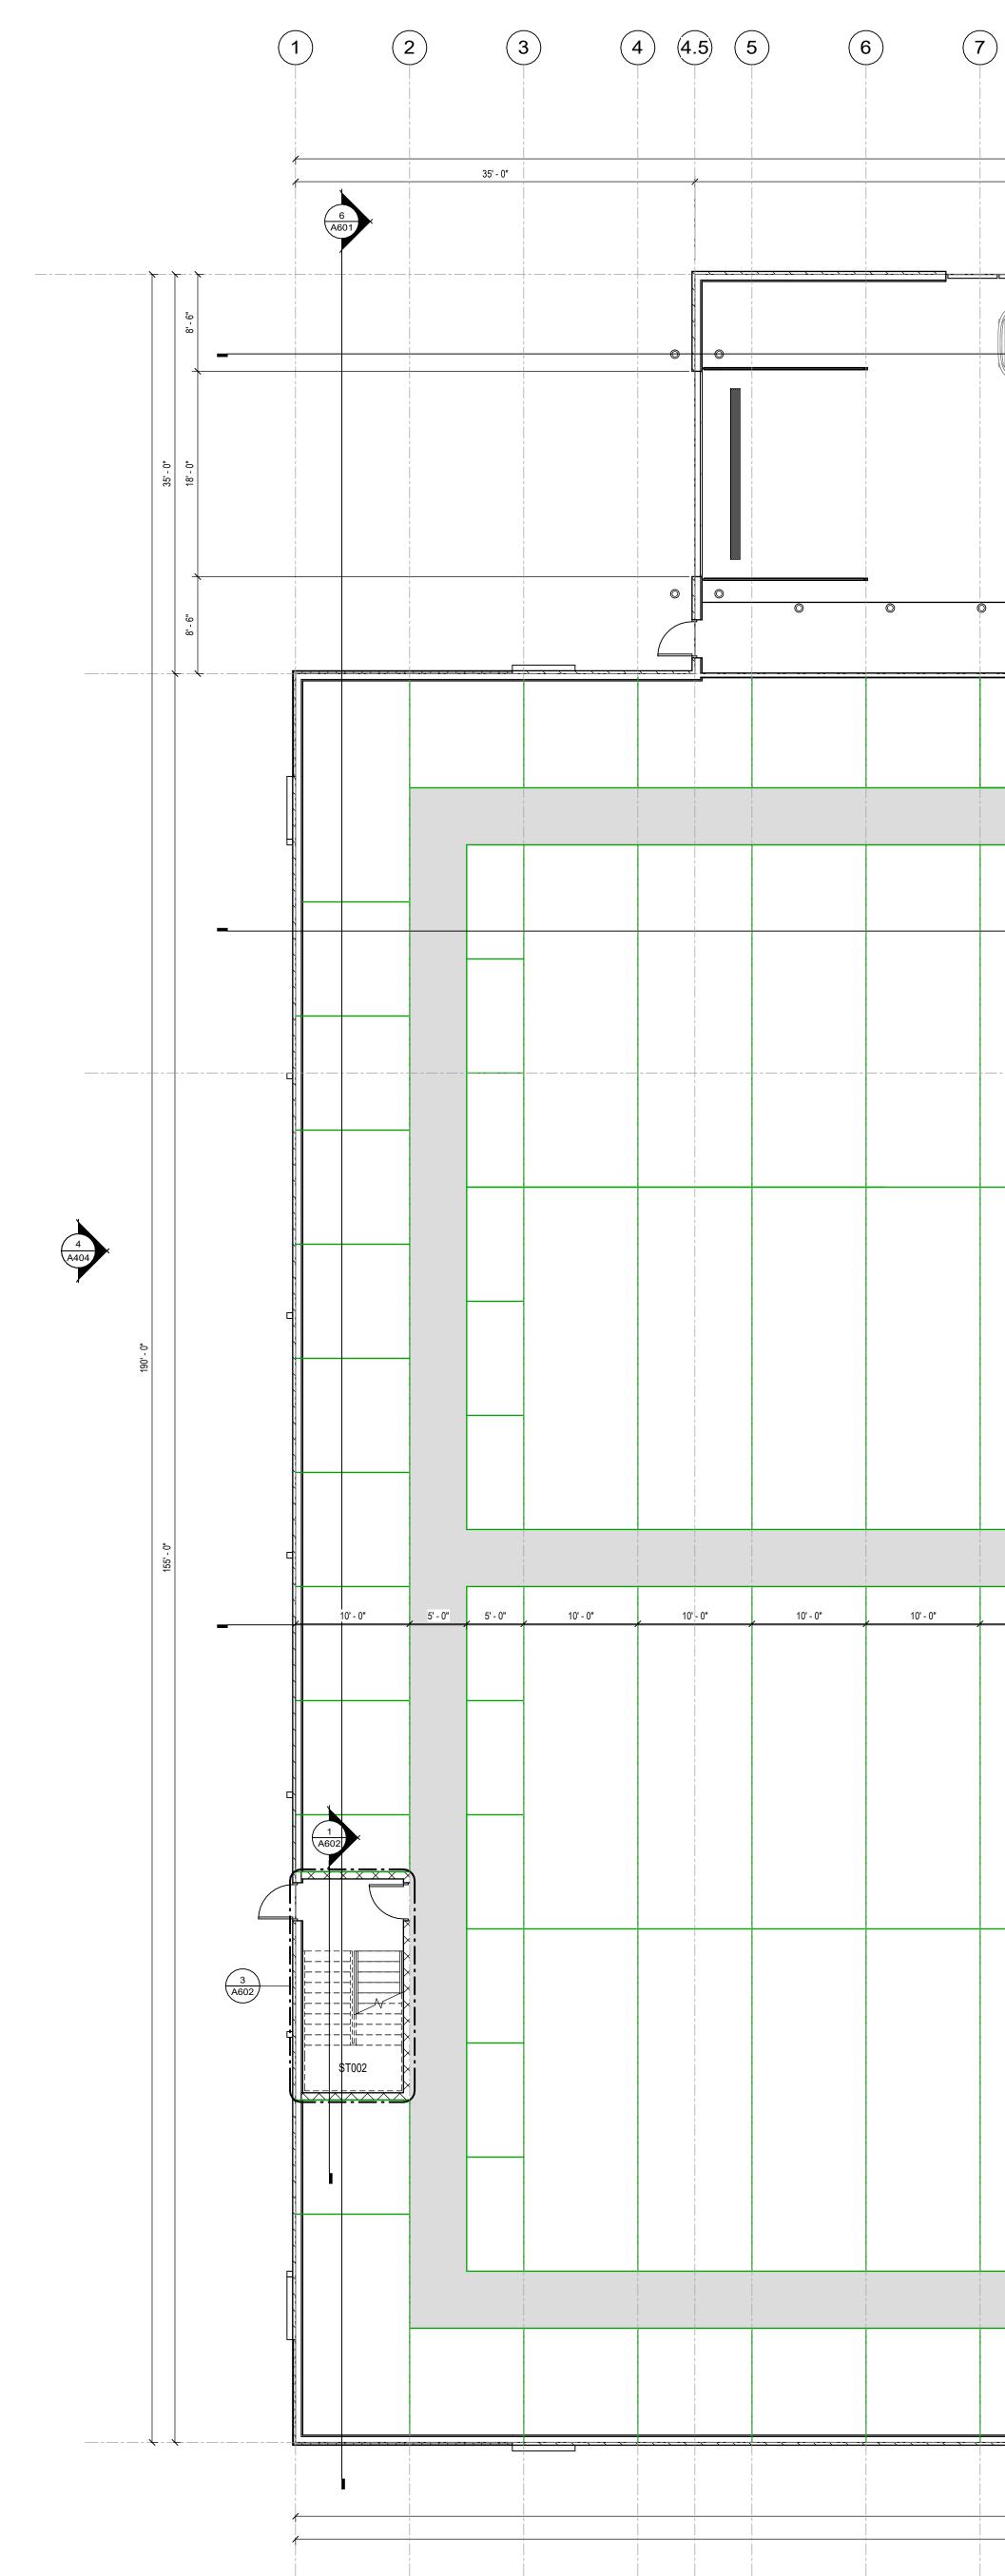


7	(8	3)	g			11 1 1 195' - 0"	) (	12)	13	14	(15)	15.5	(16)	(17
			4 A601		110 - 0"		- <u></u>				<u>22' - 0"</u>			
				.0. 35'- 0"		0	<u></u>	0	0					
					<b>*</b>	CART STORAGE			5' - 0" 10' - 0"					ST001
				ELEVATO		EVATOR ×			30, - 0.					
									20' - 0"					
. 10'	'- 0"	5' - 0"	5' - 0"	10' - 0"		10' - 0"	10' - 0"	10' - 0"	20'- 0"	10' - 0"	10' - 0"	10'- 0"		10' - 0"
									20' - 0"					
									15 <sup>-</sup> - 0"					
									10'-0" 5'-0" 10'-0"					
	<u></u>			· · · · · · · · · · · · · · · · · · ·		195' - 0" 195' - 0" 3 A404								

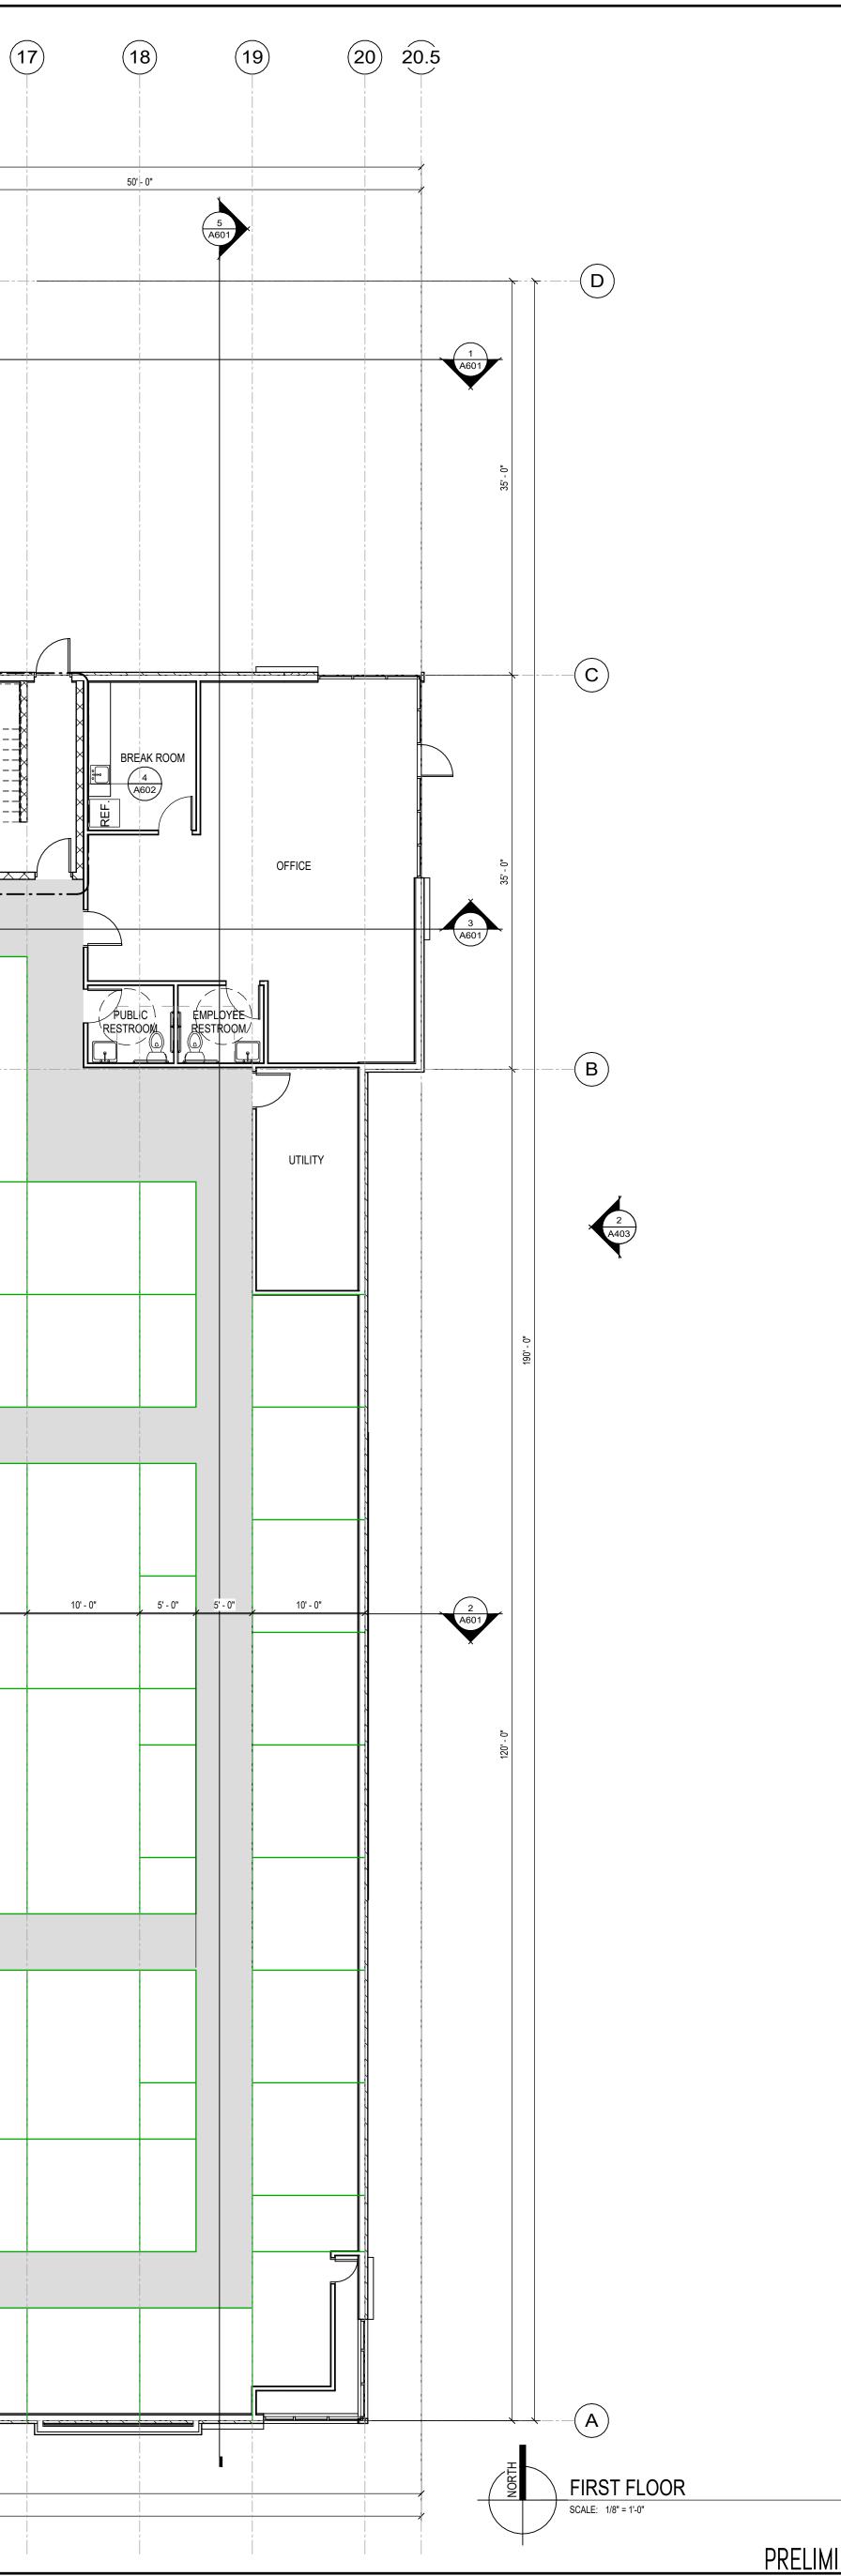


ANGUS-YOU	NG							
ARCHITECTS/ENGINEE	RS							
Janesville   Madison								
MADISON SQUARE STORAGE, LLC								
OTORACE, ELC								
PENNSYLVANIA AVENUE								
STORAGE BUILDING								
2230 Pennsylvania Ave								
Madison, WI 53704								
ISSUANCES / REVISIONS								
ISSUANCES / REVISIONS	DATE:							
	DATE:							
	DATE:							
	DATE:							
	DATE: 							
	DATE: 							
	DATE: 							
NO:       DESCRIPTION:	ving may on the							
NO:       DESCRIPTION:	ving may on the rmine							
NO:       DESCRIPTION:	ving may on the rmine ed or s, or stored out prior							
NO:       DESCRIPTION:	ving may on the rmine ed or s, or stored out prior							
NO:       DESCRIPTION:	ving may on the rmine ed or s, or stored out prior							
NO:       DESCRIPTION:	ving may on the rmine ed or s, or stored out prior							
NO:       DESCRIPTION:	ving may on the rmine ed or s, or stored out prior							
NO:       DESCRIPTION:         Image: Construction of the second in the seco	ving may on the rmine ed or s, or stored out prior							
NO:       DESCRIPTION:	ving may on the rmine ed or s, or stored out prior							
NO:       DESCRIPTION:         Image: Construction of the second of the seco	ving may on the rmine ed or s, or stored out prior							
NO:       DESCRIPTION:         Image: Construction of the second of the seco	ving may on the rmine ed or s, or stored out prior							



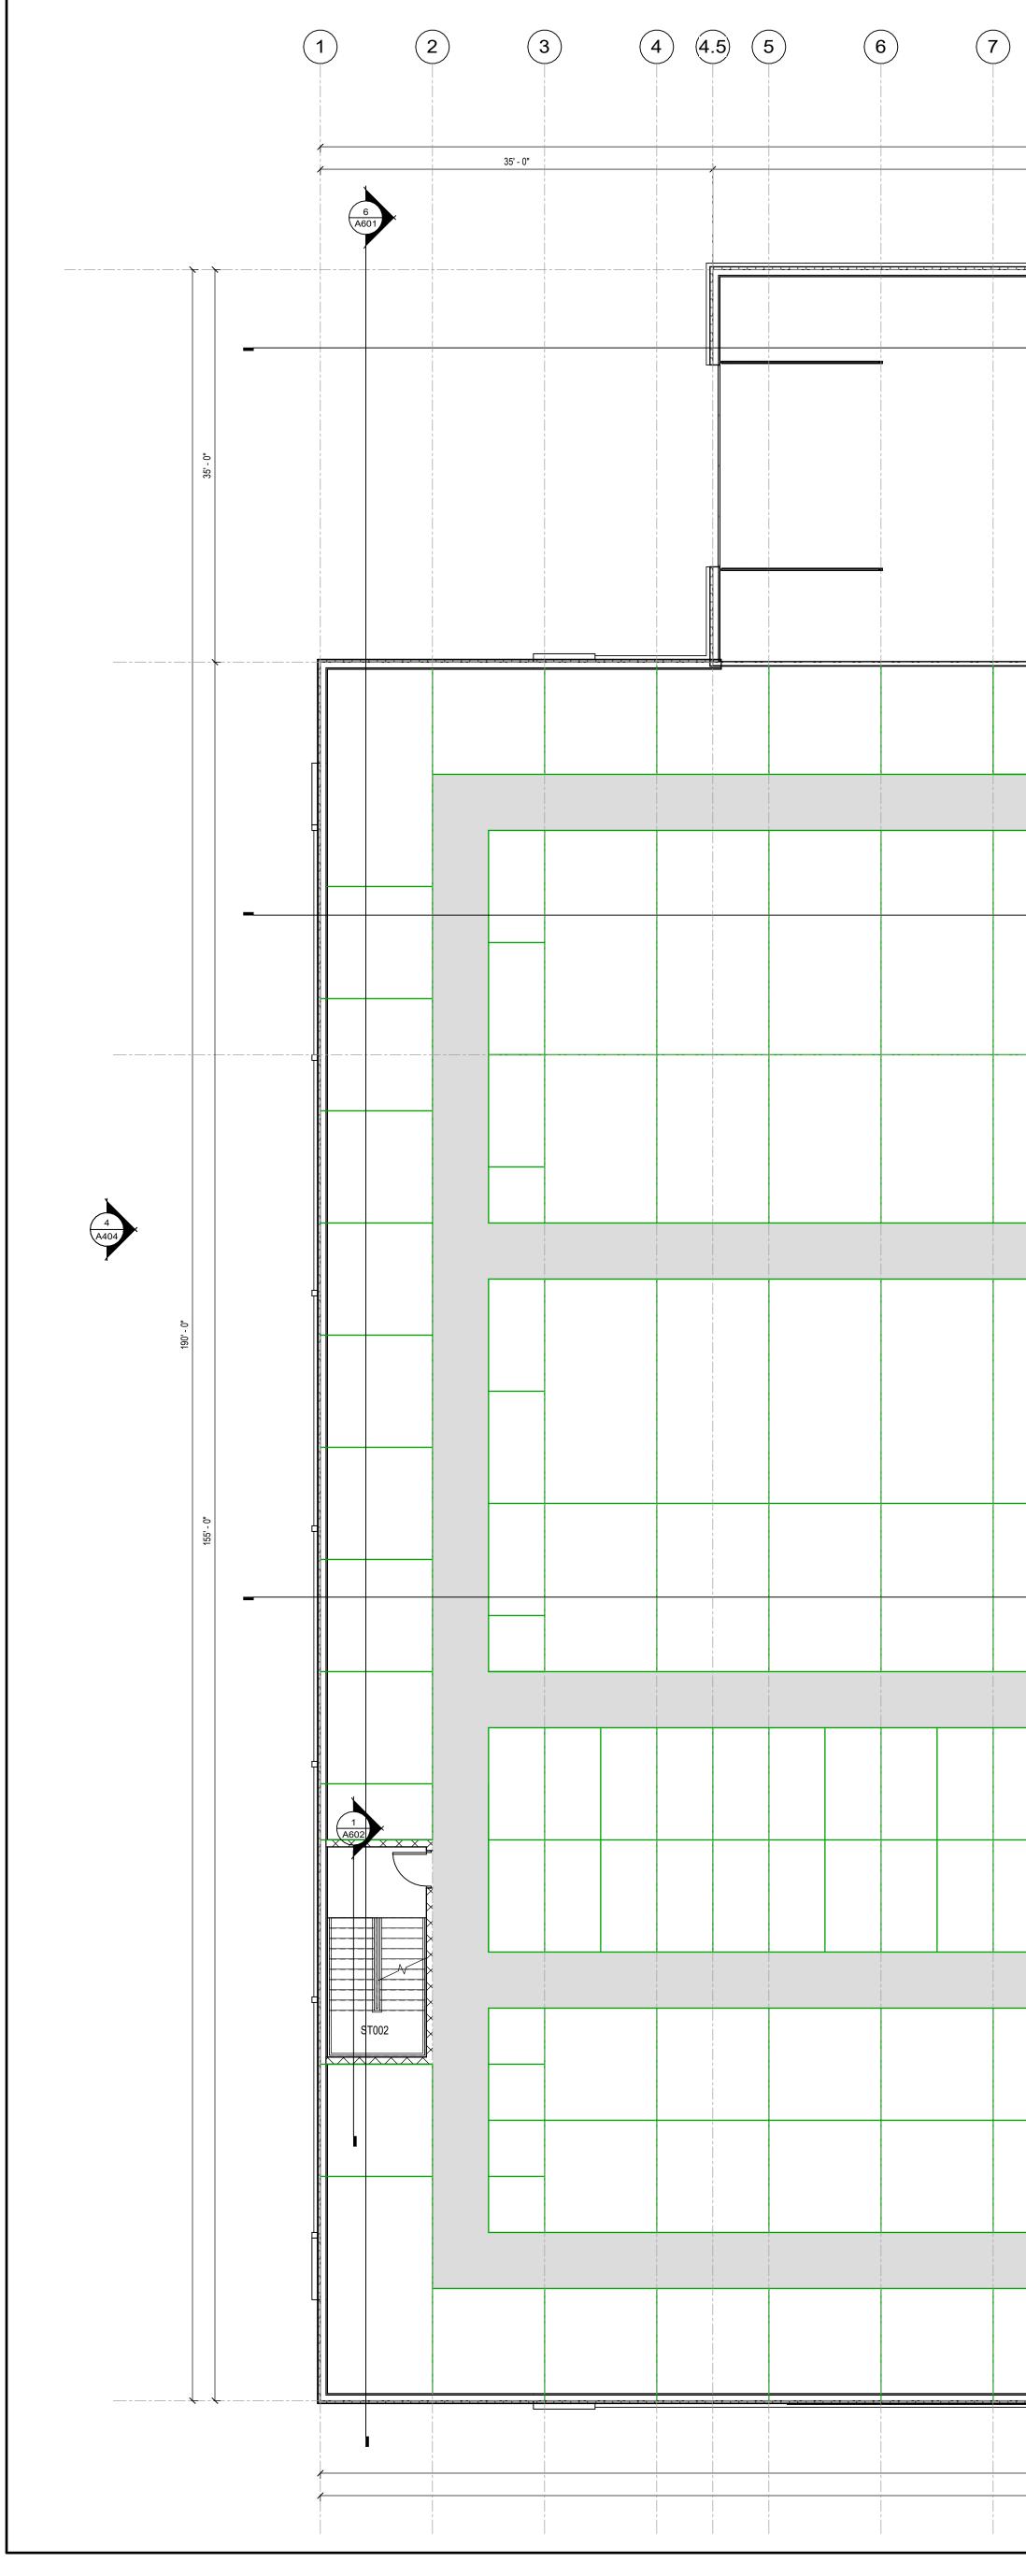


7	8		9 (10		1) (1	2) (1	3 (1	4) (15	) 15.5 (1	6) (17
		4 A601	110	195' - 0" . 0"						
										ST001
		_								
		_								
				<u> </u>	· ·					
		_								
				<del>, , , , , , , , , , , , , , , , , , , </del>		<u></u>		<u></u>		
		•		195' - 0" 195' - 0"						

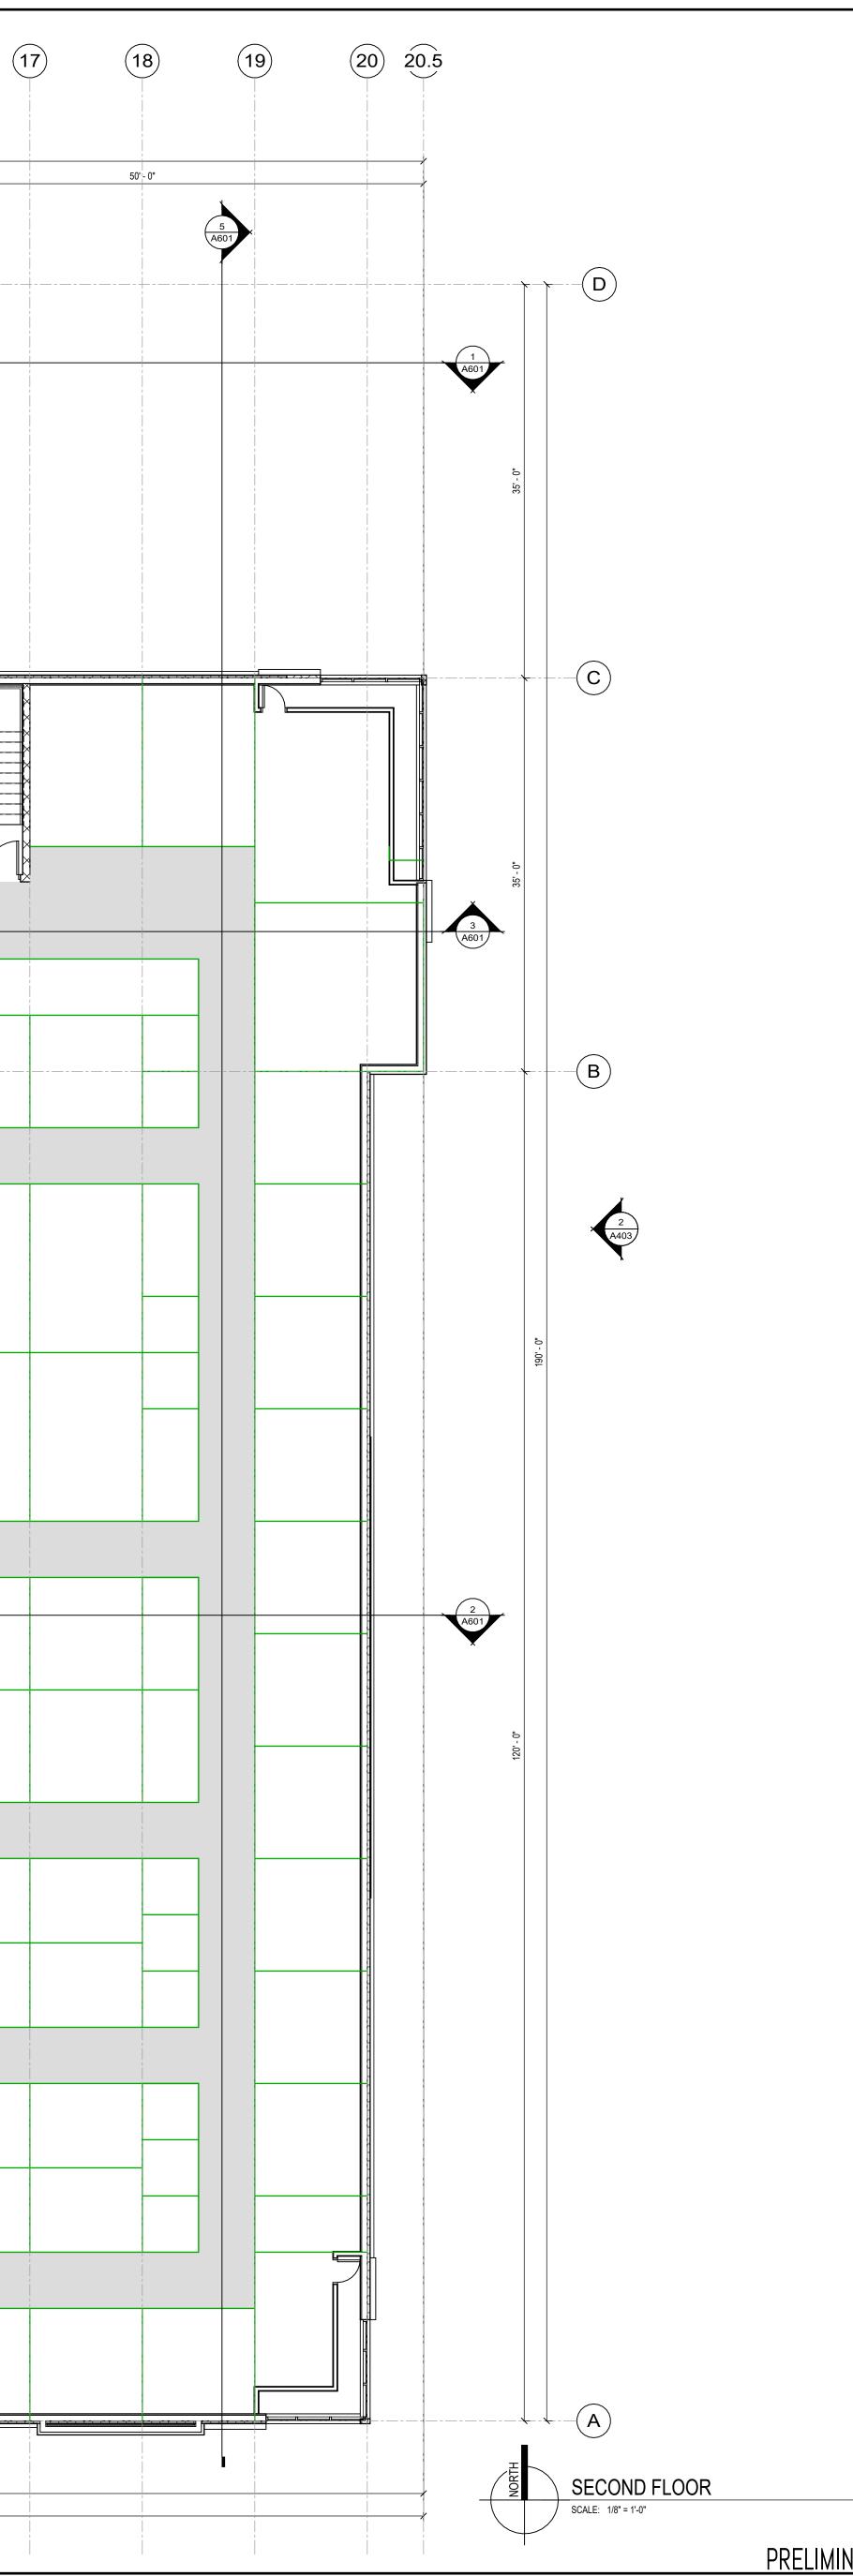


	ANGUS-YOUNG ARCHITECTS/ENGINEERS									
Janesville   Madison										
	MADISON SQUARE STORAGE, LLC									
PENNSYLVANIA AVENUE STORAGE BUILDING										
	2230 Pennsylvania Ave Madison, WI 53704									
NO:	ISSUANCES / REVISIONS	DATE:								
NO:		DATE:								
NO:										
NO:										
NO:										
NO:										
1/29/20 Du		ing may on the								
1/29/20 Du	DESCRIPTION:	ing may on the rmine d or or stored								
1/29/20 Du	DESCRIPTION:	ing may on the rmine d or or stored out prior								
1/29/20 Du	DESCRIPTION:	ing may on the rmine d or or stored out prior								
1/29/20 Du	DESCRIPTION:	ing may on the rmine d or or stored out prior								
1/29/20 Du	DESCRIPTION:	ing may on the rmine d or or stored out prior								
1/29/20 Du	DESCRIPTION:	ing may on the rmine d or or stored out prior								
1/29/20 Du	DESCRIPTION:	ing may on the rmine d or or stored out prior								
1/29/20 Du	DESCRIPTION:	ing may on the rmine d or or stored out prior								




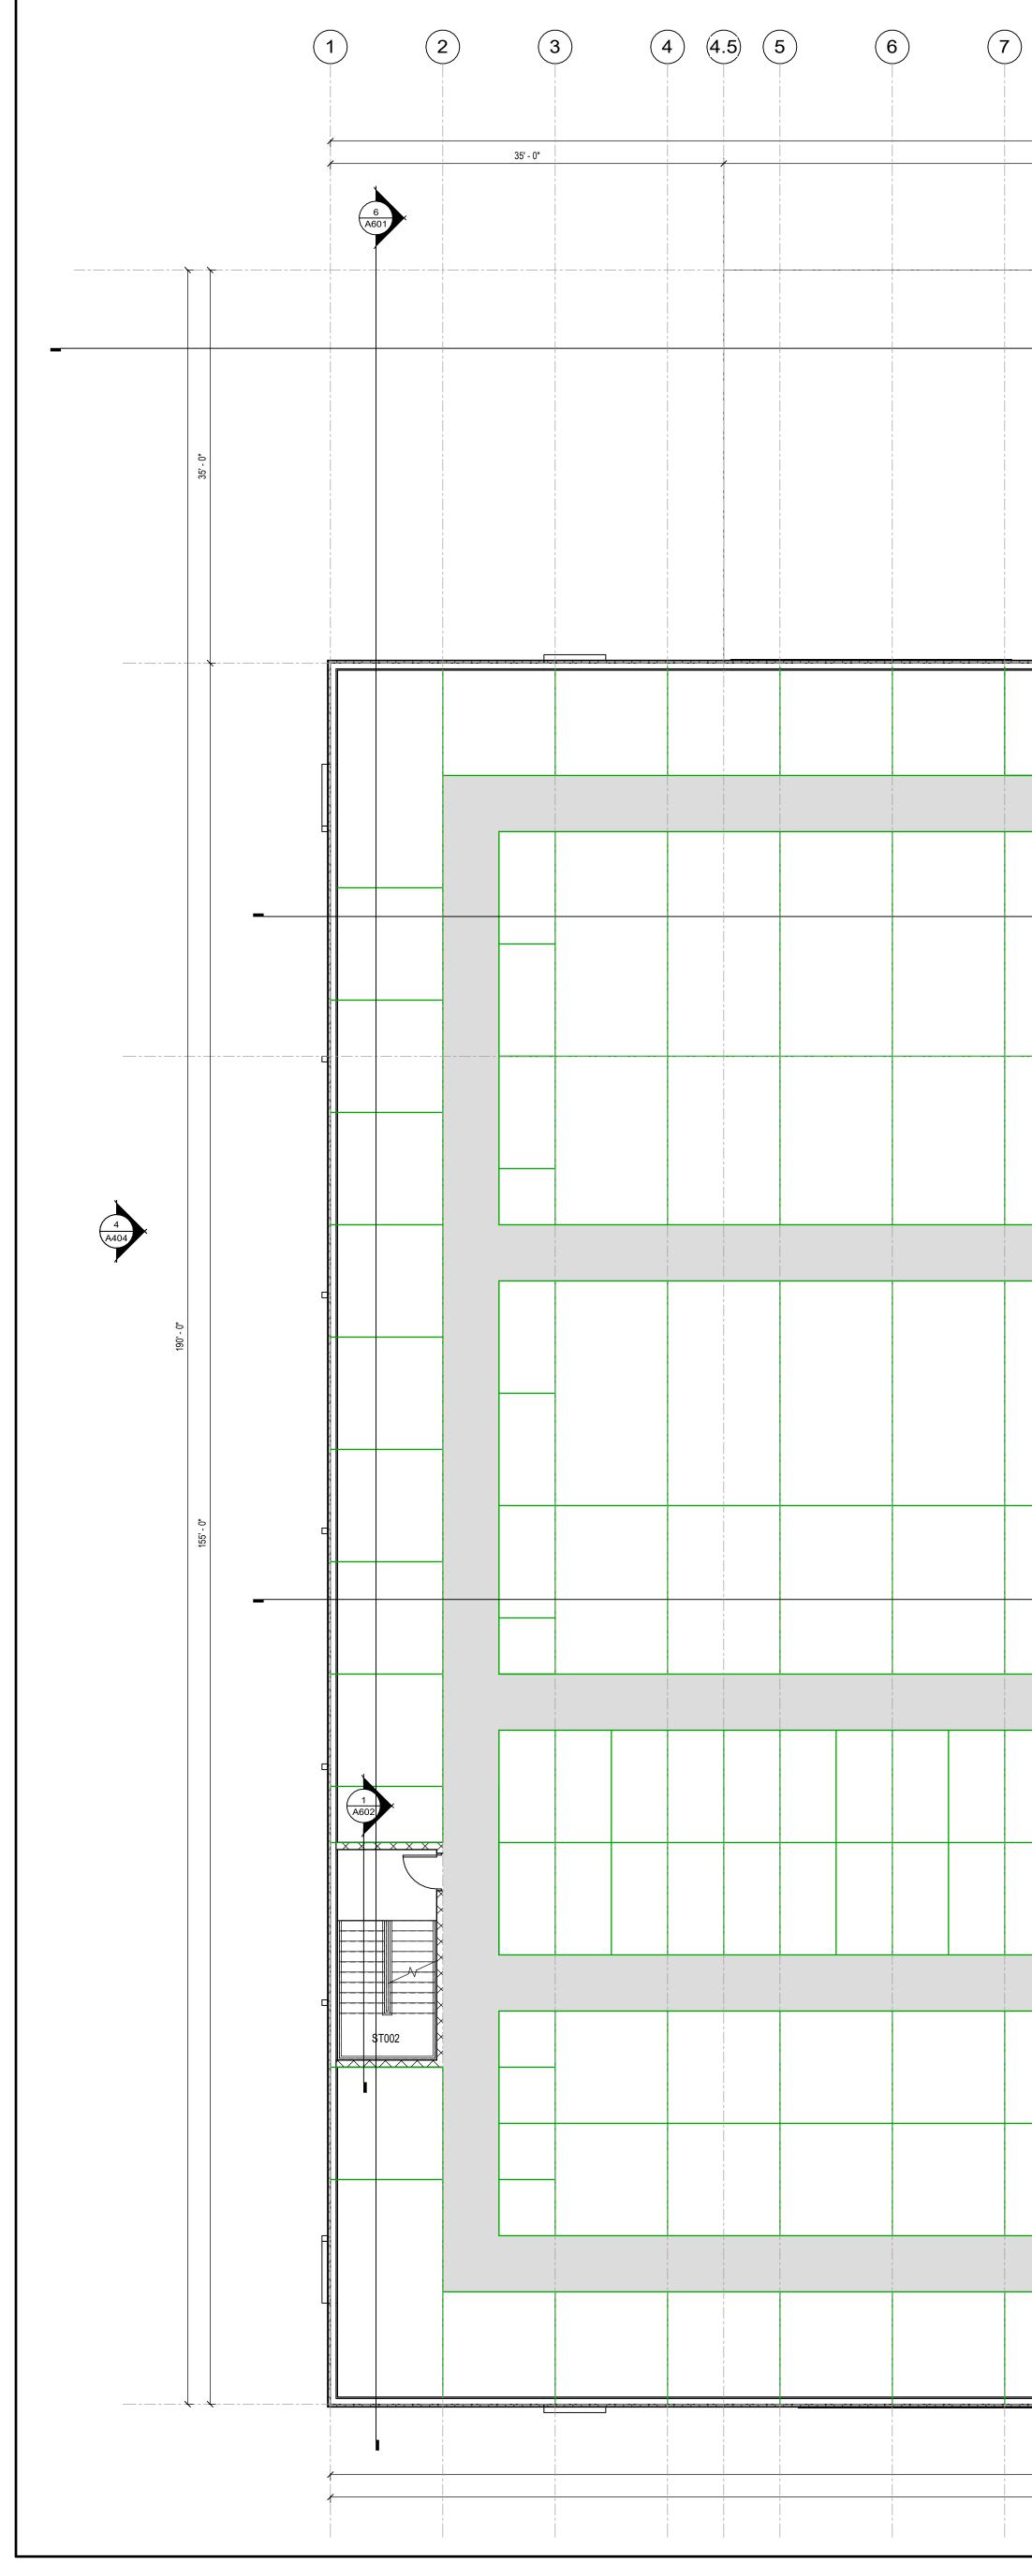


7	8	9			(12)	(13)	(14)	15 15.5	
		4 A601	110 - 0"	195' - 0"					
				<u></u>	<u></u>	<u> </u>	<u> </u>		ST001
							·		
				195' - 0"					
				195' - 0"					

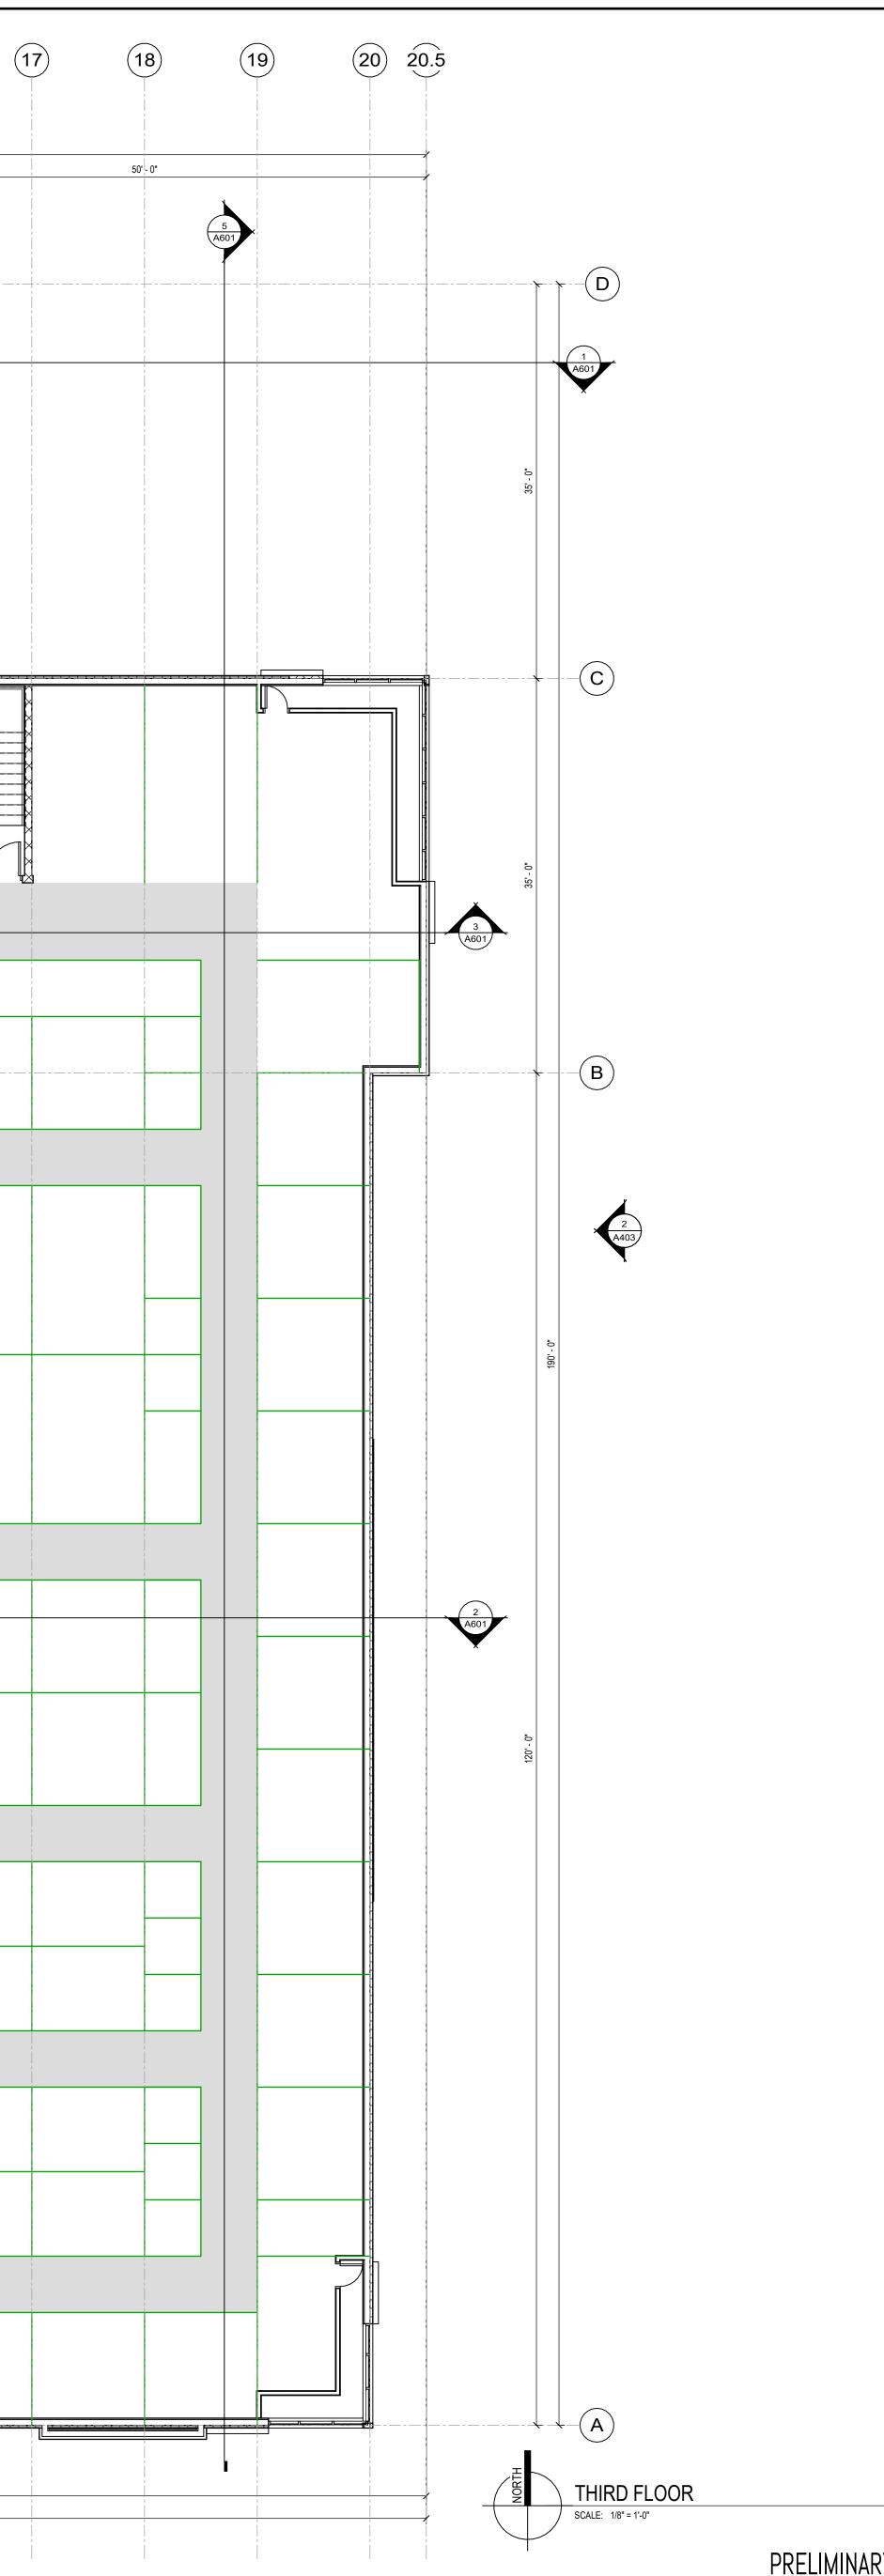

	A									
A	ANGUS-YOUNG ARCHITECTS/ENGINEERS									
Janesville   Madison										
	MADISON SQUARE STORAGE, LLC									
F	PENNSYLVANIA AVENUE STORAGE BUILDING									
2230 Pennsylvania Ave										
	Madison, WI 53704									
NO:	ISSUANCES / REVISIONS DESCRIPTION:	DATE:								
NO:		DATE:								
NO:										
NO:										
NO:										
NO:										
		/ing may on the								
	DESCRIPTION:	ving may on the rmine								
	DESCRIPTION:	/ing may on the rmine ed or , or stored out prior								
	DESCRIPTION:	/ing may on the rmine ed or , or stored out prior								
	DESCRIPTION:	/ing may on the rmine ed or , or stored out prior								
	DESCRIPTION:	/ing may on the rmine ed or , or stored out prior								
	DESCRIPTION:	/ing may on the rmine ed or , or stored out prior								
	DESCRIPTION:	/ing may on the rmine ed or , or stored out prior								
	DESCRIPTION:	/ing may on the rmine ed or , or stored out prior								

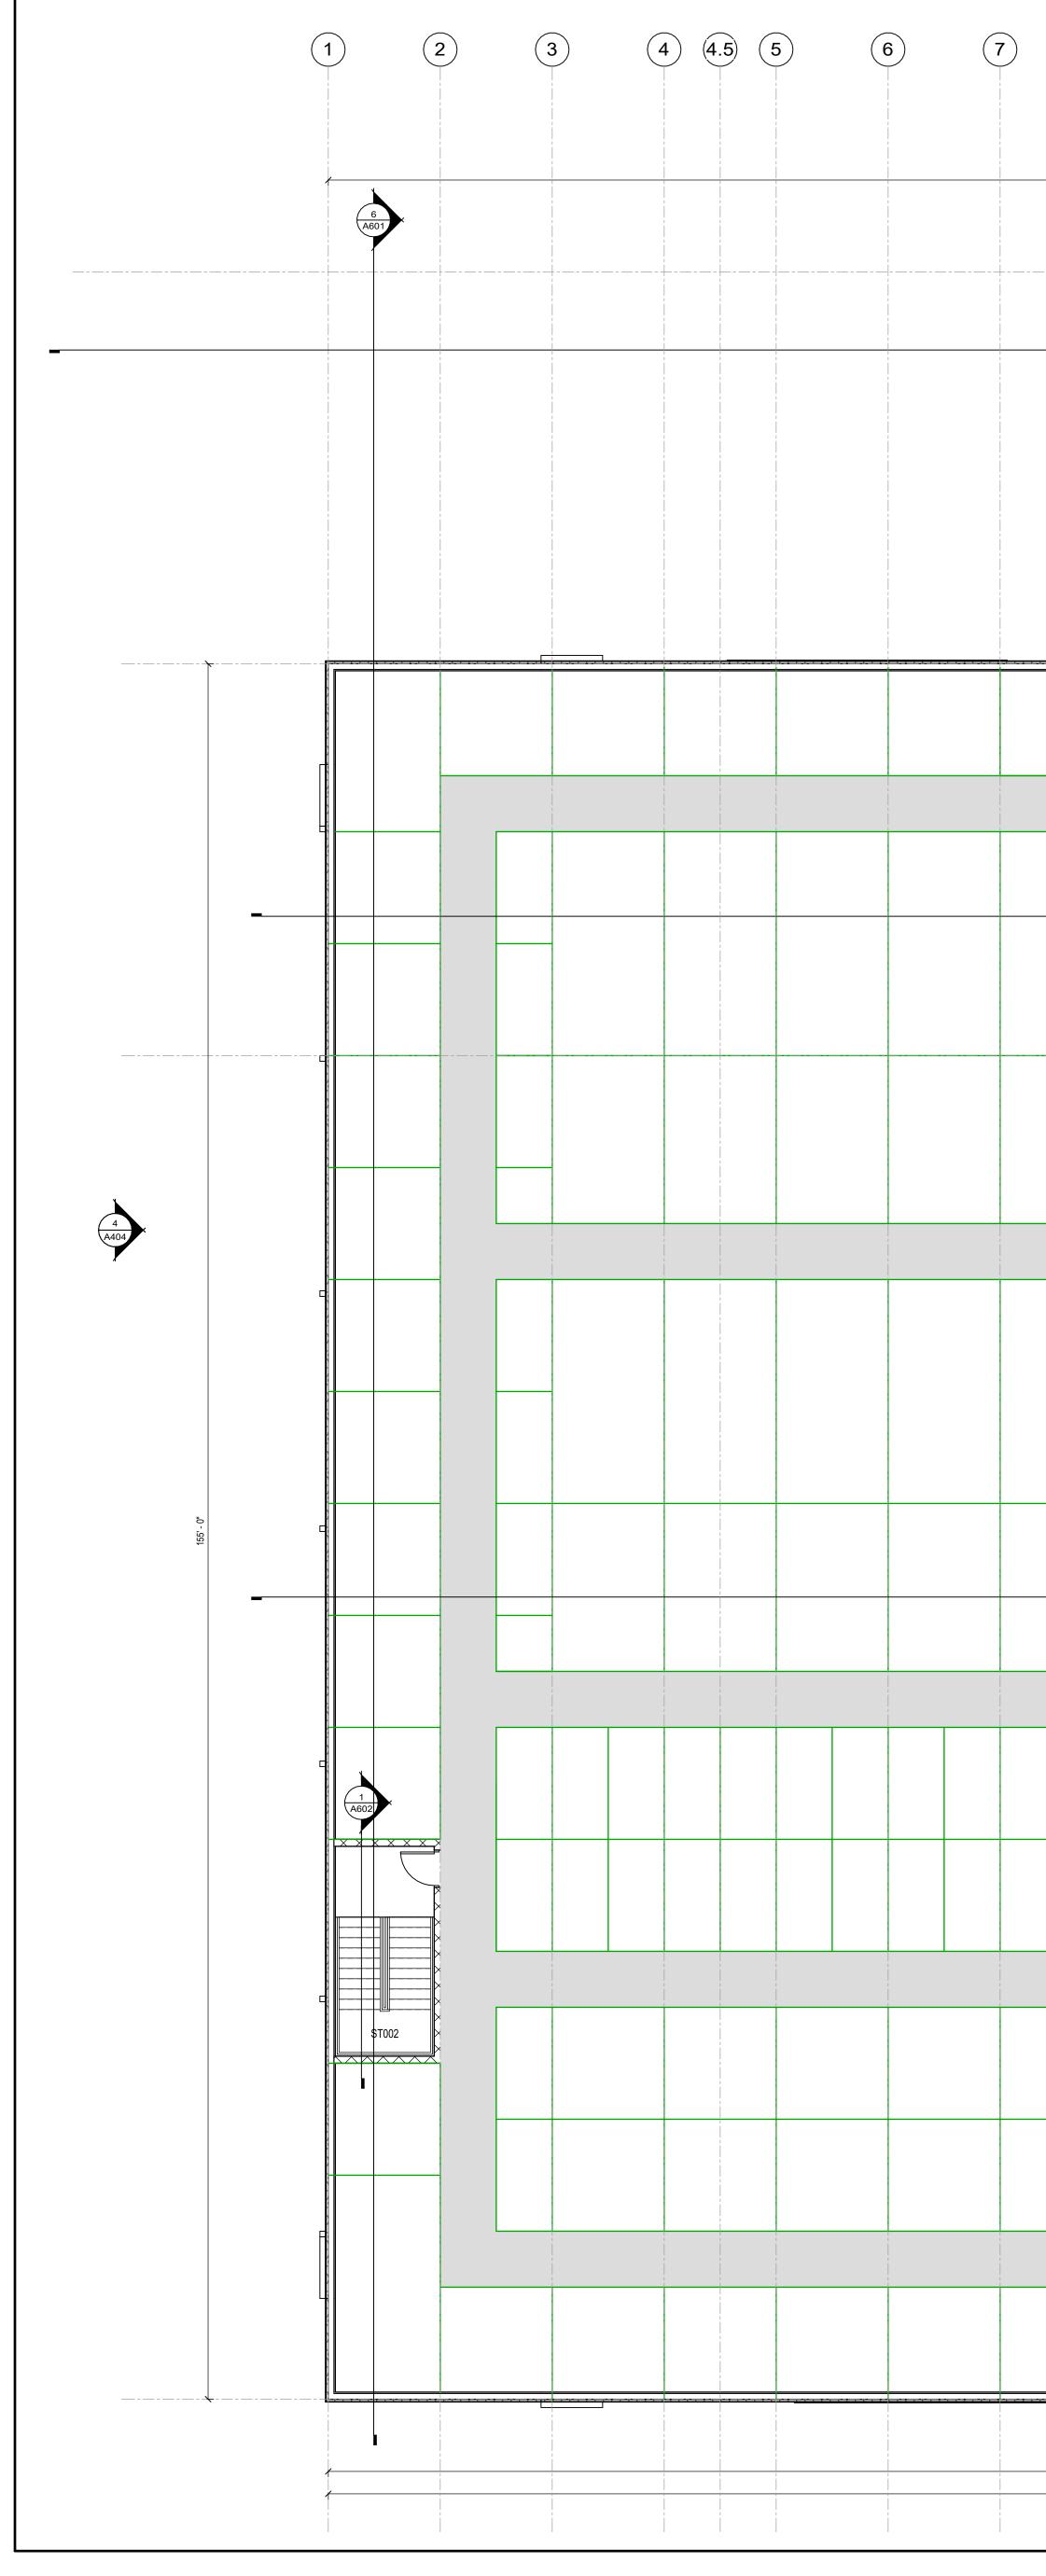


7	8	9		(12)	13)	14)	15 15.5	
		4 A601	195' - 0"					
			 		<u></u>			
								ST001
			× × × ×					
			195' - 0" 195' - 0" 3 404					

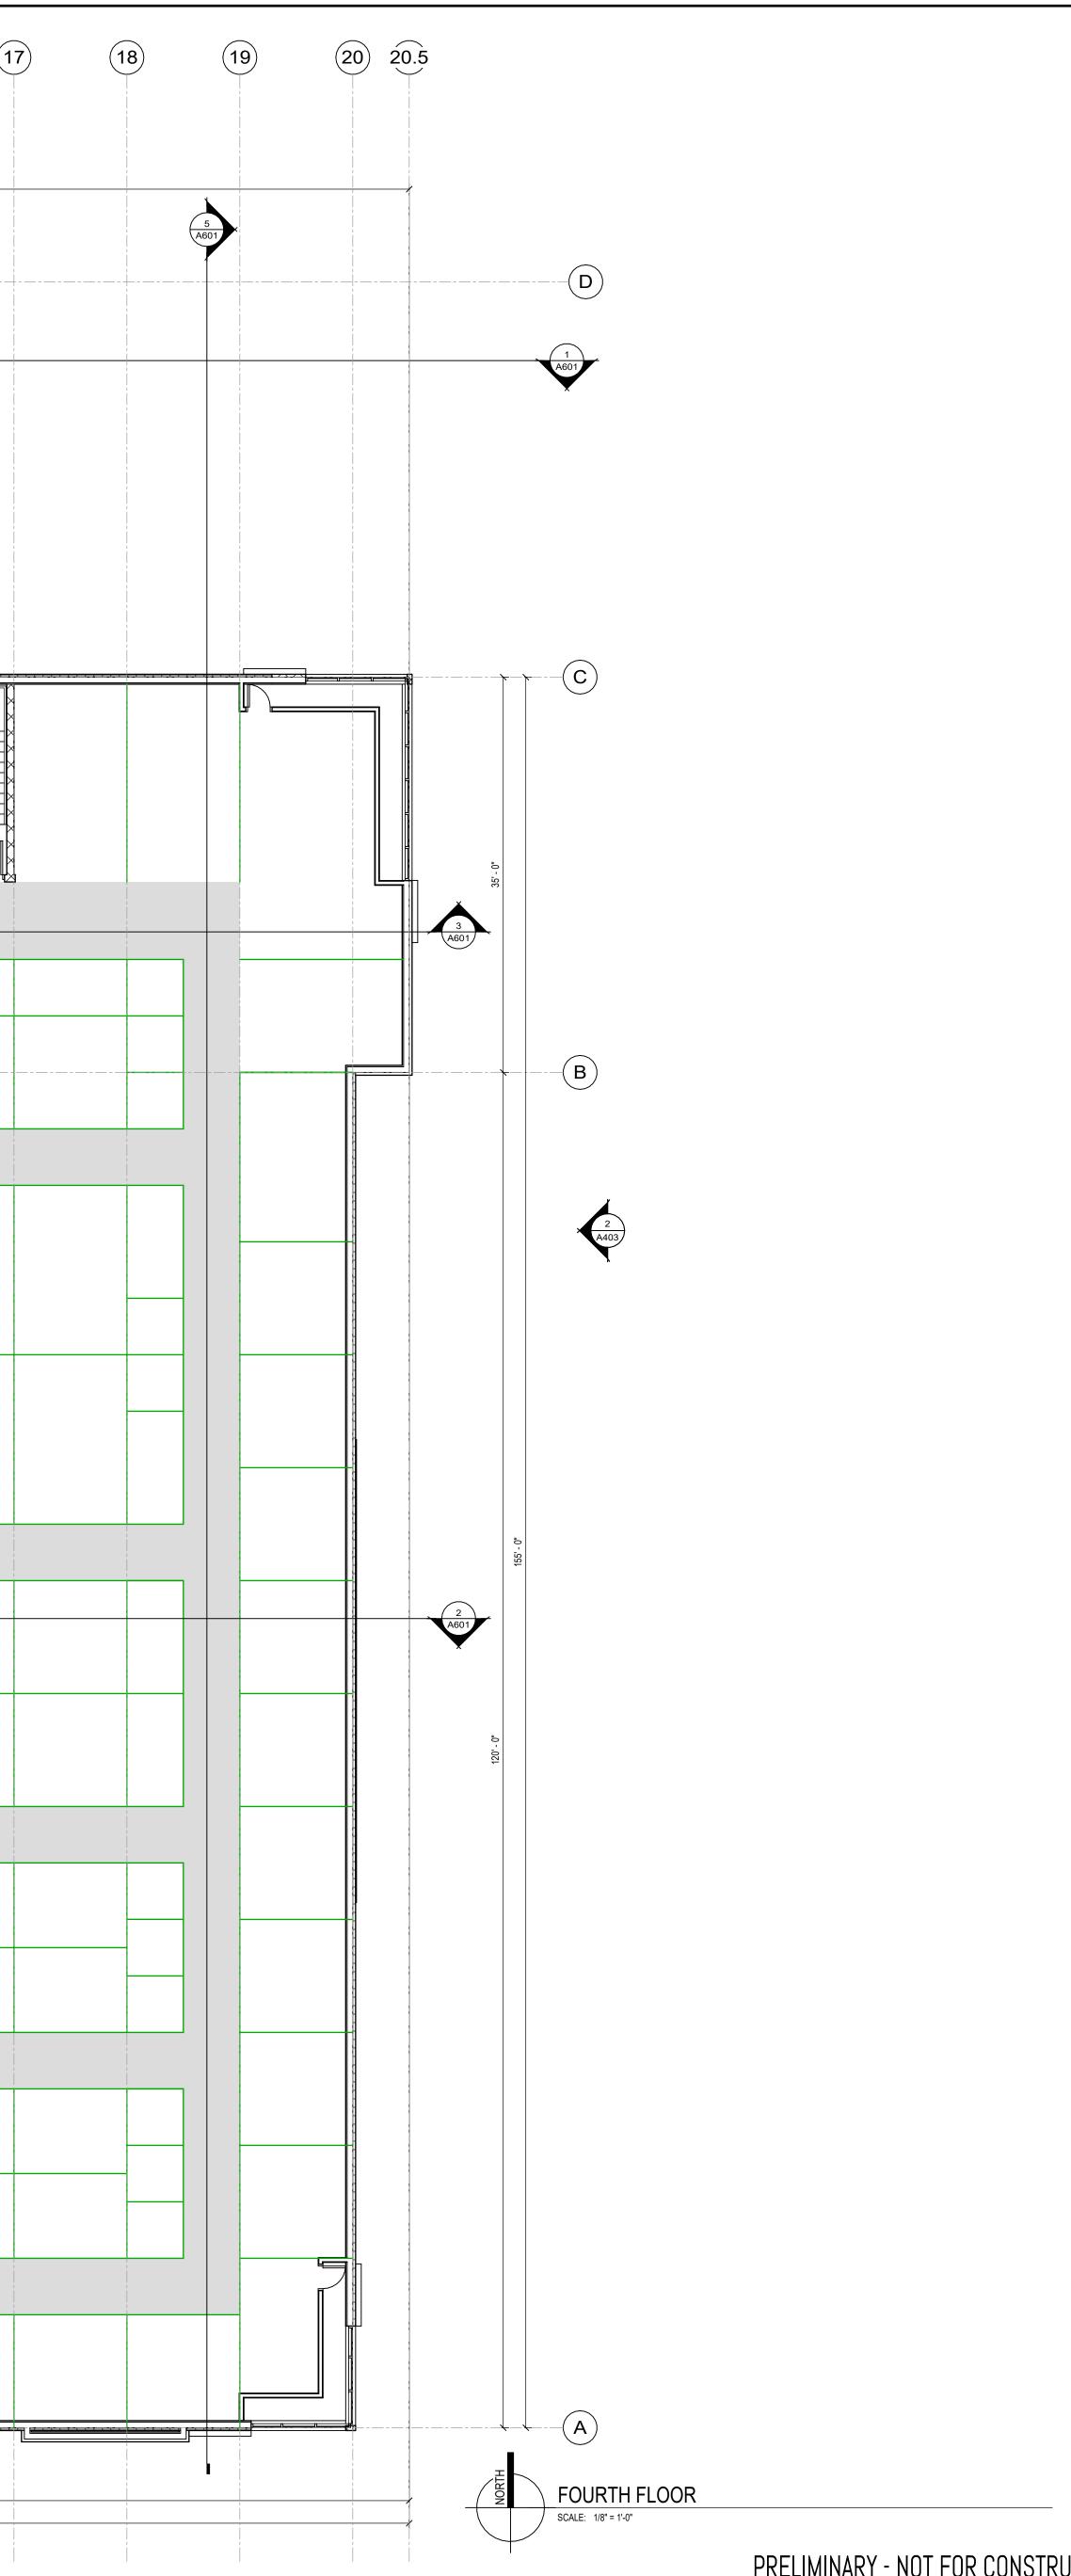


ANGUS-YC	DUNG							
ARCHITECTS/ENG								
Janesville   Madison								
MADISON SQUARE STORAGE, LLC								
PENNSYLVANIA AVENUE								
STORAGE BUILDING								
2230 Pennsylvan Madison, WI 53								
ISSUANCES / REVISIO								
NO: DESCRIPTION:	DATE:							
1/20/0024 13-41-55 14								
Due to electronic distribution, t not be printed to the scale in drawings. Do NOT use scale dimensions or siz	dicated on the to determine							
No part of this drawing ma reproduced in any form or by an in a database or retrieval syste written permission	y means, or stored em, without prior							
written permission ANGUS - YOUNG ASSOC Copyright © 2023 All Righ	ATES, INC.							
PROJECT NUME 76850	BER							
APPROVED B	Y							
Approver 	Y							
Checker								
DRAWN BY Author								
FOURTH FLOOR I	PLAN							
A10	4							




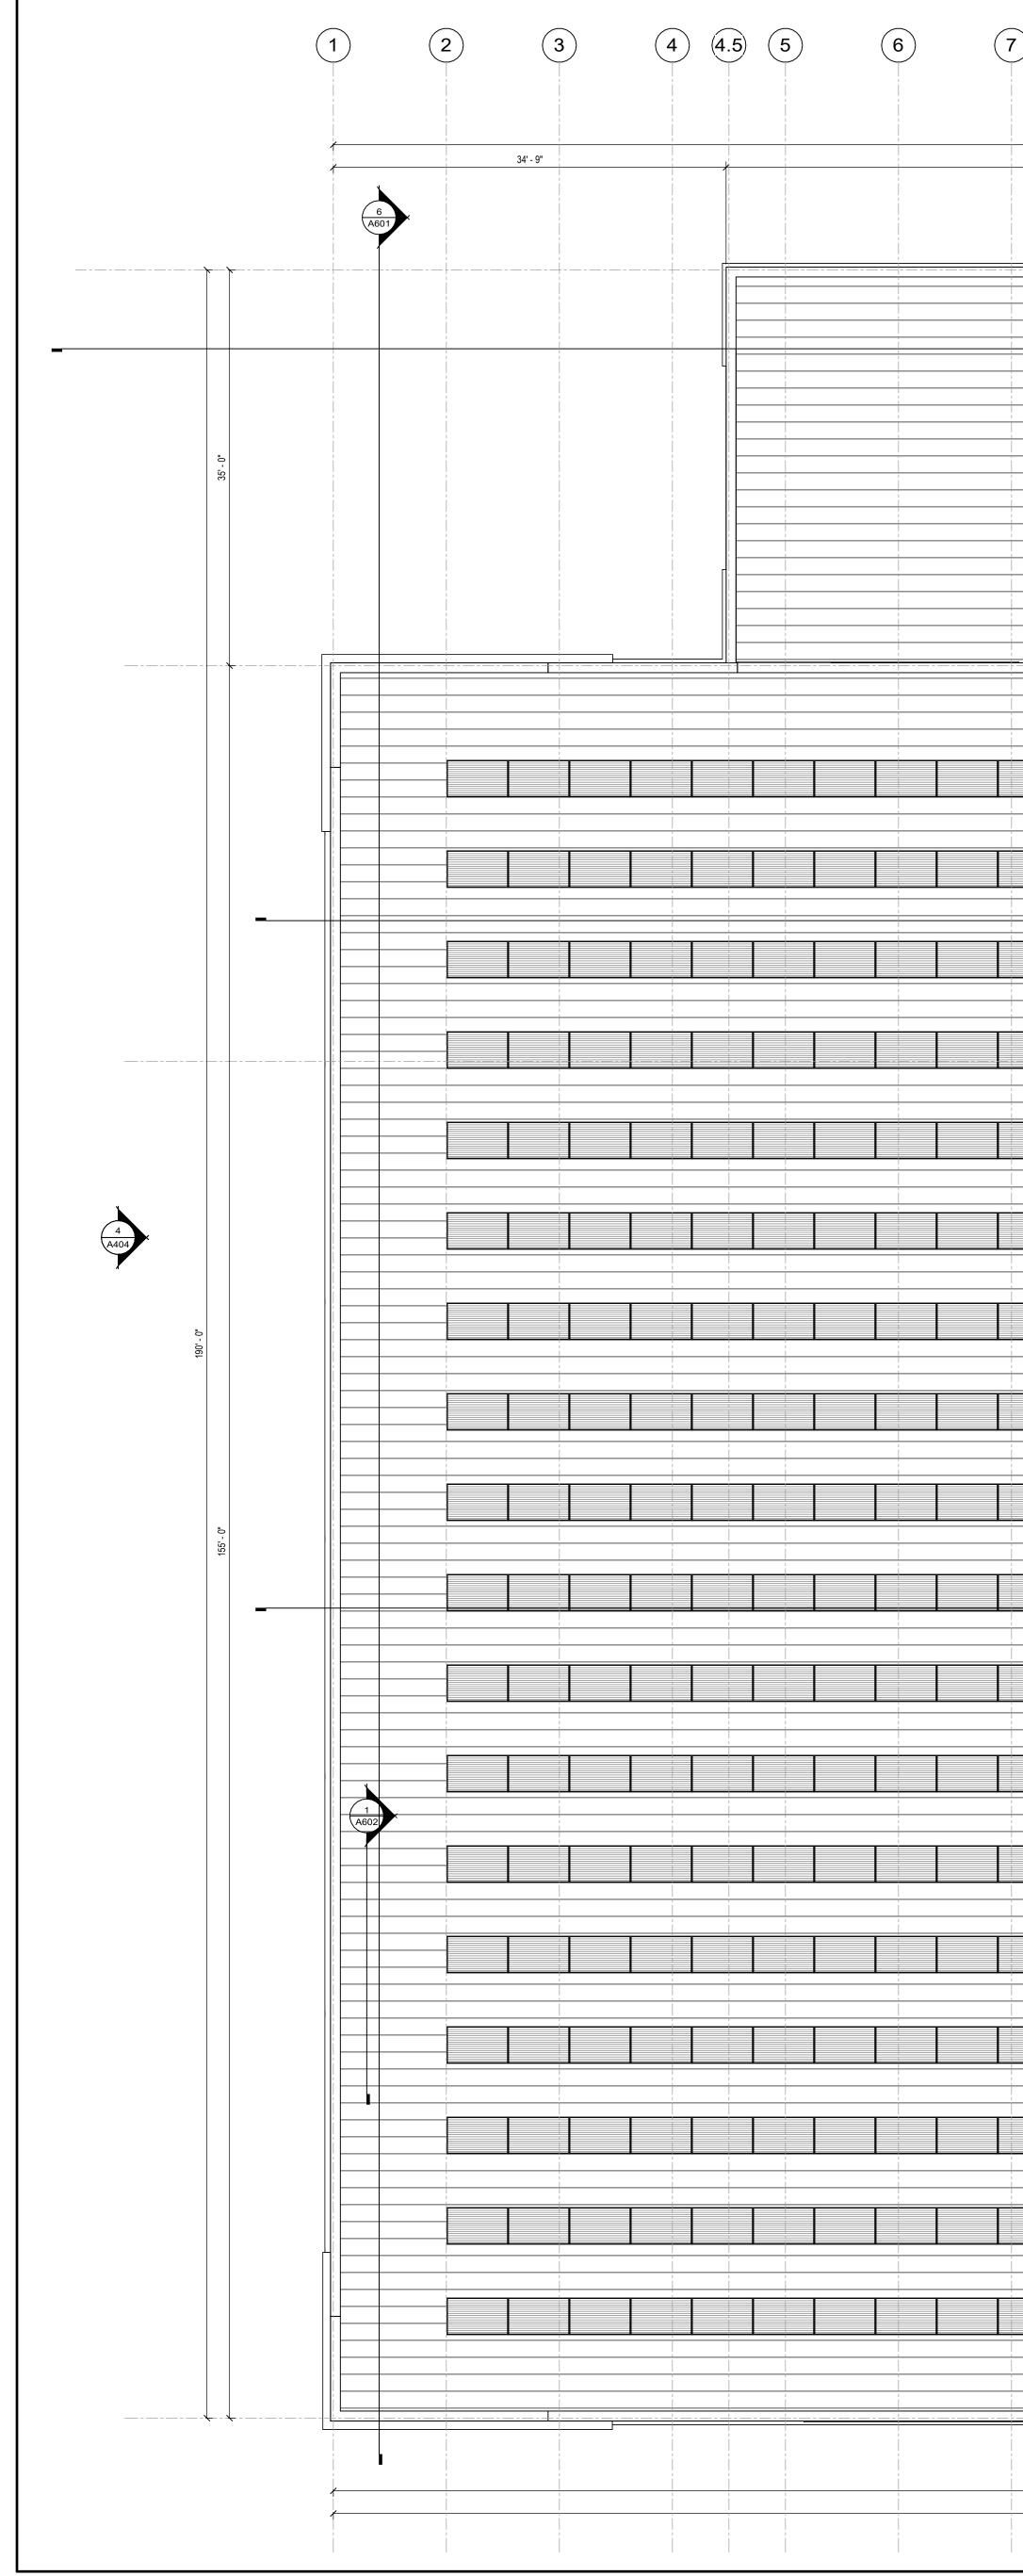



7	8	9		11 1403 195' - 0"	(12)	(13)	(14)	15 15.5 (1	6 (17
		4 A601	110 - 6"						
			" / 1'-0"						
				195' - 0" 195' - 0"					

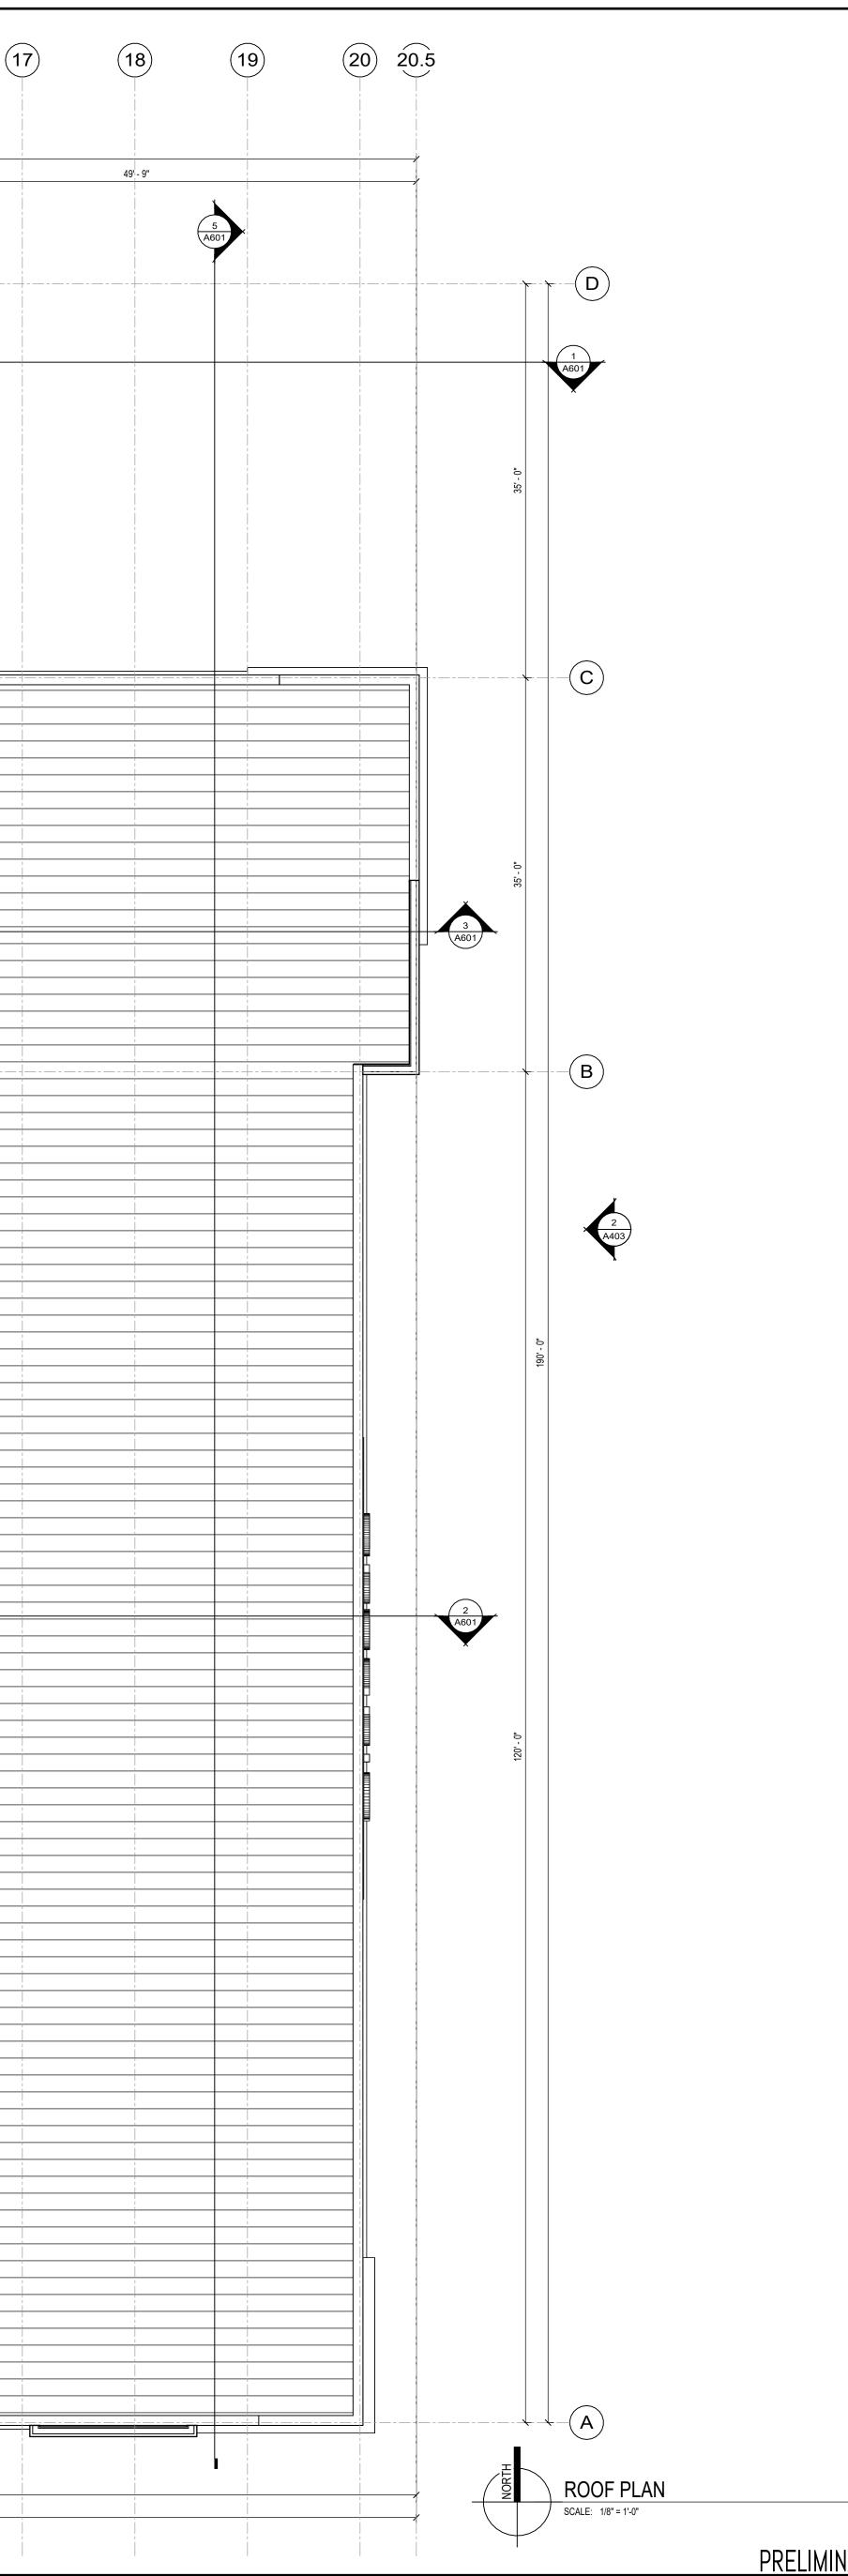

	•
ANGUS-YOU	
ARCHITECTS/ENGINEE	ERS
MADISON SQUAR	
STORAGE, LLC	
PENNSYLVANIA AVE	NUE
STORAGE BUILDIN	G
2230 Pennsylvania Ave Madison, WI 53704	
ISSUANCES / REVISIONS NO: DESCRIPTION:	DATE:
<sup>1/29/2024 11:41:12 AM</sup> Due to electronic distribution, this drawing may not be printed to the scale indicated on the drawings. Do NOT use scale to determine dimensions or sizes.	
dimensions or sizes. No part of this drawing may be used or reproduced in any form or by any means, or stored in a database or retrieval system, without prior written permission of.	
written permission of. ANGUS - YOUNG ASSOCIATES, INC. Copyright © 2023 All Rights Reserved	
PROJECT NUMBER 76850	
APPROVED BY Approver	
REVIEWED BY Checker	
DRAWN BY Author	
ROOF PLAN	
A105	•

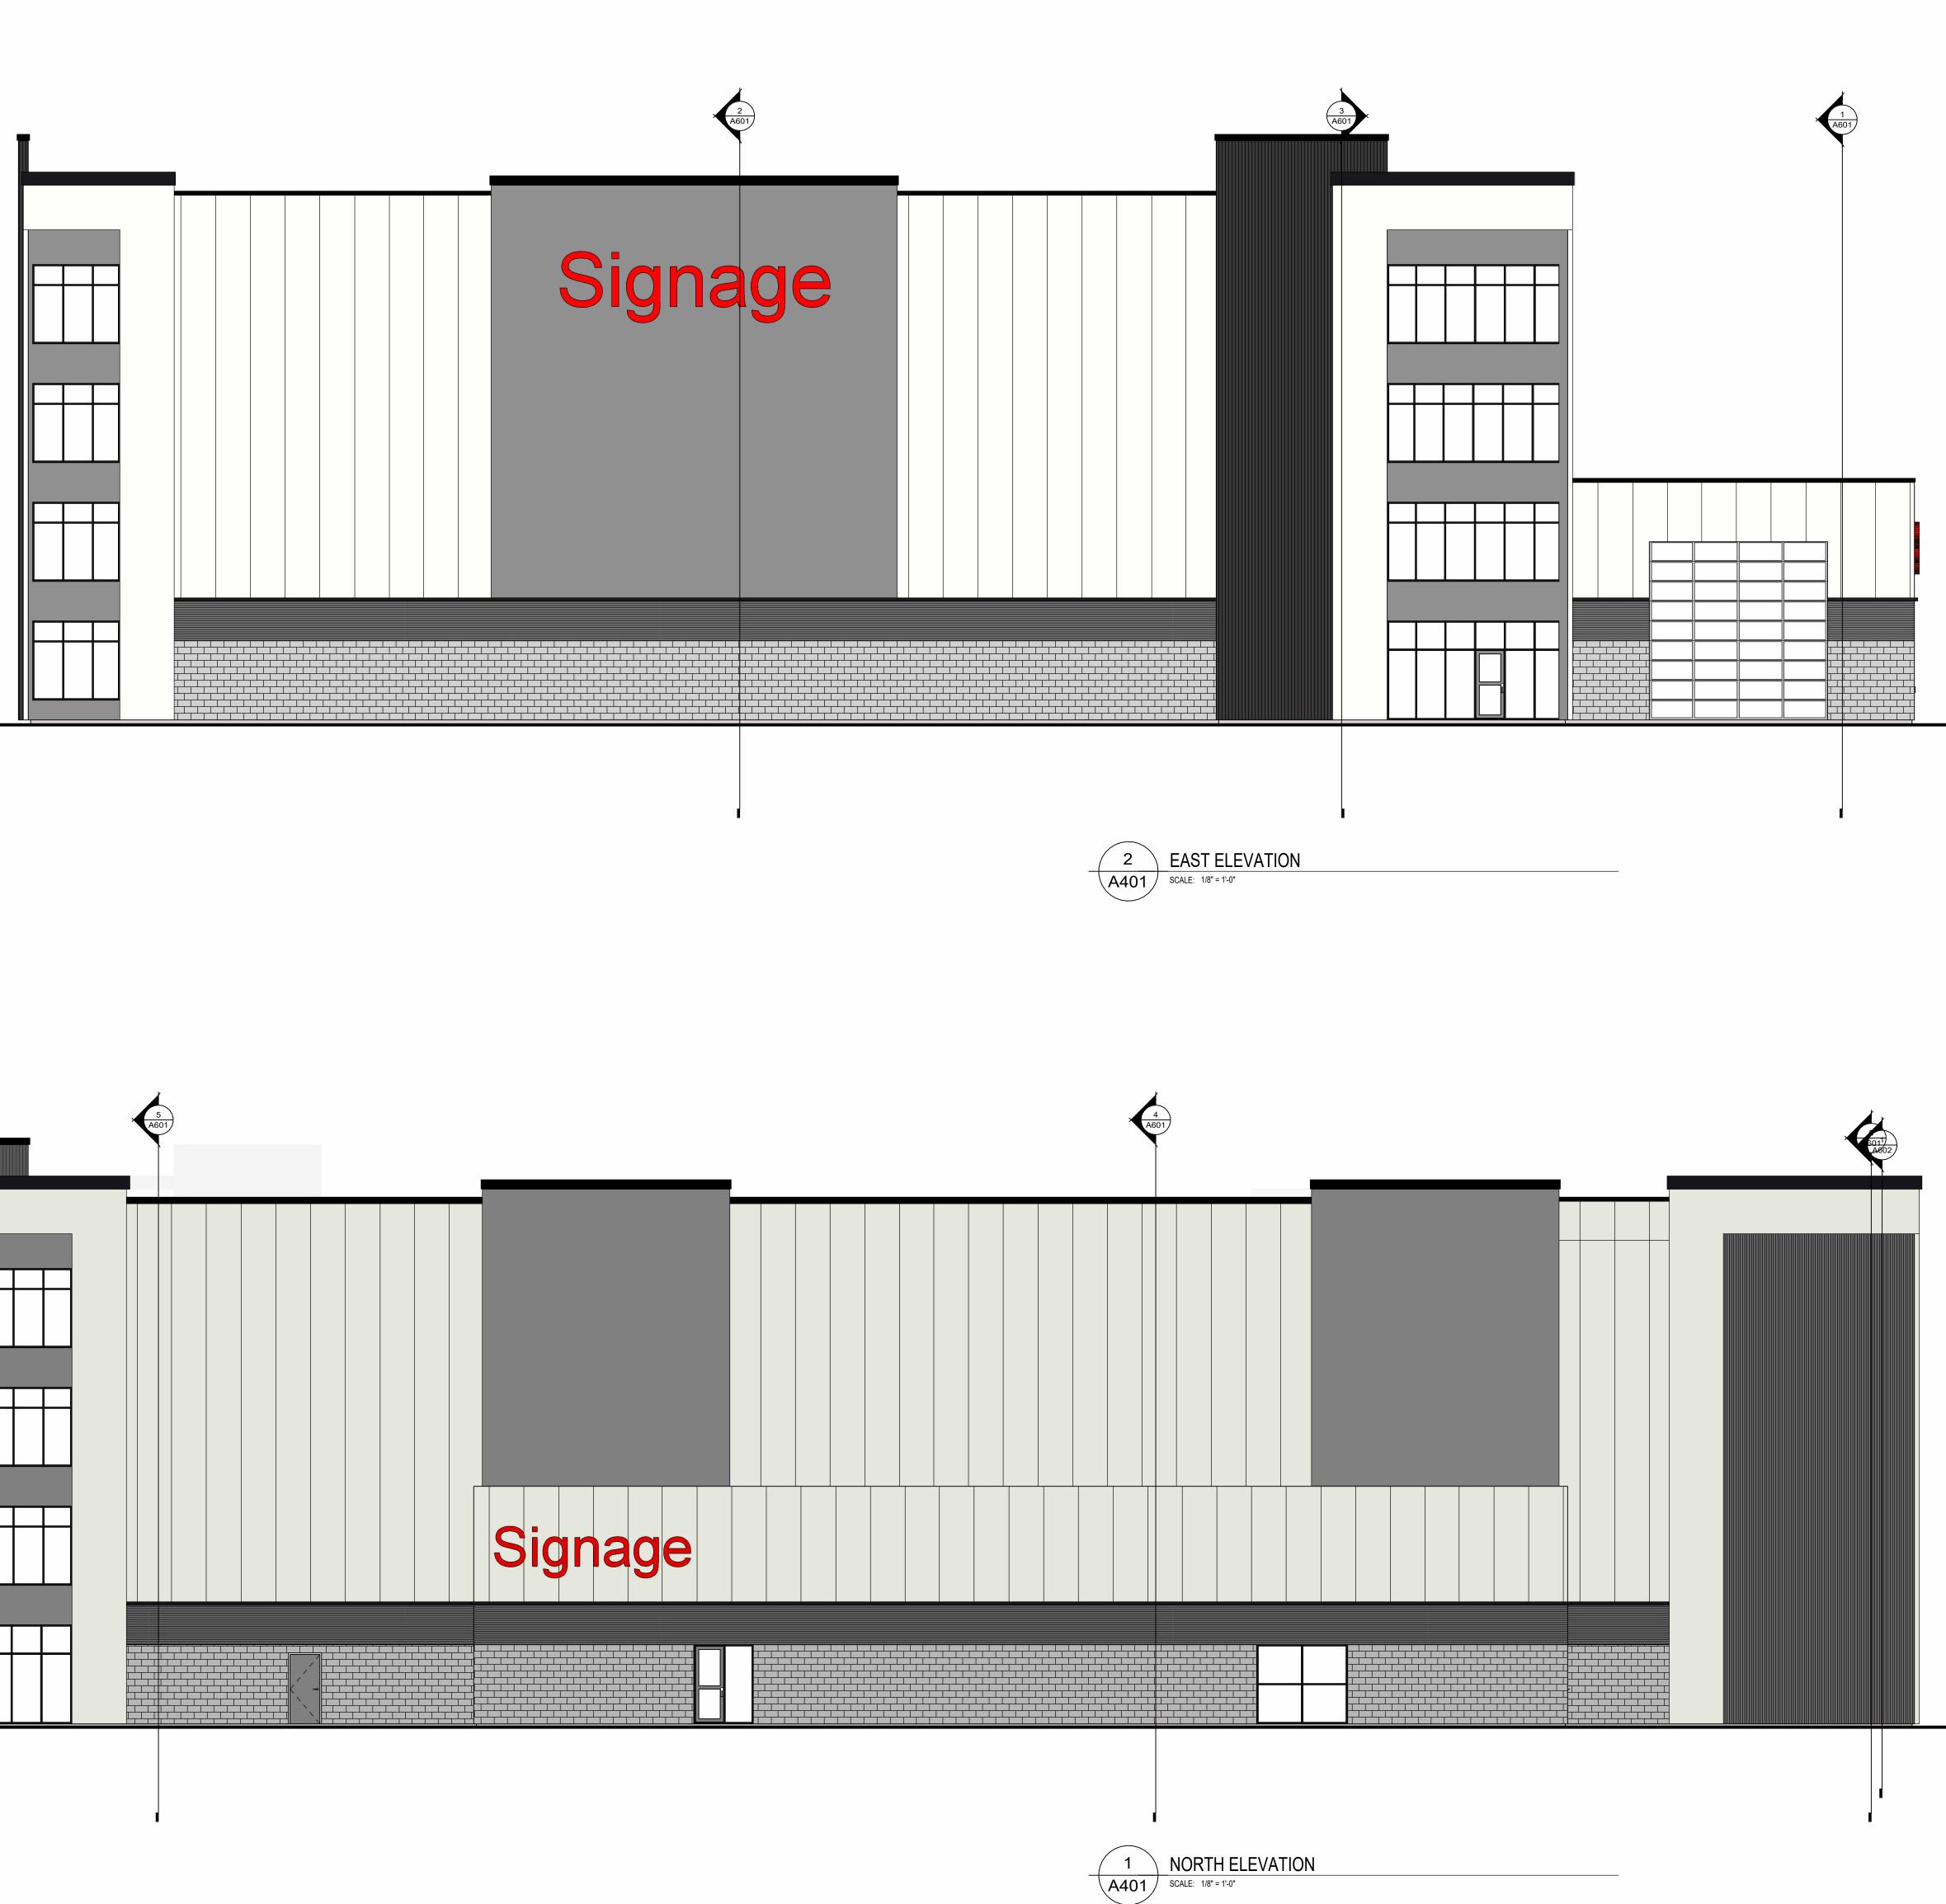


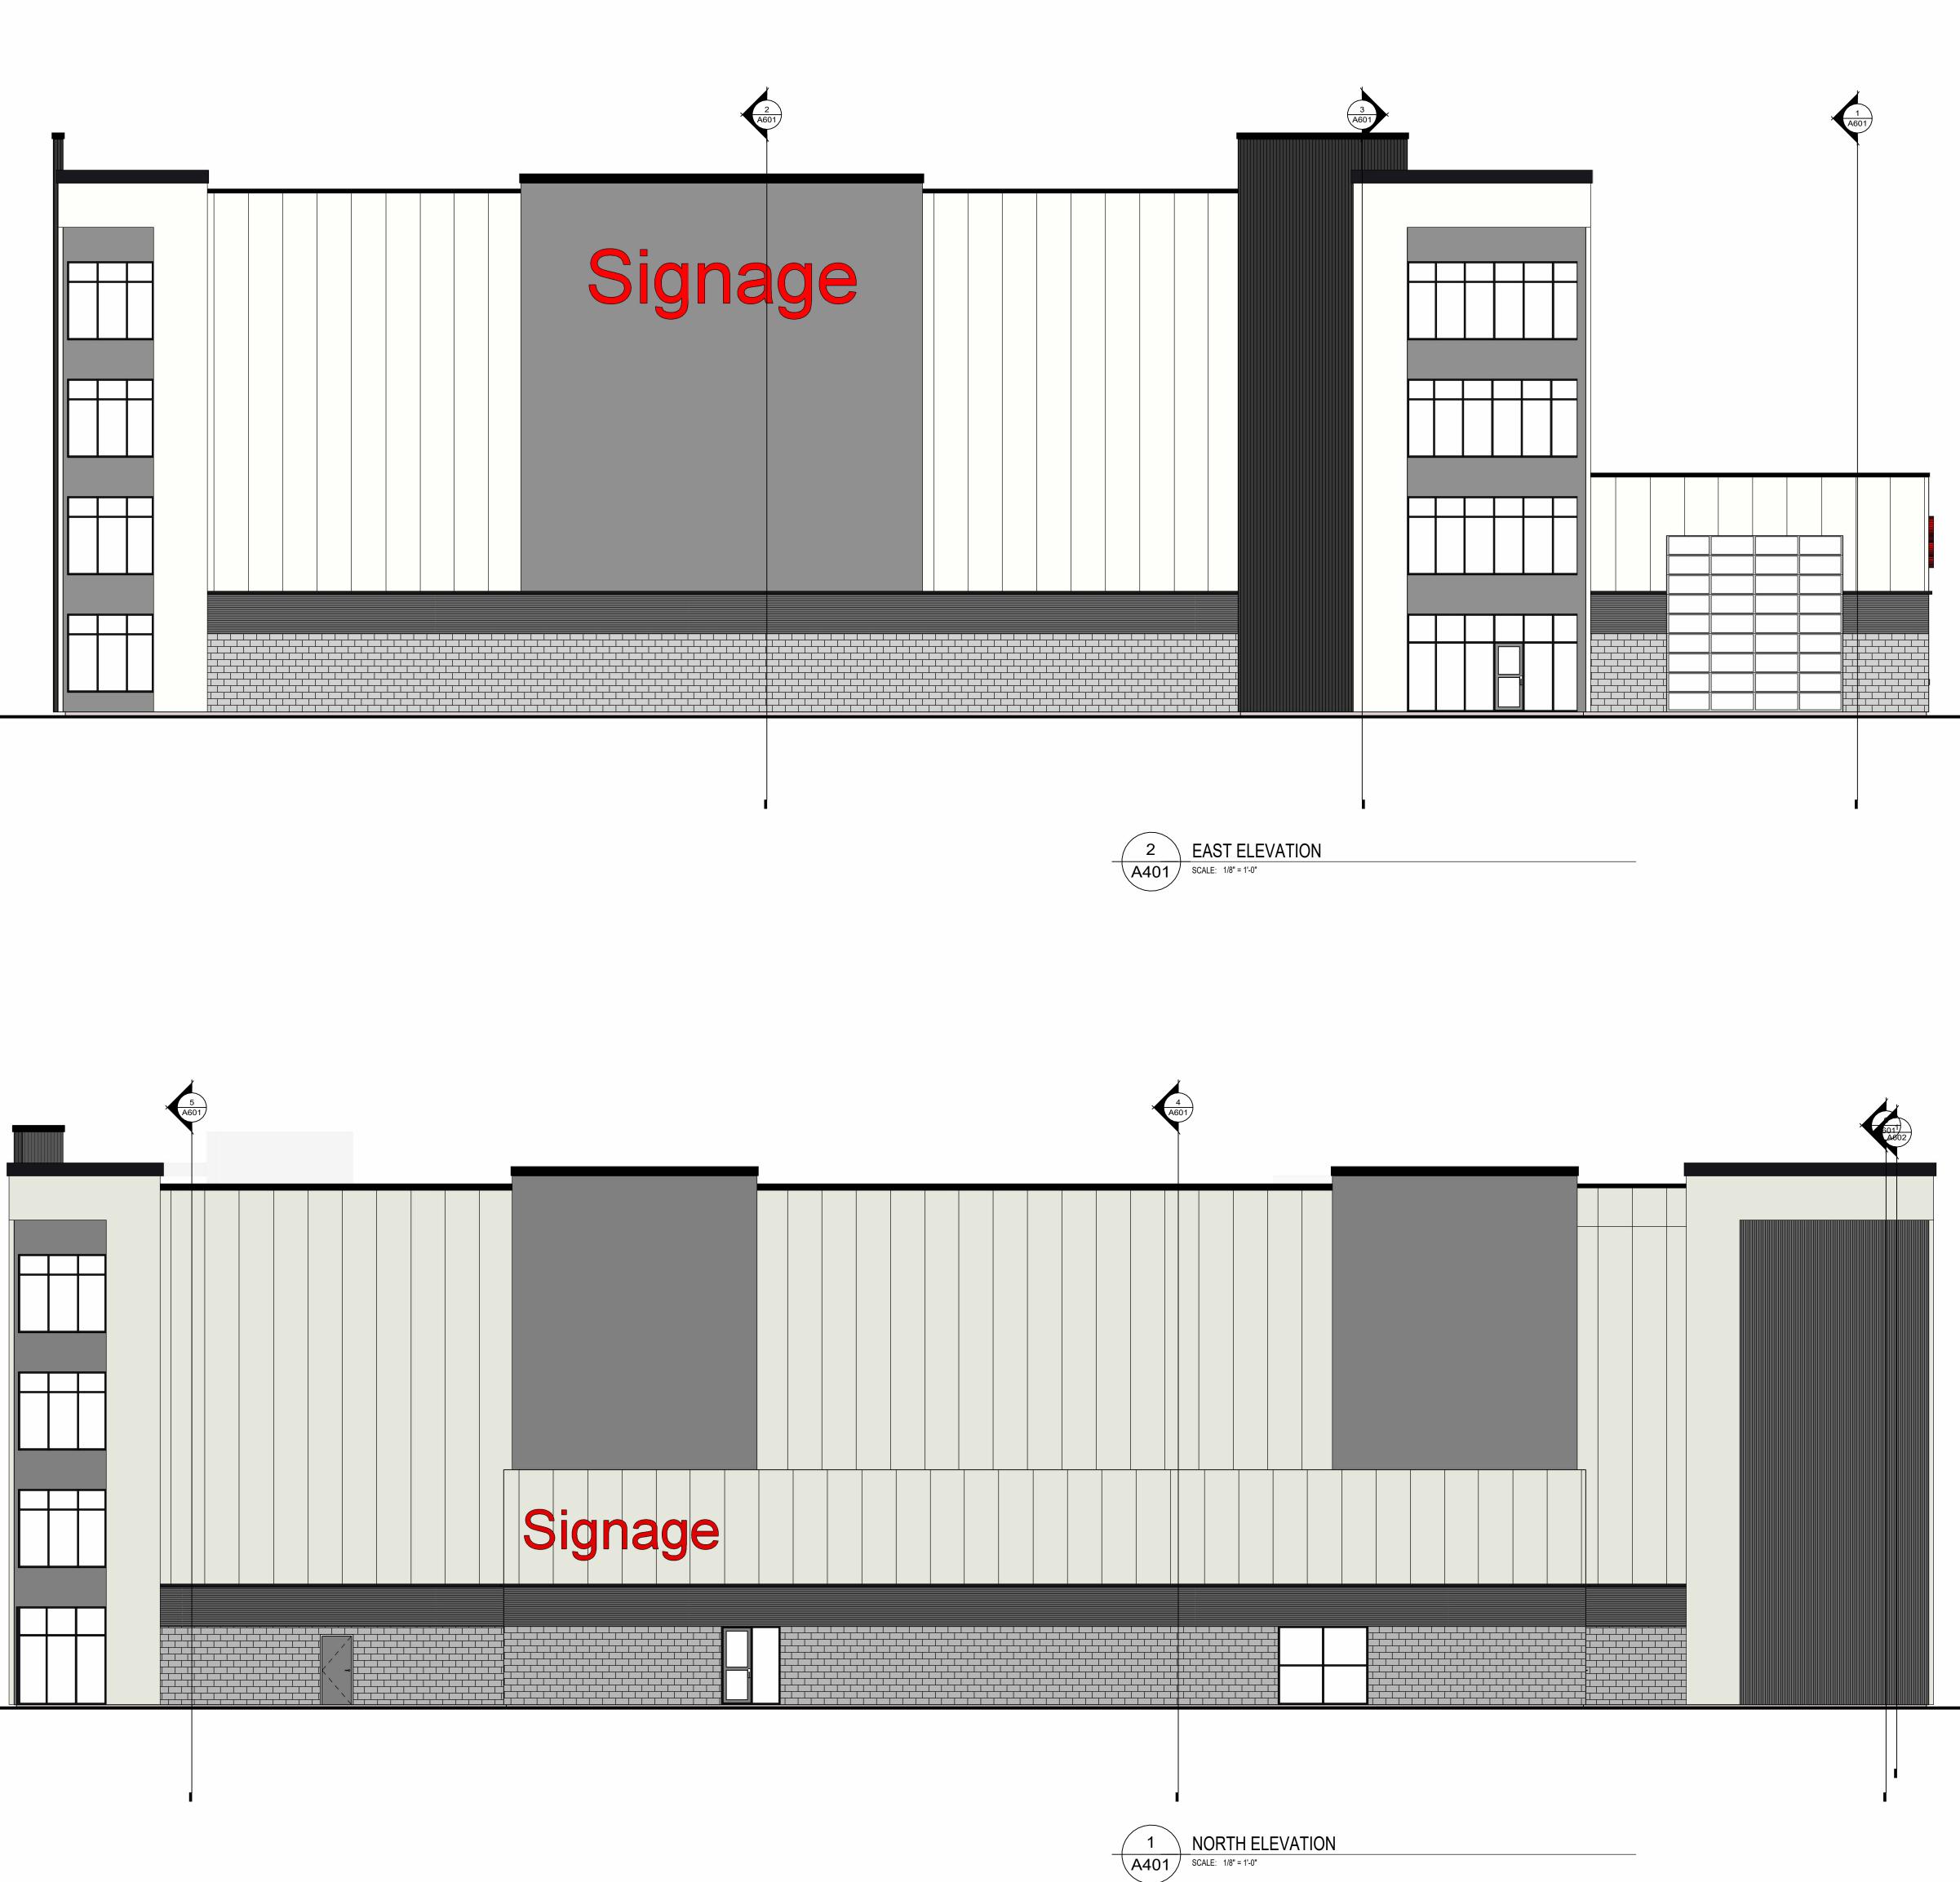


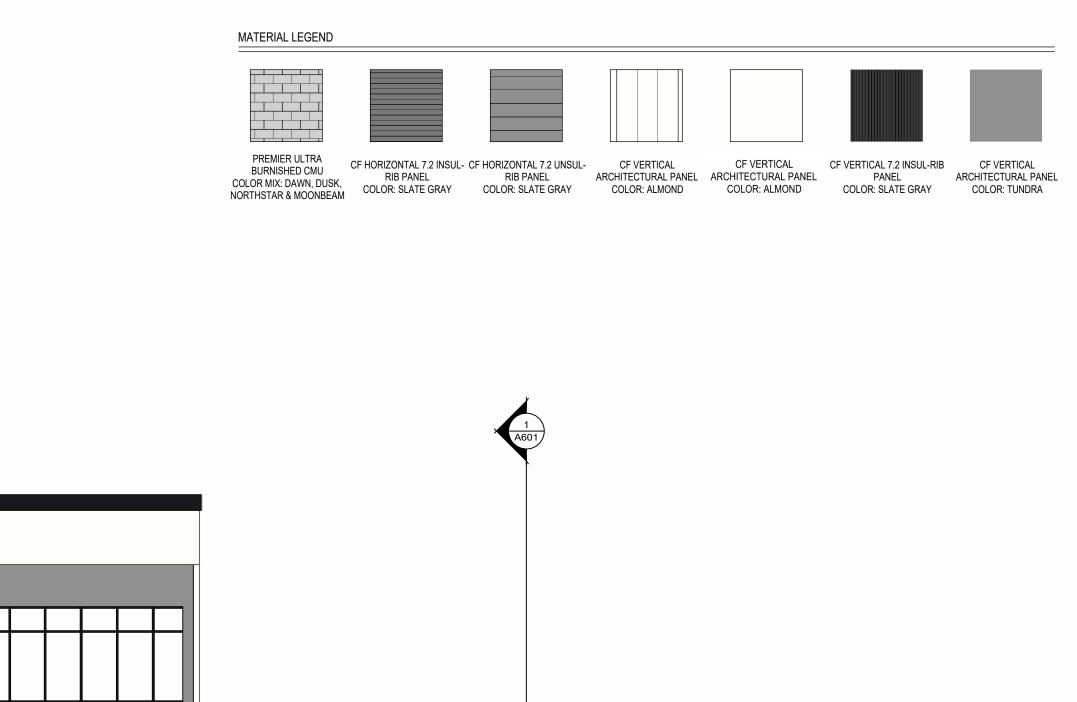



A	ANGUS-YOUNG ARCHITECTS/ENGINEERS		
	Janesville   Madison		
	MADISON SQUARE STORAGE, LLC		
F	ENNSYLVANIA AVEN STORAGE BUILDING		
	2230 Pennsylvania Ave Madison, WI 53704		
NO:	ISSUANCES / REVISIONS DESCRIPTION:	DATE:	
NO:		DATE:	
NO:		DATE:	
NO:			
NO:			
1/29/20	DESCRIPTION:		
1/29/20 Du	DESCRIPTION:	ing may	
1/29/20 Du repro	DESCRIPTION:	ing may on the mine d or or stored	
1/29/20 Du repro	DESCRIPTION:	ing may on the mine d or or stored out prior	
1/29/20 Du repro	DESCRIPTION:	ing may on the mine d or or stored out prior	
1/29/20 Du repro	DESCRIPTION:	ing may on the mine d or or stored out prior	
1/29/20 Du repro	DESCRIPTION:	ing may on the mine d or or stored out prior	
1/29/20 Du repro	DESCRIPTION:	ing may on the mine d or or stored out prior C. /ed	
1/29/20 Du repro	DESCRIPTION:	ing may on the mine d or or stored out prior C. /ed	
1/29/20 Du repro	DESCRIPTION:	ing may on the mine d or or stored out prior C. /ed	

 $\overline{}$ 

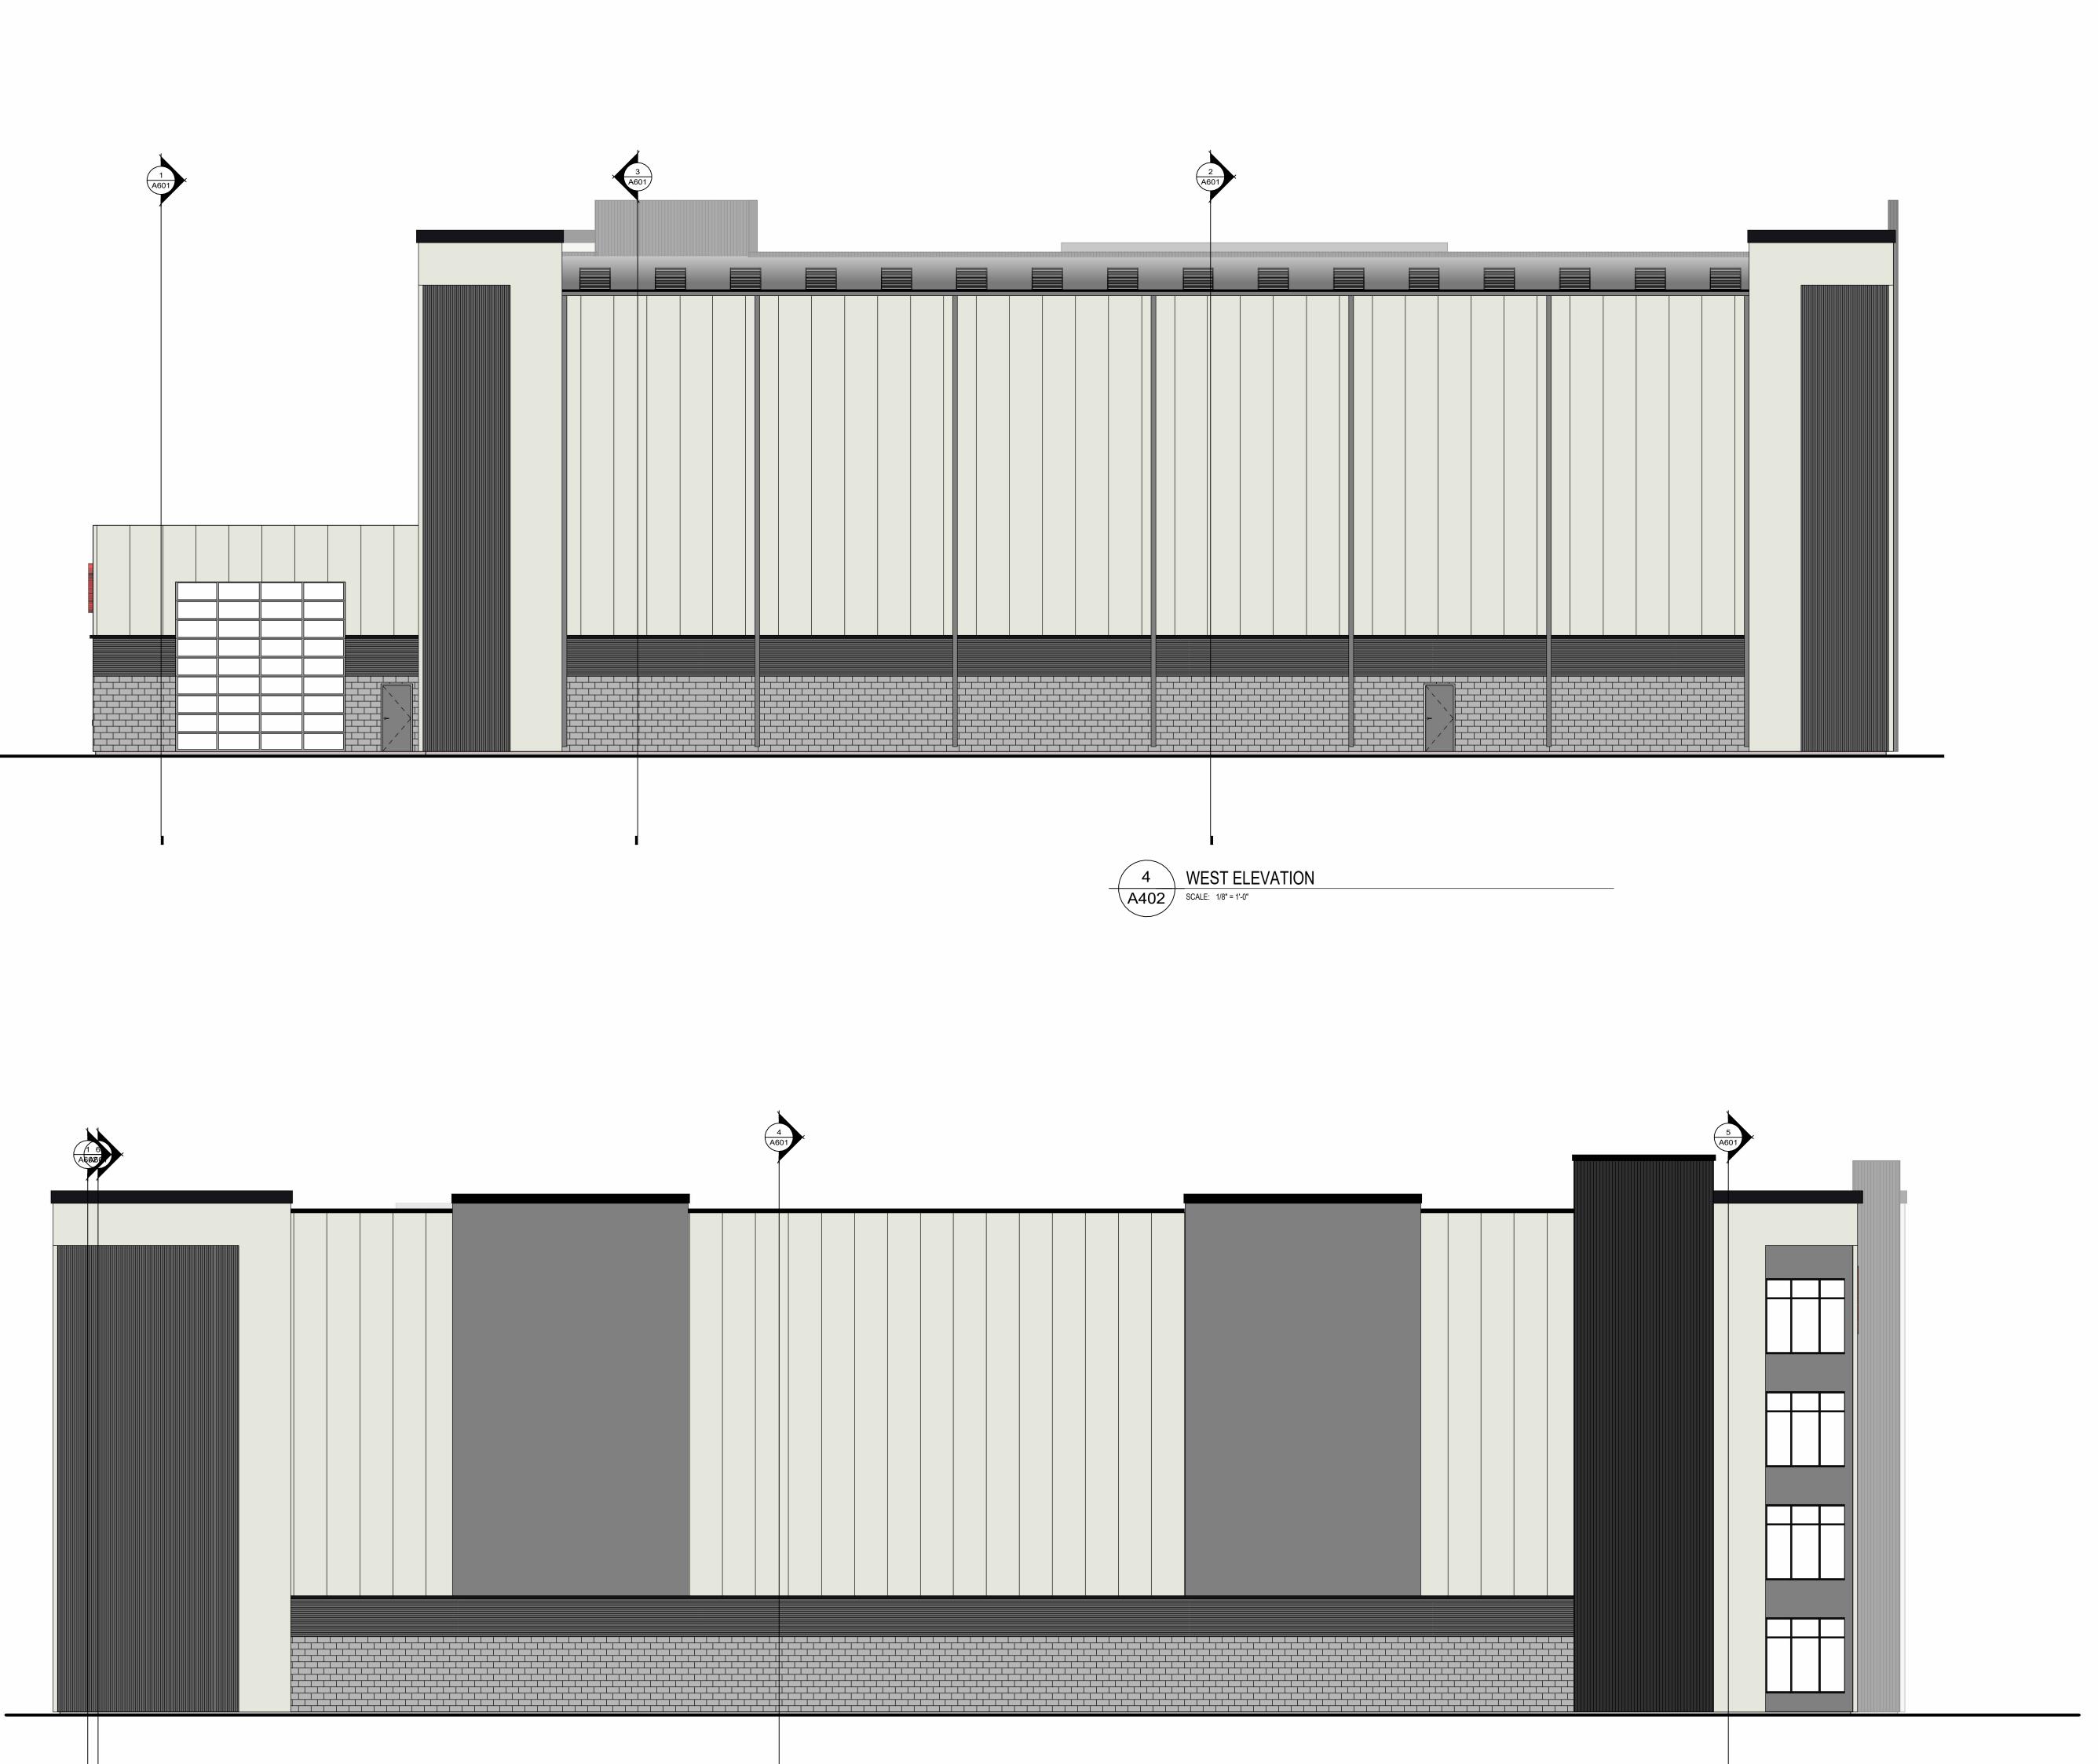

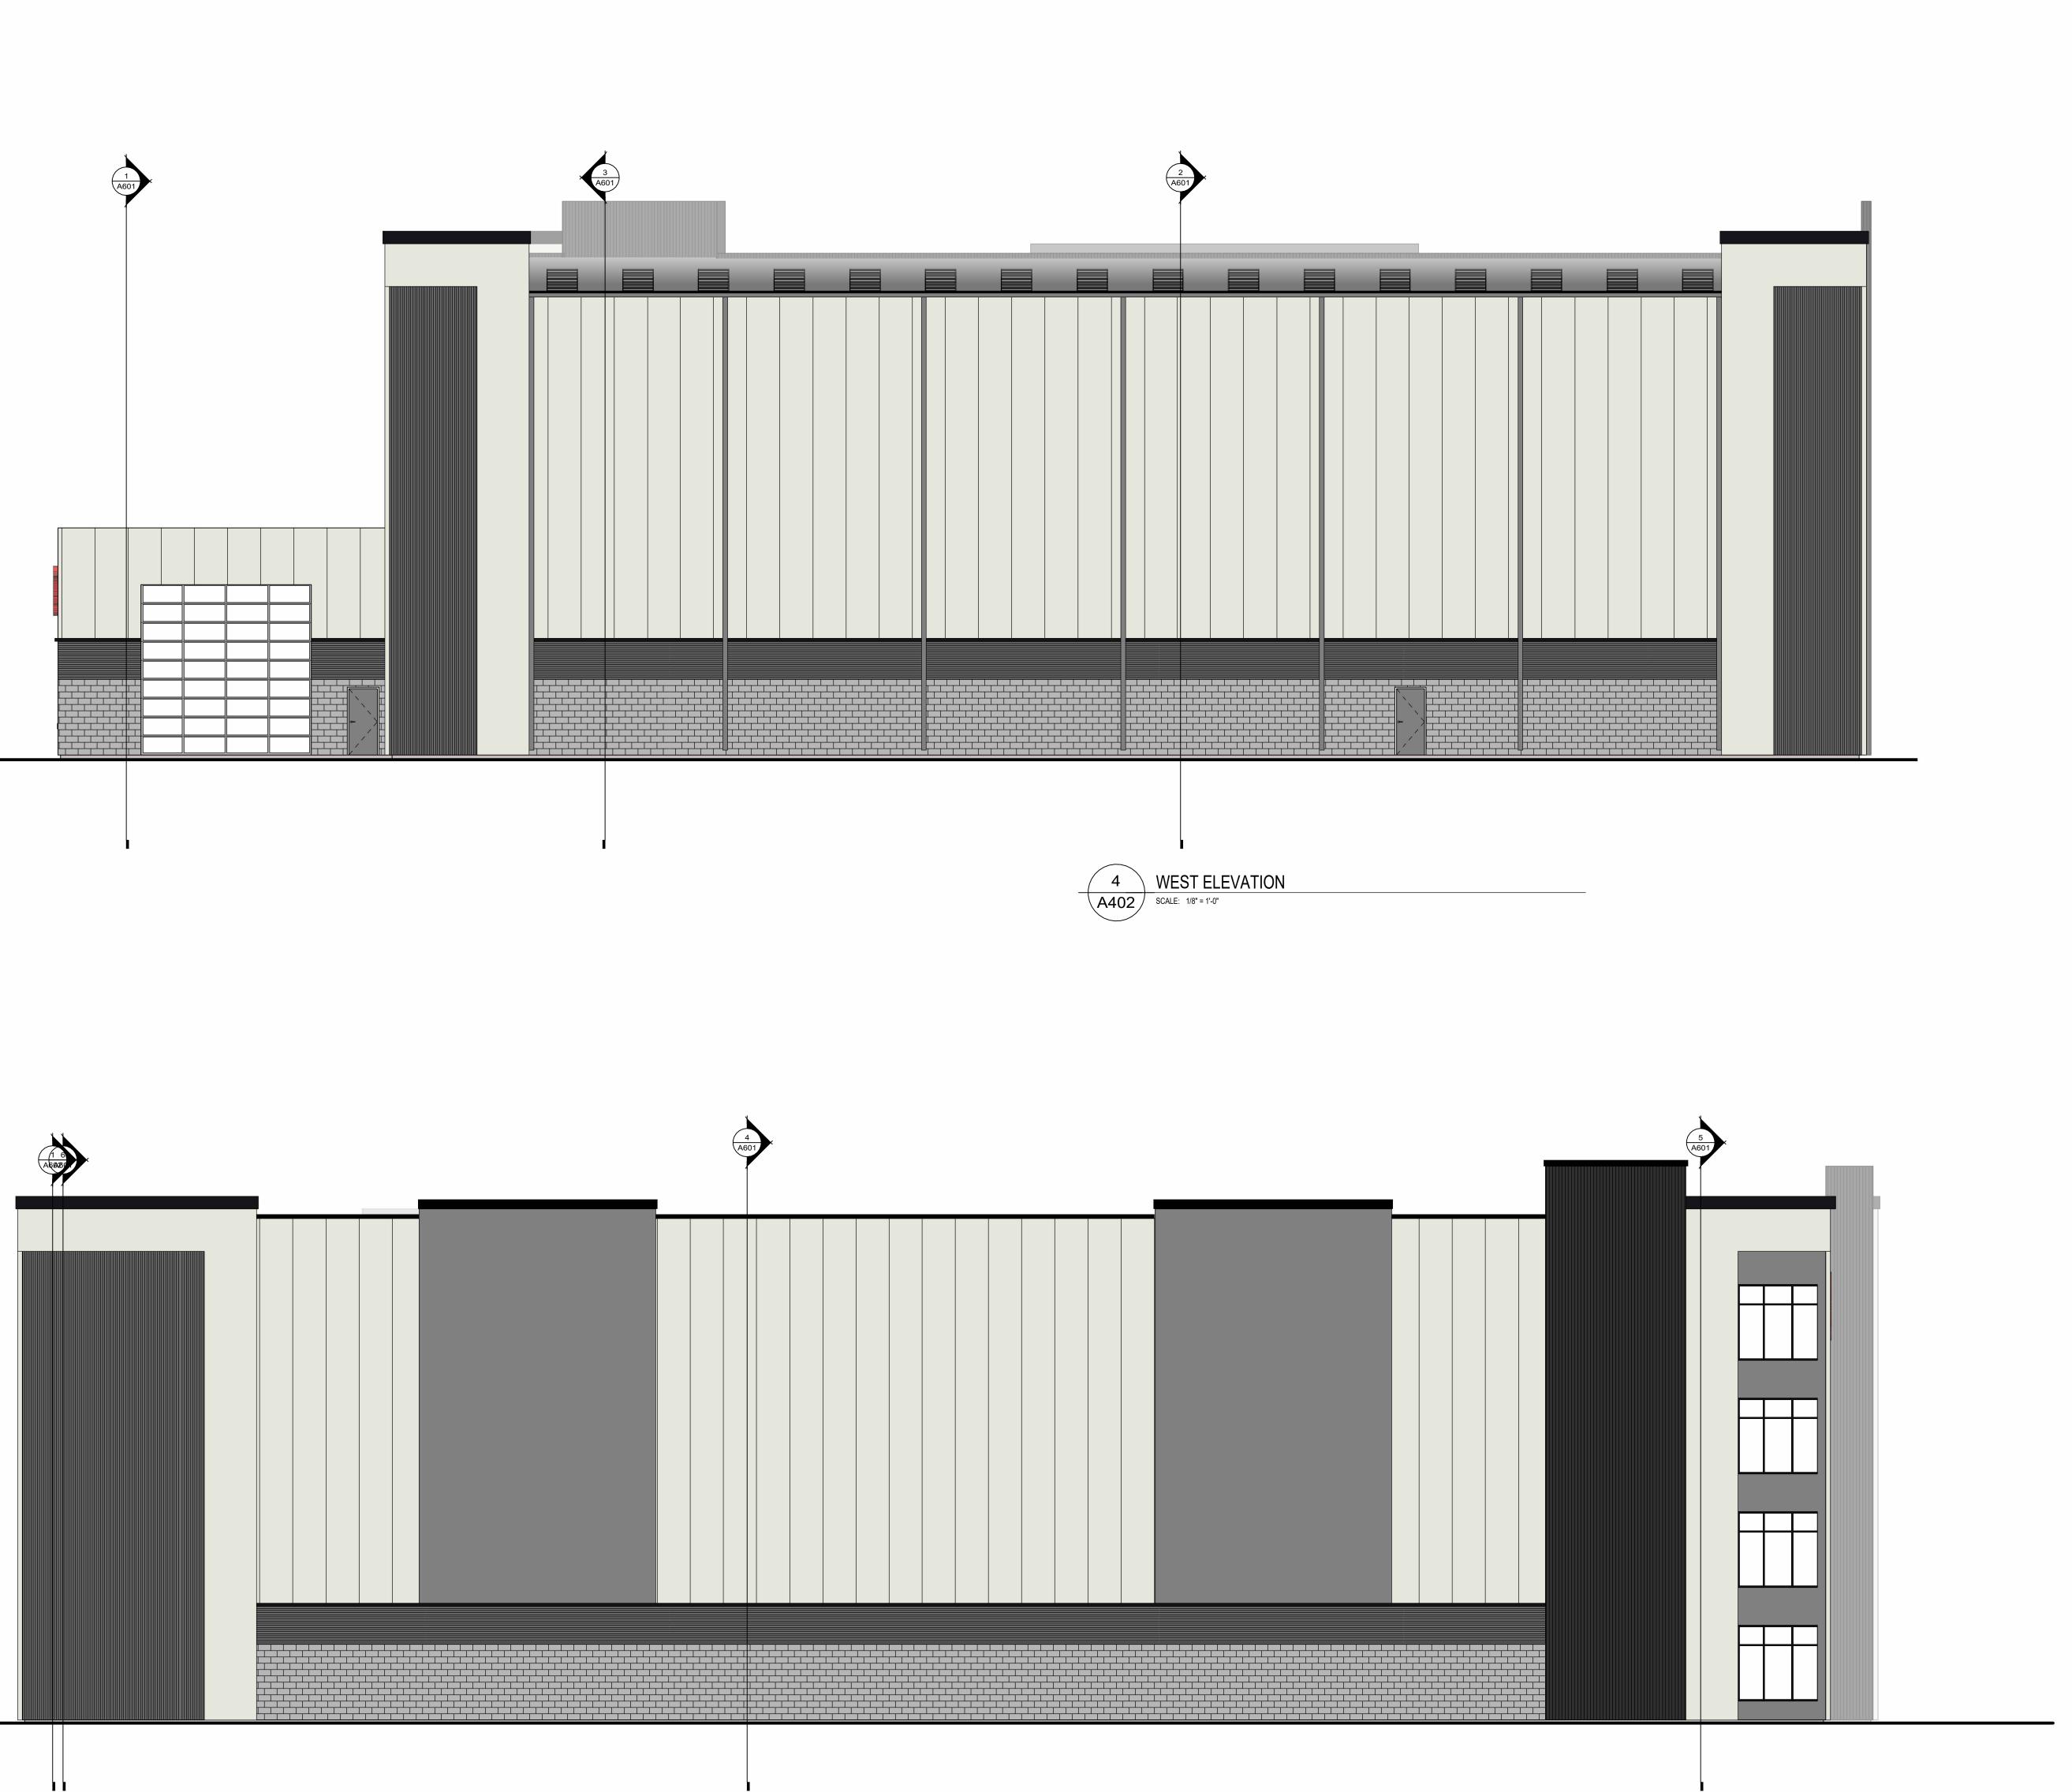


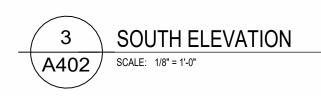


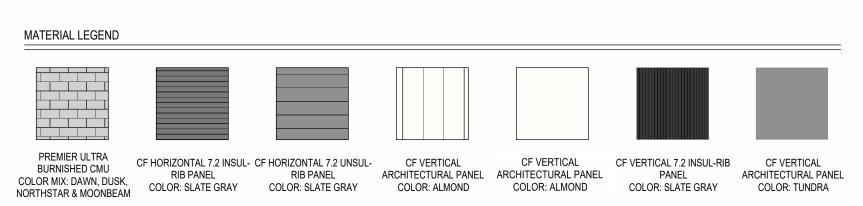


ANGUS-YOU		
Janesville   Madison		
MADISON SQUAR STORAGE, LLC	-	
PENNSYLVANIA AVEI STORAGE BUILDIN	_	
2230 Pennsylvania Ave Madison, WI 53704		
ISSUANCES / REVISIONS		
NO: DESCRIPTION:	DATE:	
1/29/2024 11:41:23 AM Due to electronic distribution, this draw not be printed to the scale indicated drawings. Do NOT use scale to dete dimensions or sizes.	on the ermine	
Due to electronic distribution, this draw not be printed to the scale indicated drawings. Do NOT use scale to dete	on the ermine ed or s, or stored	
Due to electronic distribution, this draw not be printed to the scale indicated drawings. Do NOT use scale to dete dimensions or sizes. No part of this drawing may be us reproduced in any form or by any means in a database or retrieval system, with written permission of. ANGUS - YOUNG ASSOCIATES, I Copyright © 2023 All Rights Rese	on the ermine ed or s, or stored out prior NC.	
Due to electronic distribution, this draw not be printed to the scale indicated drawings. Do NOT use scale to dete dimensions or sizes. No part of this drawing may be us reproduced in any form or by any means in a database or retrieval system, with written permission of. ANGUS - YOUNG ASSOCIATES, I Copyright © 2023 All Rights Rese PROJECT NUMBER 76850	on the ermine ed or s, or stored out prior NC.	
Due to electronic distribution, this draw not be printed to the scale indicated drawings. Do NOT use scale to dete dimensions or sizes. No part of this drawing may be us reproduced in any form or by any means in a database or retrieval system, with written permission of. ANGUS - YOUNG ASSOCIATES, I Copyright © 2023 All Rights Rese PROJECT NUMBER 76850 APPROVED BY AYA	on the ermine ed or s, or stored out prior NC.	
Due to electronic distribution, this draw not be printed to the scale indicated drawings. Do NOT use scale to dete dimensions or sizes. No part of this drawing may be us reproduced in any form or by any means in a database or retrieval system, with written permission of. ANGUS - YOUNG ASSOCIATES, I Copyright © 2023 All Rights Rese PROJECT NUMBER 76850 APPROVED BY	on the ermine ed or s, or stored out prior NC.	
Due to electronic distribution, this draw not be printed to the scale indicated drawings. Do NOT use scale to dete dimensions or sizes. No part of this drawing may be us reproduced in any form or by any means in a database or retrieval system, with written permission of. ANGUS - YOUNG ASSOCIATES, I Copyright © 2023 All Rights Rese PROJECT NUMBER 76850 APPROVED BY AYA REVIEWED BY AYA DRAWN BY Author	on the ermine ed or s, or stored out prior NC. rved	
Due to electronic distribution, this draw not be printed to the scale indicated drawings. Do NOT use scale to dete dimensions or sizes. No part of this drawing may be us reproduced in any form or by any means in a database or retrieval system, with written permission of. ANGUS - YOUNG ASSOCIATES, I Copyright © 2023 All Rights Rese PROJECT NUMBER 76850 APPROVED BY AYA REVIEWED BY AYA DRAWN BY	on the ermine ed or s, or stored out prior NC. rved	
Due to electronic distribution, this draw not be printed to the scale indicated drawings. Do NOT use scale to dete dimensions or sizes. No part of this drawing may be us reproduced in any form or by any means in a database or retrieval system, with written permission of. ANGUS - YOUNG ASSOCIATES, I Copyright © 2023 All Rights Rese PROJECT NUMBER 76850 APPROVED BY AYA REVIEWED BY AYA DRAWN BY Author EXTERIOR ELEVATIONS - CO	on the ermine ed or s, or stored out prior NC. rved	




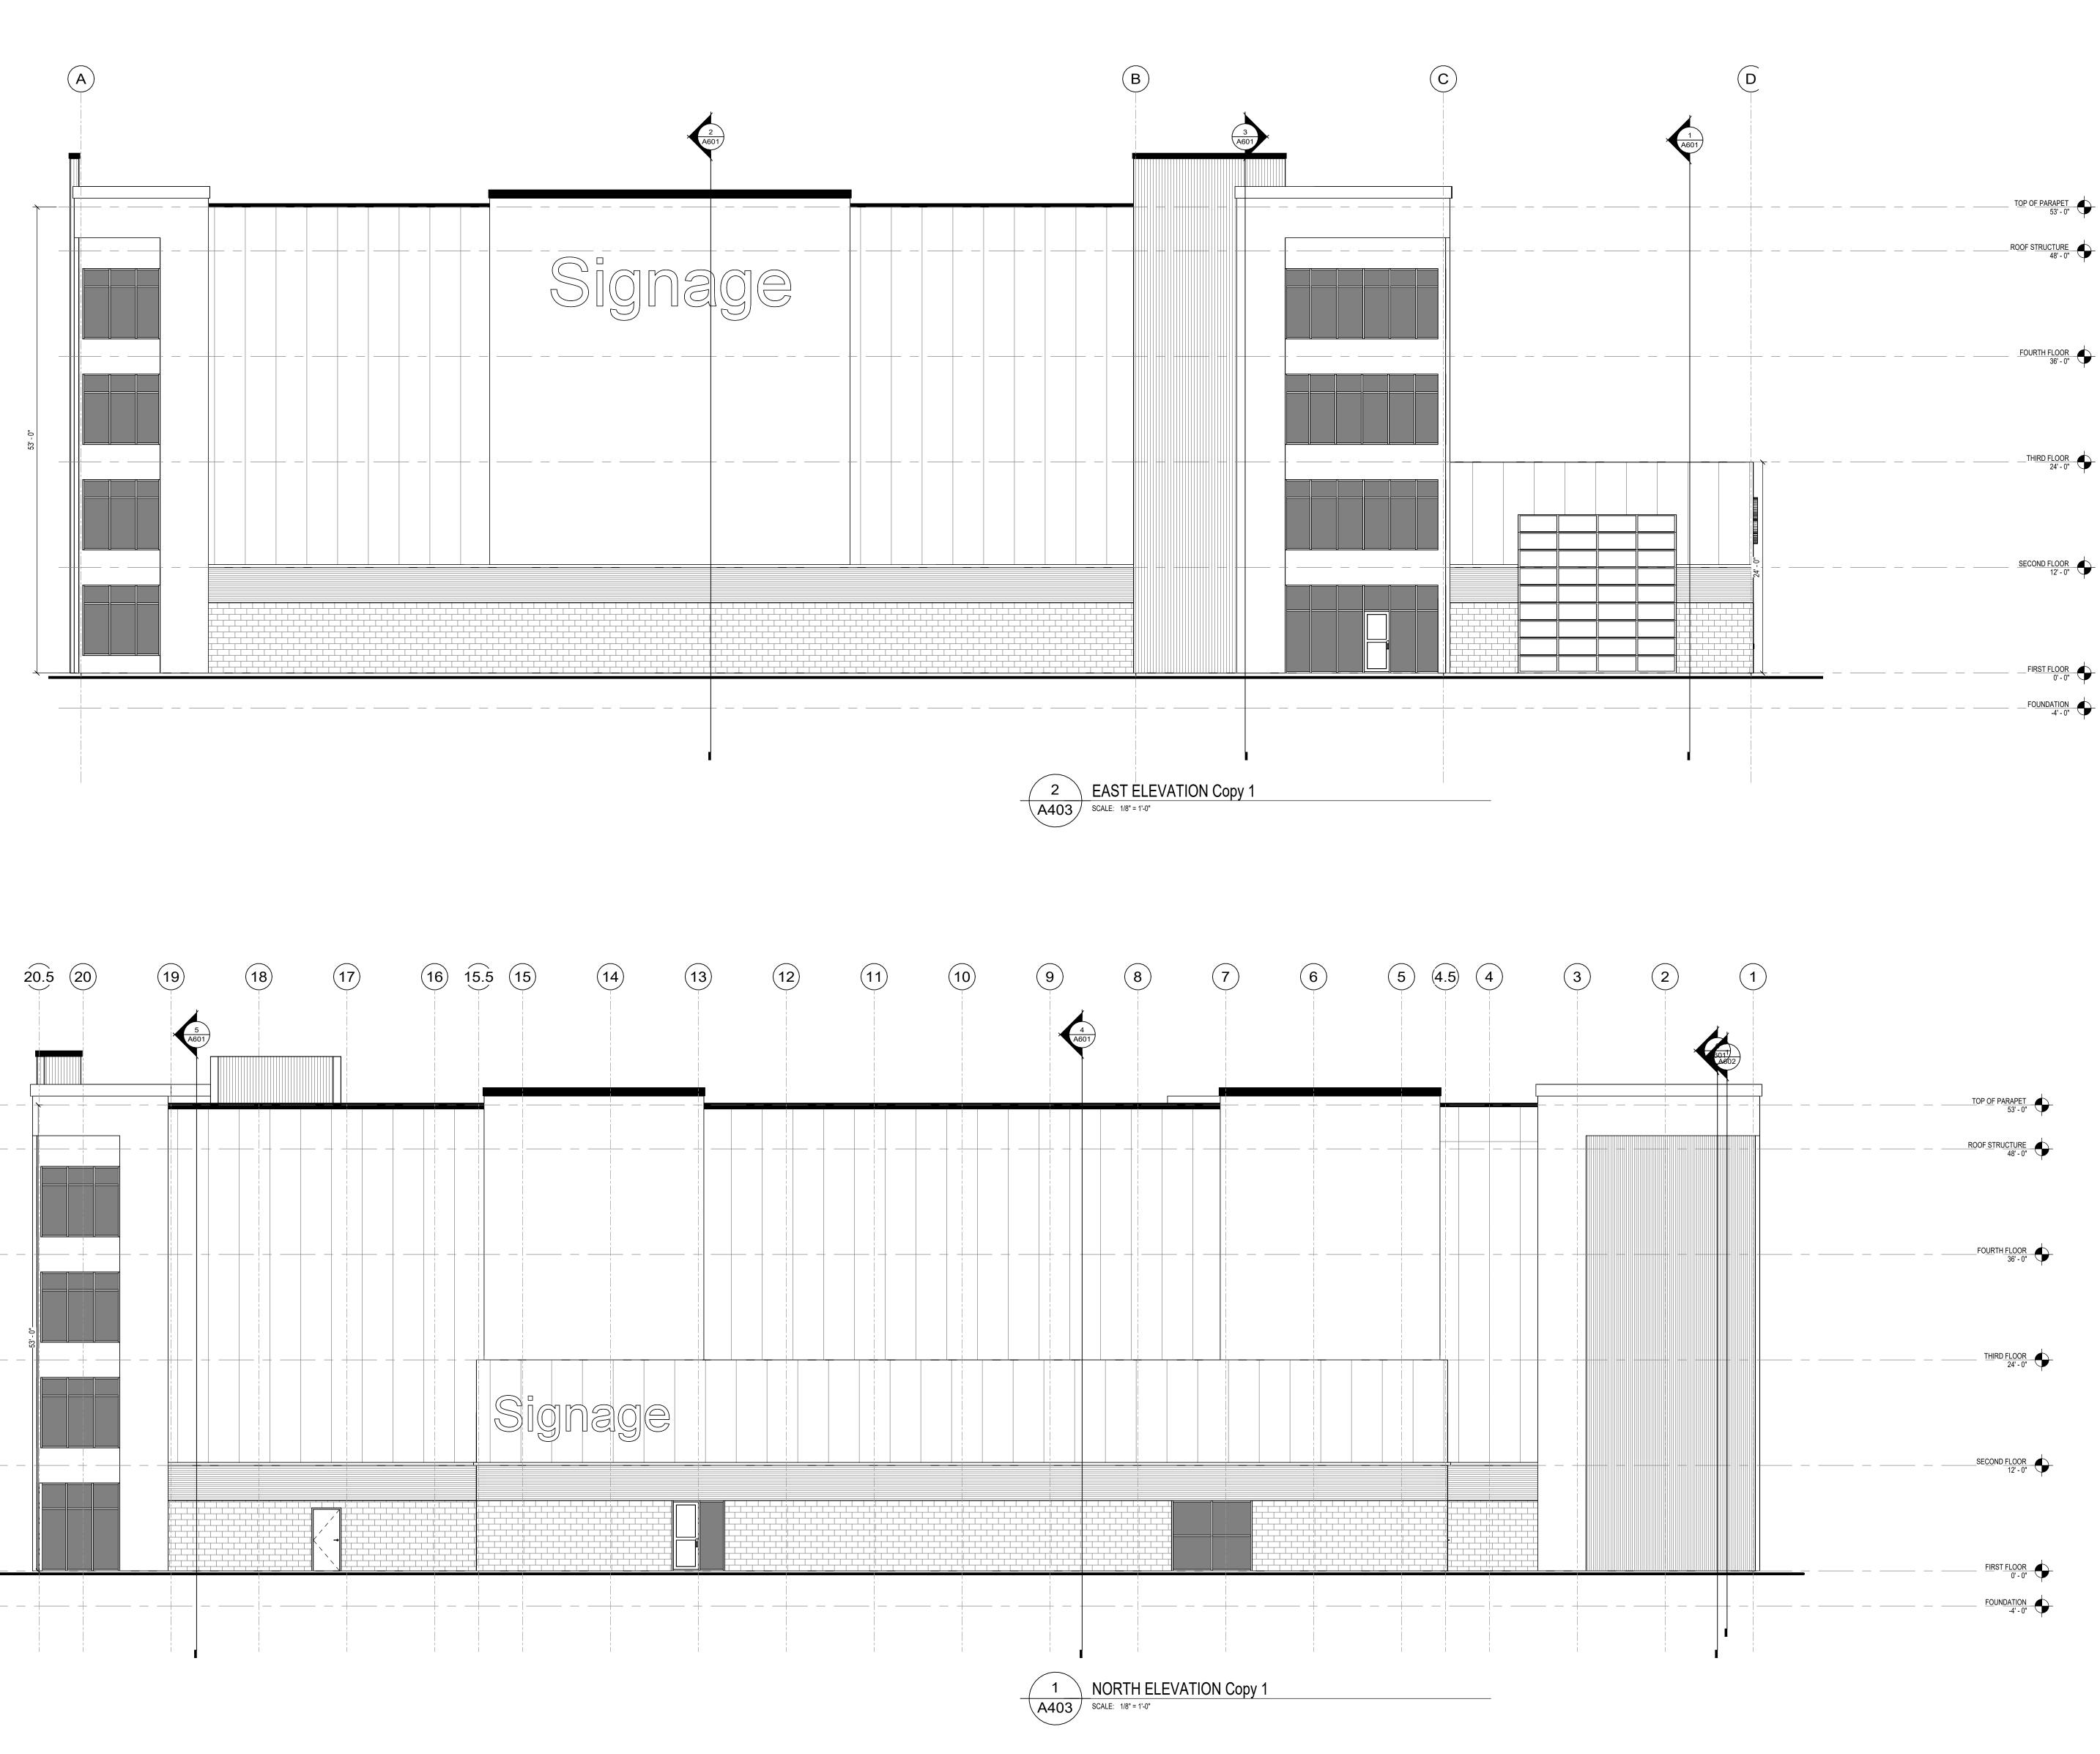

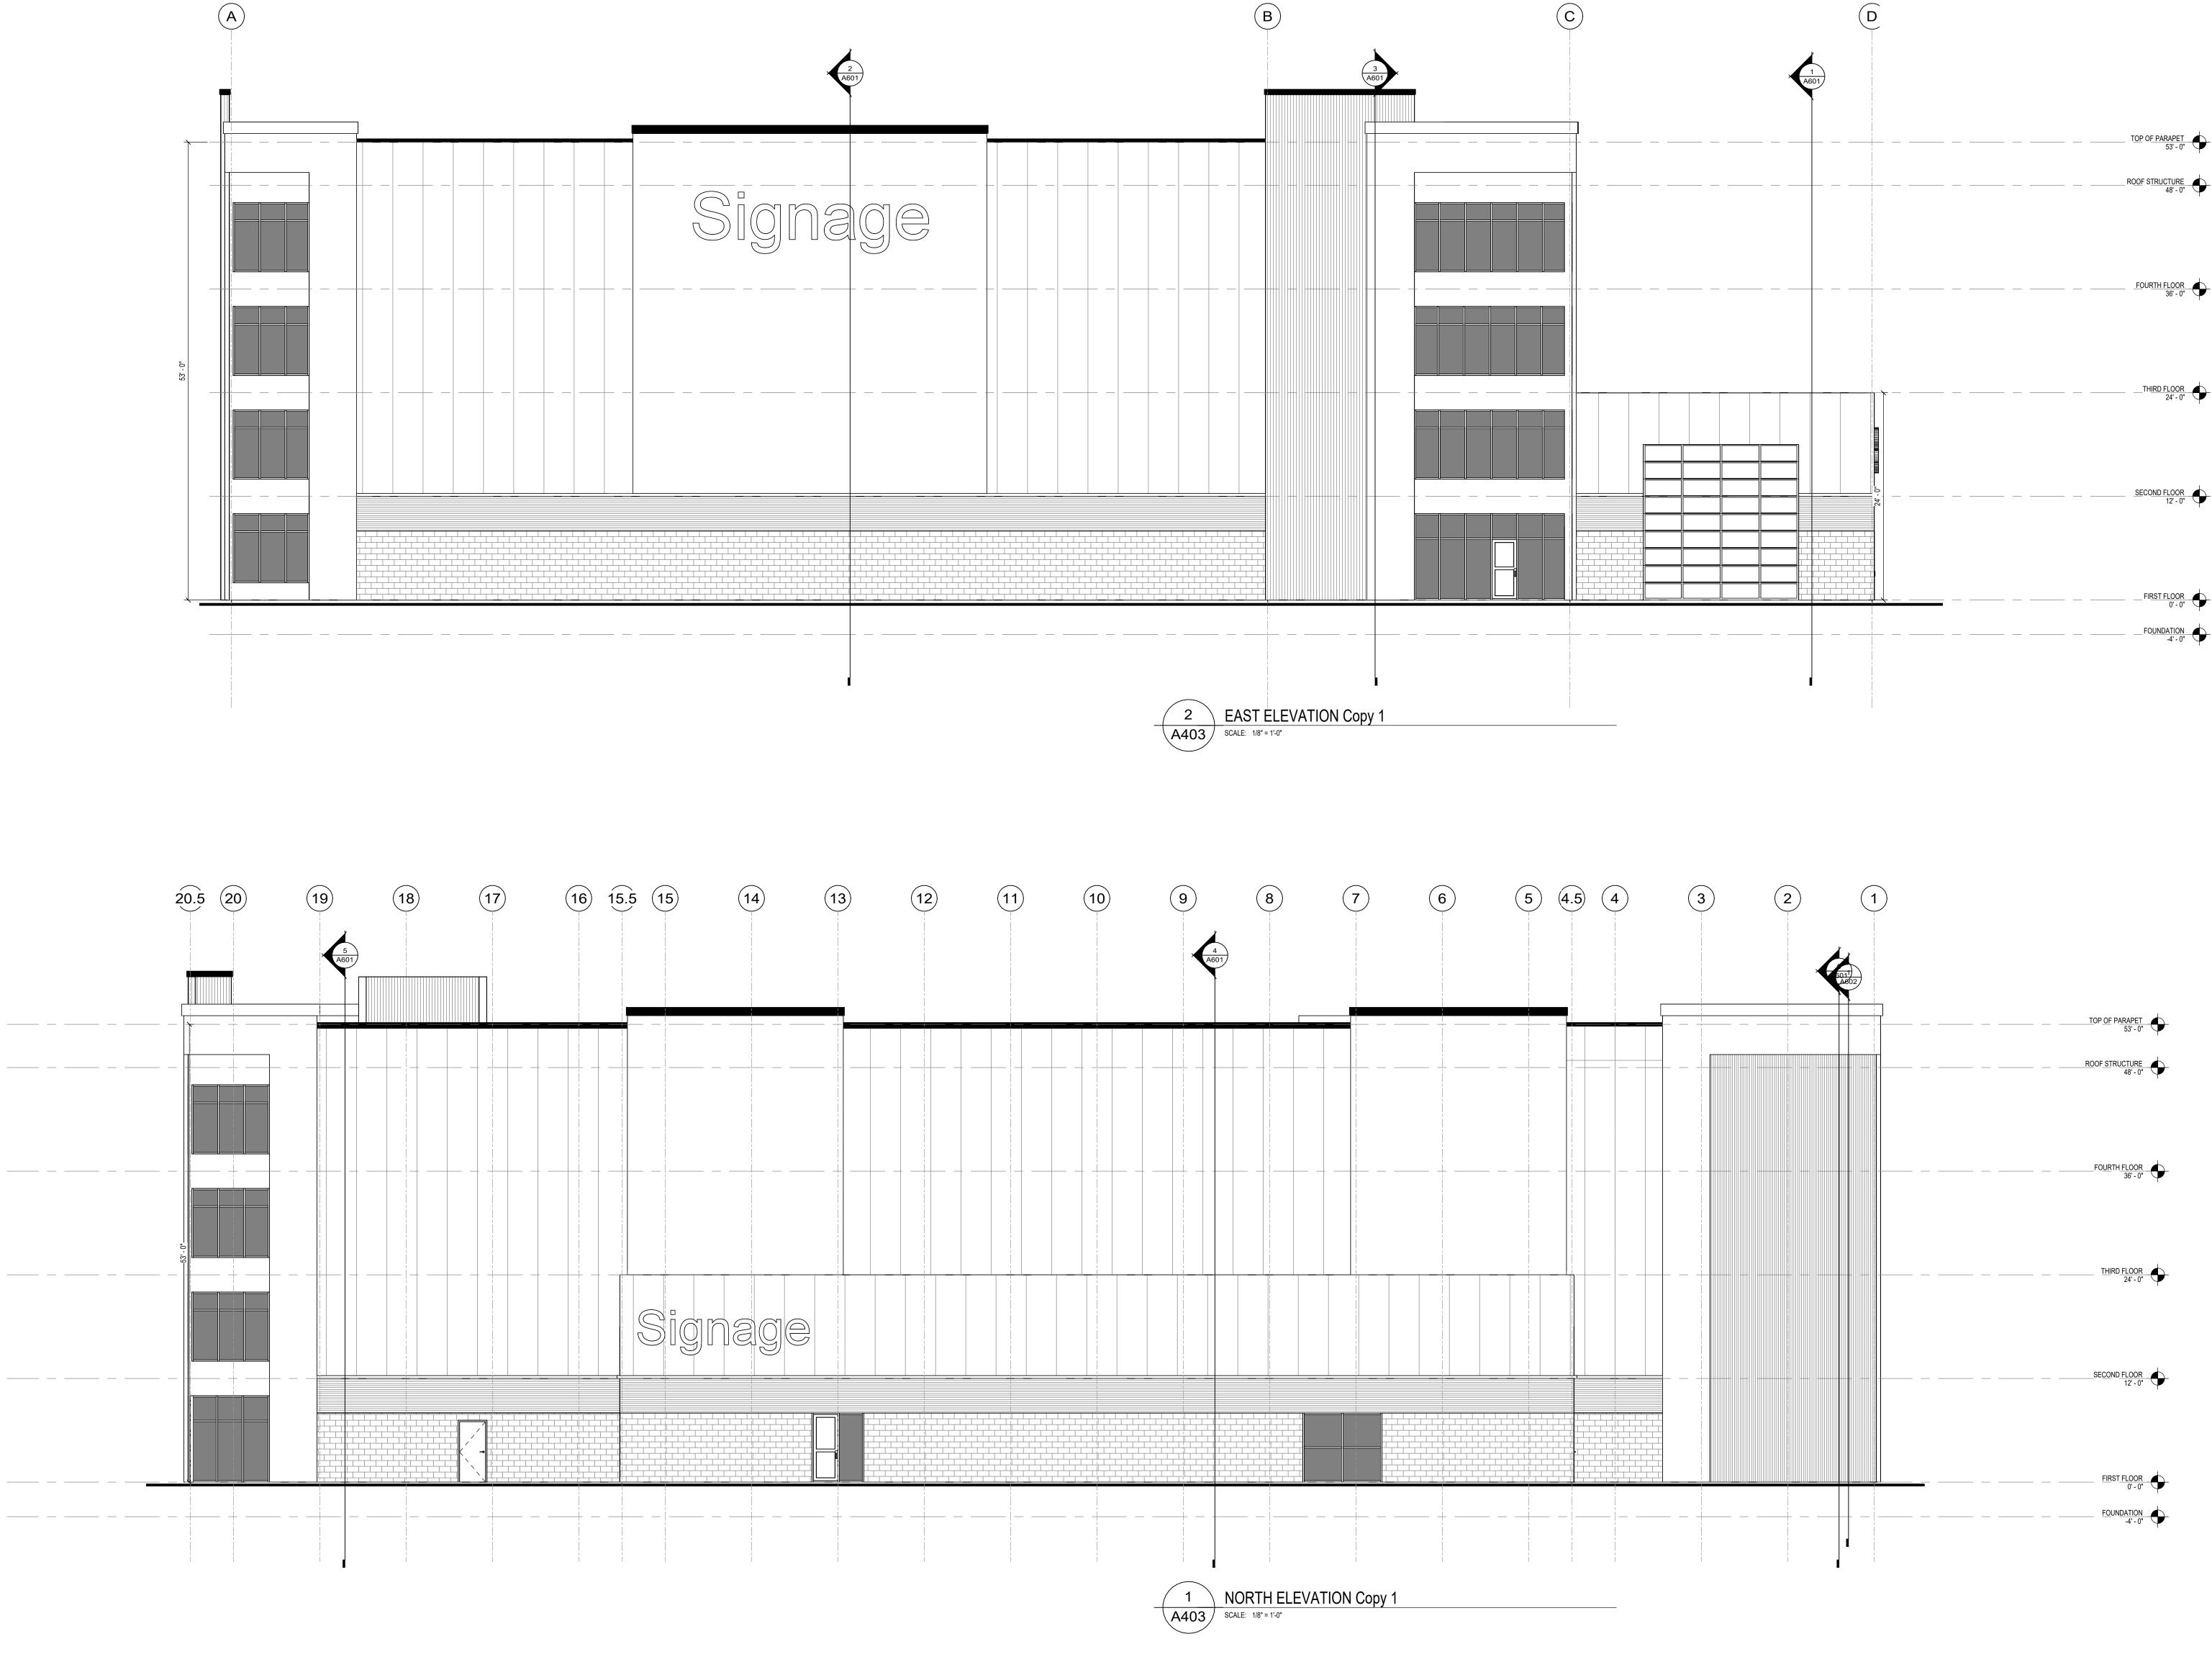


<b></b>			
A			
	ARCHITECTS/ENGINEERS Janesville   Madison		
	MADISON SQUARE		
	<u>STORAGE, LLC</u>		
F	ENNSYLVANIA AVEN	UE	
	STORAGE BUILDING	3	
	2230 Pennsylvania Ave Madison, WI 53704		
NO:	ISSUANCES / REVISIONS DESCRIPTION:	DATE:	
1/29/20	24 11:41:23 AM		
Du	1/29/2024 11:41:23 AM Due to electronic distribution, this drawing may not be printed to the scale indicated on the drawings. Do NOT use scale to determine dimensions or sizes		
dimensions or sizes. No part of this drawing may be used or reproduced in any form or by any means, or stored in a database or retrieval system, without prior			
	Copyright © 2023 All Rights Reserved PROJECT NUMBER		
-	76850 APPROVED BY		
-	AYA REVIEWED BY		
-	AYA DRAWN BY		
	Author EXTERIOR ELEVATIONS- B&W		
	<u>v v</u> uj		
1	A403		

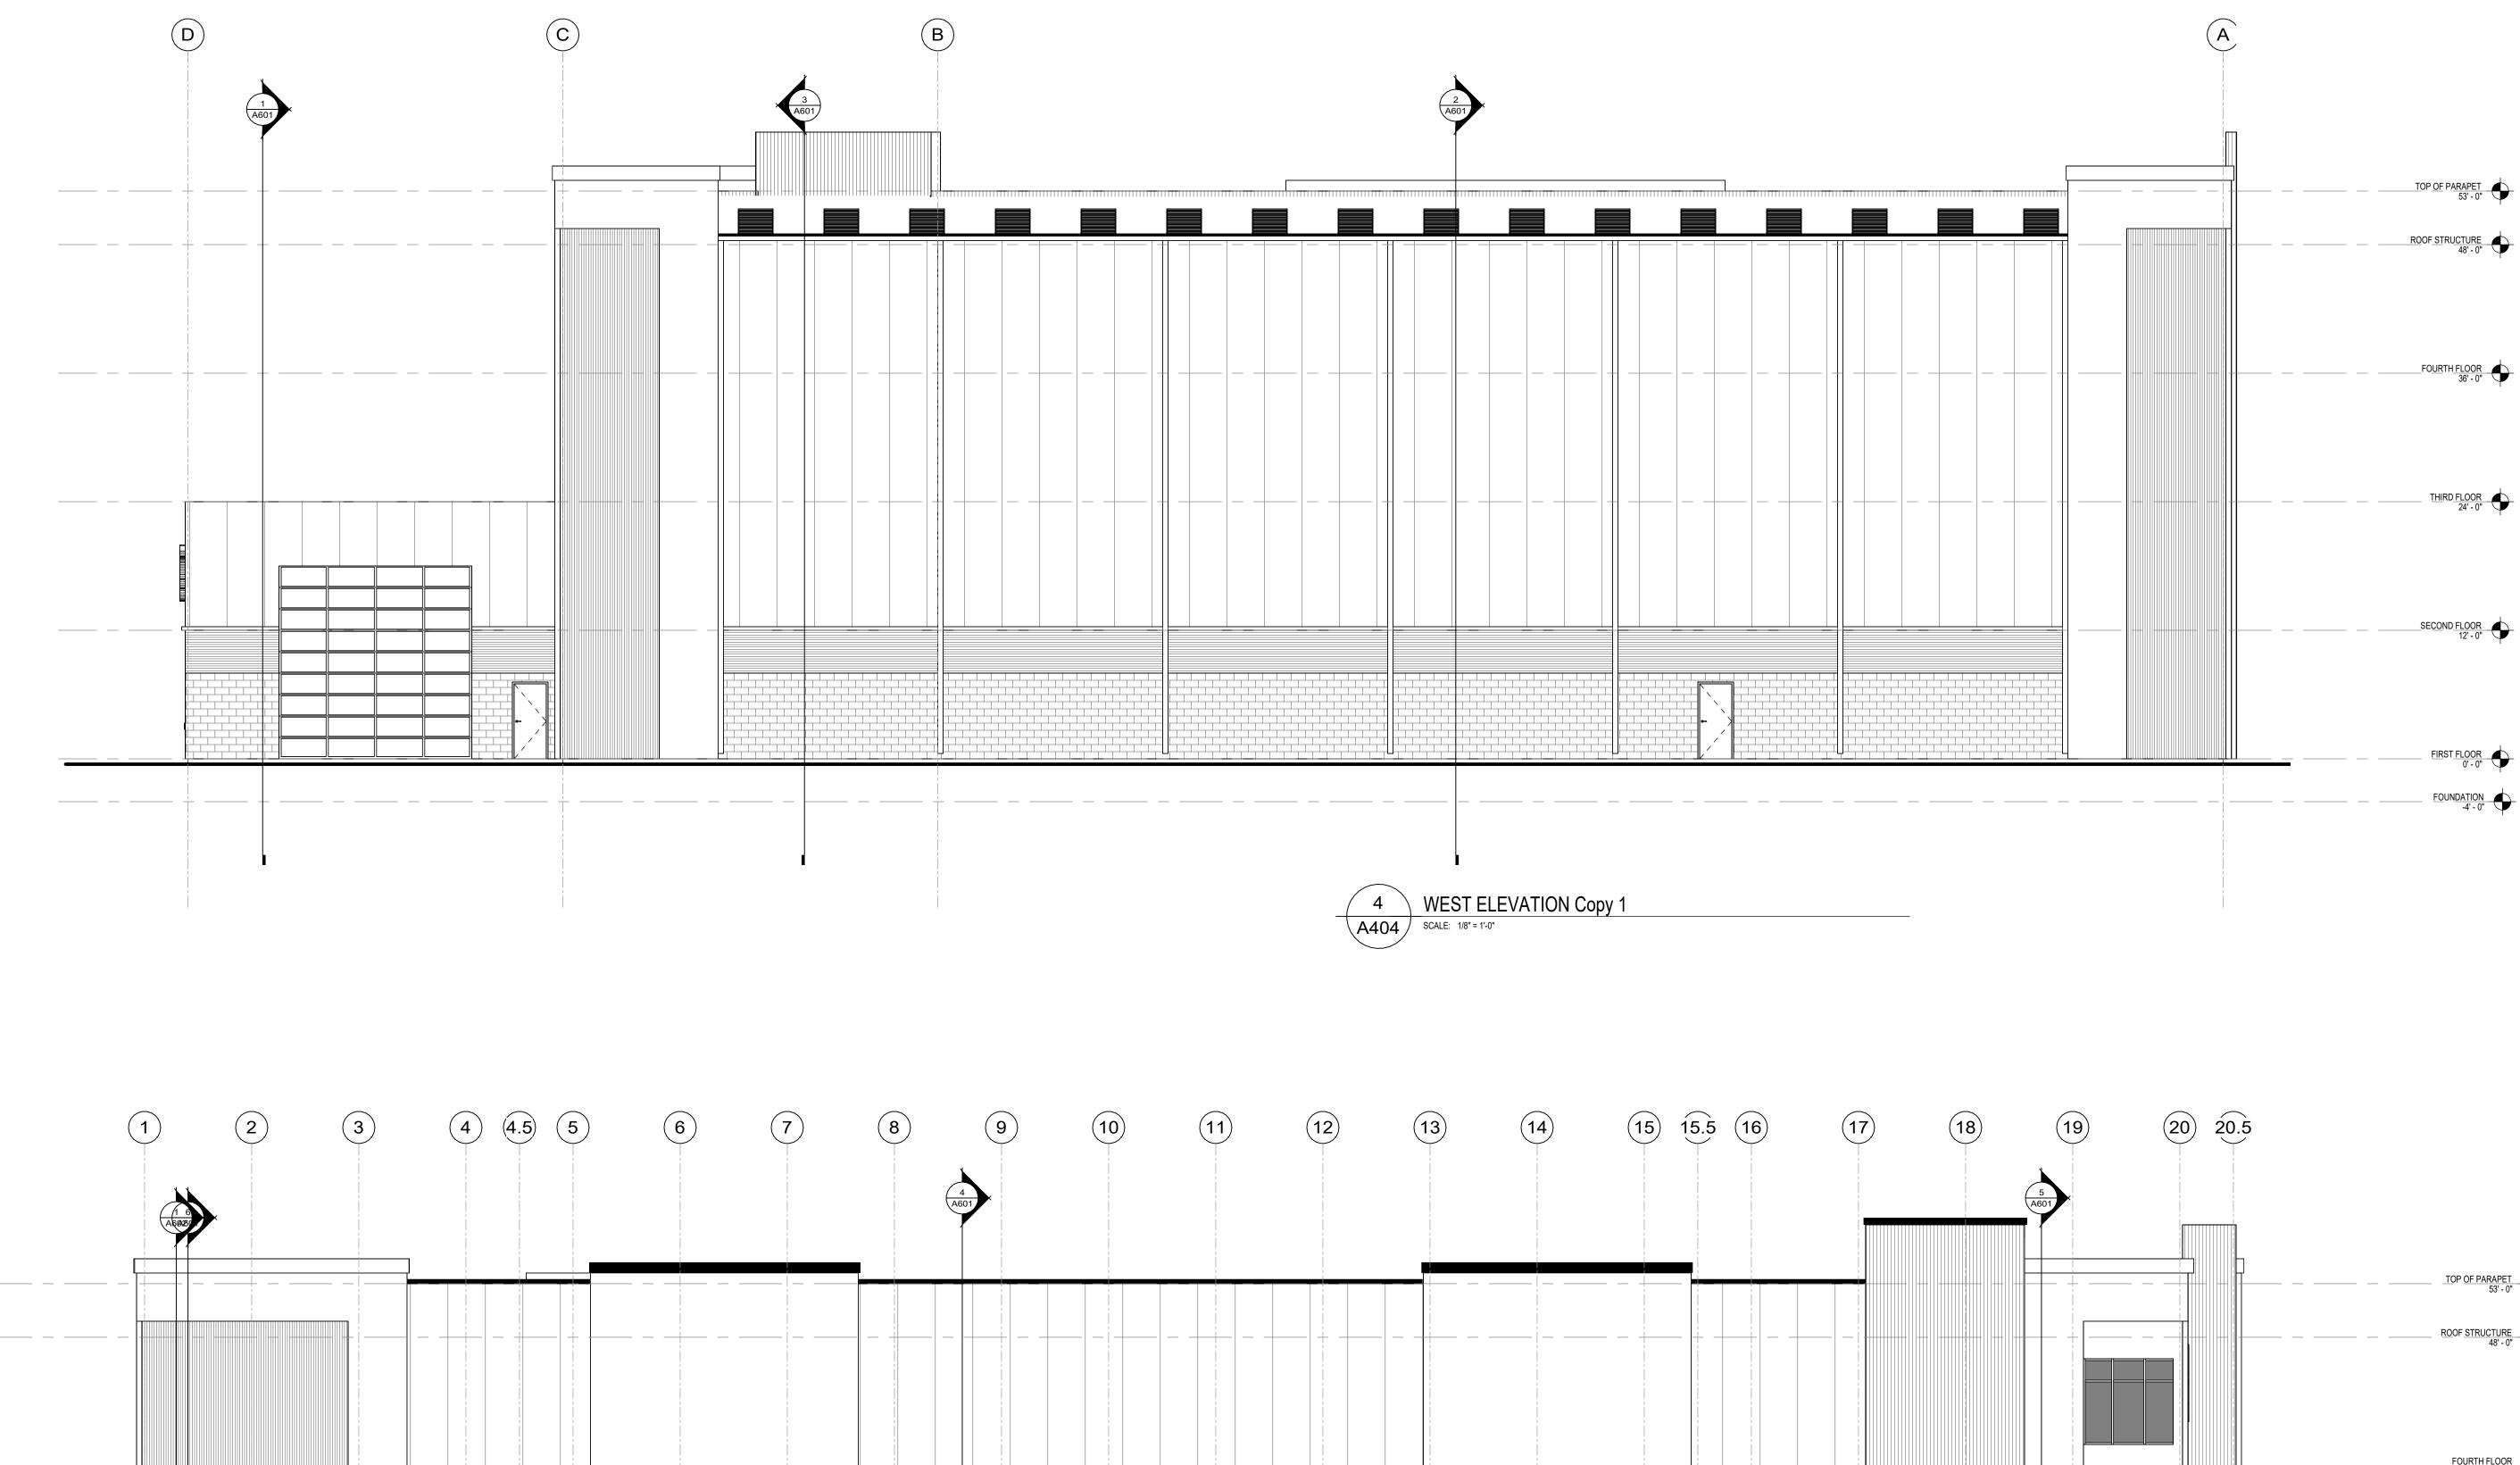

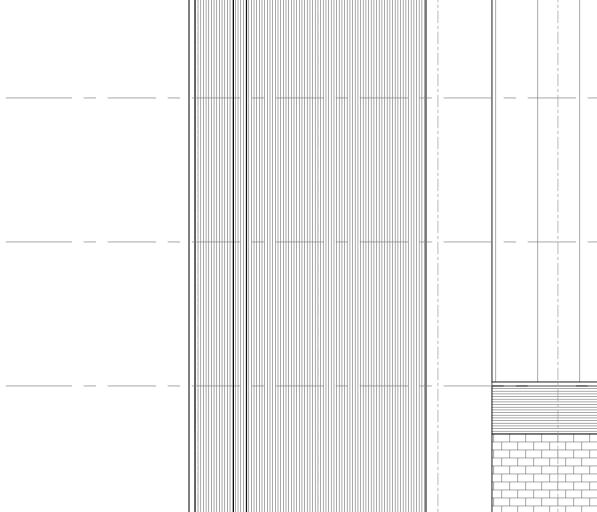

\_\_\_\_\_

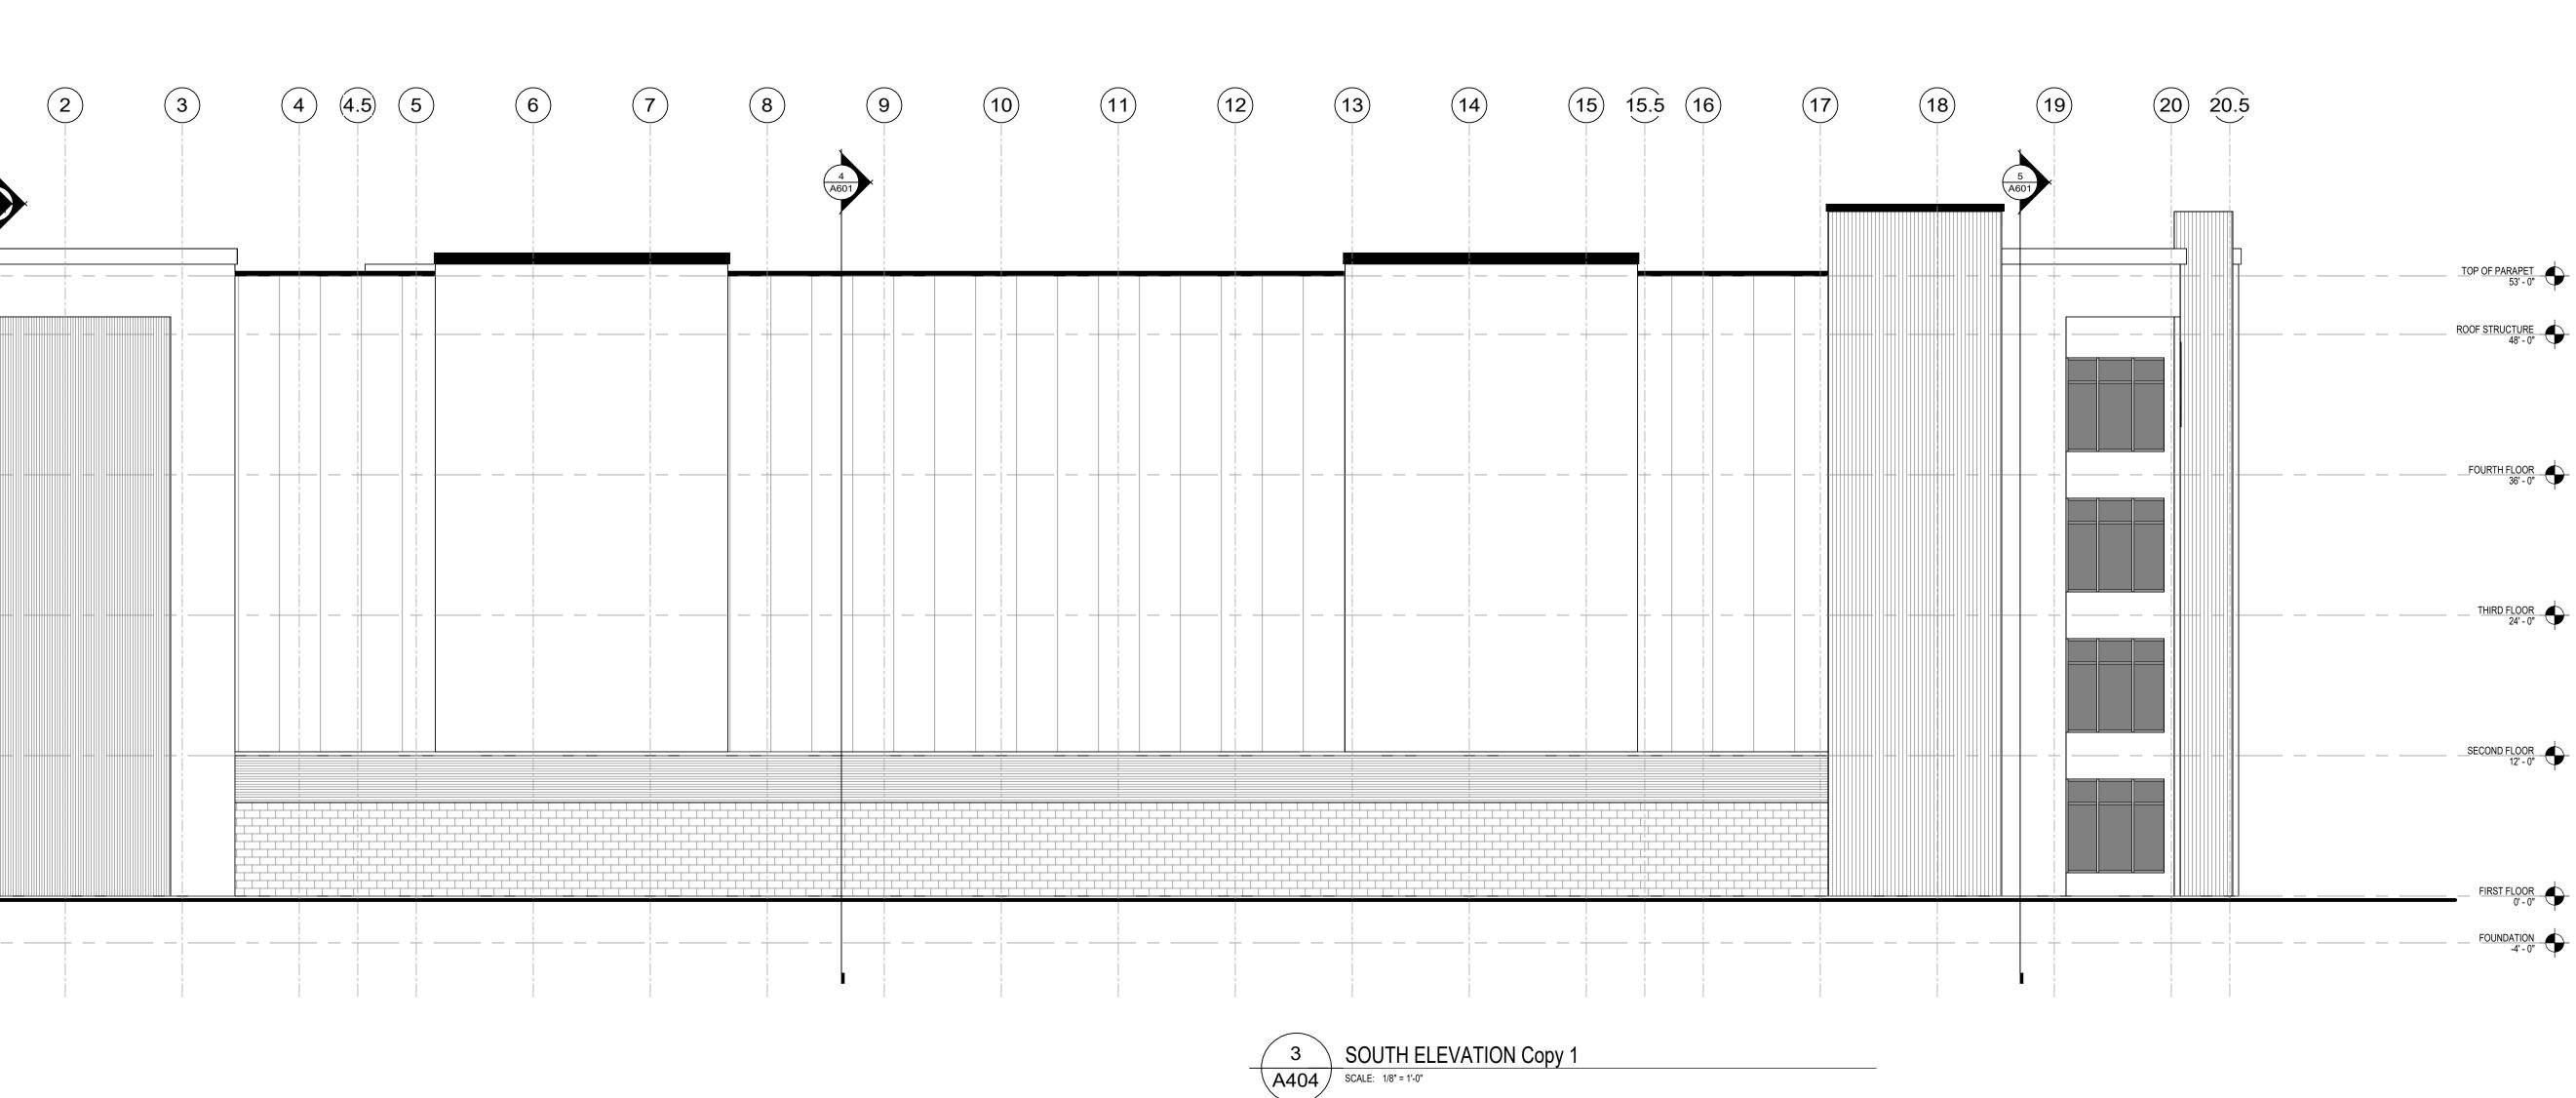

A	ANGUS-YOUNG ARCHITECTS/ENGINEERS	
	Janesville   Madison MADISON SQUARE	<u>.</u>
E.	STORAGE, LLC_	-
F	ENNSYLVANIA AVEN	IUE
	PENNSYLVANIA AVENUE STORAGE BUILDING	
	2230 Pennsylvania Ave Madison, WI 53704	
NO:	ISSUANCES / REVISIONS DESCRIPTION:	DATE:
NO:		
	DESCRIPTION:	
1/29/20 Du		ing may
1/29/20 Du	DESCRIPTION:	ing may on the mine d or or stored
1/29/20 Du	DESCRIPTION:	ing may on the mine d or or stored out prior
1/29/20 Du	DESCRIPTION:	ing may on the mine d or or stored out prior
1/29/20 Du	DESCRIPTION:	ing may on the mine d or or stored out prior
1/29/20 Du	DESCRIPTION:	ing may on the mine d or or stored out prior
1/29/20 Du	DESCRIPTION:	ing may on the mine d or or stored but prior
1/29/20 Du	DESCRIPTION:	ing may on the mine d or or stored but prior
1/29/20 Du	DESCRIPTION:	ing may on the mine d or or stored but prior



Northeast Corner | Main Entrance

2230 Pennsylvania Ave | Madison Square Storage

Δ		
Δ		
1	ANGUS-YOUNG	
	ARCHITECTS/ENGINEE	<u> </u>
	MADISON SQUARE	
	STORAGE, LLC	
	PENNSYLVANIA AVEN	
	STORAGE BUILDING	
	2230 Pennsylvania Ave	
	Madison, WI 53704	
	ISSUANCES / REVISIONS	
NO:	ISSUANCES / REVISIONS DESCRIPTION:	DATE:
NO:		
NO:		
	DESCRIPTION:	
1/29/2C Du	DESCRIPTION:	ing may
	DESCRIPTION:	ing may on the mine d or or stored
	DESCRIPTION:	ing may on the mine d or or stored out prior
	DESCRIPTION:	ing may on the mine d or or stored out prior
# Southeast Corner

2230 Pennsylvania Ave | Madison Square Storage

Sheet Size: 30" x 42" (Arch E1)

[		
ANGUS-YOUNG ARCHITECTS/ENGINEERS		
Janesville   Madison		
MADISON SQUARE STORAGE, LLC		
PENNSYLVANIA AVEN STORAGE BUILDINI		
2230 Pennsylvania Ave Madison, WI 53704		
ISSUANCES / REVISIONS		
NO: DESCRIPTION:	DATE:	
1/29/2024 11:41:10 AM		
1/29/2024 11:41:10 AM Due to electronic distribution, this drawing may not be printed to the scale indicated on the drawings. Do NOT use scale to determine dimensions or sizes.		
dimensions or sizes. No part of this drawing may be use reproduced in any form or by any means in a database or retrieval system, witho	rmine d or , or stored	
dimensions or sizes. No part of this drawing may be use reproduced in any form or by any means	rmine d or , or stored out prior IC.	
dimensions or sizes. No part of this drawing may be use reproduced in any form or by any means in a database or retrieval system, witho written permission of. ANGUS - YOUNG ASSOCIATES, IN	rmine d or , or stored out prior IC.	
dimensions or sizes. No part of this drawing may be use reproduced in any form or by any means in a database or retrieval system, witho written permission of. ANGUS - YOUNG ASSOCIATES, IN Copyright © 2023 All Rights Reser PROJECT NUMBER	rmine d or , or stored out prior IC.	
dimensions or sizes. No part of this drawing may be use reproduced in any form or by any means in a database or retrieval system, witho written permission of. ANGUS - YOUNG ASSOCIATES, IN Copyright © 2023 All Rights Reser PROJECT NUMBER 76850 APPROVED BY	rmine d or , or stored out prior IC.	
dimensions or sizes. No part of this drawing may be use reproduced in any form or by any means in a database or retrieval system, witho written permission of. ANGUS - YOUNG ASSOCIATES, IN Copyright © 2023 All Rights Reser PROJECT NUMBER 76850 APPROVED BY AYA REVIEWED BY	rmine d or , or stored out prior IC.	
dimensions or sizes. No part of this drawing may be use reproduced in any form or by any means in a database or retrieval system, witho written permission of. ANGUS - YOUNG ASSOCIATES, IN Copyright © 2023 All Rights Reser PROJECT NUMBER 76850 APPROVED BY AYA REVIEWED BY AYA DRAWN BY	rmine d or , or stored out prior IC.	
dimensions or sizes. No part of this drawing may be use reproduced in any form or by any means in a database or retrieval system, witho written permission of. ANGUS - YOUNG ASSOCIATES, IN Copyright © 2023 All Rights Reser PROJECT NUMBER 76850 APPROVED BY AYA REVIEWED BY AYA DRAWN BY Author	rmine d or , or stored out prior IC.	



Northwest Corner | Back of Loading Zone

2230 Pennsylvania Ave | Madison Square Storage

Sheet Size: 30" x 42" (Arch E1)

A	ANGUS-YOUNG ARCHITECTS/ENGINEERS	
	Janesville   Madison	
	MADISON SQUARE STORAGE, LLC	-
F	ENNSYLVANIA AVEN STORAGE BUILDING	
	2230 Pennsylvania Ave Madison, WI 53704	
	ISSUANCES / REVISIONS	
NO:	ISSUANCES / REVISIONS DESCRIPTION:	DATE:
NO:	-	DATE:
NO:	-	
NO:	-	DATE:
NO:	-	
NO:	-	
1/29/20 Du	DESCRIPTION:	ing may on the rmine
1/29/20 Du	DESCRIPTION:	ing may on the rmine d or or stored
1/29/20 Du	DESCRIPTION:	ing may on the mine d or or stored out prior
1/29/20 Du	DESCRIPTION:	ing may on the mine d or or stored out prior
1/29/20 Du	DESCRIPTION:	ing may on the mine d or or stored out prior
1/29/20 Du	DESCRIPTION:	ing may on the mine d or or stored out prior
1/29/20 Du	DESCRIPTION:	ing may on the mine d or or stored out prior
1/29/20 Du	DESCRIPTION:	ing may on the mine d or or stored out prior
1/29/20 Du	DESCRIPTION:	ing may on the mine d or or stored out prior



Southwest Corner | Back

2230 Pennsylvania Ave | Madison Square Storage

Sheet Size: 30" x 42" (Arch E1)

ARCHITECTS/ENGINEERS Janesville   Madison MADISON SQUARE STORAGE, LLC  PENNSYLVANIA AVENUE STORAGE BUILDING 2230 Pennsylvania Ave Madison, WI 53704  2330 Pennsylvania Ave Madison, WI 53704   SUBARCES / REVISIONE  SUBARCES / REVISIONE  SUBARCES / REVISIONE  SUBARCES / REVISIONE  NO PERSONAL  SUBARCES / REVISIONE  NO PERSONAL  SUBARCES / REVISIONE  NO PERSONAL  SUBARCES / REVISIONE  SUBARCES / R			
STORAGE, LLC  PENNSYLVANIA AVENUE STORAGE BUILDING  2230 Pennsylvania Ave Madison, WI 53704   SUBARCES / REVISIONS  SUBARCES / REVIS	ARCHITECTS/ENGINEERS		
SUBJECT SUBJEC			
SSUACES / REVISIONS         NO:       DESCRIPTION:         DA       DATE:         NO:       DESCRIPTION:         DA       DATE:         ID       DATE:			
ISSUANCES / REVISIONS         NO:       DESCRIPTION:       DATE:         MO:       DESCRIPTION:       DESCRIPTION:			
NO:       DESCRIPTION:       DATE:	Madison, WI 53704		
NO:       DESCRIPTION:       DATE:			
Image: Second			
Due to electronic distribution, this drawing may not be printed to the scale indicated on the drawings. Do NOT use scale to determine dimensions or sizes. No part of this drawing may be used or reproduced in any form or by any means, or stored in a database or retrieval system, without prior written permission of. ANGUS - YOUNG ASSOCIATES, INC. Copyright © 2023 All Rights Reserved PROJECT NUMBER 76850 APPROVED BY	NO: DESCRIPTION:	DATE:	
Due to electronic distribution, this drawing may not be printed to the scale indicated on the drawings. Do NOT use scale to determine dimensions or sizes. No part of this drawing may be used or reproduced in any form or by any means, or stored in a database or retrieval system, without prior written permission of. ANGUS - YOUNG ASSOCIATES, INC. Copyright © 2023 All Rights Reserved PROJECT NUMBER 76850 APPROVED BY			
Due to electronic distribution, this drawing may not be printed to the scale indicated on the drawings. Do NOT use scale to determine dimensions or sizes. No part of this drawing may be used or reproduced in any form or by any means, or stored in a database or retrieval system, without prior written permission of. ANGUS - YOUNG ASSOCIATES, INC. Copyright © 2023 All Rights Reserved PROJECT NUMBER 76850 APPROVED BY			
Due to electronic distribution, this drawing may not be printed to the scale indicated on the drawings. Do NOT use scale to determine dimensions or sizes. No part of this drawing may be used or reproduced in any form or by any means, or stored in a database or retrieval system, without prior written permission of. ANGUS - YOUNG ASSOCIATES, INC. Copyright © 2023 All Rights Reserved PROJECT NUMBER 76850 APPROVED BY			
not be printed to the scale indicated on the drawings. Do NOT use scale to determine dimensions or sizes. No part of this drawing may be used or reproduced in any form or by any means, or stored in a database or retrieval system, without prior written permission of. ANGUS - YOUNG ASSOCIATES, INC. Copyright © 2023 All Rights Reserved PROJECT NUMBER 76850 APPROVED BY	1/29/2024 11:41:10 AM		
reproduced in any form or by any means, or stored in a database or retrieval system, without prior written permission of. ANGUS - YOUNG ASSOCIATES, INC. Copyright © 2023 All Rights Reserved PROJECT NUMBER 76850 APPROVED BY	Due to electronic distribution, this drawing may not be printed to the scale indicated on the drawings. Do NOT use scale to determine		
ANGUS - YOUNG ASSOCIATES, INC. Copyright © 2023 All Rights Reserved PROJECT NUMBER 76850 APPROVED BY	No part of this drawing may be used or reproduced in any form or by any means, or stored in a database or retrieval system, without prior		
76850 APPROVED BY	ANGUS - YOUNG ASSOCIATES, INC. Copyright © 2023 All Rights Reserved		
	76850		
REVIEWED BY	AYA		
AYA DRAWN BY			
Author RENDERS 4			