

SITE INDEX SHEET SITE C-1.1 C-1.2 SITE PLAN FIRE DEPARTMENT ACCESS PLAN C-1.0 C-2.0 C-3.0 EXISTING CONDITIONS PLAN GRADING AND EROSION CONTROL PLAN UTILITY PLAN LANDSCAPE PLAN ARCHITECTURAL A-PI.0 A-1.0 A-1.1 A-1.2 A-1.3 A-1.4 LOWER FLOOR PLAN
UPPER FLOOR PLAN
FIRST FLOOR PLAN
SECOND - FOURTH FLOOR PLAN
FIFTH FLOOR PLAN
LOFT FLOOR PLAN A-2.1 A-2.2 A-2.3 ELEVATIONS ELEVATIONS ELEVATIONS

knothe • bruce Phone: 7601 University Ave, Ste 201 608.836.3690 Middleton, Wi 53562 KEY PLAN

SITE DEVELOPMENT STATISTICS
LOT AREA
U4,780 S.F./0.34 ACRES
DWELLING UNITS
LOT AREA/ D.J.
JOZ S.F./D.J.
DENSITY
BUILDING HEIGHT
6 STORIES GROSS FLOOR AREA 43,345 S.F. (excluding underground parking) FLOOR AREA RATIO 2.93 UNIT MIX EFFICIENCY VEHICLE PARKING SURFACE SURFACE 0 UNDERGROUND 43 (42 + I COMMUNITY CAR) TOTAL 43 BIKE PARKING
FLOOR STALL, SURFACE 4
WALL HUNG, UNDERGROUND 5
FLOOR STALL, UNDERGROUND 44 TOTAL USEABLE OPEN SPACE SEE SHEET C-1.3 FOR OPEN SPACE

Land Use Application - February 19, 2014

ISSUED

Revised - Month Day, Year Revised - Month Day, Year PROJECT TITLE **WEBSTER ST**

17, 19 & 25 N Webster St. and 201 E Mifflin St. SHEET TITLE SITE PLAN


SHEET NUMBER

PROJECT NO. 1315


© 2013 Knothe & Bruce Architects, LLC


25-26

SITE PLAN

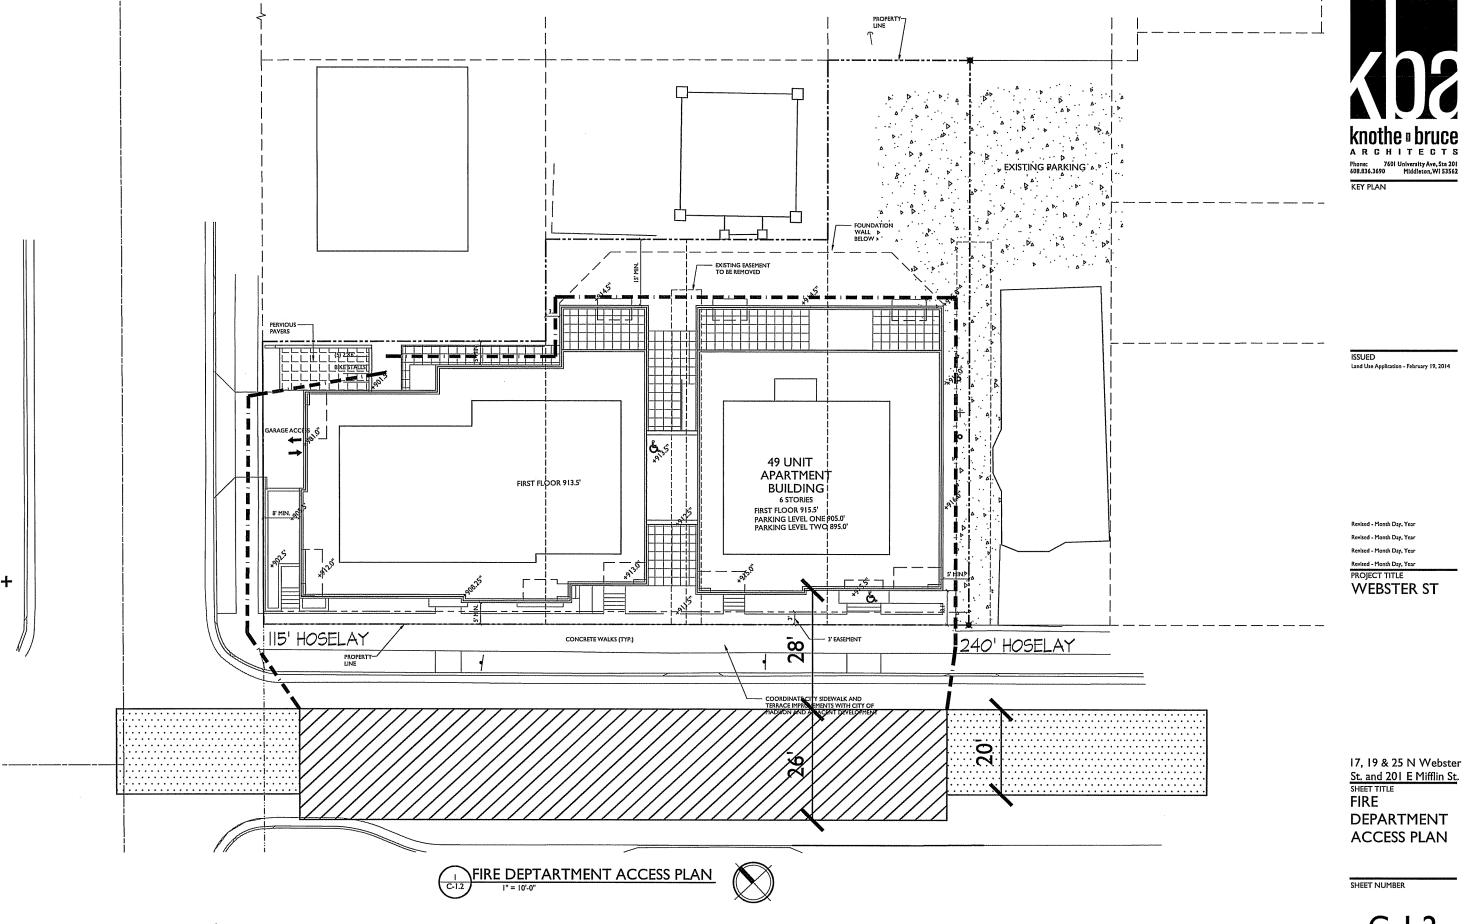

C-1.2

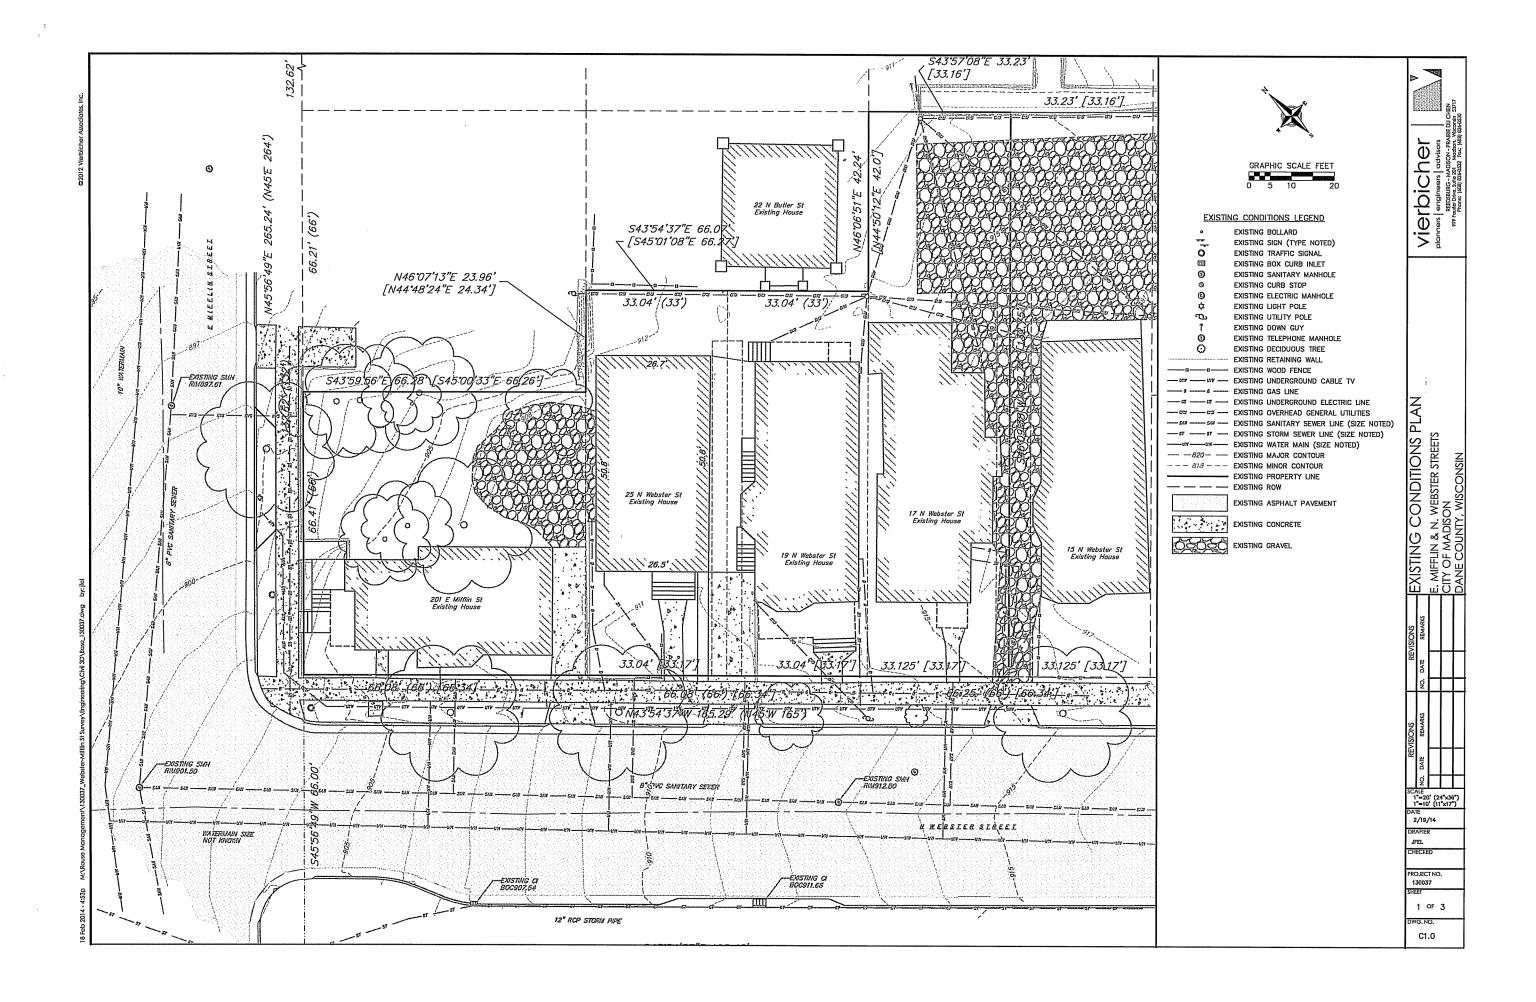

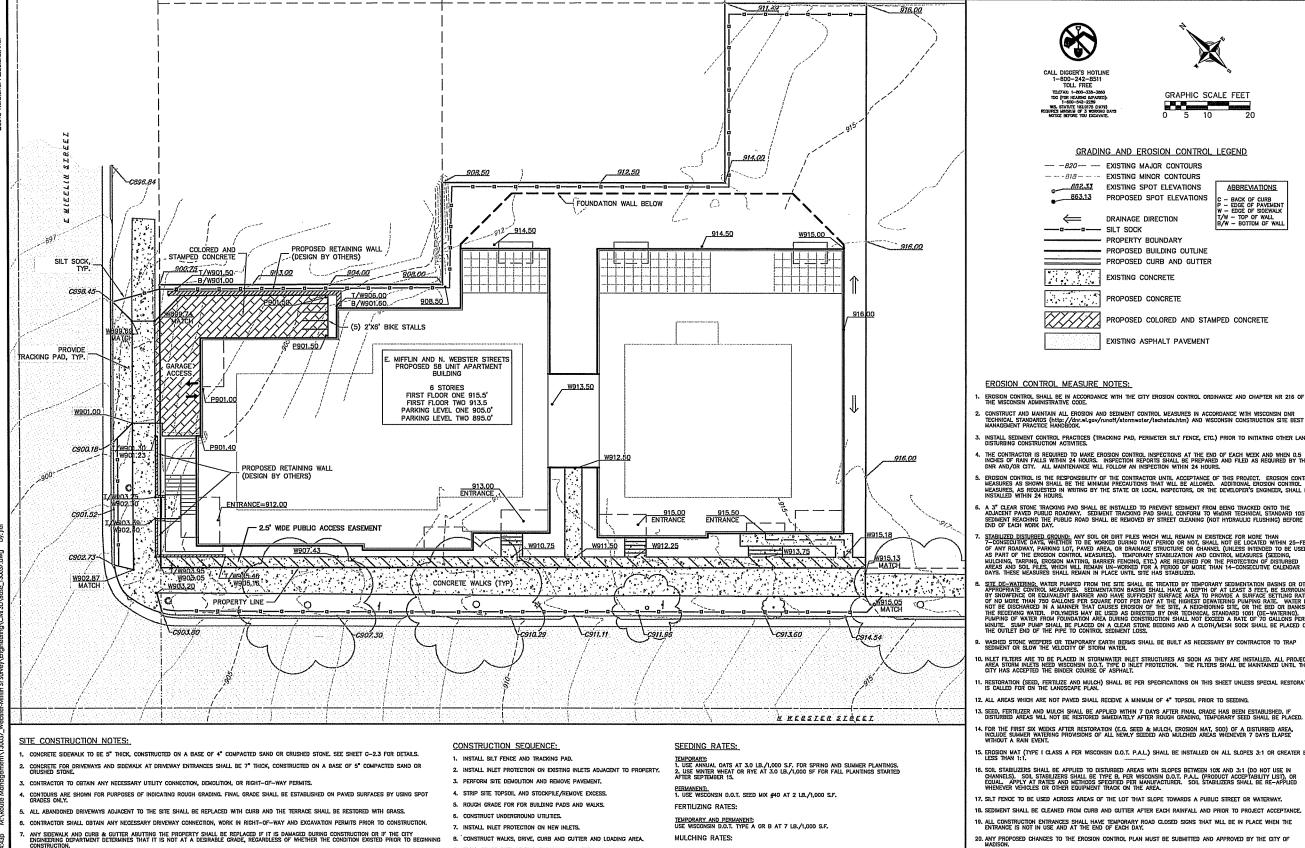

8. CONSTRUCT WALKS, DRIVE, CURB AND GUTTER AND LOADING AREA.

9. FINAL GRADE SITE, INSTALL TOPSOIL, SEED, FERTILIZER AND MULCH,


10. REMOVE SILT FENCE AFTER DISTURBED AREAS ARE RESTORED.

I. PUBLIC RIGHT-OF-WAY IMPROVEMENTS TO BE CONSTRUCTED PER CITY OF MADISON PLANS (PROJECT 5382364).

9. ALL WORK IN THE PUBLIC RIGHT-OF-WAY SHALL BE PERFORMED BY A CITY-LICENSED CONTRACTOR.



GRADING AND EROSION CONTROL LEGEND

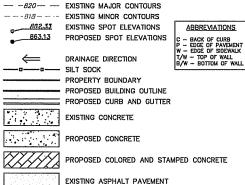

- EROSION CONTROL SHALL BE IN ACCORDANCE WITH THE CITY EROSION CONTROL ORDINANCE AND CHAPTER NR 216 OF THE WISCONSIN ADMINISTRATIVE CODE.
- CONSTRUCT AND MAINTAIN ALL EROSION AND SEDIMENT CONTROL MEASURES IN ACCORDANCE WITH WISCONSIN DNR TECHNICAL STANDARDS (http://dnrwl.gov/runoff/stormwoter/techstds.htm) AND WISCONSIN CONSTRUCTION SITE BEST MANAGEMENT PRACTICE HANDBOOK.
- INSTALL SEDIMENT CONTROL PRACTICES (TRACKING PAD, PERIMETER SILT FENCE, ETC.) PRIOR TO INITIATING OTHER LAND DISTURBING CONSTRUCTION ACTIVITIES.
- . THE CONTRACTOR IS REQUIRED TO MAKE EROSION CONTROL INSPECTIONS AT THE END OF EACH WEEK AND WHEN 0.5 INCHES OF RAIN FALLS WITHIN 24 HOURS. INSPECTION REPORTS SHALL BE PREPARED AND FILED AS REQUIRED BY THE DNR AND/OR CITY. ALL MAINTENANCE WILL FOLLOW AN INSPECTION WITHIN 24 HOURS.
- EROSION CONTROL IS THE RESPONSIBILITY OF THE CONTRACTOR UNTIL ACCEPTANCE OF THIS PROJECT. EROSION CONTROL MEASURES AS SHOWN SHALL BE THE MINIMUM PRECAUTIONS THAT WILL BE ALLOWED. ADDITIONAL EROSION CONTROL MEASURES, AS REQUESTED IN WRITING BY THE STATE OR LOCAL INSPECTORS, OR THE DEVELOPER'S ENGINEER, SHALL BE INSTALLED WITHIN 24 HOURS.
- B. A 3" CLEAR STONE TRACKING PAD SHALL BE INSTALLED TO PREVENT SEDIMENT FROM BEING TRACKED ONTO THE ADJACENT PAYED PUBLIC ROODWAY. SEDIMENT TRACKING PAD SHALL CONFORM TO WHOM TECHNICAL STANDARD 1057, SEDIMENT REACHING THE PUBLIC ROAD SHALL BE REMOVED BY STREET CLEANING (NOT HYDRAULIC FLUSHING) BEFORE THE END OF EACH WORK DAY.
- . STABILIZED DISTURBED GROUND: ANY SOIL OR DIRT PILES WHICH WILL REMAIN IN EXISTENCE FOR MORE THAN 7-CONSECUTIVE DAYS, WHETHER TO BE WORKED DURING THAT PERIOD OR NOT, SHALL NOT BE LOCATED WITHIN 25-FEET OF ANY ROADWAY, PARKING LOT, PAKED AREA, OR DRAINAGE STRUCTURE OR CHAINACL (UNLESS INTENDED TO BE USED AS PART OF THE EROSION CONTROL MEASURES). TEMPORARY STRABLIZATION AND CONTROL MEASURES (SEEDING, MULCHING, TARRING, ENOSION MATTING, BARRINE FROM ETC.) ARE REQUIRED FOR THE PROTECTION OF DISTURBED AREAS AND SOIL HELS. WHICH MILE EMAIN UN-WORKED FOR A PERIOD OF MORE HAN 14-CONSECUTIVE CALENDAR DAYS, THESE MEASURES SHALL REMAIN IN PLACE UNITE. SHE HAS STRABLIZED.
- SITE DE-WATERING. WATER PUMPED FROM THE SITE SHALL BE TREATED BY TEMPORARY SEDIMENTATION BASINS OR OTHER APPROPRIATE CONTROL MEASURES. SEDIMENTATION BASINS SHALL HAVE A DEPTH OF AT LEAST 3 FEET, BE SURFRONDED BY SNOWFENCE OR EQUIVALENT BARRIER AND HAVE SUFFICIENT SURFACE AREA TO PROVIDE A SURFACE SETTLING RATE OF NO MORE THAN 750 CALLONS PER SQUARE FOOT PER DAY AT THE HIGHEST DEWATERING PUMPING RATE. WATER MAY NOT BE DISCHARED IN A MANNER THAT CAUSES ENGINGN OF THE SITE, A NEIGHBORNOS SITE, OR THE OR BANKS OF THE RECEIVING WATER. POLYMERS HAVE BE USED BY DIRT RECHINGLA, STANDARD 1001 (DE-WATERING). PUMPING OF WATER FROM FOUNDATION AREA DURING CONSTRUCTION STALL NOT EXCEED A RATE OF TO SHALL BE PLACED ON A CLEAR STONE BEDOING AND A CLOTH/MESH SOCK SHALL BE PLACED ON THE OTHER TEND OF THE FIFE TO CONTROL SEDIMENT LOCATION.
- WASHED STONE WEEPERS OR TEMPORARY EARTH BERMS SHALL BE BUILT AS NECESSARY BY CONTRACTOR TO TRAP SEDIMENT OR SLOW THE VELOCITY OF STORM WATER.
- 10. NLET FILTERS ARE TO BE PLACED IN STORMWATER INLET STRUCTURES AS SOON AS THEY ARE INSTALLED, ALL PROJECT AREA STORM INLETS NEED WISCONSN D.C.T. TYPE D INLET PROTECTION. THE FILTERS SHALL BE MAINTAINED UNTIL THE CITY HAS ACCEPTED THE BINDER COURSE OF ASPHALT.
- II. RESTORATION (SEED, FERTILIZE AND MULCH) SHALL BE PER SPECIFICATIONS ON THIS SHEET UNLESS SPECIAL RESTORATION IS CALLED FOR ON THE LANDSCAPE PLAN.
- 12. ALL AREAS WHICH ARE NOT PAVED SHALL RECEIVE A MINIMUM OF 4" TOPSOIL PRIOR TO SEEDING.
- 13. SEED, FERTILIZER AND MULCH SHALL BE APPLIED WITHIN 7 DAYS AFTER FINAL GRADE HAS BEEN ESTABLISHED. IF DISTURBED AREAS WILL NOT BE RESTORED IMMEDIATELY AFTER ROUGH GRADING, TEMPORARY SEED SHALL BE PLACED.
- 14. FOR THE FIRST SIX WEEKS AFTER RESTORATION (E.G. SEED & MULCH, EROSION MAT, SOD) OF A DISTURBED AREA, INCLIDE SUMMER WATERING PROVISIONS OF ALL NEWLY SEEDED AND MULCHED AREAS WHENEVER 7 DAYS ELAPSE WITHOUT A RAIN EVENT.
- 15. EROSION MAT (TYPE I CLASS A PER WISCONSIN D.O.T. P.A.L.) SHALL BE INSTALLED ON ALL SLOPES 3:1 OR GREATER BUT LESS THAN 1:1.
- 18. SOIL STABILIZERS SHALL BE APPLIED TO DISTURBED AREAS WITH SLOPES BETWEEN 10% AND 3:1 (DO NOT USE IN CHANNELS). SOIL STABILIZERS SHALL BE TYPE B. PER WISCONSIN D.O.T. P.A.L. (PRODUCT ACCEPTABILITY UST), OR EQUAL. APPLY AT RATES AND METHODS SPECIFIED PER MANUFACTURER. SOIL STABILIZERS SHALL BE RE-APPLIED WHENEVER VEHICLES OR OTHER EQUIPMENT TRACK ON THE AREA.
- 17. SILT FENCE TO BE USED ACROSS AREAS OF THE LOT THAT SLOPE TOWARDS A PUBLIC STREET OR WATERWAY.
- 19. ALL CONSTRUCTION ENTRANCES SHALL HAVE TEMPORARY ROAD CLOSED SIGNS THAT WILL BE IN PLACE WHEN THE ENTRANCE IS NOT IN USE AND AT THE END OF EACH DAY.
- 20. ANY PROPOSED CHANGES TO THE EROSION CONTROL PLAN MUST BE SUBMITTED AND APPROVED BY THE CITY OF MADISON.
- IEUPORARY AND PERMANENT.
 USE & TO 1-% STRAM OR HAY MULCH, CRIMPED PER SECTION 607.3.2.3, OR OTHER RATE AND METHOD PER SECTION 627, MISCONSN D.O.T. STANDARD SPECIFICATIONS FOR HIGHWAY AND STRUCTURE 21. THE CITY OF MADISON, OWNER AND/OR ENGINEER MAY REQUIRE ADDITIONAL EROSION CONTROL MEASURES AT ANY TIME DURING CONSTRUCTION. 22. IF THE TERRACE IN THE R/W IS TO BE DISTURBED, CONTRACTOR SHALL CONSIDER PLACING STONE/MULCH TO MINIMIZE RUNOFF.

her erbic

CONTROL

AND EROSION C

WEBSTER STREETS

SON

Y. WISCONSIN ADING A

IIFLIN & N. V

OF MADISC

VECOUNTY, E. MIFFLIN & CITY OF MA DANE COU


1"=20" (24"x36") 1"=40" (11"X17") 2/19/14


JFEL.

PROJECT NO. 130037

2 OF 3

C2.0

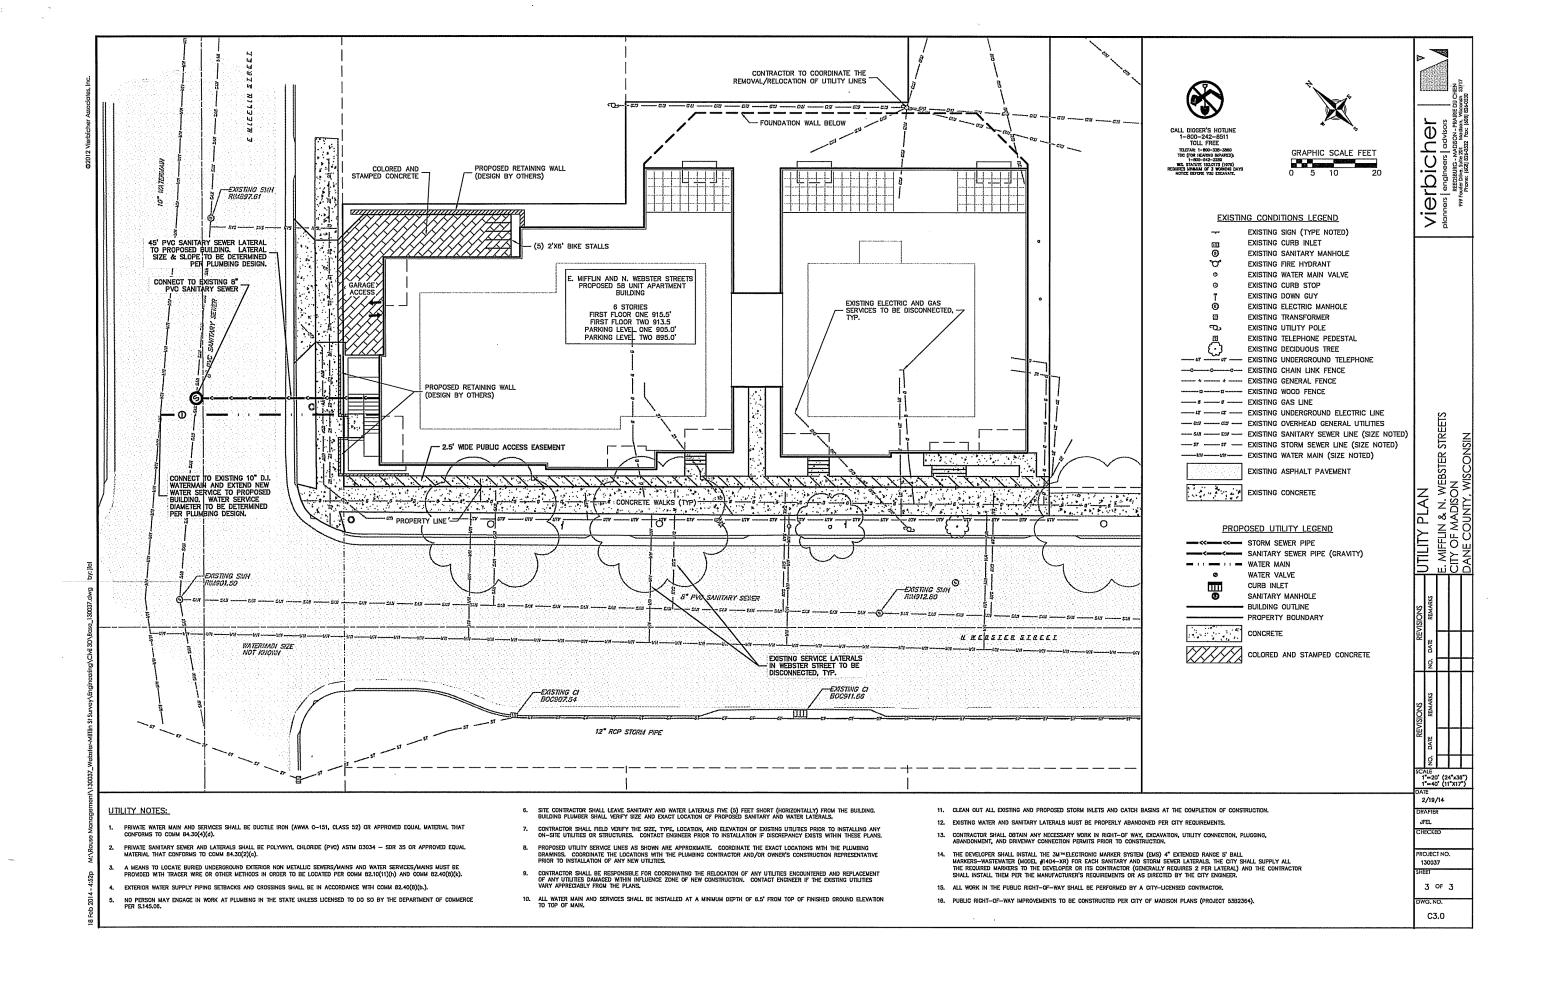

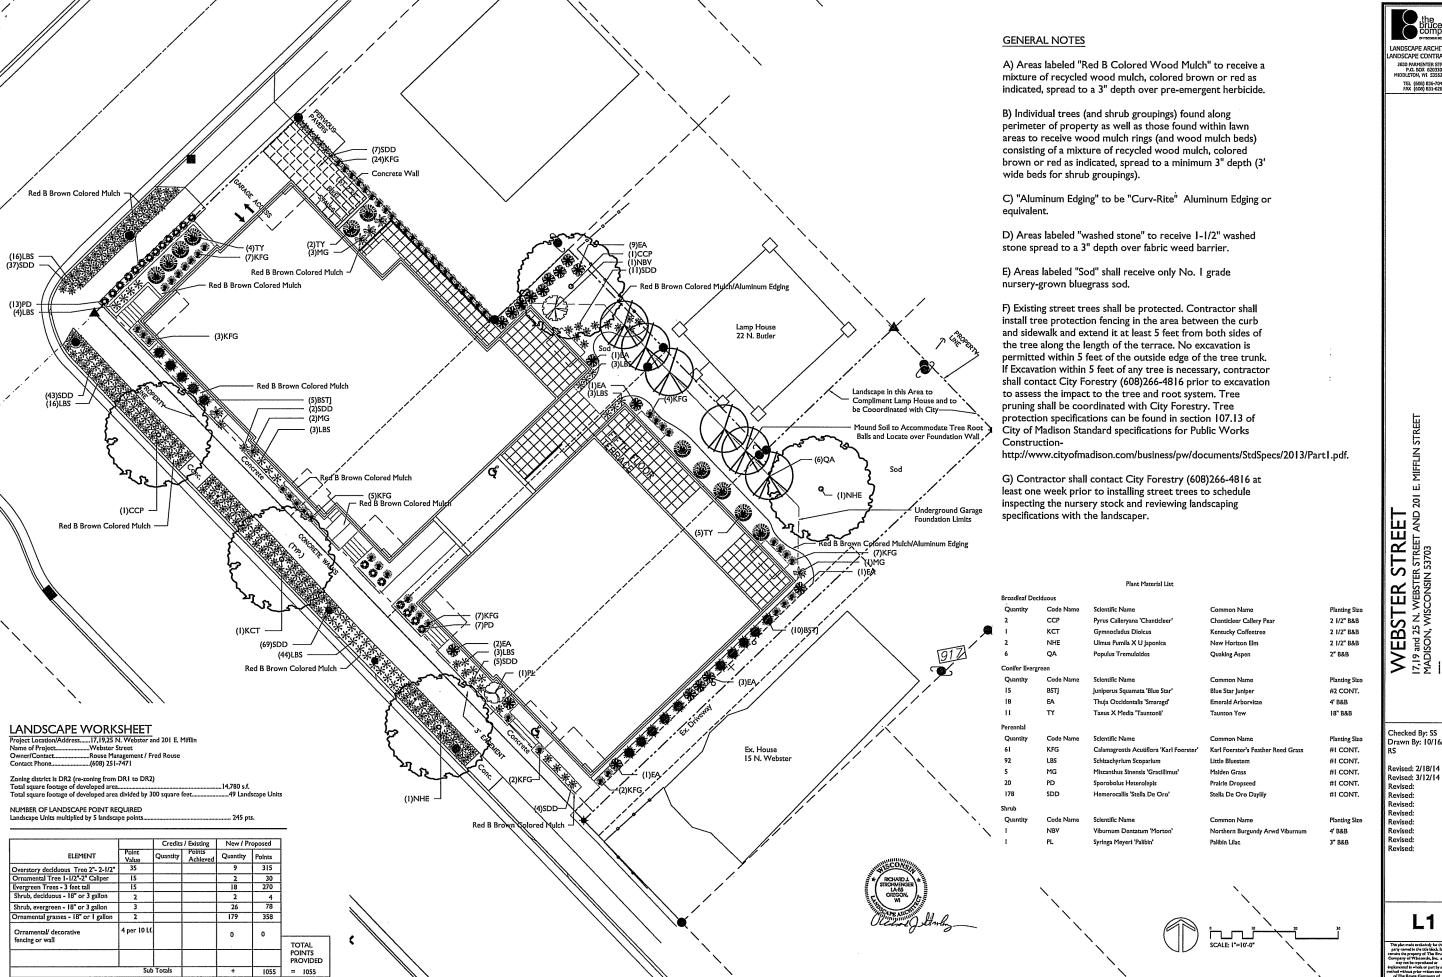


LANDSCAPE ARCHITECTS TEL (608) 836-7041 FAX (608) 831-6266

> **ET** AND 201 E. MIFELIN STREET STRE ËR

Checked By: SS Drawn By: 10/16/13

Revised: 2/18/14 RS Revised: 3/12/14 RS Revised: Revised: Revised:

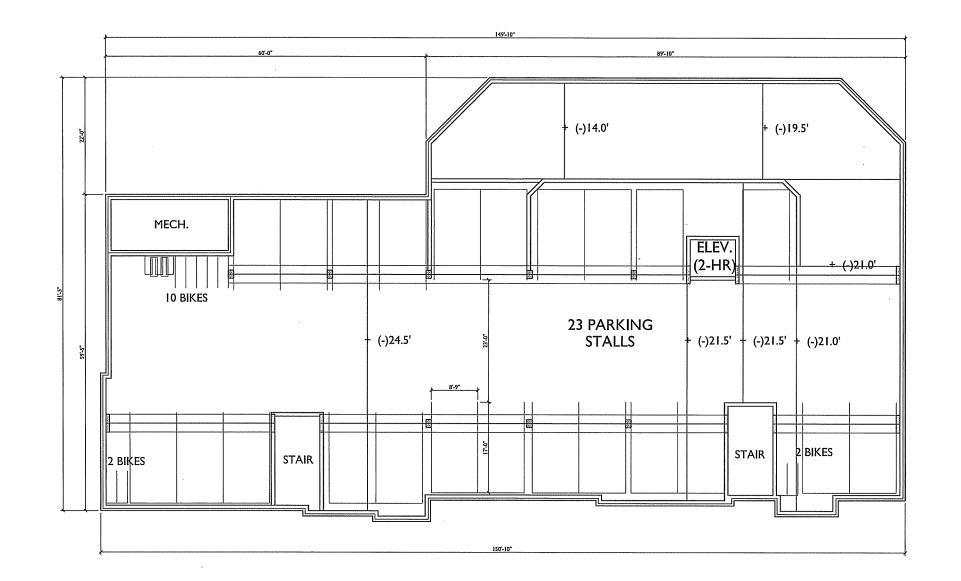








ISSUED
Land Use Application - February 19, 20

PROJECT TITLE
WEBSTER ST

17, 19 & 25 N Webster
St. and 201 E Mifflin St.
SHEET TITLE
LOWER LEVEL
PARKING PLAN

SHEET NUMBER

A-PI.0

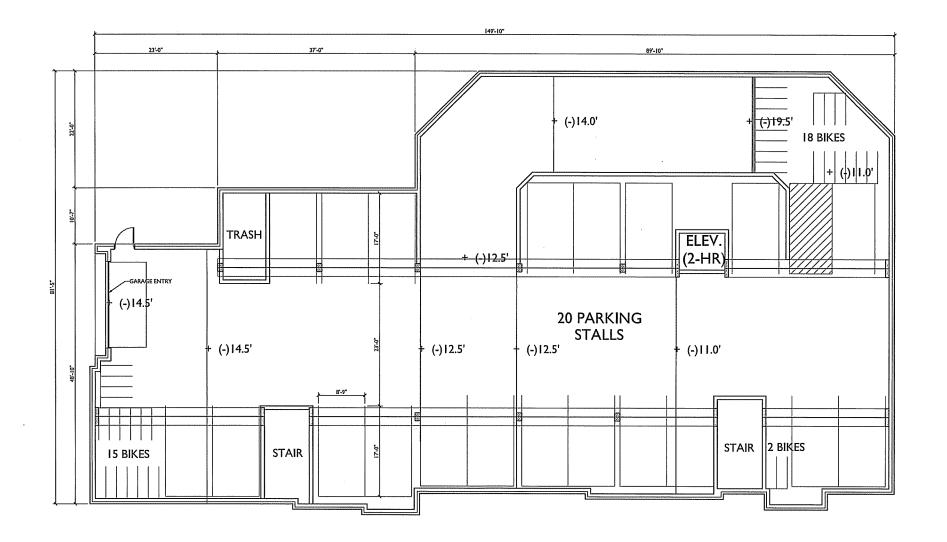



Land Use Application - February 19, 2014

PROJECT TITLE
WEBSTER ST

17, 19 & 25 N Webster
St. and 201 E Mifflin St.
SHEET TITLE
UPPER LEVEL
PARKING PLAN


SHEET NUMBER

A-1.0
PROJECT NO. 1315

© 2013 Knothe & Bruce Architects, LLC


UPPER LEVEL PARKING PLAN

SCALE: 1/8"=1'-0"

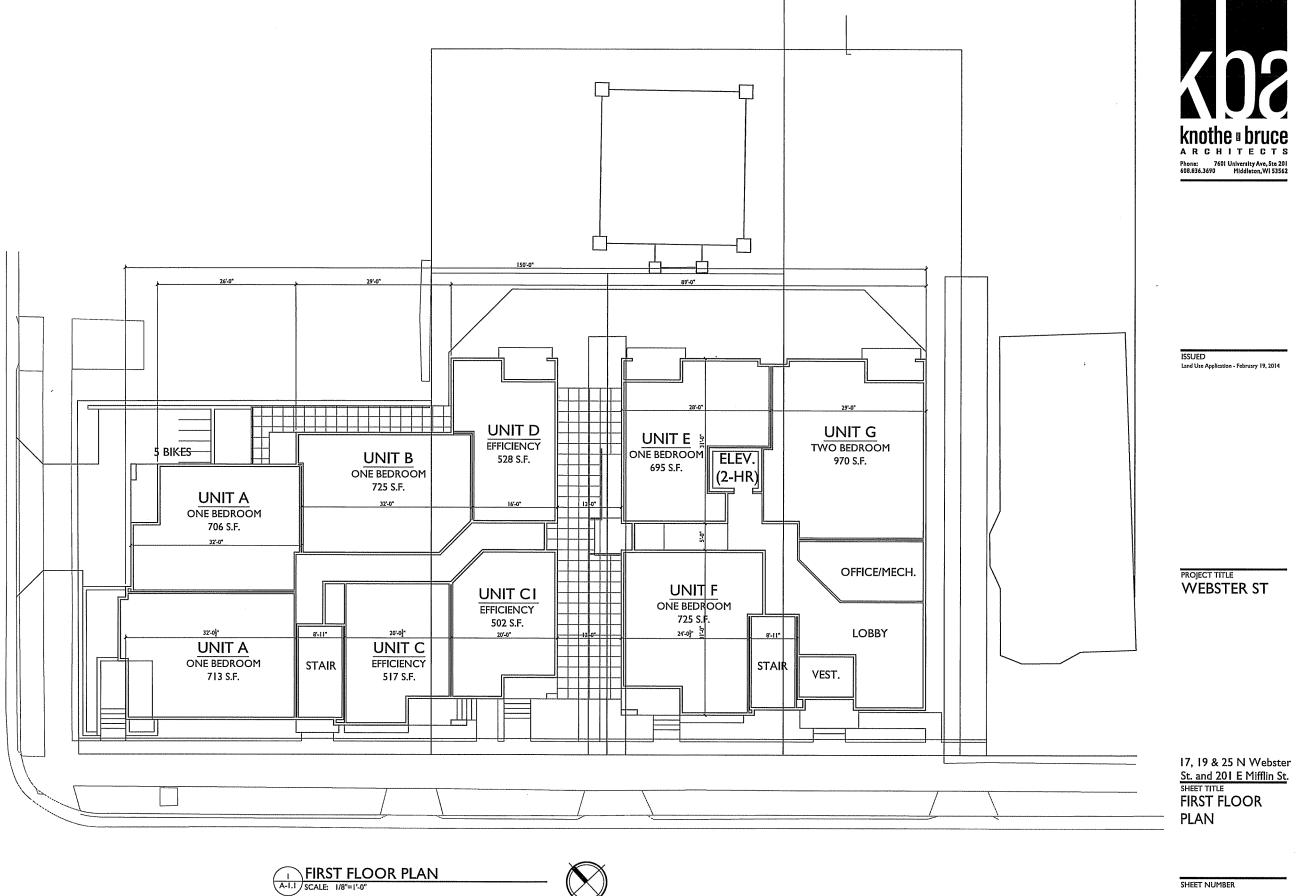



PROJECT NO. 1315 © 2013 Knothe & Bruce Architects, LLC

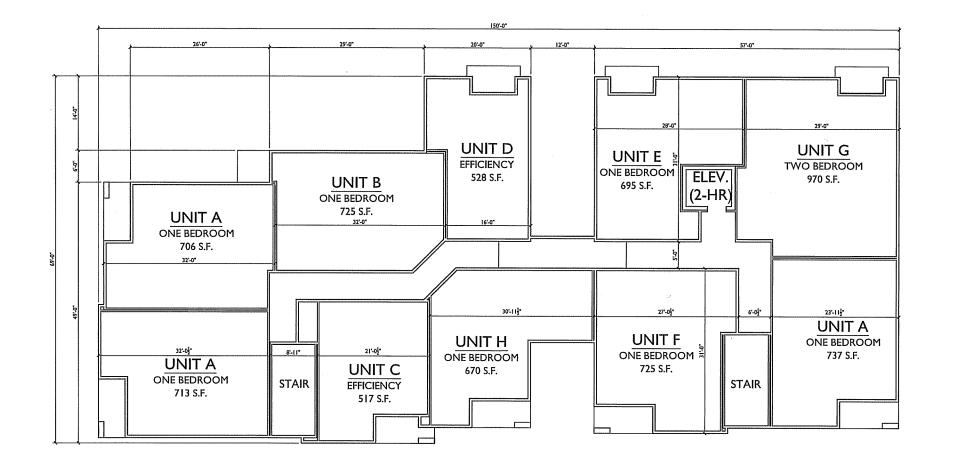




Land Use Application - February 19, 2014

PROJECT TITLE
WEBSTER ST


17, 19 & 25 N Webster
St. and 201 E Mifflin St.
SHEET TITLE
SECOND-FOURTH FLOOR PLAN

SHEET NUMBER

PROJECT NO. 1315 © 2013 Knothe & Bruce Architects, LLC

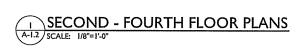



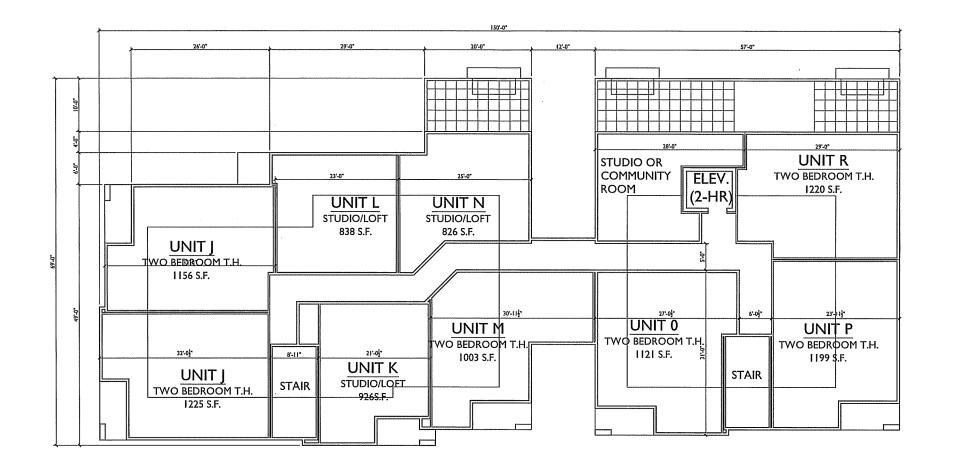



Land Use Application - February 19, 2014

PROJECT TITLE
WEBSTER ST


17, 19 & 25 N Webster
St. and 201 E Mifflin St.
SHEET TITLE
FIFTH FLOOR
PLAN

SHEET NUMBER

A-1.3





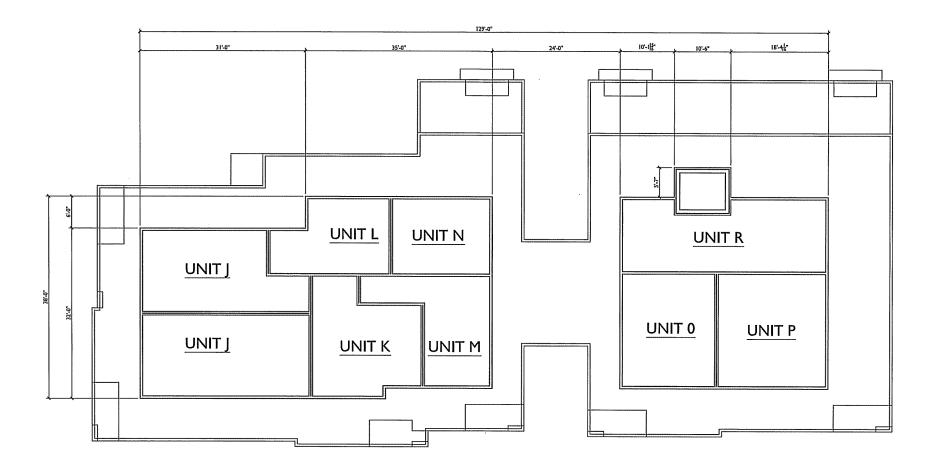

Land Use Application - February 19, 2014

PROJECT TITLE
WEBSTER ST

17, 19 & 25 N Webster
St. and 201 E Mifflin St.
SHEET TITLE
LOFT FLOOR
PLAN

SHEET NUMBER

A-1.4









Land Use Application - February 19, 2014

PROJECT TITLE
WEBSTER ST


17, 19 & 25 N Webster
St. and 201 E Mifflin St.
SHEET TITLE
ELEVATIONS

SHEET NUMBER

A-2.1





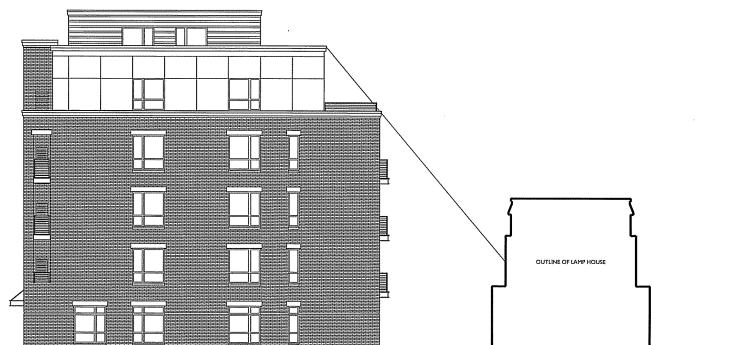





Land Use Application - February 19, 2014


PROJECT TITLE
WEBSTER ST

17, 19 & 25 N Webster
St. and 201 E Mifflin St.
SHEET TITLE
ELEVATIONS

SHEET NUMBER

A-2.2

PROJECT NO. 1315 O 2013 Knothe & Bruce Architects, LLC

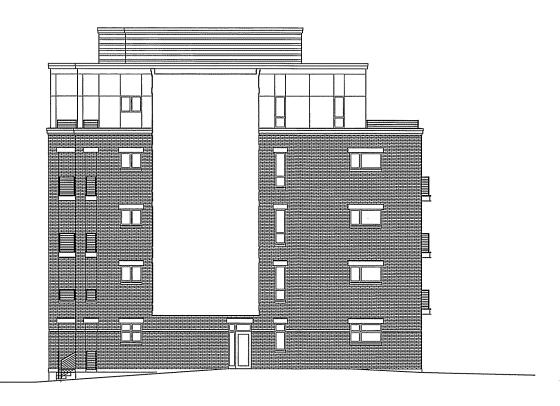

INTERIOR COURTYARD ELEVATION

A-2.3 SCALE: 1/8"=1'-0"



2 INTERIOR COURTYARD ELEVATION

A-2.3 SCALE: 1/8"=1'-0"




ISSUED Land Use Application - February 19, 2014

PROJECT TITLE
WEBSTER ST

17, 19 & 25 N Webster
St. and 201 E Mifflin St.
SHEET TITLE
ELEVATIONS


SHEET NUMBER

A-2.3

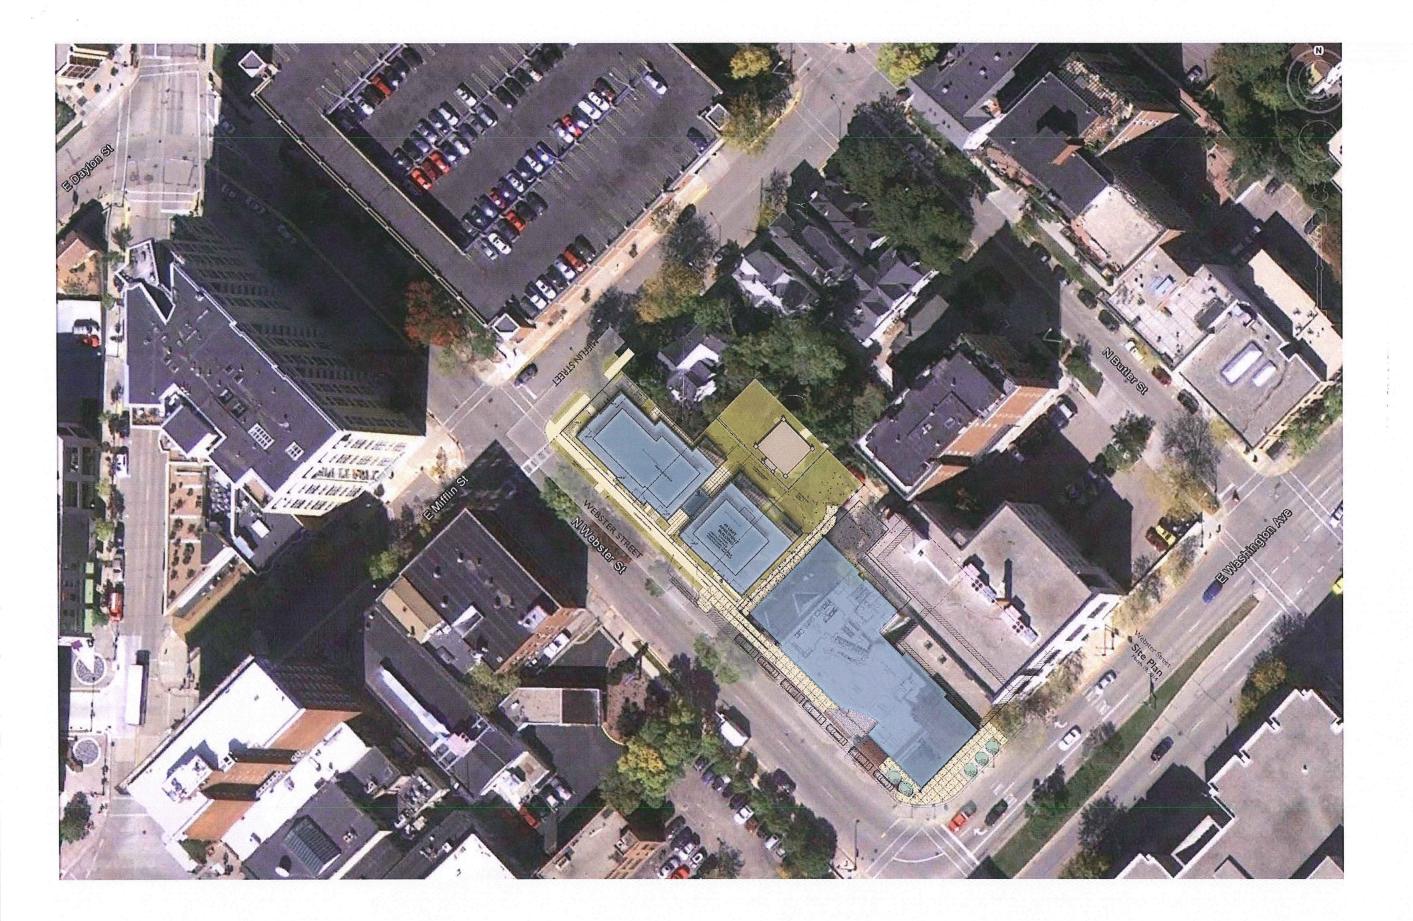


25.26



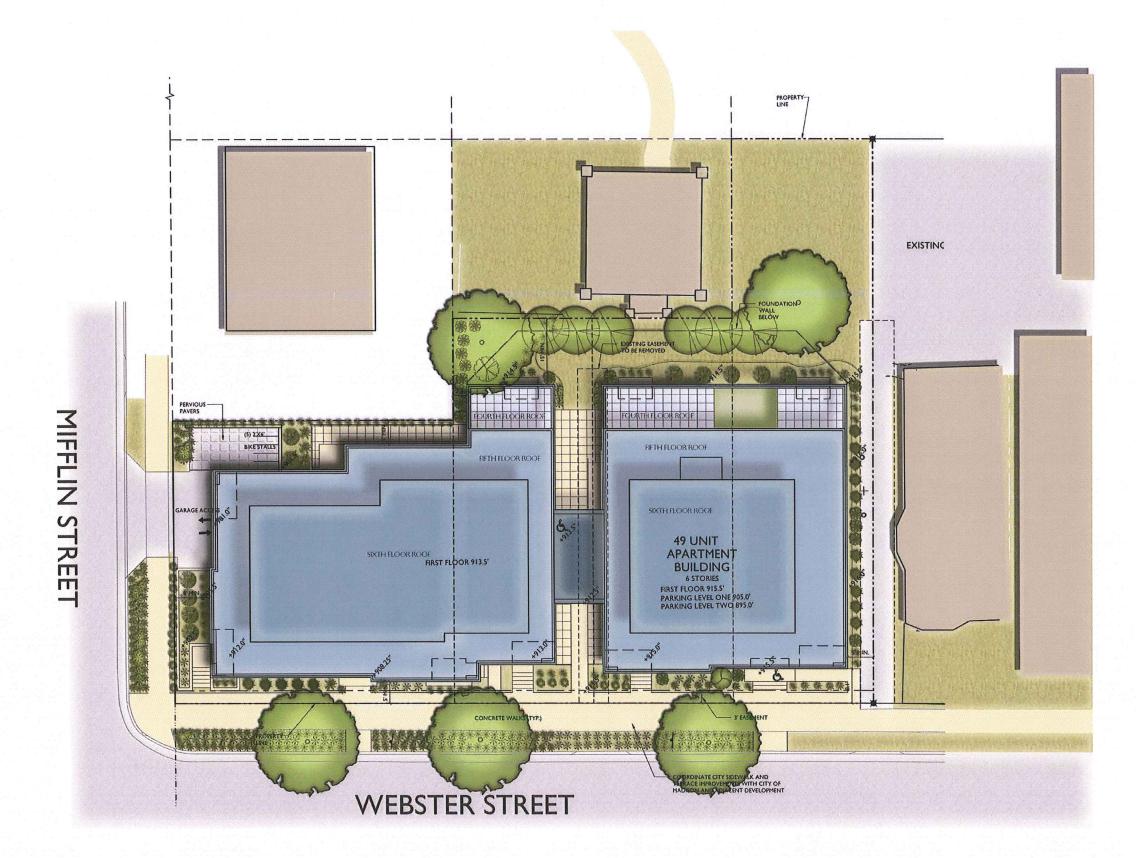



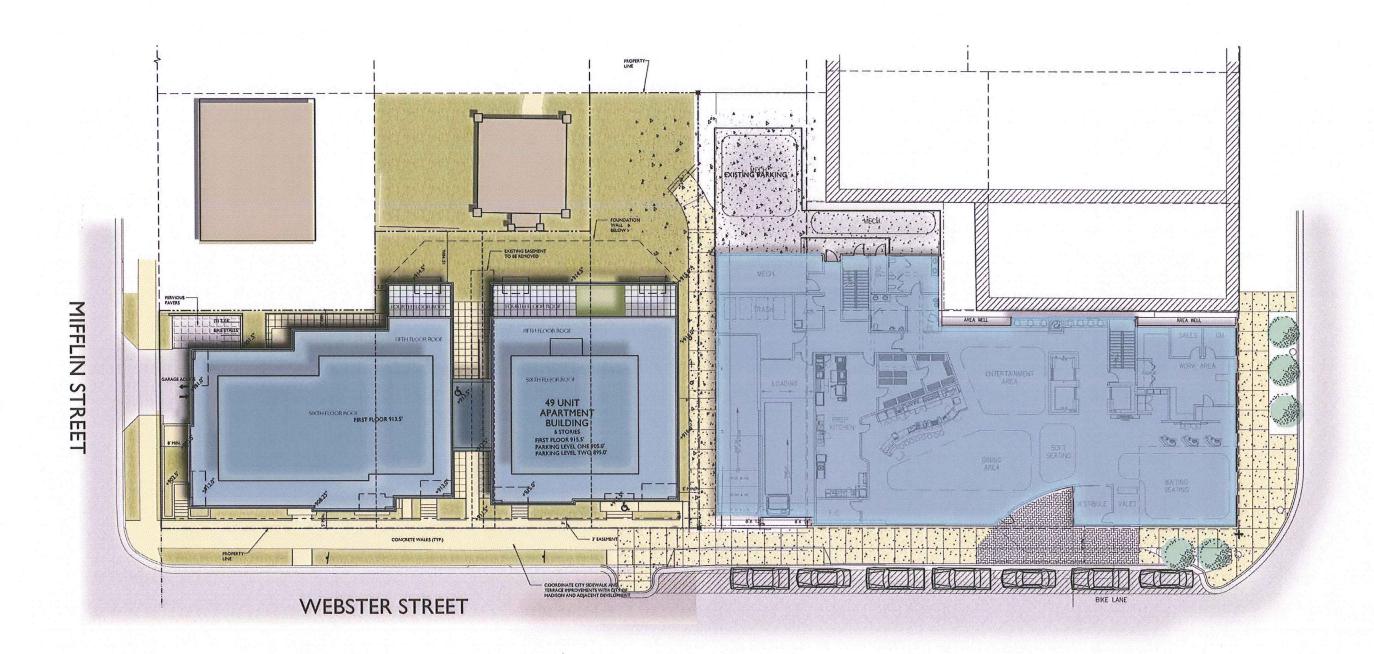





Webster Street Elevation



Mifflin Street Elevation







Side Elevation



























