URBAN DESIGN COMMISSION APPLICATION



City of Madison Planning Division Madison Municipal Building, Suite 017 215 Martin Luther King, Jr. Blvd. P.O. Box 2985 Madison, WI 53701-2985 (608) 266-4635



FOR OFFICE USE ONLY:	
Date Received	Initial Submittal
Paid	Revised Submittal

Complete all sections of this application, including the desired meeting date and the action requested. If your project requires both UDC and Land Use application submittals, a completed Land Use Application and If you need an interpreter, translator, materials in alternate formats or other accommodations to access these forms, please call the Planning Division at (608) 266-4635.

Si necesita interprete, traductor, materiales en diferentes formatos, u otro tipo de ayuda para acceder a estos formularios, por favor llame al (608) 266-4635.

	be submitted.	are also required to	ntaub ntawv ua lwm hom ntawv los sis lwm cov kev pab kom paub txog cov lus qhia no, thov hu rau Koog Npaj (Planning Division) (608) 266-4635.
1.	Project Information		
	Address (list all addresses on the pro-	oject site):	
	Title:		
2.	Application Type (check all that a	apply) and Requested Da	ate
	UDC meeting date requested		
	New development	Alteration to an existing	or previously-approved development
	Informational	Initial Approval	Final Approval
3.	Project Type		
	Project in an Urban Design Dist	rict	Signage
	Project in the Downtown Core E Mixed-Use District (UMX), or Mix	, ,,	Comprehensive Design Review (CDR)
	Project in the Suburban Employ		Modifications of Height, Area, and Setback
	Campus Institutional District (C District (EC)		Sign Exceptions as noted in <u>Sec. 31.043(3)</u> , MGO
	Planned Development (PD)		Other
	General Development Pla	n (GDP)	Please specify
	Specific Implementation P	lan (SIP)	
	Planned Multi-Use Site or Resid	dential Building Complex	
4.	Applicant, Agent, and Property	Owner Information	
	Applicant name		Company
	Street address		City/State/Zip
	Telephone		_ Email
	Project contact person		Company
	Street address		City/State/Zip
	Telephone		Email
	Property owner (if not applicant)		
	Street address		City/State/Zip
	Telephone		
	D	S \ T 1	PAGE 1 OF 4

URBAN DESIGN COMMISSION APPROVAL PROCESS



Introduction

The City of Madison's Urban Design Commission (UDC) has been created to:

- Encourage and promote high quality in the design of new buildings, developments, remodeling, and additions so as to maintain and improve the established standards of property values within the City.
- Foster civic pride in the beauty and nobler assets of the City, and in all other ways possible assure a functionally efficient
 and visually attractive City in the future.

Types of Approvals

There are three types of requests considered by the UDC:

- <u>Informational Presentation</u>. A request for an Informational Presentation to the UDC may be requested prior to seeking any approvals to obtain early feedback and direction before undertaking detailed design efforts. Applicants should provide details on the context of the site, design concept, site and building plans, and other relevant information to help the UDC understand the proposal and provide feedback. (Does not apply to CDR's or Signage Modification requests)
- <u>Initial Approval</u>. Applicants may, at their discretion, request Initial Approval of a proposal by presenting preliminary design information. As part of their review, the Commission will provide feedback on the design information that should be addressed at Final Approval stage.
- <u>Final Approval</u>. Applicants may request Final Approval of a proposal by presenting all final project details. Recommendations or concerns expressed by the UDC in the Initial Approval must be addressed at this time.

Presentations to the Commission

The Urban Design Commission meets virtually via Zoom, typically on the second and fourth Wednesdays of each month at 4:30 p.m. Applicant presentations are strongly encouraged, although not required. Prior to the meeting, each individual speaker is required to complete an online registration form to speak at the meeting. A link to complete the online registration will be provided by staff prior to the meeting. Please note that individual presentations will be limited to a **maximum of three (3) minutes**. The pooling of time may be utilized to provide one speaker more time to present, however the additional time will be based on the number of registrants from the applicant team, i.e. two (2) applicant registrants = six (6) minutes for one (1) speaker.

Primarily, the UDC is interested in the appearance and design quality of projects. Emphasis should be given to the site plan, landscape plan, lighting plan, building elevations, exterior building materials, color scheme, and graphics. Please note that presentation slides, in a PDF file format, are required to be submitted **the Friday before** the UDC meeting.

URBAN DESIGN DEVELOPMENT PLANS CHECKLIST



The items listed below are minimum application requirements for the type of approval indicated. Please note that the UDC and/or staff may require additional information in order to have a complete understanding of the project.

1. Informa	tional Presentation		
	Locator Map)	Requirements for All Plan Sheets
	Letter of Intent (If the project is within		1. Title block
	an Urban Design District, a summary of how the development proposal addresses		2. Sheet number
	the district criteria is required)	Providing additional	3. North arrow
	Contextual site information, including	information beyond these minimums may generate	4. Scale, both written and graphic
	photographs and layout of adjacent buildings/structures	a greater level of feedback	5. Date
	Site Plan	from the Commission.	Fully dimensioned plans, scaled at 1"= 40' or larger
	Two-dimensional (2D) images of		** All plans must be legible, including
_	proposed buildings or structures.	J	the full-sized landscape and lighting plans (if required)
2. Initial A	pproval		
	Locator Map)
	Letter of Intent (If the project is within a development proposal addresses the distri		ry of <u>how</u> the Providing additional
	Contextual site information, including photogr	aphs and layout of adjacent building	gs/structures information
	Site Plan showing location of existing and bike parking, and existing trees over 18" dia		minimums may
	Landscape Plan and Plant List (must be legi	ble)	generate a greater level of
	Building Elevations in both black & white ar and color callouts	nd color for all building sides, inclu	duding material feedback from the Commission.
	PD text and Letter of Intent (if applicable)		J
3. Final Ap	proval		
All the r	equirements of the Initial Approval (see abov	ve), <u>plus</u> :	
	Grading Plan		
	Lighting Plan, including fixture cut sheets a	nd photometrics plan (must be le	egible)
	Utility/HVAC equipment location and scree	ning details (with a rooftop plan i	if roof-mounted)
	Site Plan showing site amenities, fencing, to	rash, bike parking, etc. (if applical	ble)
	PD text and Letter of Intent (if applicable)		
	Samples of the exterior building materials		
	Proposed sign areas and types (if applicable	e)	
4. Signage	Approval (Comprehensive Design Review (CDR), Sign Modifications, and Sig	gn Exceptions (per <u>Sec. 31.043(3)</u>)
	Locator Map		
	Letter of Intent (a summary of <u>how</u> the proposed		
	Contextual site information, including pho project site		
	Site Plan showing the location of existing si driveways, and right-of-ways	gnage and proposed signage, dim	nensioned signage setbacks, sidewalks
	Proposed signage graphics (fully dimension	-	· ·
	Perspective renderings (emphasis on pedes		·
	Illustration of the proposed signage that me	•	- ·
	Graphic of the proposed signage as it relate	es to what the <u>Ch. 31, MGO</u> would	d permit

5. Required Submittal Materials

Application Form

• A completed application form is required for <u>each</u> UDC appearance. For projects also requiring Plan Commission approval, applicants must also have submitted an accepted application for Plan Commission consideration prior to obtaining any formal action (Initial or Final Approval) from the UDC.

Letter of Intent

- If the project is within an Urban Design District, a summary of how the development proposal addresses the district criteria is required.
- For signage applications, a summary of how the proposed signage is consistent with the applicable Comprehensive Design Review (CDR) or Signage Modification review criteria is required.

Development Plans (Refer to checklist on Page 4 for plan details)

Filing Fee (Refer to Section 7 (below) for a list of application fees by request type)

Electronic Submittal

- Complete electronic submittals <u>must</u> be received prior to the application deadline before an application will be scheduled for a UDC meeting. Late materials will not be accepted. All plans must be legible and scalable when reduced. Individual PDF files of each item submitted should be submitted via email to <u>UDCapplications@cityofmadison.com</u>. The email must include the project address, project name, and applicant name.
- Email Size Limits. Note that <u>an individual email cannot exceed 20MB</u> and <u>it is the responsibility of the applicant</u> to present files in a manner that can be accepted. Applicants who are unable to provide the materials electronically should contact the Planning Division at (608) 266-4635 for assistance.

Notification to the District Alder

• Please provide an email to the District Alder notifying them that you are filing this UDC application. Please send this as early in the process as possible and provide a copy of that email with the submitted application.

•	App	plicant Declarations	
	1.	Prior to submitting this application, the applicant is required to discontinuous discussed with	
	2.	The applicant attests that all required materials are included in this not provided by the application deadline, the application will consideration.	
	Nan	ne of applicant	Relationship to property
	Autl	norizing signature of property owner	Date
	_		

7. Application Filing Fees

6

Fee payments are due by the submittal date. Payments received after the submittal deadline may result in the submittal being scheduled for the next application review cycle. Fees may be paid in-person, via US Mail, or City drop box. If mailed, please mail to: City of Madison Building Inspection, P.O. Box 2984, Madison, WI 53701-2984. The City's drop box is located outside the Municipal Building at 215 Martin Luther King, Jr. Blvd. on the E Doty Street side of the building. Please make checks payable to City Treasurer, and include a completed application form or cover letter indicating the project location and applicant information with all checks mailed or submitted via the City's drop box.

Please consult the schedule below for the appropriate fee for your request:

Urban Design Districts: \$350 (per §33.24(6) MGO).

Minor Alteration in the Downtown Core District (DC) or Urban Mixed-Use District (UMX): \$150

(per §33.24(6)(b) MGO)

Comprehensive Design Review: \$500

(per §31.041(3)(d)(1)(a) MGO)

Minor Alteration to a Comprehensive Sign Plan: \$100 (per §31.041(3)(d)(1)(c) MGO)

All other sign requests to the Urban Design Commission, including, but not limited to: appeals from the decisions of the Zoning Administrator, requests for Sign Modifications (of height, area, and setback), and additional sign code approvals: \$300 (per §31.041(3)(d)(2) MGO)

A filing fee is not required for the following project applications if part of the combined application process involving both Urban Design Commission and Plan Commission:

- Project in the Downtown Core District (DC), Urban Mixed-Use District (UMX), or Mixed-Use Center District (MXC)
- Project in the Suburban Employment Center District (SEC), Campus Institutional District (CI), or Employment Campus District (EC)
- Planned Development (PD): General Development Plan (GDP) and/or Specific Implementation Plan (SIP)
- Planned Multi-Use Site or Residential Building Complex



Department of Transportation

Metro Transit

1245 East Washington Avenue, Suite 201
Madison, Wisconsin 53703
Administration: (608) 266-4904
Fax: (608) 267-8778
Customer Service: (608) 266-4466
mymetrobus@cityofmadison.com
www.mymetrobus.com

February 13, 2022

To: The Urban Design Commission – City of Madison cc: Tom Lynch, City of Madison Mike Cechvala, City of Madison Graham Carey, careyBRT

Subject: 432 S. Junction Road Land Use Application – Bus Rapid Transit Junction Road Terminal Requesting Initial and Final Approval

The proposed East-West Bus Rapid Transit project is a roughly 15 mile corridor from the proposed Junction Road Terminal at Mineral Point Road and Junction Road to the proposed East Springs Station near East Towne. The project includes 31 stations with level boarding, off-board fare equipment, enhanced shelters, real-time bus arrival information, and security cameras; as well as new bus lanes and other transit priority treatments, 46 new battery-electric buses, electric bus charging infrastructure, and other support facilities.

The Junction Road Terminal parcel at 432 S Junction Road is the focus of this application. The parcel will be divided into a transit area, a park and ride lot, and a stormwater management area. The transit area includes two buildings – one for operator restrooms and one for electric bus charging infrastructure – as well as space for three 60-foot BRT buses and four standard 40-foot buses, three BRT platforms, two BRT shelters, two standard Metro shelters, and two overhead vehicle chargers. The park and ride lot will have 85 parking spaces, including five accessible and several electric vehicle ready stalls. The stormwater basins will meet the City's stormwater requirements. The stormwater management report has been reviewed by the city and the final report will be submitted in February. Other amenities, including bike racks, bike canopy, and landscaping will be included at the site. The parcel was rezoned to SE (Suburban Employment) on December 6, 2022 (Legistar File 74310). This use is compatible with SE zoning.

Sincerely,

Justin Stuehrenberg

Jushn Stul

Metro Transit General Manager



Madison, Wisconsin

INDEX OF SHEETS

SHEET NO. MR1W - MR34W

SHEET NO. A001 - P902

SHEET NO. 1 TITLE SHEET NO. G1 - G3 GENERAL NOTES SHEET NO. O1 - O5 **OVERVIEW** SHEET NO. TS1 - TS12 TYPICAL SECTIONS SHEET NO. CD1 - CD24 **DETAILS** SHEET NO. CR1-W - CR19E CURB RAMP DETAILS SHEET NO. ROW - R27W REMOVAL PLAN (WEST) SHEET NO. POW - P27W SITE PLAN (WEST) SHEET NO. GOW - P27W GRADING PLAN (WEST) SHEET NO. R1E - R36E REMOVAL PLAN (EAST) SHEET NO. P1E - P36E SITE PLAN (EAST) SHEET NO. G1E - G36E GRADING PLAN (EAST) SHEET NO. P37-E - P47-E STORM SEWER SCHEDULE SHEET NO. SD1-S32E TRAFFIC SIGNALS SHEET NO. E1A - E38 ELECTRICAL PLAN SHEET NO. L1A - L34 LIGHTING PLAN SHEET NO. CP01 - CP19 COMMUNICATION PLAN SHEET NO. TC1 - TC75 TRAFFIC CONTROL PLAN SHEET NO. PMD1 - PMD2 PAVEMENT MARKING DETAILS

SHEET NO. MR1E - MR25E PAVEMENT MARKING REMOVALS (EAST) SHEET NO. M1W - M34W PAVEMENT MARKING PLANS (WEST) SHEET NO. M1E - M25E PAVEMENT MARKING PLANS (EAST) SHEET NO. SR1W - SR34W EXISTING SIGNING/REMOVALS (WEST) SHEET NO. SR1E - SR25E EXISTING SIGNING/REMOVALS (EAST) SHEET NO. SP1W -SP34W PERMANENT SIGNING (WEST) SHEET NO. SP1E - SP25E PERMANENT SIGNING (EAST) SHEET NO. PSD1 - PSD4 PERMANENT SIGNING DETAILS SHEET NO. S-S100 - S-S401 STRUCTURAL DETAILS

PAVEMENT MARKING REMOVALS (WEST)

SHEET NO. A100 - A423

SHEET NO. L201

SHEET NO. G001 - G026

SHEET NO. S001 - S900

STRUCTURAL

SHEET NO. MQ1 - MQOSS1 MISCELLANEOUS QUANTITIES

ARCHITECTURAL


CITY OF MADISON


CITY ENGINEERING DIVISION DEPARTMENT OF PUBLIC WORKS PLAN OF PROPOSED IMPROVEMENT

EAST-WEST BUS RAPID TRANSIT SET 1 OF 11

CITY PROJECT NO. 13925 CONTRACT NO. 8716

FINAL PLANS OCTOBER 5, 2022

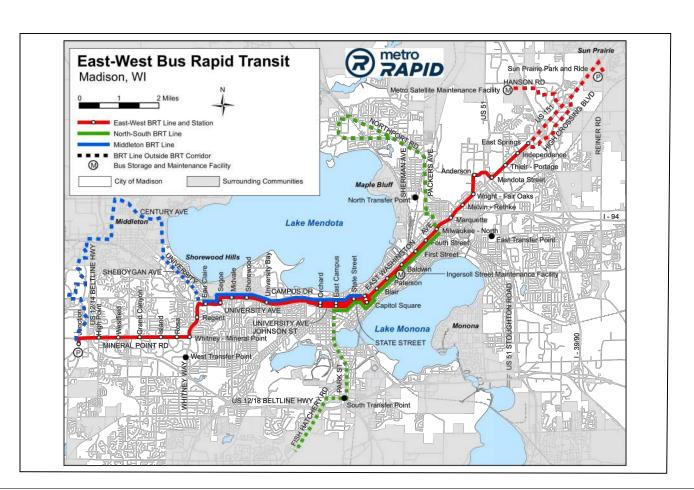

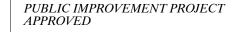

BY THE COMMON COUNCIL OF MADISON, WISCONSIN

PUBLIC IMPROVEMENT DESIGN APPROVED BY:

City Engineer

Date



CONVENTIONAL SIGNS FIELD VERIFY ALL UTILITY LOCATIONS

COMBUSTIBLE FLUIDS

BURIED ELECTRIC
FIBER OPTIC
GAS
OVERHEAD ELECTRIC
POWER POLE
STORM SEWER
SANITARY SEWER
COMMUNICATIONS
WATER

COMBUSTIBLE FLUIDS

E

E

E

E

FO

OH

FO

SS

SAN


TV


W

WATER


Existing Site – 432 S. Junction Rd




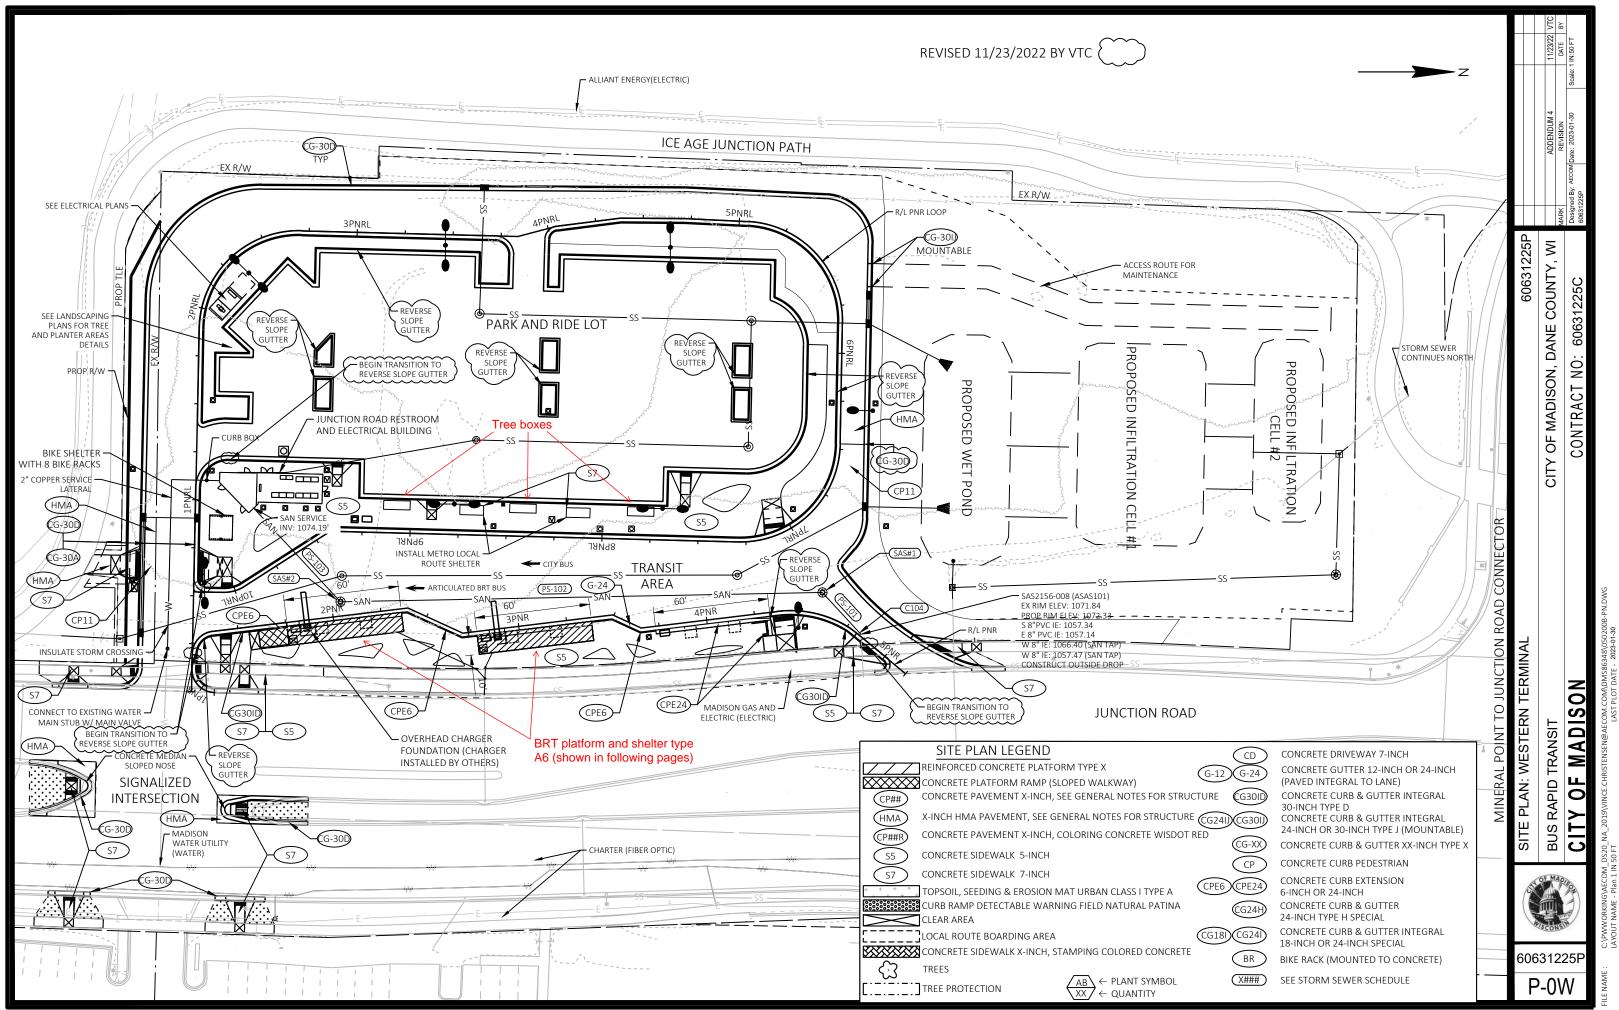

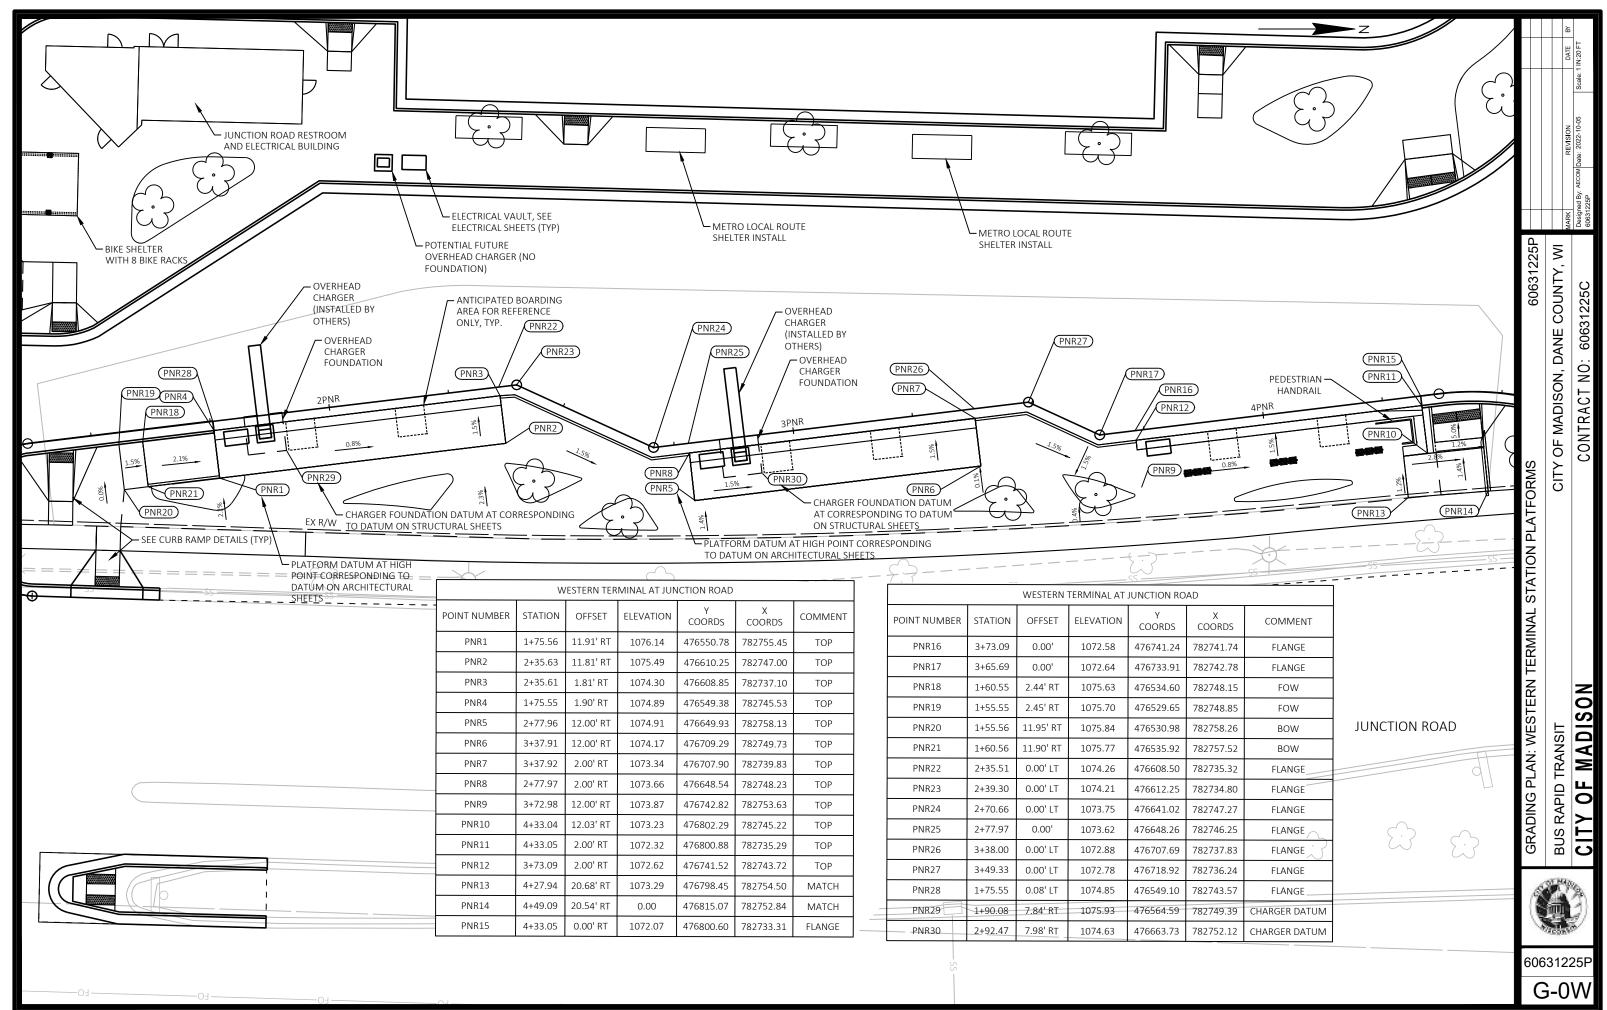


_2019\MICHAEL.SCHNEIDER2@AECOM.COM\DMS86348\050200C-GD.DWG

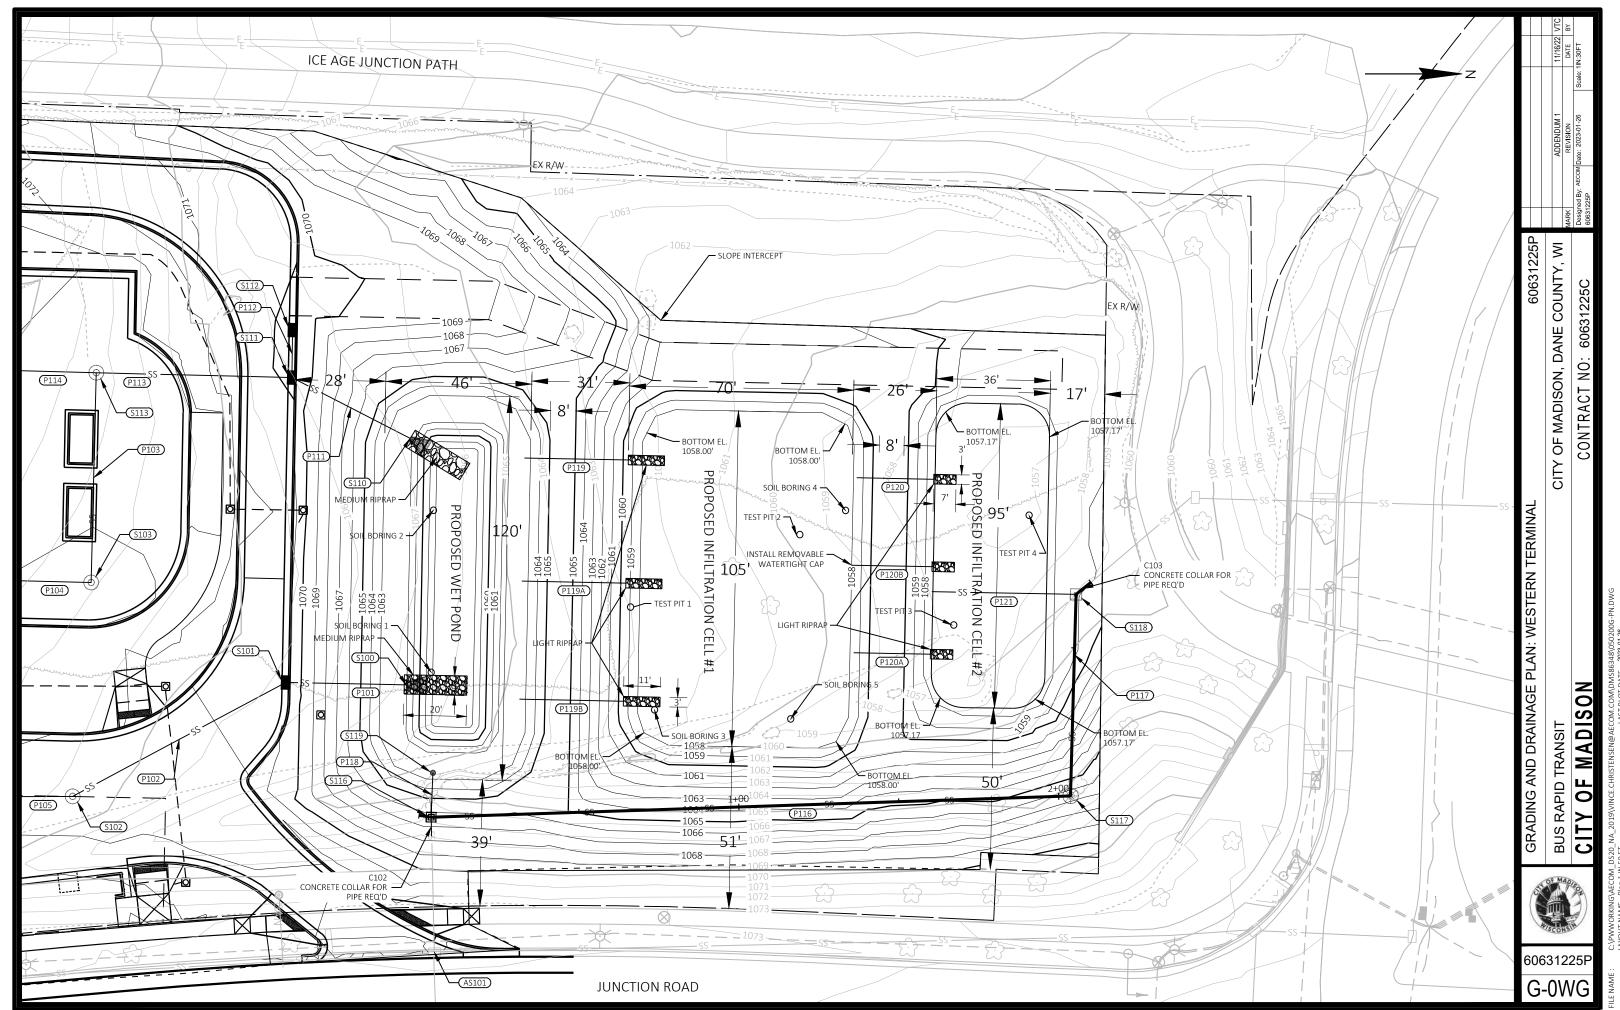

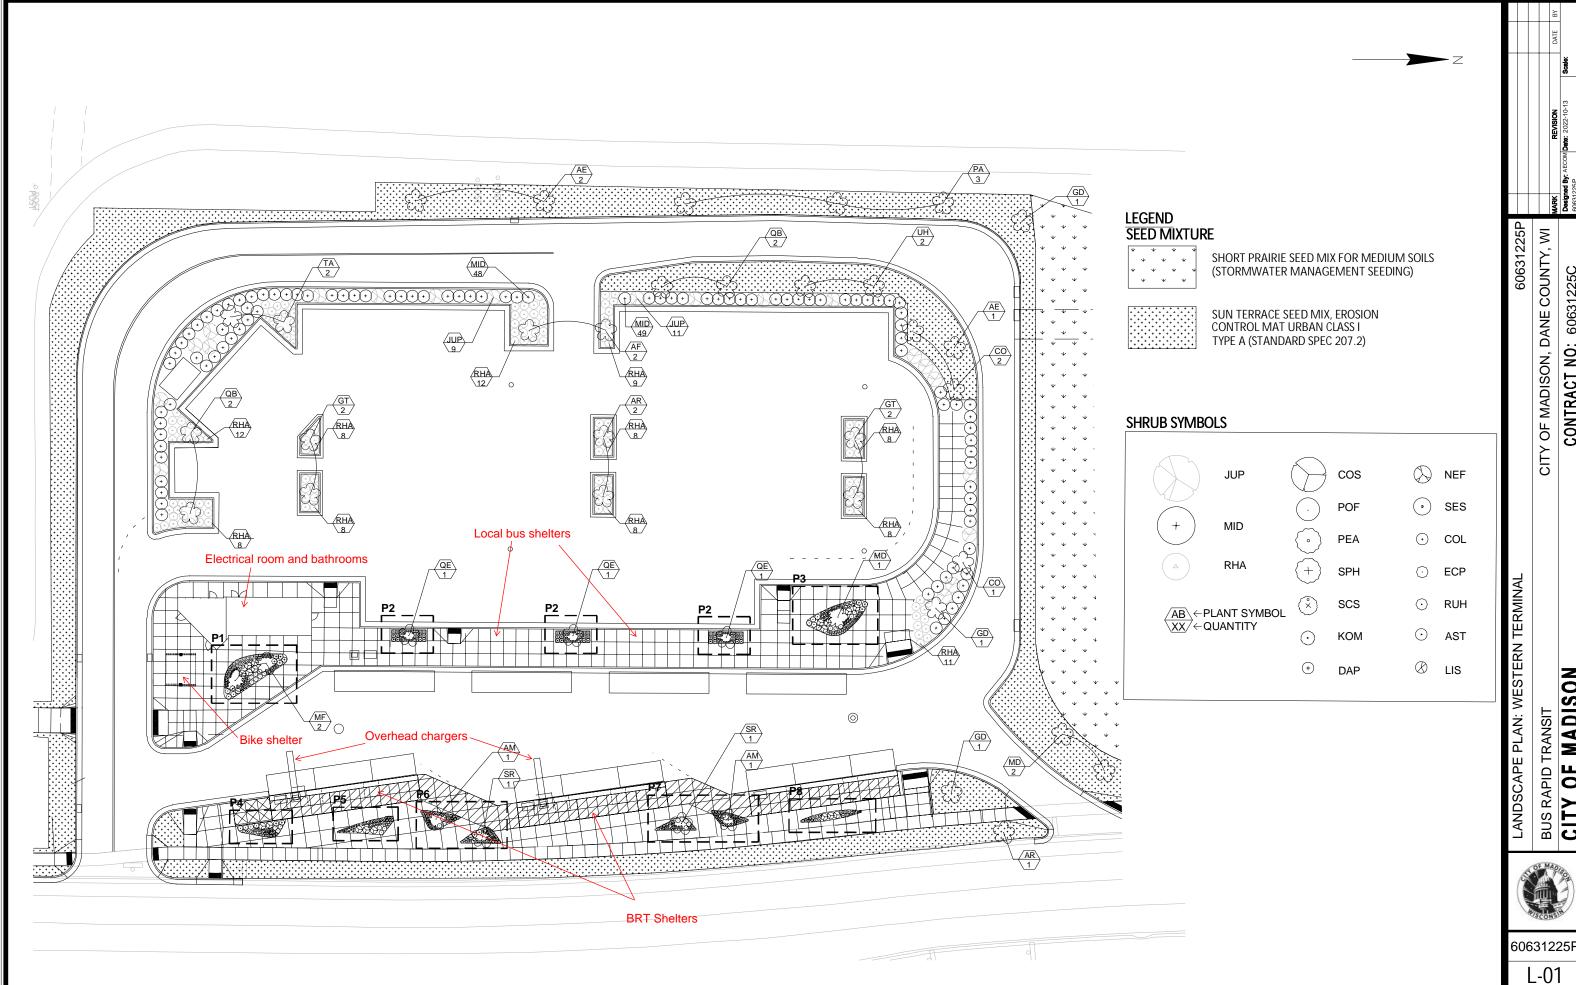


CITY OF MADISON, DANE COUNTY, WI CONTRACT NO: 60631225C BUS RAPID TRANSIT
CITY OF MADISON

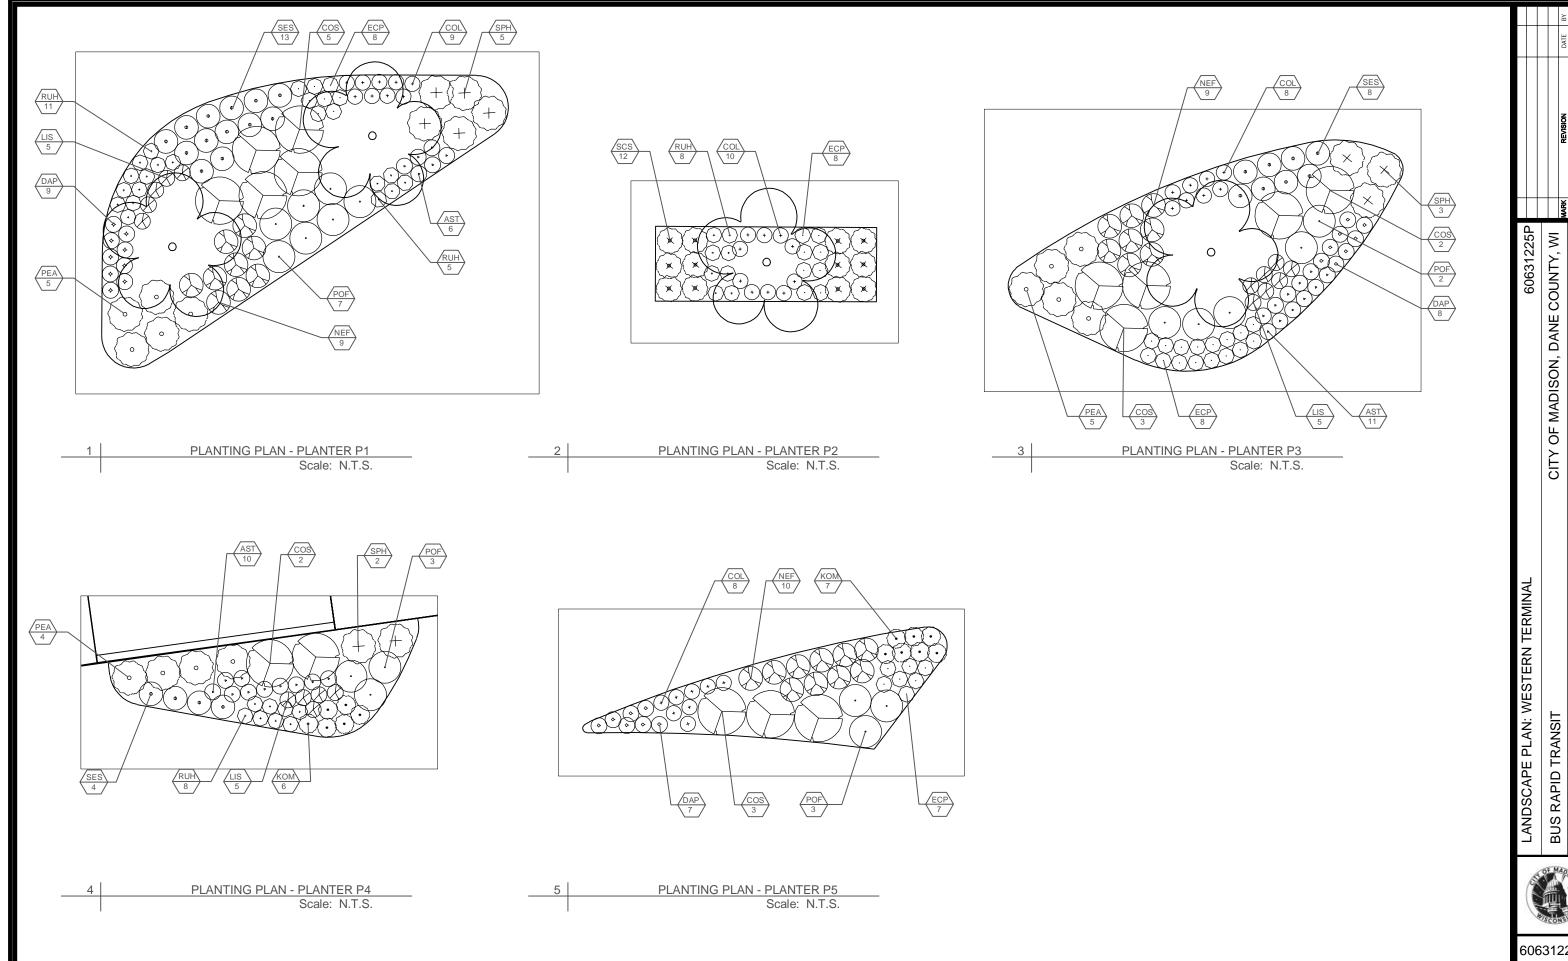



BUS RAPID TRANSIT
CITY OF MADISON 60631225F

L-02

CONTRACT NO: 60631225C

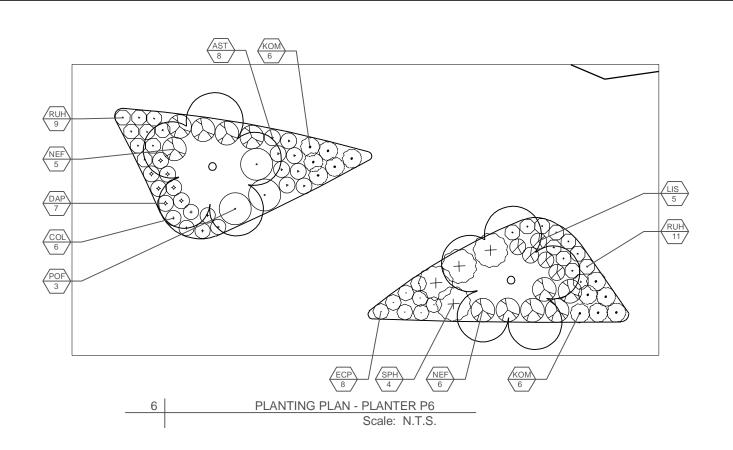

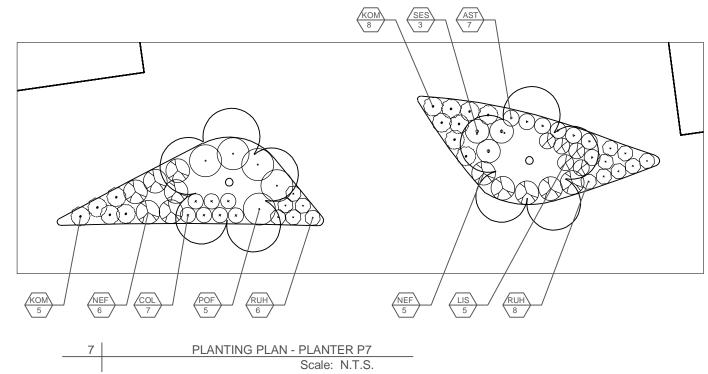

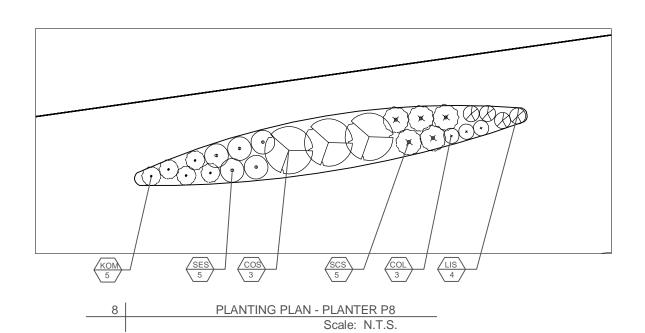




60631225P

CITY OF MADISON, DANE COUNTY, WI
CONTRACT NO: 60631225C



60631225P

L-03

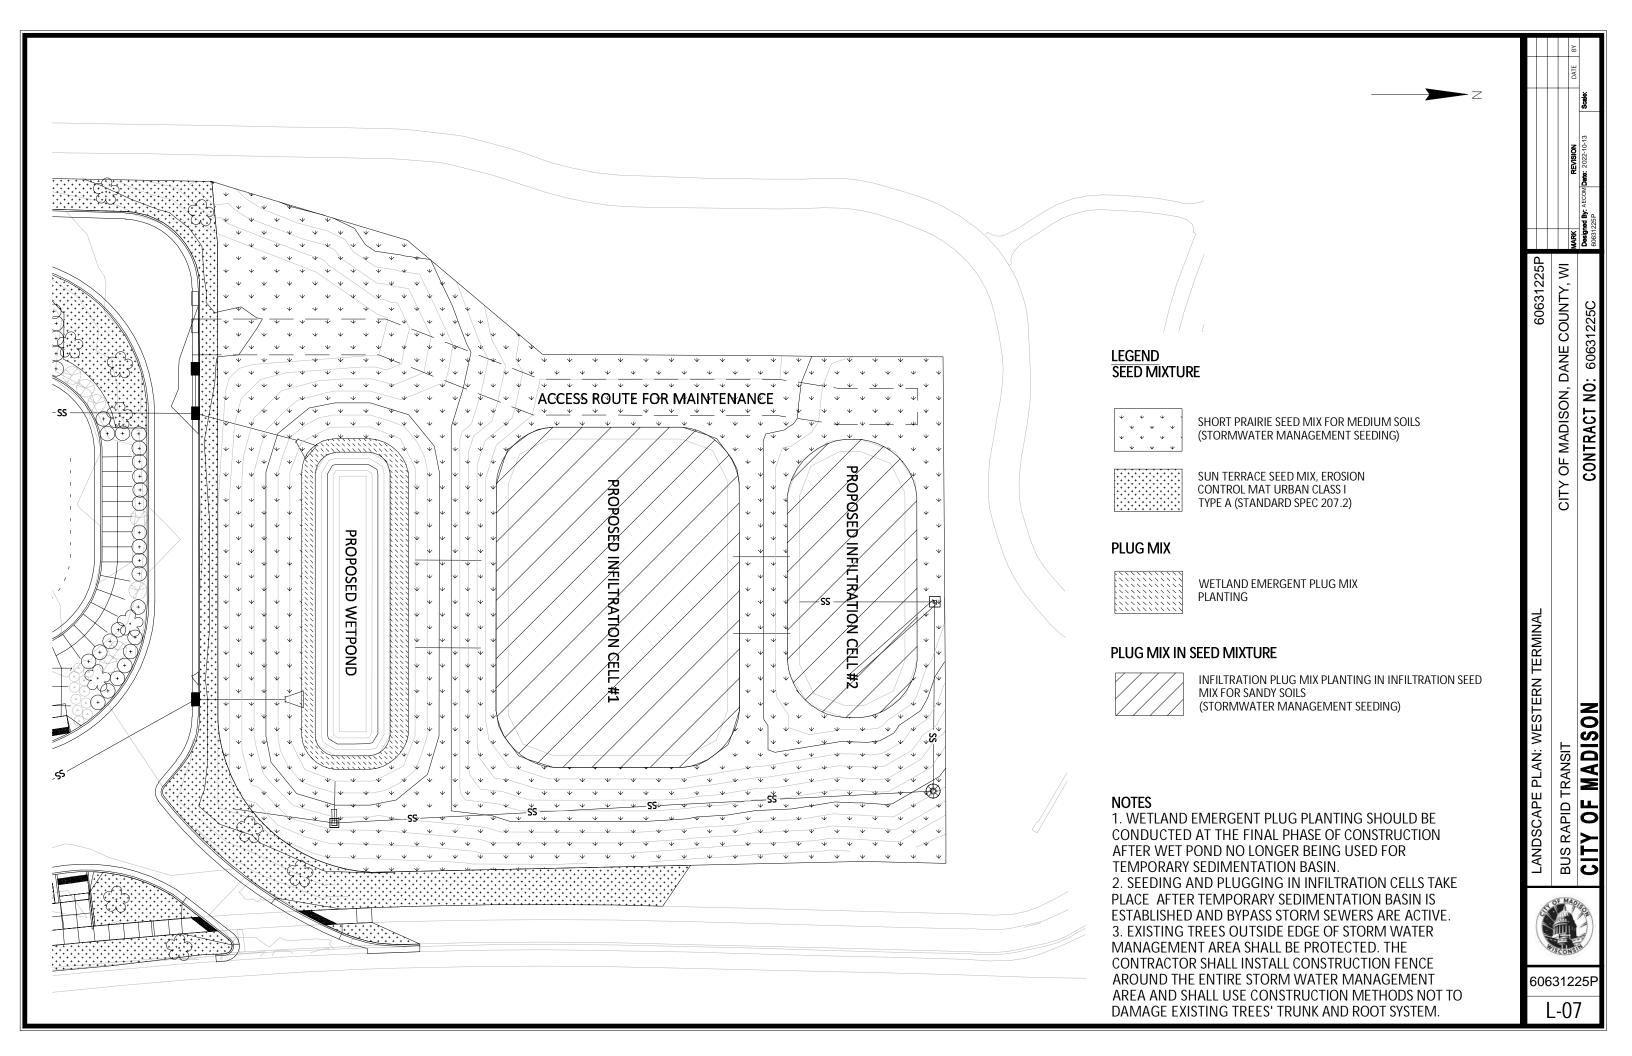

PLANT LISTS

QUANTITY	SYMBOL	BOTANICAL NAME	COMMON NAME	SIZE	CONDITION	SPACING
SHADE TREE						
6	AE	Aesculus glabra 'JN Select'	Early Glow Buckeye	2 inch	B&B	
5	AF	Acer freemanii 'Jeffersred' Autumn Blaze	Autumn Blaze Freeman Maple	2 inch	B&B	
6	AR	Acer miyabei 'Morton'	State Street Miyabe Maple	2 inch	B&B	
5	CO	Celtis occidentalis	Hackberry	2 inch	B&B	
7	GD	Gymnocladus dioica	Espresso' Kentucky Coffee Tree	2 inch	B&B	
6	GT	Gleditsia triacanthos Skycole	Skyline Thornless Honey Locust	2 inch	B&B	
4	PA	Platanus x acerifolia 'Morton Circle'	Exclamation London Planetree	2 inch	B&B	
8	QB	Quercus bicolor	Swamp White Oak	2 inch	B&B	
6	Q <i>E</i>	Quercus muehlenbergii	Chinquapin Oak	2 inch	B&B	
11	TA	Tilia americana 'McKSentry'	American Sentry Linden	2 inch	B&B	
6	UA	Ulmus americana 'Princeton'	Princeton Elm	2 inch	B&B	
6	UH	Ulmus 'New Horizon'	New Horizon Elm	2 inch	B&B	
ONAMENTAL	TRFF					
3	AM	Amelanchier × grandiflora 'Autumn Brilliance'	'Autumn Brilliance' Apple Serviceberry	2 inch	B&B	
4	MD	Malus 'Donald Wyman'	Flowering Crabapple	2 inch	B&B	
5	MF	Malus 'Prairie Fire'	Prairie Fire Crabapple	2 inch	B&B	
4	SR	Syringa reticulata 'Ivory Silk'	Japanese Tree Lilac	2 inch	B&B	
SHRUB						
18	cos	Cornus stolonifera 'Farrow'	Artic Fire Red-Osier Dogwood	 1 gal	potted	
20	JUP	Juniperus x pfitzeriana "Sea Green'	Sea Green Juniper	1 gal	potted	
43	KOM	Koeleria macrantha	June Grass	1 gal	potted	
97	MID	Microbiota decussata	Creeping Siberian Cypress	1 gal	potted	
59	NEF	Calamintha nepeta	Calamint	1 gal	potted	
100	RHA	Rhus aromatica 'Gro-Low'	Gro-Low Fragrant Sumac	1 gal	potted	
PERENNIAL &	NATIVE GRAS	rs.				
42	AST	Asclepias tuberosa	Butterfly Milkweed	1 gal	potted	1'-0" O.C.
71	COL	Coreposis lanceolata	Sand Coreopsis	 1 gal	potted	1'-0" O.C.
31	DAP	Dalea purpurea	Purple Prarie Clover	 1 gal	potted	1'-0" O.C.
55	ECP	Echinaces purpurea	Purple Coneflower	 1 gal	potted	1' O.C.
29	LIS	Liatris spicata	Blazing Star	 1 gal	potted	1'-0" O.C.
14	PEA	Pennisetum alopecuroides 'Hamein'	Dwarf Fountain Grass	1 gal	potted	2.0' O.C.
23	POF	Baptisia australis	Blue False Indigo	1 gal	potted	2'-0" O.C.
82	RUH	Rudbeckia hirta	Black-eyed Susan	1 gal	potted	1' O.C.
41	SCS	Schizachyrium scoparium 'The Blues'	Little Bluestem	1 gal	potted	1.5' O.C.
33	SES	Sedum spectabile 'Autumn Joy'	Autumn Joy Sedum	1 gal	potted	1.5' O.C.
14	SPH	Sporobolus heterolepsis	Prairie dropseed	1 gal	potted	2'-0" O.C.

City of Madison Standard Specification Article 209.4(g):
All plants shall be mulched with either shredded hardwood bark or wood chips over the root system from two (2) inches to a maximum depth of 4 inches immediately after planting. Mulching material shall be pulled back one (1) to two (2) inches away from the trunk of the tree. Mulch shall not be in contact with the trunks.

60631225P CITY OF MADISON, DANE COUNTY, WI CONTRACT NO: 60631225C LANDSCAPE PLAN: PLANT LIST BUS RAPID TRANSIT



STORMWATER MANAGEMENT SEEDING AND PLUG MIX LIST

Oz/Acre 4.00 30.00 32.00 2.00 32.00 X X X X
Oz/Acre
Oz/Acre
Oz/Acre
Oz/Acre
4.00 30.00 32.00 2.00 32.00 8.00 12.00 X X
4.00 30.00 32.00 2.00 32.00 8.00 12.00 X X
4.00 30.00 32.00 2.00 32.00 8.00 12.00 X X
30.00 32.00 2.00 32.00 8.00 12.00 X X
30.00 32.00 2.00 32.00 8.00 12.00 X X
30.00 32.00 2.00 32.00 8.00 12.00 X X
32.00 2.00 32.00 8.00 12.00 X X
2.00 32.00 8.00 12.00 X X
32.00 8.00 12.00 X X
8.00 12.00 X X X
12.00 X X X
X X X
X X
X X
Х
Х
1.00
8.00
12.00
5.00
2.00
2.00
2.00
8.00
8.00
8.00
3.00
8.00
1.00
2.00
5.00
4.00
2.00
2.00
6.00
6.00 4.00
1.00
6.00
1.00
4.00
1.00
8.00
-
Х
X
X
X

WETLAND EMERGEN	T PLUG MIX	
Specification: Custom M	ixture, 4" Deep Plug	
Description: Native speci	ies. Grasses, Sedges, Rushes and Forbs	
Application: Plugs plant	ed at 18" maximum spacing	
Common Name	Scientific Name	% of Total Plugs
Grasses, Sedgse and	Rushes	
Blue Joint Grass	Calamagrostis canadensis	2%
Bristly Sedge	Carex comosa	8%
Fringed Sedge	Carex crinita	4%
Porcupine Sedge	Carex hystericina	8%
Reed Manna Grass	Glyceria grandis	4%
Fowl Manna Grass	Glyceria striata	4%
Common Rush	Juncus effusus	2%
Rice Cut Grass	Leersia oryzoides	6%
Hard-Stem Bulrush	Scirpus acutus	2%
Dark-Green Bulrush	Scirpus atrovirens	3%
Wool Grass	Scirpus cyperinus	2%
River Bulrush	Scirpus fluviatilis	4%
Red Bulrush	Scirpus pendulus	2%
Great Bulrush	Scirpus validus	4%
Prairie Cordgrass	Spartina pectinata	10%
Forbs		,
Sweet Flag	Acorus calamus	10%
Mud Plantain	Alisma subcordatum	4%
Southern Blue Flag Iris	Iris virginica shrevei	7%
Monkey Flower	Mimulus ringens	2%
Common Arrowhead	Sagittaria latifolia	4%
Great Bur Reed	Sparganium eurycarpum	8%

Specification: Custom Mix	ture, 4" Deep Plug	
Description: Native specie	s, Grasses and Forbs	
Application: Plugs plante	d at 18" maximum spacing	
Common Name	Scientific Name	% of Total
Grasses and Sedges		
Big Bluestem	Andropogon gerardii	2%
Fringed Brome	Bromus ciliatus	6%
Bebb's Sedge	Carex bebbii	2%
Awl Fruited Sedge	Carex stipata	2%
Brown Fox Sedge	Carex vulpinoidea	2%
Canada Wildrye	Elymus canadensis	13%
Virginia Wild Rye	Elymus virginicus	13%
Switch Grass	Panicum virgatum	2%
Little Bluestem	Schizachyrium scoparium	7%
Indian Grass	Sorghastrum nutans	4%
Prairie Cordgrass	Spartina pectinata	2%
Forbs	эранна ресинаса	270
	T.m.	
Nodding Pink Onion Marsh Milkweed	Allium cernuum	2%
Marsh Milkweed Common Milkweed	Asclepias incarnata	4%
	Asclepias syriaca	2%
New England Aster	Aster novae-angliae	2%
White False Indiggo	Baptisia alba	2%
Joe Pye Weed	Eupatorium maculatum	2%
Boneset	Eupatorium perfoliatum	2%
Ox-Eye Sunflower	Heliopsis helianthoides	2%
Prairie Blazingstar	Liatris pycnostachya	7%
Yellow Coneflower	Ratibida pinnata	2%
Black Eyed Susan	Rudbeckia hirta	2%
Sweet Black Eyed Susan	Rudbeckia subtomentosa	2%
Brown Eyed Susan	Rudbeckia triloba	2%
Wild Senna	Senna hebecarpa	3%
Prairie Dock	Silphium terebinthinaceum	2%
Ohio Spiderwort	Tradescantia ohiensis	2%
Ironweed	Vernonia fasciculata	2%
Golden Alexanders	Zizia aurea	3%

Specification: Custom Mix	ture	
Description: Native specie	es, Grasses and Forbs	
Application Rate: 15lb/ac		
Common Name	Scientific Name	Oz/Acre
Grasses and Sedges		
		T
Big Bluestem	Andropogon gerardii	4.00
Fringed Brome	Bromus ciliatus	16.00
Bebb's Sedge	Carex bebbii	6.00
Awl Fruited Sedge	Carex stipata	6.00
Brown Fox Sedge	Carex vulpinoidea	6.00
Canada Wildrye	Elymus canadensis	32.00
Virginia Wild Rye	Elymus virginicus	32.00
Switch Grass	Panicum virgatum	4.00
Little Bluestem	Schizachyrium scoparium	16.00
Indian Grass	Sorghastrum nutans	8.00
Prairie Cordgrass	Spartina pectinata	2.00
Substitute Grasses and		2.00
Canada Blue Joint Grass	Calamagrostis canadensis	X
Fringed Sedge	Carex crinita	Х
Lance-Fruited Sedge	Carex scoparia	Х
Forbs		
Lavender Hyssop	Agastache foeniculum	1.00
Nodding Pink Onion	Allium cernuum	4.00
Marsh Milkweed	Asclepias incarnata	10.00
Common Milkweed	Asclepias syriaca	6.00
New England Aster	Aster novae-angliae	2.00
White False Indiggo	Baptisia alba	6.00
Joe Pye Weed	Eupatorium maculatum	4.00
Boneset	Eupatorium perfoliatum	2.00
Sneezeweed	Helenium autumnale	2.00
Ox-Eye Sunflower	Heliopsis helianthoides	5.00
Prairie Blazingstar	Liatris pycnostachya	16.00
Bergamot	Monarda fistulosa	1.00
Yellow Coneflower	Ratibida pinnata	4.00
Black Eyed Susan	Rudbeckia hirta	4.00
Sweet Black Eyed Susan	Rudbeckia subtomentosa	3.00
Brown Eyed Susan	Rudbeckia triloba	3.00
Wild Senna	Senna hebecarpa	7.00
Rosinweed	Siphium integrifolium	1.00
Prairie Dock	Silphium terebinthinaceum	6.00
Stiff Goldenrod Ohio Spiderwort	Solidago rigida	1.00
Blue Vervain	Tradescantia ohiensis	6.00
Ironweed	Verbena hastata Vernonia fasciculata	2.00
Golden Alexanders	Zizia aurea	8.00
Substitute Forbs	Zizia darea	0.00
	T	
Swamp Aster	Aster puniceus	X
Wild Iris	Iris shrevei	Х
Monkey Flower	Mimulus ringens	Х
Mountain Mint	Pycnanthemum virginianum	Х
Ohio Goldenrod	Solidago ohioensis	Х
Riddell's Goldenrod	Solidago riddellii	Х
Purple Meadow Rue	Thalictrum dasycarpum	Х
Culver's Root	Varanicastrum virainisum	V

SEEDING AND PLUG INSTALLATION NOTES

- 1. ALL SEEDING WORK SHALL BE PERFORMED IN ACCORDANCE WITH WISCONSIN DEPARTMENT OF TRANSPORTATION SPECIFICATION, SECTION 630. AND WISCONSIN DEPARTMENT OF NATURAL RESOURCES TECHNICAL STANDARD. INFILTRATION BASIN 1003.
- 2. RESTORE ALL AREAS DISTURBED DURING CONSTRUCTION. PROVIDE 4 INCHES OF TOP-SOIL AND SEED PER PLAN AND SEED MIX LIST. AVOID OVERSEEDING OR SPRAYING ONTO ADJACENT SURFACES. CLEAN AND REMOVE ALL OVER-SEEDING ONTO SUCH AREAS.
- 3. PLANT PLUGS IN A STAGGERED PATTERN, PARALLEL TO TOPOGRAPHY OR BOUNDARY.
- 4. PLANT INFILTRATION LUG MIX PRIOR TO PROVIDING INFILTRATION SEED MIX FOR SANDY SOIL AT THE BOTTOM OF INFILTRATION CELLS.





CITY OF MADISON, DANE COUNTY,


LANDSCAPE PLAN: STORMWATER MANAGEMENT SEEDING AND PLUG MIX LIST

60631225P

L-09

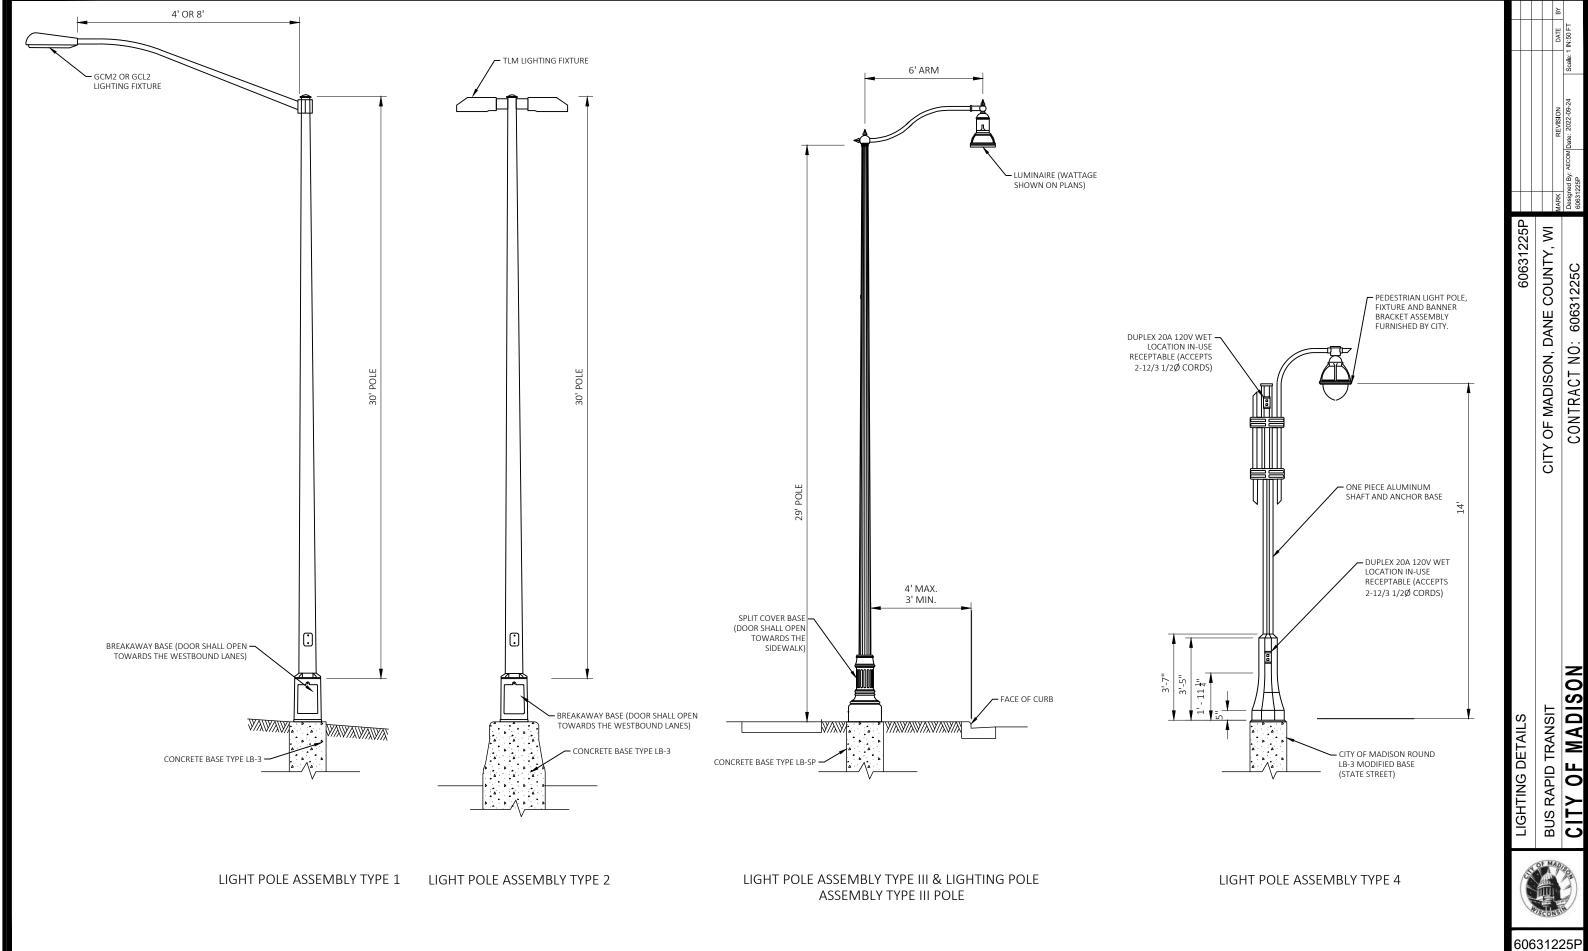

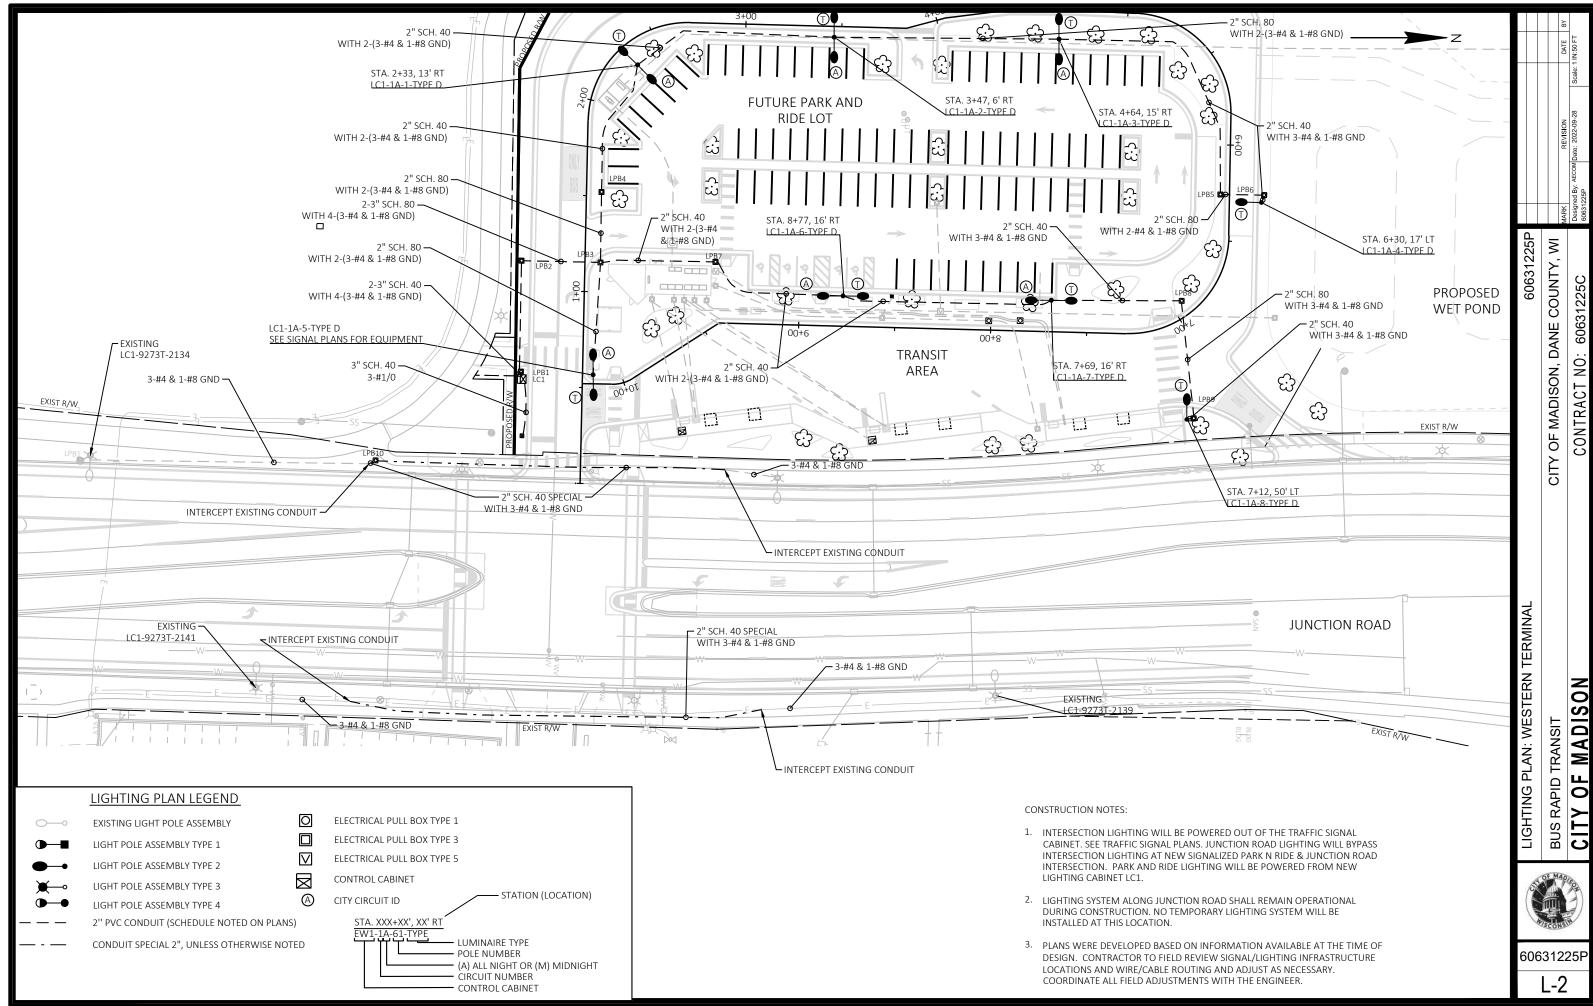


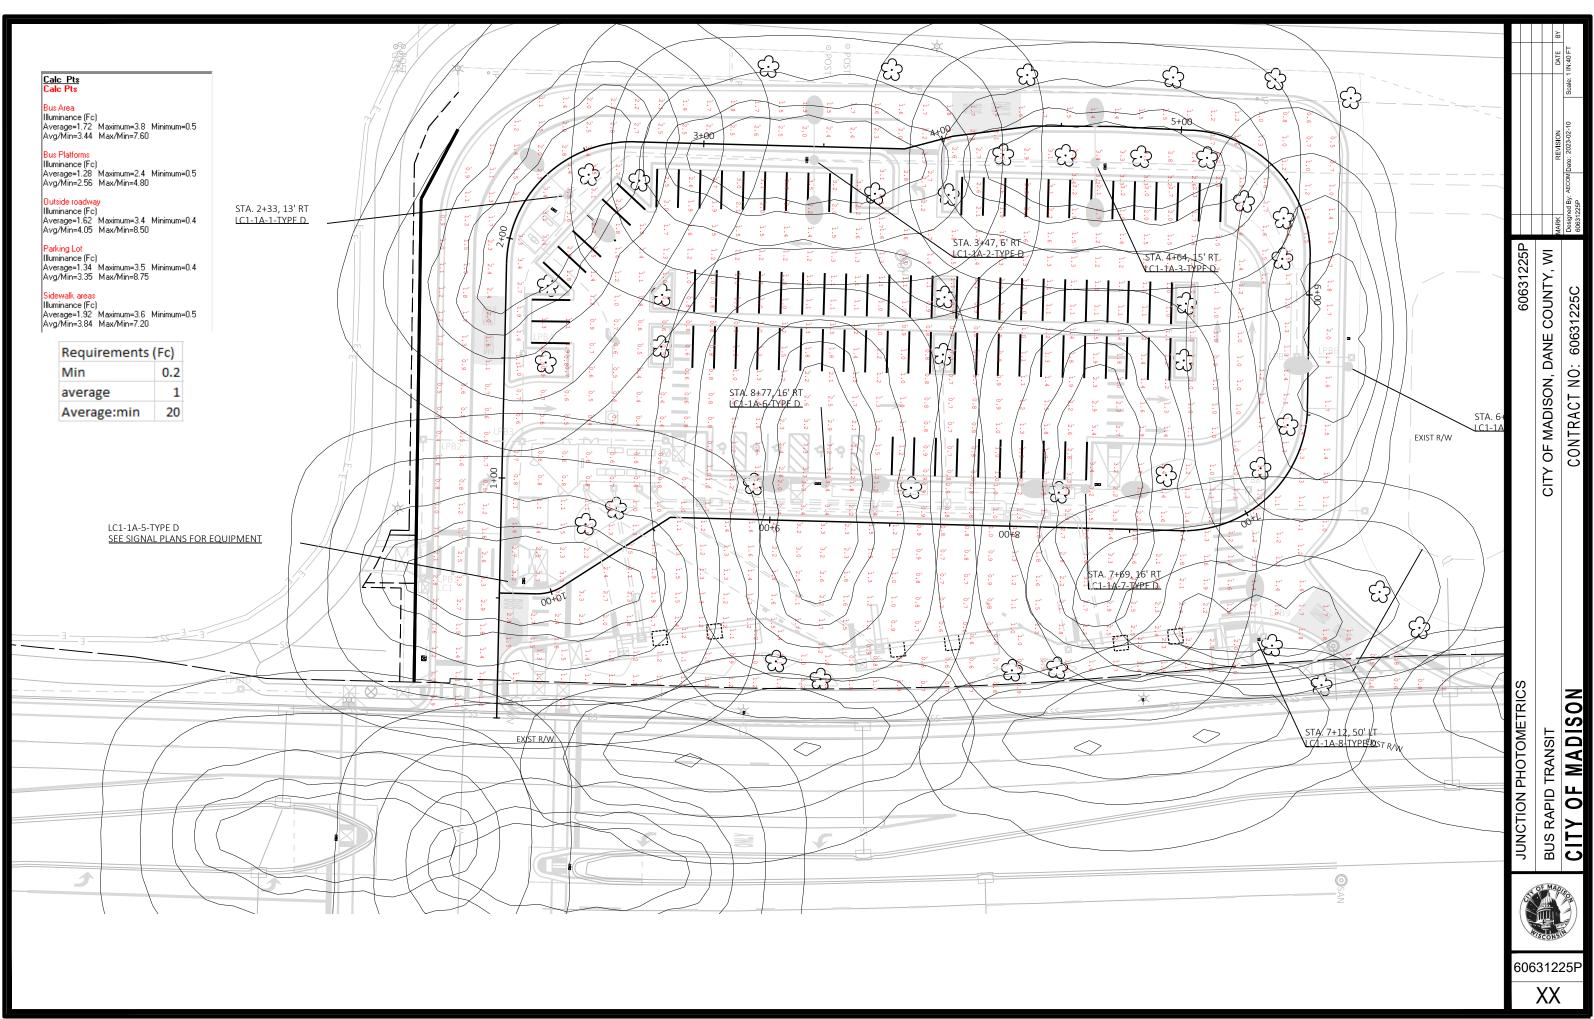

NA_2019\JAMES.JENINGA@AECOM.COM\DMS86348\Q23602-LP.DWG

WORKING\AECOM_DS20_NA_2019\JAMES.JENINGA@AEC T NAME - Plan 1 IN 50 FT (2)

FILE NAME:

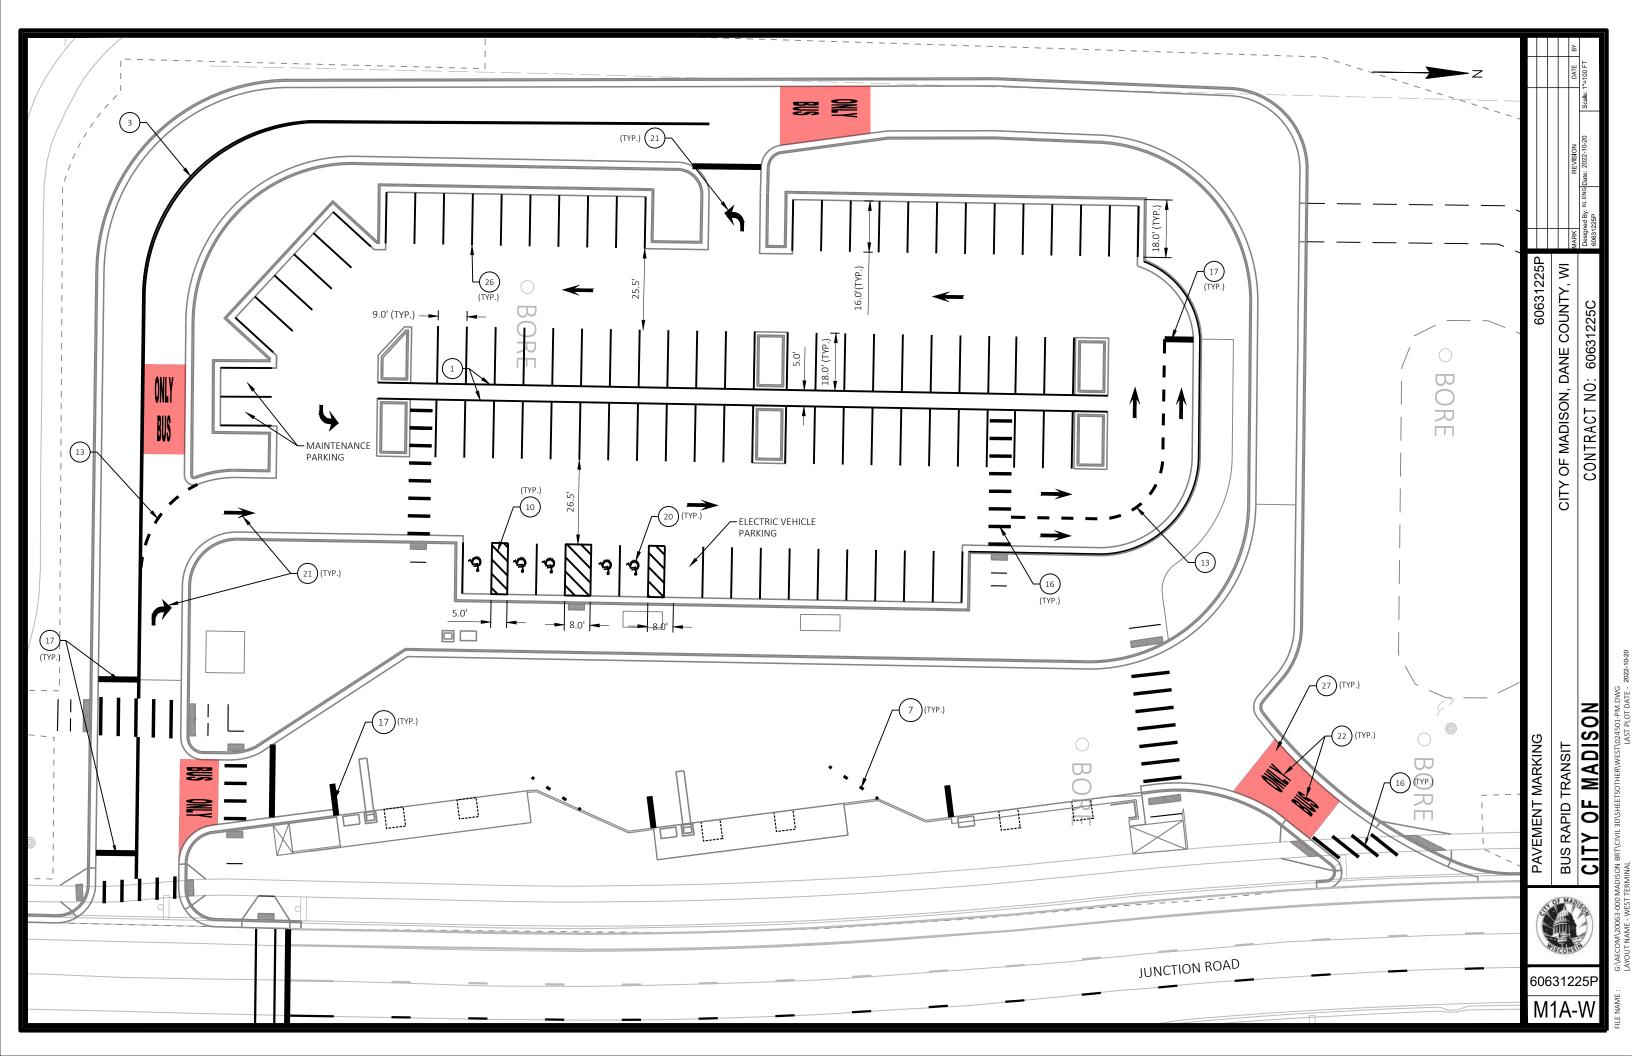

BRT Platform and Shelters

BLACK PAINTED ARCHITECTUAL STEEL

'STONEWOOD' PHENOLIC PANEL - COLOR MADISON WALNUT'

CURTAINWALL GLAZING WITH BIRD SAFETY PATTERNING



| ADDENDUM 1 | 1/08/2022 | 1/08/2022 | 1/08/2022 | 1/08/2022 | 1/08/2022 | 1/08/2023 | 1/2/239 PM | Scale: --- | Date: 1/19/2023 | 1/2/239 PM | Scale: --- | Date: 1/19/2023 | 1/2/239 PM | Scale: --- | Date: 1/19/2023 | 1/2/239 PM | Scale: --- | Date: 1/19/2023 | 1/2/239 PM | Scale: --- | Date: 1/2/2023 | 1/2/239 PM | Scale: --- | Date: 1/2/2023 | 1/2/239 PM | Scale: --- | Date: 1/2/2023 | 1/2/239 PM | Scale: --- | Date: 1/2/2023 | 1/2/239 PM | Scale: --- | Date: 1/2/2023 | 1/2/239 PM | Scale: --- | Date: 1/2/2023 | 1/2/239 PM | Scale: --- | Date: 1/2/2023 | 1/2/239 PM | Scale: --- | Date: 1/2/2023 | 1/2/239 PM | Scale: --- | Date: 1/2/2023 | 1/2/239 PM | Scale: --- | Date: 1/2/2023 | 1/2/239 PM | Scale: --- | Date: 1/2/2023 | 1/2/239 PM | Scale: --- | Date: 1/2/2023 | 1/2/239 PM | Scale: --- | Date: 1/2/2023 | 1/2/239 PM | Scale: --- | Date: 1/2/2023 | 1/2/239 PM | Scale: --- | Date: 1/2/2023 | 1/2/239 PM | Scale: --- | Date: 1/2/2023 | 1/2/239 PM | Scale: --- | Date: 1/2/2023 | 1/2/239 PM | Scale: --- | Date: 1/2/2023 | 1/2/239 PM | Scale: --- | Date: 1/2/2023 | 1/2/2023 | 1/2/2023

60631225P

CITY OF MADISON, DANE COUNTY, WI CONTRACT NO: 60631225C

BUS RAPID TRANSIT
CITY OF MADISON





60631225P





PHENOLIC PANEL MATERIAL

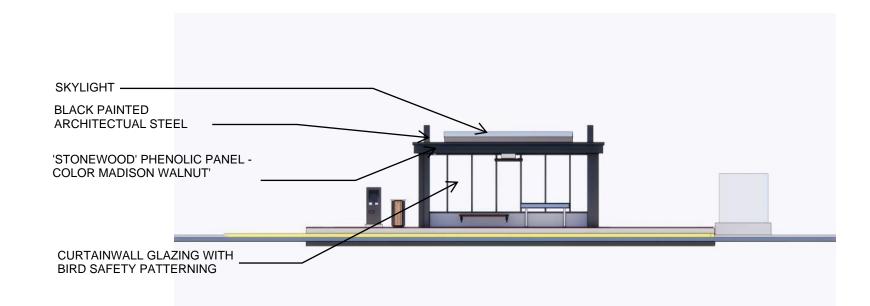

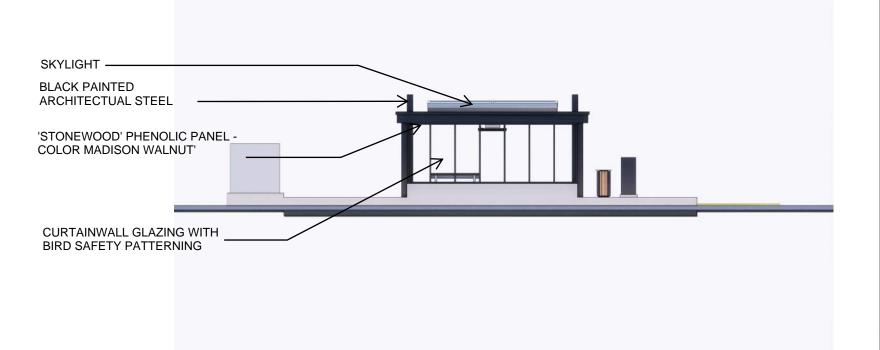




60631225P OF MADISON, DANE COUNTY, WI CONTRACT NO: 60631225C

CITY

PLATFORM RENDERINGS
BUS RAPID TRANSIT
CITY OF MADISON

MAGINA MAGINA

60631225P

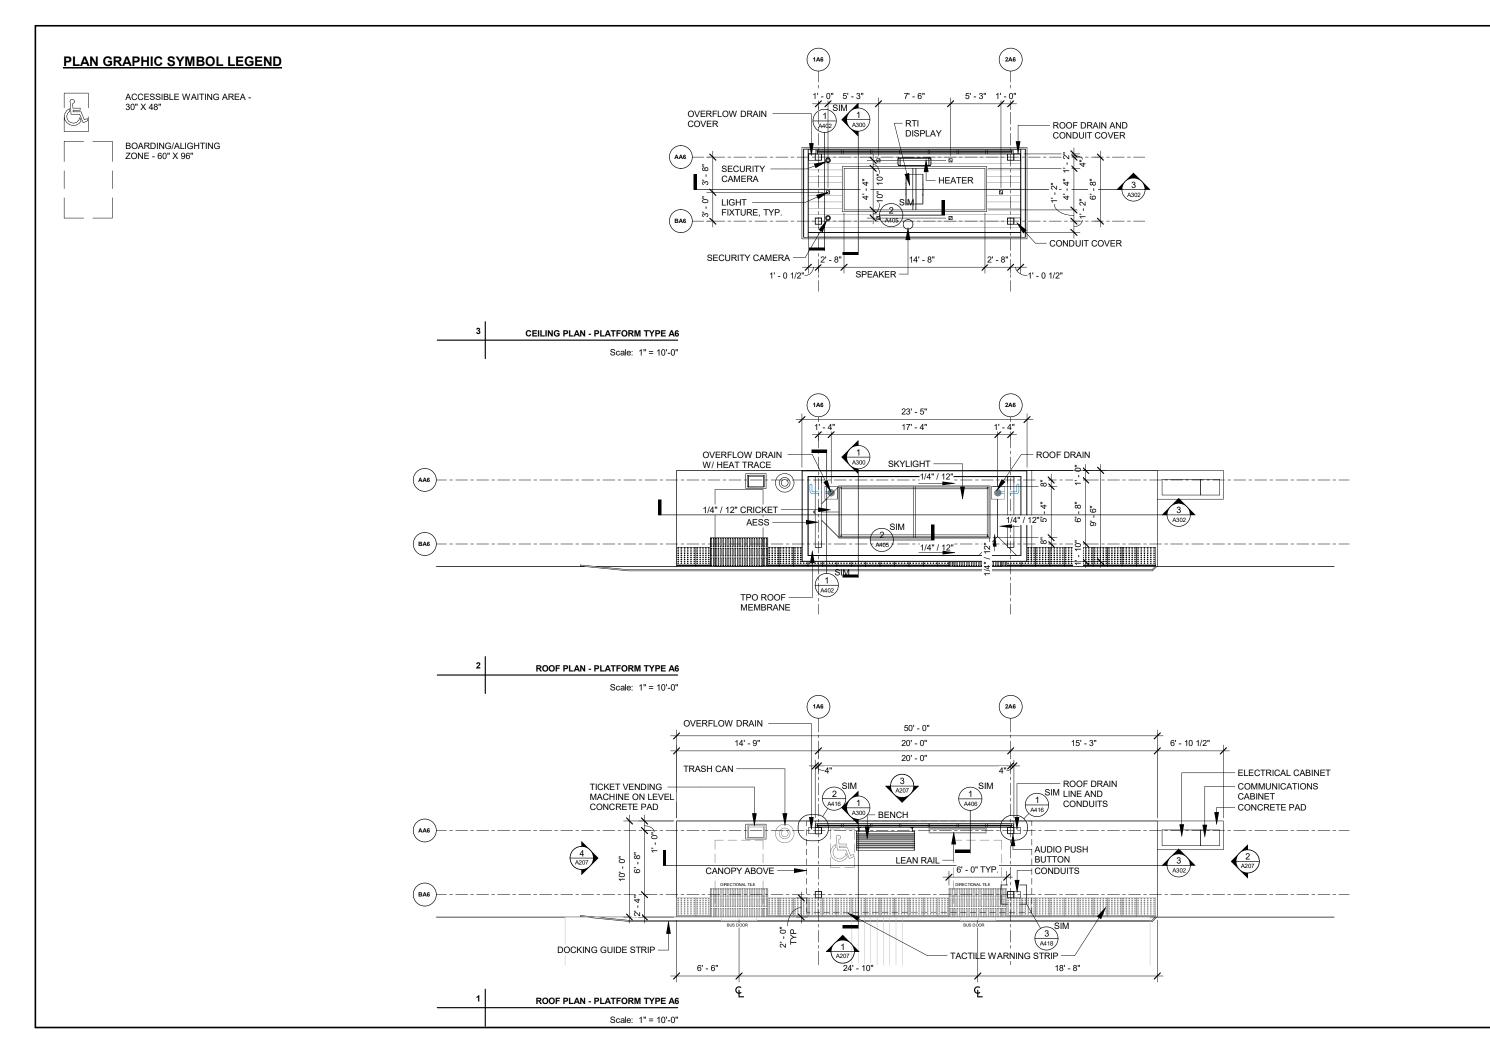


PLATFORM TYPE A6
BUS RAPID TRANSIT
CITY OF MADISON


CITY




60631225P

PLAN GRAPHIC FINISH SYMBOL LEGEND REGULAR CONCRETE (BROOM FINISH) BARK COLOR CONCRETE NOTE: SOME OBJECTS IN PLANS MAY NOT BE SHOWN FOR GRAPHIC CLARITY COUNTY, WI 60631225P EQ EQ _9" EQ EQ EQ EQ 9" EQ EQ CONTRACT NO: 60631225C MADISON, DANE 1'-6" WIDE BOX OUT AT COLUMN - SEE STRUCTURAL, TYP — SAWCUT CONTROL JOINT, TYP FINISH FLOOR PLAN - PLATFORM TYPE A6 OF Scale: 1" = 10'-0" PLATFORM FINISH FLOOR PLANS TYPE A BUS RAPID TRANSIT 60631225P

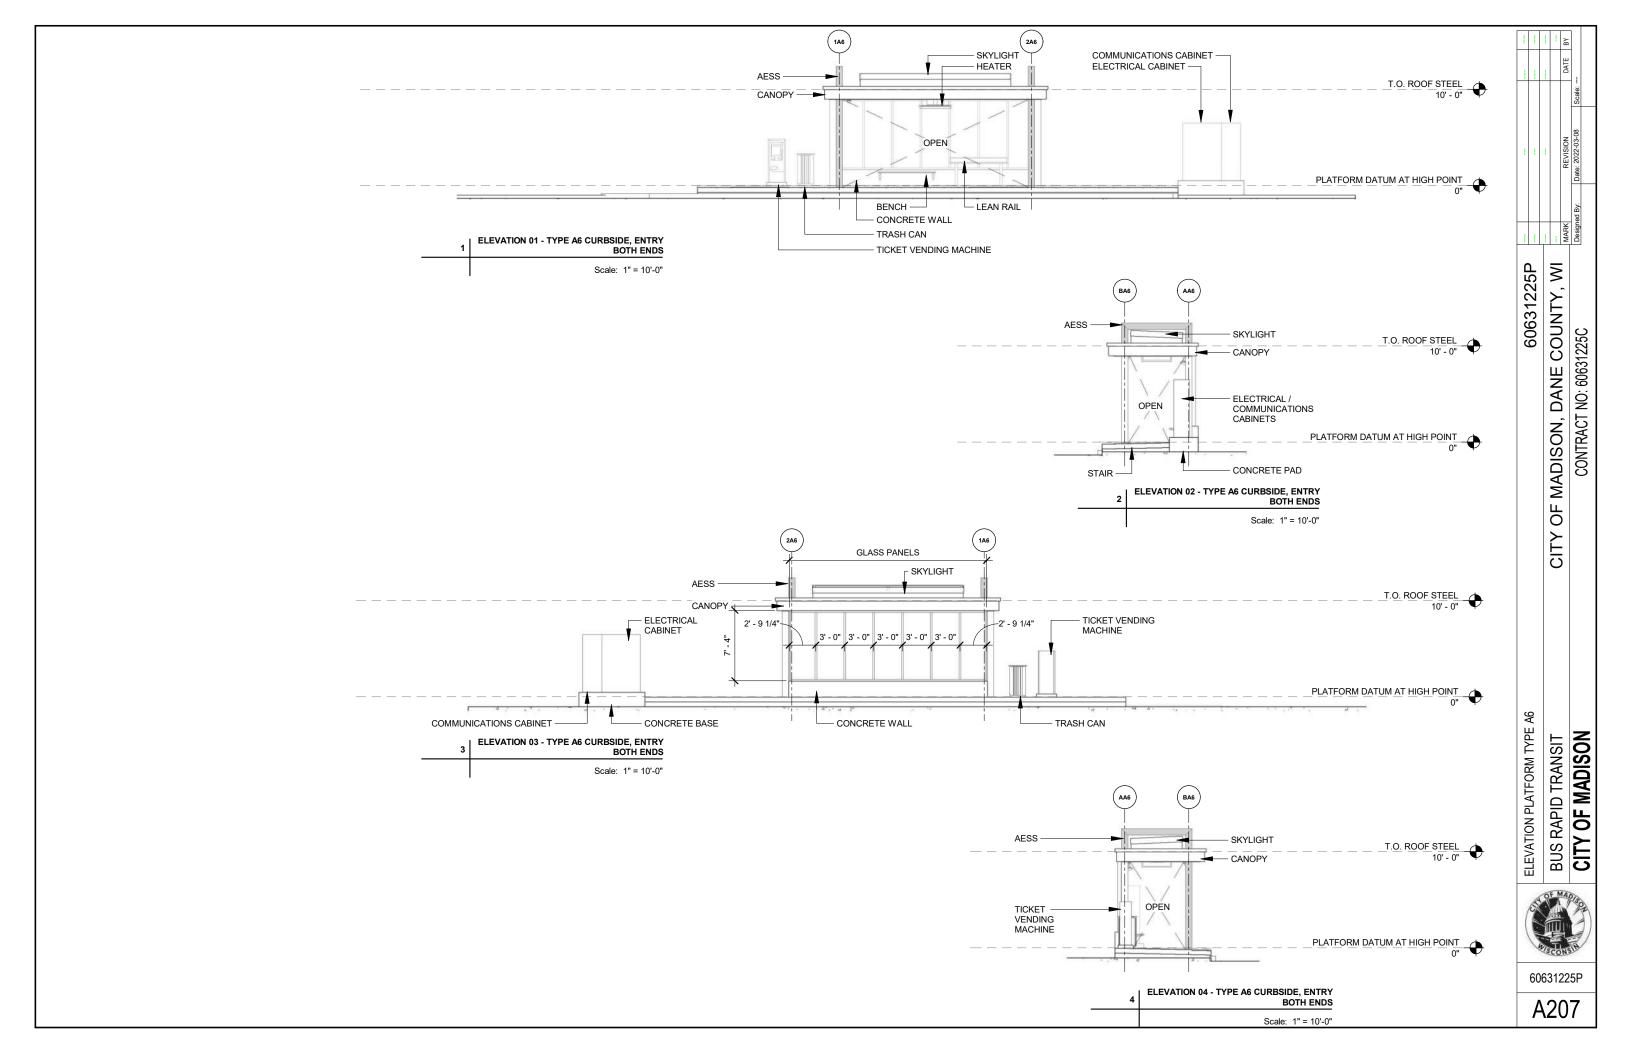


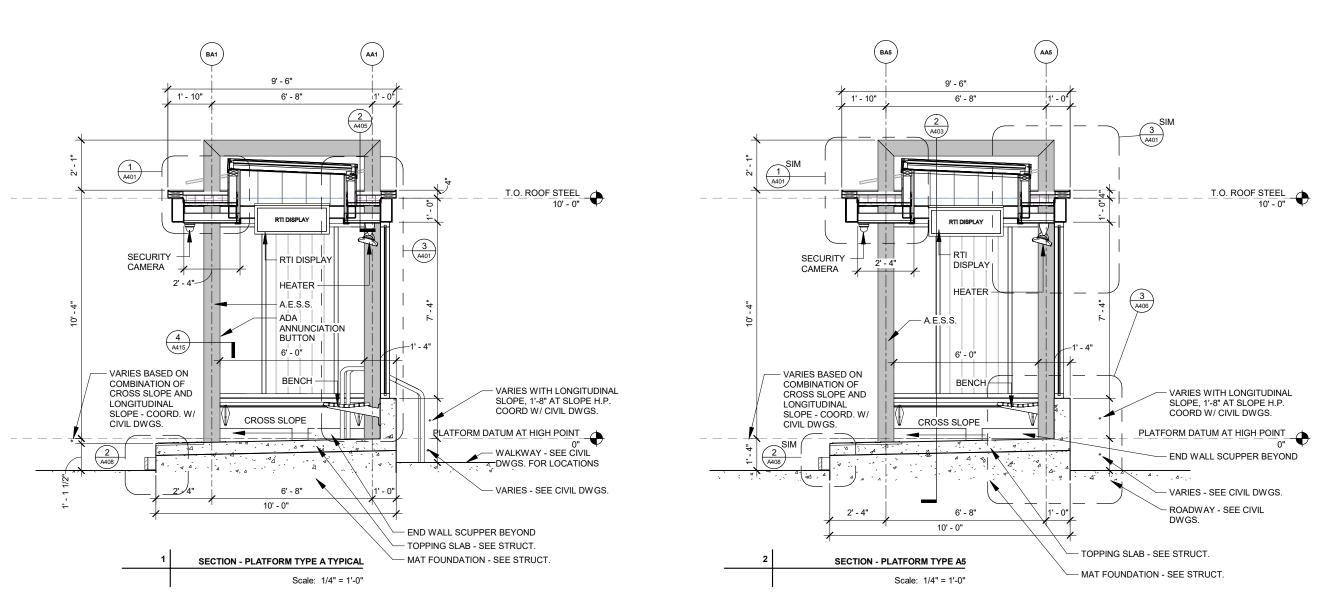


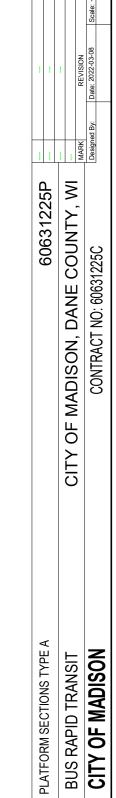



60631225P

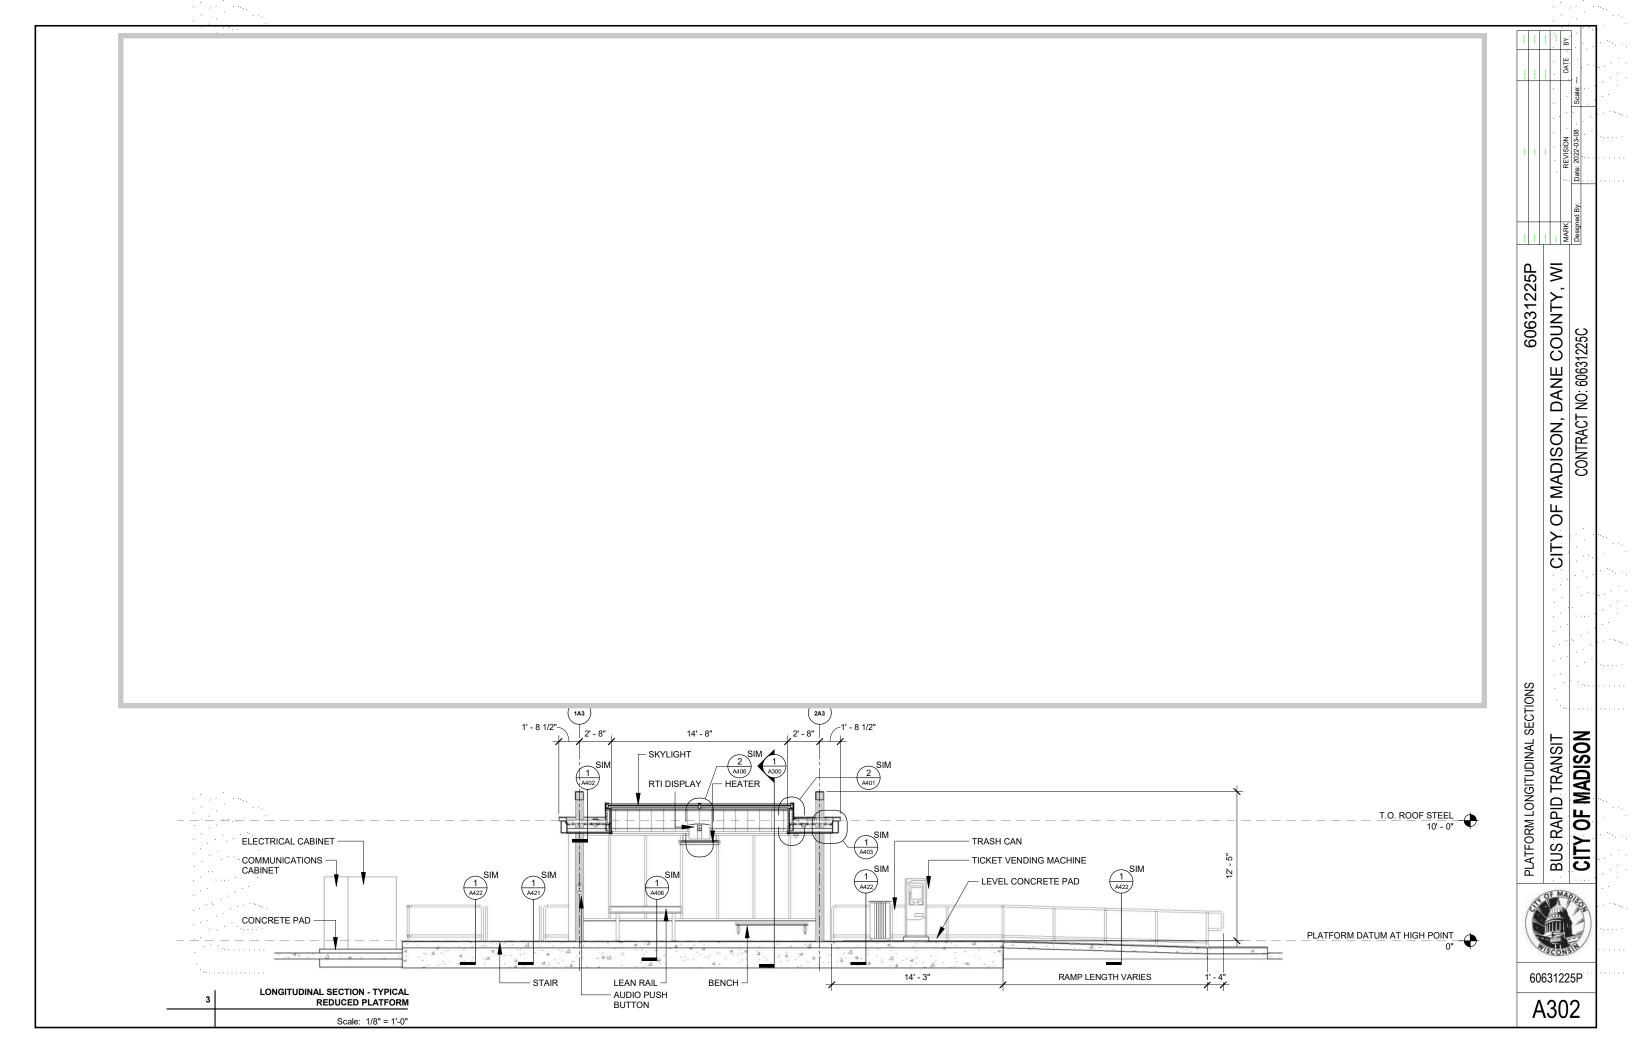


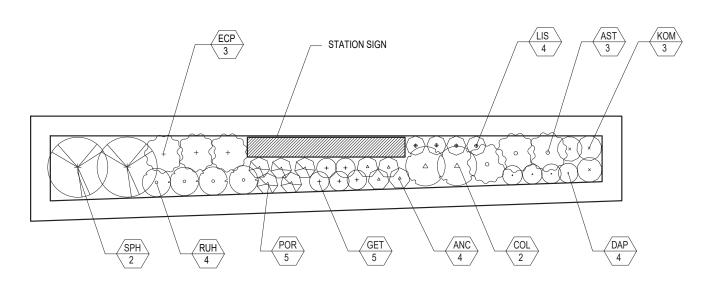

PLANTER PLANT LIST

SYMBOL	BOTANICAL NAME	COMMON NAME	MATURE HEIGHT	SIZE	CONDITION	SPACING
ANC	Anemone canadensis	Canada Anemone	18"	1 gal	potted	6" O.C.
AST	Asclepias tuberosa	Butterfly Milkweed	24"	1 gal	potted	1'-0" O.C.
ASZ	Aster azureus	Sky Blue Aster	24"	1 gal	potted	1' O.C.
COL	Coreposis lanceolata	Sand Coreopsis	18"	1 gal	potted	1'-0" O.C.
DAP	Dalea purpurea	Purple Prarie Clover	12"	1 gal	potted	1'-0" O.C.
ECP	Echinacea purpurea	Purple Coneflower	30"	1 gal	potted	1' O.C.
GET	Geum triflorum	Prairie Smoke	6"	1 gal	potted	6" O.C.
KOM	Koeleria macrantha	June Grass	24"	1 gal	potted	1'-0" O.C.
LIS	Liatris spicata	Blazing Star	30"	1 gal	potted	9" O.C.
POR	Polemonium reptans	Jacob's Ladder	12"	1 gal	potted	6" O.C.
RUH	Rudbeckia hirta	Black-eyed Susan	30"	1 gal	potted	1' O.C.
SPH	Sporobolus heterolepsis	Prairie Dropseed	36"	1 gal	potted	2'-0" O.C.

ABC PLANT SYMBOL QUANTITY

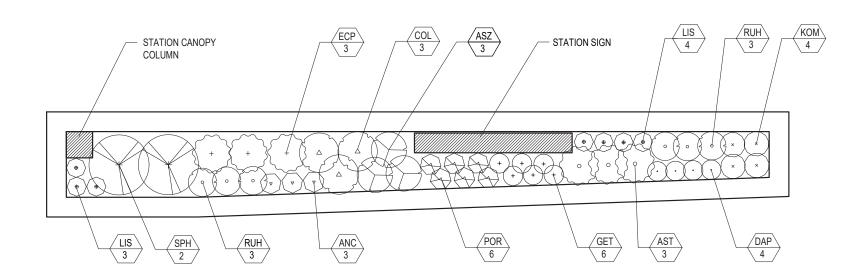


PLANTING PLAN - 15' LONG PLANTER

Scale: N.T.S.

PLANTING PLAN - 18' - 10" LONG PLANTER AT TYPE A1, A2, A5, & A6

Scale: N.T.S.

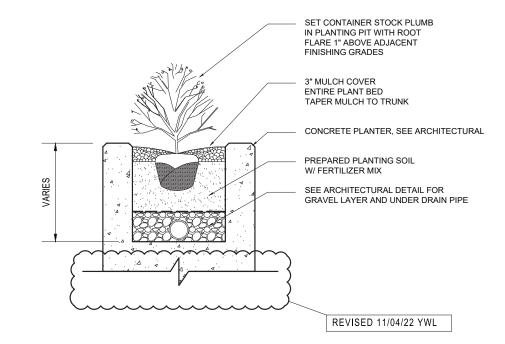

3 PLANTING SECTION - PLANTER
Scale: N.T.S.



OF MADISON, DANE COUNTY, WI CONTRACT NO: 60631225C

CITY


60631225P

60631225P

L201

	FINISH MATERIALS LEGEND
ACP	ACOUSTICAL CEILING PANEL
ACT	ACOUSTICAL CEILING TILE
AF	ACCESS FLOORING
AFA	ANODIZED FINISHED ALUMINUM
AMC	ACOUSTICAL METAL PAN CEILING
AMF	ARCHITECTURAL METAL FINISH
APC	ARCHITECTURAL PRECAST CONCRETE
APF	ACCORDIAN PANEL FINISH
AWP	ACOUSTICAL WALL PANEL
BG	BUMPER GUARD
CC	CUBICLE CURTAINS
CG	CORNER GUARD
CHR	CHAIR RAIL
CMA	CERAMIC ACCESSORY TILE
CMB	CERAMIC BASE TILE
CMT	CERAMIC FIELD TILE
CMU	CONCRETE MASONRY UNIT
CPT	CARPET
CR	CRASH RAIL
DF	DECORATIVE FILM
DG	DECORATIVE GLAZING
EC	EXPOSED CONTRUCTION
EFG	ENTRANCE FLOOR GRILLES
EST	ENGINEERED STONE
EX	EXISTING
FG	FOOT GRILL
FM	FLOOR MAT
FRP	FIBERGLASS REINFORCED PANEL
FWC	FABRIC WALL COVERING
FWP	FABRIC WRAPPED PANEL
GF	GLASS FILM
GMU	GLASS MASONRY UNIT
GVP	GYPSUM VENEER PLASTER
GYP	GYPSUM WALL BOARD
HB	HORIZONTAL BLIND
HGL	HANDRAIL GLASS
HR	HAND RAIL
IGL	INTERIOR GLAZING
INT	INTEGRAL BASE
MCP	METAL CEILING PANEL
ME	MATCH EXISTING
ML	METAL LAMINATE
MMV	MANUFACTURER MASONRY VENEER
NA	NOT APPLICABLE

NFB	INTERIOR FACE BRICK
NPM	INTERIOR PAINTED METAL
NSF	STONE FLOORING
NSV	STONE VENEER
OPF	OPERABLE PANEL FINISH
PJS	PROJECTION SCREENS
PL	PLASTIC LAMINATE
PLD	PLASTIC LAMINATE DOOR
PT	INTERIOR PAINT
RB	RESILIENT BASE
RS	ROLLER SHADE
RSF	RESILIENT SHEET FLOORING
RTF	RESILIENT TILE FLOORING
SC	SEALED CONCRETE
SCT	STONE COUNTERTOP
SDG	SUSPENDED DECORATIVE GRID
SFW	STRETCHED FABRIC WALL SYSTEMS
SMC	SNAP-IN METAL PAN CEILINGS
SMU	CALCIUM SILICATE MASONRY UNIT
SS	STAINLESS STEEL
SSM	SOLID SURFACING FABRICATIONS
ST	STONE
STB	STONE BASE TILE
STT	STONE FIELD TILE
SWP	SHEET WALL PROTECTION
TER	TERRAZZO
TIC	TEXTURED INTERIOR COATING
VB	VERTICAL BLIND
VDS	VISUAL DISPLAY SURFACES
VLB	VERTICAL LOUVER BLINDS
WCP	WOOD CEILING PANEL
WD	WOODWORK
WF	WOOD FLOORING
WSS	WOOD SOLID STOCK
WVD	WOOD VENEERED DOOR
WVP	WOOD VENEERED PANEL
XCT	EXTERIOR COATING
XFB	EXTERIOR FACE BRICK
XGL	EXTERIOR GLAZING
XPM	EXTERIOR COATED METAL
XSV	EXTERIOR STONE VENEER

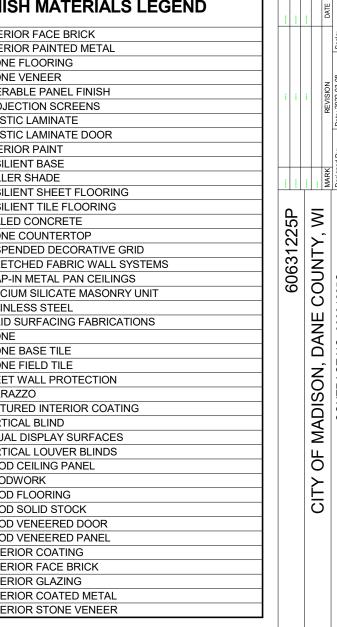



CONTRACT NO: 60631225C

owntown elocated

DESIGN LOADINGS:

CATEGORY I STRUCTURE ROOF SNOW LOAD GROUND SNOW LOAD, Pg = 30 psf FLAT-ROOF SNOW LOAD, Pg = 26 psf SLOPED ROOF SNOW LOAD, Pg = 26 psf SNOW EXPOSURE FACTOR, Ce = 1.0 SNOW IMPORTANCE FACTOR, I = LO THERMAL FACTOR, C+ = 1.2 ROOF SLOPE FACTOR, C_S = 1.0

UNBALANCED SNOW LOAD ON LEEWARD SIDE AT THE EAVE = 54 psf AT THE CROWN = 13 psf

UNBALANCED SNOW LOAD ON THE WINDWARD SIDE = 0 psf WIND LOAD

BASIC WIND SPEED = 90 mph WIND IMPORTANCE FACTOR, I = 1.0 WIND EXPOSURE # 8

ANALYSIS METHOD: ANALYTICAL METHOD, ASCE 7-98, SECTION 6.5

MWFRS - TRANSVERSE AND LONGITUDINAL WIND LOAD WINDWARD WALL LOAD = 12 psf LEEWARD WALL LOAD = 1 psf ROOF LOAD = -13.5 psf

COMPONENT AND CLADDING LOADS WALL = 18 psf ROOF = -13.5 psf EARTHQUAKE DESIGN DATA

> SEISMIC FACTOR, to = 1.0 SEISMIC DESIGN CATAGORY A
> SEISMIC USE GROUP = !
> SPECTHAL RESPONSE COEFFICIENTS
> Sds = 0.096
> Sdl = 0.064 SITE CLASS = D ANALYSIS PROCEDURE - SECTION 1604.4

NO ROOF PONDING LOAD REQUIRED NO ROOF RAIN LOAD REQUIRED NO DRIFTING OR SLIDING LOADS ROOF DEAD LOAD - 3 psf

NOTES:

- A TOTAL OF 7 SHELTERS SHALL BE FABRICATED AND ERECTED. ALL 7 SHELTERS SHALL BE IDENTICAL.
- 2. ALL THE ALUMINUM SHELTER FRAMING MEMBERS SHALL BE PAINTED.
- 3. PROVIDE HAND HOLES IN THE COLUMNS SCHEDULED FOR ELECTRIC WIRING TO BE ROUTED. SEE DETAIL 8/A-8.

TYPICAL ALUMINUM SHELTER FRAMING MEMBERS

COLUMNS: 4"x 4"x1/4" SQUARE TUBE

ROOF CROSS BEAMS AT GRIDE LINES A THRU E: 4"x 6"x1/4" RECTANGULAR TUBE CURVED ROOF MEMBERS AT GRID LINES 1 THRU 3: 2"x 4"x1/8" RECTANGULAR TUBE HORIZONTAL WALL MEMBERS: 2"x 4"x1/8" TUBE WINDOW GRILLE: 14"x14"x1/8" SQUARE TUBE

GLASS STOPS: Y4"x Y4"x V6" ANGLE

DIAGONAL BRACES: SEE DETAILS 1/A-9, 3/A-9, 4/A-9

ALUMINUM TYPE: 6063-T6

BOX NOTES

- 1 COLUMN
- 2 ARM REST
- 3 BENCH
- 4 RADIUS = 3'-8%"
- 5 BENCH BRACKET
- 6 GLASS
- 7 HORIZONTAL WALL MEMBER
- B BUS ROUTE SIGN ABOVE SEE I/A-6
- 9 LIGHT FIXTURE ABOVE
- 10 ROOF OUTLINE
- II BASE SHOE
- ELECTRIC WIRE ROUTED UP THROUGH COLUMN BY EC. PROVIDE A DIAMETER HOLE IN FRAMING FOR WIRE TO PASS THROUGH
- 13 PROVIDE HAND HOLES IN COLUMN SEE 8/A-8

ARCHITECTURAL SYMBOLS:


DETAIL OR SECTION CUT - SHEET NUMBER SECTION IS SHOW

REVISION IDENTIFICATION

ELEVATION CONTROL POINT:

INDEX OF DRAWINGS

- A-1 BUS SHELTER FLOOR PLAN A-2 BUS SHELTER ROOF PLAN
- BUS SHELTER ROOF FRAMING PLAN A-3
- BUS SHELTER ELEVATIONS
- BUS SHELTER ELEVATIONS A-5 A-6 BUS SHELTER DETAILS
- A-7 BUS SHELTER DETAILS
- BUS SHELTER DETAILS A-8 BUS SHELTER DETAILS A-9
- BUS SHELTER DETAILS

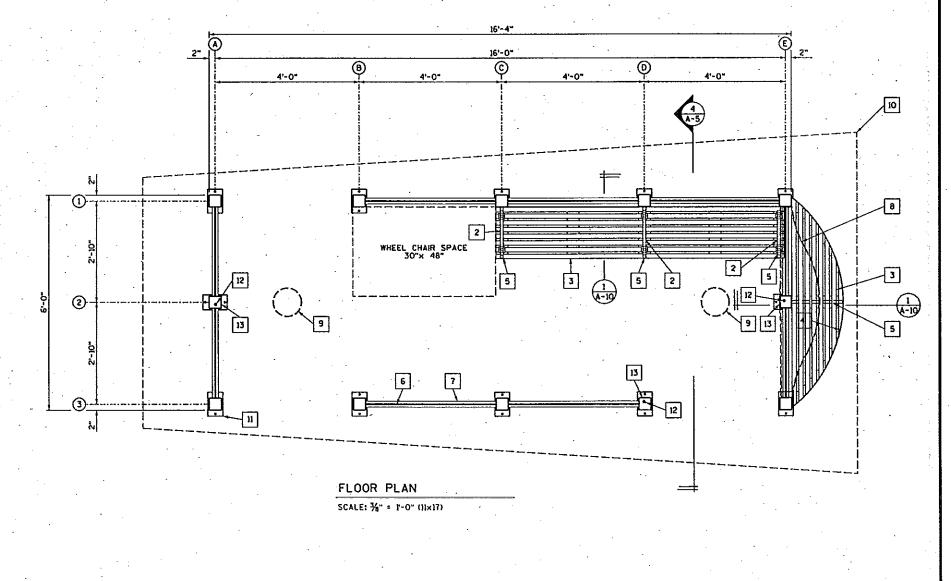

STATE PROJECT NUMBER:5992-07-66

HWY: STATE STREET MALL


COUNTY: DANE

PLOT DATE: 02/03/2004

A-I BUS SHELTER FLOOR PLAN

SCALE, FEET

SHEET NO: SP 67

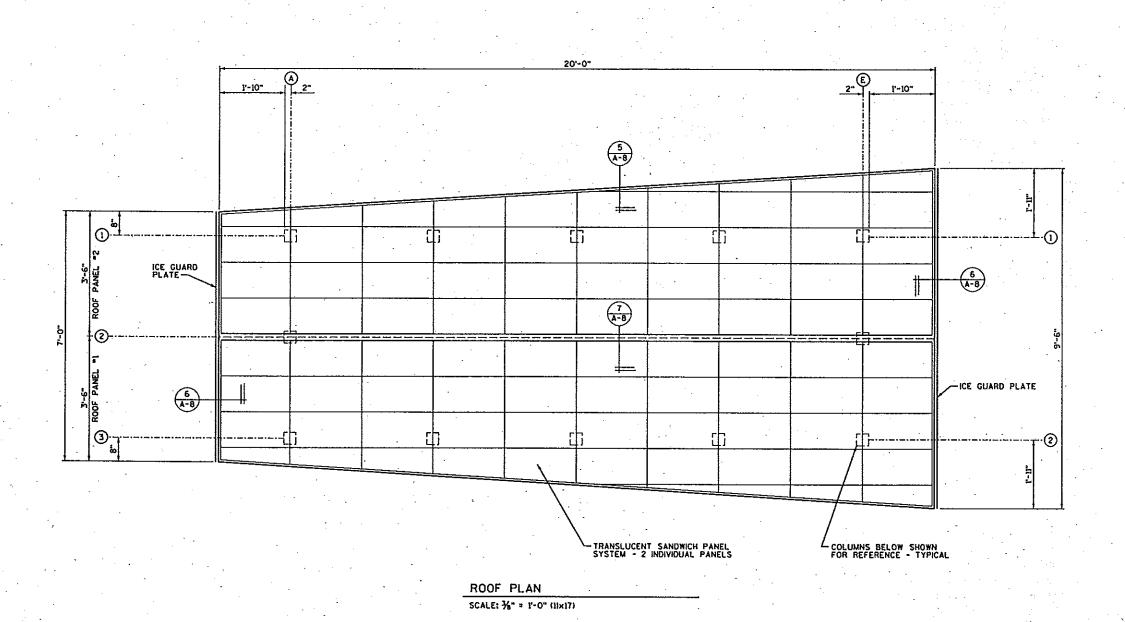



BOX NOTES

1 GLASS


2 ICE GUARD PLATE

STATE PROJECT NUMBER:5992-07-66 HWY: STATE STREET MALL N'A SHEET NO: SP 68 COUNTY: DANE A-2 BUS SHELTER ROOF PLAN SCALE, FEET

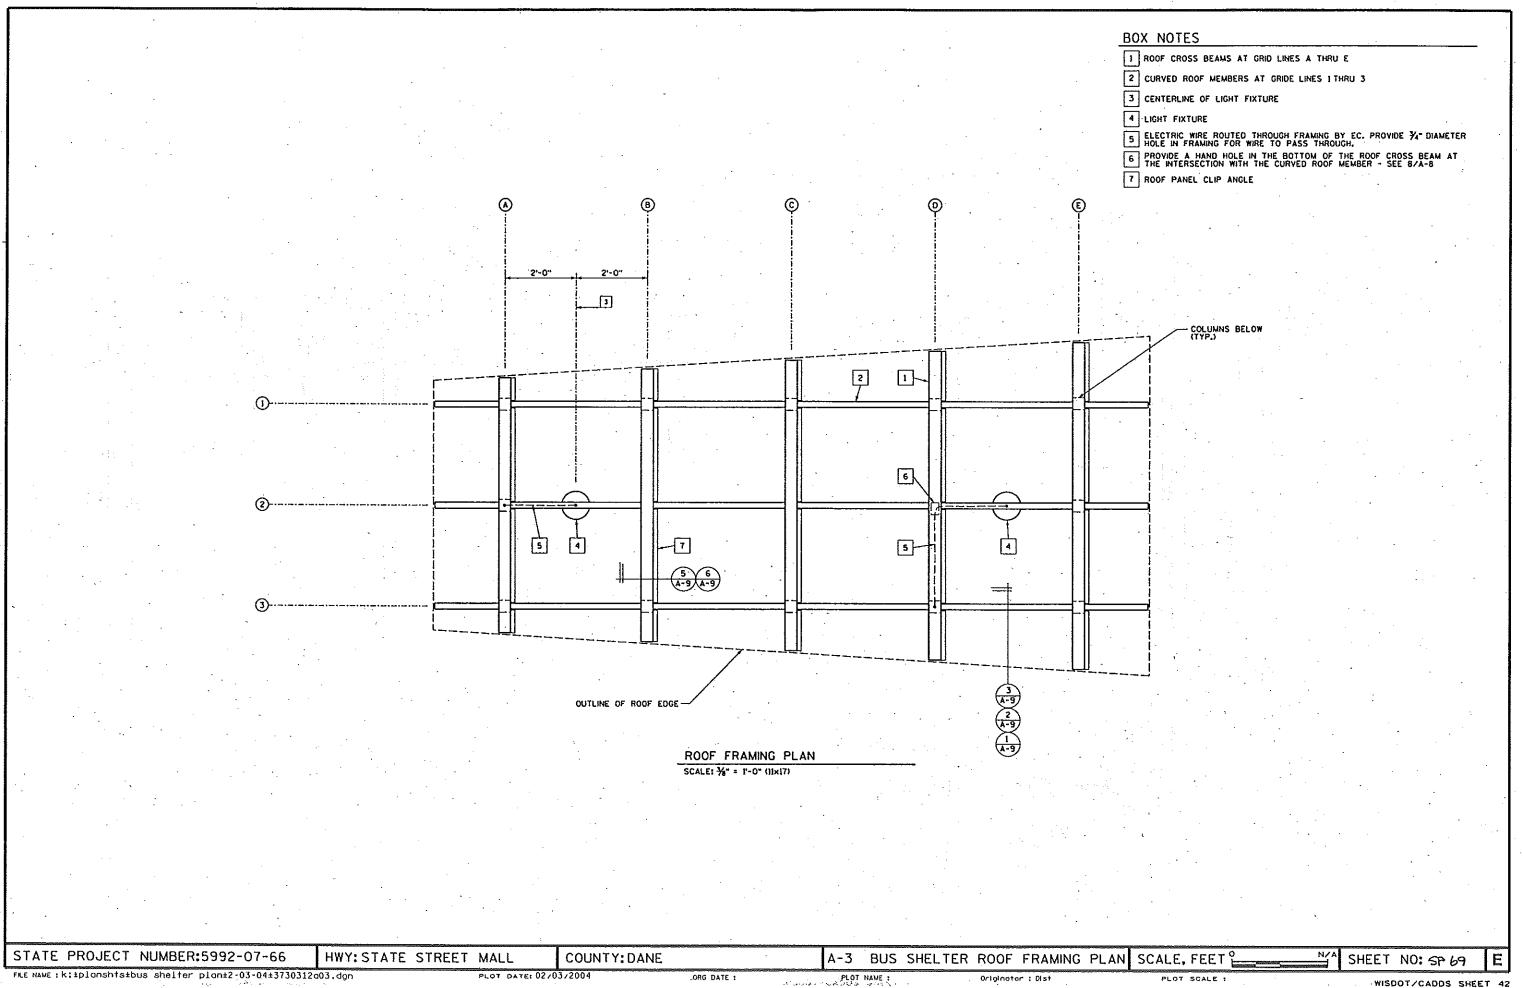

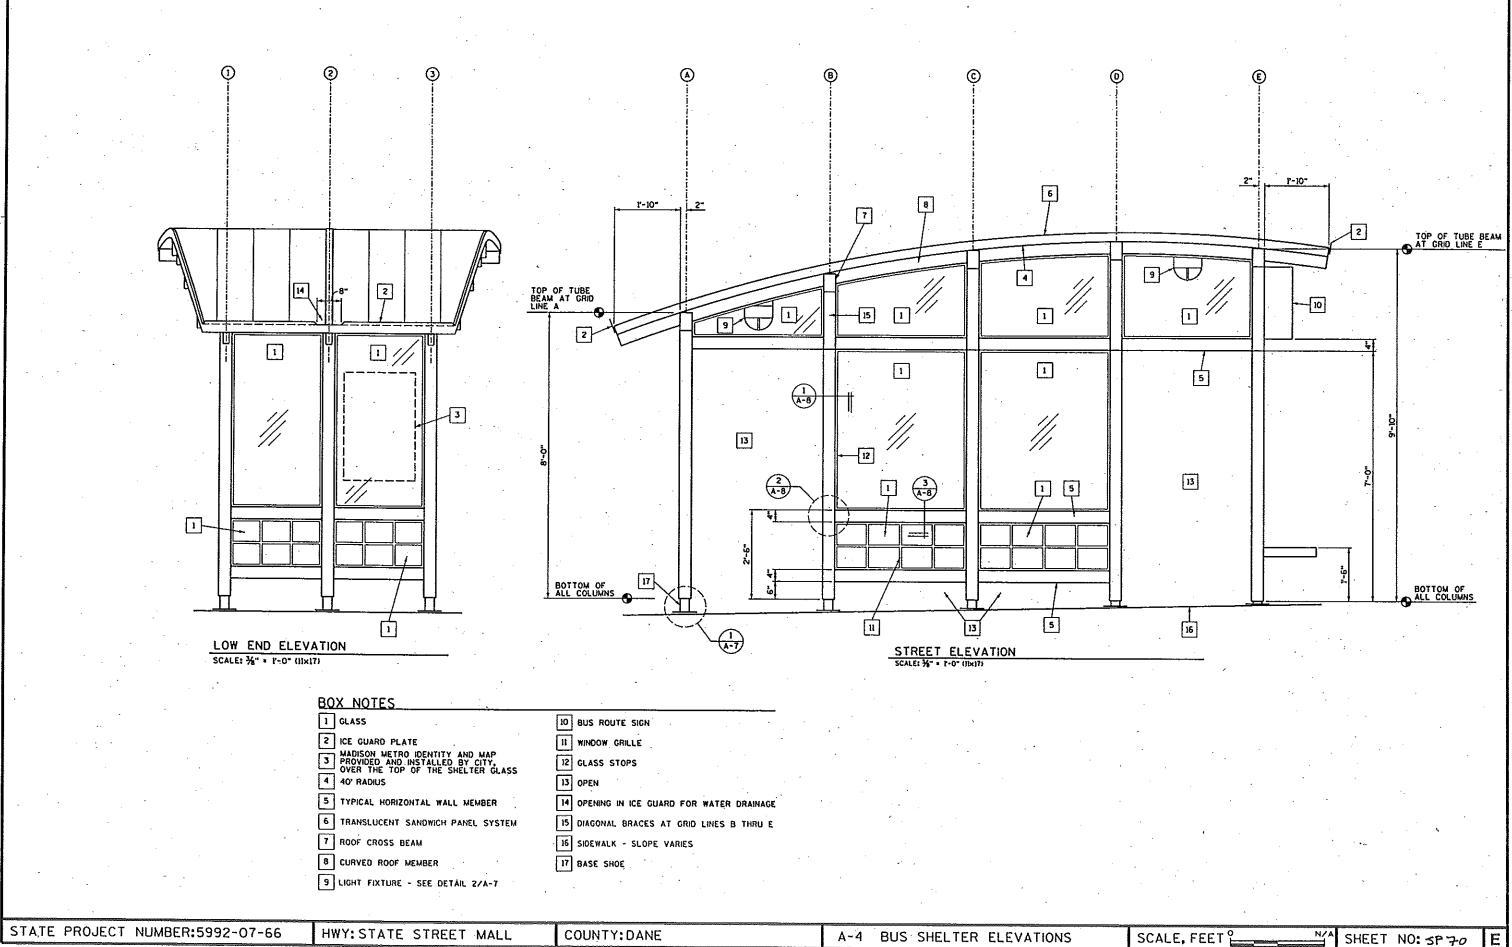

ORG DATE :

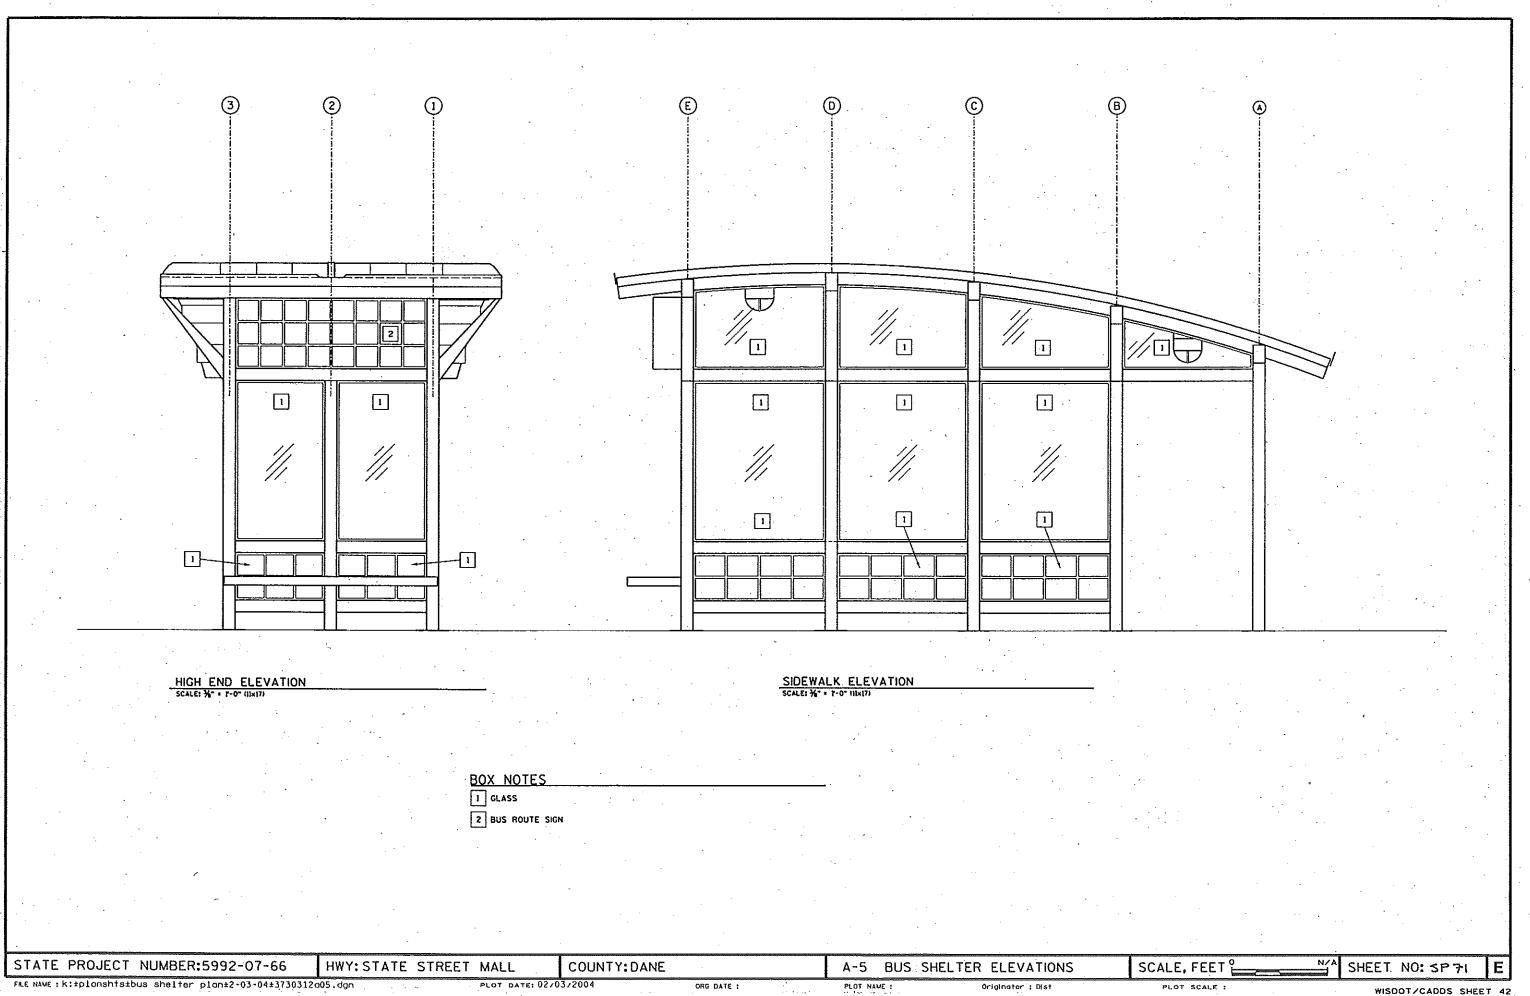

FRE NAME: k: plonshtstbus shelter plont2-03-04t3730312005.dgn


PLOT DATE: 02/03/2004

Originator : Dist

PLOT SCALE :

WISDOT/CADDS SHEET 42

Electrical Room and Bathrooms

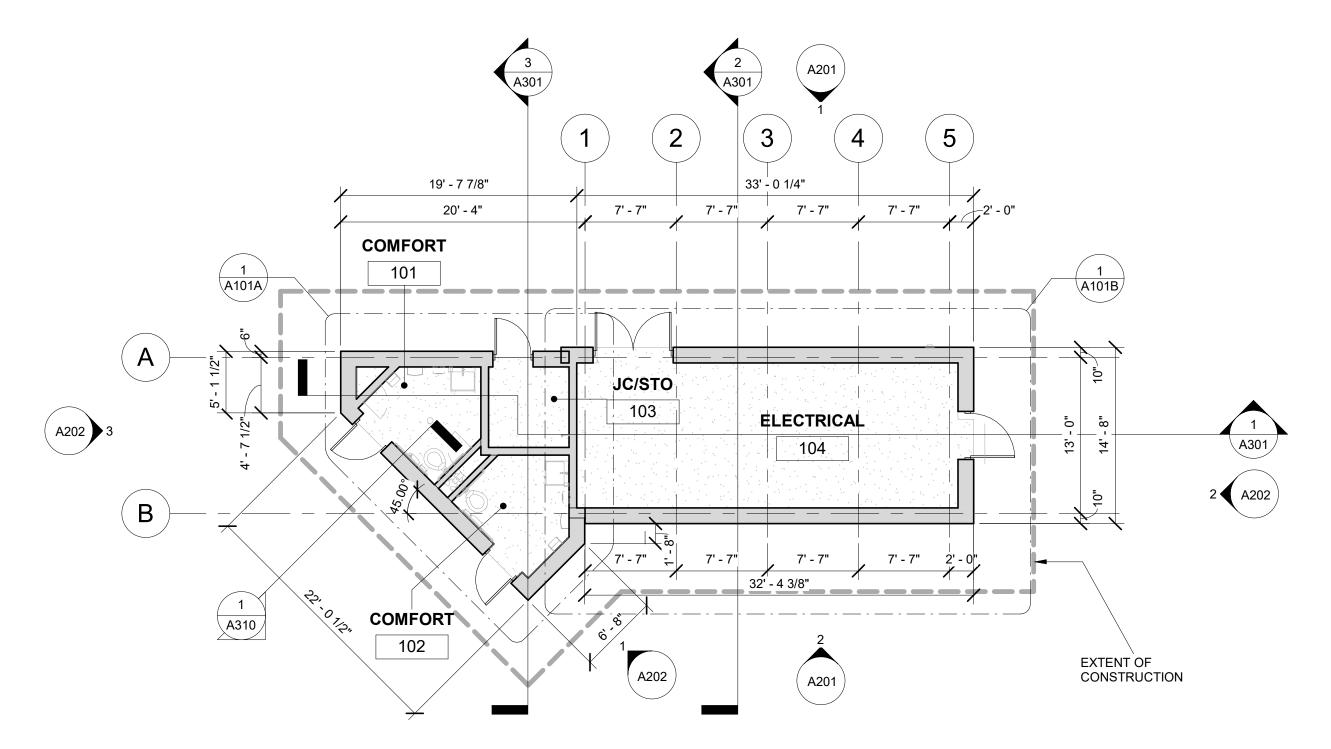



1 FINISH FLOOR COMBINED


A201 Scale: 1/8" = 1'-0"


A020

60631225P

CITY OF MADISON, DANE COUNTY, WI

CONTRACT NO: 60631225C

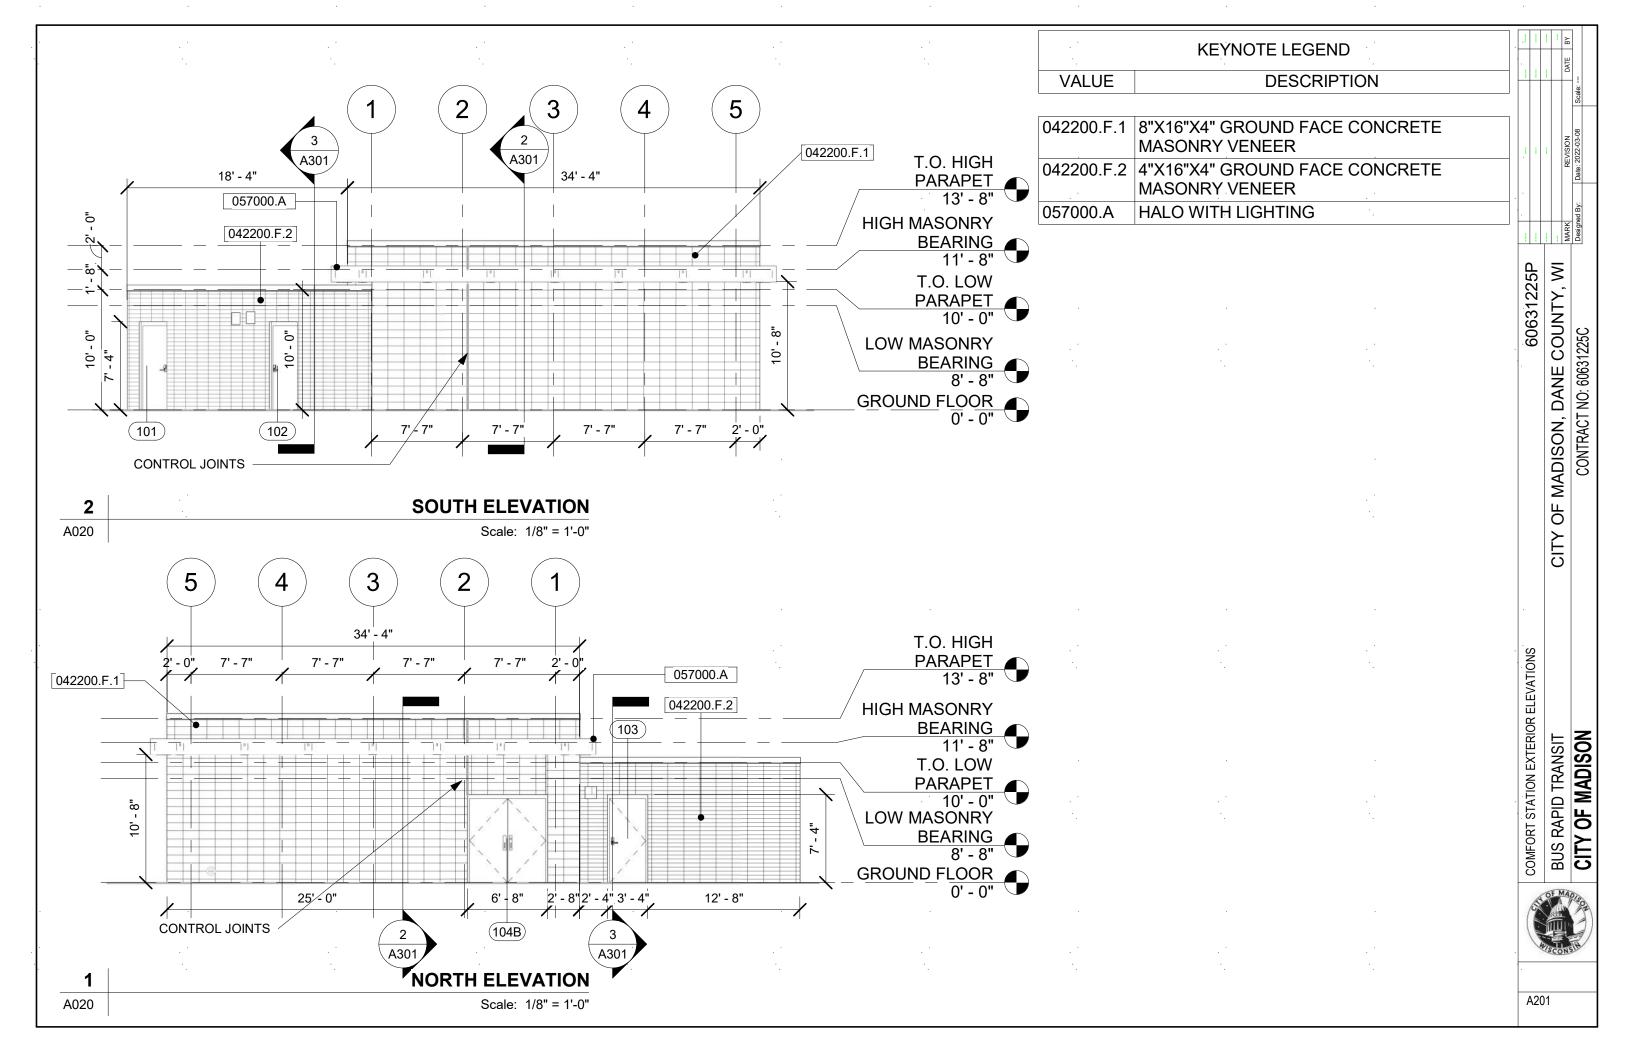

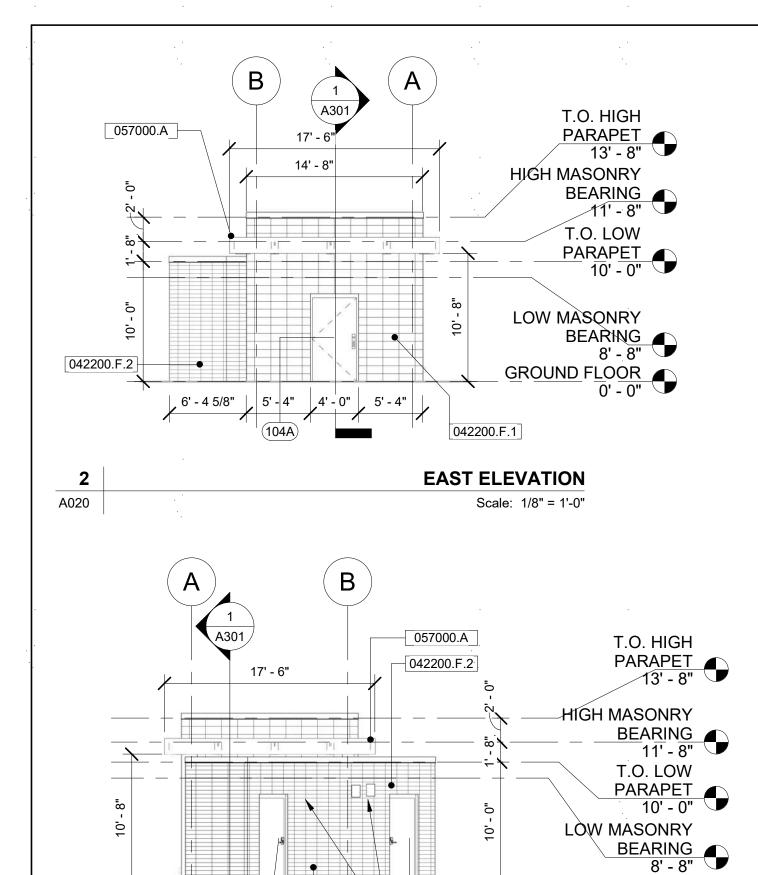

[102]

-MECH. LOUVERS

WEST ELEVATION

Scale: 1/8" = 1'-0"

101

042200.F.2


5' - 1 1/2"

3

A020



042200.F.1	8"X16"X4" GROUND FACE CONCRETE MASONRY VENEER
042200.F.2	4"X16"X4" GROUND FACE CONCRETE MASONRY VENEER
057000.A	HALO WITH LIGHTING

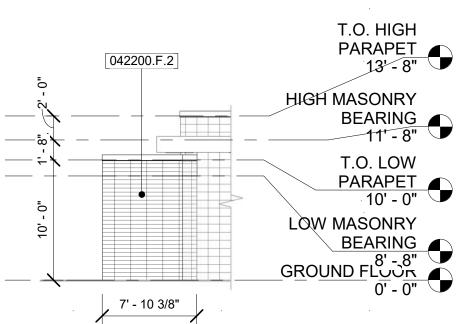

SOUTHEAST ELEVATION 1 Scale: 1/8" = 1'-0"

CITY OF MADISON **BUS RAPID TRANSIT**

OF MADISON, DANE COUNTY, WI

CITY

CONTRACT NO: 60631225C


60631225P

A020


GROUND FLOOR 0' - 0"

A202


COMFORT STATION EXTERIOR ELEVATIONS

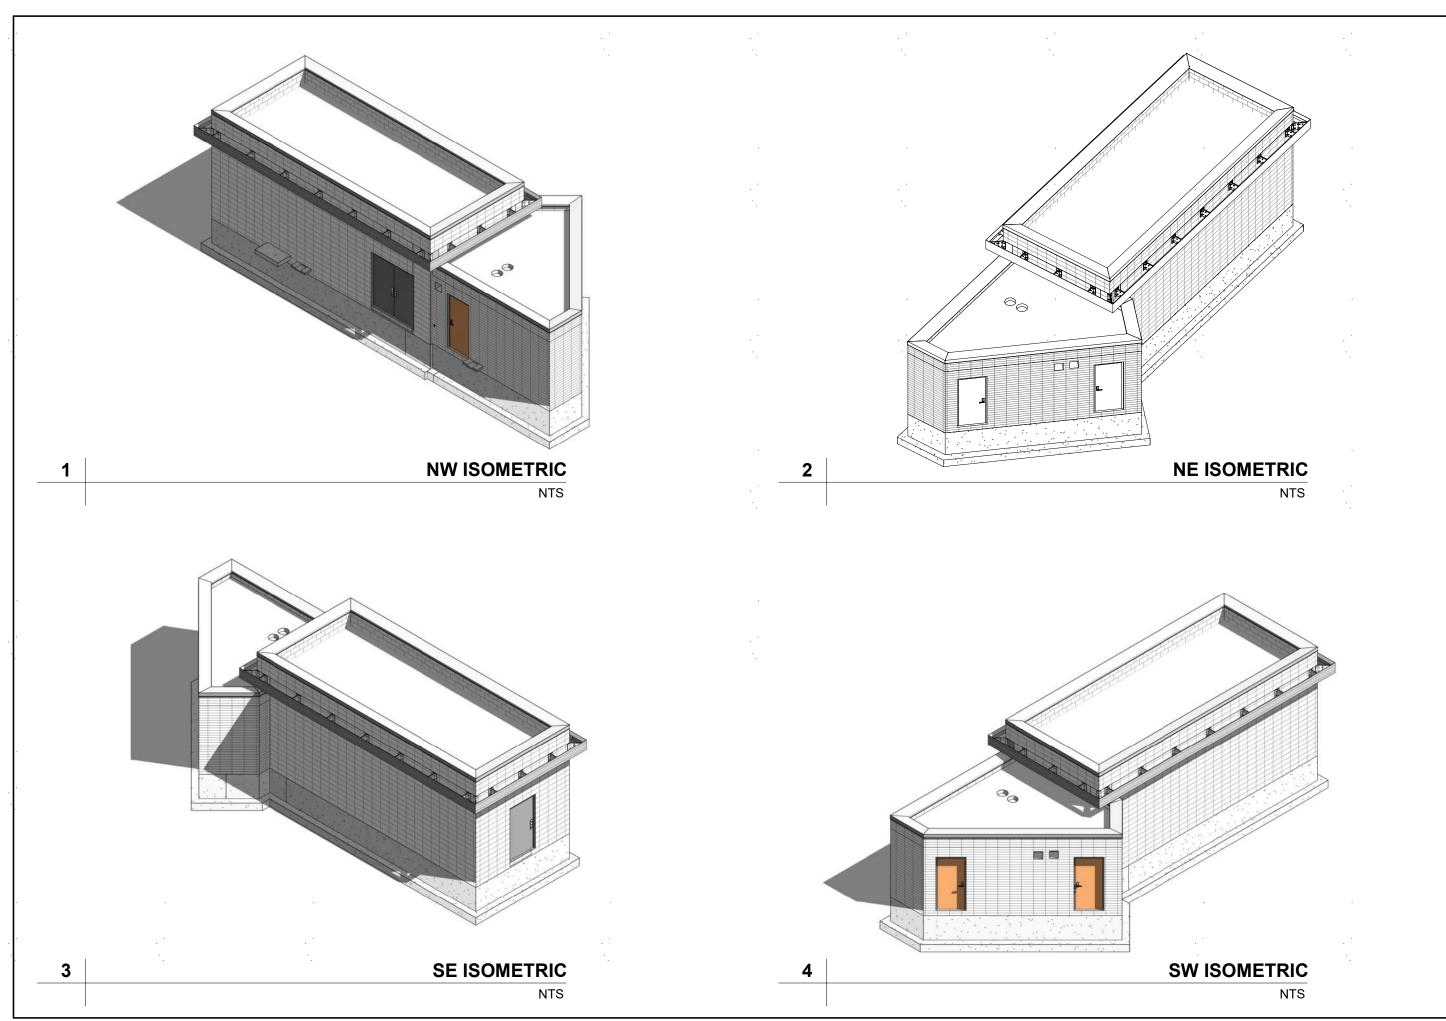

60631225P CITY OF MADISON, DANE COUNTY, WI CONTRACT NO: 60631225C COMFORT STATION ISOMETRIC VIEWS COMBINED BUS RAPID TRANSIT
CITY OF MADISON

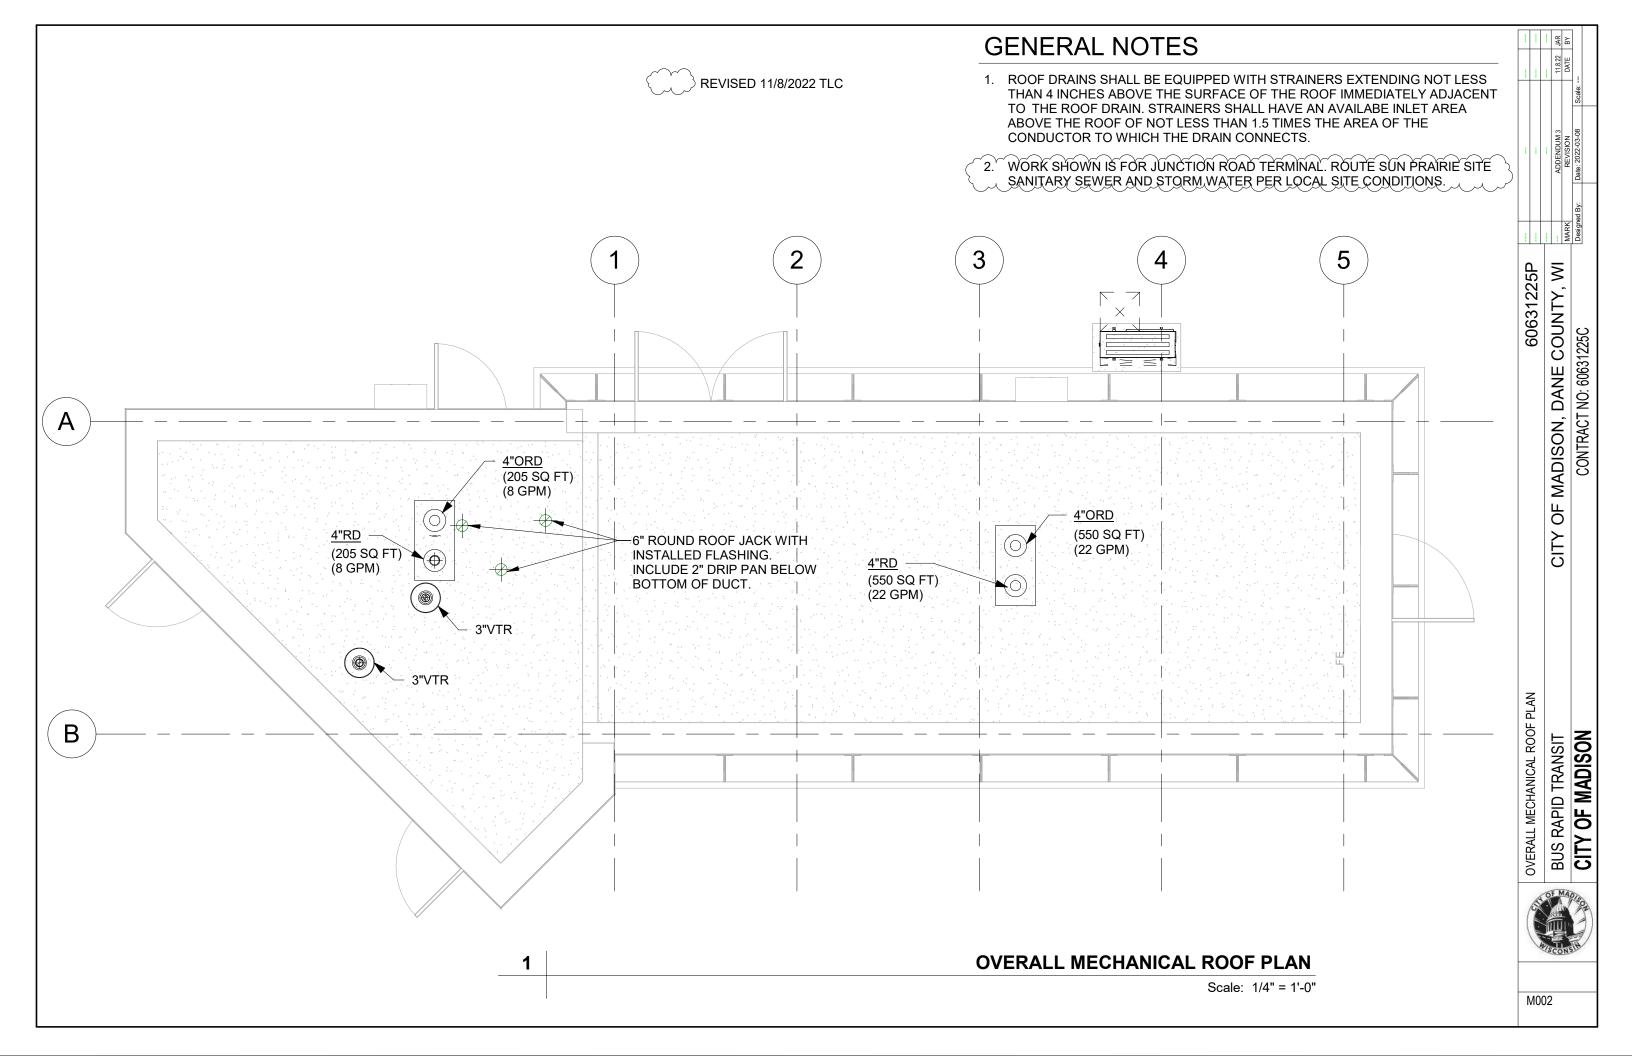



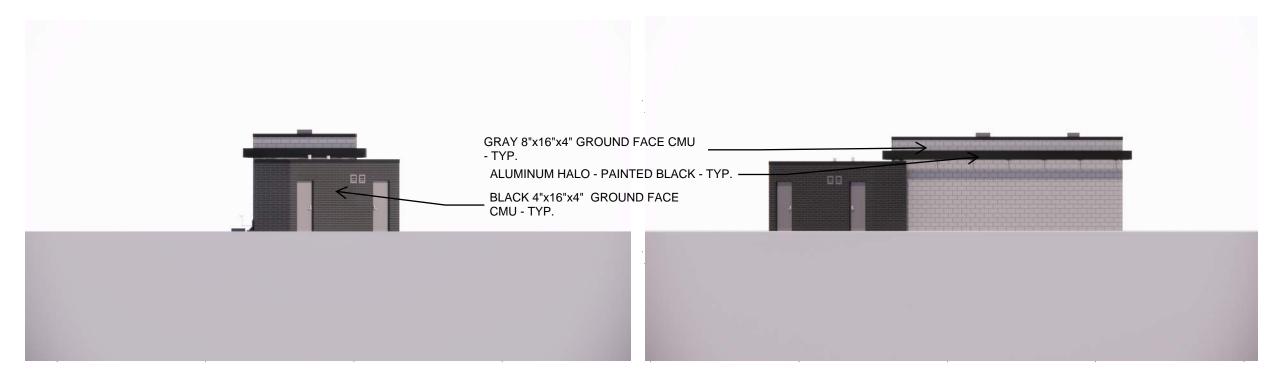

COMFORT STATION ELEVATIONS

60631225P CITY OF MADISON, DANE COUNTY, WI COMFORT STATION ISOMETRIC VIEWS COMBINED

CONTRACT NO: 60631225C

BUS RAPID TRANSIT






GRAY 8"x16"x4" GROUND FACE CMU -TYP.

TYP.

BLACK 4"x16"x4" GROUND FACE CMU -TYP.

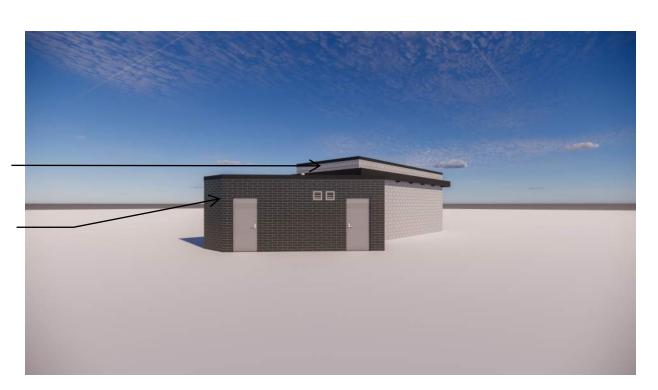

COMFORT STATION RENDERINGS

NTS

60631225P CITY OF MADISON, DANE COUNTY, WI CONTRACT NO: 60631225C

COMFORT STATION ISOMETRIC VIEWS COMBINED




ARCHITECTURE GRAPHIC SYMBOLS DETAIL / DRAWING NUMBER MODIFIER, IF NECESSARY PLAN DETAIL NUMBER / LETTER SHEET WHERE DETAIL IS SHOWN DIRECTION OF ELEVATION VIEW **ELEVATION TAG** SHEET ELEVATION IS SHOWN SHEET SECTION IS SHOWN **BUILDING SECTION NUMBER / LETTER** DETAIL SECTION NUMBER / LETTER SHEET SECTION IS SHOWN SHEET SECTION IS SHOWN DIRECTION OF SECTION VIEW DIRECTION OF SECTION VIEW

VICINITY MAP

PROJECT LOCATION

CITY, STATE

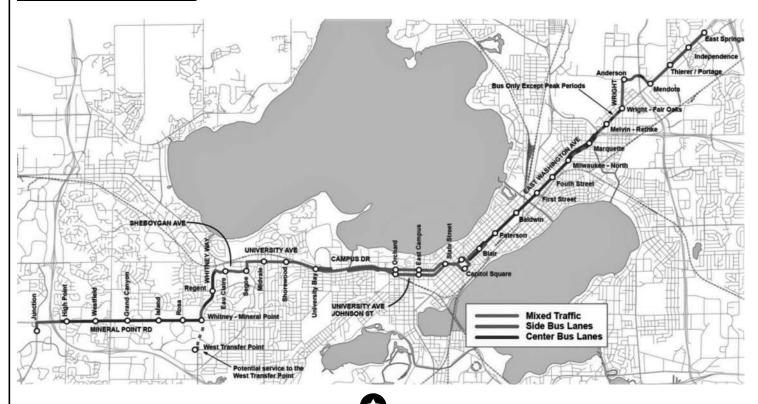

ARCHITECTURAL ABBREVIATIONS

A:	C:	E:	H:	O: OA OVERALL
AB ANCHOR BOLT	CAB CABINET	EA EACH	H HIGH	
ABV ABOVE	CC CENTER TO CENTER CEM CEMENT	EB EXPANSION BOLT	HES HIGH EARLY- STRENGTH	
AC ACOUSTICAL		EF EACH FACE	HM HOLLOW METAL	OD OUTSIDE DIAM
ACC ACCESS	CFL COUNTER-FLASHING	EJ EXPANSION JOINT	HORZ HORIZONTAL	OF OUTSIDE FACE
AD AREA DRAIN	CH CEILING HEIGHT	EL ELEVATION	HP HIGH POINT	OP OPAQUE
ADD ADDENDUM	CJ CONTROL JOINT	ELEC ELECTRIC, ELECTRICAL	HR HANDRAIL	OPG OPENING
ADH ADHESIVE	CK CAULK, CAULKING	ENC ENCLOSE, ENCLOSURE	HT HEIGHT	OPH OPPOSITE HA
ADJ ADJACENT	CLG CEILING	EP ELECTRICAL PANELBOARD	HTG HEATING	OPP OPPOSITE
ADJT ADJUSTABLE	CLR CLEAR, CLEARANCE	EPC EPOXY COATING	L:	OPS OPPOSITE SU
AESS ARCHITECTURAL EXPOSED STRUCTURAL	CLS CLOSURE	EQ EQUAL	L LENGTH	OWJ OPEN WEB J
STEEL	COL COLUMN	EQP EQUIPMENT	LC LIGHT CONTROL	P:
AFF ABOVE FINISHED FLOOR	COMB COMBINATION	EW EACH WAY	LG LONG	PAR PARALLEL
AGG AGGREGATE	CONC CONCRETE		LH LEFT HAND	PERF PERFORATE,
AL ALUMINUM	CONCT CONCRETE TOPPIN		LL LIVE LOAD	
	CONN CONNECTION	EXP EXPOSED	LMC LINEAR METAL CEILING	PERI PERIMETER
ALT ALTERNATE	CORR CORRUGATED	EXPN EXPANSION	LPT LOW POINT	PF PORTAL FRAM
AMP ACOUSTICAL METAL PANEL	CONST CONSTRUCTION	F:		PFB PREFABRICAT
MR ACOUSTICAL METAL ROOF	CONT CONTINUOUS	FBO FURNISHED BY OTHERS	M:	PFN PREFINISHED
ANR ANCHOR, ANCHORAGE	CONTR CONTRACTOR,	FDN FOUNDATION	M METER	PNL PANEL
NOD ANODIZED		FFE FINISH FLOOR ELEVATION	MAS MASONRY	PRF PREFORMED
AP ACCESS PANEL	D DRAIN	FFL FINISHED FLOOR LINE	MAX MAXIMUM	PREFB PREFABRIO
PX APPROXIMATE	DEP DEPRESSED	FIN FINISH, FINISHED	MB MACHINE BOLT	PSC PRESTRESSE
3:	DIA DIAMETER	FJT FLUSH JOINT	MBR MEMBER	PSF POUNDS PER
BD BOARD	DIAG DIAGONAL	FLG FLASHING	MET METAL	PSI POUNDS PER
BEL BELOW	DM DIMENSION	FLX FLEXIBLE	MEZZ MEZZANINE	PTC POST-TENSIO
BET BETWEEN	DIV DIVISION	FOF FACE OF FINISH	MFR MANUFACTURER	PVMT PAVEMENT
BF BARRIER-FREE	DK DECK	FOS FACE OF STUDS	MMB MEMBRANE	R:
BIT BITUMINOUS	DL DEAD LOAD	FR FRAME, FRAMED,	MRD METAL ROOF DECK	RCP REINFORCED
BJT BED JOINT	DN DOWN	FT FOOT, FEET	MT MOUNT, MOUNTED,	RD ROOF DRAIN
BLK BLOCK (STANDARD WEIGHT	DP DAMPPROOFING	FTG FOOTING	MTFR METAL FURRING	RE REINFORCE, R
BM BEAM, BENCHMARK		G:	MTL MATERIAL	REF REFERENCE
вот воттом	DS DOWNSPOUT	GA GAUGE	MULL MULLION	REINF REINFORCE
P BEARING PLATE	DSAGL DSA GLASS	GD GRADE, GRADING	N:	REM REMOVE, RE
RG BEARING	DSBGL DSB GLASS	GKT GASKET, GASKETED	NMT NON-METALLIC	REQ REQUIRED
AC POTH CIDEO	DT DRAIN TILE		NOM NOMINAL	REV REVISED, REV
BS BOTH SIDES	DTL DETAIL	GL GLASS, GLAZING	NS NEAR SIDE	RFG ROOFING
BT BENT	DWG DRAWING	GSS GALVANIZED STEEL SHEET GV GALVANIZED	NTS NOT TO SCALE	RH RIGHT HAND
BULT BULLETIN	DWL DOWEL	GV GALVANIZED GVL GRAVEL		RL RAIL, RAILING
BUR BUILT-UP ROOF		GVL GRAVEL		RO ROUGH OPEN
BVL BEVELED				ROW RIGHT OF W
BW BOTH WAYS				

SCH SCHEDULE SCN SCREEN SD STORM DRAIN SEC SPECIAL EQUIPMENT SG SHEET GLASS SHO SHORE, SHORED, SHORING SHT SHEET SHTH SHEATHING OPS OPPOSITE SURFACE SKL SKYLIGHT SL SLEEVE SLR SEALER SLT SLATE PERF PERFORATE, PERFORATED SNT SEALANT SPEC SPECIFICATION SPK SPEAKER SQ SQUARE SS STAINLESS STEEL STA STATION STD STANDARD STG SEATING PSC PRESTRESSED CONCRETE STL STEEL PSF POUNDS PER SQUARE STO STORAGE PSI POUNDS PER SQUARE STR STRAIGHT STRUCT STRUCTURAL SWM SURFACE APPLIED SYM SYMMETRICAL, SYMMETRY RCP REINFORCED CONCRETE RE REINFORCE, REINFORCED, TC TOP CHORD THK THICK THICKNESS TOC TOP OF CONCRETE TOF TOP OF FOOTING REM REMOVE REMOVABLE TOJ TOP OF JOIST TOL TOLERANCE TOM TOP OF MASONRY TSL TOP OF SLAB TST TOP OF STEEL TYP TYPICAL T&B TOP AND BOTTOM V VERTICAL VA VARIES VIF VERIFY IN FIELD W WIDTH, WIDE W/ WITH WIN WINDOW

> WO WITHOUT WP WATERPROOF,

WPT WORKING POINT WR WATER REPELLENT 60631225P

COUNTY,

MADISON, DANE

OF.

CONTRACT NO: 60631225C

PREFB PREFABRICATED

PTC POST-TENSIONED

REQ REQUIRED REV REVISED, REVISION

RO ROUGH OPENING

ROW RIGHT OF WAY

PFB PREFABRICATED

OPH OPPOSITE HAND

OWJ OPEN WEB JOIST

OD OUTSIDE DIAMETER


BUS RAPID TRANSIT
CITY OF MADISON

ARCHITECTURAL COVER SHEET

60631225P

G000

Overhead Charger Example Pictures from Milwaukee BRT

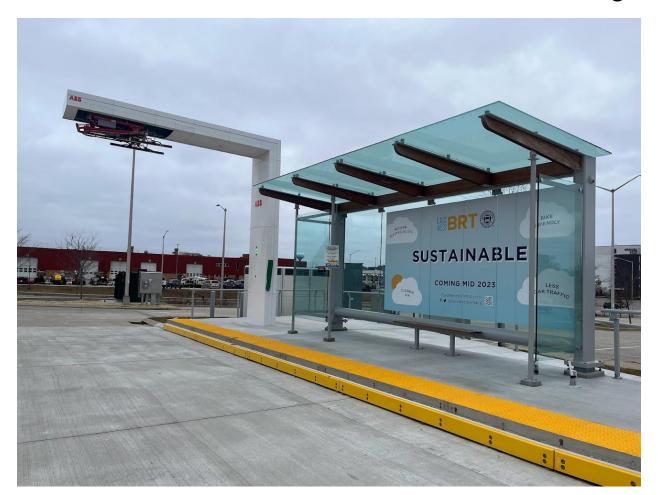





Bike Shelter and Rack

