


SITE CONSTRUCTION NOTES:

- CONCRETE SIDEWALK TO BE 5" THICK, CONSTRUCTED ON A BASE OF 4" COMPACTED SAND OR CRUSHED STONE.
- CONCRETE FOR DRIVEWAYS AND SIDEWALK AT DRIVEWAY ENTRANCES SHALL BE 7" THICK, CONSTRUCTED ON A BASE OF 5" COMPACTED SAND OR CRUSHED STONE.
- CURB FACE HEIGHT ON DRIVEWAYS SHALL BE 6 INCHES. CURB FACE IN PARKING LOTS SHALL BE 4 INCHES.
- CONTRACTOR SHALL DEEPL TILL ANY DISTURBED AREAS AFTER CONSTRUCTION IS COMPLETE AND BEFORE RESTORING.
- CONTRACTOR SHALL MAINTAIN NECESSARY UTILITY CONNECTION, DEMONSTRATE DRIVEWAY CONNECTION, RIGHT-OF-WAY AND EXCAVATOR PERMITS PRIOR TO CONSTRUCTION.
- ALL ABANDONED DRIVEWAYS ADJACENT TO THE SITE SHALL BE REPLACED WITH CURB AND THE TERRACE SHALL BE RESTORED WITH GRASS.
- ANY SIDEWALK AND CURB & GUTTER ALONG THE PROPERTY SHALL BE REPLACED IF IT IS DAMAGED DURING CONSTRUCTION OR IF THE CITY ENGINEER DETERMINES THAT IT IS NOT AT A DESIRABLE GRADE, REGARDLESS OF WHETHER THE CONDITION EXISTED PRIOR TO BEGINNING CONSTRUCTION.

DEMOLITION/EROSION CONTROL NOTES:

- CONTRACTOR SHALL KEEP ALL CITY STREETS FREE AND CLEAR OF CONSTRUCTION RELATED DIRT/DUST/DEBRIS.
- COORDINATE EXISTING UTILITY REMOVAL/ABANDONMENT WITH LOCAL AUTHORITIES AND UTILITY COMPANIES HAVING JURISDICTION.
- ALL SAWCUTTING SHALL BE FULL DEPTH TO PROVIDE A CLEAN EDGE TO MATCH NEW CONSTRUCTION MATCH EXISTING ELEVATIONS AT POINTS OF CONNECTION FOR NEW AND EXISTING PAVEMENT, CURB, SIDEWALKS, ETC. ALL SAWCUT LOCATIONS SHOULD BE APPROXIMATE AND MAY BE FIELD ADJUSTED TO ACCOMMODATE CONDITIONS, JOINTS, MATERIAL TYPE, ETC. REMOVE MINIMUM AMOUNT NECESSARY FOR INSTALLATION OF PROPOSED IMPROVEMENTS.
- CONTRACTOR SHALL PROVIDE AND SHALL BE RESPONSIBLE FOR ANY NECESSARY TRAFFIC CONTROL SIGNAGE AND SAFETY MEASURES DURING DEMOLITION AND CONSTRUCTION OPERATIONS WITHIN OR NEAR THE PUBLIC ROADWAY.
- COORDINATE TREE REMOVAL WITH LANDSCAPE ARCHITECT. ALL TREES TO BE REMOVED SHALL BE REMOVED IN THEIR ENTIRETY AND STUMPS SHALL BE GROUND TO 12" BELOW PROPOSED SUBGRADE.
- IF APPLICABLE, PROVIDE TREE PROTECTION FENCING PRIOR TO CONSTRUCTION OPERATIONS. MANTAIN THROUGHOUT CONSTRUCTION.
- ALL LIGHT POLES TO BE REMOVED FROM PRIVATE PROPERTY SHALL BE REMOVED IN THEIR ENTIRETY, INCLUDING BASE AND ALL APPURTENANCES. COORDINATE ABANDONMENT OF ELECTRICAL LINES WITH ELECTRICAL ENGINEER AND OWNER PRIOR TO DEMOLITION.
- CONTRACTOR SHALL CLOSE ALL ABANDONED DRIVEWAYS BY REPLACING THE CURB IN FRONT OF THE DRIVEWAYS AND RESTORING THE TERRACE WITH GRASS.
- CONTRACTOR SHALL OBTAIN ANY NECESSARY DEMOLITION AND UTILITY PLUGGING PERMITS.
- THE LOCATION OF EXISTING UNDERGROUND UTILITIES AS SHOWN ON THE PLANS HAS BEEN DETERMINED FROM THE BEST AVAILABLE INFORMATION AND IS GIVEN FOR INFORMATION ONLY. THE CONTRACTOR, THE OWNER AND THE ENGINEER DO NOT ASSUME RESPONSIBILITY IN THE EVENT THAT DURING CONSTRUCTION, UTILITIES OTHER THAN THOSE SHOWN MAY BE ENCOUNTERED, AND THAT THE ACTUAL LOCATION OF THOSE WHICH ARE SHOWN MAY BE DIFFERENT FROM THE LOCATION AS SHOWN ON THE PLANS.
- ANY DAMAGE TO THE CITY PAVEMENT, INCLUDING DAMAGE RESULTING FROM CURB REPLACEMENT, WILL REQUIRE RESTORATION IN ACCORDANCE WITH THE CITY ENGINEERING PATCHING CRITERIA.


SITE PLAN LEGEND:
 PROPERTY BOUNDARY
 CURB AND GUTTER (REVERSE CURB HATCHED)
 PROPOSED CONCRETE
 PROPOSED SIDEWALK
 PROPOSED LIGHT POLE

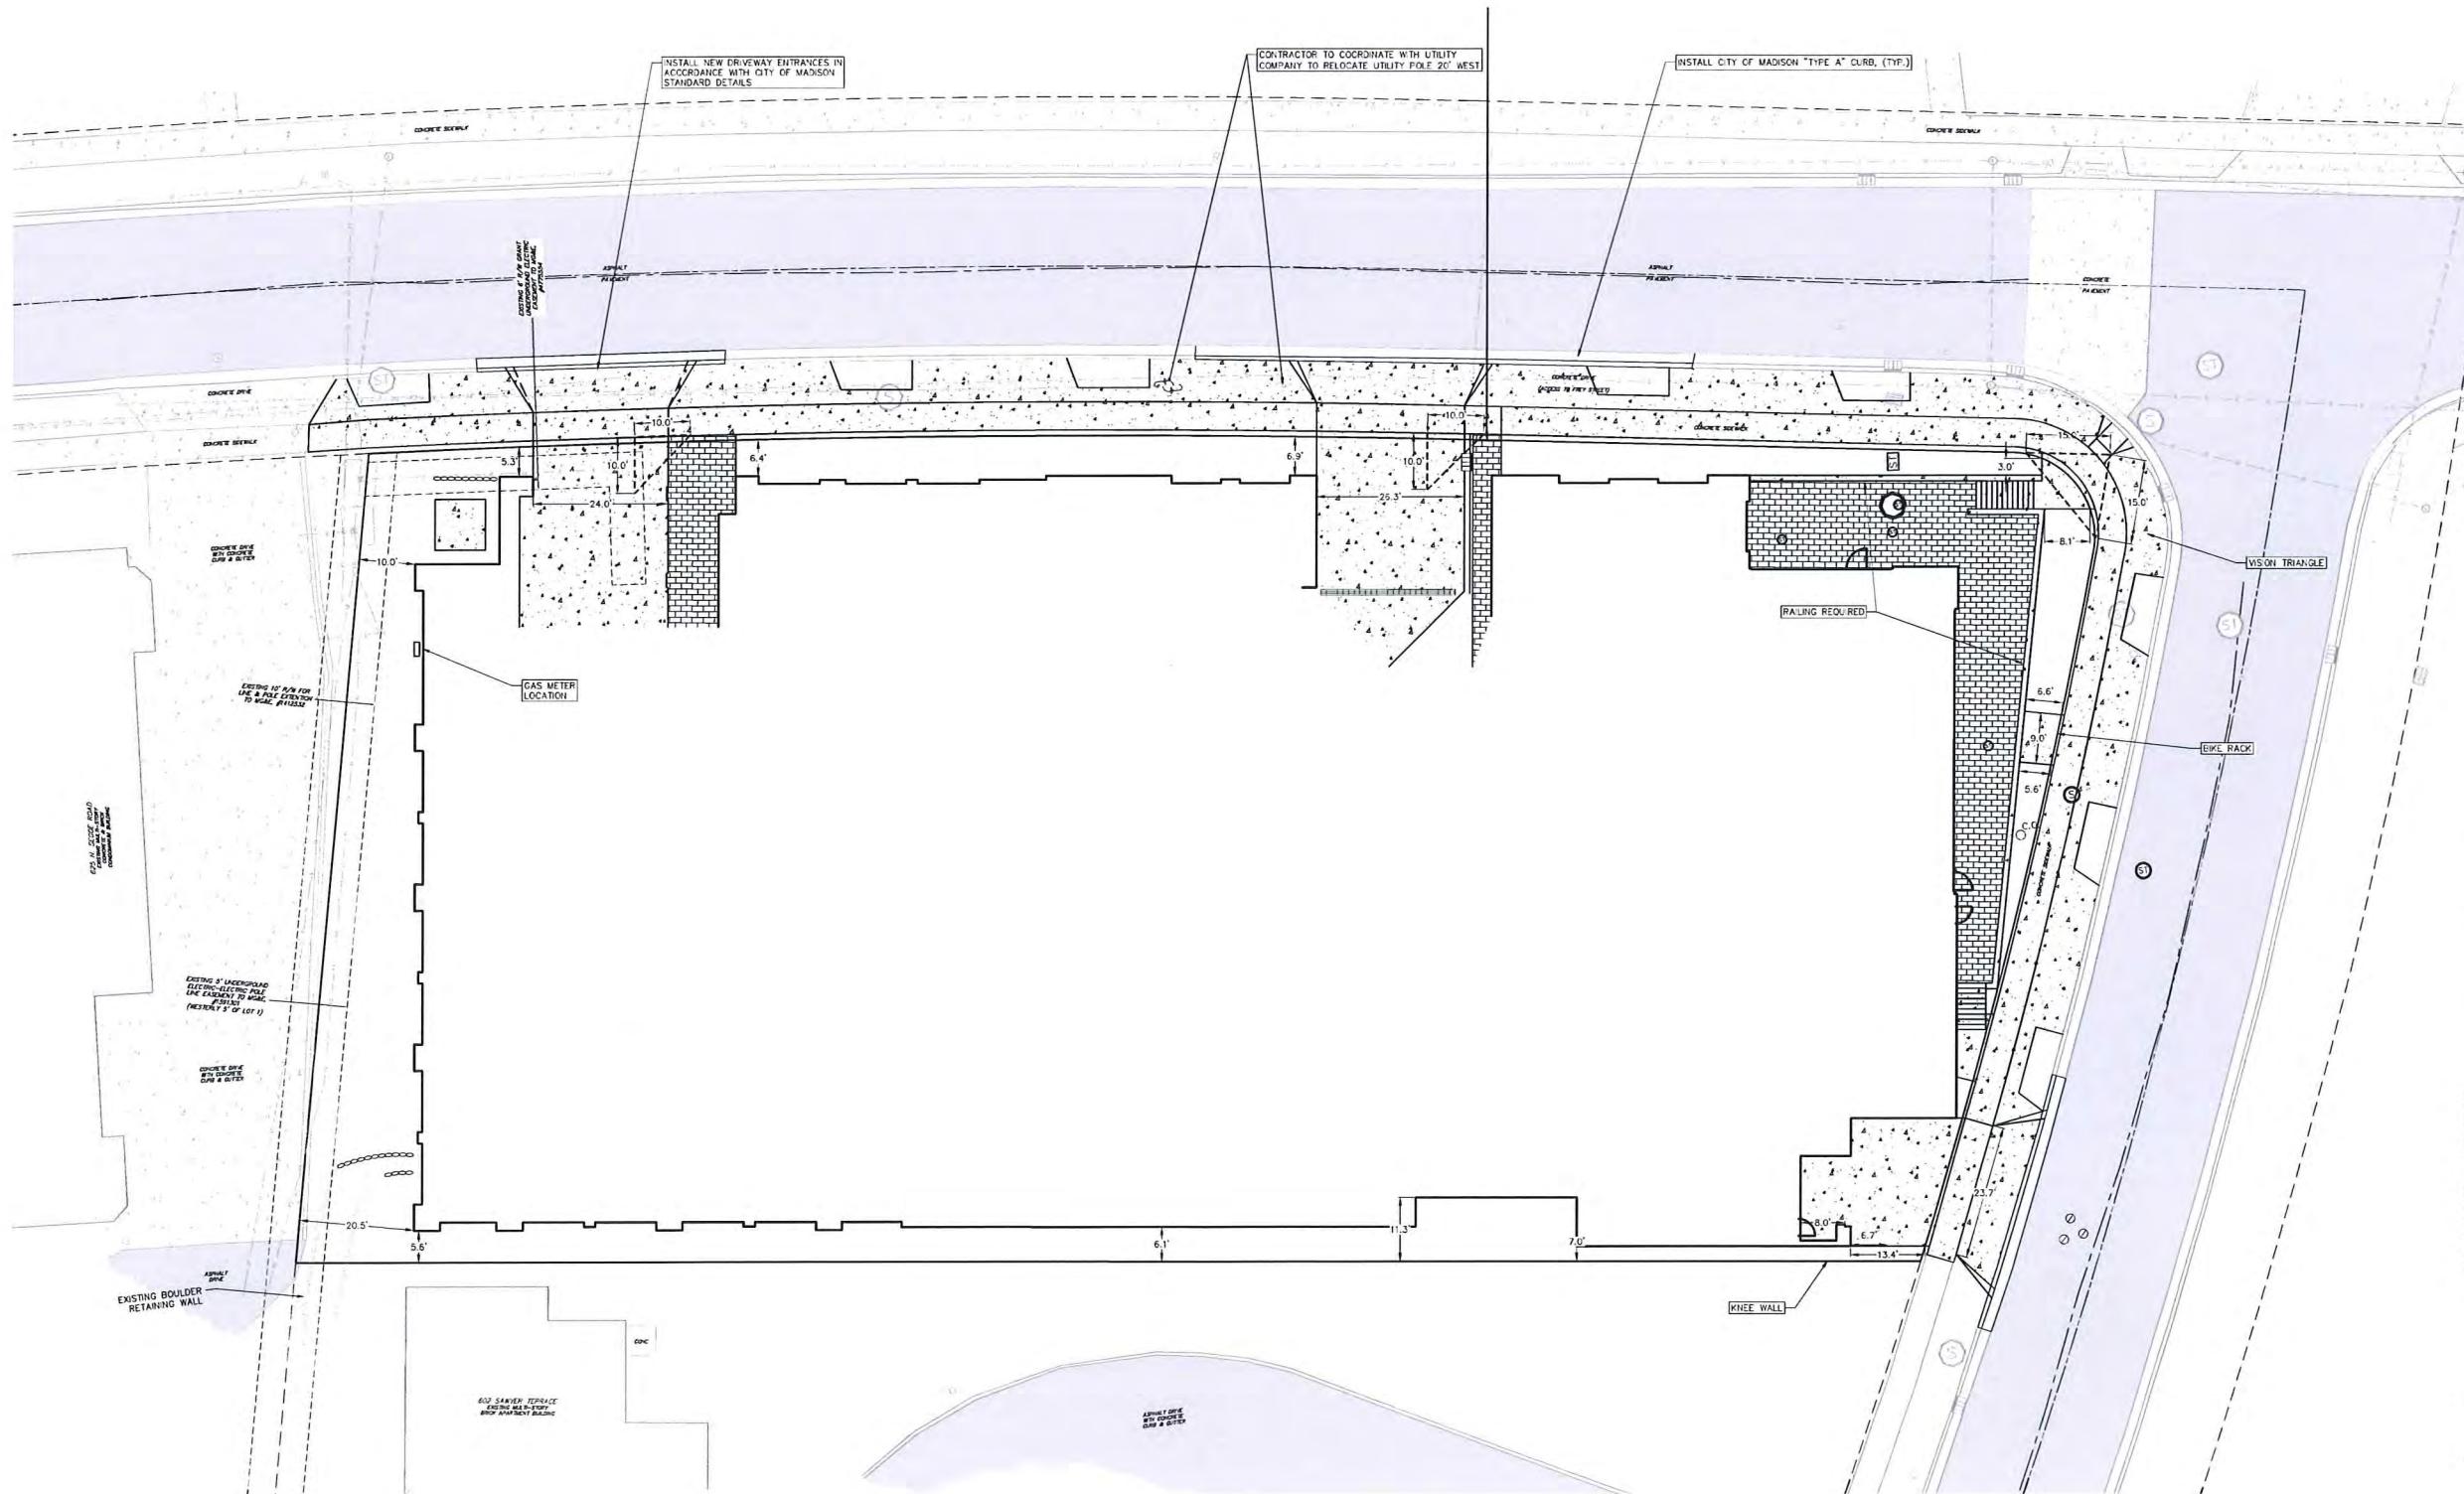


GRADING NOTES:

- CONTOURS ARE SHOWN FOR PURPOSES OF INDICATING ROUGH GRADING. FINAL GRADE SHALL BE ESTABLISHED ON PAVED SURFACES BY USING SPOT GRADES ONLY.
- SEE DETAIL SHEETS FOR EROSION CONTROL NOTES AND CONSTRUCTION SEQUENCE.
- INSTALL A 48" X 20'W X 1.5'D TRACKING PAD AT THE SITE ENTRANCE. THE TRACKING PAD SHALL BE MAINTAINED/REPARED AS NECESSARY TO ACCOMMODATE CONSTRUCTION.
- THE CONTRACTOR IS REQUIRED TO TAKE EROSION CONTROL INSPECTIONS AT THE END OF EACH WEEK AND WHEN 0.5 INCHES OF RAIN FALLS WITHIN 24 HOURS. INSPECTION REPORTS SHALL BE PREPARED AND FILED AS REQUIRED BY THE DNR. ALL MAINTENANCE/REPAIR WILL FOLLOW AN INSPECTION WITHIN 24 HOURS.
- INSTALL WI DOT TYPE D SILT PROTECTOR IN EXISTING CURB NETS AND WI DOT TYPE A IN FIELD INLETS.
- THE CONTRACTOR IS RESPONSIBLE FOR ANY DAMAGE CAUSED DURING CONSTRUCTION TO PUBLIC PROPERTY, PRIVATE PROPERTY OR UTILITIES.
- THE CONTRACTOR SHALL SUBMIT SHOP DRAWINGS FOR REVIEW BY THE ENGINEER, PRIOR TO PLACING AN ORDER OF ANY SUCH ITEM.
- EXISTING TOPOGRAPHIC INFORMATION IS BASED ON FIELD OBSERVATIONS AND/OR PLAN OF RECORD DRAWINGS. CONTRACTOR SHALL VERIFY TOPOGRAPHIC INFORMATION PRIOR TO STARTING CONSTRUCTION.
- CONTRACTOR SHALL VERIFY LOCATION OF EXISTING SANITARY SEWER, STORM SEWER AND WATER MAIN. PRIOR TO CONSTRUCTION TO ENSURE PROPER CLEARANCE OF THE NEW UTILITIES. CONTRACTOR MUST TAKE ALL NECESSARY PRECAUTIONS TO PROTECT EXISTING UTILITIES DURING CONSTRUCTION. ANY DAMAGE TO THE EXISTING UTILITIES AND ANY REPAIRS NEEDED AS A RESULT OF THE DAMAGE SHALL BE AT THE EXPENSE OF THE CONTRACTOR REGARDLESS OF THE LOCATION MARKED IN THE FIELD OR SHOWN ON THE PLANS.
- THE LOCATIONS OF EXISTING UTILITY INSTALLATIONS AS SHOWN ON THE PLAN ARE APPROXIMATE. THERE MAY BE OTHER UTILITY INSTALLATIONS WITHIN THE PROJECT AREA THAT ARE NOT SHOWN. CONTRACTOR SHALL BE RESPONSIBLE FOR CONTACTING DIGGERS HOTLINE AND LOCATING ALL EXISTING UTILITIES AND ENSURE PROPER CLEARANCE OF NEW UTILITIES.
- SEE DETAIL SHEETS FOR EROSION CONTROL NOTES AND CONSTRUCTION SEQUENCE.
- THE CONTRACTOR SHALL REMOVE ANY SEDIMENT TRACED ONTO ADJACENT ROADS BY MEANS OF STREET SWEEPING (NOT FLUSHING) AT A MINIMUM OF THE END OF EACH WORK DAY OR MORE AS NEEDED.
- RIGHT OF WAY (ROW) AND PROPERTY LINES ARE APPROXIMATE. CONTRACTOR SHALL BE RESPONSIBLE FOR PROTECTING EXISTING PROPERTY CORNER MONUMENTATION. ANY MONUMENTS DISTURBED BY CONTRACTOR SHALL BE REPLACED AT THE CONTRACTOR'S EXPENSE.

- CROSS-SLOPE OF SIDEWALKS SHALL BE 2% UNLESS OTHERWISE NOTED.
- LONGITUDINAL GRADE OF SIDEWALK RAMPS SHALL NOT EXCEED 8.33% (1:12) AND SHALL BE IN ACCORDANCE WITH ADA REQUIREMENTS.
- ACCESSIBLE ROUTES SHALL BE 1% MAX LONGITUDINAL SLOPE AND 2% MAX CROSS SLOPE. ACCESSIBLE LOADING AREAS OR LANDINGS SHALL BE 2% MAX SLOPE IN ANY DIRECTION. RAMPS SHALL BE 8.33% MAX SLOPE.
- CONTRACTOR SHALL COORDINATE WITH BPV UTILITY COMPANIES REGARDING ANY POTENTIAL CONFLICTS AND COORDINATE RELOCATIONS AS MAY BE REQUIRED. CONTRACTOR SHALL ALSO COORDINATE THE PROPOSED INSTALLATION OF NEW FACILITIES AS REQUIRED.
- EXISTING SPOT ELEVATIONS
- PROPOSED SPOT ELEVATIONS
- INLET PROTECTION
- EROSION MAT CLASS
- TRACKING PAD

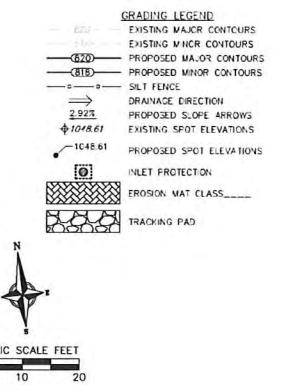

GRAPHIC SCALE FEET
0 5 10 20

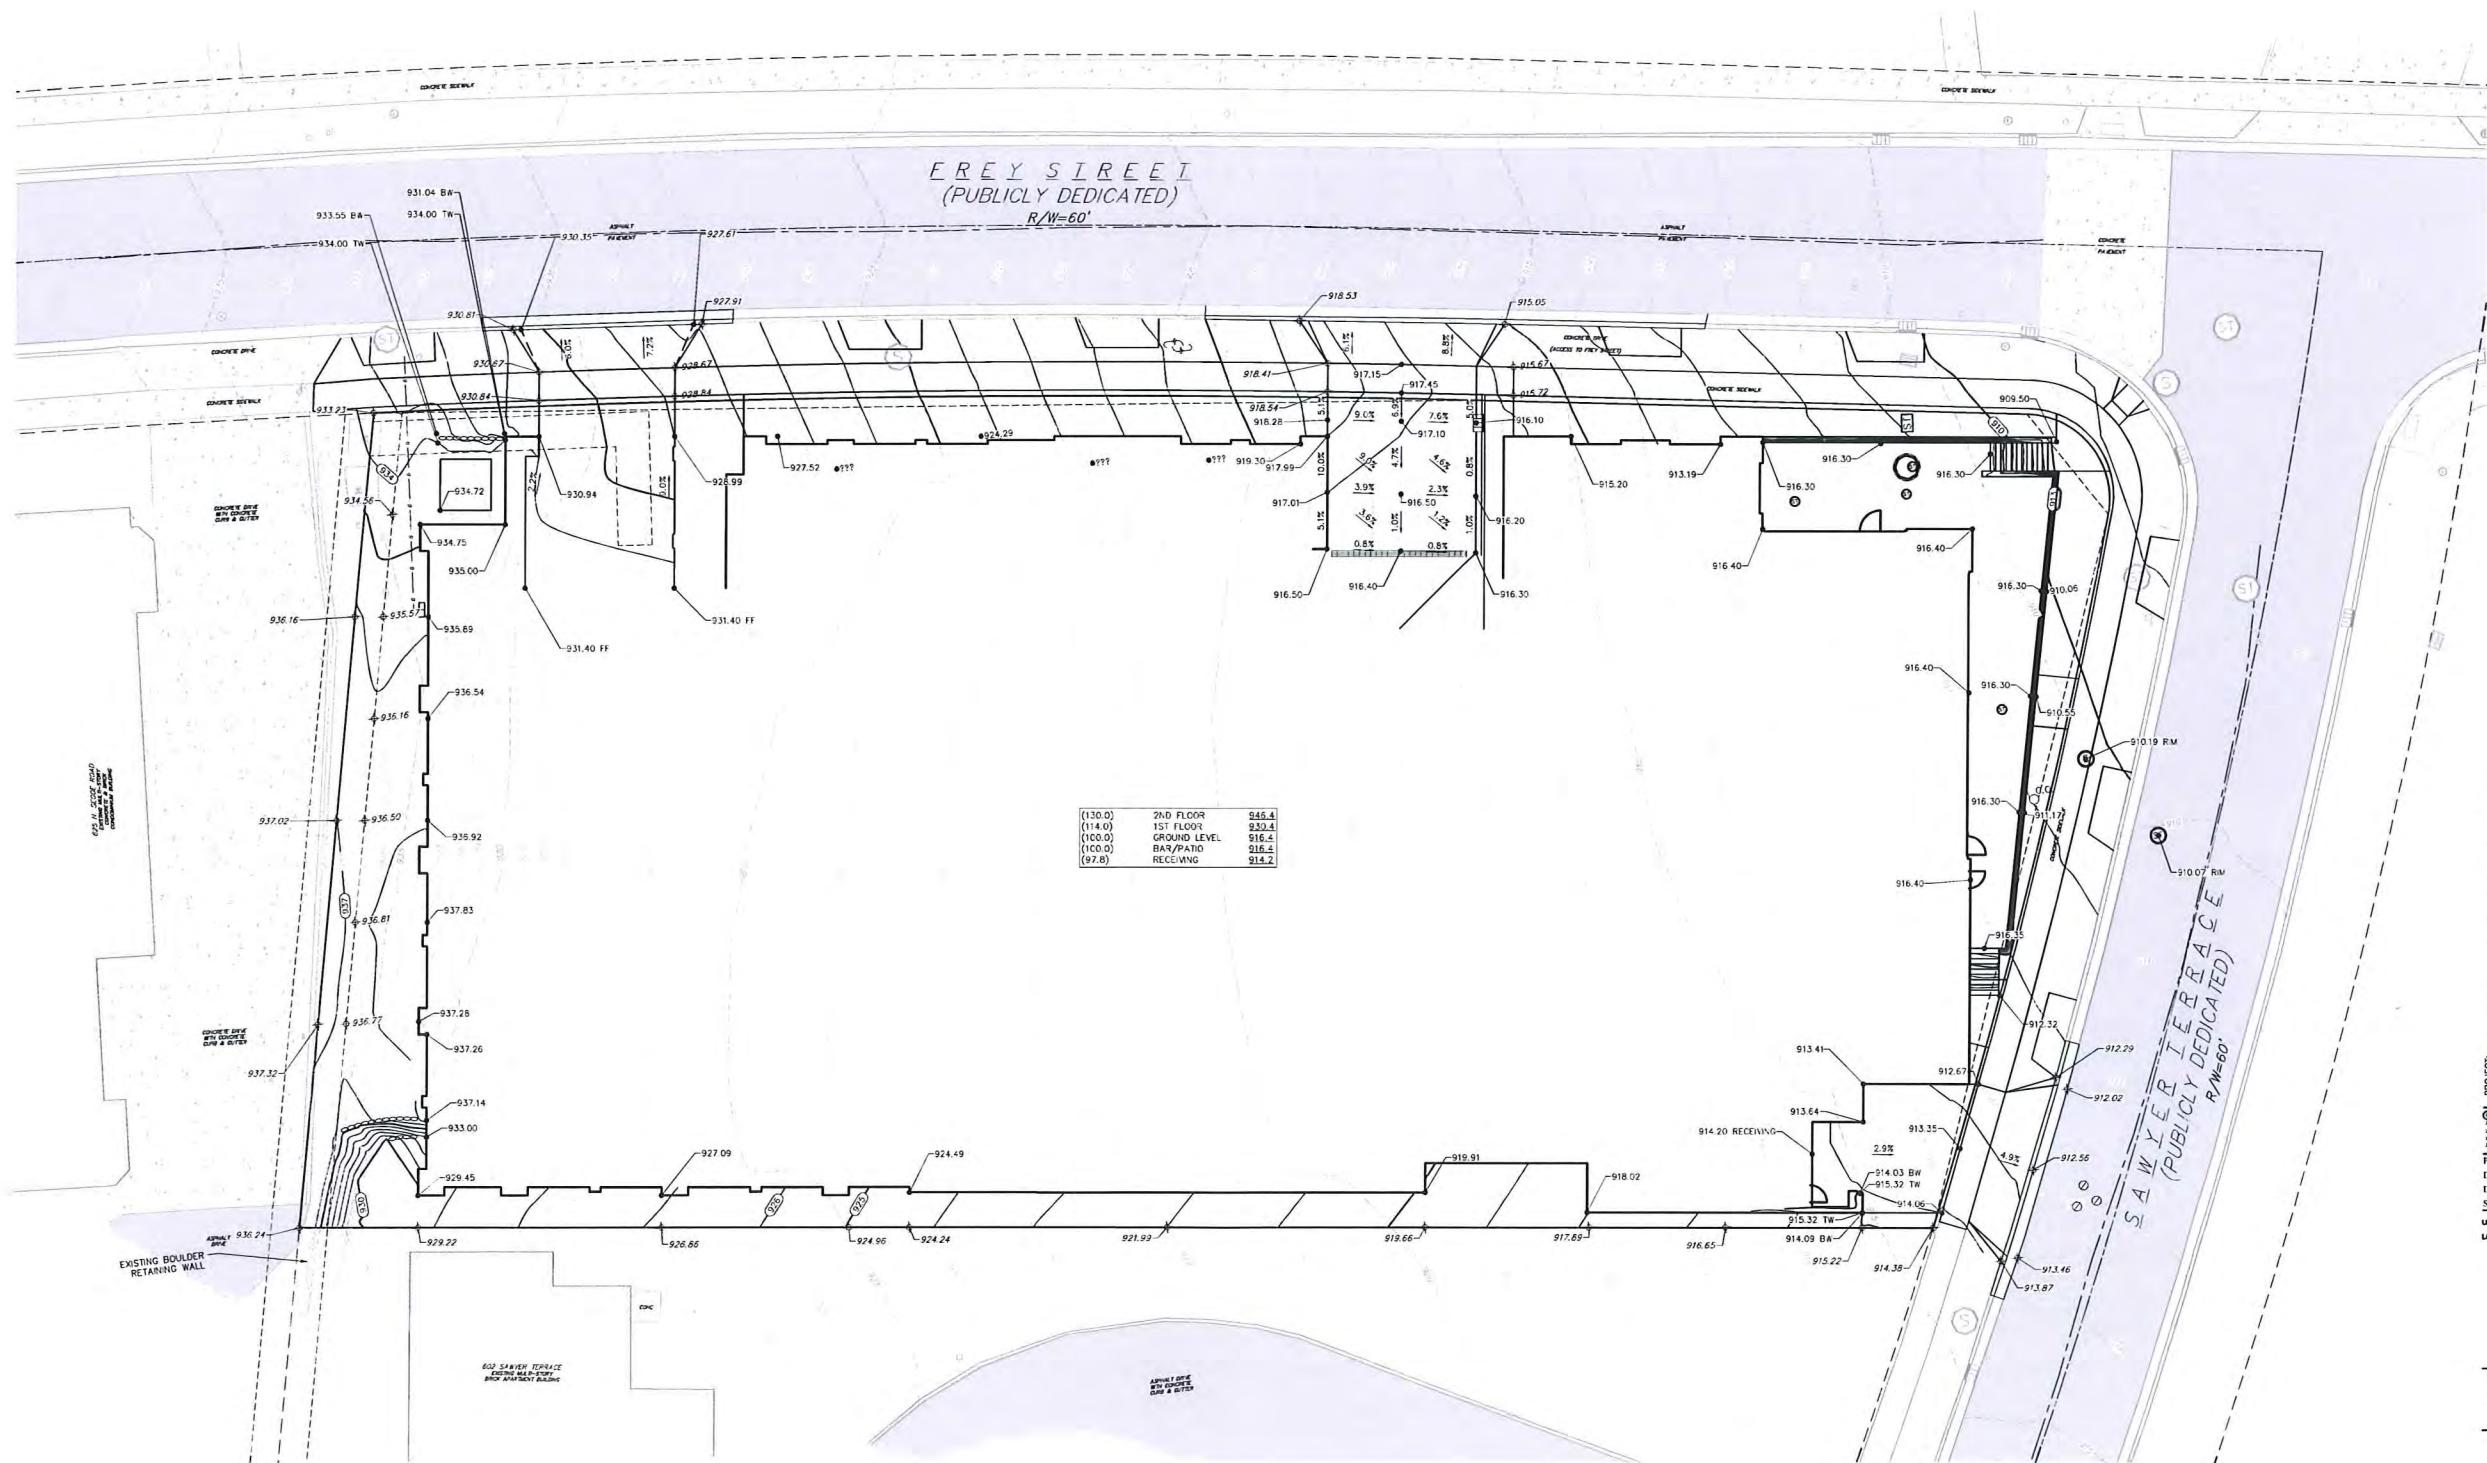



UTILITY NOTES:



1. SANITARY & STORM SEWER LENGTHS SHOWN ARE FROM CENTER OF STRUCTURE TO CENTER OF STRUCTURE. STORM SEWER END SECTIONS ARE INCLUDED IN THE LENGTH AND SLOPE OF THE P.P.E.
2. CONTRACTOR SHALL INVESTIGATE ALL UTILITY CROSSINGS PRIOR TO CONSTRUCTION AND NOTIFY ENGINEER OF ANY CONCERN.
3. CONTRACTOR SHALL BE RESPONSIBLE FOR ADJUSTING ALL UTILITY STRUCTURES (MANHOLE FRIMS, WATER VALVES, AND CURB STOPS), IF NECESSARY.
4. CONTRACTOR SHALL OBTAIN ANY NECESSARY WORK IN RIGHT-OF-WAY, EXCAVATION, UTILITY CONNECTION, PLUGGING, ABANDONMENT, AND DRIVEWAY CONNECTION PERMITS PRIOR TO CONSTRUCTION.
5. FOR ALL SEWER AND WATER MAIN CROSSINGS, PROVIDE MINIMUM 18" SEPARATION WHEN WATER MAIN CROSSES BELOW SEWER AND MINIMUM 6" SEPARATION WHEN WATER MAIN CROSSES ABOVE SEWER.
6. IF DEWATERING OPERATIONS EXCEED 70 GALLONS PER MINUTE OF PUMPING CAPACITY, A DEWATERING WELL PERMIT SHALL BE OBTAINED FROM THE DEPARTMENT PRIOR TO STARTING ANY DEWATERING ACTIVITIES.
7. A COPY OF THE APPROVED UTILITY PLANS, SPECIFICATIONS AND PLUMBING PERMIT APPROVAL LETTER OF THE DAY ON-SITE DURING CONSTRUCTION AND CRED TO INSPECTION BY AUTHORIZED REPRESENTATIVES OF THE DEPARTMENT OF SAFETY AND PROFESSIONAL SERVICES AND OTHER LOCAL INSPECTORS.
8. STORM BUILDING SEWER PIPE SHALL CONFORM TO ONE OF THE STANDARDS LISTED IN TABLE 384.30-6 OF SPS 384.30(3).
9. PRIVATE WATER SERVICES AND PRIVATE WATER MAINS SHALL CONFORM TO ONE OF THE STANDARDS LISTED IN TABLE 384.30-7 OF SPS 384.30(4)(b).
10. PRIVATE WATER HYDRANTS SHALL BE YELLOW IN COLOR.
11. PRIVATE SANITARY SEWER AND LATERALS SHALL BE POLYVINYL CHLORIDE (PVC) ASTM D3034 - SDR 35 OR APPROVED EQUAL MATERIAL THAT CONFORMS TO ONE OF THE STANDARDS LISTED IN TABLE 384.30-3 OF SPS 384.30(2)(c).
12. A MEANS TO LOCATE BURIED UNDERGROUND EXTERIOR NON METALLIC SEWERS/MAINS AND WATER SERVICES/MAINS MUST BE PROVIDED WITH TRACER WIRE OR OTHER METHODS IN ORDER TO BE LOCATED PER SPS 382.10(1)(h) AND SPS 382.40(8)(k).
13. EXTERIOR WATER SUPPLY PIPING SETBACK AND CROSSINGS SHALL BE IN ACCORDANCE WITH SPS 382.40(8)(b).
14. NO PERSON MAY ENGAGE IN PLUMBING WORK IN THE STATE UNLESS LICENSED TO DO SO BY THE DEPARTMENT OF SAFETY AND PROFESSIONAL SERVICES PER S145.06.
15. SITE CONTRACTOR SHALL LAKE SANITARY AND WATER LATERALS FIVE (5) FEET SHORT (HORIZONTALLY) FROM THE BUILDING. BUILDING PLUMBER SHALL VERIFY SIZE, LOCATION, AND INVERT ELEVATION OF PROPOSED SANITARY AND WATER LATERALS.
16. CONTRACTOR SHALL FIELD VERIFY THE SIZE, TYPE, LOCATION, AND ELEVATION OF EXISTING UTILITIES CROSSING EXISTING ANY CITY UTILITIES OR OTHER FEATURES. CONTACT ENGINEER PRIOR TO INSTALLATION IF DISCREPANCY EXISTS IN THESE PLANS.
17. PROPOSED UTILITY SERVICE LINES SHOWN ARE APPROXIMATE. COORDINATE THE EXACT LOCATIONS WITH THE FILMING DRAMMAS. COORDINATE THE LOCATIONS WITH THE FILMING CONTRACTOR AND/OR OWNER'S CONSTRUCTION REPRESENTATIVE PRIOR TO INSTALLATION OF ANY NEW UTILITIES.
18. CONTRACTOR SHALL BE RESPONSIBLE FOR COORDINATING THE RELOCATION OF ANY UTILITIES ENCOUNTERED AND RELOCATE ANY UTILITIES DAMAGED WITHIN INFLUENCE ZONE OF NEW CONSTRUCTION. CONTACT ENGINEER IF THE EXISTING UTILITIES VARY APPRECIABLY FROM THE PLANS.
19. ALL WATER MAINS AND SERVICES SHALL BE INSTALLED AT A MINIMUM DEPTH OF 6'5" FROM TOP OF FINISHED GROUND ELEVATION TO TOP OF MAIN.
20. IT IS THE CONTRACTOR'S RESPONSIBILITY TO VERIFY THAT THE EXISTING VALVES WILL HOLD THE PRESSURE TEST PRIOR TO CONNECTION. THE CITY IS NOT RESPONSIBLE FOR ANY COSTS INCURRED DUE TO THE CONTRACTOR NOT VERIFYING THAT THE EXISTING VALVE WILL HOLD THE PRESSURE TEST PRIOR TO CONNECTION. IF THE EXISTING VALVE IS NOT HOLDING, THE APPLICANT WILL BE REQUIRED TO INSTALL ONE AT THEIR EXPENSE, AT THE POINT OF CONNECTION.
21. CLEAN OUT ALL EXISTING AND PROPOSED STORM INLETS AND CATCH BASINS AT THE COMPLETION OF CONSTRUCTION.



GRAPHIC SCALE FEET
0 5 10 20

| EX. SANITARY SEWER CHART | |
|---|------------------|
| P1 - 8" | CAPACITY=150 GPM |
| P2 - 8" | CAPACITY=140 GPM |
| P3 - 8" | CAPACITY=160 GPM |
| PROP. BULIDING 1200 DFU (PRELIMINARY ESTIMATE)= 240 GPM | |

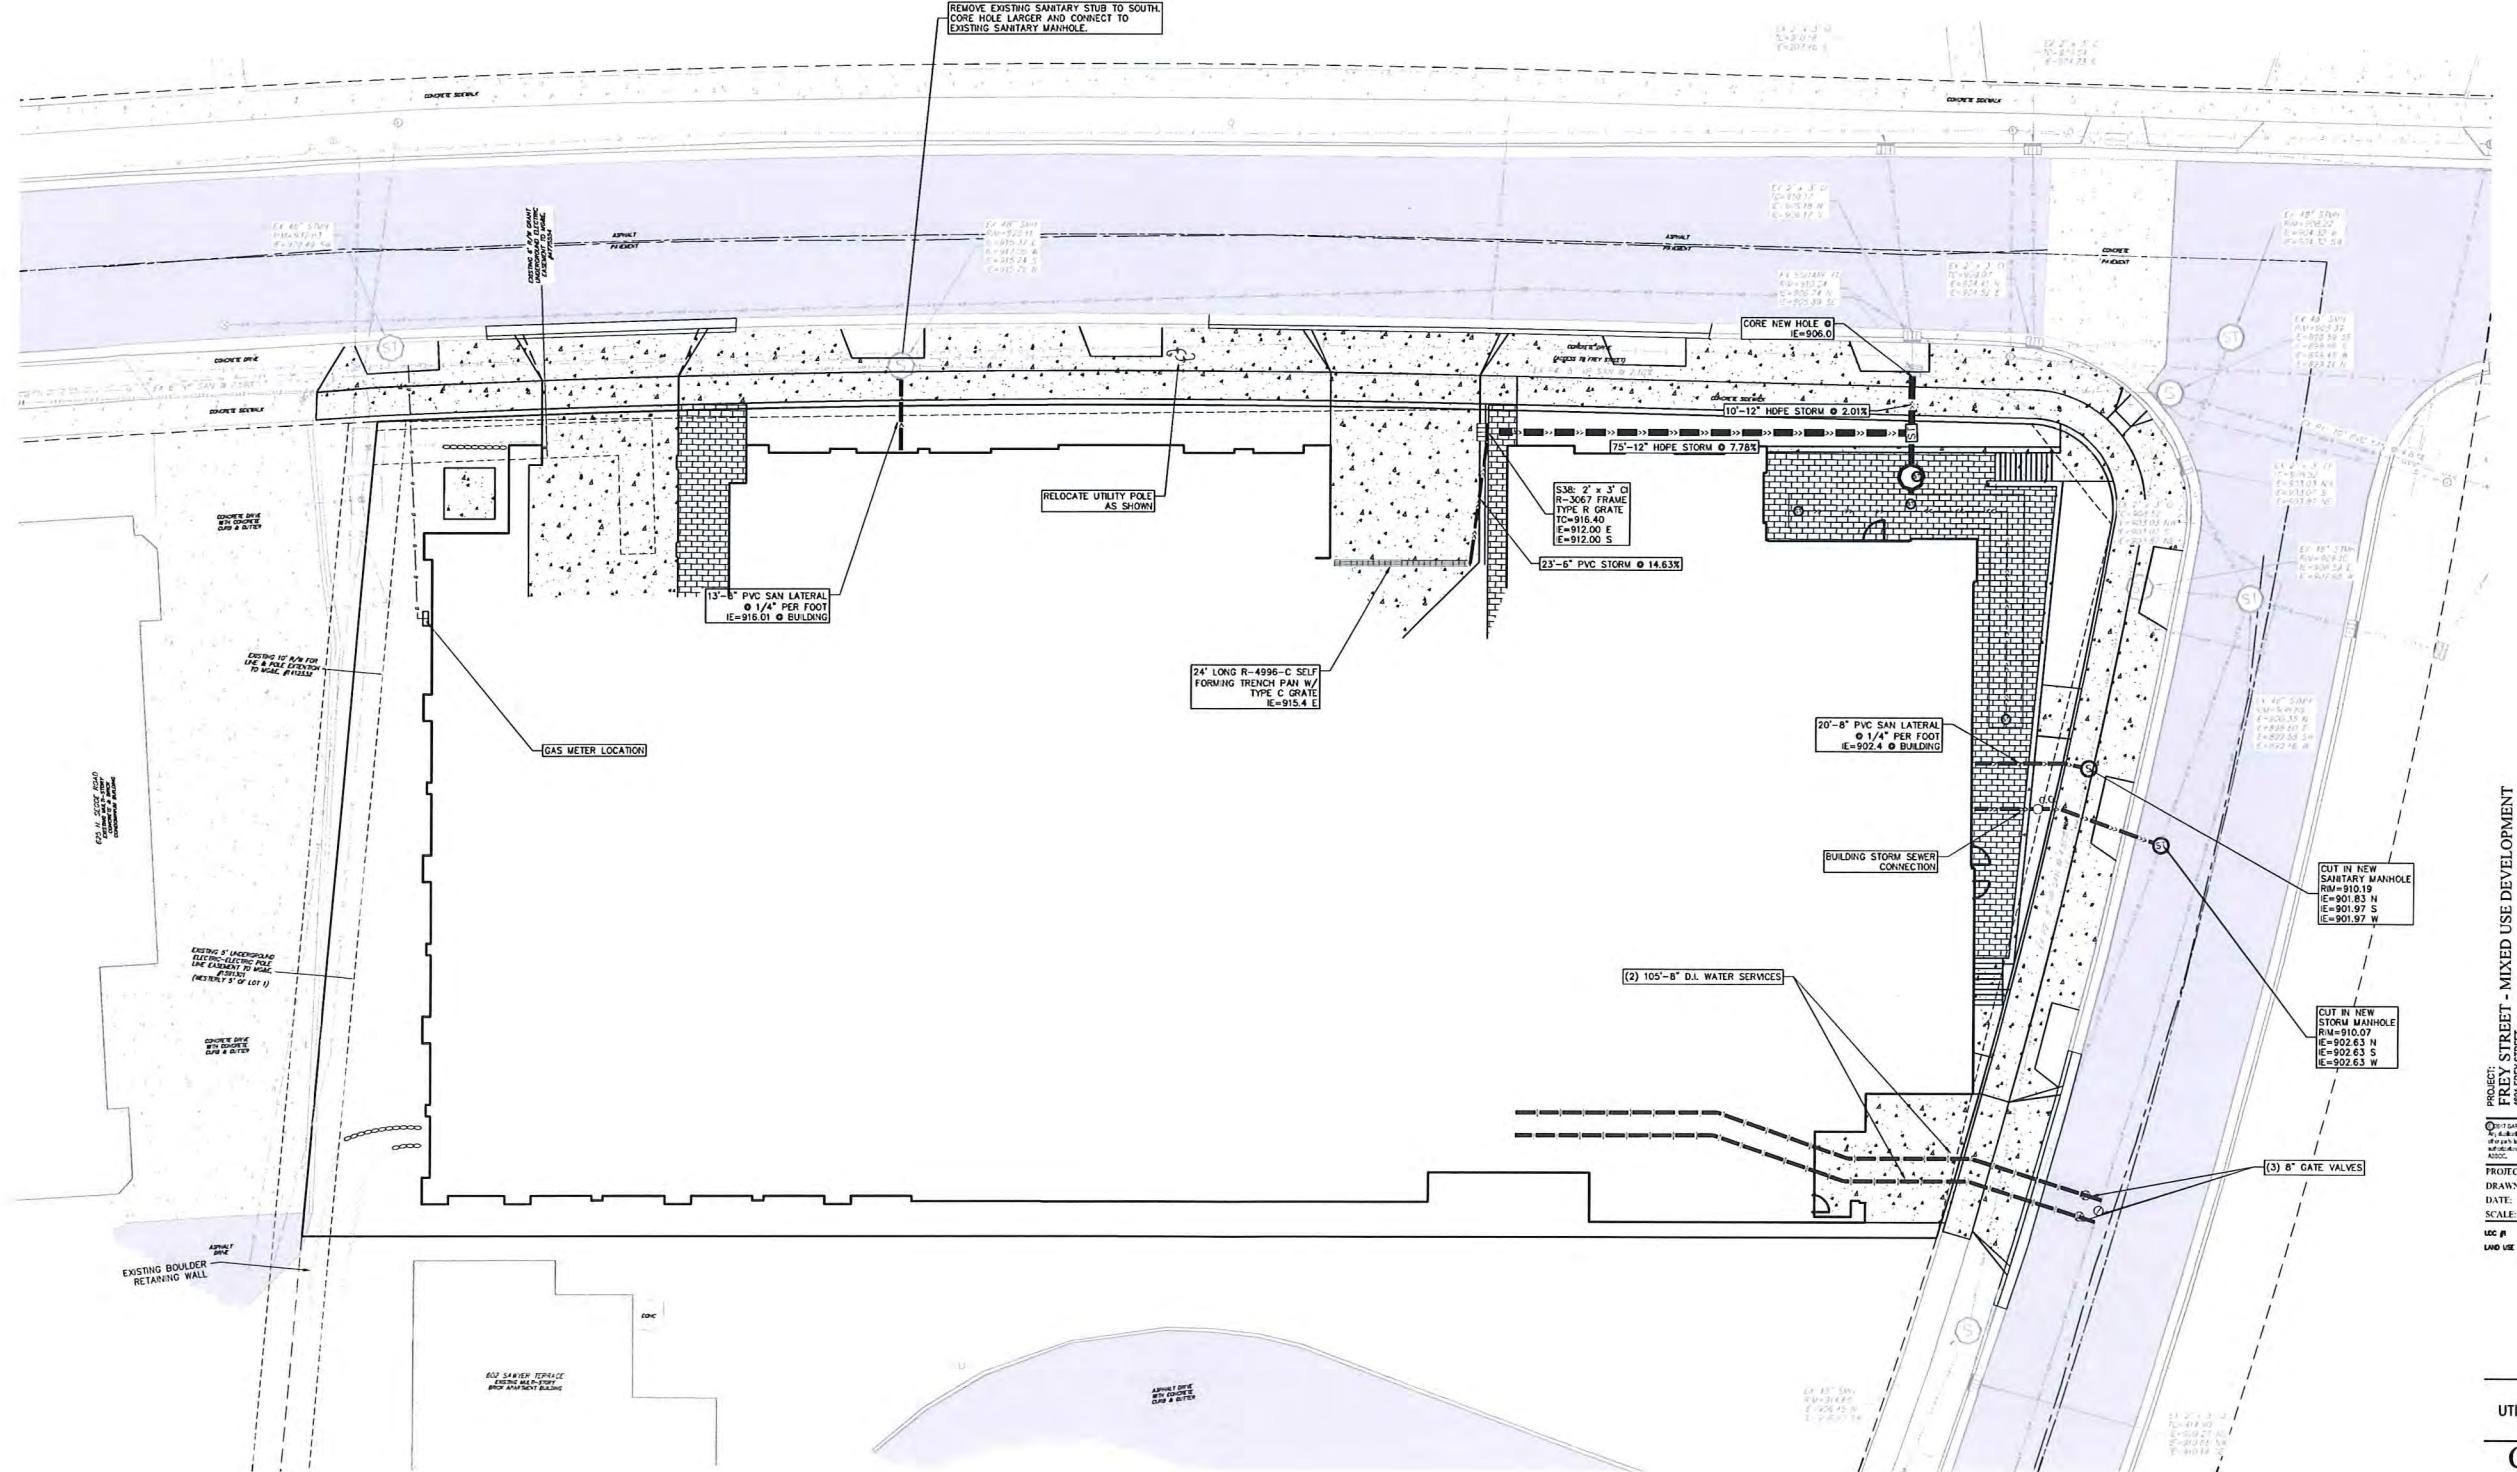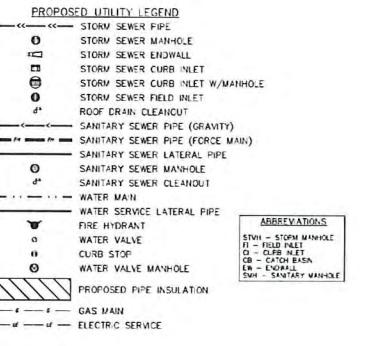

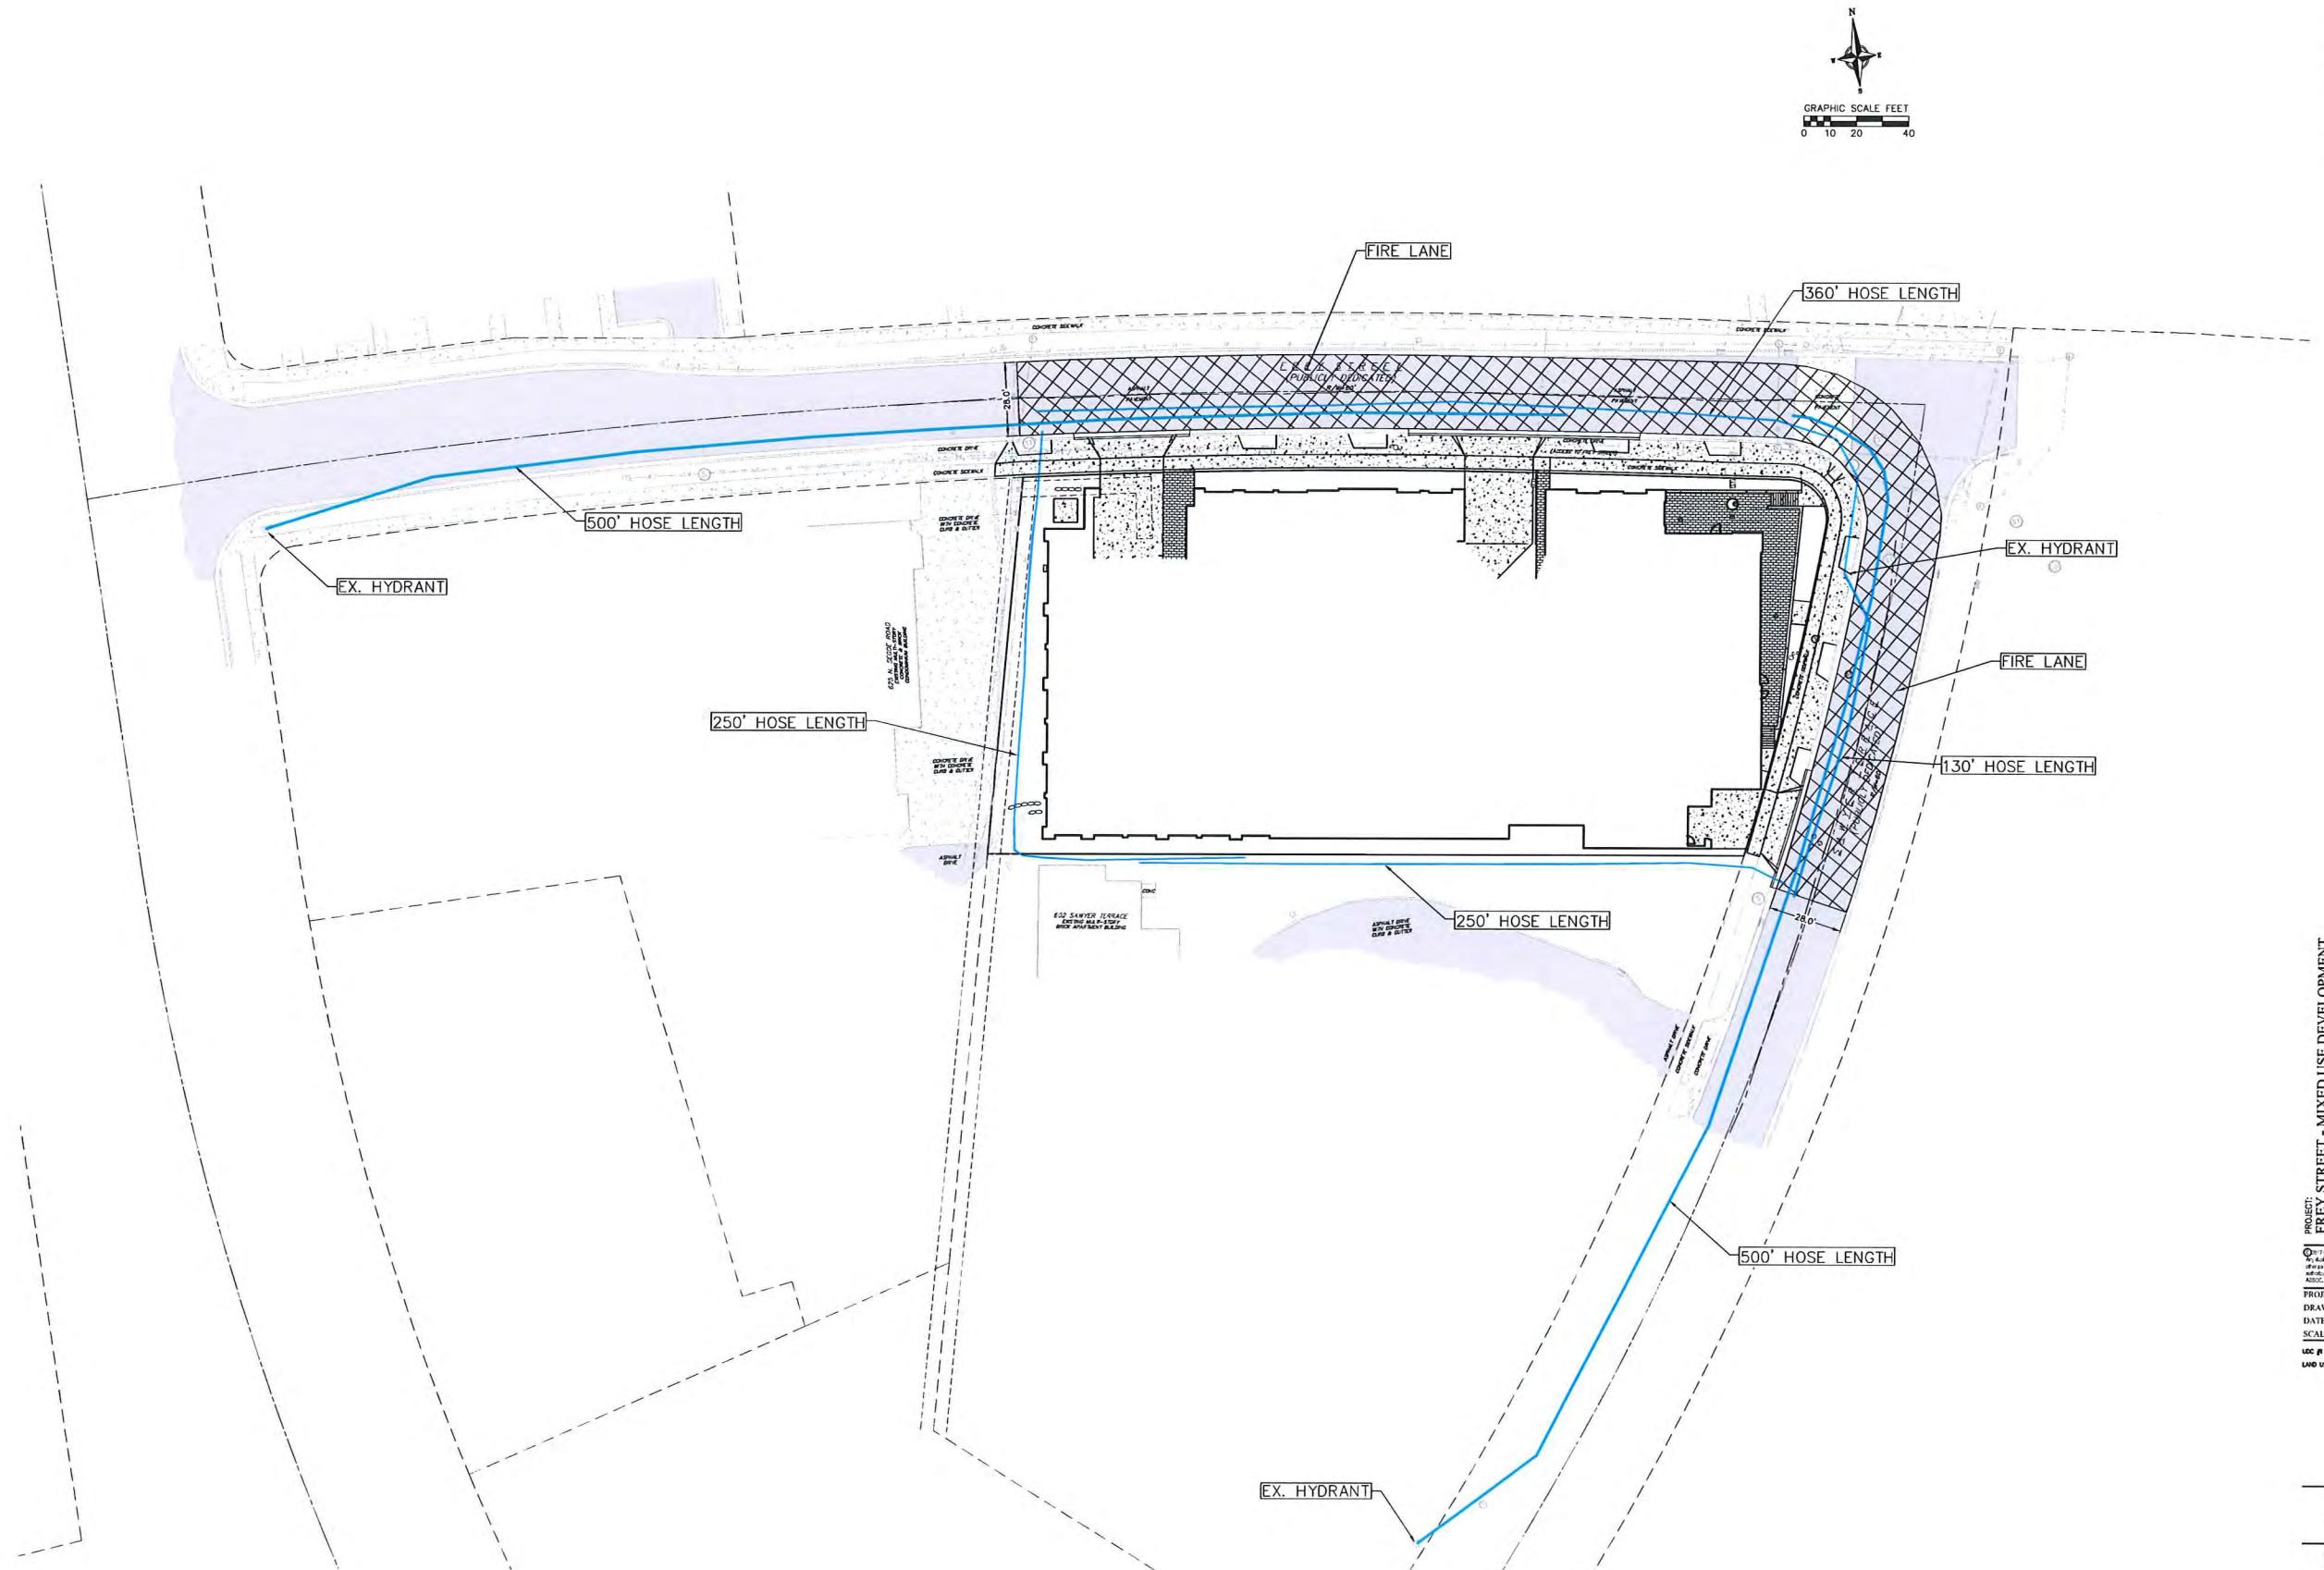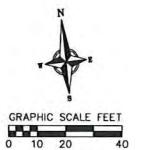

PROJECT: FREY STREET - MIXED USE DEVELOPMENT
DRAWN BY: DPER
DATE: 2-8-2017
SCALE: 1"=20'
LOC #: 11-10-2016
LAND USE: 02-00-2017



PROJECT: FREY STREET - MIXED USE DEVELOPMENT
ADDRESS: 1000 FREY STREET, MIDDLETON, WI 53562
CLIENT: CORAYMOND MANAGEMENT COMPANY
ARCHITECT: CORAYMOND MANAGEMENT COMPANY
ASDOC: 201525












PROJ. NO.: 201525
DRAWN BY: DPER
DATE: 2-28-2017
SCALE: 1"=60'
UCC #: 11-16-2018
LAND USE: 02-08-2018



CONTEXT
MAP

GRAPHIC SCALE FEET
0 50 100 200


C1.4

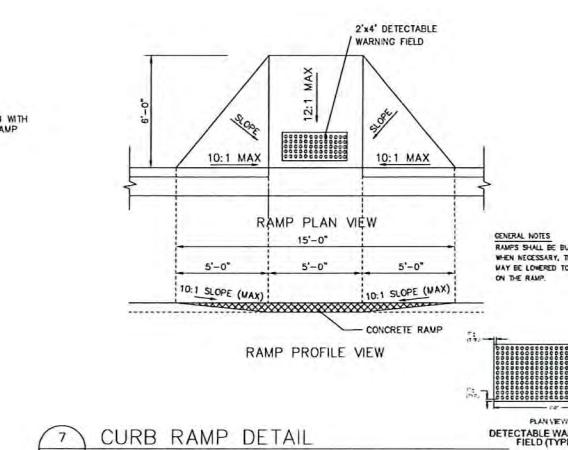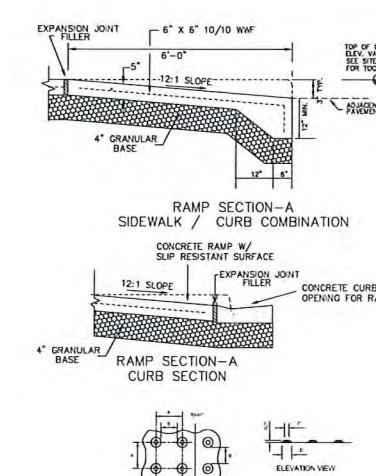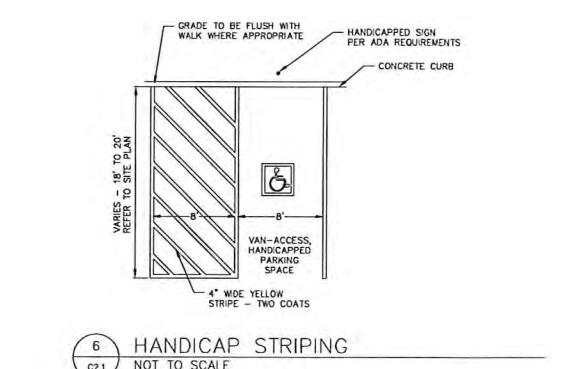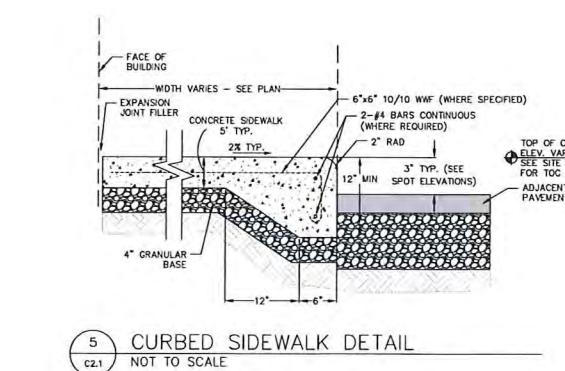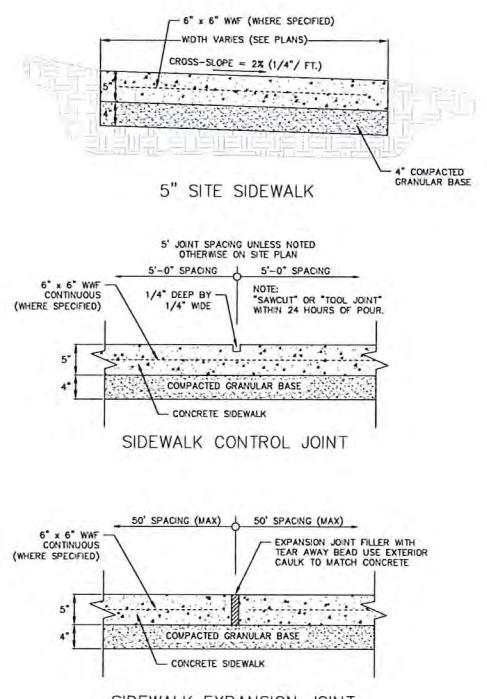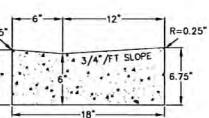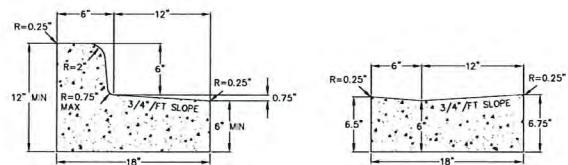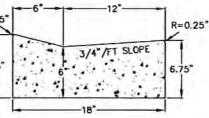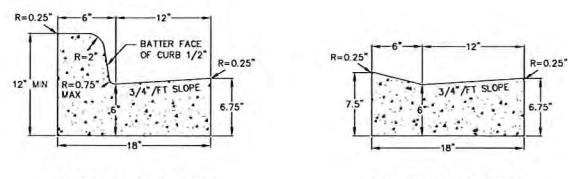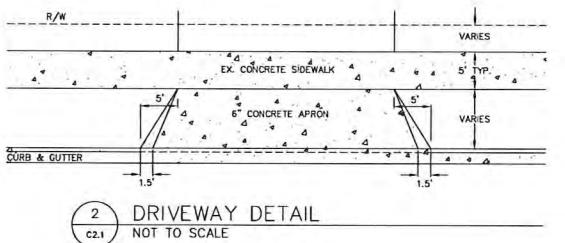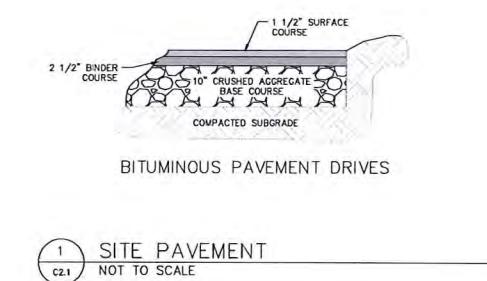


PROJECT: FRIY STREET - MIXED USE DEVELOPMENT
CLIENT: CIO RAYMOND LODGING ASSOCIATES, LLC
ADDRESS: 1033 FRIY STREET, NEW YORK, NY 10019
DRAWN BY: DFR
DATE: 2-2-2017
SCALE: AS SHOWN
DEC #: 11-4-2016
LAM USE: 01-08-2017

PROJECT: FRIY STREET - MIXED USE DEVELOPMENT
CLIENT: CIO RAYMOND LODGING ASSOCIATES, LLC
ADDRESS: 1033 FRIY STREET, NEW YORK, NY 10019
DRAWN BY: DFR
DATE: 2-2-2017
SCALE: AS SHOWN
DEC #: 11-4-2016
LAM USE: 01-08-2017

CONSTRUCTION DETAILS
C2.1

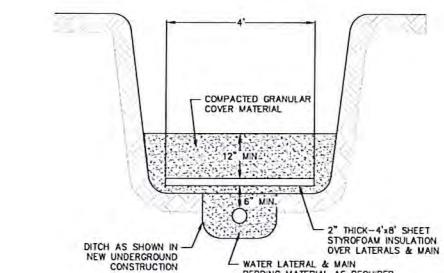


1 INSULATION DETAIL
C2.2 NOT TO SCALE

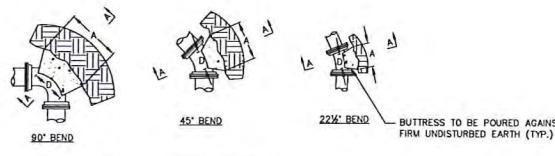

DIMENSION "D" SHALL BE AS LARGE AS POSSIBLE, BUT THE CONCRETE SHALL NOT INTERFERE WITH THE MECHANICAL JOINTS.
DIMENSION "C" SHALL BE AT LEAST 6 INCHES, AND LARGE ENOUGH TO MAKE THE "D" ANGLE EQUAL TO OR GREATER THAN 45 DEGREES WITH THE DIMENSION "A" AS SHOWN ON THE TABLE, OR GREATER, AND WITH DIMENSION "D" AS LARGE AS POSSIBLE.

| BUTTRESS DIMENSIONS | |
|------------------------|---|
| PIPE, TEE | 11.25° BEND 22.5° BEND 45° BEND 90° BEND |
| SIZE | A B A B A B |
| 0'-10" 1'-5" | 0'-0" 0'-0" 1'-0" 1'-0" 1'-0" 1'-0" |
| 6" 1'-6" 1'-8" | 0'-6" 1'-2" 0'-9" 1'-4" 2'-2" 1'-10" |
| 8" 1'-9" 2'-4" | 0'-9" 1'-3" 1'-0" 2'-0" 1'-11" 2'-0" |
| 10" 2'-3" 1'-7" | 0'-9" 1'-3" 1'-0" 2'-0" 1'-12" 2'-0" |
| 12" 2'-6" 2'-10" | 0'-12" 1'-7" 2'-0" 2'-6" 3'-0" 2'-4" |
| 16" 3'-8" 2'-10" 2'-2" | 2'-0" 2'-10" 1'-6" 3'-0" 3'-0" 5'-6" |
| 20" 5'-0" 3'-10" 1'-5" | 2'-6" 1'-11" 3'-9" 3'-9" 6'-9" 3'-9" |
| 24" 5'-4" 4'-8" 1'-8" | 3'-0" 2'-4" 4'-3" 4'-7" 4'-3" 8'-4" 4'-4" |


3 BUTTRESS FOR BENDS
C2.2 NOT TO SCALE

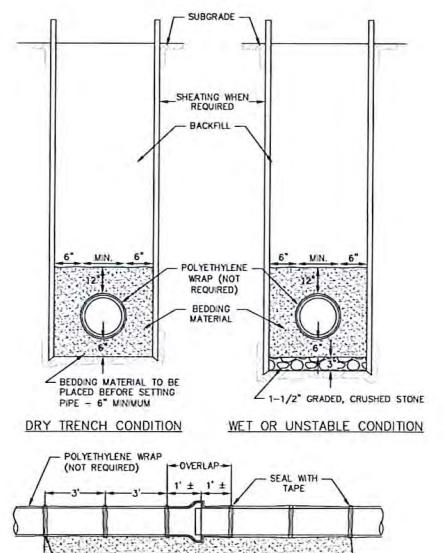


6 STANDARD WATERMAIN TRENCH SECTION
C2.2 NOT TO SCALE



NOTE: GATE VALVE ADAPTOR ARE MANDATORY IN THE VILLAGE OF DEFOREST
MANUFACTURED BY ADAPTOR, INC.
3642 E. AMERICAN AVE.
MILWAUKEE, WI
53114

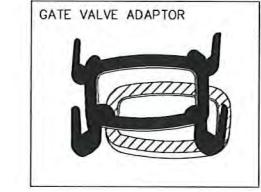



9 GATE VALVE ADAPTOR

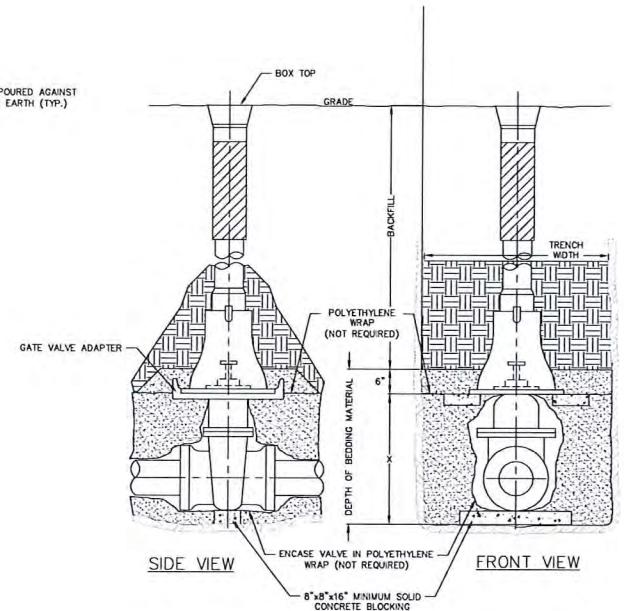

10 GATE VALVE AND GATE VALVE ADAPTOR
C2.2 NOT TO SCALE

| PIPE DIA INCHES | X=SETTING INCHES |
|-----------------|------------------|
| 2 | 6 |
| 3 | 7 |
| 4 | 8 |
| 6 | 12 |
| 8 | 13 |
| 12 | 21 |
| 16 | 30 |

11 CUT PAVEMENT TRENCH SECTION
C2.2 NOT TO SCALE

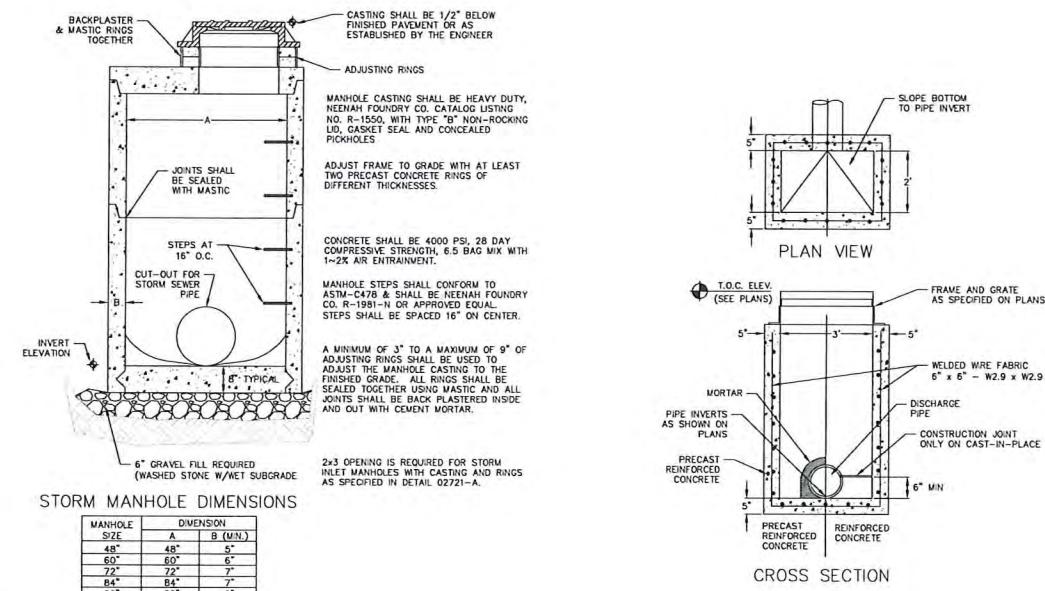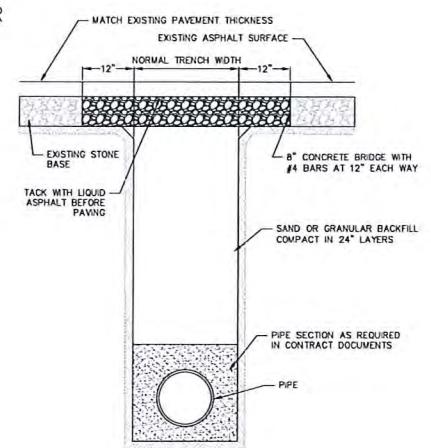

13 STORM SEWER MANHOLE
C2.2 NOT TO SCALE

14 CURB INLET - TYPE 3, 2' x 3' BASIN
C2.2 NOT TO SCALE


15 CLASS B BEDDING COMPACTED SECTION
C2.2 NOT TO SCALE

PROJECT: FREY STREET - MIXED USE DEVELOPMENT
DRAWN BY: DDFR
DATE: 7-8-2017
SCALE: AS SHOWN
LOC #: 11-14-2016
LAND USE: ROADWAY/BIKE LANE

PROJECT: FREY STREET - MIXED USE DEVELOPMENT
DRAWN BY: DDFR
DATE: 7-8-2017
SCALE: AS SHOWN
LOC #: 11-14-2016
LAND USE: ROADWAY/BIKE LANE

CONSTRUCTION DETAILS
C2.2

| LIGHT FIXTURE LEGEND | |
|----------------------|--|
| DESCRIPTION | DESCRIPTION |
| • WSG | WALL MOUNTED LED ACCENT GRAYER WITH 5' SPOT OPTIC SHIELDED SOURCE, DOWNWARD ORIENTATION |
| • GLA | GROUND MOUNTED LED LANDSCAPE ACCENT FLOOR LIGHT WITH 30° SPOT OPTIC SHIELDED SOURCE AND EYELID NEAR/UPLIGHT ORIENTATION. |
| • WFL | WALL MOUNTED LED SURFACE LIGHT WITH SHIELDED SOURCE, DOWNWARD ORIENTATION |
| FLR | RECESSED LINEAR LED BLOD WITH DIFFUSE ACRYLIC LENS, DOWNWARD ORIENTATION |
| CONTR | CONTINUOUS LED STRIP POSITIONED IN CONCEALED ARCHITECTURAL COVE |

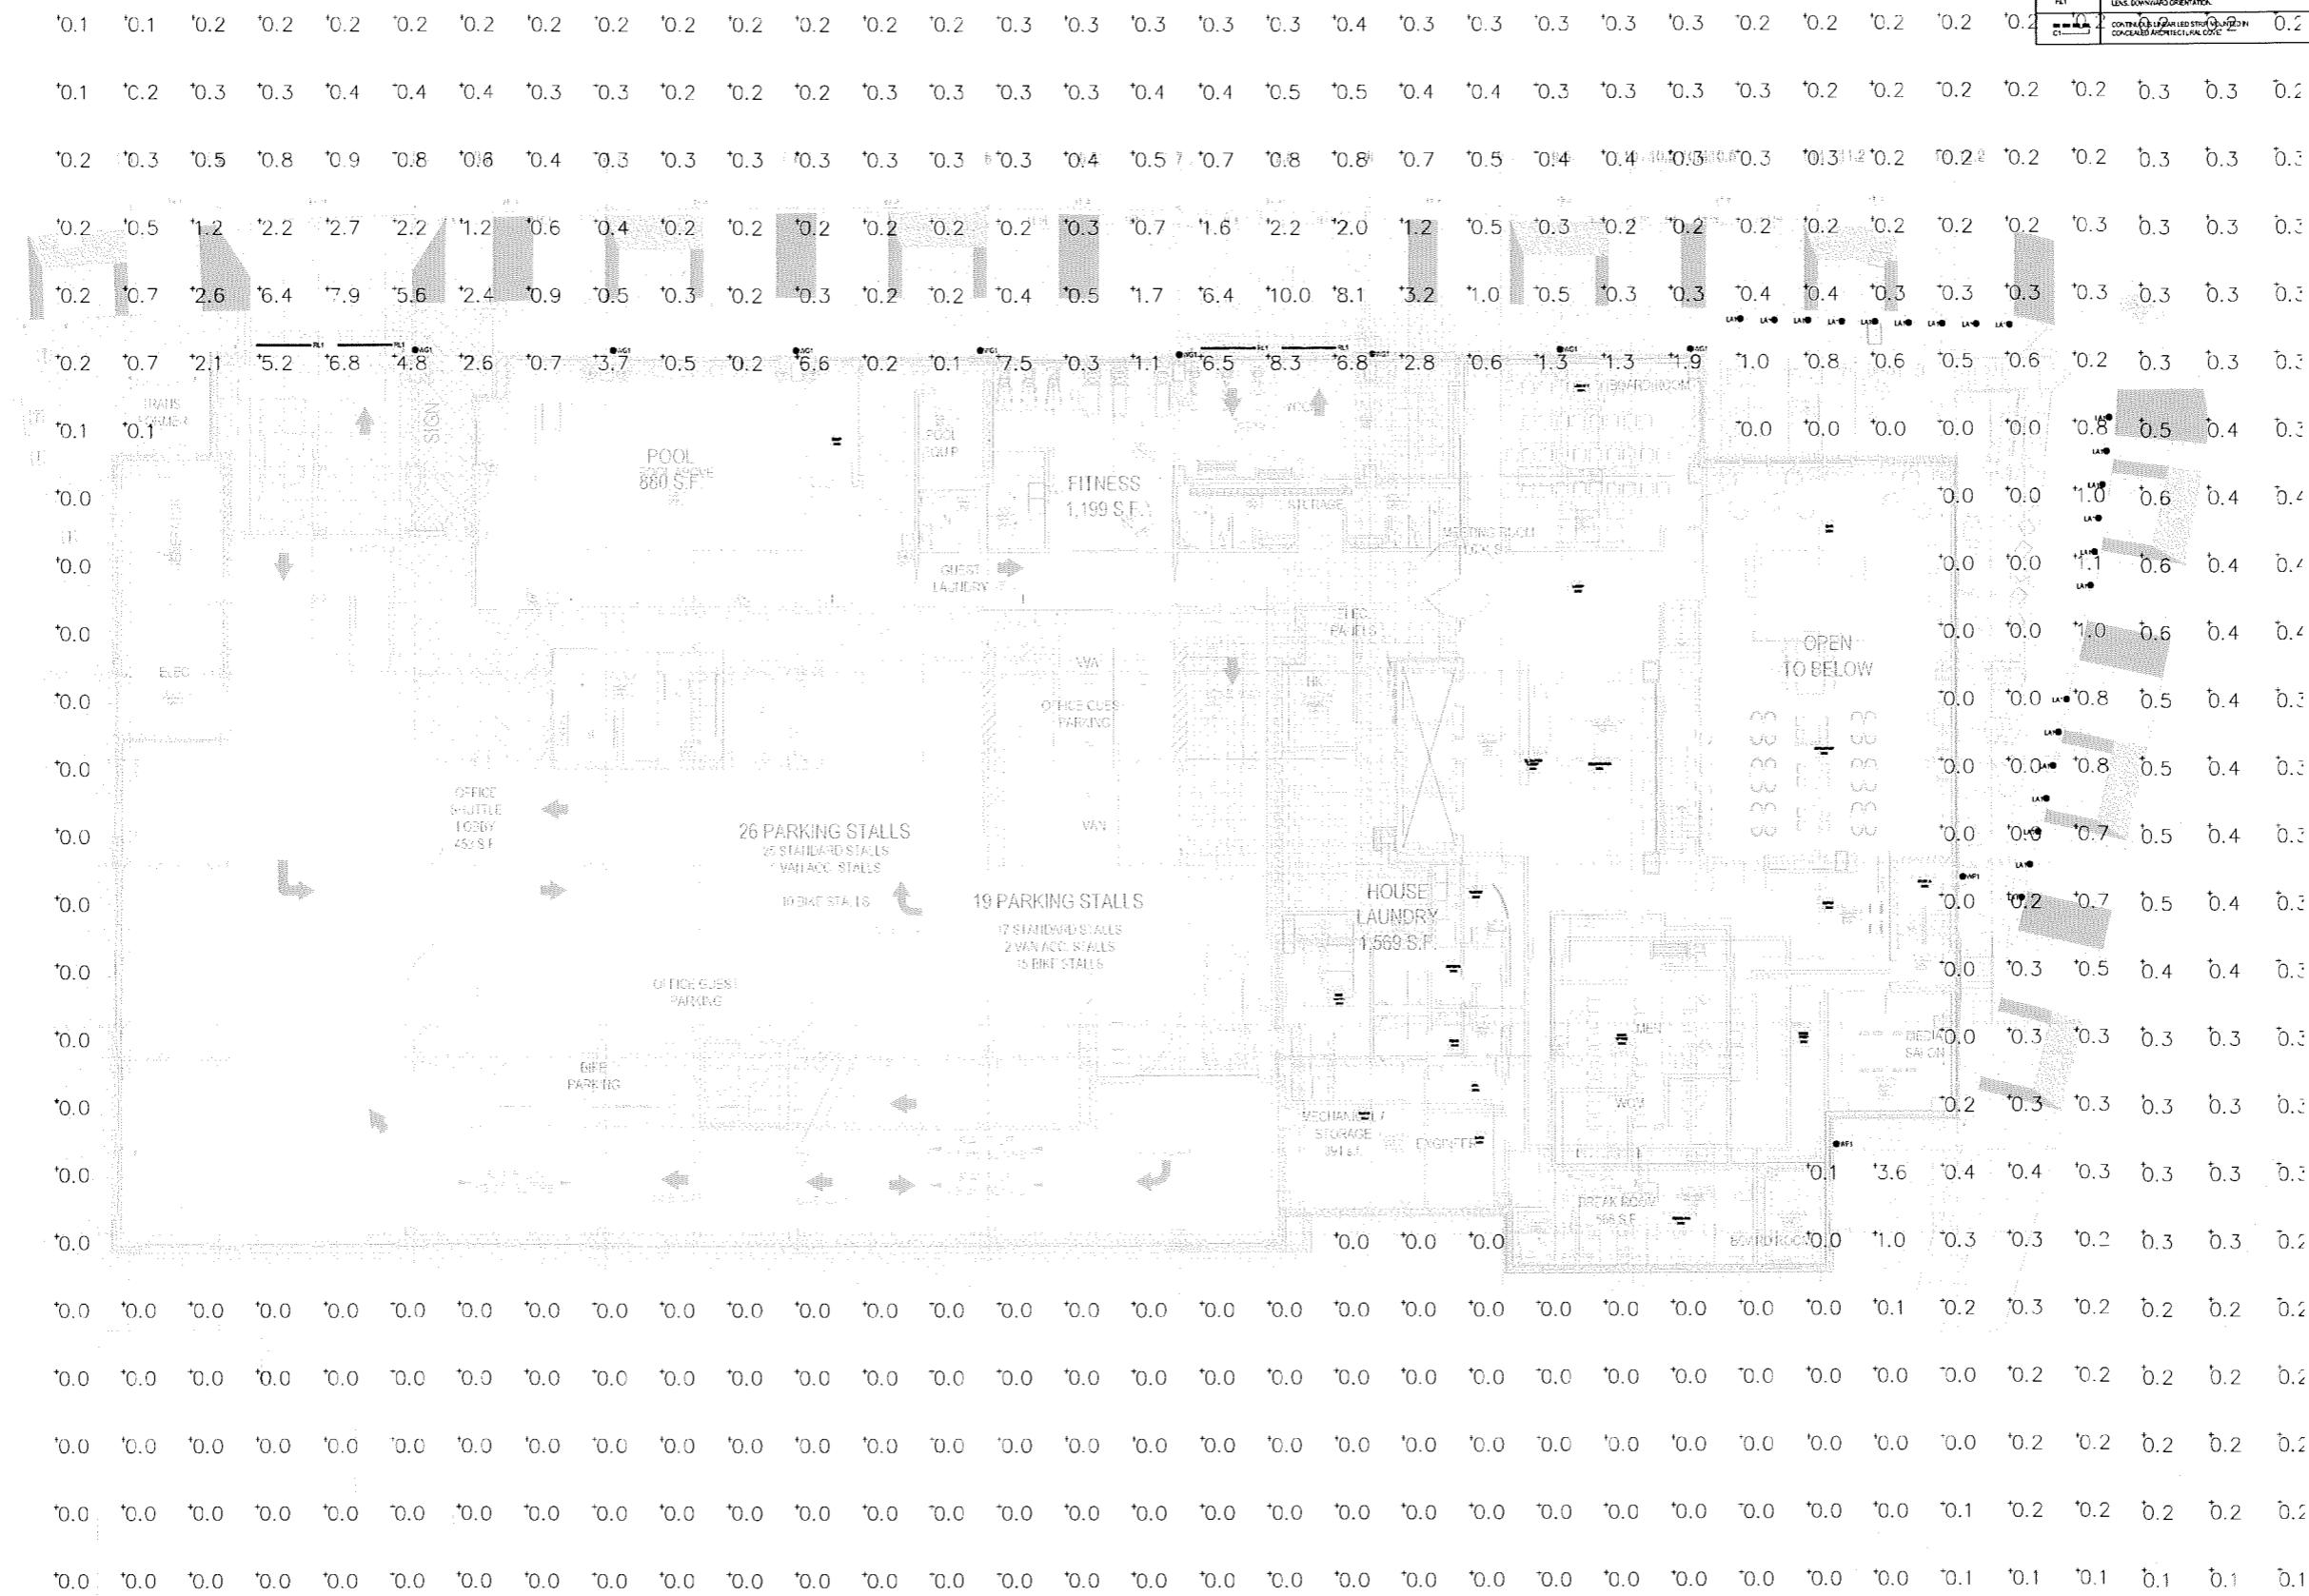

PROJECT: FREY STREET - MIXED USE DEVELOPMENT
ADDRESS: 710 ELMWOOD AVE., MILWAUKEE, WI 53214
CLIENT: CIO RAYMOND MANAGEMENT COMPANY
BUILDER: CIO RAYMOND MANAGEMENT COMPANY
DATE: 03-01-2011
SCALE: 1/8" = 1'-0"
CITY CAPITAL: 03-01-2011

1 SITE PLAN
SCALE 1/8" = 1'-0"


EXTERIOR
SITE
PHOTOMETRICS
EO

G B A

TRADEMARK AND TRADE SHOW
MIDDLETON, WI 53562
608-827-1755
608-827-1755

| LIGHT FIXTURE LEGEND | |
|----------------------|---|
| DESIGNATION | DESCRIPTION |
| • W1 | WALL MOUNTED LED ACCENT GRAYER INTEGRATED SPOT DETECTOR, 5-HEXAGON DOWNWARD ORIENTATION |
| • L1 | GROUNDS MOUNTED LED LINEAR ACCENT FLUORESCENT WITH 80° FLOOD OPTICS, SHIELDED SOURCE AND EYELID VEIL UPWARD ORIENTATION |
| • H1 | WALL MOUNTED LED SURFACE LIGHT WITH SHIELDED SOURCE, DOWNWARD ORIENTATION |
| R1 | RECESSED LINEAR LED SLOT WITH DIFFUSE ACRYLIC LENS, DOWNWARD ORIENTATION |
| CL | CONTINUOUS LINEAR LED STRIP MOUNTED IN CONCEALED MORTISE CHANNELS |

ROOF PARAPET
 248'-4" (10645')
 ROOF PARAPET
 245'-4" (10615')
 ROOF BEARING
 241'-4" (10575')
 11th FLOOR
 230'-0" (10412')
 10th FLOOR
 219'-8" (1036.9')
 9th FLOOR
 209'-4" (1026.6')
 8th FLOOR
 199'-0" (1016.3')
 7th FLOOR
 188'-8" (1006.0')
 6th FLOOR
 178'-4" (995.7')
 5th FLOOR
 168'-0" (985.4')
 4th FLOOR
 150'-0" (967.4')
 3rd FLOOR
 140'-0" (957.4')
 2nd FLOOR
 130'-0" (947.4')
 1st FLOOR
 114'-0" (931.4')
 GROUND LEVEL
 100'-0" (914')

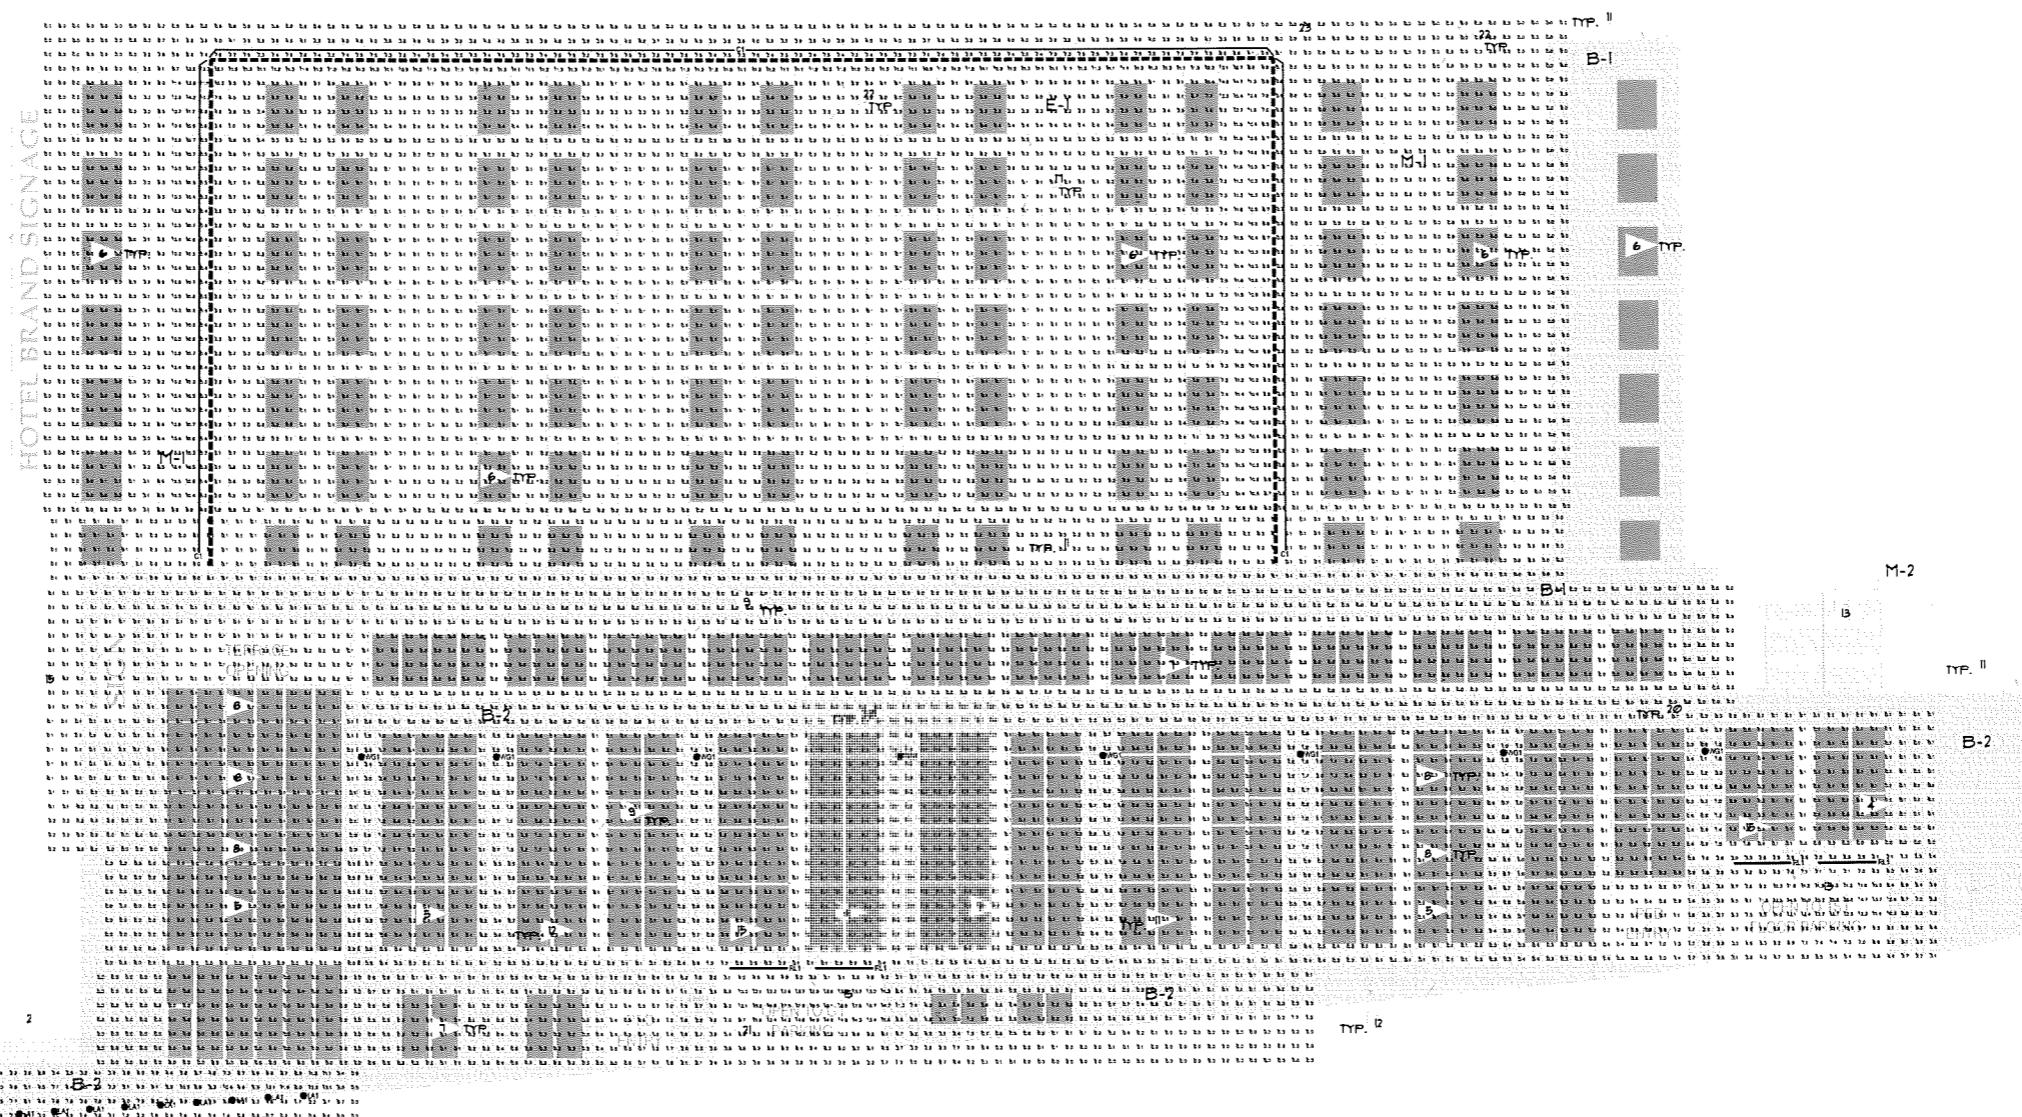


PROJECT:
 FREY STREET - MIXED USE DEVELOPMENT
 On Behalf of: CIO RAYMOND MANAGEMENT COMPANY
 Address: 100 FREY STREET, MILWAUKEE, WI 53202
 Client:
 CIO RAYMOND MANAGEMENT COMPANY
 Address: 100 FREY STREET, MILWAUKEE, WI 53202
 DRAWN BY:
 HEI
 DATE: 03-01-2011
 SCALE: 1/8" = 1'-0"
 CITY APPROVAL: 03-01-2011


1 ELEVATION - FREY STREET
 SCALE 1/8" = 1'-0"
 12 1 3 6 12 24

EXTERIOR
 ELEVATIONS
 PHOTOMETRICS
 E1



| LIGHT FIXTURE LEGEND | |
|----------------------|--|
| DESIGNATION | DESCRIPTION |
| W1 | WALL MOUNTED LED AGENT GRAYER WITH 5' SPOT OPTICS & SHIELDED SOURCE, DOWNWARD ORIENTATION |
| L1 | GROUND MOUNTED LED LANDSCAPE ACCENT 1,000 LUMEN WITH 6" FLOOR OPTICS, SHIELDED SOURCE AND EYED VERTically UPWARD ORIENTATION |
| M1 | WALL MOUNTED LED SURFACE LIGHT WITH SHIELDED SOURCE, DOWNWARD ORIENTATION |
| R1 | RECESSED LINEAR LED SLOT WITH DIFFUSE ACRYLIC LENS, DOWNWARD ORIENTATION |
| C1 | CONTINUOUS LINEAR LED STRIP MOUNTED IN CONCEALED ARCHITECTURAL COVE |

G B A
774 ELMWOOD AVE STE 204
MILWAUKEE, WI 53206
(414) 429-3036 (FAX)

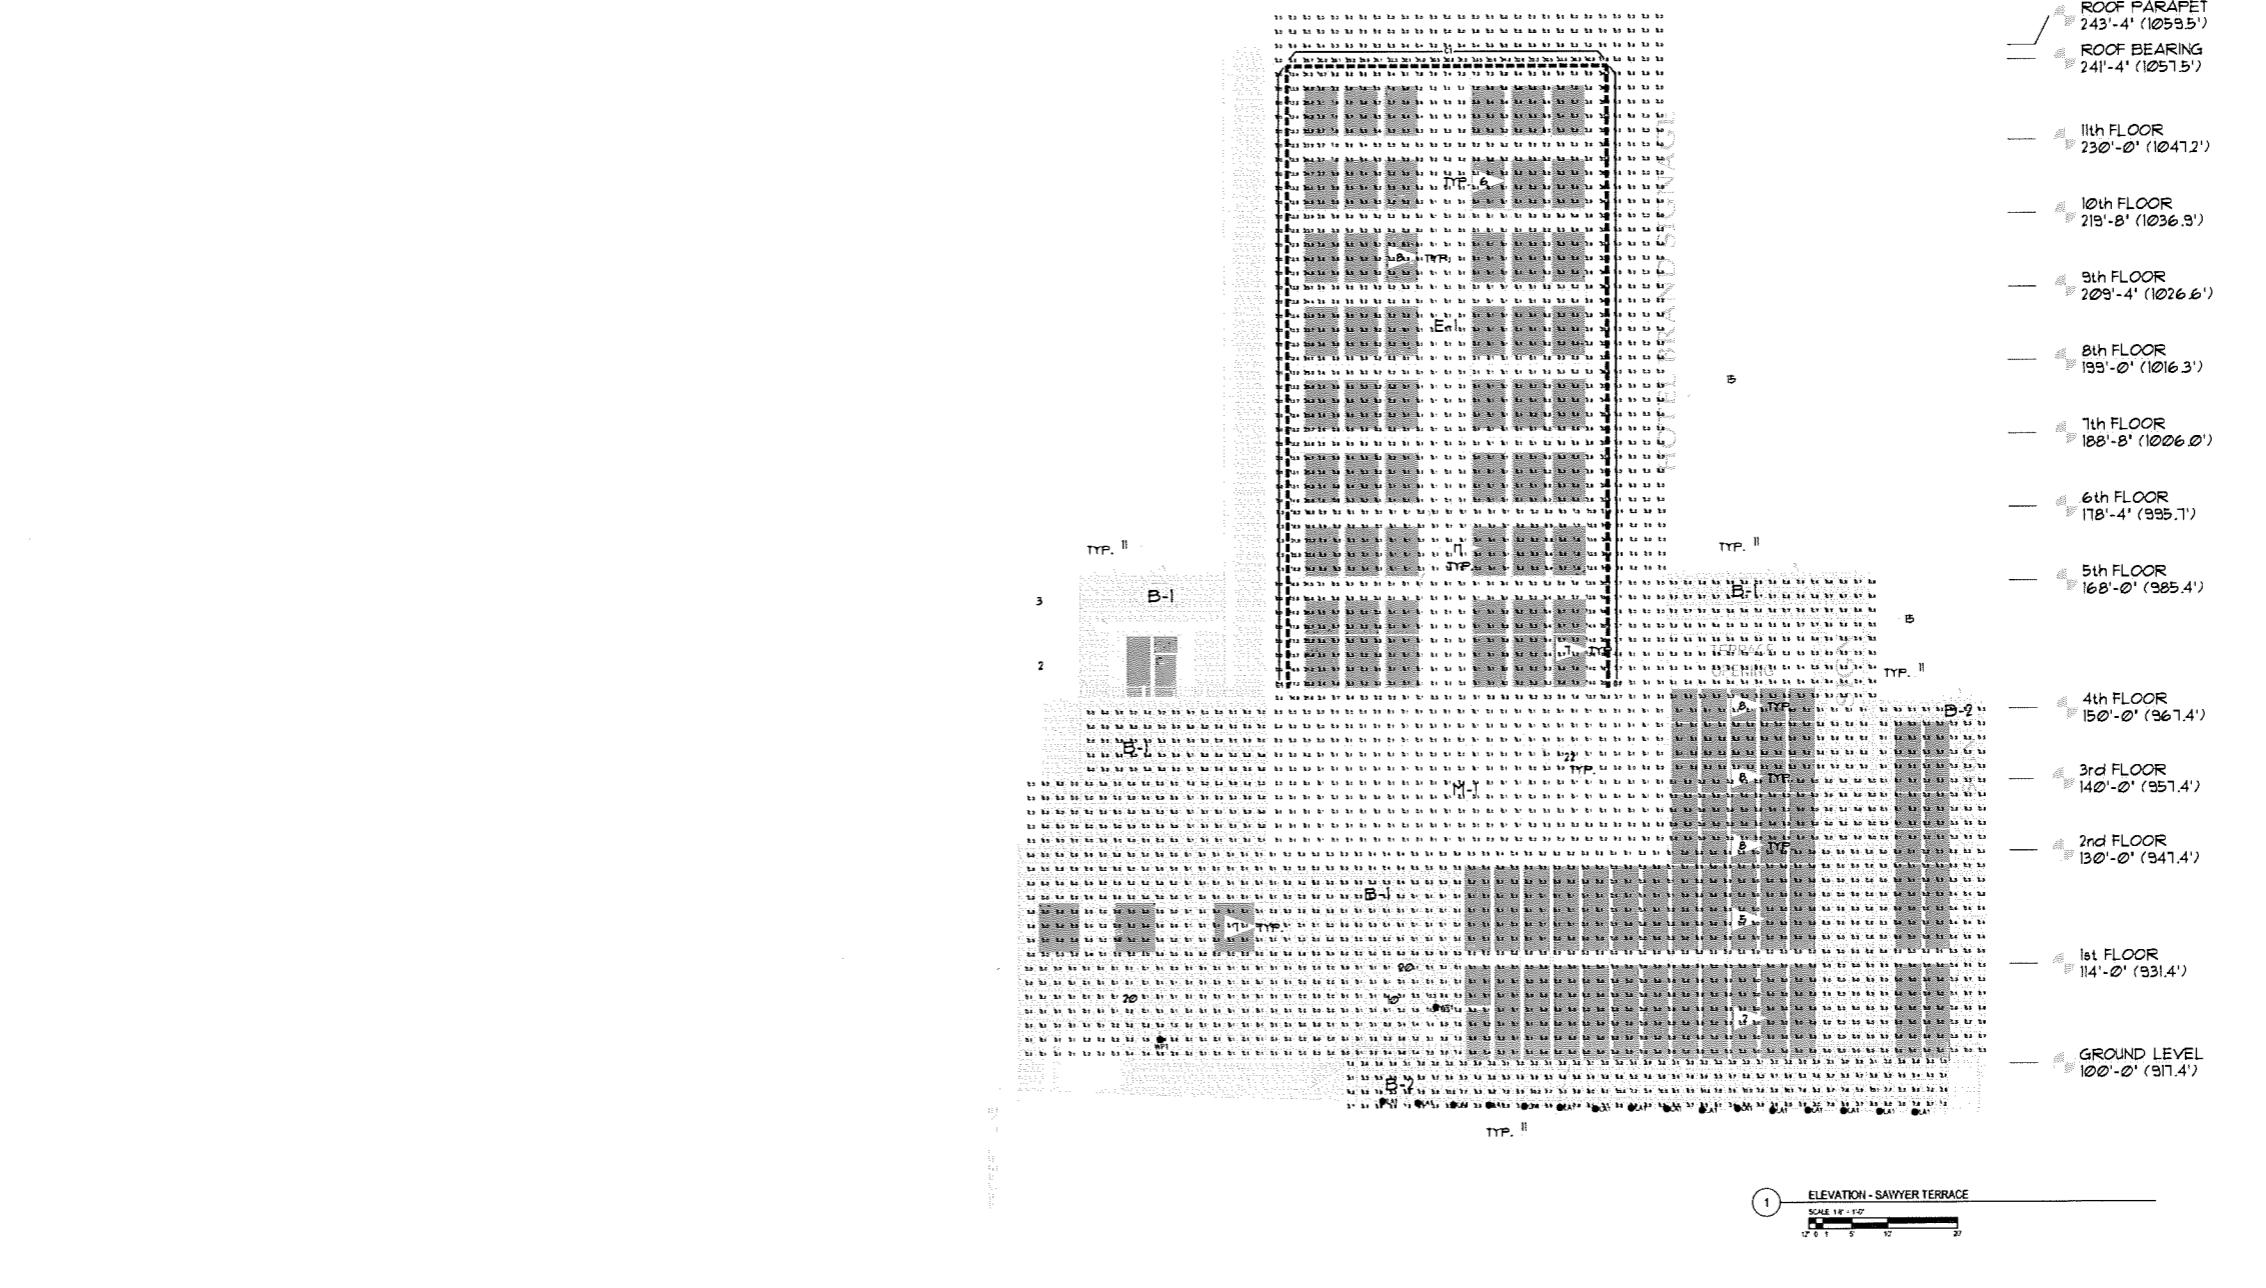


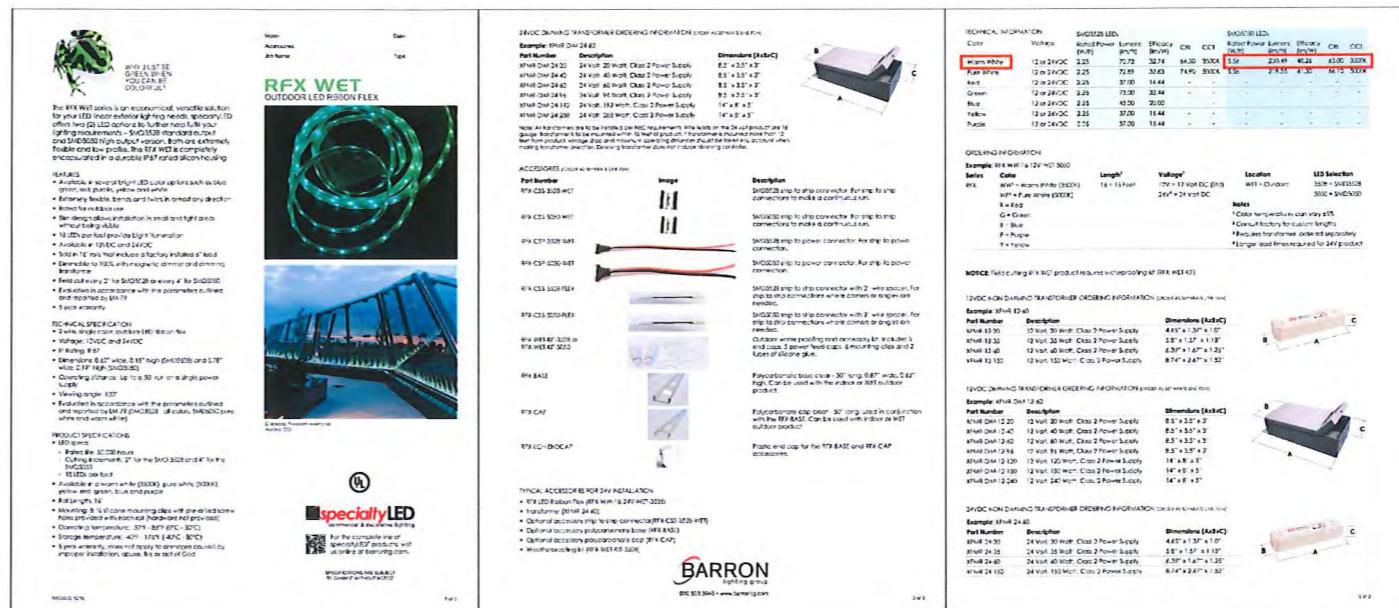


TYPE C1
NO SCALE

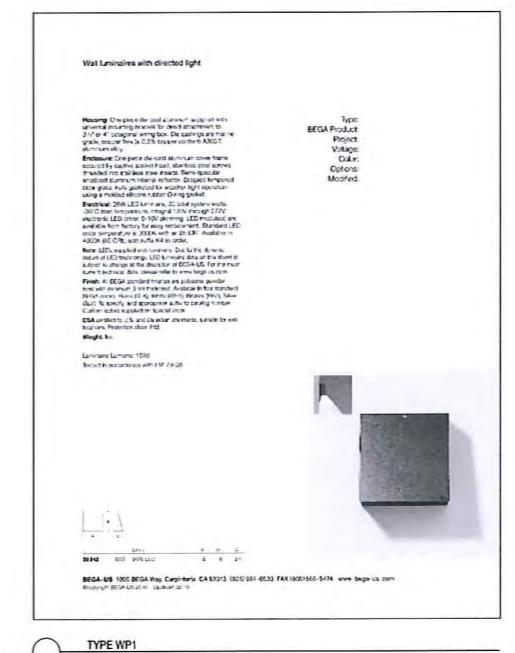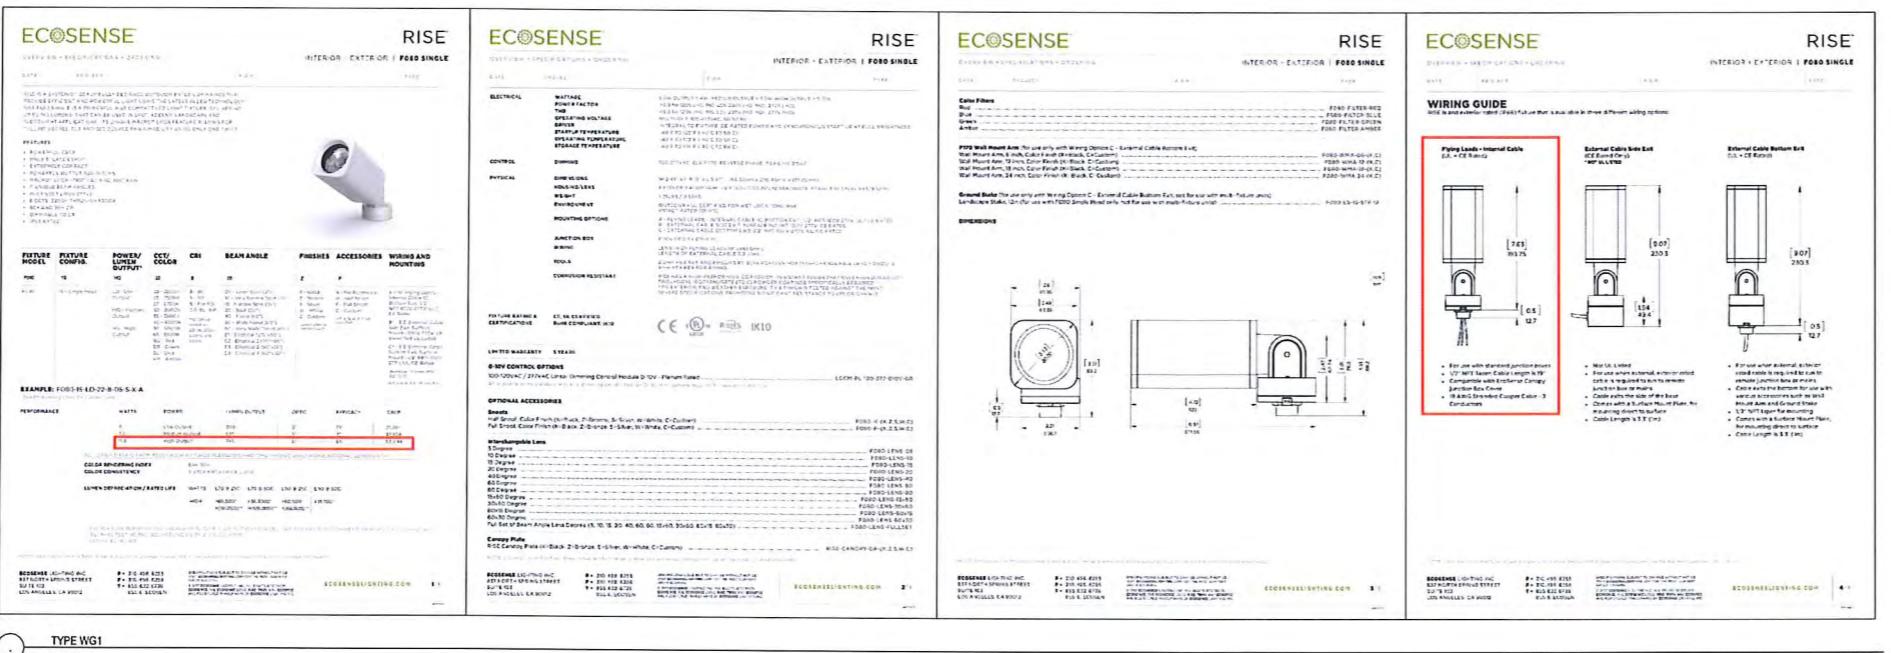


TYPE WP1
NO SCALE

TYPE WG1
NO SCALE

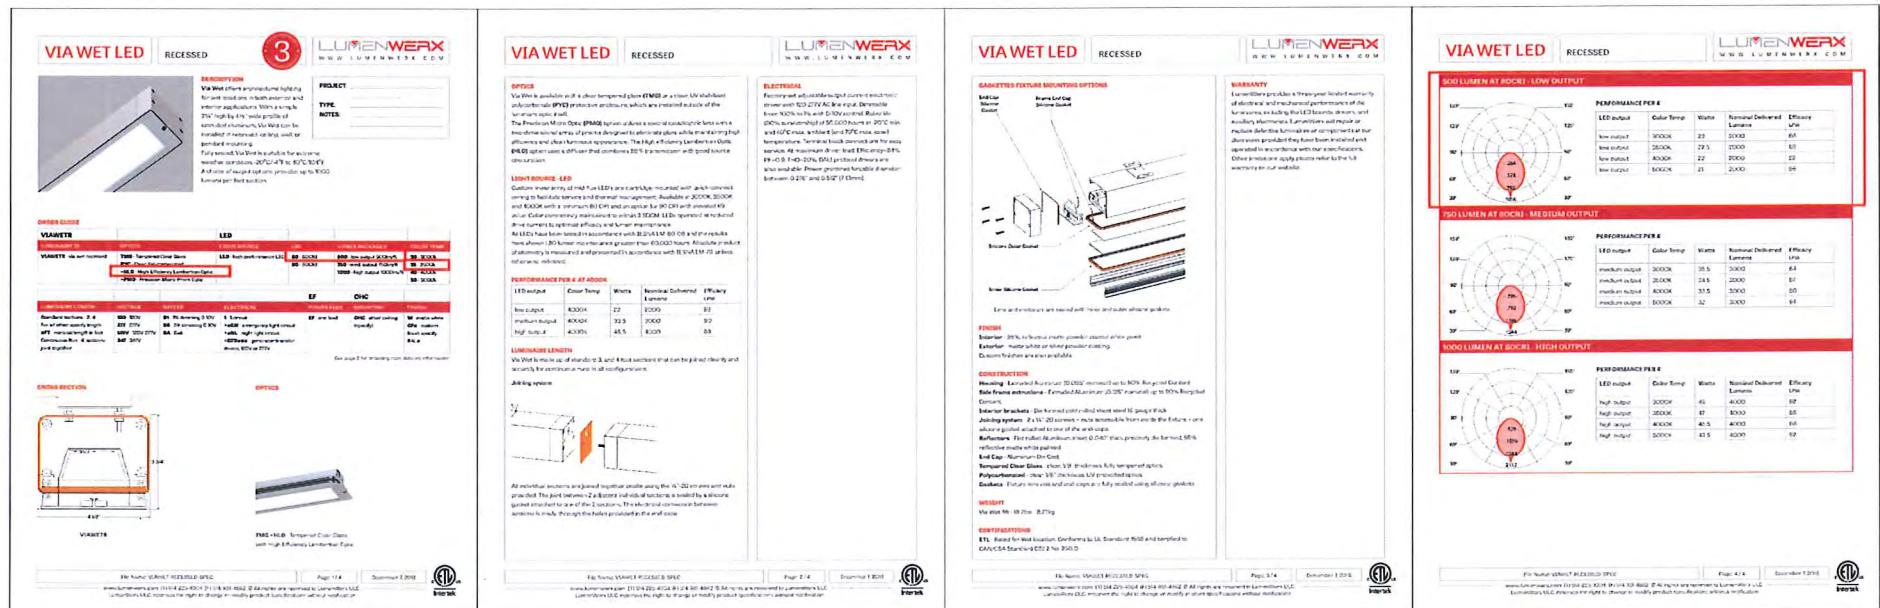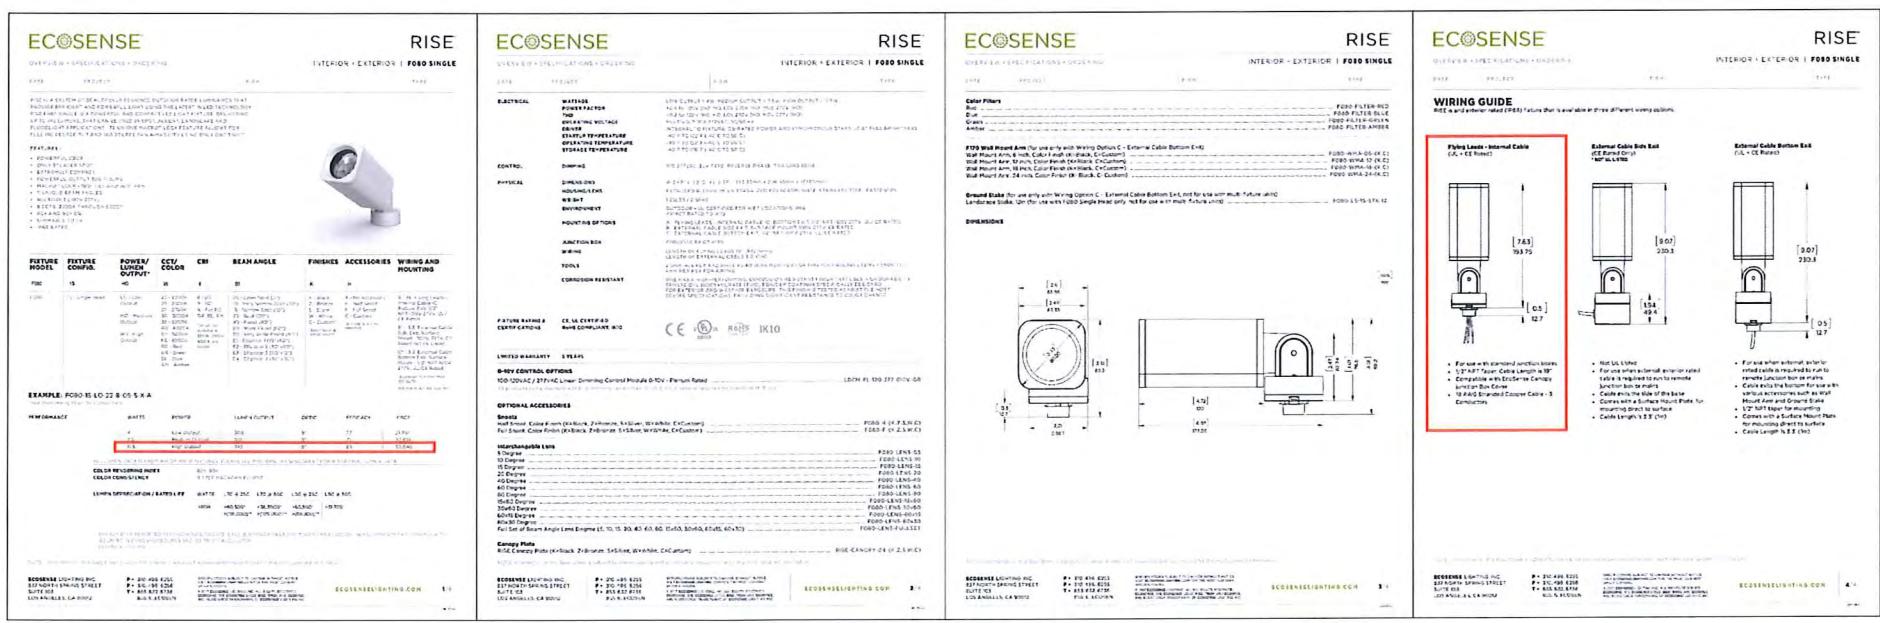TYPE RL1
NO SCALETYPE LA1
NO SCALE

PROJECT: FRY STREET - MIXED USE DEVELOPMENT
DRAWN BY: HEI
DATE: 03-01-2011
SCALE: 1"-0' / 1'-0"
CITY: BIRMINGHAM
MODIFIED BY: HEI
REVIEWED BY: HEI

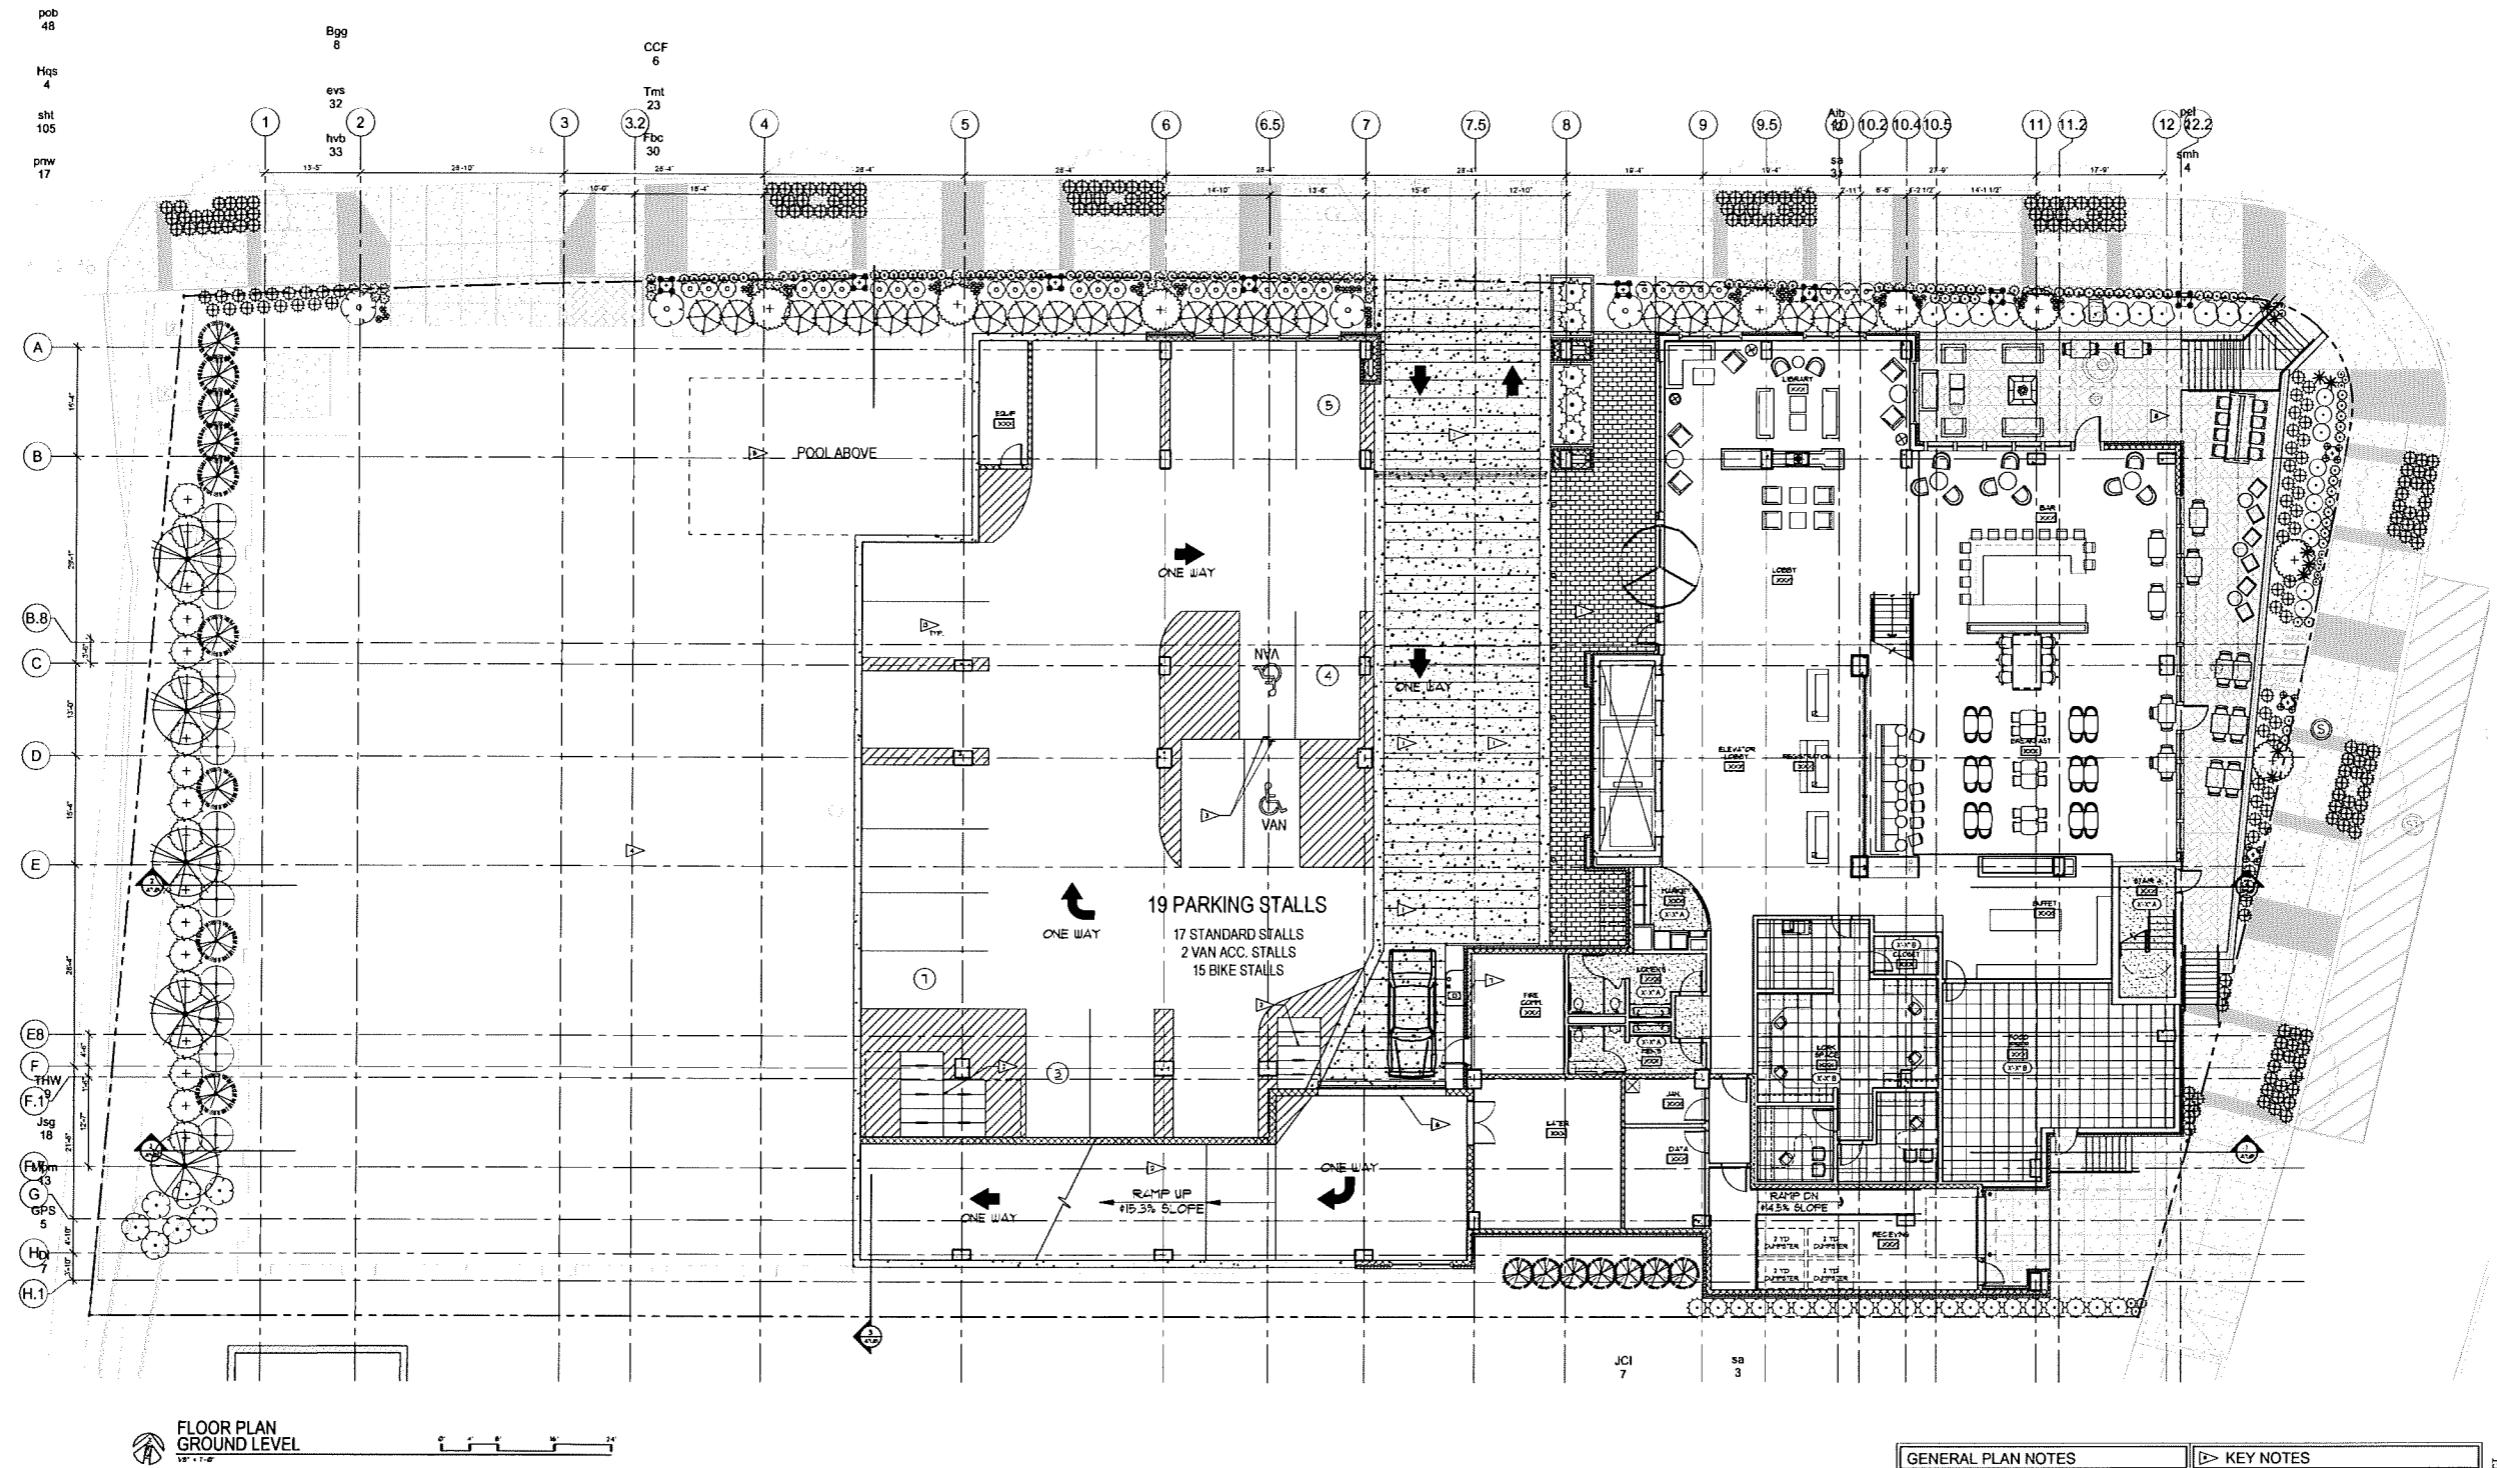

FLOOR PLAN
GROUND LEVEL

1'-0" x 7'-0"

GENERAL PLAN NOTES

- ALL DOORS ARE TO FACE OF 8'0" UNLESS NOTED OTHERWISE.
- EXTerior OPENINGS AND THE FACE OF EXTERIOR SHEATHING (OR INSULATION) ARE TO BE AT LEAST 12" FROM THE CENTER LINE OF EXTERIOR WALL BOARD. TO ACHIEVE LISTED WALL TYPE ADJUSTMENT, ADDITIONAL SHEATHING IS REQUIRED ON THE EXTERIOR WALL.
- SEE WPL FOR DRYWALL OR SPECIFIC AREA.
- SEE WPL FOR ALL FOR WALL TYPE CONSTRUCTION.
- LODGING ACCOMMODATION ARE PROVIDED OVER BY ADDITIONAL END WALL. TRUSS, SUBSTITUTE S/T TYPE X-DIAGONAL SHEathing MUST BE USED IN THESE AREAS. THESE WALLS MUST BE CONTINUE PRIOR TO BUILDING REACH IN THE DRY.
- SEE SHEATHING WALL RATING. RATINGS ARE NOT SHOWN ON THESE PLANS.
- OWNER SHALL PROVIDE ALL CODE REQUIRED FOR BOMA HOUSE CODE. SEE WPL FOR BOMA REQUIREMENTS.
- UNLESS NOTED ON WPL OTHERWISE, ALL DOORS ARE TO BE LOCATED "X" FROM ADJACENT WALL.

PLAN SYMBOLS

- DECORATIVE CONCRETE PAVING (W AND AT HEAT).
- ENCL. PARKING DOCK. SEE WPL FOR DETAILS.
- LANDSCAPING. SEE WPL FOR DETAILS.
- ANKEATED AREA BELOW FIRST FLOOR.
- POOL ACCESS.
- ONE SPEED HEAD DOOR.
- DOOR ACCESS CONTROL SYSTEM.
- ELEVATED TERRACE IN STORY WATER RETENTION PER CIVIL DRAWING.
- CANTILEVERED.
- WHEEL STOP PER ALA.
- BALCONY BLACK SPOT OVER 4' X 6' OF POLY ISO.
- CONCRETE IMPREGNATED BRICK OR STONE ON TOP OF CONCRETE.
- COMPACT PARKING (ALL AREAS IN WIDTH. ALL ARE GREATER THAN 8' X 10' AND 8' X 8' DEEP).
- PAINTED CURB/WALL LINE.
- MECHANICAL UNIT ALUMINUM ROOF.
- ACROSS THE ROAD TO DRIVING AREA FOR DOOR AND WINDOW OPENINGS SHOWN.
- DOOR/INTERIOR OPENING NUMBER REFER TO DRAWING AREA FOR DOOR AND INTERIOR OPENINGS SHOWN.


KEY NOTES

- DECORATIVE CONCRETE PAVING (W AND AT HEAT).
- ENCL. PARKING DOCK. SEE WPL FOR DETAILS.
- LANDSCAPING. SEE WPL FOR DETAILS.
- ANKEATED AREA BELOW FIRST FLOOR.
- POOL ACCESS.
- ONE SPEED HEAD DOOR.
- DOOR ACCESS CONTROL SYSTEM.
- ELEVATED TERRACE IN STORY WATER RETENTION PER CIVIL DRAWING.
- CANTILEVERED.
- WHEEL STOP PER ALA.
- BALCONY BLACK SPOT OVER 4' X 6' OF POLY ISO.
- CONCRETE IMPREGNATED BRICK OR STONE ON TOP OF CONCRETE.
- COMPACT PARKING (ALL AREAS IN WIDTH. ALL ARE GREATER THAN 8' X 10' AND 8' X 8' DEEP).
- PAINTED CURB/WALL LINE.
- MECHANICAL UNIT ALUMINUM ROOF.
- ACROSS THE ROAD TO DRIVING AREA FOR DOOR AND WINDOW OPENINGS SHOWN.
- DOOR/INTERIOR OPENING NUMBER REFER TO DRAWING AREA FOR DOOR AND INTERIOR OPENINGS SHOWN.

PROJECT: 201555
ADDRESS: 400 FREY STREET
CITY: MINNEAPOLIS, MN 55452
CLIENT: STREET LODGING ASSOCIATES, LLC
ARCHITECT: CORY RAYMOND MANAGEMENT COMPANY

GROUND
FLOOR PLAN


A2.00

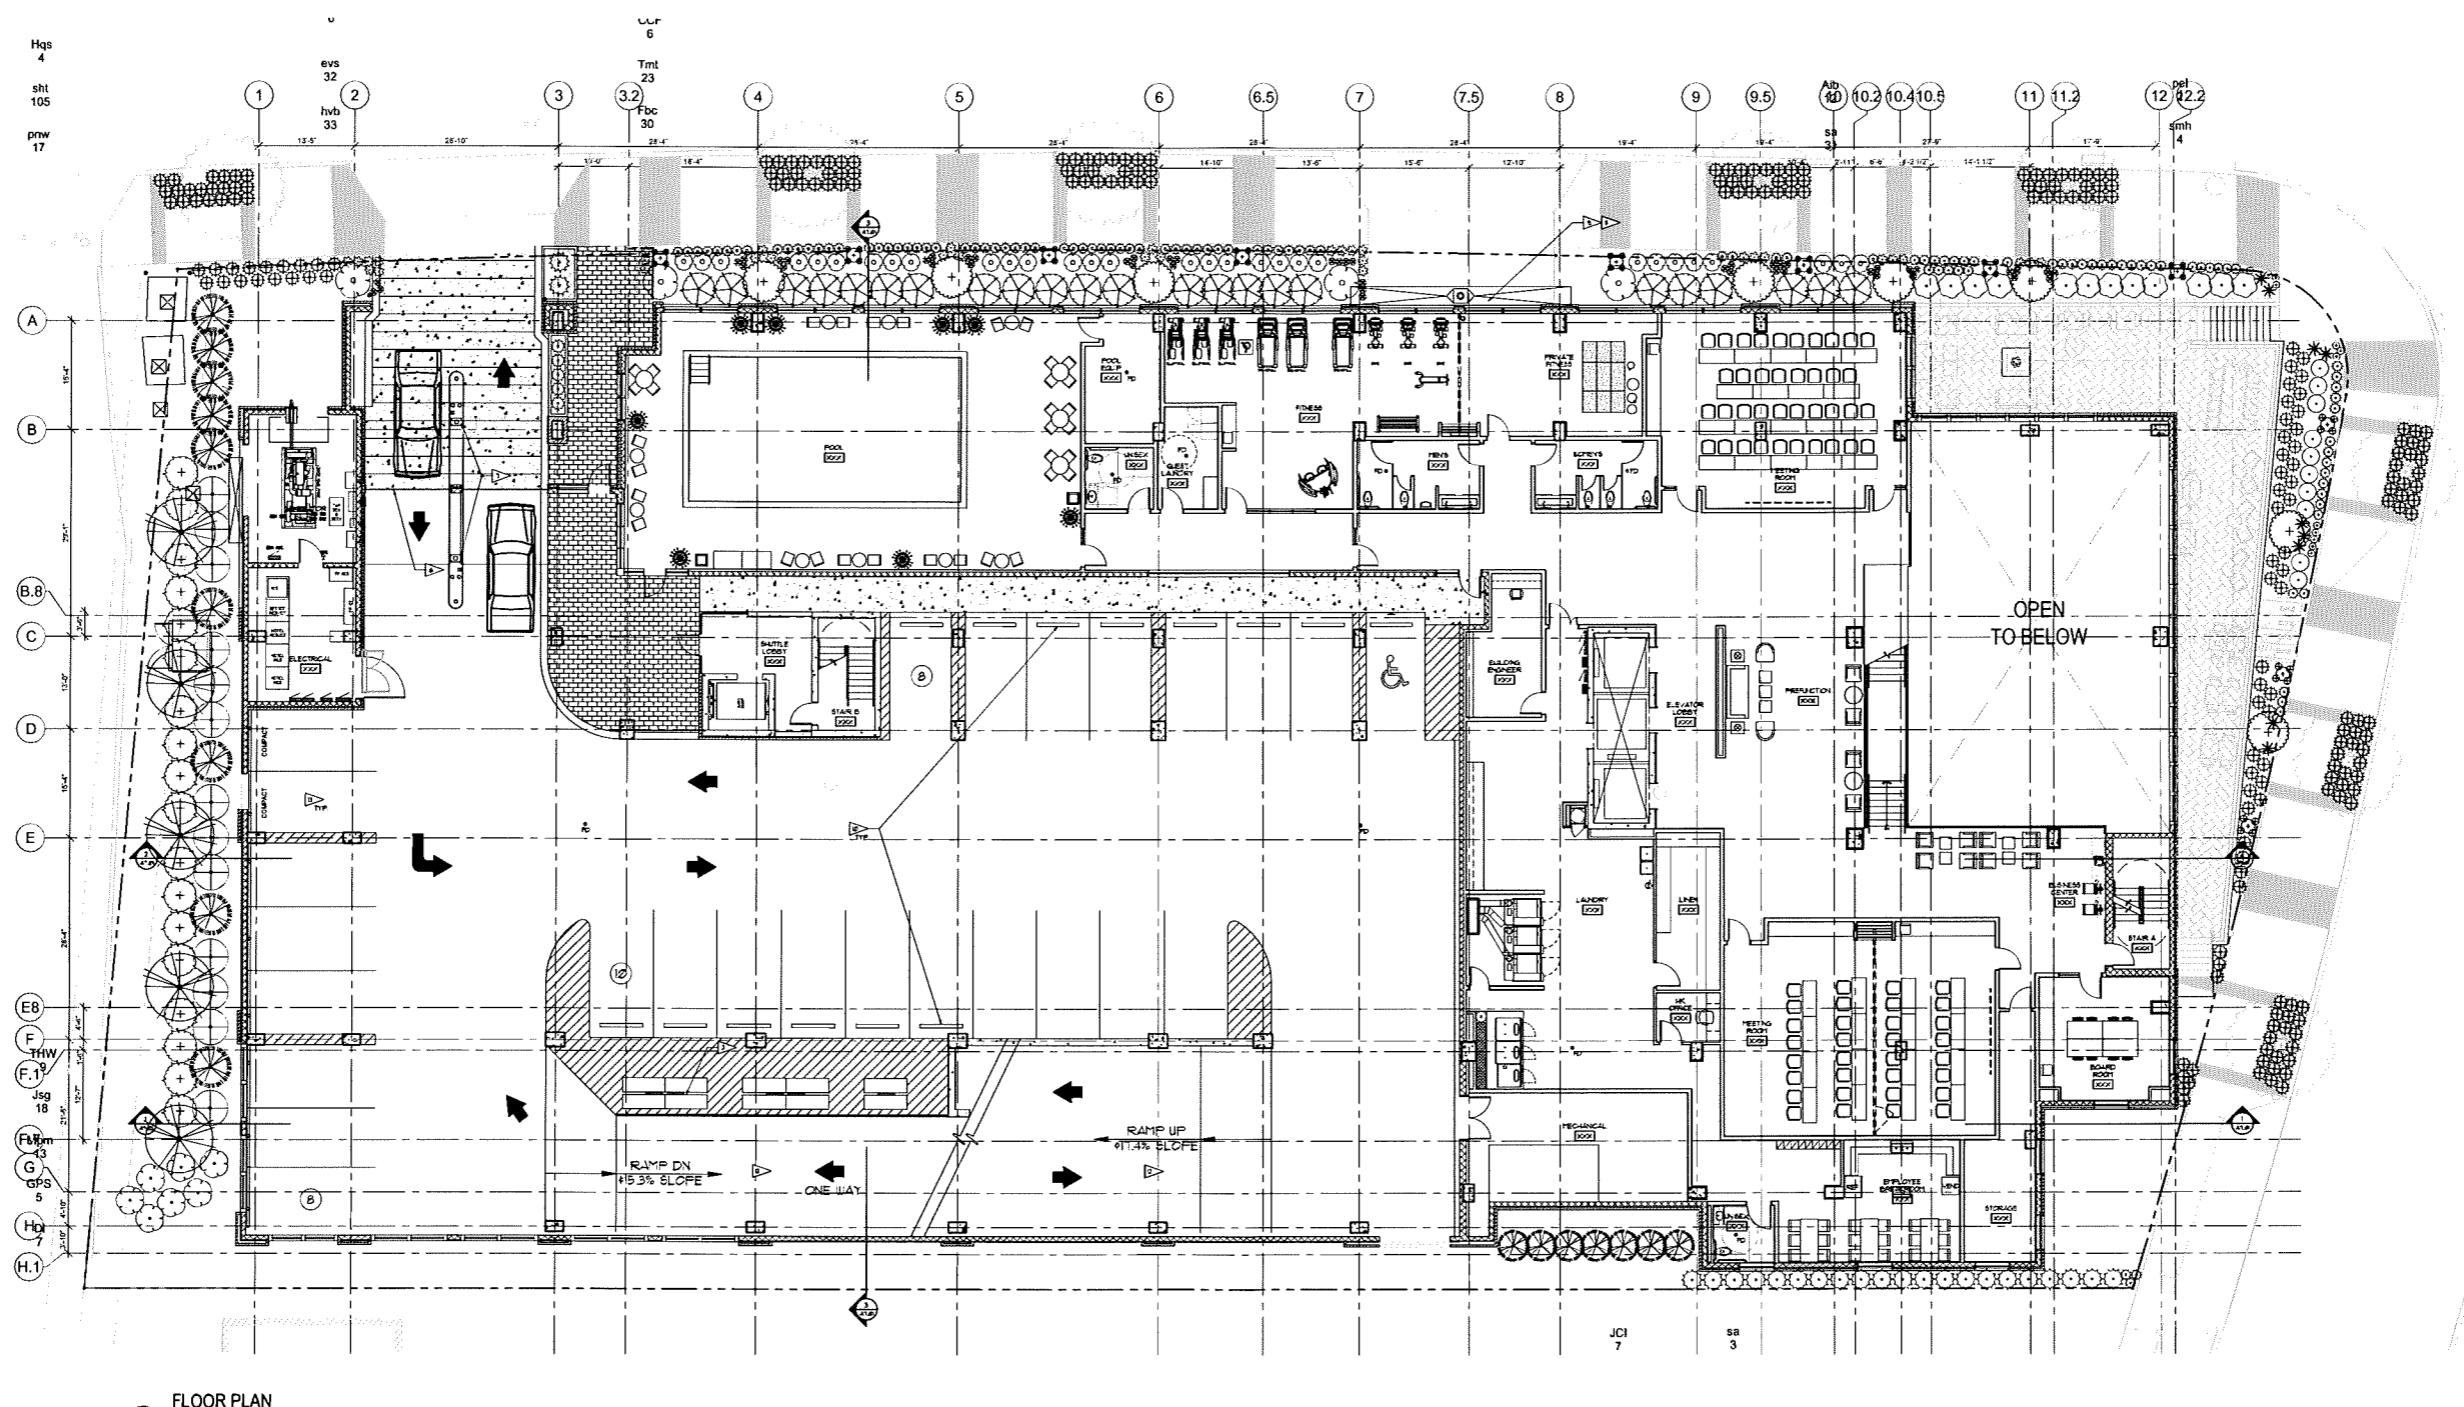

| GENERAL PLAN NOTES | | KEY NOTES | |
|--|--|------------------|--|
| 1. ALL PAVING ARE TO FACE OF 5&1/2 UNLESS NOTED OTHERWISE. 2. EXTERIOR WALKWAYS ARE TO FACE OF 5&1/2 UNLESS NOTED OTHERWISE. EXTERIOR WALKWAYS ARE TO ACCOMMODATE VARIATION IN ELEVATION OF GROUND SURFACE. TO ACHIEVE LATED WALK TYPES ADJUST ELEVATION AS NECESSARY. 3. REFER PLANS FOR DETERMINING OF SPACING AREAS. 4. REFER PLANS FOR DETERMINING OF SPACING AREAS. 5. REFER PLANS FOR DETERMINING OF SPACING AREAS. 6. REFER PLANS FOR DETERMINING OF SPACING AREAS. 7. REFER PLANS FOR DETERMINING OF SPACING AREAS. 8. REFER PLANS FOR DETERMINING OF SPACING AREAS. 9. REFER PLANS FOR DETERMINING OF SPACING AREAS. 10. REFER PLANS FOR DETERMINING OF SPACING AREAS. 11. REFER PLANS FOR DETERMINING OF SPACING AREAS. 12. REFER PLANS FOR DETERMINING OF SPACING AREAS. | ► DECORATIVE CONCRETE PAVING AND ANY HEAT. | | |
| 13. REFER PLANS FOR DETERMINING OF SPACING AREAS. | ► SITE PARKING DOCK. SEE AIM FOR DETAILS. | | |
| 14. REFER PLANS FOR DETERMINING OF SPACING AREAS. | ► MECH CAP INC. SEE AIM FOR DETAILS. | | |
| 15. REFER PLANS FOR DETERMINING OF SPACING AREAS. | ► UNCOVERED AREA BELOW FIRST FLOOR. | | |
| 16. REFER PLANS FOR DETERMINING OF SPACING AREAS. | ► POOL AREA. | | |
| 17. REFER PLANS FOR DETERMINING OF SPACING AREAS. | ► HIGH SPEED HEAD DOOR. | | |
| 18. REFER PLANS FOR DETERMINING OF SPACING AREAS. | ► DOOR ACCESS CONTROL SYSTEM. | | |
| 19. REFER PLANS FOR DETERMINING OF SPACING AREAS. | ► ELEVATED TERRACE OR STORM WATER RETAIN PER CIVIL DRAGMA. | | |
| 20. REFER PLANS FOR DETERMINING OF SPACING AREAS. | ► CANOPY BEAM. | | |
| 21. REFER PLANS FOR DETERMINING OF SPACING AREAS. | ► INCL. STOP FOR AIR. | | |
| 22. REFER PLANS FOR DETERMINING OF SPACING AREAS. | ► CONCRETE SPEED BUMP OR TROUGH AT TOP & BOTTOM. | | |
| 23. REFER PLANS FOR DETERMINING OF SPACING AREAS. | ► DECK/PATIO FURNITURE IS TO BE LOCATED IN HOUSING AREA FOR WALL TYPE CONSTRUCTION. | | |
| 24. REFER PLANS FOR DETERMINING OF SPACING AREAS. | ► FLOOR DRAIN. | | |
| 25. REFER PLANS FOR DETERMINING OF SPACING AREAS. | ► ENTRY LEADER REFER TO PLUMBING. | | |
| 26. REFER PLANS FOR DETERMINING OF SPACING AREAS. | ► COOR TYPE REFER TO DRAWING AND FOR DOOR AND INTERIOR OPENING SCHEDULE. | | |
| 27. REFER PLANS FOR DETERMINING OF SPACING AREAS. | ► DOOR INTERIOR OPENING NUMBER REFER TO DRAWING ALSO FOR DOOR AND INTERIOR OPENING SCHEDULE. | | |
| 28. REFER PLANS FOR DETERMINING OF SPACING AREAS. | ► AN UNPAINTED BLACK STONE OVERLAY 4 IN. POLY SO. | | |
| 29. REFER PLANS FOR DETERMINING OF SPACING AREAS. | ► CONCRETE SPEED BUMP OR TROUGH AT TOP & BOTTOM. | | |
| 30. REFER PLANS FOR DETERMINING OF SPACING AREAS. | ► DECK/PATIO FURNITURE IS TO BE LOCATED IN HOUSING AREA FOR WALL TYPE CONSTRUCTION. | | |
| 31. REFER PLANS FOR DETERMINING OF SPACING AREAS. | ► CANOPY BEAM. | | |
| 32. REFER PLANS FOR DETERMINING OF SPACING AREAS. | ► INCL. STOP FOR AIR. | | |
| 33. REFER PLANS FOR DETERMINING OF SPACING AREAS. | ► CONCRETE SPEED BUMP OR TROUGH AT TOP & BOTTOM. | | |
| 34. REFER PLANS FOR DETERMINING OF SPACING AREAS. | ► DECK/PATIO FURNITURE IS TO BE LOCATED IN HOUSING AREA FOR WALL TYPE CONSTRUCTION. | | |
| 35. REFER PLANS FOR DETERMINING OF SPACING AREAS. | ► FLOOR DRAIN. | | |
| 36. REFER PLANS FOR DETERMINING OF SPACING AREAS. | ► ENTRY LEADER REFER TO PLUMBING. | | |
| 37. REFER PLANS FOR DETERMINING OF SPACING AREAS. | ► COOR TYPE REFER TO DRAWING AND FOR DOOR AND INTERIOR OPENING SCHEDULE. | | |
| 38. REFER PLANS FOR DETERMINING OF SPACING AREAS. | ► DOOR INTERIOR OPENING NUMBER REFER TO DRAWING ALSO FOR DOOR AND INTERIOR OPENING SCHEDULE. | | |


PROJECT: 201525
 FREY STREET - MIXED USE DEVELOPMENT
 400 FREY STREET
 WISCONSIN 53093
 CITY: MADISON
 COUNTY: MADISON
 STATE: WISCONSIN

FIRST
 FLOOR PLAN
 A2.01

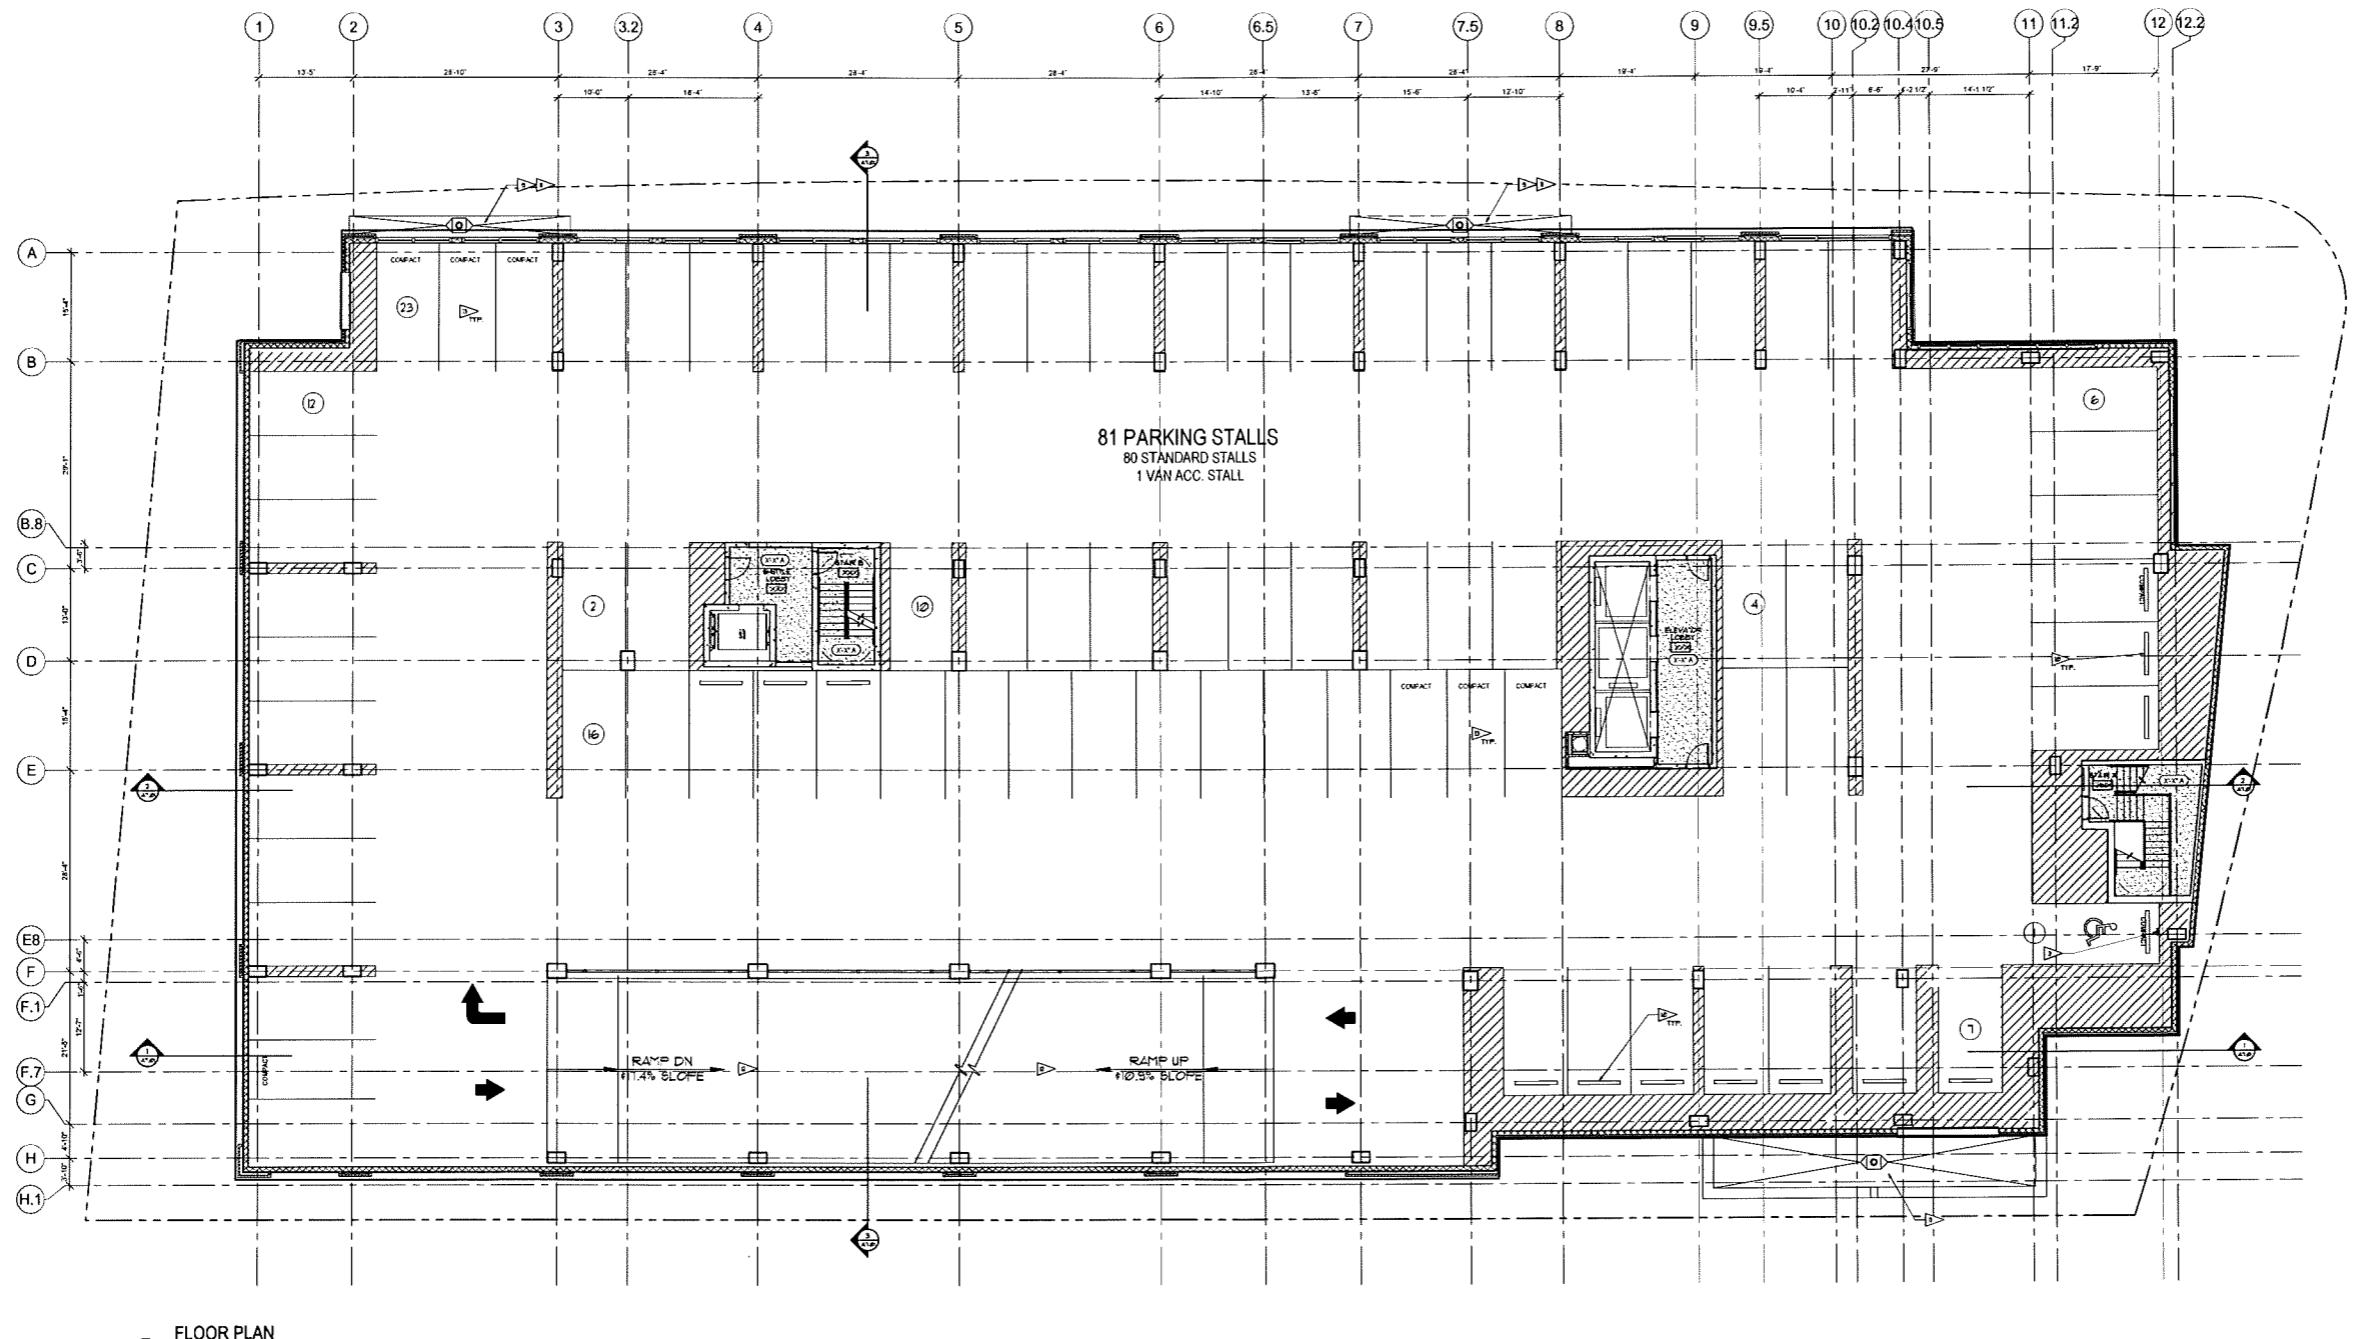

PROJECT: FREY STREET - MIXED USE DEVELOPMENT
401 FREY STREET, MILWAUKEE, WI 53205
CLIENT: KEY STREET LODGING ASSOCIATES, LLC
KEY STREET LODGING MANAGEMENT COMPANY
MILWAUKEE, WI 53205


SECOND FLOOR PLAN
A2.02

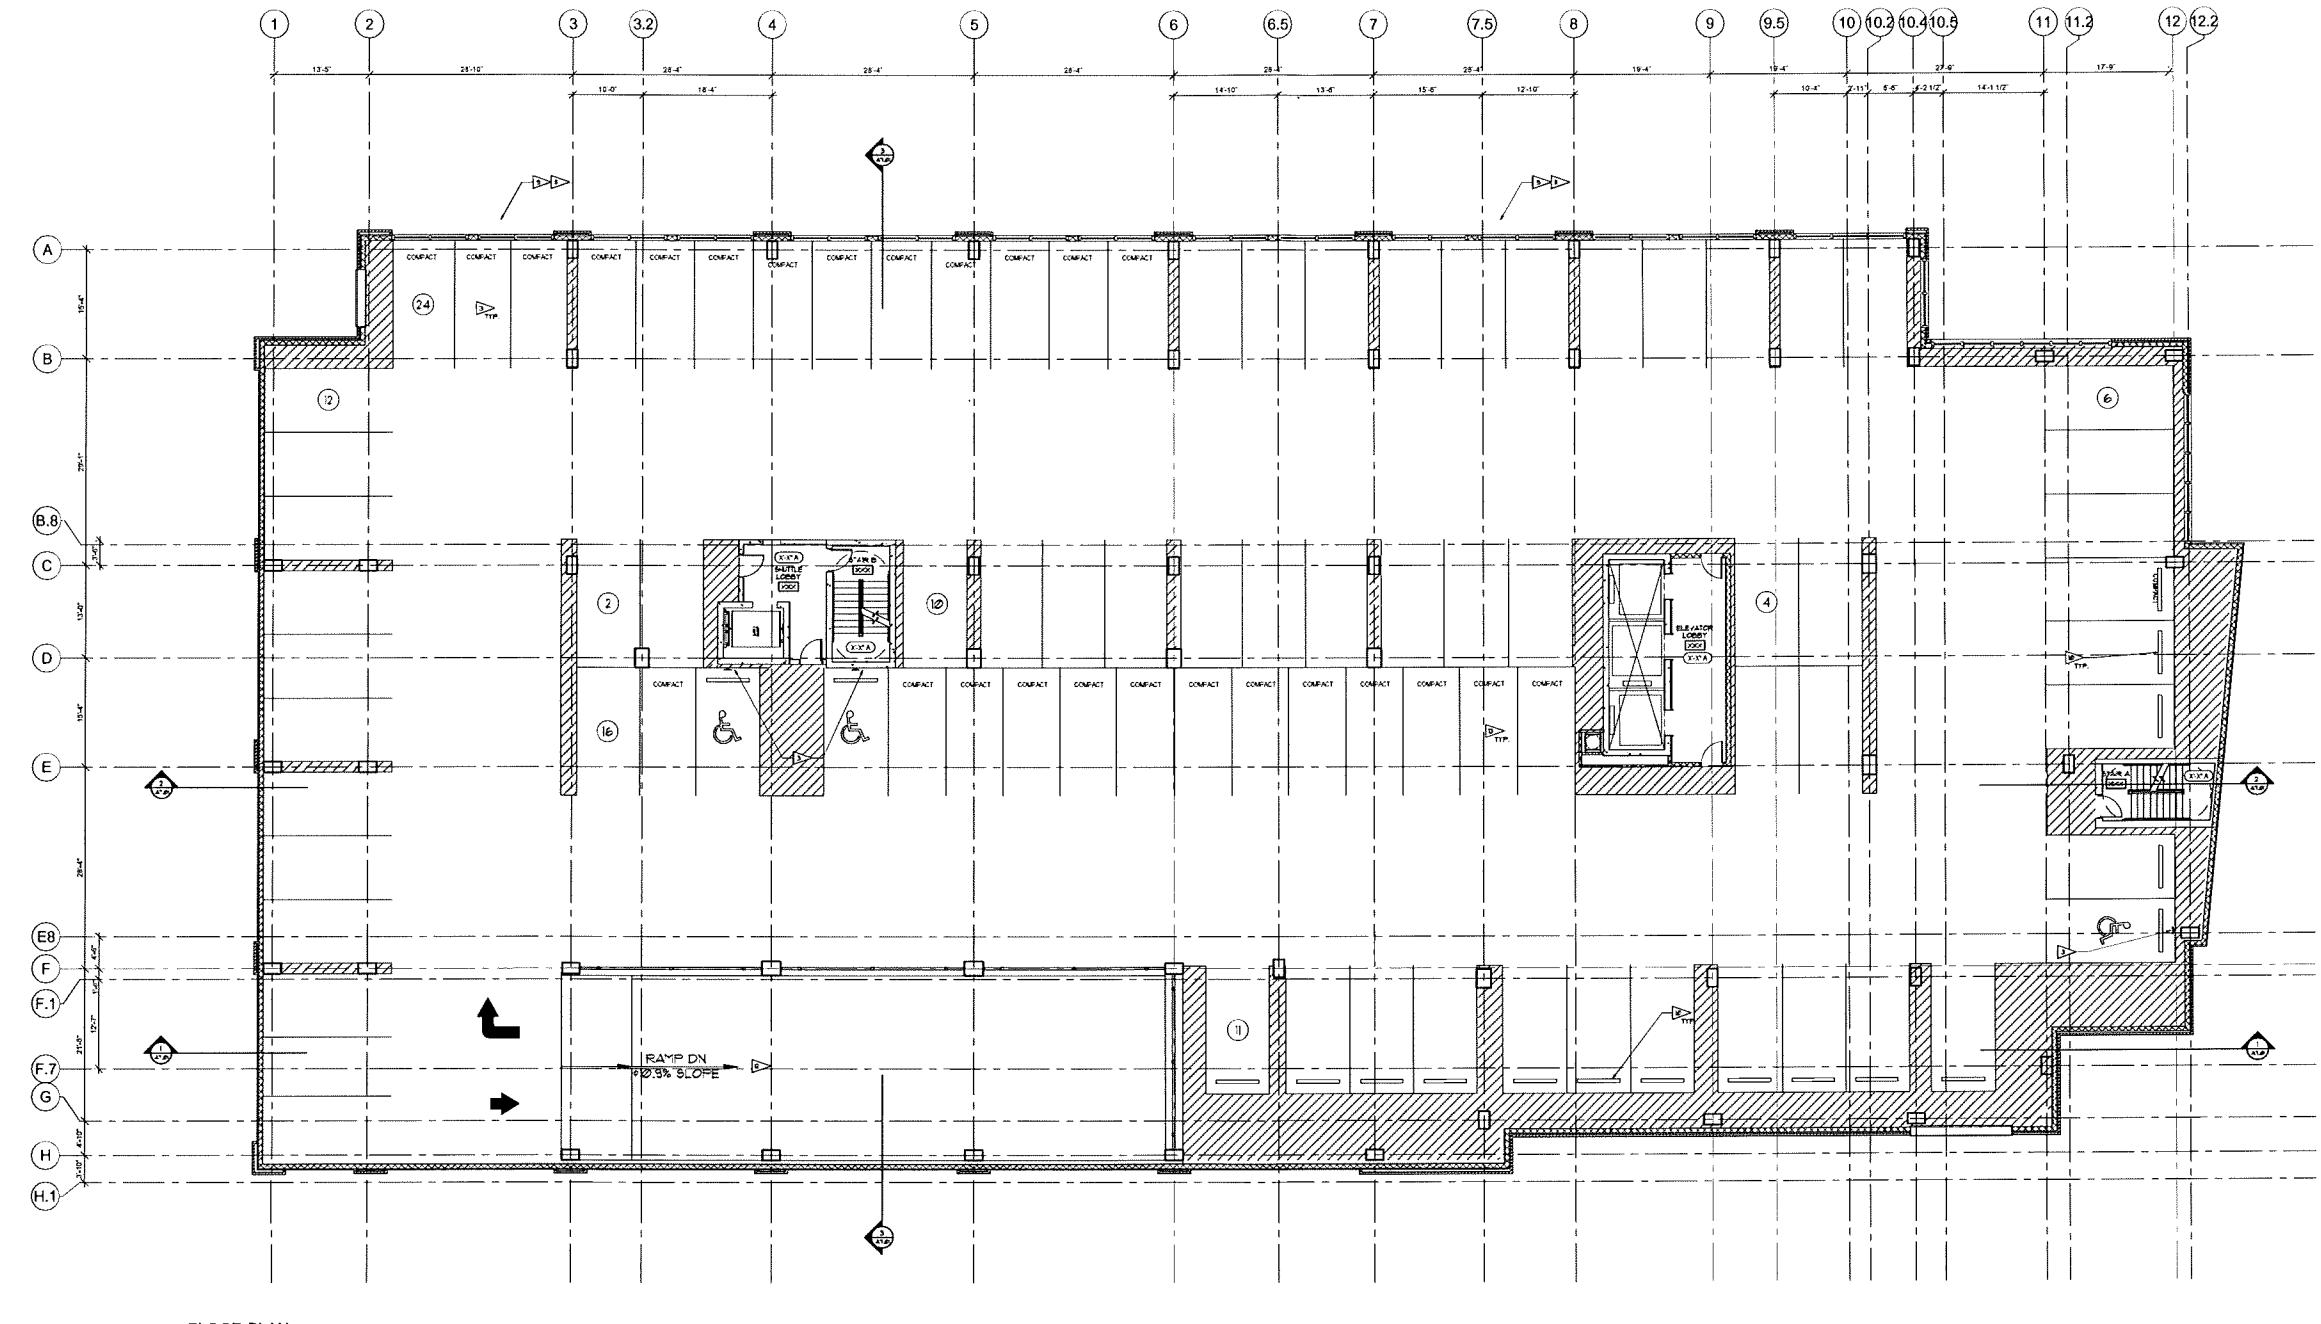

| GENERAL PLAN NOTES | |
|--|--|
| 1. ALL DIMENSIONS ARE TO FACE OF WALL UNLESS NOTED OTHERWISE. 2. EXTERIOR WALLS ARE TO BE CONCRETE BLOCK OR STONE VENEER. 3. EXTERIOR WALLS DO NOT HAVE ACCESS TO THE VARIOUS LATENT OR EXISTING HALL AREAS. TO PROVIDE ACCESS TO THESE AREAS, ADD AN EXTERIOR STAIRCASE OR LIFT. | |
| 4. REFER PLANS FOR DETERMINATION OF SPACING AREAS. 5. REFER PLANS FOR ALL FIRE EXTINGUISHER LOCATIONS. 6. REFER PLANS FOR ALL EQUIPMENT LOCATIONS. 7. REFER PLANS FOR ALL HALL AREAS AS ALL ARE COVERED OVER BY ADDITIONAL ROOF TRUSSES. ELECTRICAL, IF NOT PROVIDED, IS THE RESPONSIBILITY OF THE OWNER. IF PROVIDED, ELECTRICAL CONTRACTOR IS TO PROVIDE A DRAFT TO ENGINEER FOR APPROVAL. 8. REFER PLANS FOR ALL WALL ACROSS. RAILINGS ARE NOT BUILT ON THESE PLANS FOR CLARITY. 9. DRAWDINGS ARE NOT TO SCALE. DRAWDINGS ARE MEANINGFUL. 10. UNLESS NOTED OTHERWISE, ALL DOORS ARE TO BE LOCATED IN FRESH AIR/WALL. | |
| 11. REFER PLANS FOR ALL WALL ACROSS. RAILINGS ARE NOT BUILT ON THESE PLANS FOR CLARITY. 12. DRAWDINGS ARE NOT TO SCALE. DRAWDINGS ARE MEANINGFUL. 13. UNLESS NOTED OTHERWISE, ALL DOORS ARE TO BE LOCATED IN FRESH AIR/WALL. | |
| KEY NOTES | |
| 1. DECORATIVE CONCRETE PAVING W/ RADIAL HEAT. 2. ENTRANCE DOOR. SEE ALR FOR DETAILS. 3. HANDICAP DOOR. SEE ALR FOR DETAILS. 4. UNLEVEL AREA BELOW FIRST FLOOR. 5. POOL ABOVE. 6. HIGH SPEED HEAD DOOR. 7. DOOR ACCESS CONTROL SYSTEM. 8. ELEVATED TERRACE OF STORM WATER RETENTION PER CIV. DRAWINGS. 9. CARPORT. 10. GATE STOP PER ALR. 11. BALCONY BLOCK SPAN OVER 4' X 4' OF POLY SOIL. 12. CONCRETE SPEED RAMP TO TURNBOW AT TOP EDITION. 13. COMPACT PAVING SHALL BE 2" THICK IN NORTH. ALL ARE GREATER THAN 4' IN LENGTH OR DEEP. 14. PAINTED ALUMINUM SCREEN. 15. OUTLINE OF HOTEL VALET ABOVE. 16. APPROXIMATE SUPPORT PLATES TO BE PROVIDED FREE BY OWNER AND ARCHITECT. | |
| PLAN SYMBOLS | |
| ALL-PURPOSE FIRE EXTINGUISHERS 4-4 LB. EACH. 4-4 LB. NOTIFICATION CAPACITY. 4-4 LB. NOTIFICATION CAPACITY. 4-4 LB. NOTIFICATION CAPACITY. 4-4 LB. NOTIFICATION CAPACITY. FIRE EXTINGUISHER CABINET. 4-4 LB. EACH. 4-4 LB. NOTIFICATION CAPACITY. 4-4 LB. NOTIFICATION CAPACITY. 4-4 LB. NOTIFICATION CAPACITY. FIRE HYDRANT. 4-4 LB. EACH. 4-4 LB. NOTIFICATION CAPACITY. 4-4 LB. NOTIFICATION CAPACITY. FLOOR DRAIN. FIRE ALARM. FLOOR LEADER. REFER TO PLUMBING DESIGN. DOOR. REFER TO DRAWINGS FOR SIZE AND INTERIOR OPENING SCHEDULE. DOOR INTERIOR OPENING NUMBER. REFER TO DRAWINGS ALR FOR DOOR AND INTERIOR OPENING SCHEDULE. DOOR INTERIOR OPENING NUMBER. REFER TO DRAWINGS ALR FOR DOOR AND INTERIOR OPENING SCHEDULE. DOOR INTERIOR OPENING NUMBER. REFER TO DRAWINGS ALR FOR DOOR AND INTERIOR OPENING SCHEDULE. DOOR INTERIOR OPENING NUMBER. REFER TO DRAWINGS ALR FOR DOOR AND INTERIOR OPENING SCHEDULE. DOOR INTERIOR OPENING NUMBER. REFER TO DRAWINGS ALR FOR DOOR AND INTERIOR OPENING SCHEDULE. DOOR INTERIOR OPENING NUMBER. REFER TO DRAWINGS ALR FOR DOOR AND INTERIOR OPENING SCHEDULE. DOOR INTERIOR OPENING NUMBER. REFER TO DRAWINGS ALR FOR DOOR AND INTERIOR OPENING SCHEDULE. | |

PROJECT: FREY STREET - MIXED USE DEVELOPMENT
ADDRESS: 400 FREY STREET, MIDDLETON, WI 53562
DRAWN BY: [Signature]
DATE: 9-10-06
SCALE: AS NOTED
LOC 1: DW-10-06
LAND USE: DT-00-06
CITY INDUSTRIAL: DI-00-06
ELEVATIONAL DRAWINGS: E-00-06

THIRD
FLOOR PLAN
A2.03

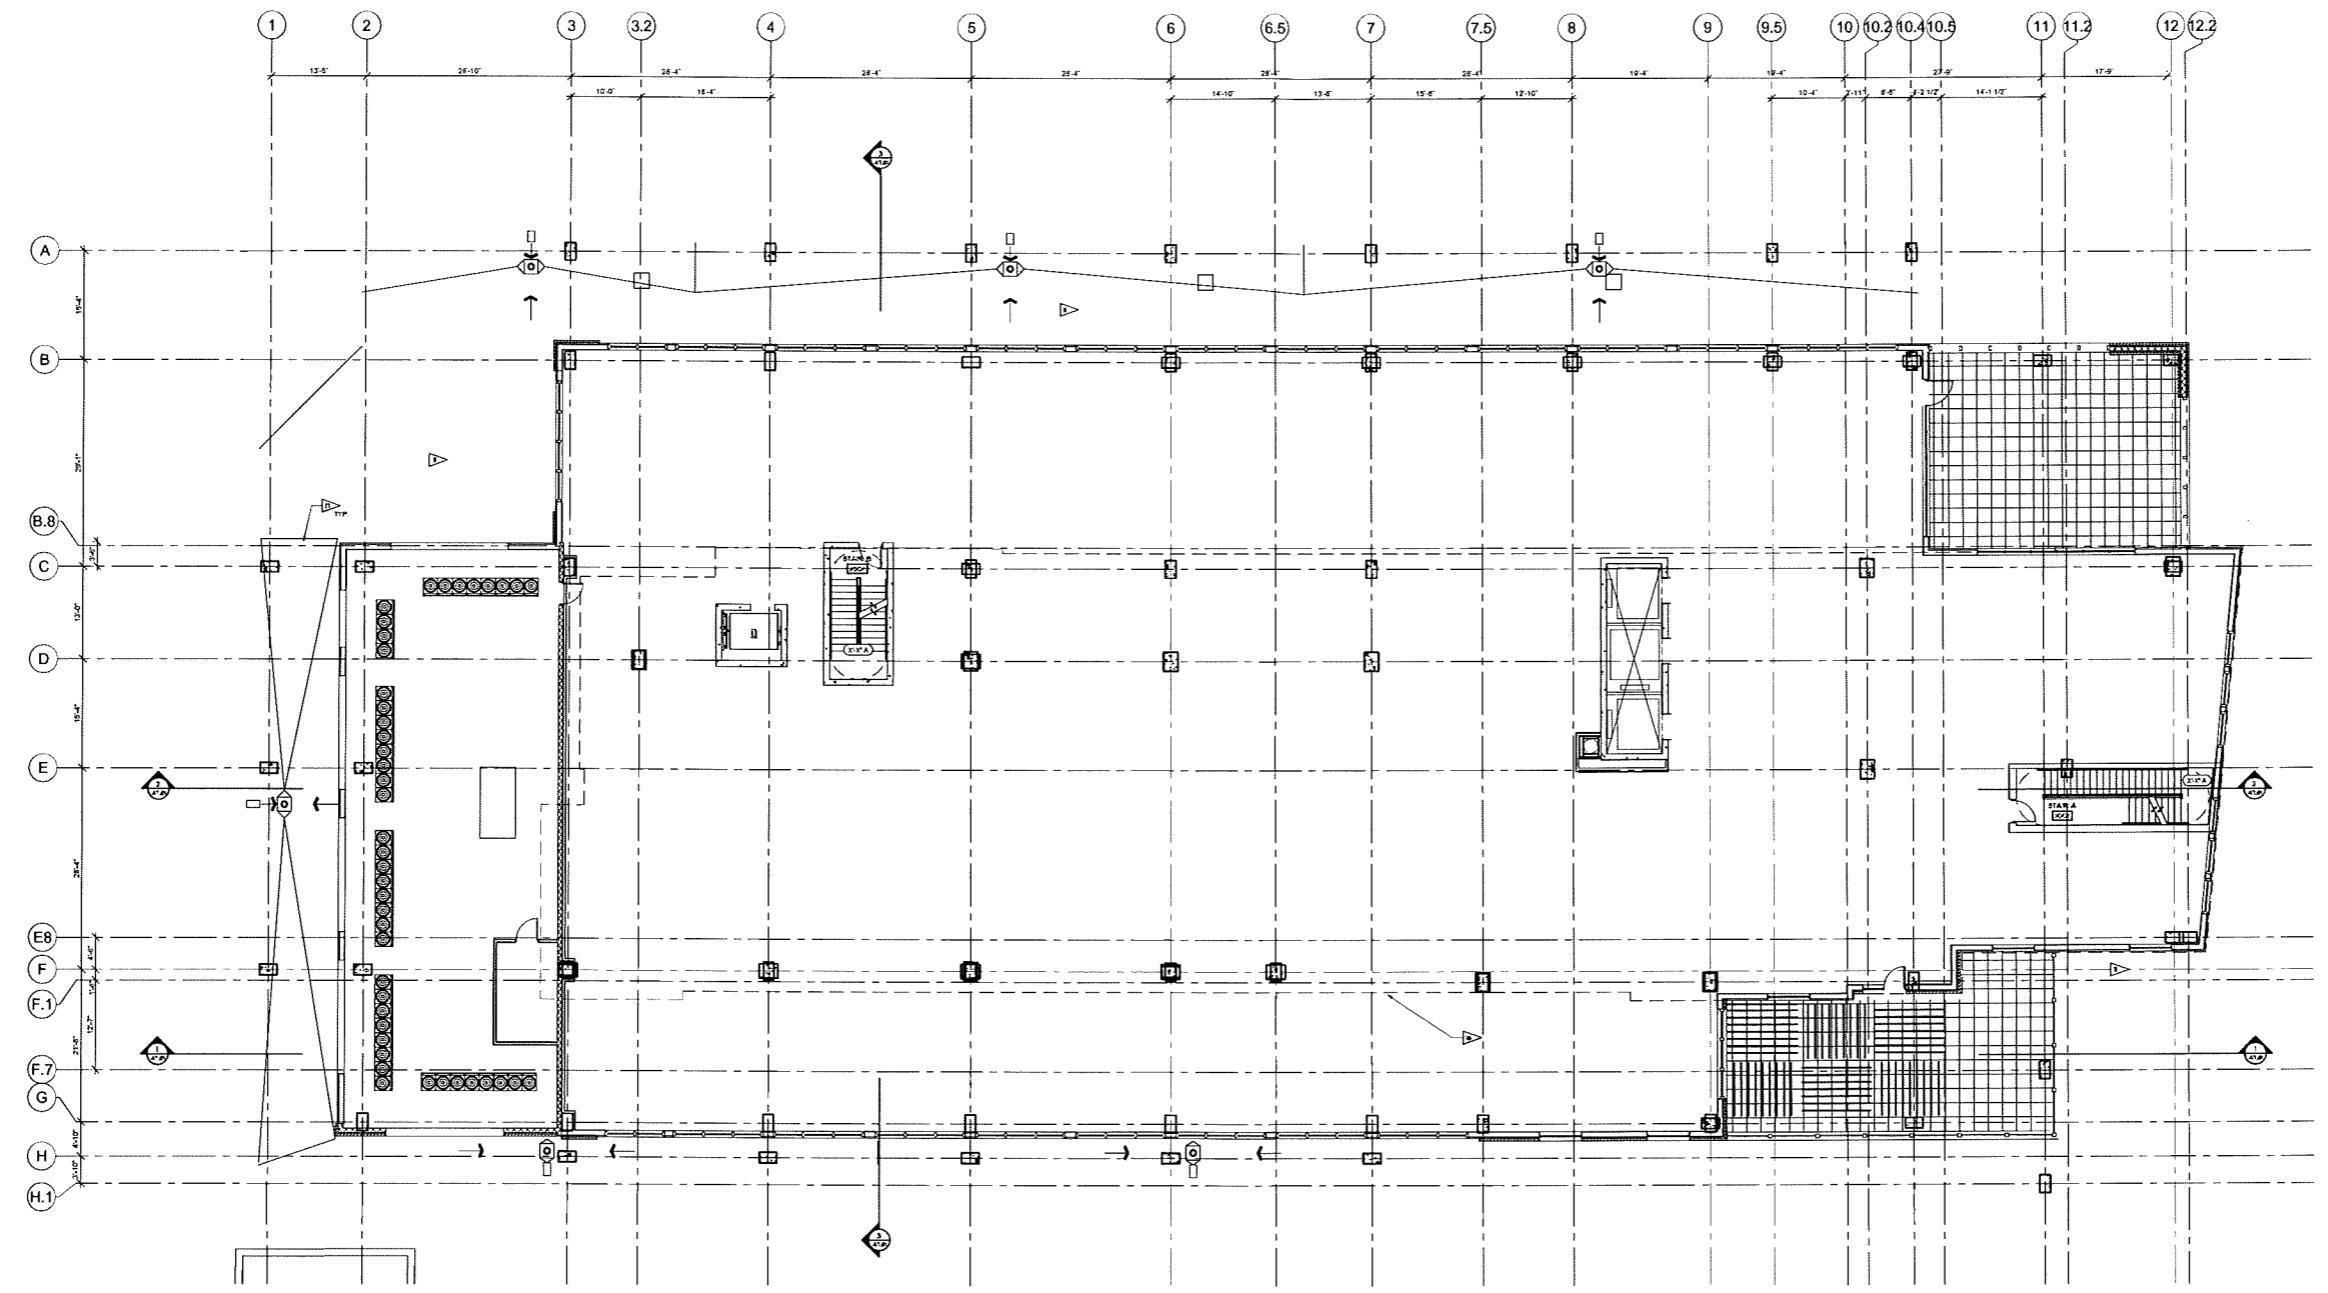

GENERAL PLAN NOTES

- ALL OPENINGS ARE TO FACE OF STO. unless noted otherwise.
- EXTENSION EXPANSIONS ARE TO FACE OF EXTERIOR SHEATHING OR INSIDE OF INTERIOR WALL. USE 4" IN. FOR DETAILS.
- INTERIOR DOORS ARE TO BE 30" X 80" OR 32" X 80" UNLESS OTHERWISE SPECIFIED. DOORS ARE TO SWING OUTWARD UNLESS OTHERWISE INDICATED.
- BK IN PLANS FOR DETERMINATION OF APPROX. AREA.
- ICE MELT ALUMINUM FOR ALL TIME CONSTRUCTION.
- STRUCTURAL SYSTEMS ARE TO BE DESIGNED BY ADDITIONAL ENGINEER. PIPING, AIR DUCTS, S/B TUBE AND ROOF/CLAD SHEATHING MUST NOT DAMAGE THE STRUCTURE. NO PIPE, DUCT, OR SHEATHING CAN BE PLACED ON THE EXTERIOR OF THE BUILDING.
- ALL EXTERIOR WALL RAILINGS, RAILINGS ARE NOT TO REST ON THESE PLANS FOR CLARITY.
- OTHER SMALL PROBLEMS ARE LEFT TO OWNER'S DESIGN INCLUDING CONCRETE SLAB, ROOF, ETC. (EX. ROOF OVERHANGS, ETC.) UNLESS NOTED ON PLANS. OTHERWISE, ALL DOORS ARE TO BE LOCATED AT PUNCH ACCORDING TO PLANS.

PLAN SYMBOLS

- ALL DOORS ARE TO SWING OUTWARD UNLESS OTHERWISE INDICATED. DOORS ARE TO SWING OUTWARD UNLESS OTHERWISE INDICATED.
- ALL ROOF EXPANSION JOINTS ARE TO BE APPROVED BY LARSEN MANUFACTURING COMPANY, OR APPROVED EQUAL.
- ALL ROOF EXPANSION JOINTS ARE TO BE APPROVED BY LARSEN MANUFACTURING COMPANY, OR APPROVED EQUAL.
- ALL EXTERIOR DOORS ARE TO SWING OUTWARD UNLESS OTHERWISE INDICATED.
- DOOR LEADER REFER TO PUSHING SIDE.
- FLOOR DRAIN
- DOOR TYPE REFER TO DRAWING AND INTERIOR OPENING SCHEDULE.
- DOOR INTERIOR OPENING NUMBER REFER TO DRAWING AND INTERIOR OPENING SCHEDULE.
- MINIMUM CLEARANCE PLACEMENT AND DIMENSIONS ARE TO BE COORDINATED & OWNER AND ARCHITECT.

KEY NOTES


- DECORATIVE CONCRETE PAVING IN RADIAN HEAT.
- ENKE PARKING DOOR. SEE ENKE FOR DETAILS.
- HARDWARE. SEE ALUM FOR DETAILS.
- INDICATED AREA BELOW FIRST FLOOR.
- PEEL ADH.
- PLAN FOR CLARITY.
- OWNER SHALL PROVIDE ALL CLOSER ROOF DOOR SCAFFOLDING INCLUDING DOORS, LADDERS, ETC.
- UNLESS NOTED ON PLANS. OTHERWISE, ALL DOORS ARE TO BE LOCATED AT PUNCH ACCORDING TO PLANS.
- ELEVATED TERRACE IN ROOF WATER RECEPTION PER CIV. DRAWING.
- CANOPY BELOW.
- INSEL, INSEL PER ALUM.
- BALLASTED BLACK IRON OVER 1/2" IN. OF POLY SO.
- CONCRETE INSEL IRON TO MOUNT AT TOP OF BOTTOM. ALL CONCRETE INSEL IRON TO MOUNT AT TOP OF BOTTOM.
- CONTACT ARCHITECT FOR ALL TIME CONSTRUCTION. UNLESS NOTED ON PLANS. OTHERWISE, ALL DOORS ARE TO BE LOCATED AT PUNCH ACCORDING TO PLANS.
- PAINTED ALUMINUM TRIM.
- TECHNICAL UNIT ALUMINUM SCREEN.
- DOOR INTERIOR OPENING NUMBER REFER TO DRAWING AND INTERIOR OPENING SCHEDULE.
- MINIMUM CLEARANCE PLACEMENT AND DIMENSIONS ARE TO BE COORDINATED & OWNER AND ARCHITECT.

 FOURTH
FLOOR PLAN

A2.04

 PROJECT:
 FREY STREET - MIXED USE DEVELOPMENT
 400 FREY STREET
 MADISON, WISCONSIN 53705
 CLIENT:
 CORAY STREET LODGING ASSOCIATES, LLC
 CORAY STREET LODGING MANAGEMENT COMPANY
 ADDRESS: NEW YORK CITY, NY

 DRAWN BY: BLM
 DATE: 12-12-06
 SCALE: AS NOTED
 Job # 11-308
 Land Use: 01-09-301
 City/County: 01-0-301

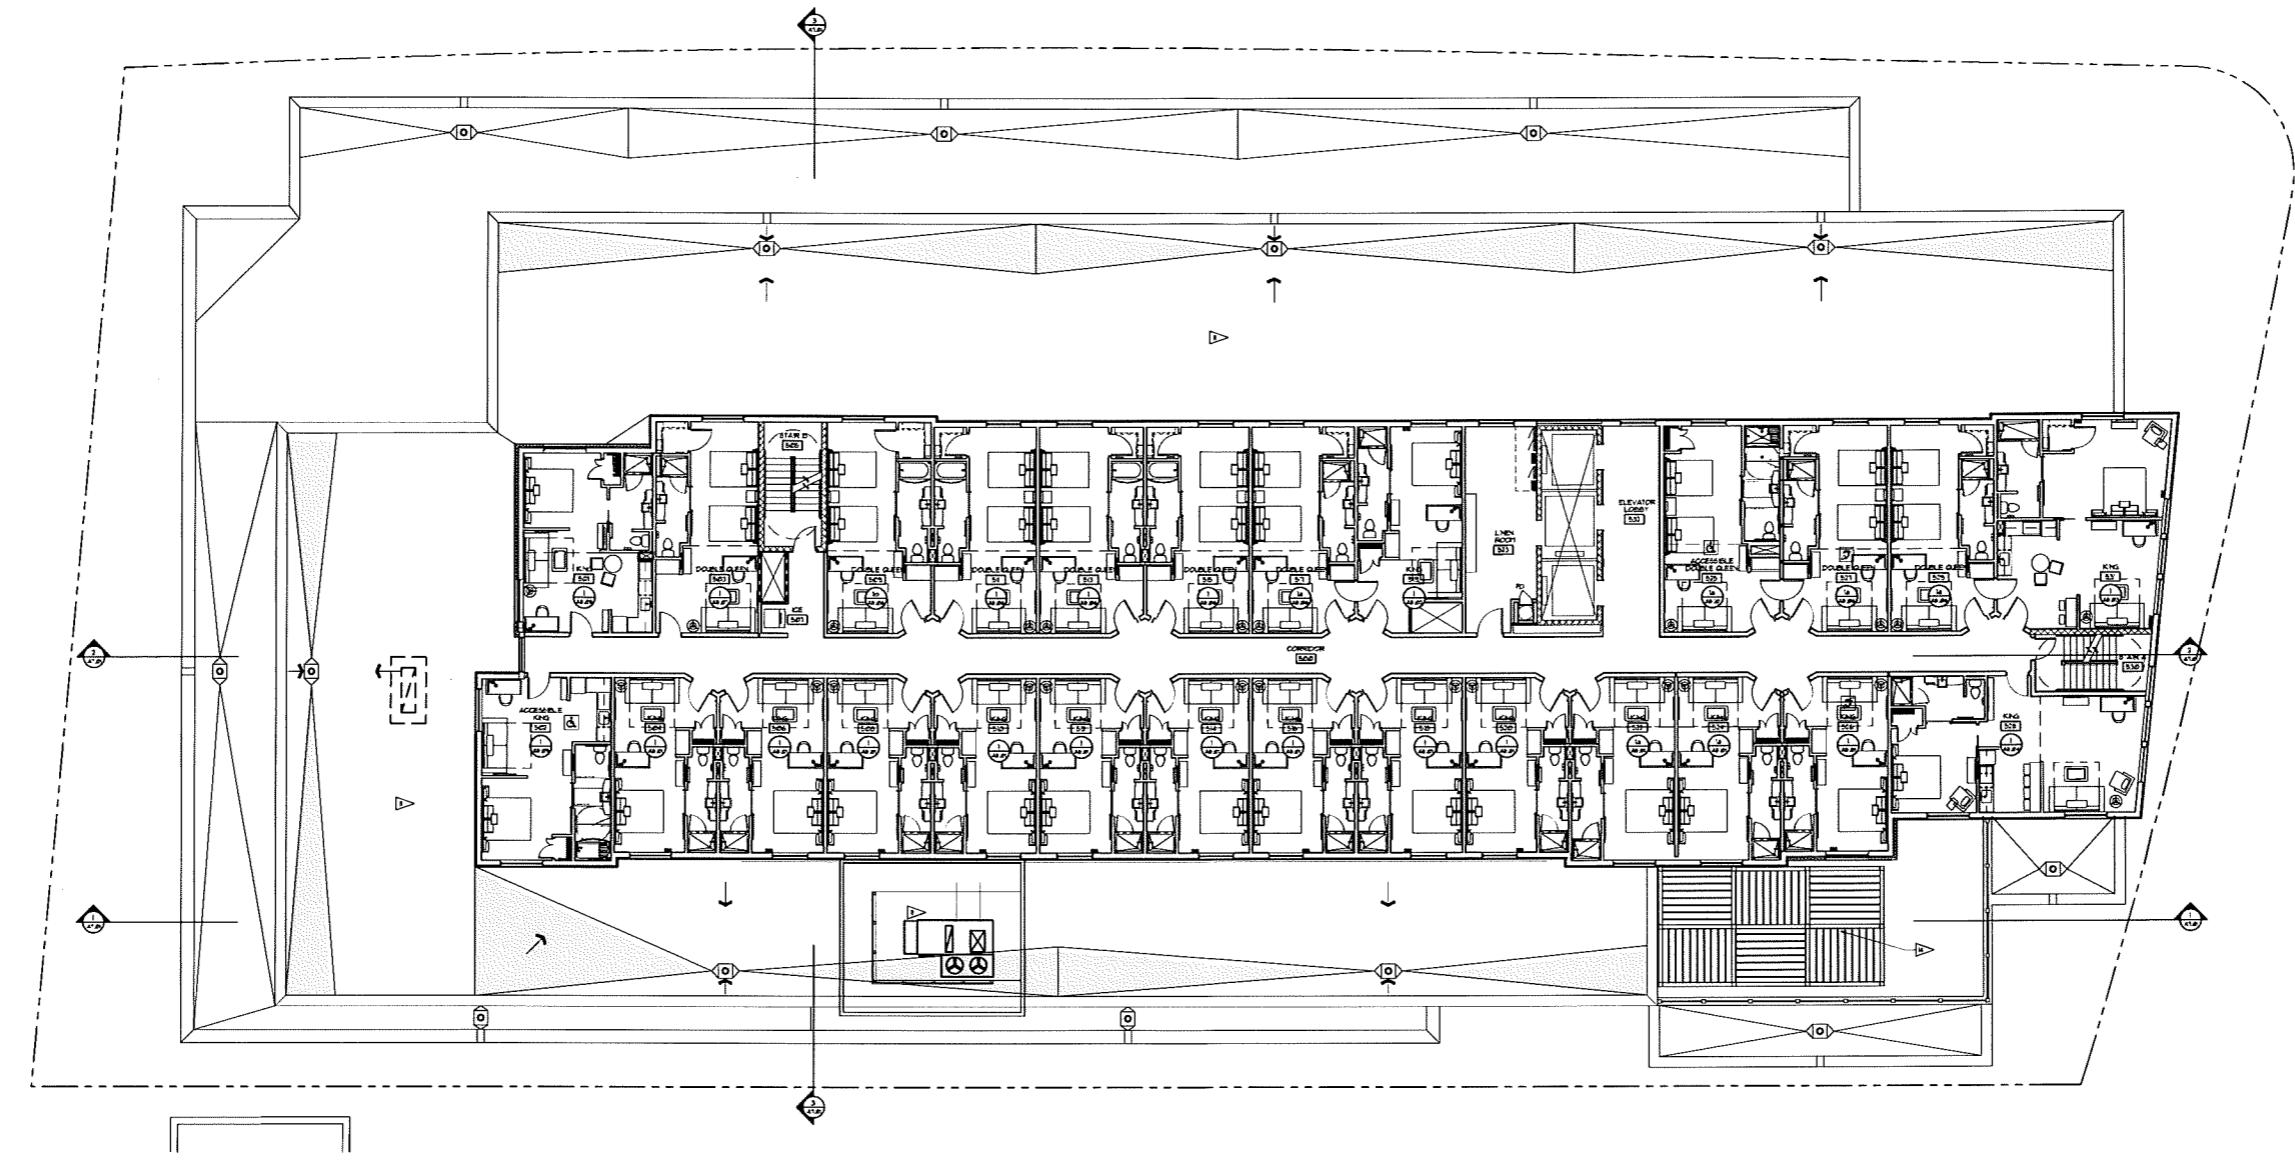

FIFTH FLOOR PLAN

1'-0" x 14'-0"

GENERAL PLAN NOTES


- ALL DOORS ARE TO FACE OF 8'0" WALLS NOTED ON DRAWING.
- EXTERIOR EXTERIOR AND STAFF DOORS ARE TO FACE OF 8'0" WALLS NOTED ON DRAWING.
- DOORS ARE TO BE SWINGING IN THE DIRECTION OF EXTERIOR EXTERIOR AND STAFF DOORS. TO ACHIEVE 8'0" SWING, TYPES ADJUST AS PER LOCAL CODE REQUIREMENTS.
- REF ID: PLANS FOR OTHER SWING OF SWING AREAS.
- REF ID: PLANS FOR OTHER SWING AREAS.
- WALLS ARE TO BE SWUNG OVER BY ADDITIONAL SWING GATE. SWING, SUBSTITUTE S/F TYPE OF DOOR AS SWING AND SWING GATE. SWING GATE IS TO SWING IN THE DIRECTION OF EXTERIOR EXTERIOR AND STAFF DOORS. SWING GATE IS TO SWING IN THE DIRECTION OF EXTERIOR EXTERIOR AND STAFF DOORS.
- PLANS FOR CLEARANCE.
- OTHER SWING PROBLEMS: CODE REQUIRES SWINGING DOORS TO SWING OUTWARD. EXTERIOR EXTERIOR AND STAFF DOORS ARE NOT SWUNG OUTWARD.
- UNSWUNG AREA BELOW FIRST FLOOR.
- POOL ABOVE.
- HIGH SPEED HEAD DOOR.
- DOOR ACCESS CONTROL SYSTEM.
- ELEVATED TERRACE IN STORY WATER RETENTION PER CIVL DRAWINGS.
- CARRY BEAM.
- WHEEL CHAIR PARKING.
- SWINGING DOORS ARE TO SWING OUTWARD.
- SWINGING DOORS ARE TO SWING INWARD.
- ELEVATED BLACK EPON OVER 4' FT OF POLY SO.
- GARAGE SPEED BUMP TO SWING ON AT TOP & BOTTOM.
- DEPACT PARKING SHALL BE 8'0" X 10'0". ALL ARE GREATER THAN 8'0" X 8'0" IN DEPACT.
- PAINTED ALUMINUM TRIM.
- TECHNICAL UNIT ALUMINUM SCREEN.
- LINE OF HOTEL DOOR ABOVE.
- APPROVAL LETTERS PLACED IN CIVL DRAWINGS REFER TO DOOR INTERIOR OPENING NUMBER. REFER TO DRAWINGS ALSO FOR DOOR AND INTERIOR OPENING SCHEDULE.

PLAN SYMBOLS

- D - DECORATIVE CONCRETE PAVING UND AN HEAT.
- DR - PARKING DOOR. SEE ADR FOR DETAILS.
- DR-A - ACCESIBLE DOOR. SEE ADR FOR DETAILS.
- DR-B - BATH DOOR. SEE ADR FOR DETAILS.
- DR-C - CLOSET DOOR.
- DR-E - ELEVATOR DOOR.
- DR-F - FIRE DOOR.
- DR-G - GLASS DOOR.
- DR-H - HALL DOOR.
- DR-I - HIGH SPEED HEAD DOOR.
- DR-J - DOOR ACCESS CONTROL SYSTEM.
- DR-K - ELEVATED TERRACE IN STORY WATER RETENTION PER CIVL DRAWINGS.
- DR-L - CARRY BEAM.
- DR-M - WHEEL CHAIR PARKING.
- DR-N - SWINGING DOORS ARE TO SWING OUTWARD.
- DR-O - SWINGING DOORS ARE TO SWING INWARD.
- DR-P - ELEVATED BLACK EPON OVER 4' FT OF POLY SO.
- DR-Q - GARAGE SPEED BUMP TO SWING ON AT TOP & BOTTOM.
- DR-R - DEPACT PARKING SHALL BE 8'0" X 10'0". ALL ARE GREATER THAN 8'0" X 8'0" IN DEPACT.
- DR-S - PAINTED ALUMINUM TRIM.
- DR-T - TECHNICAL UNIT ALUMINUM SCREEN.
- DR-U - LINE OF HOTEL DOOR ABOVE.
- DR-V - APPROVAL LETTERS PLACED IN CIVL DRAWINGS REFER TO DOOR INTERIOR OPENING NUMBER. REFER TO DRAWINGS ALSO FOR DOOR AND INTERIOR OPENING SCHEDULE.

PROJECT: FREY STREET - MIXED USE DEVELOPMENT
 401 FREY STREET
 MIDDLETON, WISCONSIN 53562
CLIENT: CORAL MOND MANAGEMENT COMPANY
 MIDDLETON, WISCONSIN

DRAWN BY: DATE: SCALE: AS NOTED
 JDC 1 6-18-04
 LAD 1 6-18-04
 CIVL 1 6-18-04

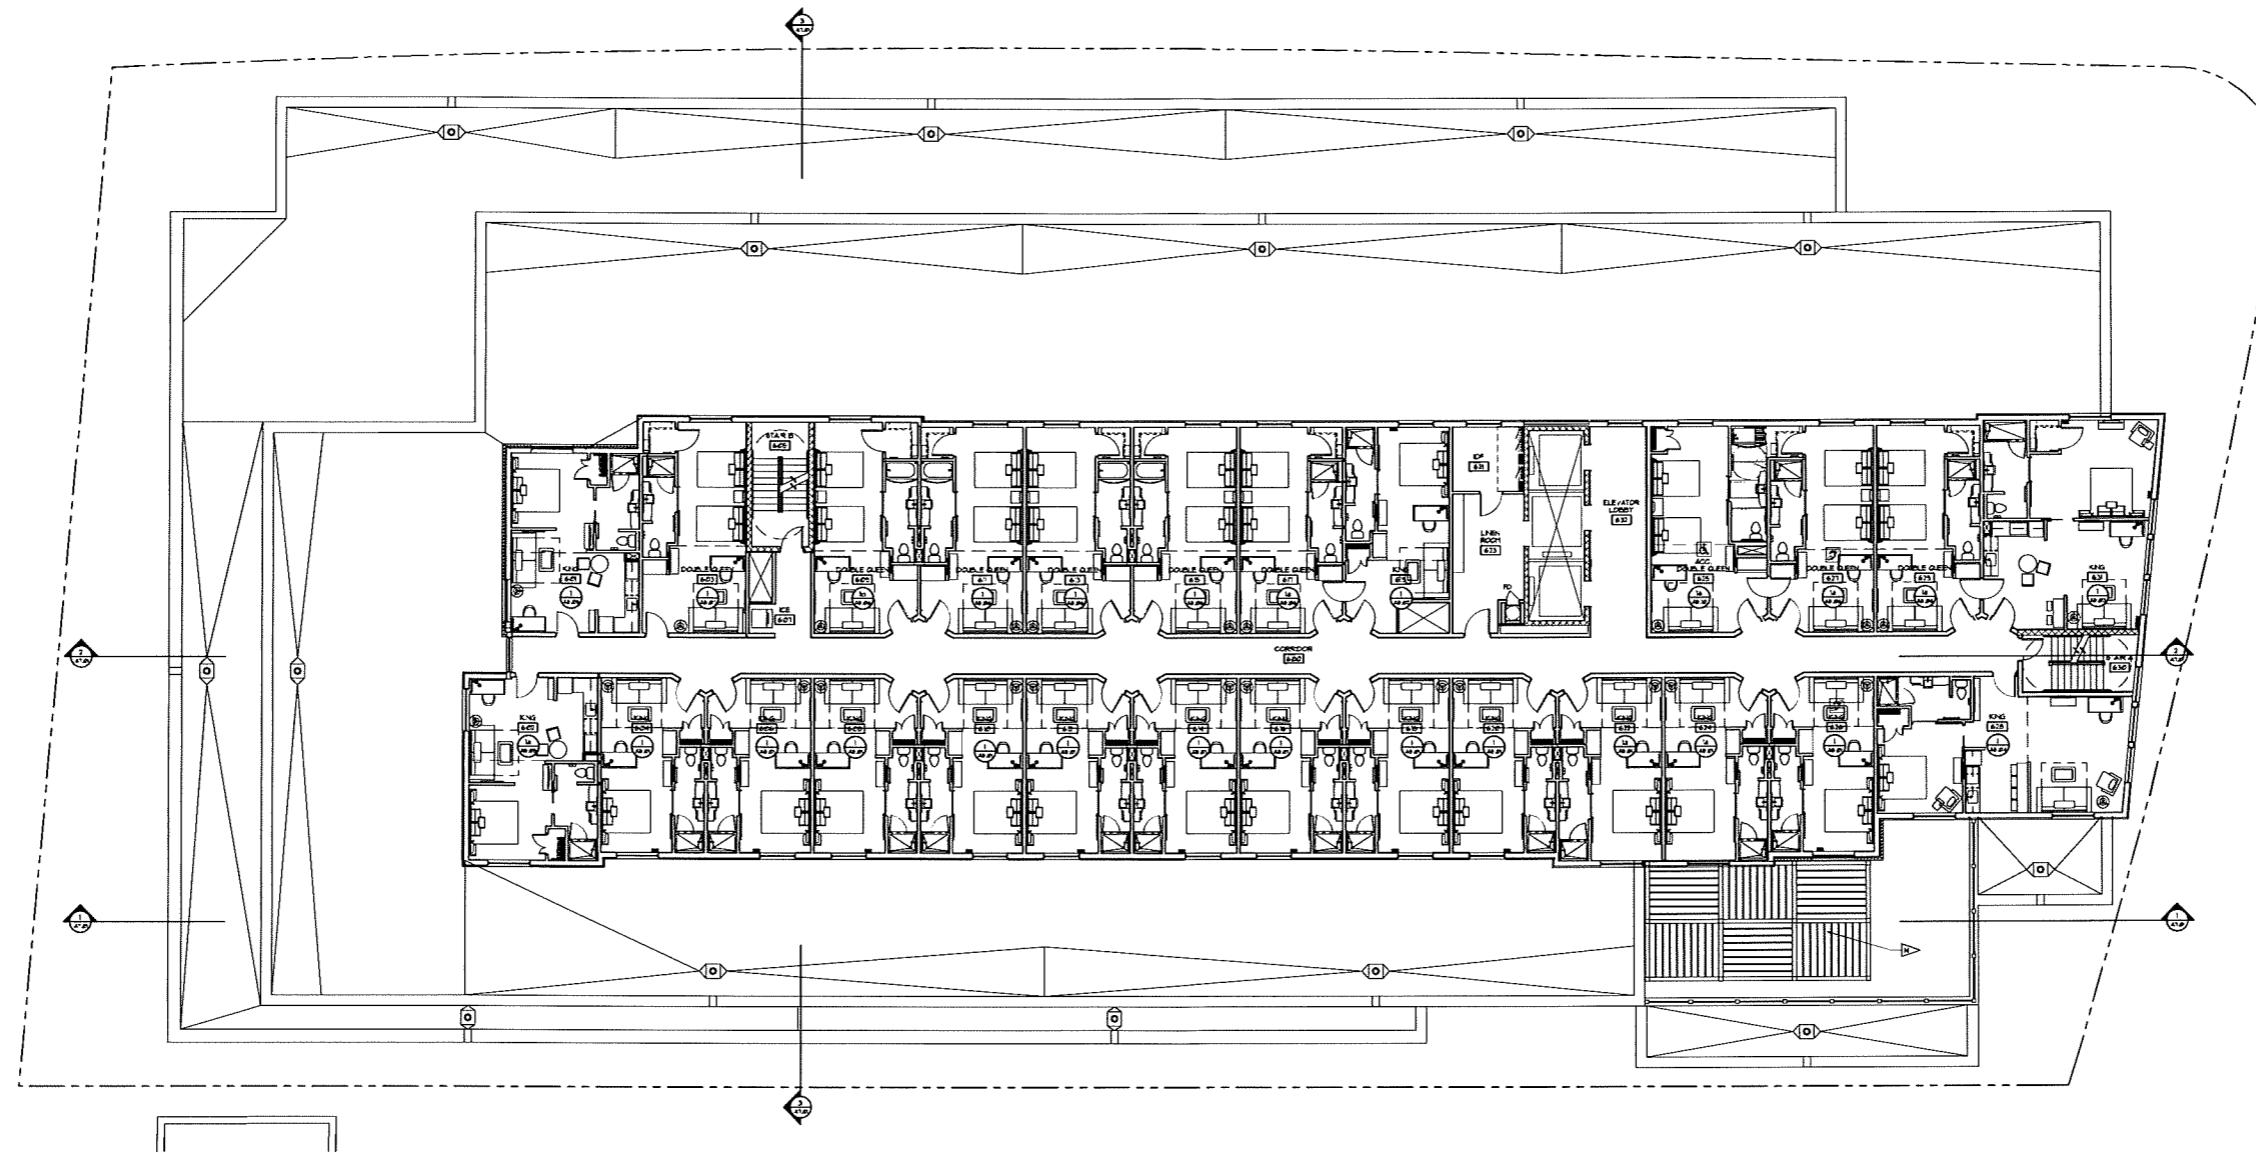

6th FLOOR PLAN

1'-0" 4' 0" 8' 0" 2' 0"

GENERAL PLAN NOTES

1. ALL DIMENSIONS ARE TO FACE OF STUD WALLS NOTED ON DRAWING.
2. EXTERIOR Dimensions ARE TO FACE OF EXTERIOR WallS.
3. INTERIOR Dimensions ARE TO CENTER LINE OF INTERIOR WallS. REGARD TO ACHIEVE LISTED WALL TYPES ADJUST CENTER LINES AS NECESSARY. REFER TO WALL TYPES FOR DETAILS ON CENTER LINES.
4. SEE WPL PLANS FOR DETERMINATION OF SPECIFIC AREA.
5. SEE SHEET A202 FOR WALL TYPE CONSTRUCTION.
6. LOAD BE�NGS ARE TO BE LOCATED OVER ST RETROFITTED STUD WALL. PLACING SUBSTITUTE ST TYPE OR DENSER GLASS SHEETING OVER ST ADDITIONAL STUD WALL IS NOT RECOMMENDED. THESE SHEET PLATES MUST CONTINUE PRIOR TO BUILDING BEAM IN THE DRY.
7. BOX SHEET IS TO ST WALL RATTAGE. RATTAGE ARE NOT BOX SHEET OR THESE SHEETS ARE NOT TO BE LOCATED OVER ST ADDITIONAL STUD WALL.
8. OTHER SHEET PROVIDED ARE CODE RELATED TO RATTAGE INCLUDING CLOTHESLINE SHEET. REFER TO PLANS FOR CODE RELATED TO RATTAGE.
9. UNLESS NOTED ON DRAWING OTHERWISE, ALL DOORS ARE TO BE LOCATED AT FRONT EXTERIOR WALL.

PLAN SYMBOLS


- DECORATIVE CONCRETE PAVING IN AND AROUND POOL.
- ▲ SWIMMING POOL. SEE ALR FOR DETAILS.
- WHIRLPOOL SPA. SEE ALR FOR DETAILS.
- UNFINISHED AREA BELOW FIRST FLOOR.
- POOL ABOVE.
- △ HIGH SPEED HEAD DOOR.
- DOOR ACCESS CONTROL SYSTEM.
- ELEVATED TERRACE IN STONE WATER RETAINING CONCRETE DRIVING.
- △ CANTER BOWL.
- △ WHEEL CHAIR PARKING.
- △ BALCONY BLOCK EPIPHYTE OVER 4' X 8' OF POLY SO.
- △ COACHES SPEED RAMP IN TURN ON AT TOP & BOTTOM.
- △ DECKING PARAPET WALL SIZE VARIES IN LENGTH. ALL ARE GREATER THAN 4' IN WIDTH & 8' DEEP.
- △ PAINTED ALUMINUM TRIM.
- △ LINE OF HOTEL ROOM ABOVE.
- △ APPROXIMATE SUPPORT PLACEMENT IN 6' X 8' EPIPHYTE AREA. THIS LOCATION AND SIZE IS TO BE COORDINATED BY OWNER AND ARCHITECT.

PROJECT: FREY STREET - MIXED USE DEVELOPMENT
605 FREY STREET
MIDDLETON, WI 53562
CLIENT: STREET LODGING ASSOCIATES, LLC
CORE & MONDO MANAGEMENT COMPANY
MIDDLETON, WI 53562

01/07/2017 4:17:00 PM
DRAFTING DATE: 01/07/2017
DRAWN BY: JBLM
DATE: 11-06-2016
SCALE: AS NOTED
LOC 1: 11-06-2016
LAND USE: 01-08-2016
CITY SUBDIVISION: 01-08-2016

6TH FLOOR PLAN

A2.06

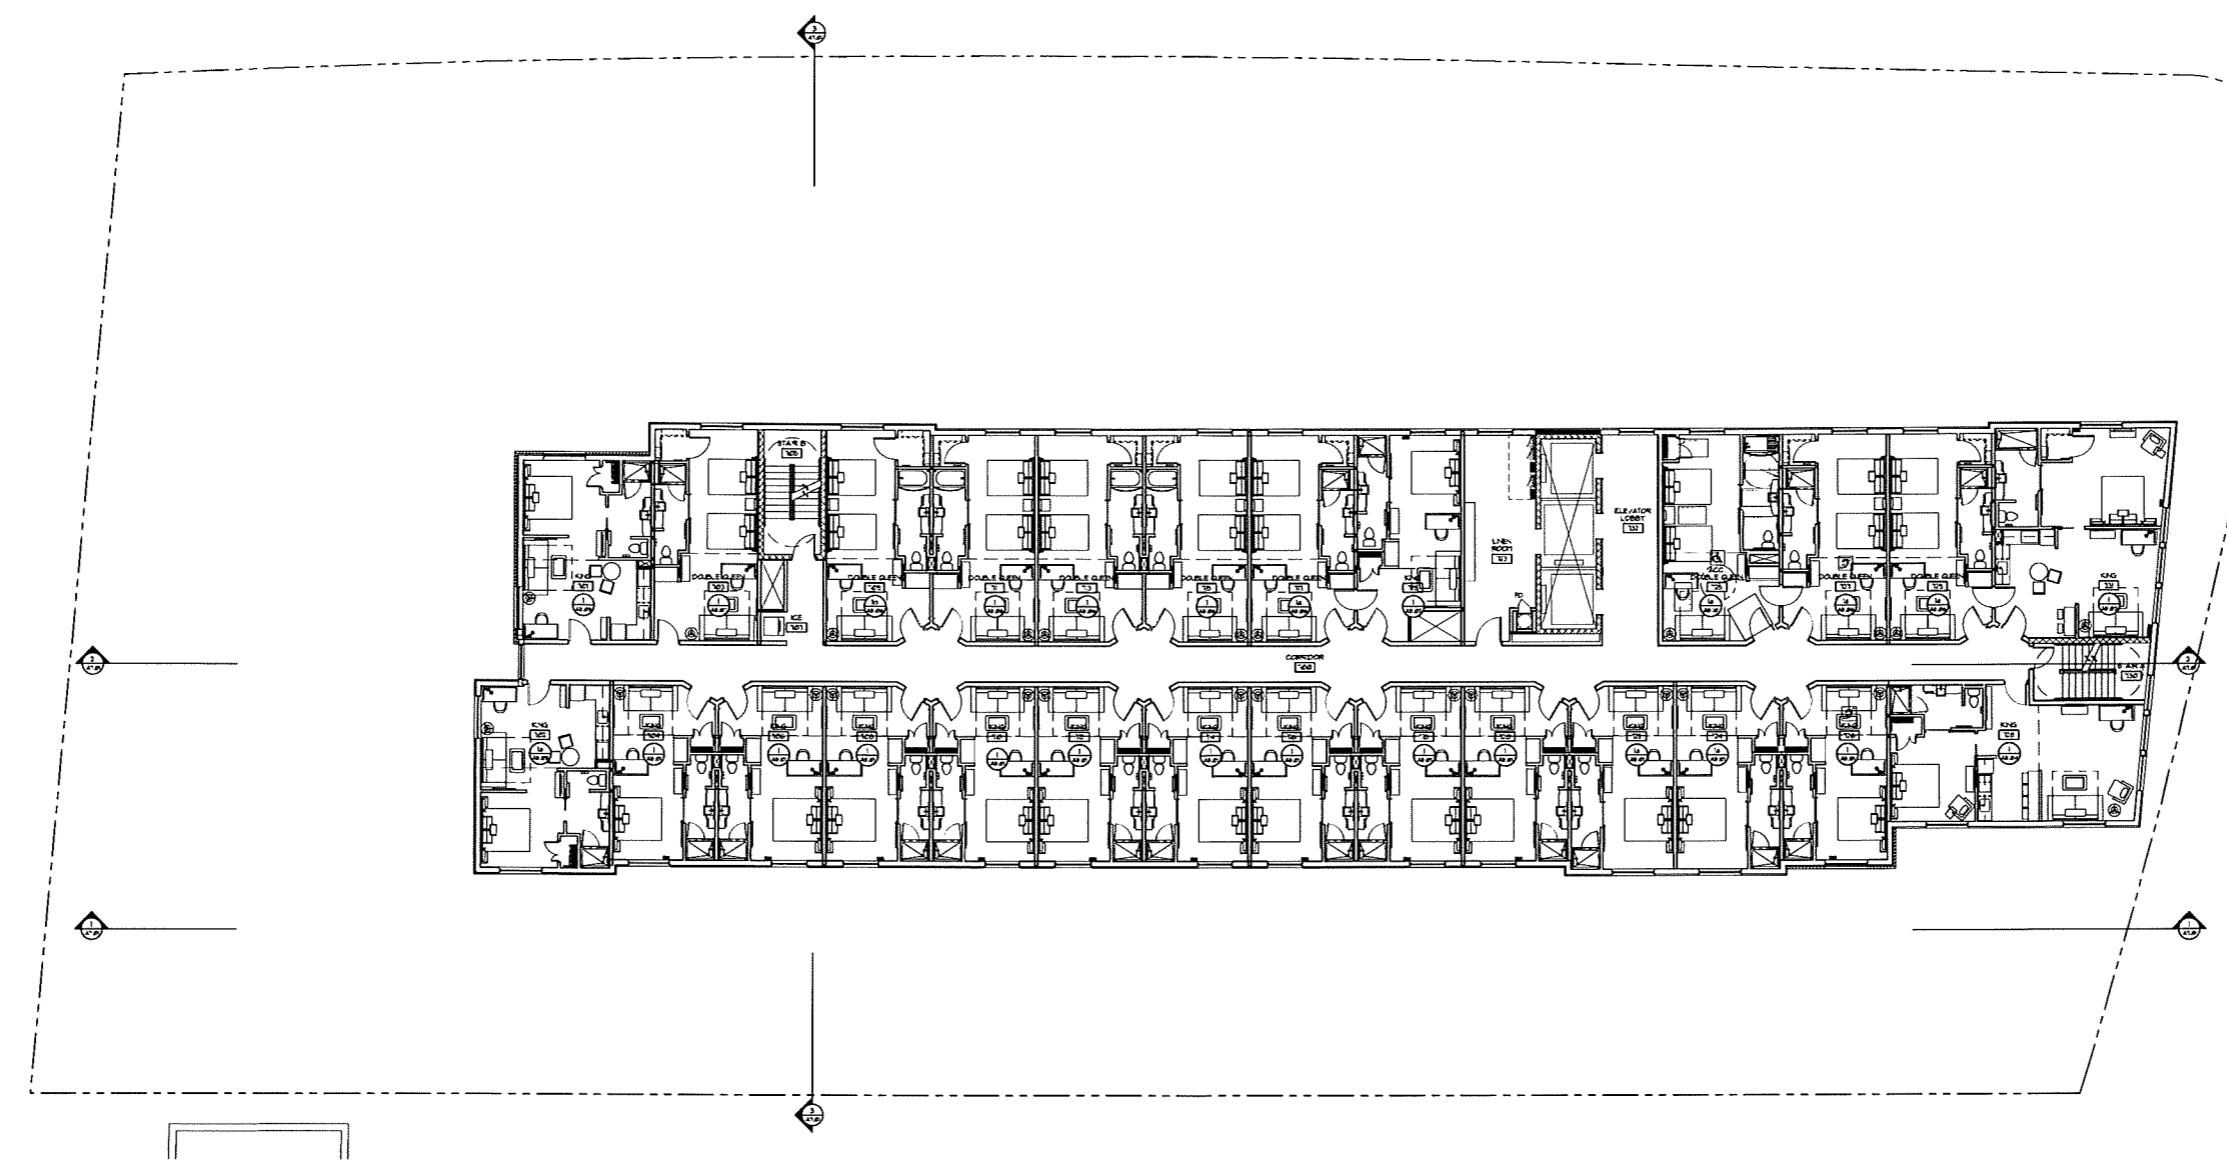

7TH FLOOR PLAN

13' 0" X 12' 0"

GENERAL PLAN NOTES

- 1. ALL DOORS ARE TO FACE OUT UNLESS NOTED OTHERWISE.
- 2. EXTERIOR OPENINGS ARE TO FACE OUT EXCEPT WHERE PAVING IS LOCATED ON THE EXTERIOR WALL. USE EXTERIOR OPENINGS TO ACHIEVE LISTED WALL THICKNESS ADJUSTMENT OF 3/4 IN. ADDITIONAL OPENING SIZE SHOULD BE 1/2 IN. LESS THAN THE LISTED OPENING SIZE.
- 3. SEE W-PLANS FOR DIMMING OF EXTERIOR AREA.
- 4. SEE W-PLANS FOR DIMMING OF EXTERIOR AREA.
- 5. SEE W-PLANS FOR GUTTER CONSTRUCTION.
- 6. LIDDED ROOF FRAMING. SUBSTITUTE LID TYPE OF SHEATHING. THIS SHOULD BE APPLIED OVER AN ADDITIONAL STOKE WALL.
- 7. REF SHEET E3 FOR WALL PATH. RATIONS ARE NOT SHOWN ON THESE SHEETS, REFER TO E3.
- 8. OTHER WALL PROVIDE ALL CODE REQUIRED SHEathing INCLUDING OVERHANGS AND EAVES.
- 9. UNLESS NOTED ON S-COA, OTHERWISE, ALL DOORS ARE TO BE LOCATED AT LEAST 48 IN. FROM ADJACENT WALL.

DRAWN BY: DATE: SCALE:

JD 11-26-16 AS NOTED

LOC #: LAND USE: CITY OF PORTLAND ZONING:

CODE NUMBER: PROJECT NUMBER: DRAWN FOR:

DATE: 03-03-16 BY: ARCHITECT:

LOC#: LAND USE: CITY OF PORTLAND ZONING:

CODE NUMBER: PROJECT NUMBER: DRAWN FOR:

DATE: 03-03-16 BY: ARCHITECT:

LOC#: LAND USE: CITY OF PORTLAND ZONING:

CODE NUMBER: PROJECT NUMBER: DRAWN FOR:

KEY NOTES


- DECORATIVE CONCRETE PAVING W/ RADIAL HEAT.
- SURFACE PARKING DOCK. SEE ALB FOR DETAILS.
- UNFINISHED AREA BELOW FIRST FLOOR.
- POOL ABOVE.
- DOOR ACCESS CONTROL SYSTEM.
- GROUND FLOOR TERRACE IN STORM WATER RETENT OR PER CIVIL DRAWING.
- CANDY STORE.
- WHEEL CHAIR ACCESSIBLE.
- BALANCED BLACK OPEN OVER 4 FT OF POLY ISO.
- DOOR FRAME HEIGHT. SEE ALB FOR TOP & BOTTOM.
- DOORS OPEN INWARDS. SIZE FOR 36 IN. WIDTH. ALL ARE GREATER THAN 8'-0" IN WIDTH.
- PLANTED ALUMINUM BOLLARD.
- MECHANICAL UNIT W/ ALUMINUM SCREEN.
- CIRCLE OF NOTE. TURN TO DRAWING.
- INFORMATION TABLE. CORPUS PLACEMENT W/ INFORMATION INDEX & W-10. CO. TBL LOCATION AND SIZE IS TO BE COORDINATED W/ OWNER AND ARCHITECT.

PROJECT: FREY STREET - MIXED USE DEVELOPMENT
 ADDRESS: 4040 FREY STREET
 CITY: PORTLAND
 STATE: OREGON
 ZIP: 97204
 LATITUDE: 45.518303
 LONGITUDE: -122.708530
 ALTITUDE: 530 FT
 Elevation: 530

PROJEC NUMBER: 2013-033
 DRAWN BY: BLM
 DATE: 11-26-2016
 SCALE: AS NOTED

LOC #: 11-26-061
 LAND USE: CITY OF PORTLAND
 CITY OF PORTLAND ZONING:

7TH FLOOR PLAN
 A2.07

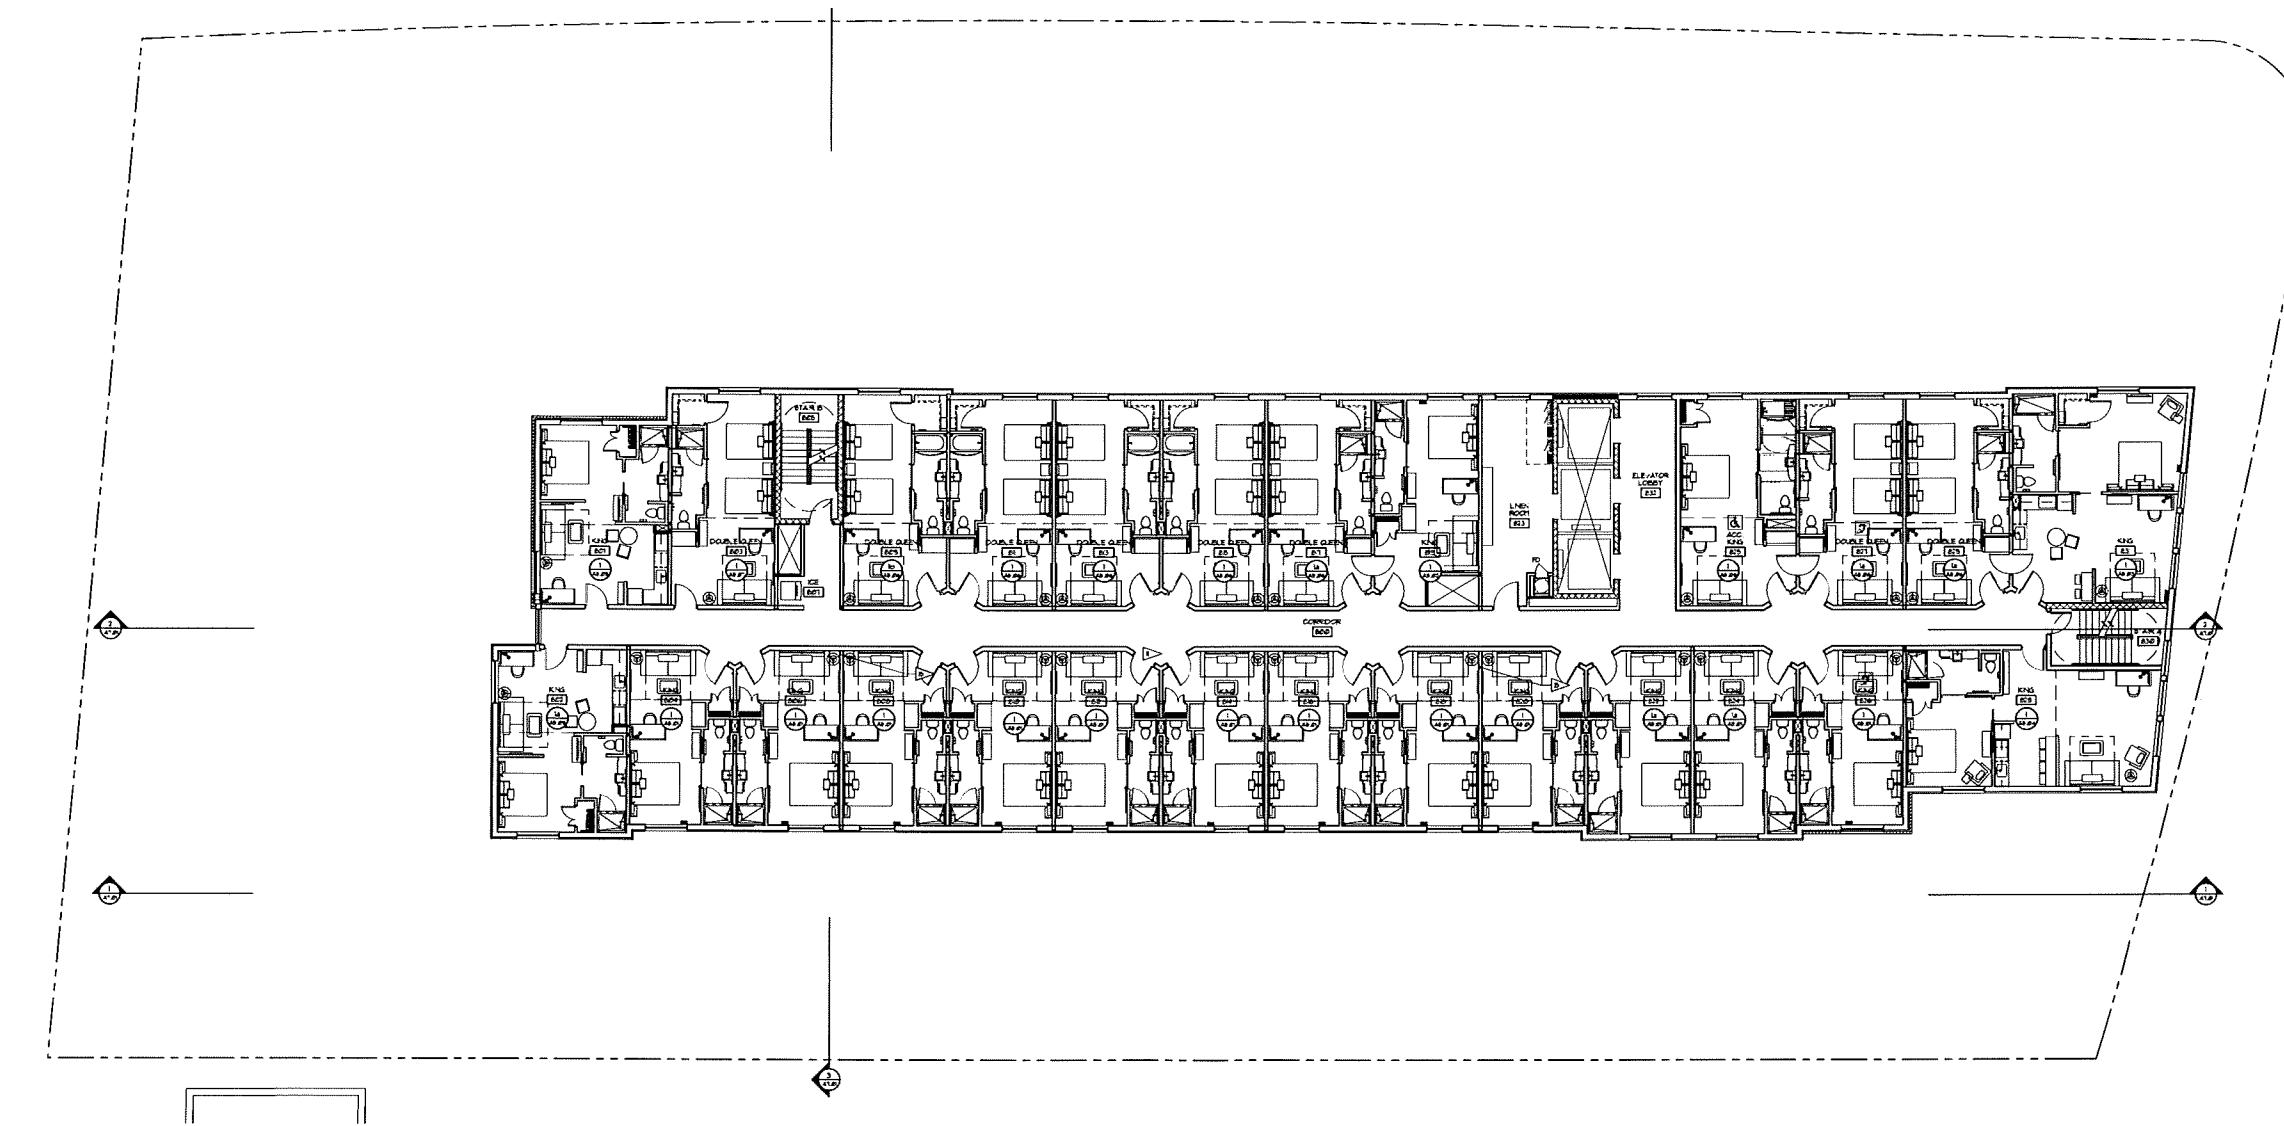

8TH FLOOR PLAN

13'-0" x 7'-0"


24'

| GENERAL PLAN NOTES | |
|--------------------|---|
| 1. | ALL OPENINGS ARE TO FACE OF STUD WALLS NOTED ON DRAWING. |
| 2. | EXTERIOR DOORS ARE TO FACE OUT AS NOTED ON DRAWING. |
| 3. | DOORS AND DOOR SWINGS DO NOT INTERFERE WITH VARIOUS TYPES OF EQUIPMENT. DOORS MUST SWING CLEAR OF ALL EQUIPMENT. |
| 4. | SEE 1/4 PLANS FOR DETERMINATION OF SPECIFIC AREAS. |
| 5. | DOORS ARE TO SWING CLEAR OF ALL EXISTING EQUIPMENT. |
| 6. | WALLS ARE TO SWING CLEAR OF ALL EXISTING EQUIPMENT. |
| 7. | ALL EXISTING WALLS ARE TO BE COVERED OVER BY ADDITIONAL INSULATION AND PAINTED. INSULATION IS TO BE APPLIED IN FIRE-RATED WALL AREAS AS ALL ARE COLOCATED OVER CONCRETE Poured IN PLACE BUILDING BEING IN THE CITY. |
| 8. | ALL EXISTING WALL NUMBER, LETTERS AND NO'S SHOWN ON THESE PLANS ARE CLARIFIED. |
| 9. | OPEN BAYS ARE TO SWING CLEAR OF ALL EXISTING EQUIPMENT. DOORS ARE TO SWING IN ALL REGULAR CASEMENT DOORS. |
| 10. | UNLESS NOTED ON DRAWING OTHERWISE ALL DOORS ARE TO BE LOCATED 6' FROM ADJACENT WALL. |

PROJECT: 201335
 FREY STREET - MIXED USE DEVELOPMENT
 401 FREY STREET, MIDDLETON, WI 53562
 608-829-3356 (FAX)
 GUY STREET LODGING ASSOCIATES, LLC
 COLDIRON MANAGEMENT COMPANY
 MIDDLETON, WI 53562

8TH
FLOOR PLAN
A2.08

| KEY NOTES | |
|-----------|---|
| 1. | DECORATIVE CONCRETE PAVERS W/ RADICANT HEAT. |
| 2. | BIKE PARKING DOCK. SEE AIR FOR DETAILS. |
| 3. | HANDICAP RAMP. SEE AIR FOR DETAILS. |
| 4. | JACKHOLE AREA BELOW FIRST FLOOR. |
| 5. | POOL ABOVE. |
| 6. | HIGH SPEED HEAD DOOR. |
| 7. | DOOR ACCESS CONTROL SYSTEM. |
| 8. | ELEVATED TERRACE W/ STORM WATER RETENTION PER CIVIL DRAWINGS. |
| 9. | CANOPY BELOW. |
| 10. | WHEEL CHAIR PER AIR. |
| 11. | INSULATED BLACK EPDM OVER 4' THK OF POLY ISO. |
| 12. | CONCRETE SLAB SUPPORTS IN TURNSTILE AT TOP & BOTTOM. |
| 13. | DOOR SWINGS CLEAR OF EXISTING EQUIPMENT. ALL ARE GREATER THAN 6' x 6' x 8' IN SIZE. |
| 14. | PAINTED ALUMINUM TRIM. |
| 15. | TECHNICAL UNIT W/ ALUMINUM SCREEN. |
| 16. | OUTLINE OF HOTEL TOUR ABOVE. |
| 17. | AWNING TALL CORPUS PLACED OVER 10' PARKING FREE + 10' AND ARCHITECT. |

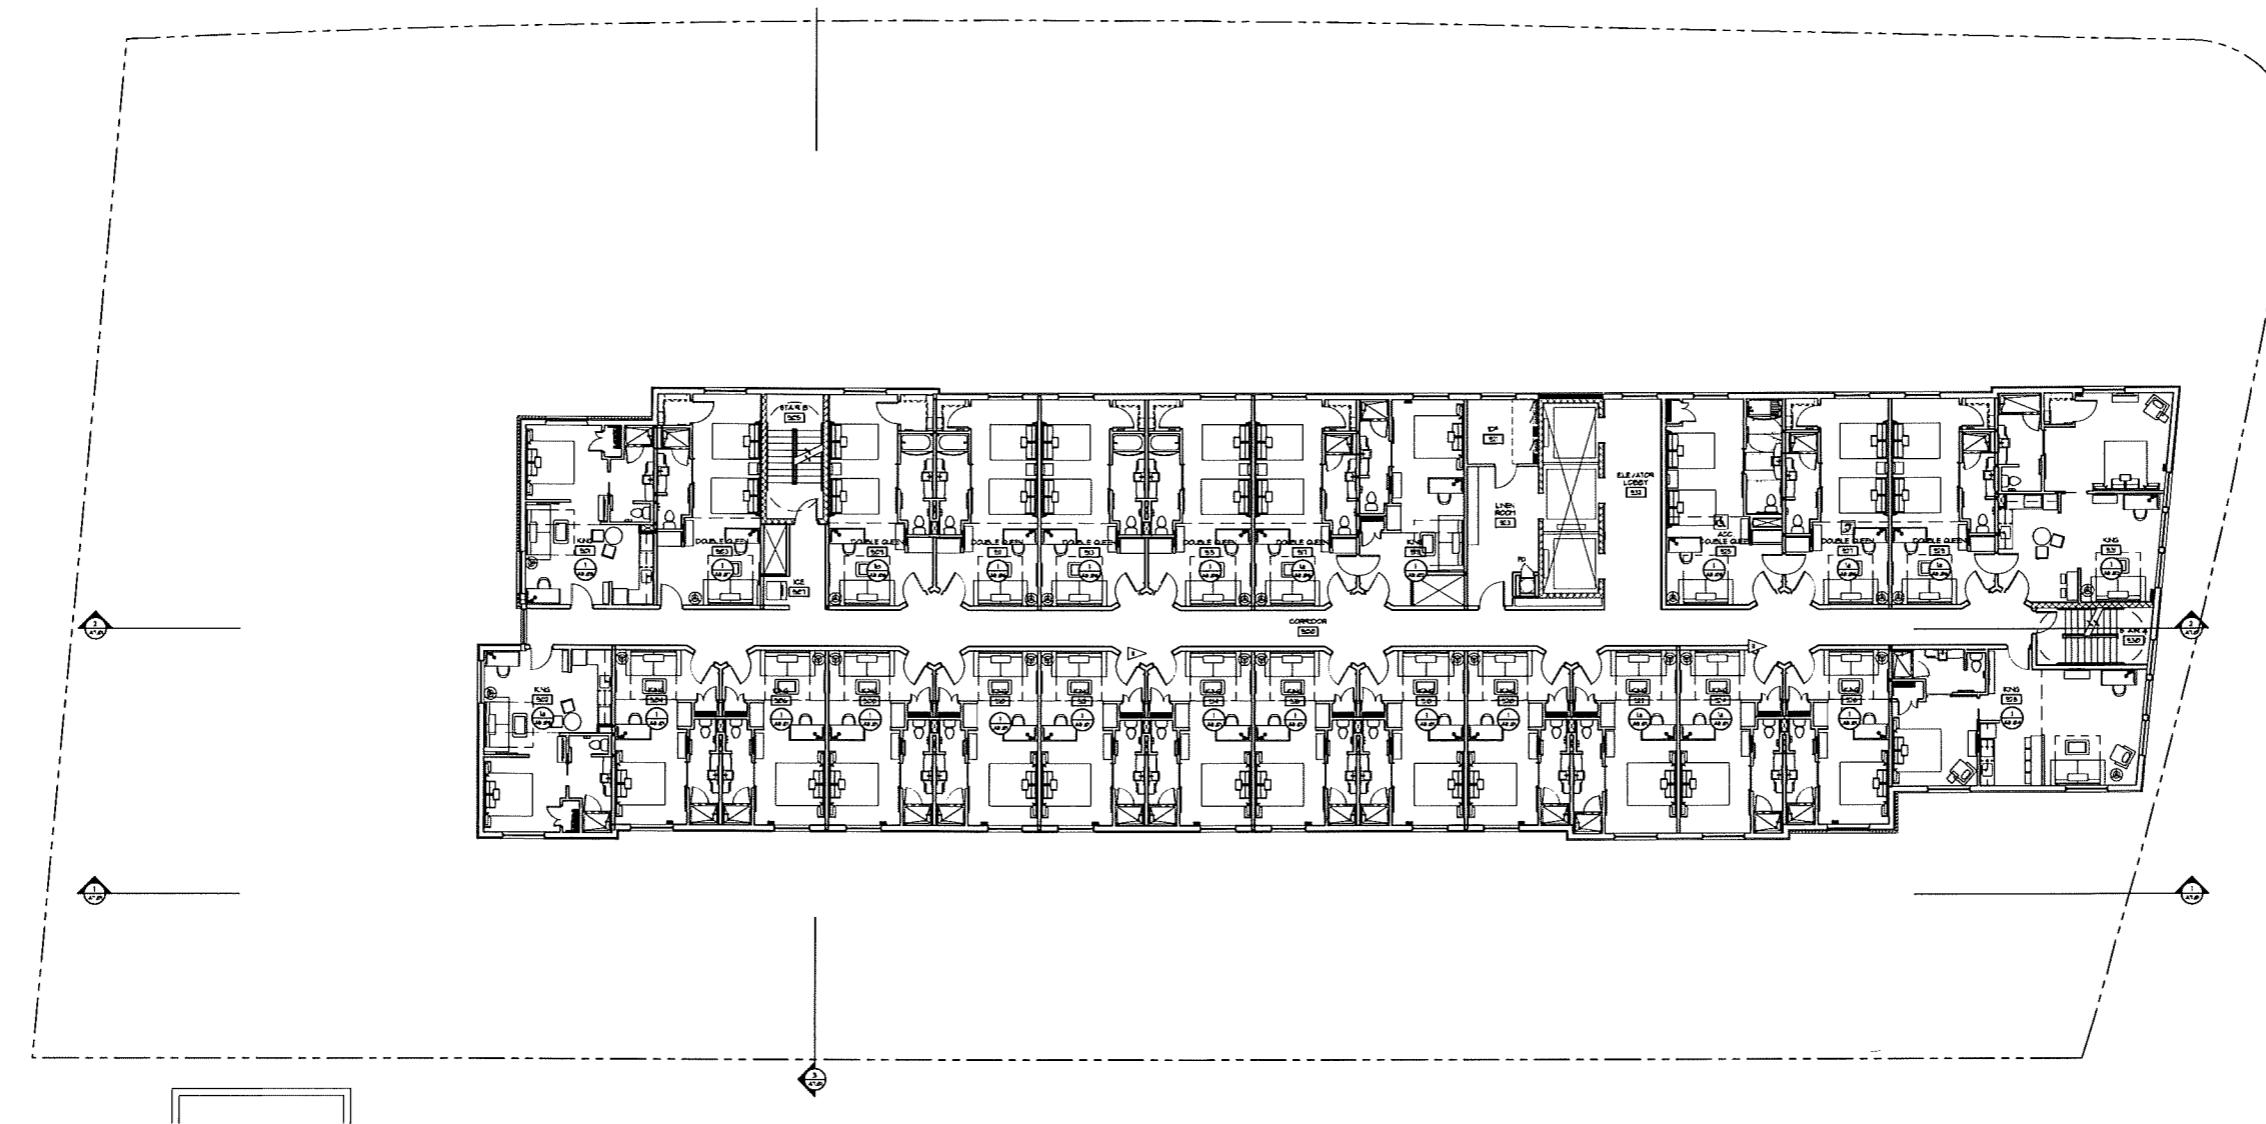

9TH FLOOR PLAN


12'-11" 12'-11" 24'

| KEY NOTES | |
|---|--|
| ► DECORATIVE CONCRETE PAVING IN FRONT OF MEAT. | |
| ► BIKE PARKING DOOR, SEE AIR FOR DETAILS. | |
| ► HANGAR DOOR, SEE AIR FOR DETAILS. | |
| ► INDICATED AREA BELOW FIRST FLOOR. | |
| ► PER ABOVE. | |
| ► HIGH SPEED HEAD DOOR. | |
| ► DOOR ACCESS CONTROL SYSTEM. | |
| ► ELEVATED TERRACE IN FRONT WATER RECEPTOR PER CIVIL DRAWINGS. | |
| ► CANOPY BELOW. | |
| ► INLET STOP PER AIR. | |
| ► BALLOONED BLACK SPOT OVER 4' PIN OF POLY 80. | |
| ► CONCRETE SLAB OVER 4' PIN OF POLY 80. | |
| ► CONCRETE SLAB OVER 4' PIN OF POLY 80. | |
| ► CONCRETE SLAB OVER 4' PIN OF POLY 80. | |
| ► PAINTED ALUMINUM TRIM. | |
| ► TECHNICAL HATCHES, SEE AIR FOR DETAILS. | |
| ► ONE LINE CHARTS, SEE AIR. | |
| ► MINIMUM TALL COMPOUND PLANTERS TO BE ENCLUSED INSTEAD OF 4'-0" DECK RAIL. | |

| GENERAL PLAN NOTES | |
|---|--|
| 1. ALL DIMENSIONS ARE TO FACE OF STUD UNLESS NOTED OTHERWISE. | |
| 2. ALL EXTERIOR OPENINGS ARE TO BE LOCATED AS SHOWN ON THESE PLANS. | |
| 3. EXTERIOR OPENINGS DO NOT TAKE INTO ACCOUNT THE VARYING LAYER(S) OF EXTERIOR INSULATION BOARD. TO ACHIEVE LISTED SIZES, ADJUSTMENT IS REQUIRED AS SHOWN ON THESE PLANS. | |
| 4. SEE 1/4 PLANS FOR DIMENSIONS OF SPECIFIC AREAS. | |
| 5. SEE 1/4 PLANS FOR DIMENSIONS OF SPECIFIC AREAS. | |
| 6. HIGH RATED WALL AREA/TILES WILL BE COVERED OVER BY ADDITIONAL STYLING. THIS MAY REQUIRE ADDITIONAL STYLING TO BE ADDED TO THE EXISTING PLANS. PLEASE CONSULT WITH THE CONTRACTOR FOR ADDITIONAL INFORMATION. | |
| 7. ALL EXTERIOR OPENINGS ARE TO BE LOCATED AS SHOWN ON THESE PLANS FOR CLARITY. | |
| 8. CONTRACTOR IS RESPONSIBLE FOR ALL CODE REQUIRED ROOM ENHANCEMENTS INCLUDING DOOR SWING SIZE IN ALL REQUIRED AMENITY ROOMS. | |
| 9. VULNER NOTES OR HOOKS OTHERWISE ALL DOORS ARE TO BE LOCATED AT FROM ADJACENT WALL. | |

PROJECT: FREY STREET - MIXED USE DEVELOPMENT
SUB: 401 FREY STREET
CITY: MADISON, WISCONSIN 53705
CLIENT: CIO RAYMOND MANAGEMENT COMPANY
ARCHITECT: GBA ARCHITECTURE INC.
DRAWN BY: BLM
DATE: 11-30-2016
SCALE: AS NOTED
LOC 1
LAND USE: 0-0-201
CITY ZONING: 0-0-201

9TH FLOOR PLAN
A2.09

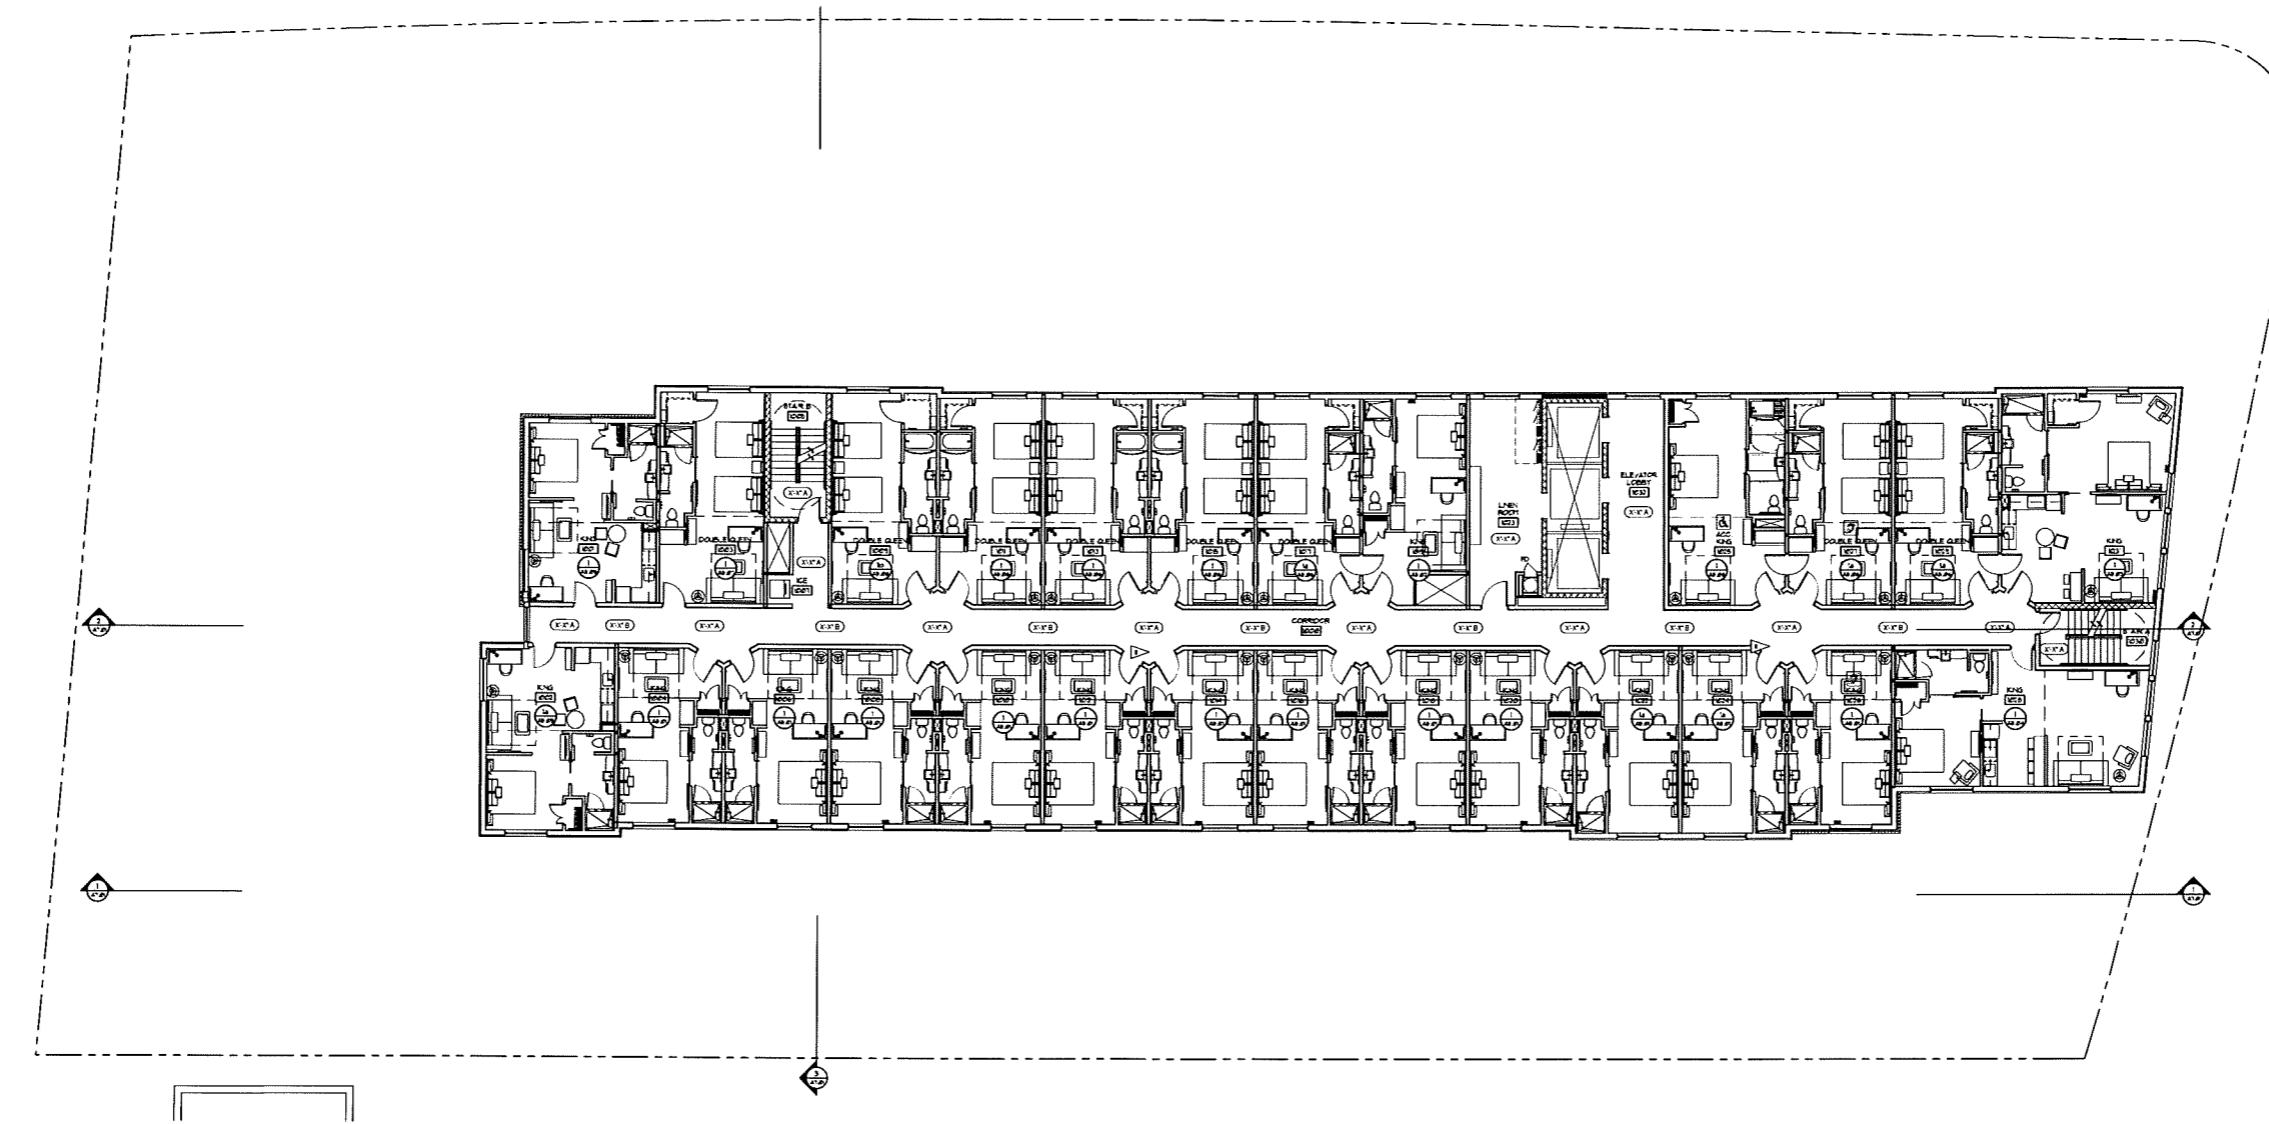

10TH FLOOR PLAN


18'-0" x 7'-0"

| KEY NOTES | |
|---|--|
| ► DECORATIVE CONCRETE PAVING W/ RADIAL HEAT. | |
| ► BASE PARKING DOOR, REAR AND PORCH STALLS. | |
| ► HANDICAP BLDG. SEE AVAIL FOR DETAILS. | |
| ► MECHANICAL AREA BELOW FIRST FLOOR. | |
| ► POOL ABOVE. | |
| ► HIGH SPEED HEAD DOOR. | |
| ► DOOR ACCESS CONTROL SYSTEM. | |
| ► ELEVATED TERRACE W/ STORY WATER RETENTION PER CIVIL DRAWINGS. | |
| ► CANOPY BEAM. | |
| ► ACED. ENTR. PER AV. | |
| ► BALCONY BLACK STONE OVER 4" THK OF POLY ISO. | |
| ► CONCRETE SLAB OVER 4" THK OF POLY ISO. | |
| ► CONCRETE PARKING STALLS SEE VARIOUS IN LOC 14. ALL ARE GREATER THAN 8' X 18' BOTH IN AND OUT. | |
| ► PAINTED ALUMINUM TRIM. | |
| ► MECHANICAL INT'L. ALUMINUM SCREEN. | |
| ► DOUBLE DOOR ENTRANCE. | |
| ► MAXIMUM TALL CONCRETE PLANTERS TO BE ERECTED NEAR A #100' DEPT. LOCATION AND TREE SIZE. #10 TO BE COORDINATED BY OWNER AND ARCHITECT. | |

| GENERAL PLAN NOTES | |
|--|--|
| 1. ALL DIMENSIONS ARE TO FACE-OF-STUD WALLS NOTED OTHERWISE. | |
| 2. EXTERIOR CIRCULAR STAIRS ARE TO BE LOCATED ON THE EAST SIDE OF THE BUILDING. | |
| 3. EXTERIOR STAIRS DO NOT TAKE INTO ACCOUNT THE VARIOUS LEVELS OF GROUND SURFACE. DO NOT ACHIEVE LISTED CALL HEIGHTS AGAINST GROUND SURFACE AS THIS WILL NOT ACCOMPLISH THE STAIR REQUIREMENT. | |
| 4. SEE 1/4" PLANS FOR DIMENSIONS OF MEETING AREA. | |
| 5. DOORS ARE TO SWING OUT. DOORS ARE TO SWING IN WHEN RATED-40' ALL ANGLES ARE TO SWING OVER 81" ADDITIONAL SWING CLEARANCE. DOORS ARE TO SWING IN WHEN RATED-40' ALL ANGLES ARE TO SWING OVER 81" ADDITIONAL SWING CLEARANCE. DOORS ARE TO SWING IN WHEN RATED-40' ALL ANGLES ARE TO SWING OVER 81" ADDITIONAL SWING CLEARANCE. DOORS ARE TO SWING IN WHEN RATED-40' ALL ANGLES ARE TO SWING OVER 81" ADDITIONAL SWING CLEARANCE. | |
| 6. DOORS ARE TO SWING OUT. DOORS ARE TO SWING IN WHEN RATED-40' ALL ANGLES ARE TO SWING OVER 81" ADDITIONAL SWING CLEARANCE. DOORS ARE TO SWING IN WHEN RATED-40' ALL ANGLES ARE TO SWING OVER 81" ADDITIONAL SWING CLEARANCE. DOORS ARE TO SWING IN WHEN RATED-40' ALL ANGLES ARE TO SWING OVER 81" ADDITIONAL SWING CLEARANCE. | |
| 7. DOORS ARE TO SWING OUT. DOORS ARE TO SWING IN WHEN RATED-40' ALL ANGLES ARE TO SWING OVER 81" ADDITIONAL SWING CLEARANCE. | |
| 8. DOORS SHALL SWING IN. ALL DOORS ARE TO SWING IN WHEN RATED-40' ALL ANGLES ARE TO SWING OVER 81" ADDITIONAL SWING CLEARANCE. | |
| 9. UNLESS NOTED OR SHOWN OTHERWISE ALL DOORS ARE TO BE LOCATED AT PRET ADJACENT WALL. | |

PROJECT: FREY STREET - MIXED USE DEVELOPMENT
 ADDRESS: 408 FREY STREET, MADISON, WISCONSIN 53705
 CLIENT: CIO RAYMOND MANAGEMENT COMPANY
 DRAWN BY: BLM
 DATE: 11-20-2016
 SCALE: AS NOTED
 LOC 1
 LAND USE: E-0-201
 CITY BOUNDARY: E-0-201

10TH FLOOR PLAN
 A2.10

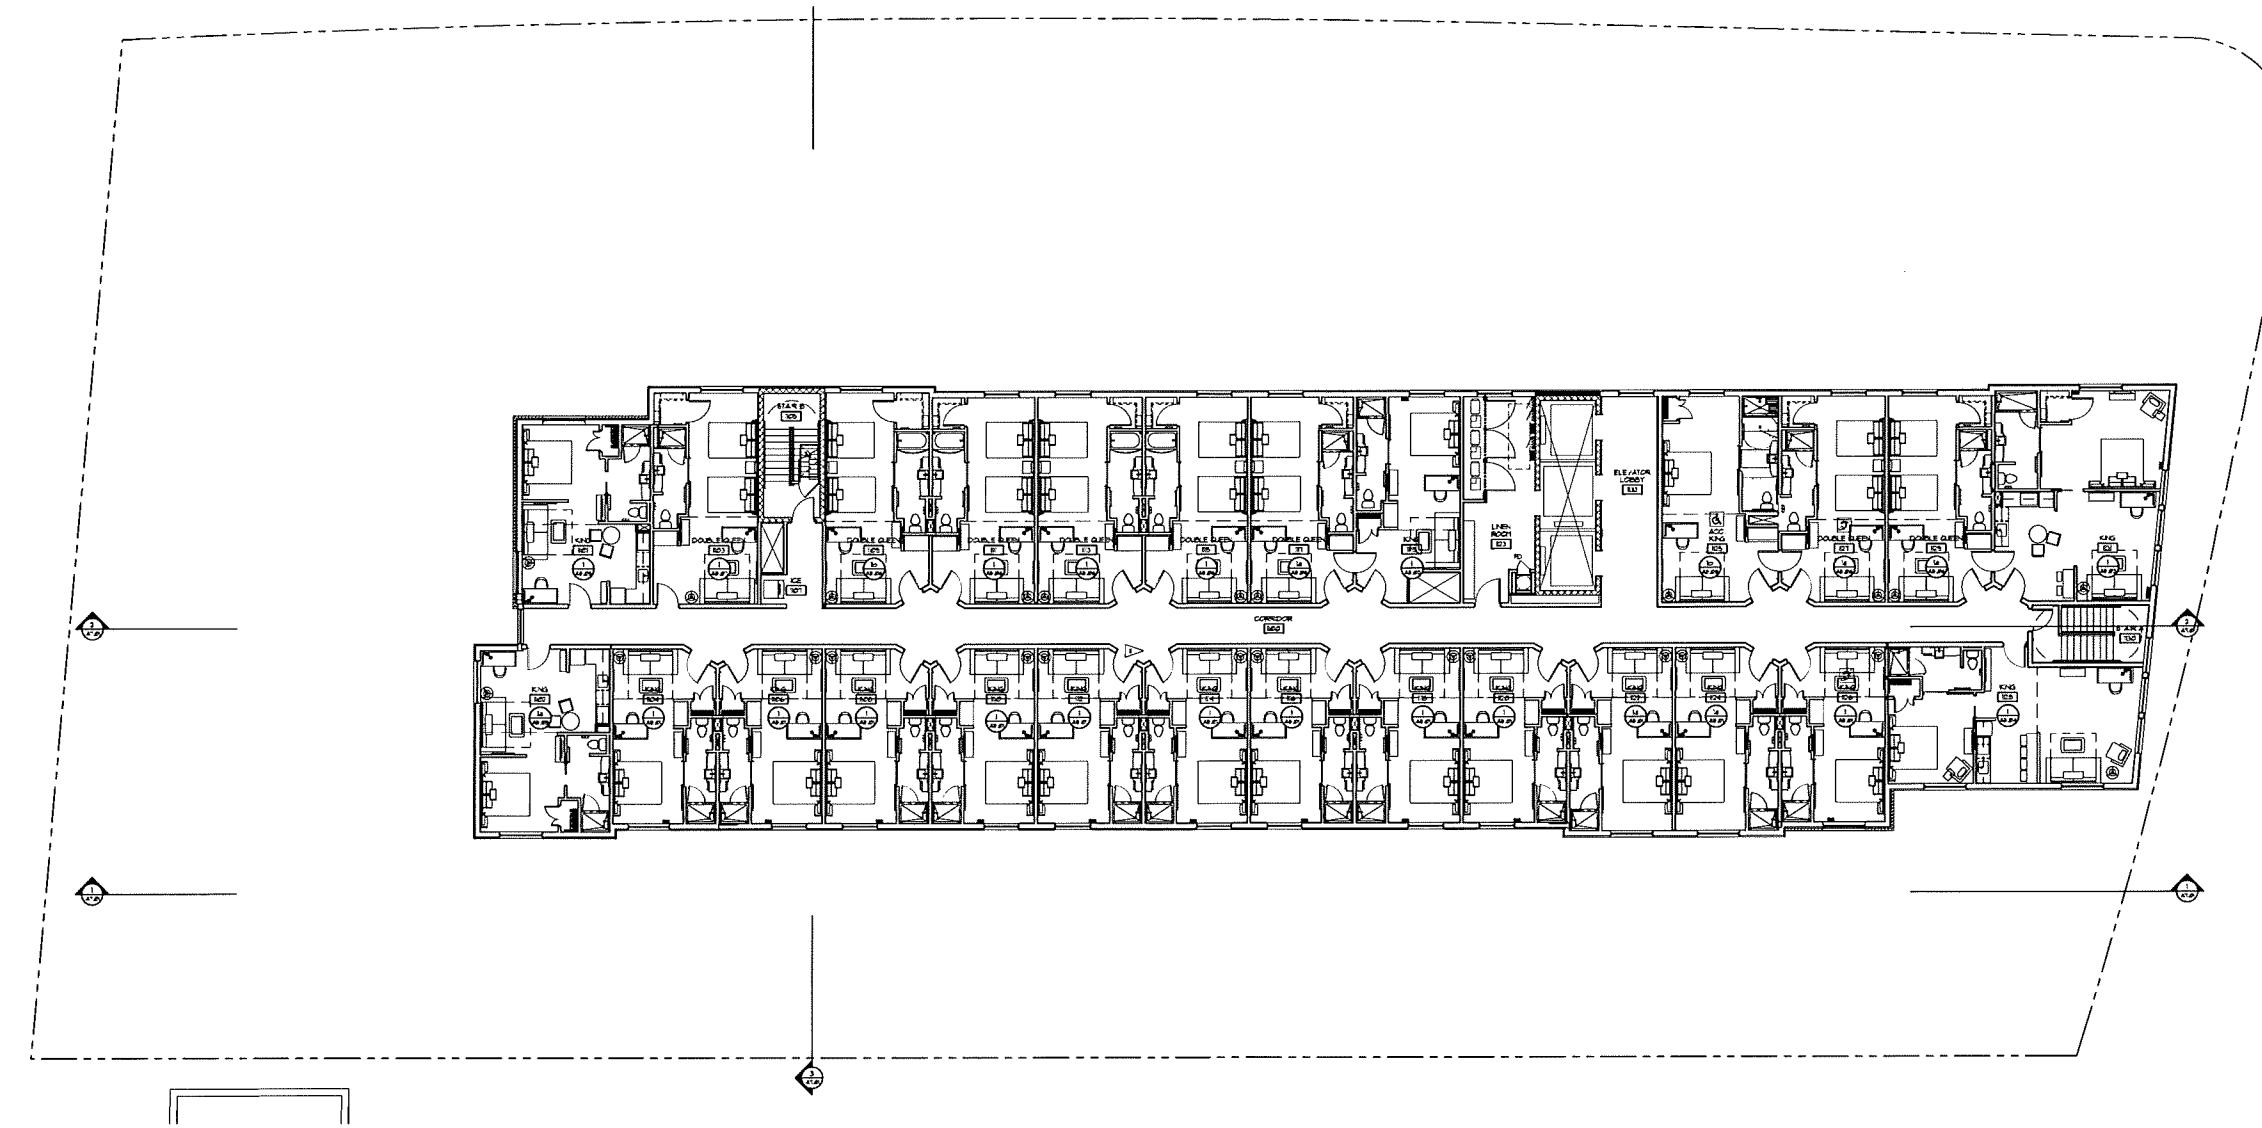

11TH FLOOR PLAN


24'

| KEY NOTES | |
|---|-----------------------|
| ▼ DECORATIVE CONCRETE PAVING IN RADIAN HERRINGBONE PATTERN. | SEE PLAN FOR DETAILS. |
| ▼ HANDICAP BATH. SEE AVAIL FOR DETAILS. | |
| ▼ AMENITY AREA BELOW ROOF FLOOR. | |
| ▼ POOL ABOVE. | |
| ▼ HIGH SPEED HEAD DOOR. | |
| ▼ DOOR ACCESS CONTROL SYSTEM. | |
| ▼ ELEVATED TERRACE BY STORM WATER RETENTION PER CIVIL DRAWINGS. | |
| ▼ CANOPY BEAM. | |
| ▼ BASE STOP PER ALR. | |
| ▼ BALCONY BLACK EXTERIOR 4'11" OF POLY 60. | |
| ▼ CONCRETE SPEED RAMP OR TRANSITION AT TOP 4 BAYS. | |
| ▼ CONTRACT PURCHASE WALL SIZE VARIES IN WIDTH. ALL ARE GREATER THAN 8'-0" IN WIDTH EXCEPT 2'. | |
| ▼ PAINTED ALUMINUM REAR. | |
| ▼ TECHNICAL WALL ALUMINUM REAR. | |
| ▼ SOLAR PANELS ON ROOF AREA. | |
| ▼ CONTRACTOR TALL CONCRETE PLANTERS W/ GARDENING BED & PLANTER BOXES. FINAL LOCATION AND SIZE IS TO BE DETERMINED BY ARCHITECT. | |

| GENERAL PLAN NOTES | |
|---|--|
| 1. ALL OPENINGS ARE TO FACE OF 8'10" UNLESS NOTED OTHERWISE. | |
| 2. EXTERIOR OPENINGS ARE TO FACE OF 8'-0" UNLESS NOTED OTHERWISE. | |
| 3. EXTERIOR OPENINGS ARE TO FACE OF 8'-0" UNLESS NOTED OTHERWISE. THE CENTER LINE OF EXTERIOR WALL BOARD, TO ACCOMPLISH LISTED WALL TYPES ADJUST OFFSET AS NEEDED. | |
| 4. SEE VV PLANS FOR DIMENSIONS OF SPECIFIC AREAS. | |
| 5. SEE VV PLANS FOR WALL TYPE CONSTRUCTION. | |
| 6. SEE SHEET 12 FOR WALL TYPE CONSTRUCTION. | |
| 7. STUD WALL, RAFTERS, SUBSTUDS & FIFTEEN X ONE-FOOT DECKING ARE REQUIRED OVER 8'11" ADDITIONAL LENGTH. RAFTERS SUBSTITUTED BY FIFTEEN X ONE-FOOT DECKING ARE REQUIRED OVER 8'11" ADDITIONAL LENGTH. THESE WALL TYPES ARE TO BE LOCATED 4'-0" CONTINUE PRIOR TO BUILDING BEING 8'-0" IN-DEPT. | |
| 8. ALL EXTERIOR OPENINGS ARE TO FACE OF 8'-0" UNLESS NOTED OTHERWISE. RAFTERS RATHER THAN STUDS ARE NOT TO BE ON THESE PLACES FOR CLARITY. | |
| 9. OTHER B-WALL PROVISIONS ARE CODE REQUIRED BY CONTRACTOR. CONTRACTOR IS RESPONSIBLE FOR PROVIDING DRAWINGS INCLUDING CONTRACTOR'S B-WALL PROVISIONS IN PLANS. | |
| 10. UNLESS NOTED OR SHOWN OTHERWISE ALL DOORS ARE TO BE LOCATED 4'-0" FROM ADJACENT WALL. | |

PROJECT: 21555
FREY STREET - MIXED USE DEVELOPMENT
ADDRESS: 400 FREY STREET
MORTON GROVE, IL 60052
CLIENT: FREY STREET LODGING ASSOCIATES, LLC
CROSSING MANAGEMENT COMPANY
ARCHITECT: KIRKLAND LEWIS INC.
INTERIOR: KIRKLAND LEWIS INC.

11TH
FLOOR PLAN
A2.11

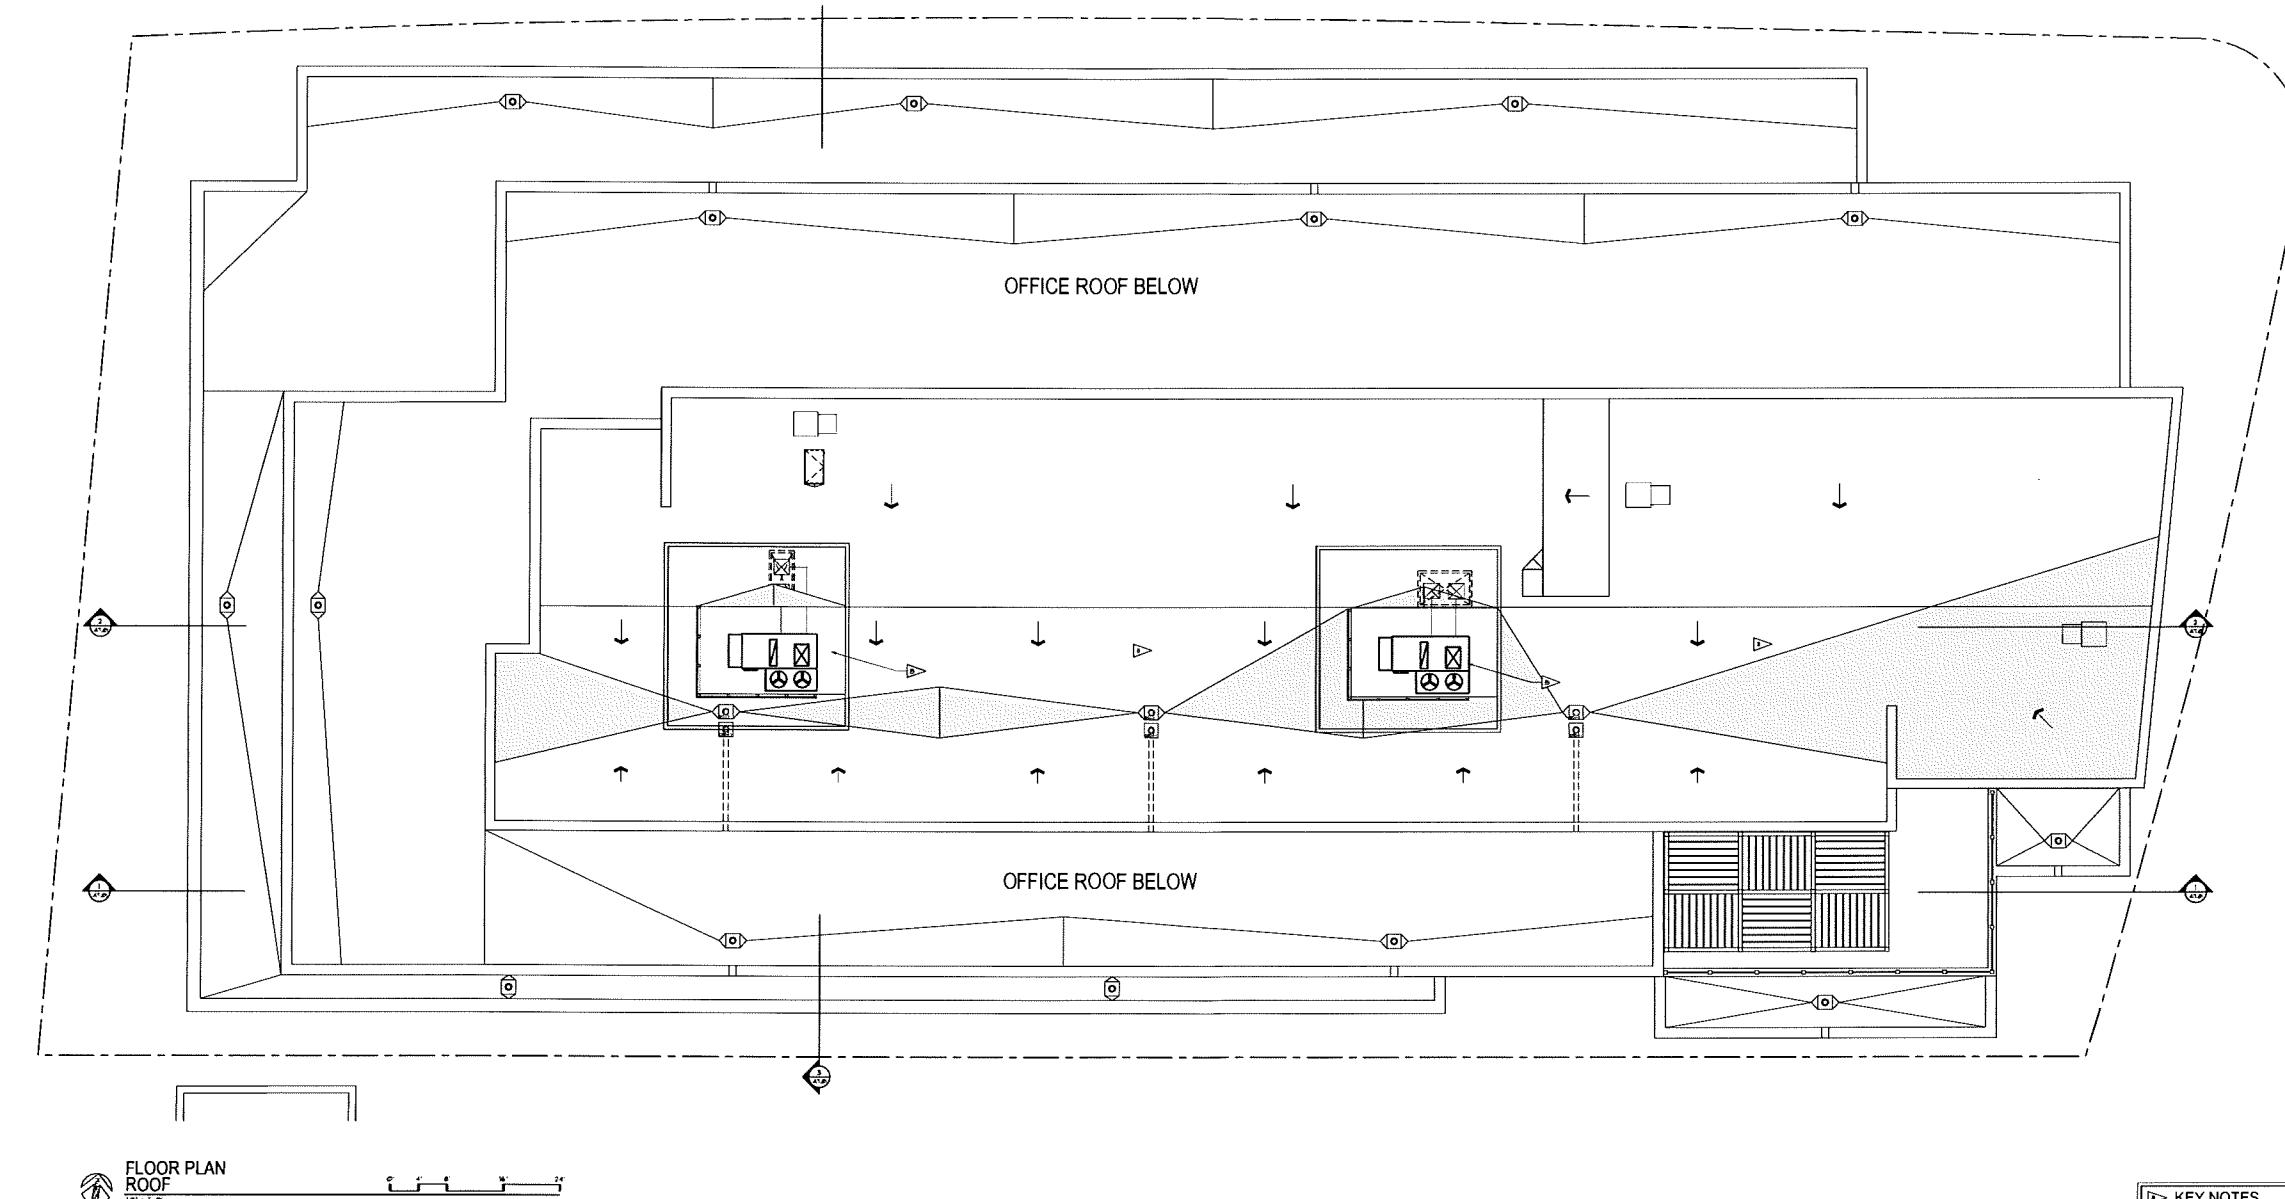

GENERAL PLAN NOTES

- ALL OPENINGS ARE TO FACE OUT AND UNOBSTRUCTED OTHERWISE.
- EXTENSION DIMENSIONS ARE TO FACE OF EXTERIOR SHEATHING IF POSSIBLE. IF NOT, EXTENSION DIMENSIONS ARE TO BE FROM THE CENTER LINE OF GUTTER WALL BOARD. TO ACHIEVE LISTED WALL TYPES ADJUSTMENT IS REQUIRED. SEE DETAIL FOR ADDITIONAL INFORMATION ON HOW TO DETERMINE THE CENTER LINE.
- NOT H.P. PLANS FOR EXTENSIONS OF EXISTING WALLS.
- SEE SHEET 12 FOR DETAILED CONSTRUCTION.
- NO ADDITIONAL FLOOR AREA IS ALLOWED OVER THE EXISTING ROOF. ADDITIONAL FLOOR AREA IS ALLOWED OVER THE EXISTING ROOF IF THE ADDITIONAL FLOOR AREA IS PLANNED, BUDGETED & TITLED AS A SEPARATE BUILDING. THIS MEANS THE ADDITIONAL FLOOR AREA IS NOT PART OF THE EXISTING BUILDING. THESE SHEET PLANING ALL CONFINE PRIOR TO BUILDING DEMO IN THE DRAWING.
- EXTERIOR WALL RAILINGS, RATHERS ARE NOT SHOWN ON THESE PLANS FOR CLARITY.
- CENTER WALL, SIDE WALL, ALL CODE REQUIRED INSULATION INCLUDING CONCRETE FLOORS, CONCRETE FLOORS, CONCRETE FLOORS.
- UNLESS NOTED OR SHOWN OTHERWISE ALL DOORS ARE TO BE LOCATED AT PROX ADJACENT WALL.

| KEY NOTES | |
|---|--|
| ► DECORATIVE CONCRETE PAVING U/RAD ARK HEAT | |
| ► BSR PARKING CODE, SEE ALIN FOR DETAILS | |
| ► HANGAR ROOF, SEE ALIN FOR DETAILS | |
| ► UNENCLOSED AREA BELOW FIRST FLOOR | |
| ► POOL ABOVE | |
| ► HIGH SPEED HEAD DOORS | |
| ► DOOR ACCESS CONTROL SYSTEM | |
| ► ELEVATED TERRACE BY STORM WATER RETENTION PER CIVIL DRILLING | |
| ► CANOPY RAIL | |
| ► WALL STOP PER ALIN | |
| ► BALCONY, BLACK IRON OVER 4' X 6' OF POLY ISO | |
| ► CONCRETE SPEED RAMP U TURNOUT AT TOP & BOTTOM | |
| ► CONTRACT PARKING SHALL BE VARIED IN WIDTH, ALL ARE GREATER THAN 8'-0" IN WIDTH & 8'-0" DEEP | |
| ► PAINTED ALUMINUM RAILINGS | |
| ► TECHNICAL INT'L ALUMINUM SCREEN | |
| ► OUTLINE OF HOTEL TOWER ABOVE | |
| ► OFFICE PLAZA PLAZA U/RAD ARK HEAT & 4' OF POLY ISO | |
| ► OFFICE PLAZA PLAZA U/RAD ARK HEAT & 4' OF POLY ISO | |

PROJECT:
FREY STREET - MIXED USE DEVELOPMENT
450 FREY STREET
MADISON, WISCONSIN 53705
CLIENT:
C/O RAYMOND LODGING ASSOCIATES, LLC
C/O RAYMOND MANAGEMENT COMPANY
www.raymond.com
www.raymondmanagement.com

ROOF PLAN
A2.12


| KEY NOTES - BUILDING ELEVATIONS | |
|---------------------------------|--|
| GRAPHIC | EXTERIOR FINISH KEY |
| (H1) | TOTAL NO. 1 SIZE: VARIOUS PROJECT NUMBER: FCA TOP EAST/FRONT ACROSS MATERIAL: BRICK |
| (H2) | TOTAL NO. 1 SIZE: VARIOUS PROJECT NUMBER: FCB TOP EAST/FRONT ACROSS MATERIAL: BRICK |
| (B1) | BLOCK NO. 1 SIZE: VARIOUS PROJECT NUMBER: FCA MATERIAL: BRICK COLOR: TERRACOTTA TOP EAST/FRONT ACROSS |
| (B2) | BLOCK NO. 2 SIZE: VARIOUS PROJECT NUMBER: FCB MATERIAL: BRICK COLOR: TERRACOTTA TOP EAST/FRONT ACROSS |
| (P1) | PICTURE FRAME NO. 1 SIZE: VARIOUS PROJECT NUMBER: FCA MATERIAL: BRICK COLOR: TERRACOTTA TOP EAST/FRONT ACROSS |
| (P2) | PICTURE FRAME NO. 2 SIZE: VARIOUS PROJECT NUMBER: FCB MATERIAL: BRICK COLOR: TERRACOTTA TOP EAST/FRONT ACROSS |
| (E1) | EPA NO. 1 SIZE: VARIOUS PROJECT NUMBER: FCA MATERIAL: BRICK COLOR: TERRACOTTA TOP EAST/FRONT ACROSS |
| (E2) | EPA NO. 2 SIZE: VARIOUS PROJECT NUMBER: FCB MATERIAL: BRICK COLOR: TERRACOTTA TOP EAST/FRONT ACROSS |
| (C1) | CLEARANCE FIELD NO. 1 SIZE: VARIOUS PROJECT NUMBER: FCA MATERIAL: BRICK COLOR: TERRACOTTA TOP EAST/FRONT ACROSS |
| (C2) | CLEARANCE FIELD NO. 2 SIZE: VARIOUS PROJECT NUMBER: FCB MATERIAL: BRICK COLOR: TERRACOTTA TOP EAST/FRONT ACROSS |

G B A
770 ELLIOTT AVENUE, SUITE 204
MIDDLEBURY, VT 05753
(802) 325-1730
(802) 325-5341 (FAX)




EXTERIOR ELEVATIONS




A6.01

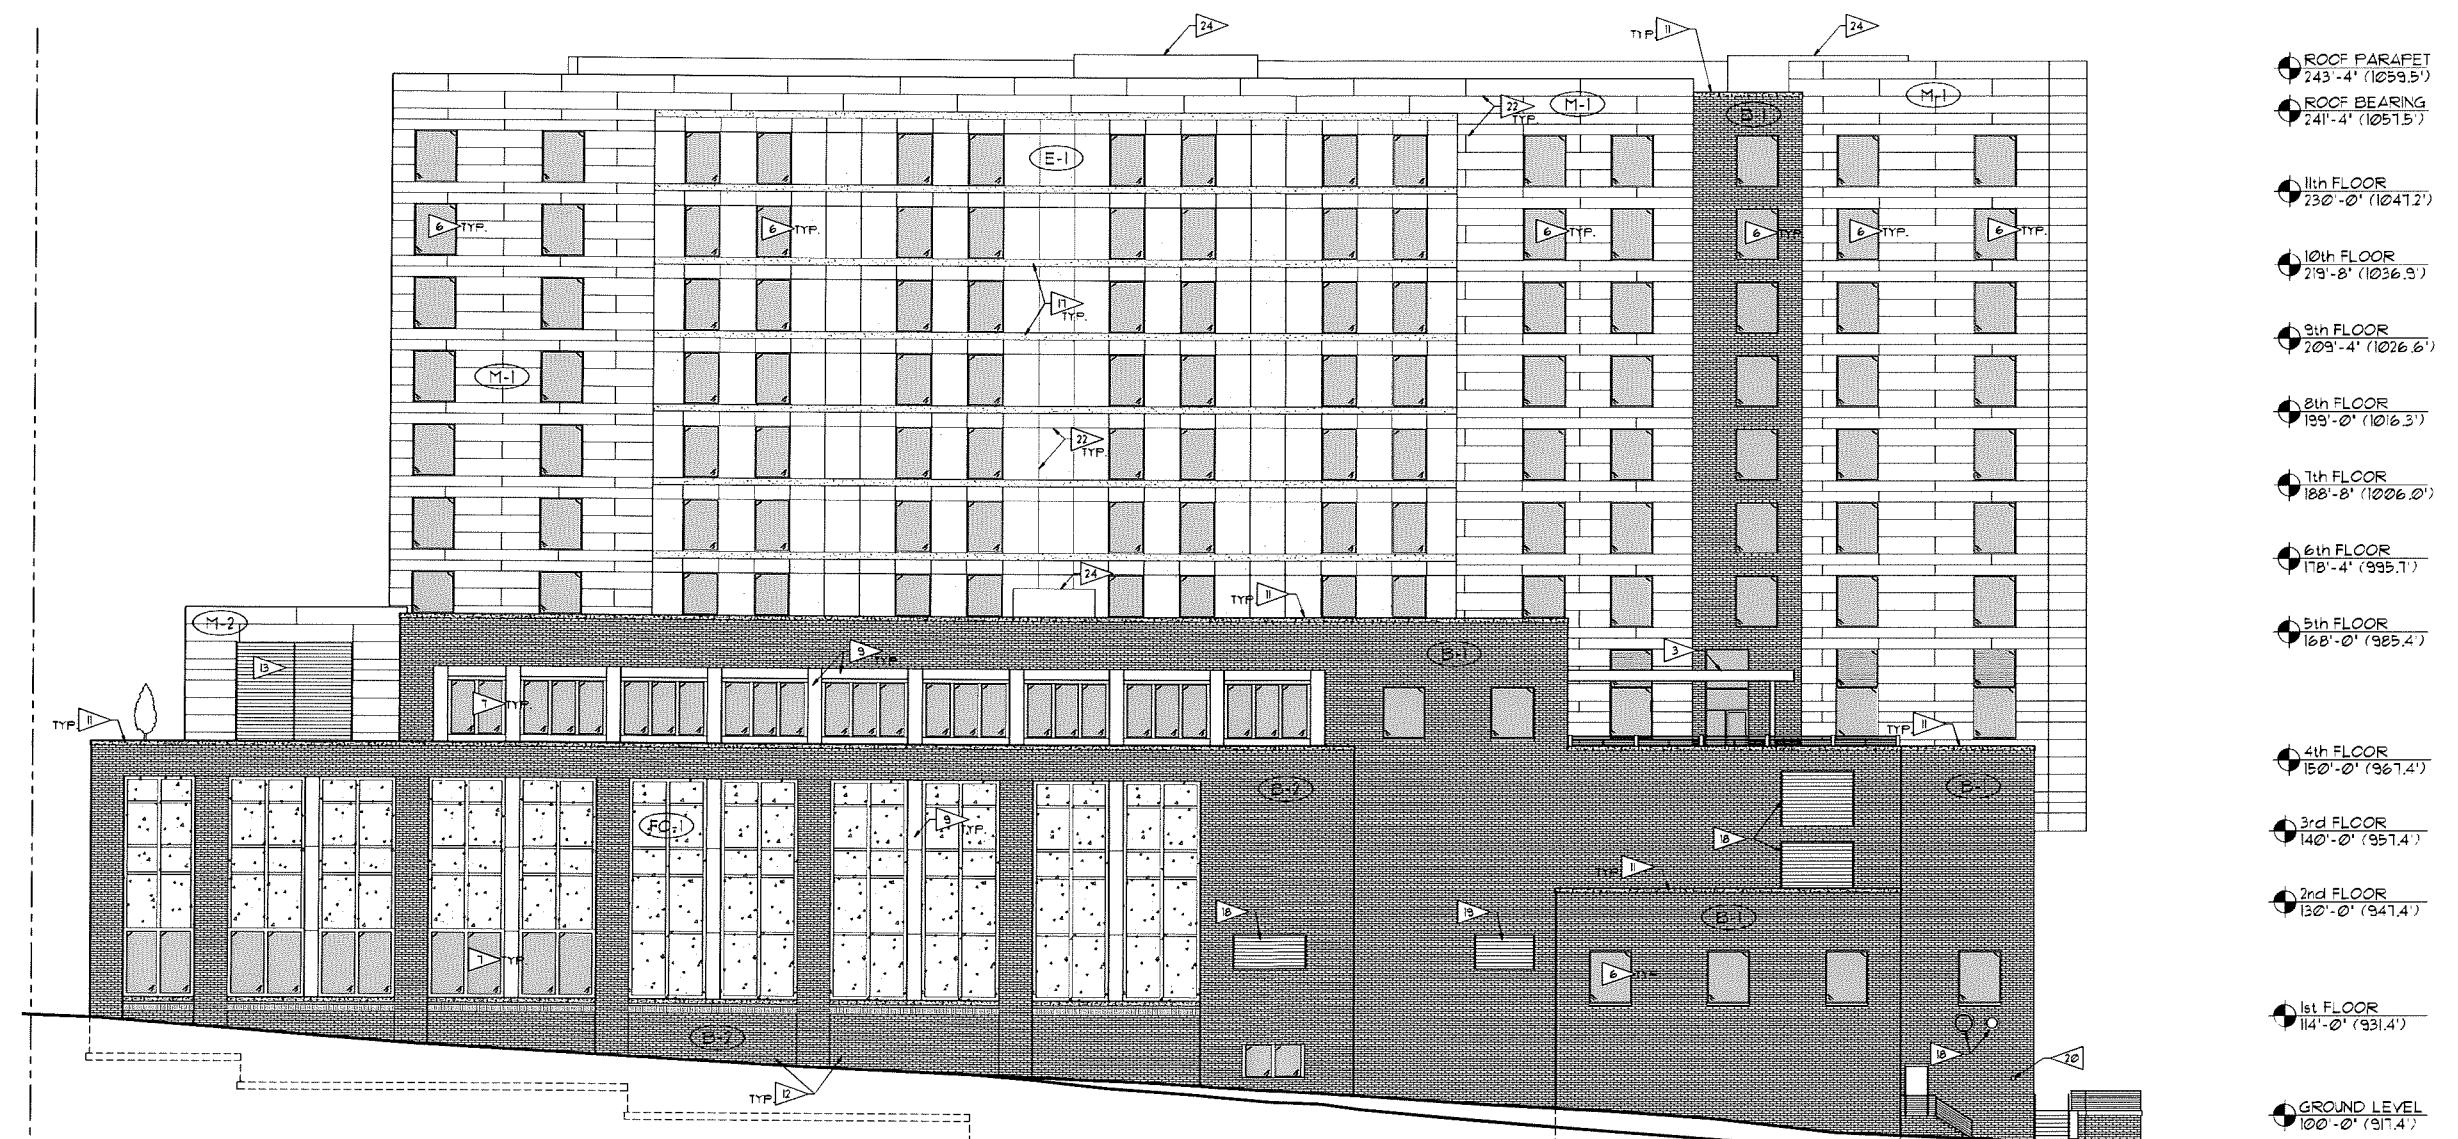



PROJECT: FREY STREET - MIXED USE DEVELOPMENT
DRAWN BY: BLM
DATE: 12-2-2016
SCALE: AS NOTED
JOB #: 11-326
LAND USE: RR-1-301
CITY BOUNDARY: E14-01-201

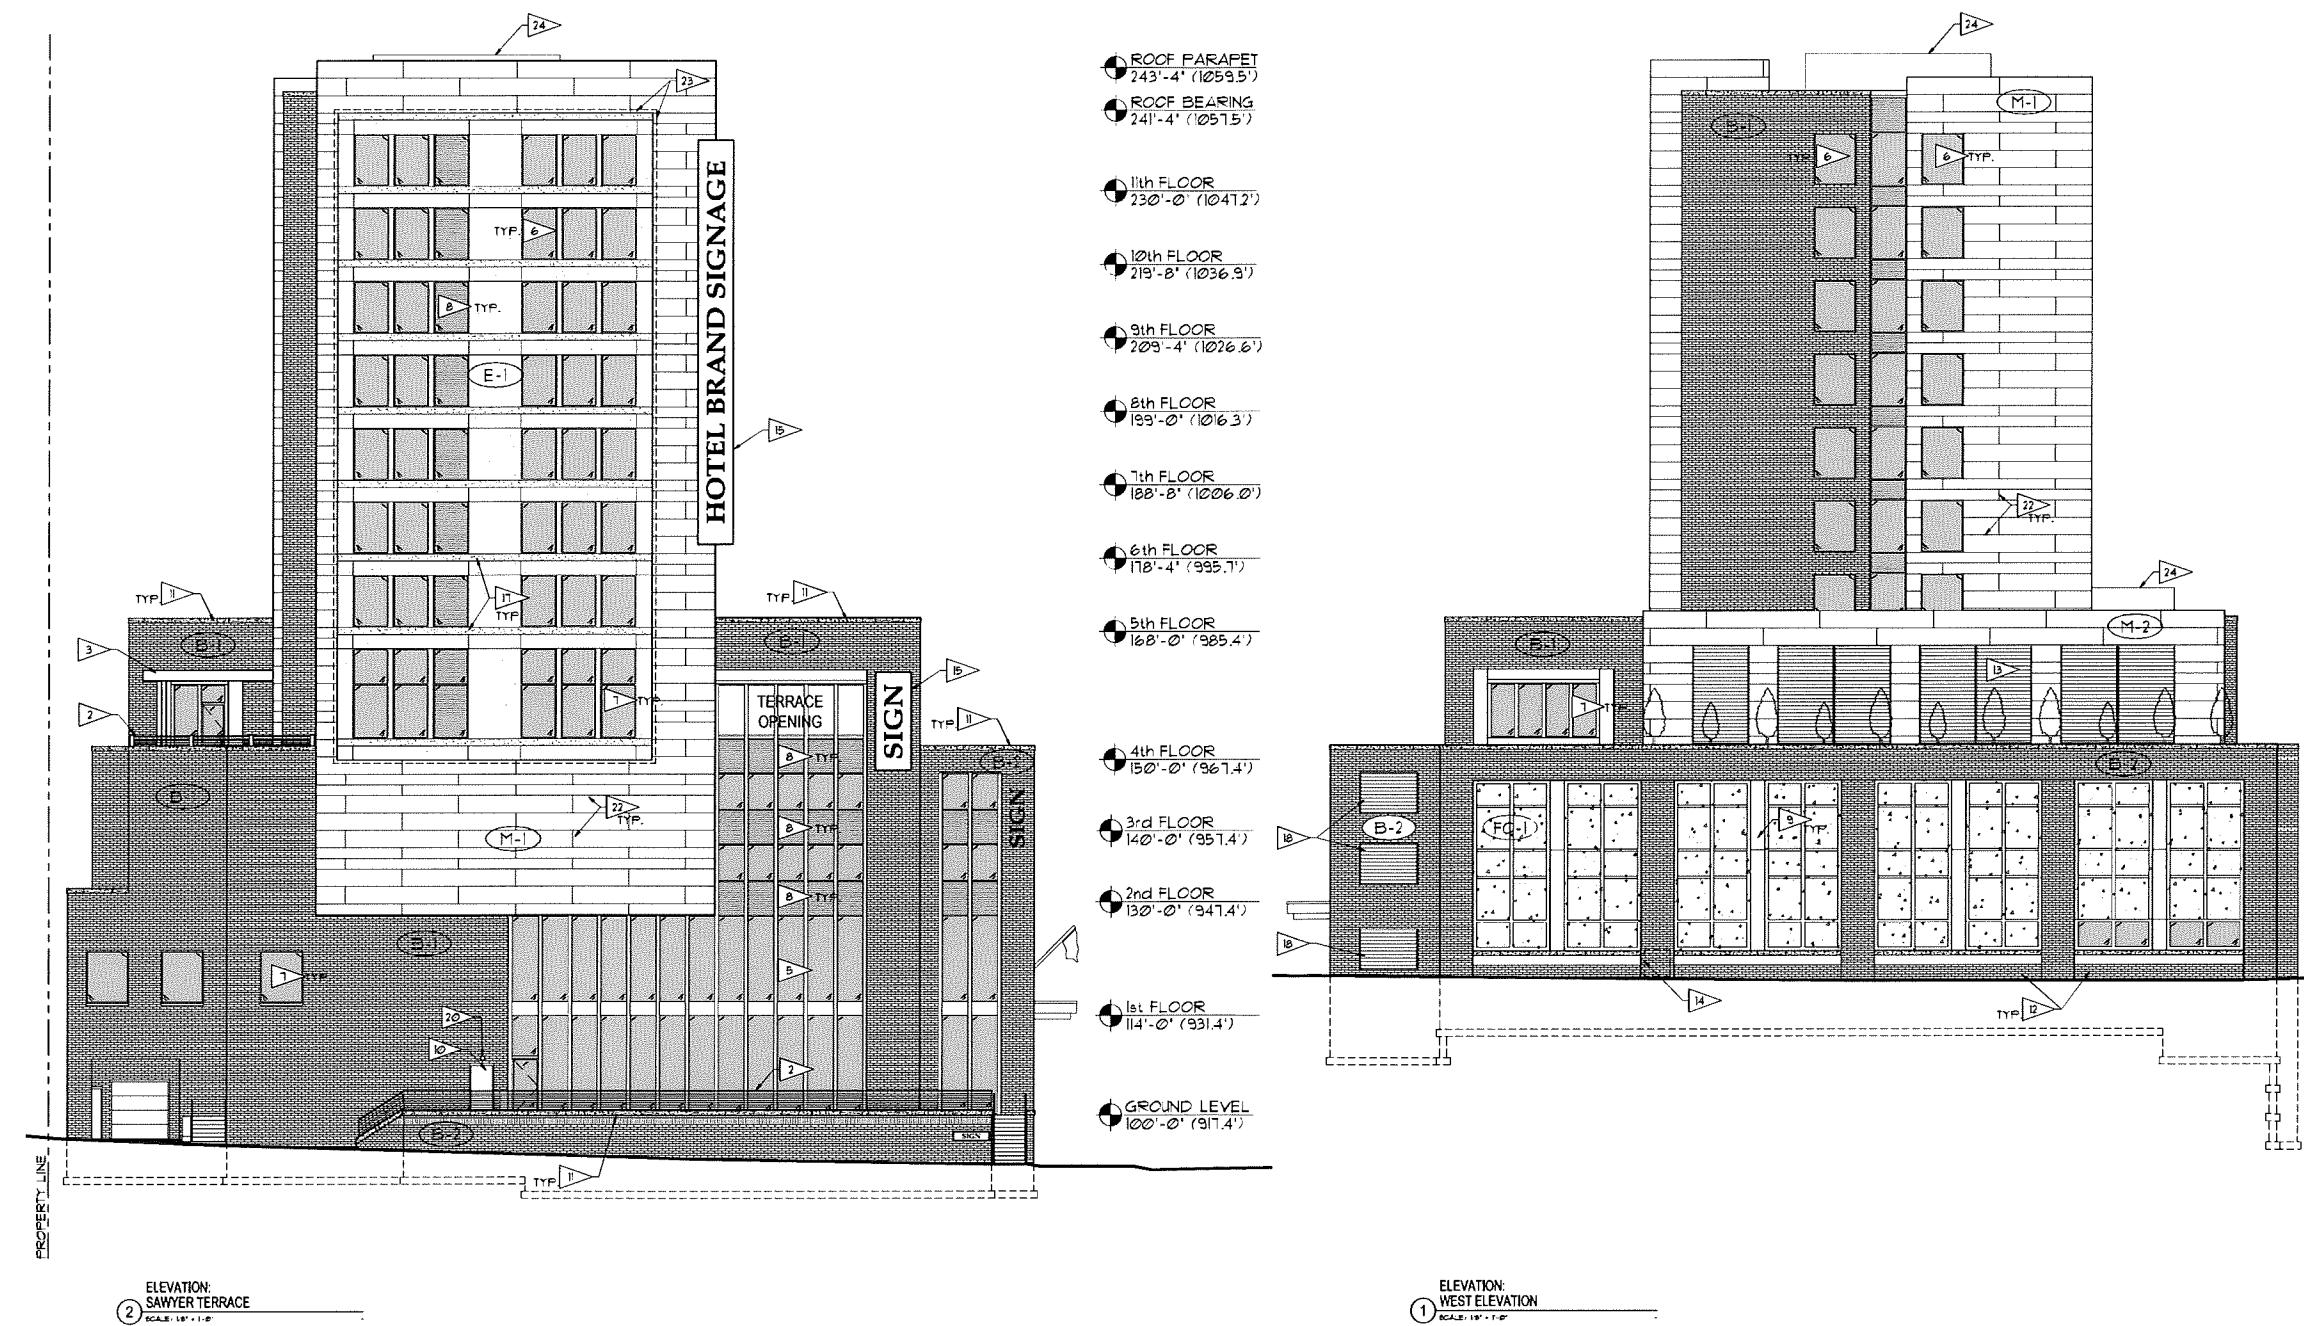

PROJECT: FREY STREET - MIXED USE DEVELOPMENT
451 FREY STREET
MAILED: WISCONSIN STATE
CLIENT: CIO RAYMOND LODGING ASSOCIATES, LLC
MANAGER: CIO RAYMOND MANAGEMENT COMPANY
DRAWN BY: BLM
DATE: 12-12-06
SCALE: AS NOTED
LOC: 4
LAND USE: #1-2-3-4
CITY: MILWAUKEE
CITY: MILWAUKEE
CITY: MILWAUKEE
CITY: MILWAUKEE

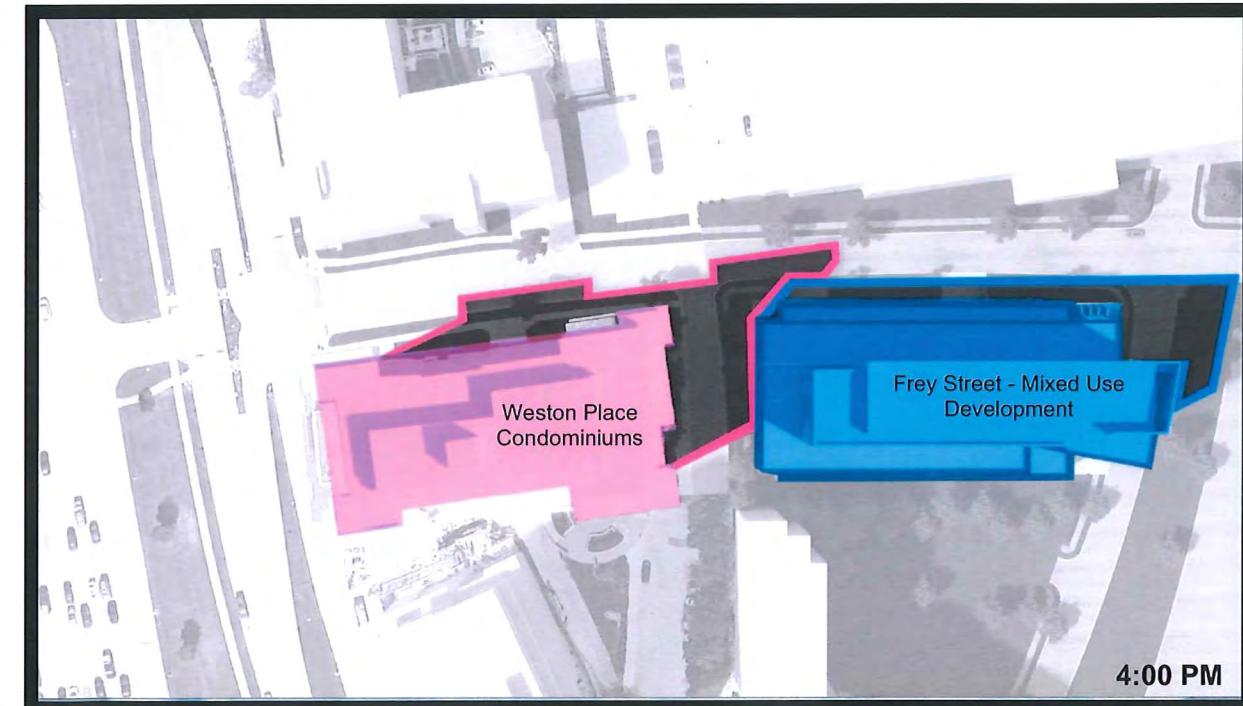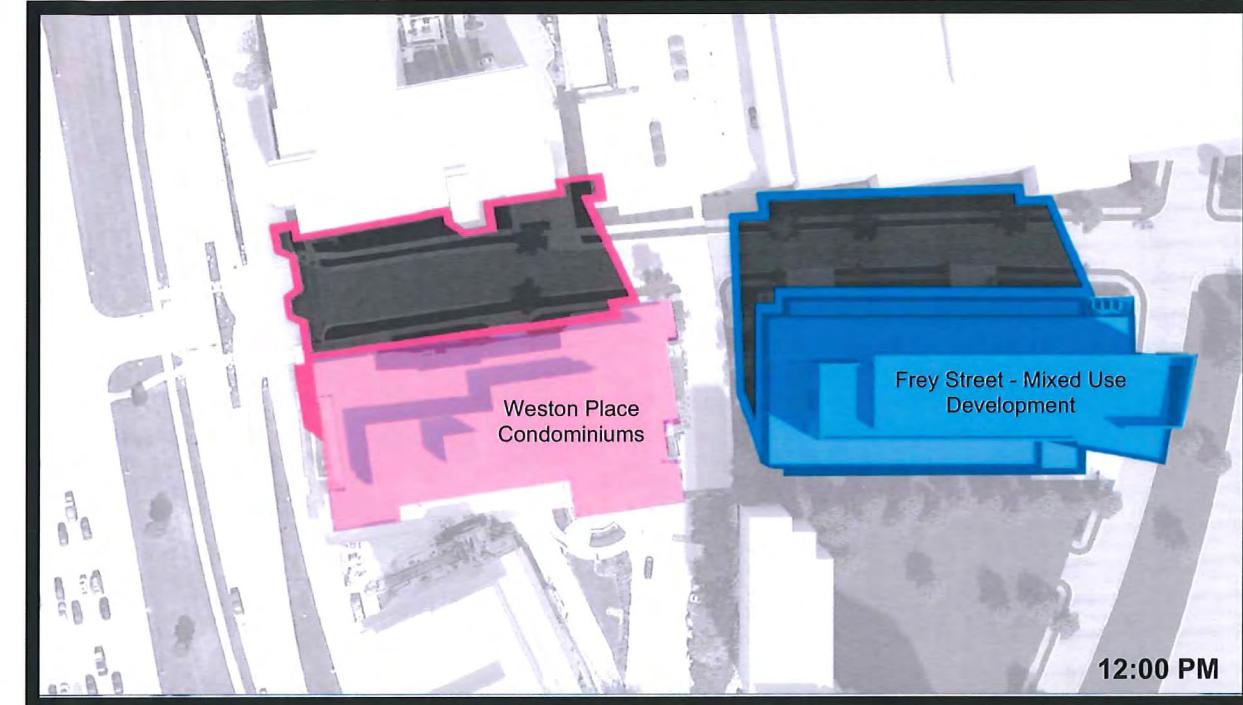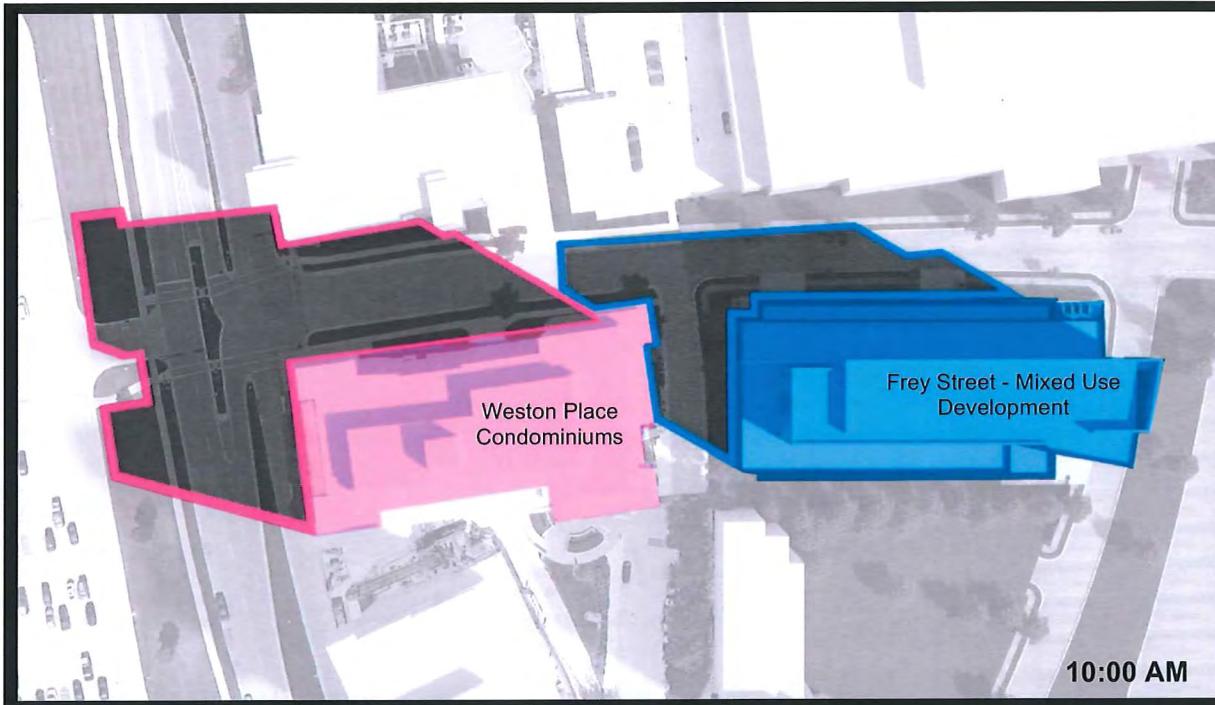

PROJECT: FREY STREET - MIXED USE DEVELOPMENT
4001 FREY STREET, MIDDLETON, WI 53562
CLIENT: CORY STREET LODGING ASSOCIATES, LLC
CORY STREET MANAGEMENT COMPANY
DRAWN BY: BLM
DATE: 12-12-2006
SCALE:
LOC 1: 1-4-304
LAND USE: 02-09-301

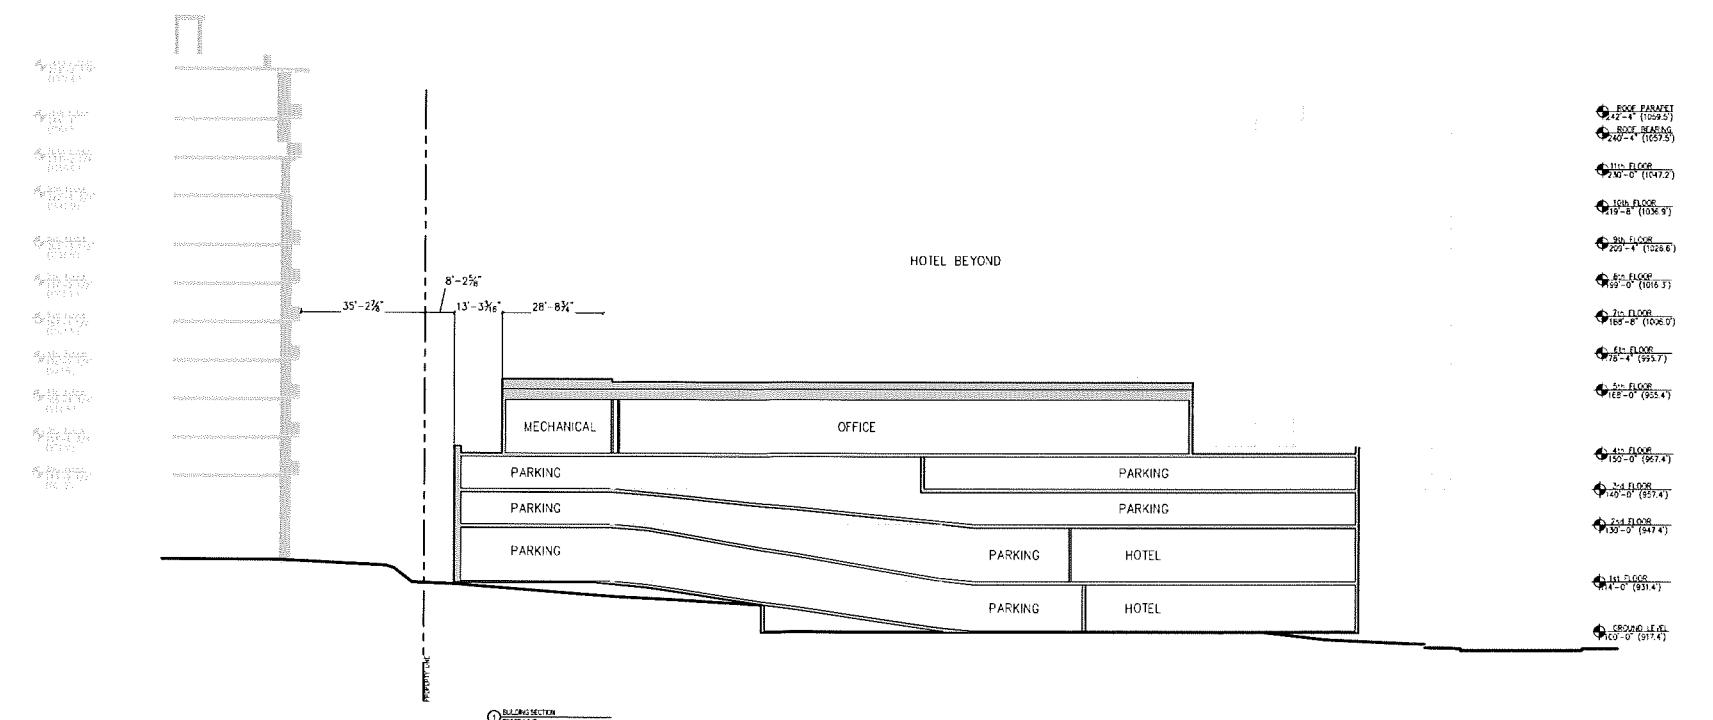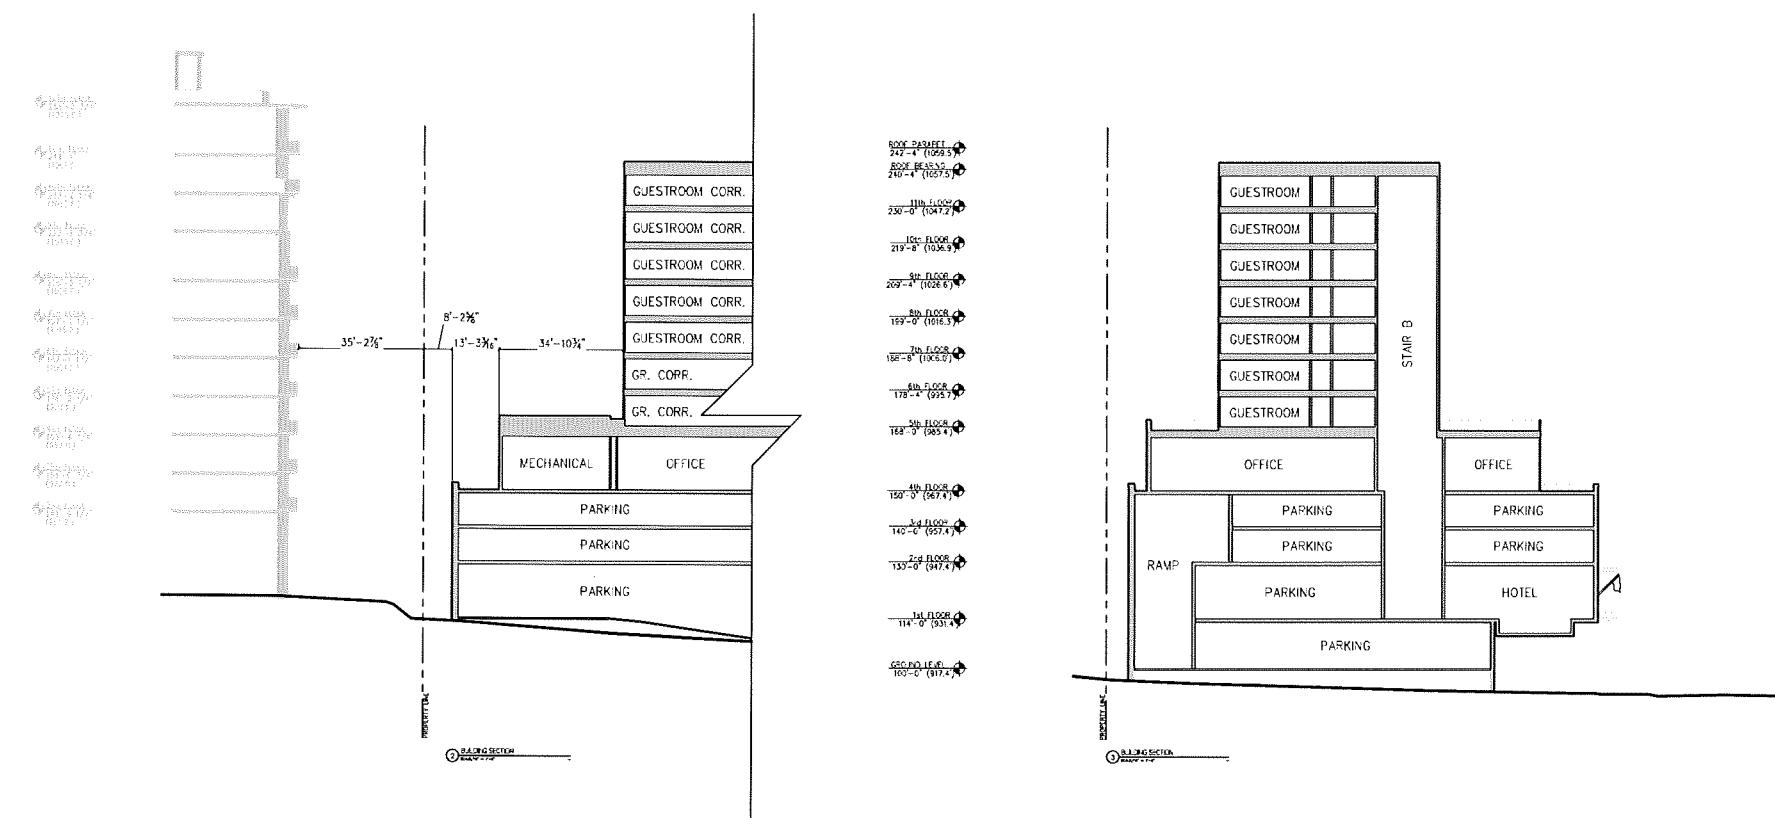

PROJECT: FREY STREET - MIXED USE DEVELOPMENT
400 FREY STREET SECTION 3705
CLIENT: 400 FREY STREET LODGING ASSOCIATES, LLC
MIDDLETON, WI 53562
MANAGEMENT COMPANY

ORIGINATOR: BIM 4.0
An AutoCAD® Revit® add-in
for faster, easier, more accurate 3D
Architectural, Structural, and Civil design.

PROJECT: 201635
DRAWN BY: GJA
DATE: 11-15-2016
SCALE: 1/8" = 1'-0"
LSC #: C-06-2017
LAND USE:



PROJECT: FREY STREET • MIXED USE DEVELOPMENT
400 FREY STREET
MADISON, WISCONSIN 53705
CLIENT: CJO RAYMOND LODGING ASSOCIATES, LLC
CJO RAYMOND MANAGEMENT COMPANY
MIDDLETON, WI 53562

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PROJECT: 3/1/17
DRAWN BY: BLH
DATE: 12-12-06
SCALE: 1:6-30'
JCS: 1
UPDATE: 12-12-06



PROJECT: FREY STREET - MIXED USE DEVELOPMENT
401 FREY STREET
MADISON, WISCONSIN 53705
CLIENT: C/O RAYMOND LODGING ASSOCIATES, LLC
ADDRESS: 1500 MADISON AVENUE, SUITE 100, MILWAUKEE, WI 53202

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AIA/CES

PROJECT: 201555
DRAWN BY: BLM
DATE: 12-12-2016
SCALE: 1-8-20'
JDC-1
UPDATE #5-10-2016



PROJECT: FREY STREET - MIXED USE DEVELOPMENT
400 FREY STREET
CITY: MIDDLETON, WI 53562
ARCHITECT: GIBSON, WILSON & ASSOCIATES, LLC
GENERAL CONTRACTOR: O'LEARY CONSTRUCTION CO., LLC
MANAGEMENT COMPANY: GIBSON, WILSON & ASSOCIATES, LLC
LANDSCAPE ARCHITECT: MCGOWAN LANDSCAPE ARCHITECTURE
STRUCTURAL ENGINEER: KUEHNLE & ASSOCIATES
MECHANICAL ENGINEER: KUEHNLE & ASSOCIATES
ELECTRICAL ENGINEER: KUEHNLE & ASSOCIATES
PLUMBING ENGINEER: KUEHNLE & ASSOCIATES
LAND SURVEYOR: KUEHNLE & ASSOCIATES
PROJECT NUMBER: 010133
DRAWN BY: BLM
DATE: 12-12-2016
SCALE: 1:100
LDS #: 100-261
UPDATE: 12-12-2016



PROJECT: FREY STREET - MIXED USE DEVELOPMENT
DRAWN BY: BLM
DATE: 12-2-2016
SCALE: 1:400
R4