

City of Madison

Conditional Use

Location 1804 S Park Street

Project Name Auto Repair


Applicant Shariff Syed / Gary Olen, GOLA Architects Inc.

Existing Use Multi-tenant Commercial

Proposed Use

Allow repair station tenant in existing multi-tenant building in CC-T zoning.

Public Hearing Date Plan Commission 04 December 2017

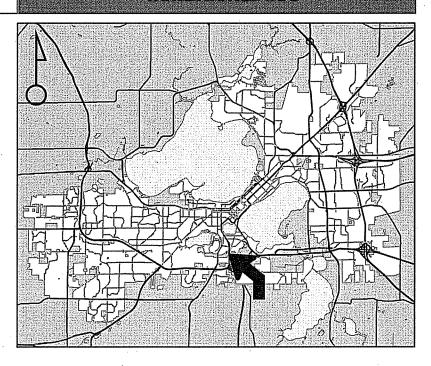


For Questions Contact: Tim Parks at: 261-9632 or tparks@cityofmadison.com or City Planning at 266-4635



Scale: 1" = 400'

City of Madison

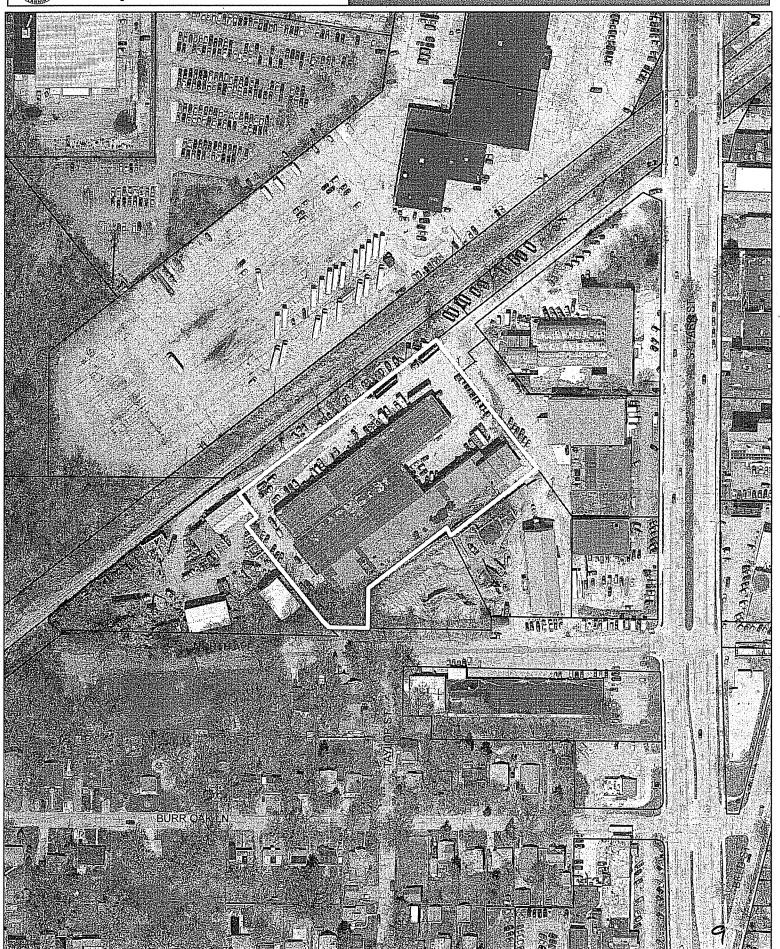

Date of Aerial Photography : Spring 2016

City of Madison Planning Division 126 S. Hamilton St. P.O. Box 2985 Madison, WI 53701-2985 (608) 266-4635



FOR OFFICE USE ON	
Paid 600 —	Receipt # 36294-0009
Date received	10-17-17
Received by	mwT
Parcel #	0709-352-1101-4
Aldermanic district	14-cprter
Zoning district	CC-T
Special requirements	
Review required by	
□ UDC	□ PC

والمراوي المواصلة المسابع المسابعة المنافقة والمعادية والمعاد المادي المسابعة المنافقة والمسابعة المنافقة الما	Aldermanic district 14 - CATEC
All Land Use Applications must be filed with the Zoning Office at the above address.	the Zoning district <u>CC-T</u>
	Special requirements
This completed form is required for all applications for Plan Commission review except subdivisions or land divisions, which should be filed using the Subdivision Application found on the Circle was leading to the complete the	Review required by
	e 🗆 UDC 🗓 PC
	on 🛘 Common Council 🗘 Other
the City's web site.	Reviewed By
	er e
1. Project Information	and the second process of the second
Address: 1804 5. PAV	V- ST.
Title: FACIUTY CHA	NEE OF OCCUPANCY
2. This is an application for (check all that apply	N
☐ Zoning Map Amendment (rezoning) from	ري و در
	ed Development-General Development Plan (PD-GDP) Zoning
	ed Development-Specific Implementation Plan (PD-SIP)
Review of Alteration to Planned Developr	· · · · · · · · · · · · · · · · · · ·
Conditional Use or Major Alteration to an	·
☐ Demolition Permit	Approved conditional ode
☐ Other requests	
	·
3. Applicant, Agent and Property Owner Inform	ation
Applicant name SHARIFE SY	Company
Street address 19015, PAIRK S	ToCity/State/Zip
Telephone 608-353-1786	
Project contact person	Company GO/A AVOITED STATE
Street address 6405 Cantilley Au	E. City/State/Zip WIDDLE TON, WI 52562
Telephone 608-53 - 5255	Email GOIEN & GOA-AVICHITECTS, COM
Property owner (if not applicant)	•
Street address	City/State/Zip
Telephone	Email

121

GO/A Architects, Inc.

6405 Century Ave., #003, Middleton, WI 53562 608-831-5255 voice goien@goa-architects.com

LETTER OF INTENT

October 17, 2017

CITY OF MADISON
Department of Planning & Community Development
126 S. Hamilton St.
Madison, WI 53703

RE: Conditional Use Permit for Four Automotive Repair Shops

Property Address:

1804 S. Park St.

Zoning District:

CC-T and WP-18

Aldermanic District:

14

Project Team:

Owner:

Shariff Syed Macro, Inc.

714 W. Badger Rd. Madison, WI 53713

Architect;

Gary Oien

GO/A Architects, Inc. 6405 Century Ave. Middleton, WI 53562

Project Details:

This property was annexed from the Town of Madison. According to the Owner automotive repair shops were originally approved by the Town of Madison, but now that use is currently a Conditional Use in the City of Madison's CC-T zoning district. Our goal is to bring this property up to City of Madison's current standards.

The proposed automotive repair shops are small family run businesses. Therefore, we are asking that units 7, 11, 18 & 19 of this mixed-use property be approved as conditional uses.

All other proposed uses for this property are approved for this zoning district.

This property is also in Zone B of a WP-18 Wellhead Protection Zone. For this reason we are submitting a Best Management Practices guide for auto repair shops as part of this application to protect the ground water in this area.


There is no minimum parking required in this zoning district but we are showing existing parking on existing asphalt that will stripped. We are also adding the required amount of bicycle stalls for the proposed uses.


All other building code issues will be addressed thru the building permit application. New building code features that will be added include men/women toilets and fire walls next to certain uses.

Respectfully,

GO/A Architects Inc.

Mr. Gary Oien, President

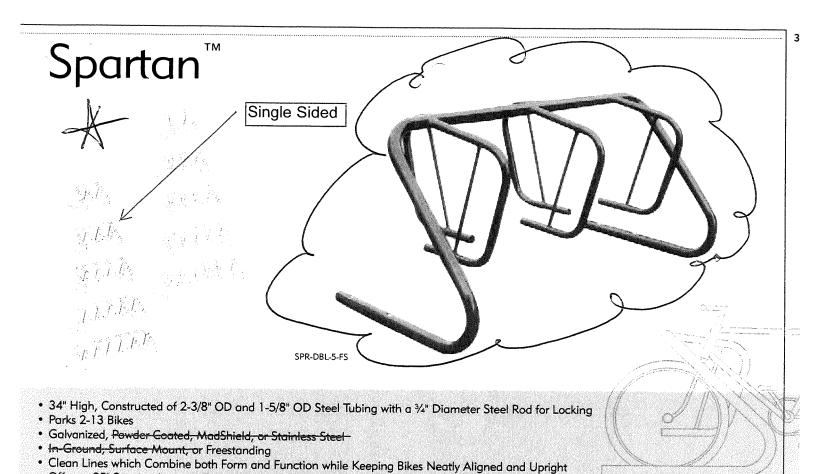

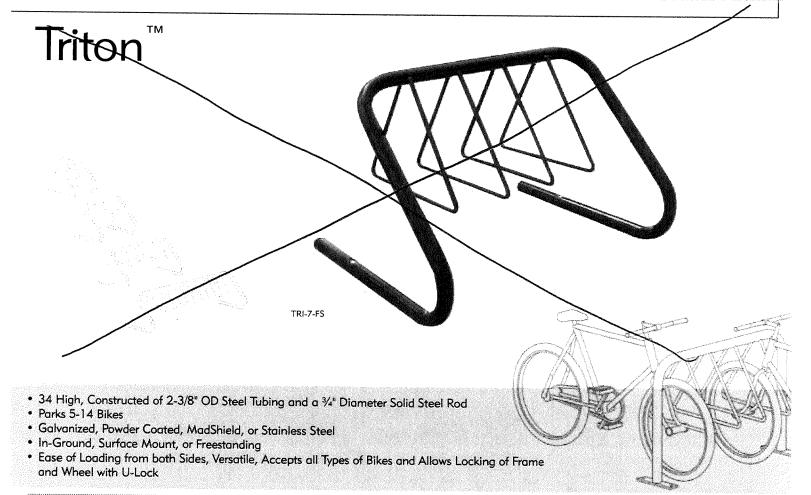

Offers a 25" Spacing between Bikes and All-Welded Construction

Gary Oien

From:

Grande, Joseph < JGrande@madisonwater.org>

Sent:

10-11-17 4:15 PM

To:

'goien@goa-architects.com'

Cc:

Van Aartsen, Marie; Kirchgatter, Jenny; Moskowitz, Jacob

Attachments:

S4.2 PotentialSources.pdf; S2.13 Prohibited Use Zone B.pdf

Gary -

Thank you for providing the opportunity to review the plans for the property located at 1804 S Park Street. This property is located in Zone B of the Wellhead Protection District for Well 18. As such, there are certain land use restrictions that serve to protect groundwater in the vicinity of this and other municipal drinking water wells. Auto body repair, vehicle towing, and vehicle repair are among recommended prohibited uses within Zone B based on the probable presence, use, or storage of hazardous chemicals. These toxic chemicals include parts washers, spray solvents, paints and paint thinner, petroleum products (gas, oil, diesel), antifreeze, and batteries.

The continued operation of four auto repair shops at this location could be approved subject to new and on-going mitigation consistent with the Best Management Practices (BMP) for Automotive Repair Shops you provided for my review. In particular, secondary containment in storage areas, spill response planning and clean up materials (i.e. drop pans and trays, rags, hydrophobic maps, dry absorbent materials), and lawful disposal of all solid and liquid wastes including regular pump-outs of holding tanks by a certified waste hauler would be required.


During an in-person meeting on October 5, you provided floor plans of the existing facility that included potential locations for new underground vaults or holding tanks (Note 2) for collecting liquid waste and/or potentially contaminated wash water. The Water Utility recommends against installing underground vaults for storage of waste. Importantly, the existing concrete floor serves as an impermeable barrier against wastes leaching underground. Alternatives identified in the BMP guidance document include operating a dry shop, providing secondary containment in storage areas, being prepared for spills (i.e. spill kits and spill response plan), identifying non-hazardous alternatives (if available), and training employees about waste reduction activities and the benefits of preventing pollution on the shop floor. The Water Utility also reserves the right to conduct periodic inspections of the property to ensure that the recommended BMPs are being implementing.

Finally, expansion of any automobile repair activities beyond the footprint of the existing four shops, or the initiation of other activities that have the potential to contaminate groundwater (see attached) are restricted by MGO 28.102 (4) based on the property's location in Zone B of the Wellhead Protection District.

Let me know if you have any questions.

Sincerely, Joe

Joseph Grande Water Quality Manager Madison Water Utility 608-261-9101

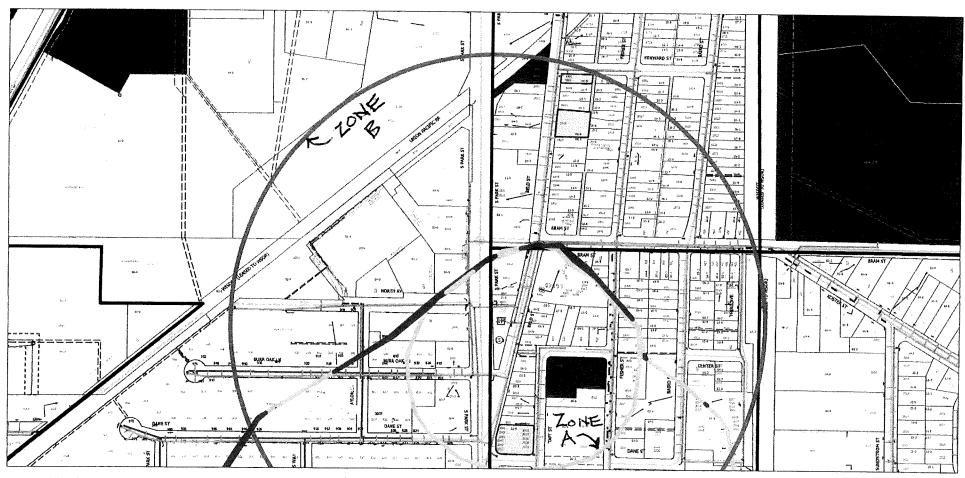

Time: 9/26/2017 1:48:34 PM

 $\textbf{Session:} F: \label{thm:common} GTV iewer \label{thm:common} GTV iewer \label{thm:common} Sessions \label{t$

Note: 1804 S Park Street

City of Madison, WI - GIS/Mapping data

Printed By: wumcv

Disclaimer: The City makes no representation about the accuracy of these records and shall not be liable for any damages

Best Management Practices (BMP) For Automotive Repair Shops

Best Management Practices for Auto Repair Shops are utilized to manage and control wastes generated by these and related facilities to minimize or prevent releases to the environment. During normal vehicle repair and maintenance activities, vehicle fluids may drip or spill or otherwise enter floor drains or sinks in service areas. Following the practices and using the equipment described in the BMPs below will help the facility conduct business in a way that protects drinking water.

- **Running a Dry Shop.** This management approach involves minimizing wastewater produced by a shop through a variety of techniques. Some of the most prominent practices are as following ways:
 - O Prevent spills from ever reaching the shop floor by installing secondary containment in storage areas; using safety cans, drip pans and trays, and funnel drum covers when transferring fluids.
 - o Immediate cleanup of spills can be promoted if employees carry rags for small spills; clean with reusable cloth rags; use absorbent materials such as hydrophobic mops to remove medium-size or larger spills; wring out absorbed fluids into suitable containers for reuse or recycling; and carefully mark and make available all spill cleanup material.
 - Keep the floor clean and dry by sweeping every day; using only a damp mop for general cleanups; never hosing work areas.
- Installing Above Grade Holding Tanks. There are no existing floor drains in any of the auto repair shops, therefore this BMP provides an appropriate method to dispose of potentially contaminated wash water and oil spills through new above ground holding waste oil tanks. The above grade holding tank will meet all federal, state, and local requirements; monitor the fluid level and schedule regular pump-outs by certified waste haulers; and check for leaks and drips on a regular basis.
- Substitution of Carburetor Cleaners Containing Chlorinated Compounds. These compounds are considered hazardous. Their use and potential threat to drinking water supplies can be reduced by:
 - O Determining if non-hazardous carburetor cleaners can be substituted;
 - Segregating carburetor cleaner from other wastes;
 - Infrequent use without spray dispensers (to minimize VOC's export to the atmosphere);
 - Saving and adding parts for single cleaning batches in heavy parts cleaning; and
 - Distillation with other solvents.
- Managing Parts-Washing Solvent Wastes. These strategies are designed to minimize and properly manage solvent wastes that result from the cleaning of parts needed for repair work. Reduction recommendations include:
 - O More efficient use:
 - Alternative cleaning; and
 - Distillation.
- Managing Oil Waste Streams. This BMP employs techniques to handle and manage new and used oil that includes oil filters and absorbents. Best Management Practices for waste oil include:
 - Catching oil dripping from parts, transfer funnels, and vehicles in drip pans;

and

- Keeping used oil in separate secure containers that are clearly marked.
- Managing solid wastes including 55-Gallon Steel Drums. This strategy is applied to
 manage and properly dispose of various solid and liquid wastes being reused and
 recycled. The services of a reliable and dependable supplier will be necessary. BMPs for
 drums being used or collected include:
 - O Drums should be empty, with no residual materials inside, outside, or on the top;
 - O Drums should be structurally sound, without big dents or rust;
 - O Drums should be located in areas clearly visible to prevent damage from motor vehicles;
 - Open head drums should be covered with lids sealed by heavy-duty bolt clamps, snap rings, or bungs;
 - Drums should be placed off the ground or on an impermeable surface in a covered containment area to prevent corrosion and discharges to ground water;
 - Drums should be stored away from the eaves of a roof and any heat sources;
 - O Drums should be located away from wetlands, surface water, wells, property lines, flood zones, and drainage areas;
 - O Drums should not be covered with other materials where they may become forgotten, knocked over, or develop unseen leaks;
 - O Drums being used should be labeled and face "out" so as to be easily read, and accessible year round in case of fire, removal, or spills; and
 - Drums should be regularly inspected for structural integrity (rust, cracks, leaks, etc.).
- Training Your Employees and Yourself. This management strategy involves the implementing a series of practices to generate less waste through effective employee training. Employees should be educated about the benefits of preventing pollution on the shop floor; know about Material Safety Data Sheets (MSDSs); be re-trained periodically to keep good practices in mind; and to be informed of new regulatory requirements.

Effective Communication. This basic shop practice involves reminding employees about pollution prevention, spill avoidance and control procedures, and emergency response information through the effective use of signs, posters, and other techniques.

I, as the Owner, certify that the above Best Management Practices will be utilized in all automotive repair shops at 1804 S. Park St., Madison, WI.

Shariff Syed, Owner

SafeWaste™ System for Used Oil Storage

SafeWasteTM

Phone

Store used oil safely indoors and out in this versatile double containment storage system. SafeWasteTM Storage Systems feature a UL-listed storage tank and diaphragm suction pump and includes features like automatic overflow protection and an audible overspill prevention alarm.

SafeWaste Storage Systems are designed to be fully operational with minimal installation cost.

A complete selection of Containment Solutions storage systems are available nationwide. Our experienced sales staff is ready to assist you in selecting the tank best suited to fit your needs, or to custom design a complete system for you.

Standard Features:

- Superior environmental protection
- Engineered to meet national and local codes
- Eliminates underground liability
- Tamper-proof self containment
- Versatile applications indoor and outdoor
- Moveable by forklift
- UL-listed aboveground flammable liquid primary storage tank
- UL-listed air operated suction pump
- Environmental security enclosure cabinet
- 110% secondary containment
- Automatic overflow protection
- Audible overspill alarm
- Liquid level indicator
- 100% observable primary and secondary tanks
- Corrosion resistant exterior coating

Options:

- 2-hour fire protection, UL-2085
- · Collection caddy

Calibration Charts:

For all tank calibration charts CLICK HERE

Above products are available through GSA Contract #GS-07F-9114G

Share this:












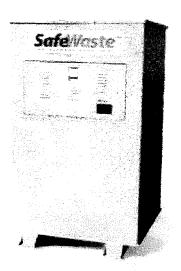

PRODUCT LITERATURE **PRODUCT SPECIFICATIONS TYPICAL DRAWINGS** INSTALLATION INSTRUCTIONS **CONTACT FORM**
















- Home
- Company Information
- Contact CSI
- Product Literature

© 2017 Containment Solutions, Inc. All rights reserved. CSI is a Woman Owned Business certified by the WBENC. A Lynn Tilton Company

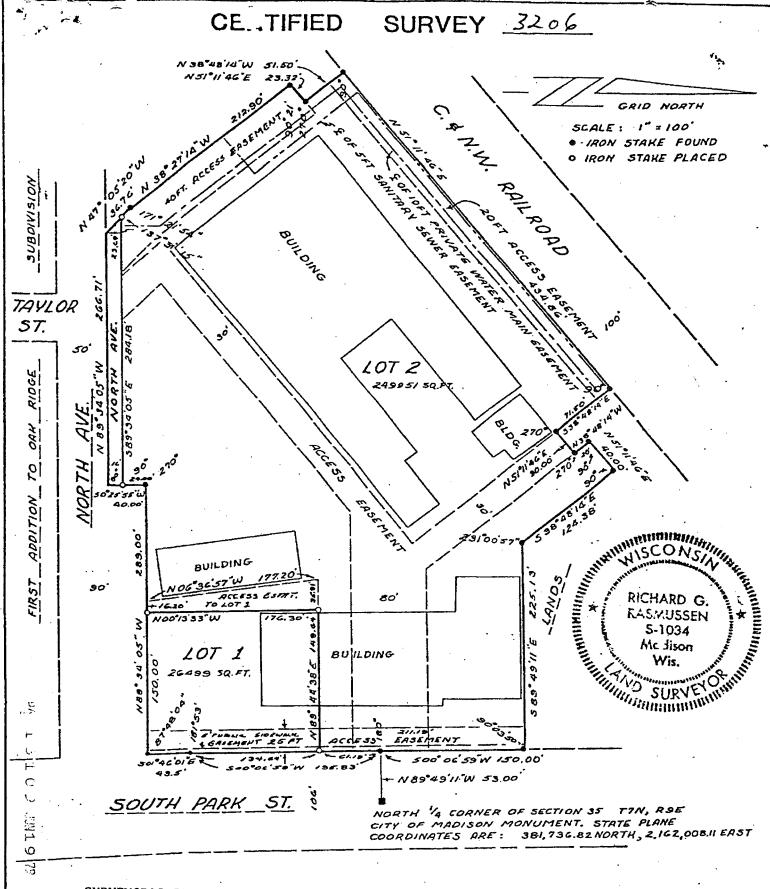

SURVEYOR'S CERTIFICATE

I, Richard G. Rasmussen, registered Land Surveyor, S-1034, do hereby certify that this is in full compliance with Chapter 236.34 of the Wisconsin Statutes and the subdivision regulations of the Town of Madison, City of Madison, and Dane County, Wisconsin. I also certify that I have surveyed and mapped the lands described herein and that the map is a correctly dimensioned representation in accordance with the information furnished.

Richard G. Rasmussen, R.L.S. S-1034

C.C.

D'ONOFRIO, KOTTKE AND ASSOCIATES, INC.

7530 WESTWARD WAY MADISON, WISCONSIN 53717 AREA CODE: 508-538-324; Date: May 10, 1978

JOB NUMBER 77 07 125

DOCUMENT NUMBER 1626109

CERTIFIED SURVEY NUMBER 3206

PAGE 1 OF 2 PAGES

CERTIFIED SURVEY

DESCRIPTION-

A parcel of land located in the NE 1/4 of the NW 1/4 of Section 35, and in the SE 1/4 of the SW 1/4 of Section 26, T7N, R9E, Town of Madison, Dane County, thence N89°49'11'W, 53.00 feet to the point of beginning; thence S00°06'59'W, 195.83 S00°25'55'W, 40.00 feet; thence N89°34'05'W, 266.71 feet; thence N38°27'14'W, 212.90 feet; thence N51°11'46'E, 23.32 feet; thence N51°11'46'E, 434.86 feet; thence S38°48'14'E, 71.50 N51°11'46'E, 40.00 feet; thence S38°48'14'E, 71.50 N51°11'46'E, 40.00 feet; thence S38°48'14'E, 71.50 N51°11'46'E, 40.00 feet; thence S38°48'14'E, 124.38 feet; thence S89°49'11'E, 225.13 acres.

Approved for recording per Dane County	***
Agriculture Zoning Planning and Was	"Resolved, that this Certified
Resources Committee action of Mey 25, 1979	Survey including any dedications shown thereon, which has been duly filed for
	approval of the Town Board of the Town
Authorized Representative # 2/68	or Madison, Dane County Wisconsin 1
The state of the s	and the same 15 hereby approved as
	quiled by Chapter 236 of the Wisconsin
Approved for recording per City of Madison	Statutes.
Fran Commission Secretary.	"I hereby compiler at
Date: 5-24-79 And Dimer BYEOK	"I hereby certify that the above is a true and correct copy of a re-
Charles B. Dimer	Surdiction adopted by the Town Page 3
Charles R. Dinauer ByEok	of the fown of Madison on this
	day of 71 1978"
Received for recording this 19 day of	
(h, h, h, h) 197# at (J, J, Q, J)	1)
O'clock .m. and recorded in Volume of Certified Surveys on page	Donna Mejer, Town Clerk
2871288	Donna Meier, Town Clerk
Carol R. Malle Harold K. Hill, Register of Deeds	•
Harold K. Hill. Register of Deeds	••
CAROL R. MAHNUE	
By! Maien Juden Leftly OWNER'S CERTIFICATE OF DEDI	•
OWNER'S CERTIFICATE OF DEDI	CATION
to be surveyed, divided, mapped and dedicated as re	presented on this Certified Surve
WITNESS the hand and don't	. Survey map.
WITNESS the hand and seal of said owners this /6	day of MAY , 1978
	, 13/6
(1)/// 1 2 2 7 7	
Winds of work	
Miles C. Durfee	
STATE OF WISCONSIN) SS Personally came before me day of the above named Notes	MISCONSIL
COUNTY OF DANE) SS personally came before me	this 16 This warming the state of the state
the above panel Mill	Durfee to E RICHARD GWARD Who ex-
me know on hand MNGK (Durice to Ext. KICHAND Gwo. E.
ecuted the foregoing instrument and acknowledged th	who ex-
10 V	
Votary Public Dans Course	Wis.
, bane county, Wisconsin	The Samme of His
by Commission Lypused 7/26/8/	SURVEY IN
11/1/10/10/	
NOTE:	
Notary Public, Dane County, Wisconsin My Commission Library 7/26/8/	Madison Wis. Wis. SURVEYORINING
NOTE:	

This document is to correct the right-of-way location of South Park Street as shown on Certified Survey Number 3186 recorded in Volume 12 of Certified Surveys on

D'ONOFRIO KOTTKE AND ASSOCIATES, INC.

Pages 250 and 251, Document #1623432, Dane County Registry.

7530 WESTWARD WAY MADISON, WISCONSIN 53717 AREA CODE: 608-836-3241

JOB NUMBER 77 07 125 DOCUMENT NUMBER 1626109 CERTIFIED SURVEY NUMBER 3206


PAGE 2 OF 2 PAGES

CERTIFIED SURVEY MAP

VUL 16977 PAGE 70


GRENLIE OFFICE MAP NO. 1708

PAGE 2 OF 3 PAGES

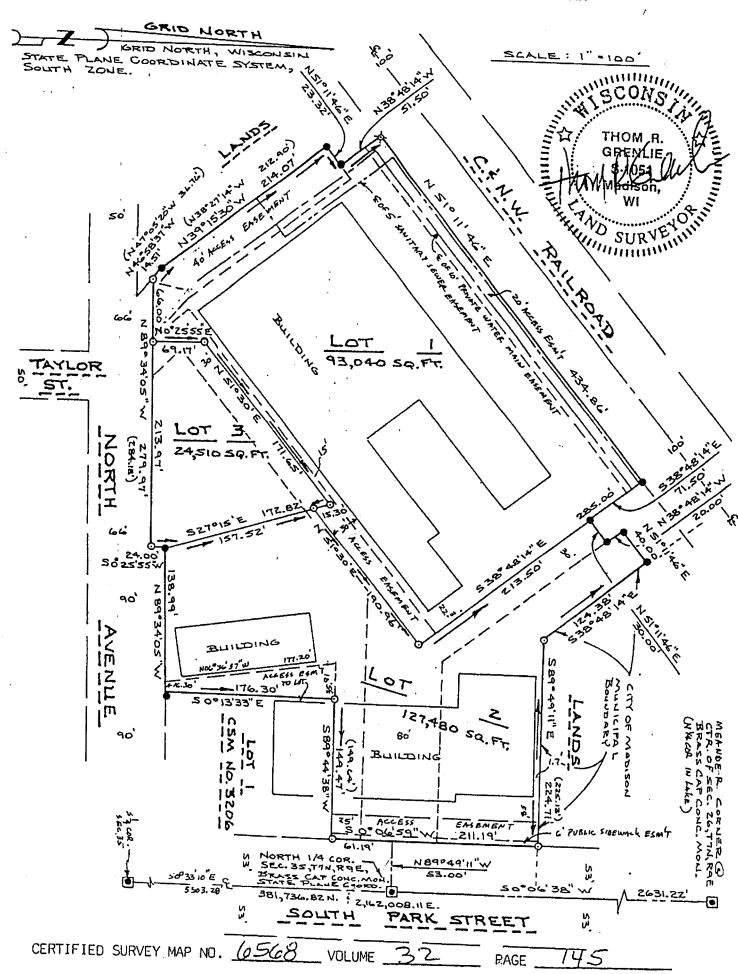

DANE COUNTY CERTIFIED SURVEY MAP NO.

BEING A DIVISION OF LOT 2, CERTIFIED SURVEY MAP NO. 8588, LOCATED IN THE NE 1/4 OF THE NW 1/4 OF SECTION 35 AND IN THE SE 1/4 OF THE SW 1/4 OF SECTION 26, ALL IN T7N, R9E, TOWN OF MADISON, DANE COUNTY, WISCONSIN.

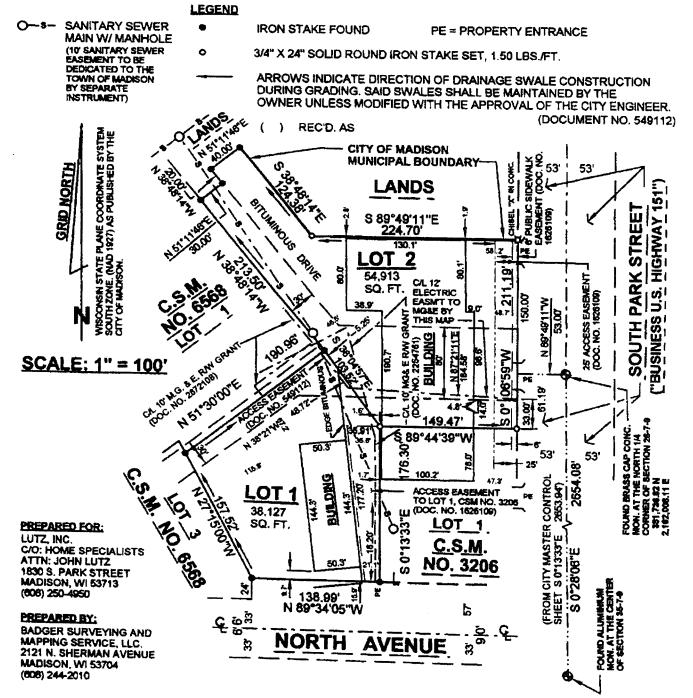

SURVEYOR'S CERTIFICATE:

I, ALDEN G. KAUKL, WISCONSIN LAND SURVEYOR, S-1384, DO HEREBY CERTIFY THAT I HAVE SURVEYED, DIVIDED AND MAPPED THE LANDS DESCRIBED HEREON AND THAT THIS MAP IS A CORRECT AND ACCURATE REPRESENTATION OF ALL EXTERIOR BOUNDARIES OF THE LANDS SURVEYED, THE LAND DIVISION THEREOF MADE AND THAT I HAVE FULLY COMPLIED WITH THE PROVISIONS OF CHAPTER 236.34, WISCONSIN STATUTES, THE DANE COUNTY LAND DIVISION AND SUBDIVISION REGULATIONS, THE TOWN OF MADISON SUBDIVISION REGULATIONS AND THE SUBDIVISION REGULATIONS OF THE CITY OF MADISON IN SURVEYING, DIVIDING AND MAPPING THE SAME.

DATE: MAY 22, 2001
REVISED: OCTOBER 24, 2001

ALDEN G.

KAUKL
S-1384

MADISON

MADISON

WIS.

WIS.

WIS.

DOCUMENT NO. 345/01

JN 1G - 24


PAGE 1 OF 5 PAGES

VOLUME (D/) CERTIFIED SURVEY MAP NO.

PROJECT:

FACILITY CHANGE OF **OCCUPANCY**

1804 S. PARK ST. MADISON, WISCONSIN

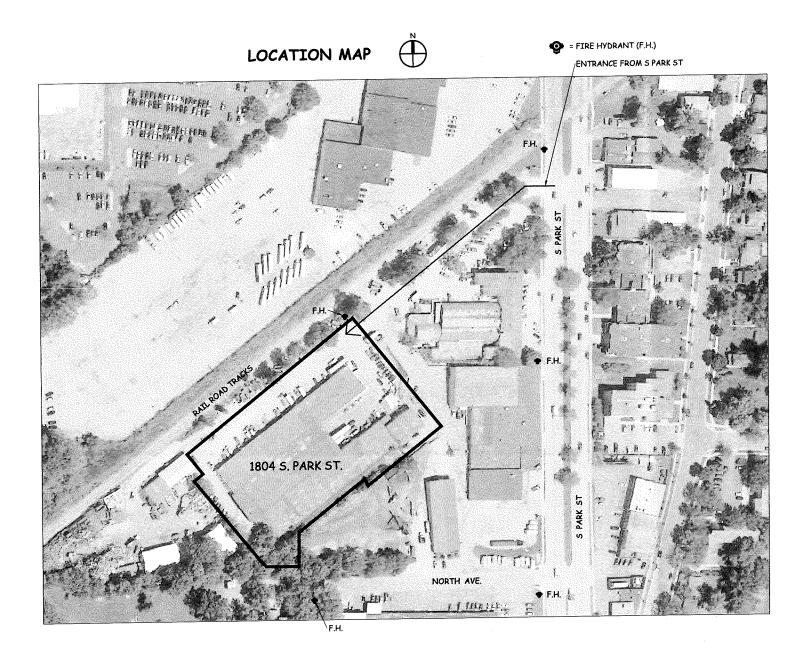

INDEX OF DRAWINGS

TI = TITLE SHEET
EXISTING CONDITIONS AND EASEMENT MAP
CI = STTE PLAN
C2 = FIRE ACCESS PLAN
C3 = SITE DETAILS
A1 = FLOOR PLANS

PROJECT INFORMATION

APPLICABLE CODES: WISCONSIN COMMERCIAL BUILDING CODE.
INTERNATIONAL EXISTING BUILDING CODE (IEBC), 2009 EDITION. CITY OF MADISON ZONING ORDINANCE.

912.1.1.1 - CHANGE OF OCCUPANCY CLASSIFICATION WITHOUT SEPARATION. THE ENTIRE BUILDING SHALL COMPLY WITH ALL OF THE REQUIREMENTS OF CHAPTER 8 APPLIED THROUGHOUT THE BUILDING FOR THE MOST RESTRICTIVE OCCUPANCY IN THE BUILDING.

912.2.1 - FIRE SPRINKLER OR FIRE ALARM/ DETECTION SYSTEMS ARE NOT REQUIRED. SEE FIRE AREAS ON SHT. C2.

912.3 - CLASS 'B' CORRIDOR AND CLASS 'C' ROOM INTERIOR FINISHES SHALL BE PROVIDED.

912.4.2 - THE MEANS OF EGRESS HAS EQUAL OR LOWER HAZARD CATEGORIES PER TABLE 912.4. EXISTING ELEMENTS SHALL COMPLY WITH SECTION 805. NEW ELEMENTS SHALL COMPLY WITH CHAPTER 10

912.5.2 - THE HEIGHTS AND AREAS HAS EQUAL OR LOWER HAZARD CATEGORIES PER TABLE 912.5. THE EXISTING BUILDING SHALL BE

912.6.2 - THE EXPOSURE OF EXTERIOR WALLS HAS EQUAL OR LOWER HAZARD CATEGORIES PER TABLE 912.6. EXISTING EXTERIOR WALLS AND OPENINGS SHALL BE ACCEPTED.

912.8.1 - ACCESSIBILITY. THE BUILDING IS A PARTIAL CHANGE IN OCCUPANCY. SECTIONS 605 AND 706 SHALL COMPLY, UNLESS TECHNICALLY INFEASIBLE.

TYPE OF CONSTRUCTION:

TYPE IIIB.

ZONED:

NO MINIMUM PARKING SPACED REQUIRED PER TABLE 281-2 OF THE PARKING:

OFFICES & ARTIST STUDIO
CONTRACTOR/SERVICE BUSINESS w/ WORKSHOP
INDOOR RECREATION BICYCLE SPACES: 03 SPACES 18 SPACES AUTO REPAIR STATION ARTISAN WORKSHOP 06 SPACES 01 SPACE 44 SPACES

TOTAL BICYCLE SPACES REQUIRED

FEMALE = 2.94 MALF = 2.94 MALE = 2,22 FEMALE = 2.22 (LOAD = 194) FEMALE = .46 MALE = .46 GROUP F-1 & F-2 (LOAD = 91) FEMALE = .46

MALE = .57 GROUP S-1 FEMALE = .57 (LOAD = 113) MALE = .57 FEMALE = 4 FEMALE = 4 TOTAL REQUIRED MALE = 4


SERVICE SINK MISCELLANEOUS:


THE EXISTING TRASH AREA IS LOCATED AT THE SE CORNER OF THE DRIVE. EXISTING MAILBOXES ARE LOCATED AT THE EXTERIOR ENTRANCE OF


▲ REVISIONS





PROJECT 10-17-17 ▼ SHEET No.

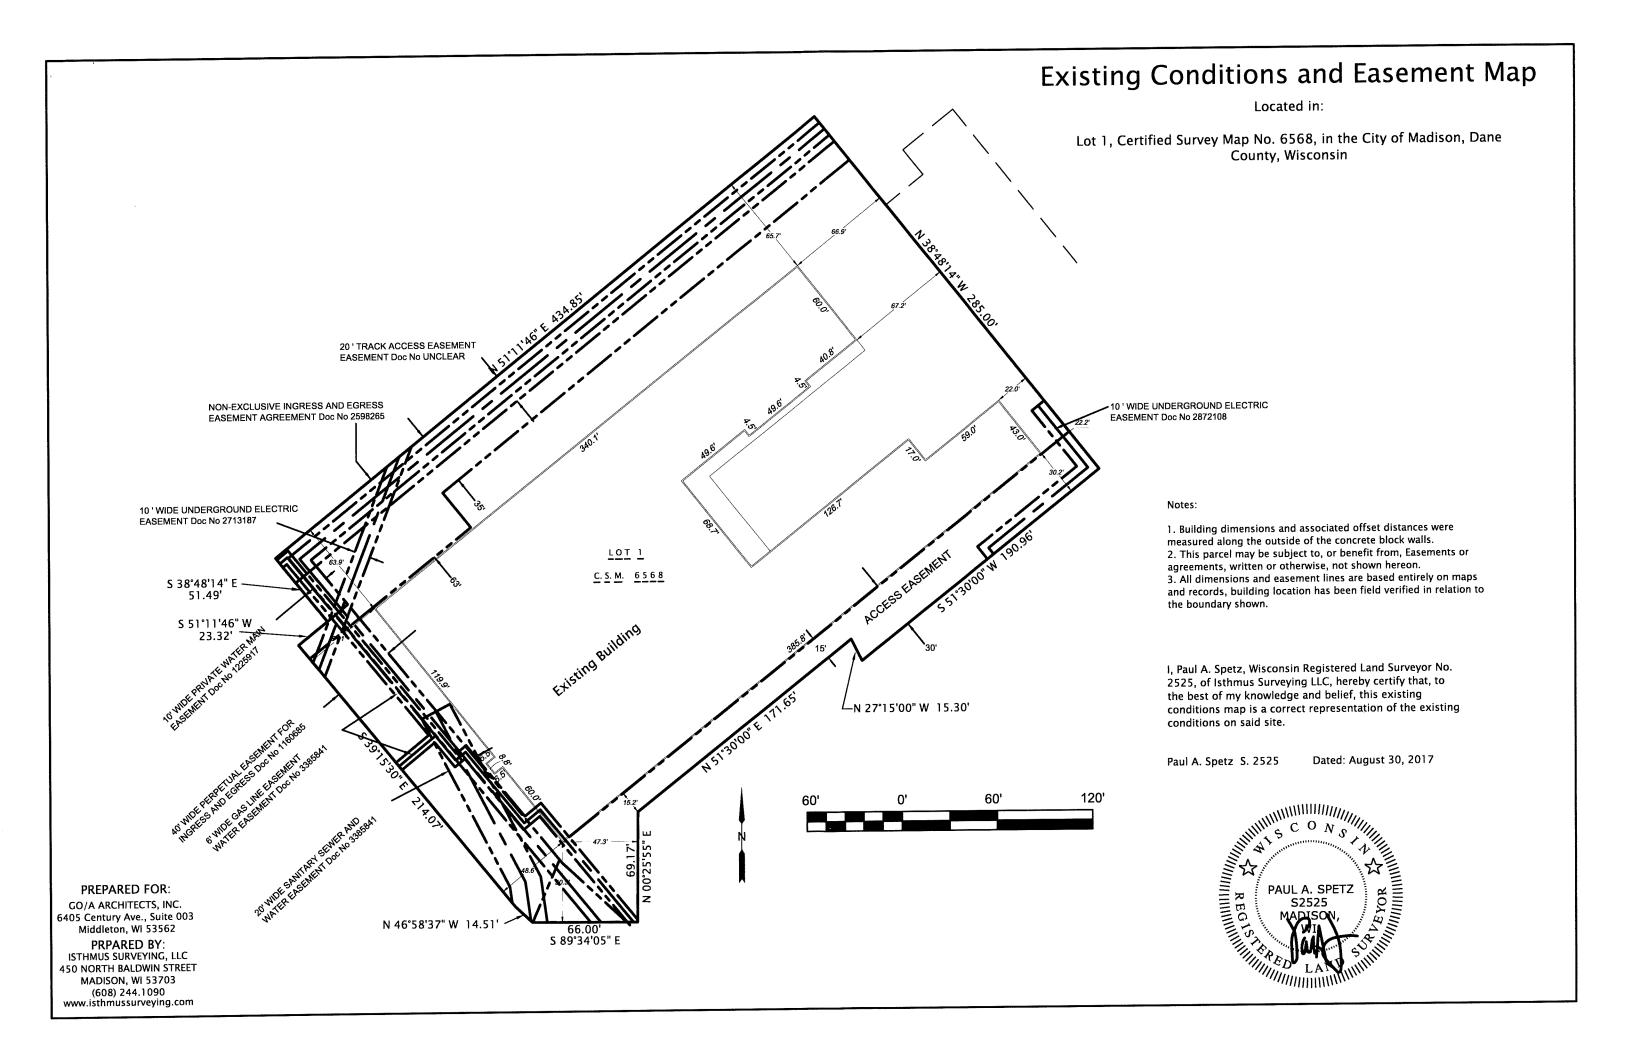


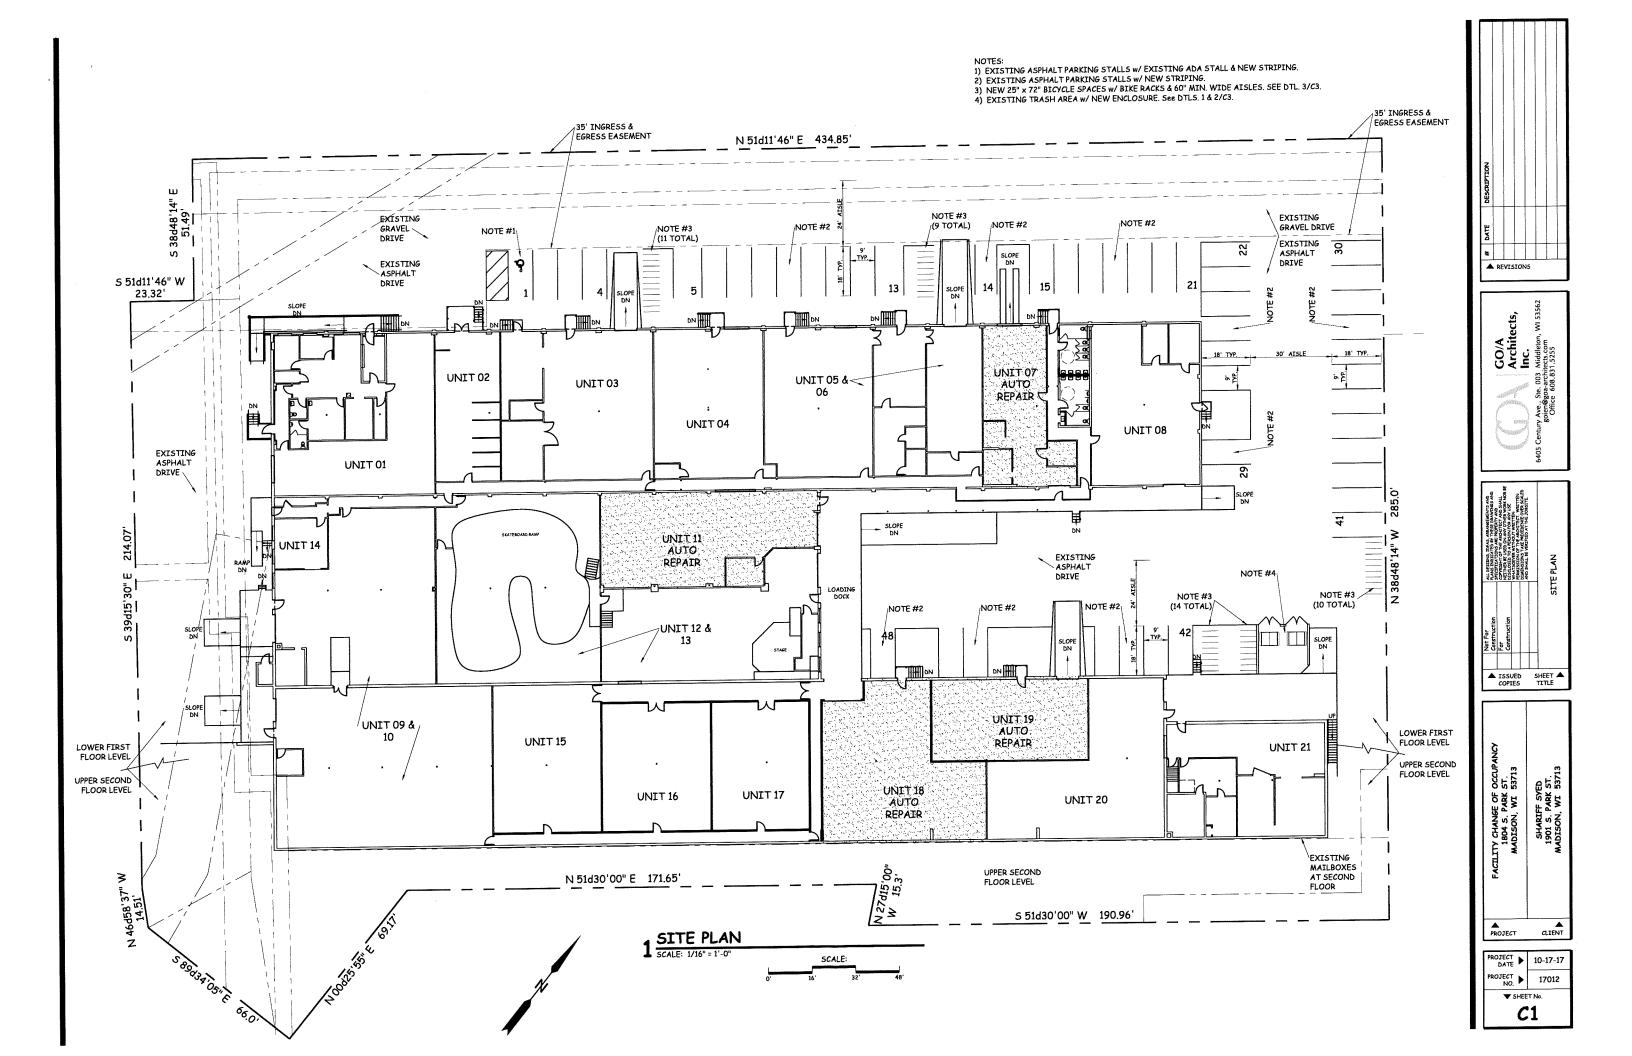

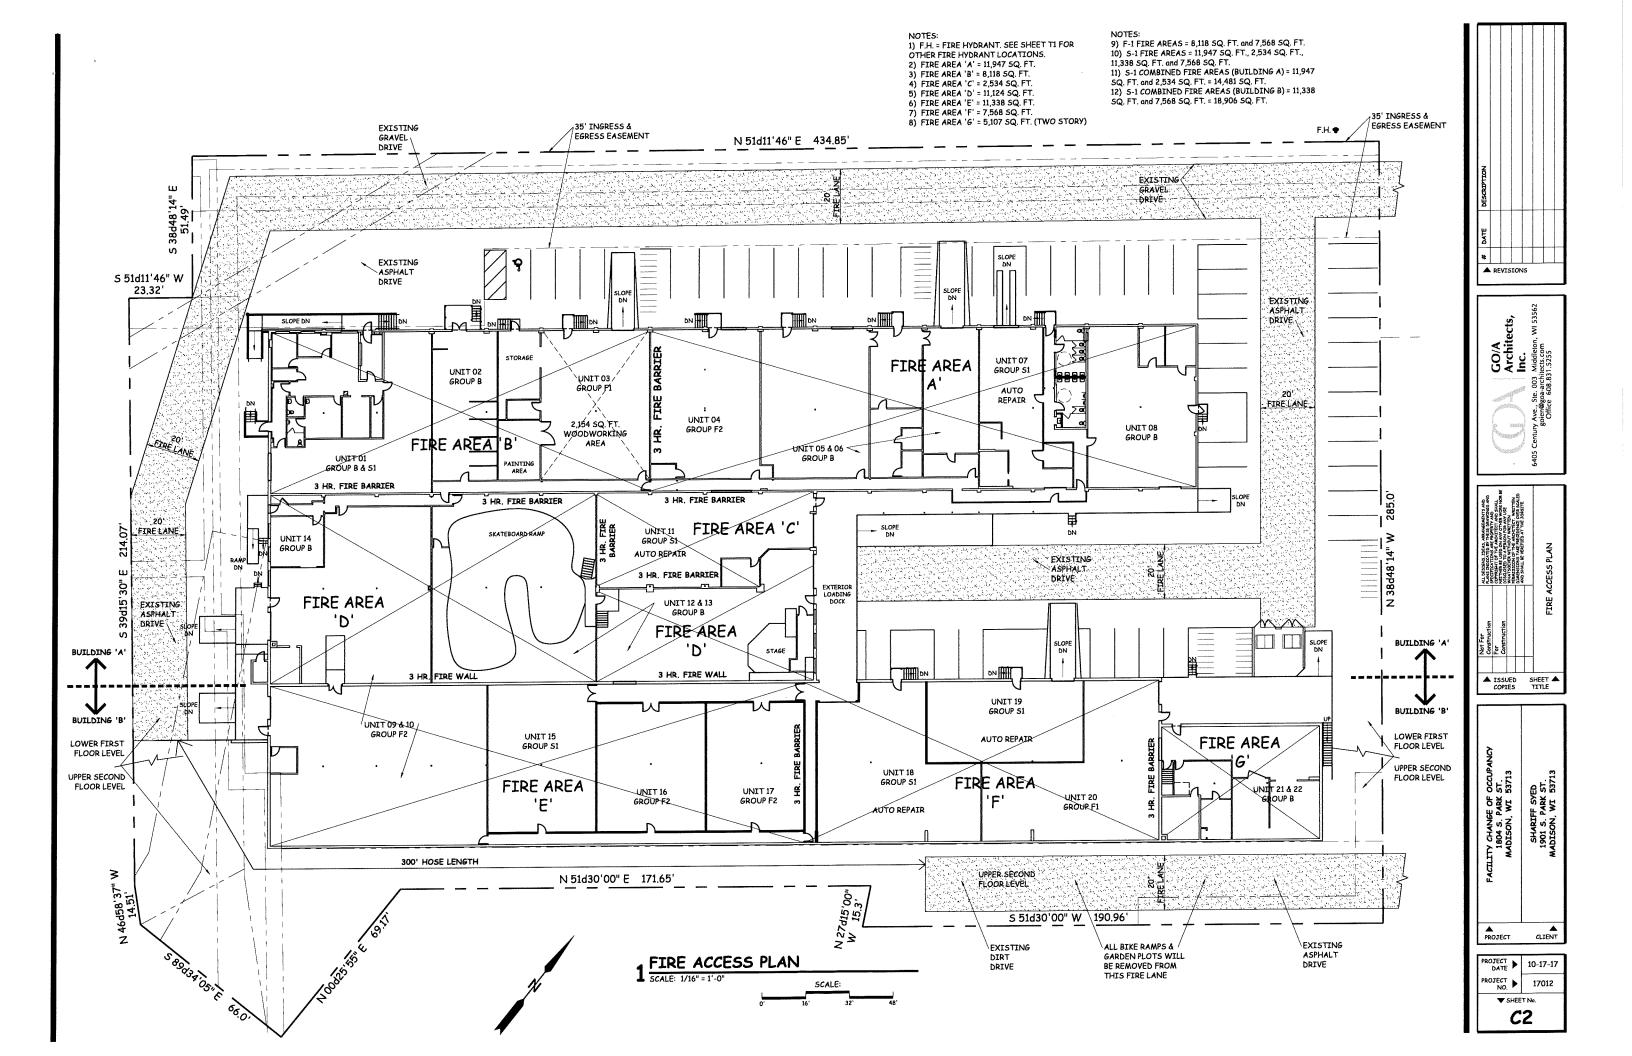


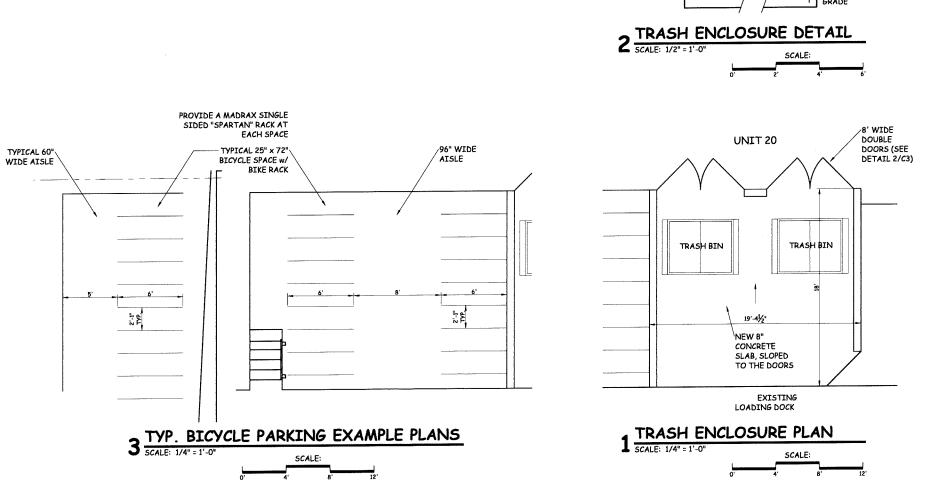

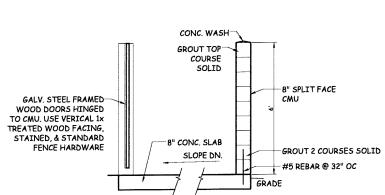

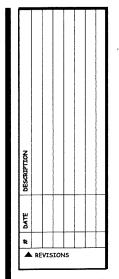


GO/A
Architects,
Inc.
6405 Century Ave., Ste. 003 Middleton, WI 33362
Goldee 608.831,5255

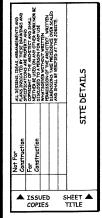

PROJECT 10-17-17
PROJECT 17012

SHEET No.

C3

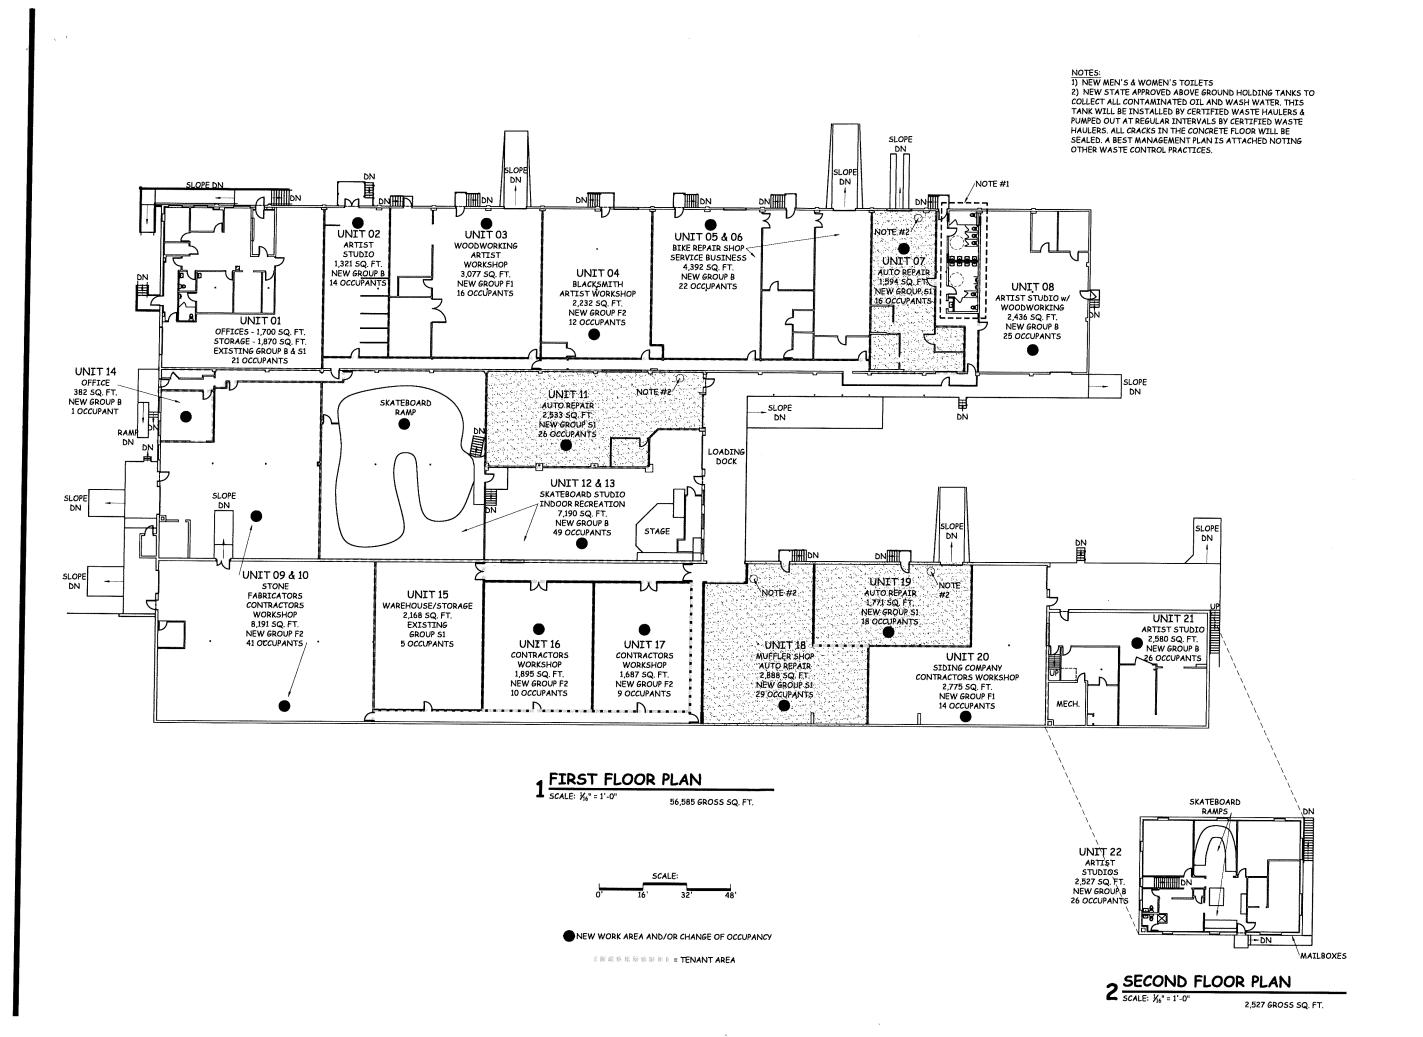



GO/A
Architects,
Inc.
Ste. 003 Middleton, WI 53562
going@asstribects.com
Office 618 823 5162

Not For Authorized House Selection and Selection of Authorized House Selection and Selection of Authorized House Selection of

FACILITY CHANGE OF OCCUPANCY
1804 S. PARK ST.
MADISON, WI 53713
SHARIFF SYED
1901 S. PARK ST.
MADISON, WI 53713

PROJECT ► 10-17-17

PROJECT ► 17012

PROJECT NO. 17012

▼ SHEET No.