

City of Madison

Conditional Use

Location

801 East Washington Avenue

Project Name The Cosmos


Applicant

Otto C. Gebhardt III - Gebhardt Development LLC / Lee Christensen - Gebhardt Development LLC


Existing Use Automobile Parking

Proposed Use Construct up to eight-story commercial/ office building containing 152,925 square feet of floor area, including 40,000 square foot theater/concert hall

Public Hearing Date Plan Commission 23 January 2017

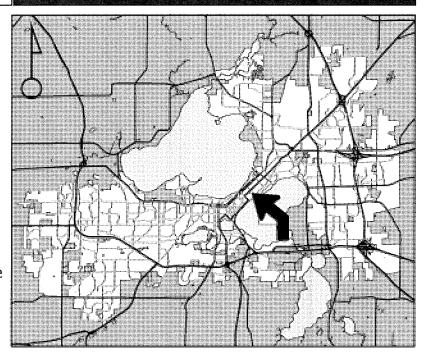

For Questions Contact: Tim Parks at: 261-9632 or tparks@cityofmadison.com or City Planning at 266-4635

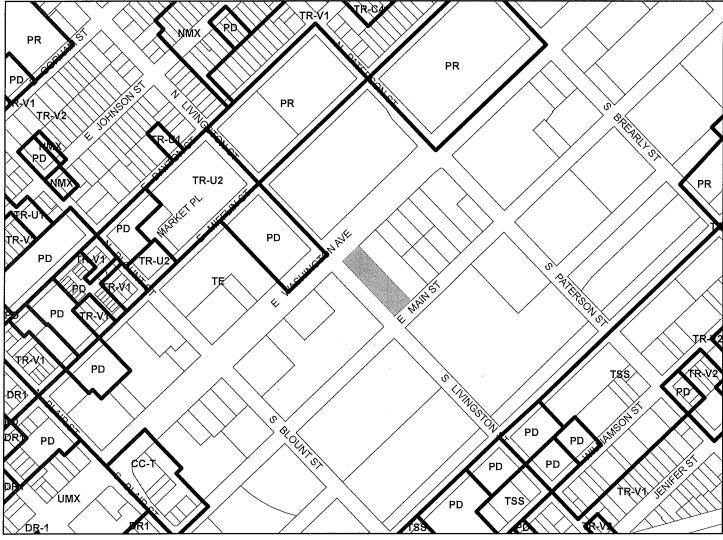

Scale: 1'' = 400'



City of Madison



Date of Aerial Photography : Spring 2016



Development Schedule: Commencement

LAND USE APPLICATION

FOR OFFICE USE ONLY: 215 Martin Luther King Jr. Blvd; Room LL-100 ____ Receipt No. __ Amt. Paid PO Box 2985; Madison, Wisconsin 53701-2985 Date Received _____ Phone: 608.266.4635 | Facsimile: 608.267.8739 Received By ____ Parcel No. ____ • All Land Use Applications should be filed with the Zoning Aldermanic District Administrator at the above address. Zoning District ___ • The following information is required for all applications for Plan Special Requirements ___ Commission review except subdivisions or land divisions, which should be filed using the Subdivision Application. Review Required By: Urban Design Commission Plan Commission • This form may also be completed online at: Common Council Other: www.cityofmadison.com/developmentcenter/landdevelopment Form Effective: February 21, 2013 801 East Washington Avenue 1. Project Address: Project Title (if any): The Cosmos 2. This is an application for (Check all that apply to your Land Use Application): Zoning Map Amendment from _____ ☐ Major Amendment to Approved PD-SIP Zoning Review of Alteration to Planned Development (By Plan Commission) Conditional Use, or Major Alteration to an Approved Conditional Use ☐ Demolition Permit Other Requests: ___ 3. Applicant, Agent & Property Owner Information: Company: Gebhardt Development LLC Otto C. Gebhardt III Applicant Name: 222 North Street Madison, WI 53704 _____ City/State: Street Address: Zip: 608, 245-0753 gebhardtdevelopment@tds.net Telephone: () Email: Company: Gebhardt Development LLC Project Contact Person: Lee Christensen Madison, WI 53704 222 North Street City/State: Street Address: Zip: Telephone: (608) 209-7568 lee@gebhardtdevelopment.com Fax: Email: Property Owner (if not applicant): City of Madison Madison, WI 53703 126 South Hamilton Street Street Address: City/State: 4. Project Information: Mixed-use development with office, retail Provide a brief description of the project and all proposed uses of the site: and entertainment venue. January 2018 January 2017

Completion

5. Required Submittal Information

All Land Use applications are required to include the following:

- Project Plans including:*
 - Site Plans (<u>fully dimensioned</u> plans depicting project details including all lot lines and property setbacks to buildings; demolished/proposed/altered buildings; parking stalls, driveways, sidewalks, location of existing/proposed signage; HVAC/Utility location and screening details; useable open space; and other physical improvements on a property)
 - Grading and Utility Plans (existing and proposed)
 - Landscape Plan (including planting schedule depicting species name and planting size)
 - Building Elevation Drawings (fully dimensioned drawings for all building sides, labeling primary exterior materials)
 - Floor Plans (fully dimensioned plans including interior wall and room location)

Provide collated project plan sets as follows:

- Seven (7) copies of a full-sized plan set drawn to a scale of 1 inch = 20 feet (folded or rolled and stapled)
- Twenty Five (25) copies of the plan set reduced to fit onto 11 X 17-inch paper (folded and stapled)
- One (1) copy of the plan set reduced to fit onto 8 ½ X 11-inch paper
- * For projects requiring review by the **Urban Design Commission**, provide **Fourteen (14) additional 11x17 copies** of the plan set. In addition to the above information, <u>all</u> plan sets should also include: 1) Colored elevation drawings with shadow lines and a list of exterior building materials/colors; 2) Existing/proposed lighting with photometric plan & fixture cutsheet; and 3) Contextual site plan information including photographs and layout of adjacent buildings and structures. The applicant shall bring samples of exterior building materials and color scheme to the Urban Design Commission meeting.

V	Letter of Intent: Provide one (1) Copy	per Plan Set describing this application	in detail including, but not limited to:
	 Project Team Existing Conditions Project Schedule Proposed Uses (and ft² of each) Hours of Operation 	 Building Square Footage Number of Dwelling Units Auto and Bike Parking Stalls Lot Coverage & Usable Open Space Calculations 	 Value of Land Estimated Project Cost Number of Construction & Full-Time Equivalent Jobs Created Public Subsidy Requested
~	Filing Fee: Refer to the Land Use Applic	cation Instructions & Fee Schedule. Mak	e checks payable to: City Treasurer.
V			omitted in hard copy with their application as eir application materials, or by e-mail to
	Additional Information may be require	ed, depending on application. Refer to t	the <u>Supplemental Submittal Requirements.</u>
6.	Applicant Declarations		
V	neighborhood and business associated alderperson, neighborhood association		
	→ If a waiver has been granted to th	is requirement, please attach any corr	espondence to this effect to this form.

Pre-application Meeting with Staff: <u>Prior</u> to preparation of this application, the applicant is required to discuss the proposed development and review process with Zoning and Planning Division staff; note staff persons and date.

____ Date: 08-10-16 Zoning Staff: Matt Tucker

The applicant attests that this form is accurately completed and all required materials are submitted:

Name of Applicant Otto C. Gebhardt III Relationship to Property: Applicant

Authorizing Signature of Property Owner

Planning Staff: Tim Parks

Date December 21, 2016

10

HUSCHBLACKWELL

Angela Black Direct: (608) 258-7128 angela.black@huschblackwell.com

Jeffrey L. Vercauteren Direct: (608) 234-6052 jeff.vercauteren@huschblackwell.com

December 21, 2016

VIA E-MAIL AND HAND DELIVERY

Urban Design Commission
City of Madison
126 South Hamilton Street
Madison, WI 53703
udcapplications@cityofmadison.com

Plan Commission City of Madison 126 South Hamilton Street Madison, WI 53703 pcapplications@cityofmadison.com

Re: Resubmittal – Land Use and Urban Design Commission Applications The Cosmos Project – 801 East Washington Avenue

Dear Commission Members:

Please find enclosed a resubmittal of the Land Use and Urban Design Commission applications for the eight-story version of The Cosmos Project at 801 East Washington Avenue. The Urban Design Commission previously reviewed and granted Initial Approval for the four-story version of the project on November 30, 2016. The Plan Commission reviewed and approved the four-story version on December 12, 2016.

Based on the comments received from the Urban Design Commission and the Plan Commission, this resubmittal addresses the following:

- Height. The proposal complies with the UDD-8 standard for two bonus stories facing East Main Street. The Cosmos portion of the shared plaza includes 7,185 square feet of on-site plaza space providing seating and landscaping, allowing for up to 35,925 square feet of additional floor area. The revised plans include 20,100 square feet of bonus story floor area.
- Lot Coverage. The revised plans demonstrate compliance with the maximum 85% lot coverage requirement through the utilization of additional green roof features including an expanded landscaped area on the fourth floor terrace and additional landscaping on the corner of East Main Street.

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December 21, 2016 Page 2

- Bike Parking. The revised plans include a total of 226 bike stalls or spaces, exceeding the 181 required stalls, including 58 stalls on site in traditional racks, 50 vertical stalls along a screening wall adjacent to the shared plaza area, 60 interior spaces on the fourth floor available to all tenants, 50 shared stalls in the plaza area, and 8 dispersed stalls in the city right-of-way.
- Loading Docks. The revised plans include three loading berths, including two
 loading docks facing East Main Street with capacity to park two semi-trucks for
 concert venue events (and available for use by all tenants) and one dock facing
 East Livingston Street for use by retail and office tenants.
- Loading Area Screening. The loading areas include improved screening and vegetative cover to be compatible with the adjacent plaza area and to integrate an efficient vertical bike parking area.
- Cantilever Screening. The revised plans include screening below the fourthfloor cantilever area provided by a metal grill and landscape features.
- Sustainability. The building includes a large green roof area on the fourth floor.
 The roof will be constructed with wiring pathways to potentially accommodate
 solar PV panels in the future. The project is seeking LEED certification and is
 working to maximize the number of LEED-equivalent features. The plans include
 window shading on south-facing façades to assist with temperature control and
 reduce energy use.

We look forward to presenting these materials to you at your upcoming meetings.

Very truly yours,

Angela Black

Jeffrey L. Vercauteren

Ingola Black

AB/JLV/jmd Enclosures



December 21, 2016

Via Email and Hand Delivery

Plan Commission and Urban Design Commission City of Madison 126 South Hamilton Street Madison, WI 53703

Re:

Letter of Intent for Proposed Development The Cosmos Project – 801 East Washington Avenue

Dear Commission Members:

Gebhardt Development, LLC is pleased to present the enclosed materials as part of a Land Use and Design Review submittal to the Plan Commission and the Urban Design Commission for the third project in Gebhardt's redevelopment of the former Don Miller car dealership parcels on East Washington Avenue, including The Constellation on the 700 North Block and The Galaxie on the 800 North Block.

This letter of intent is for a resubmittal of the Land Use and Urban Design Commission applications for the eight-story version of The Cosmos Project at 801 East Washington Avenue. The Urban Design Commission previously reviewed and granted Initial Approval for the four-story version of the project on November 30, 2016. The Plan Commission reviewed and approved the four-story version on December 12, 2016.

Project Summary

The Cosmos Project includes 4 stories / approximately 43,400 square feet of retail and office space at the corner of East Washington Avenue and South Livingston Street, 2 stories (with a total height of approximately 32 feet) / approximately 9,500 square feet of retail and office space at the corner of East Main Street and South Livingston Street, 2 stories / approximately 40,025 square feet for an entertainment venue on South Livingston Street, and an additional 4 stories / approximately 60,000 square feet of office space above the entertainment venue.

The entertainment venue will be owned and operated by Frank Productions and will include a capacity of up to 2,500 people for live music and other types of entertainment. The Cosmos and The Spark will share a landscaped mid-block plaza, and The Cosmos will also include rooftop outdoor landscaped areas for use by tenants and guests. Gebhardt is seeking conditional use

approval for general retail, food and related goods sales, restaurant, tavern, outdoor eating/drinking areas, concert hall, and height exceeding district standards for The Cosmos.

Existing Site Conditions

This site currently includes 2.01 acres of vacant surface parking area bounded by East Washington Avenue, South Livingston Street and East Main Street extending 264.74 feet to the northeast. The internal site boundaries will be reorganized via a certified survey map (CSM) to divide the site into two parcels, one owned by Gebhardt Development and one owned by American Family Insurance. On the East Washington Capitol Gateway Corridor Plan, the site is shown as part of Block 12, sub blocks A and B. This site is currently zoned TE Traditional Employment. With conditional use approval under this zoning designation, The Cosmos will comply with current zoning.

Access to the site is provided by East Washington Avenue, South Livingston Street and East Main Street. The site is also served by Madison Metro routes 6, 14, 15, 25, 27, 29, 37, 56 and 57.

Project Layout

The project is located within Urban Design District No. 8 along the East Washington Capitol Gateway Corridor in Sub Blocks 12a & b. The project as currently designed meets established requirements or permissible variations for building height, façade height, minimum/maximum setback, and minimum stepback.

The South Livingston Street setback varies between 5 and 15 feet (the District standard is 0-10 feet, but the Commission can allow for a greater setback to allow for the articulation of long building facades or the development of additional usable open public spaces). The Livingston Street setbacks are proposed to allow for articulation of the long building façade, allow for the development of additional usable open space and accommodate an existing utility easement.

The building is two stories along East Main Street (3-5 stories are required unless greater floor heights are provided). The proposed minimum 18' ground floor and minimum 14' second floor height exceed average required story heights and have an overall height meeting the three-story height requirements.

Proposed trash areas are enclosed or screened and bike parking is shown dispersed through the site. Selections related to exterior materials, landscaping, lighting and other elements are intended to comply with design district guidelines. The project design is intended to be consistent with design district guidelines, as provided below.

Project Objectives and Benefits

The Project will benefit the City of Madison in the following ways:

 Revitalizing the western half of the 800 South Block of East Washington Avenue and providing a catalyst for further redevelopment on the south side of the street.

- Providing additional employment opportunities to the area by activating unused commercial property and adding substantial amounts of office, retail and other commercial space to the employment corridor.
- Improving pedestrian access to and circulation around the site by upgrading existing sidewalks and adding landscaping areas.
- Substantially increasing the property tax base on the block by placing currently exempt property on the tax rolls and constructing substantial improvements on the property.

Project Data

Location:

801 East Washington Avenue

Building Sq. Ft.:

Approximately 161,750 sq. ft.

Start Construction:

Approximately February 2017

Complete Construction:

Approximately February 2018

Type of Building:

Commercial (retail, restaurant, office and concert venue)

Land Area:

Approximately 1.17 acres (51,123 sq. ft.)

Vehicle Parking:

Approximately 275 vehicle parking spaces to be provided in the parking ramp to be constructed by the City pursuant to a Development Agreement between the City, Gebhardt and

American Family.

Bicycle Parking:

Approximately 226 bicycle spaces distributed throughout the site in traditional racks, vertical racks adjacent to the plaza area, shared racks with The Spark, and an interior bike room. The bicycle parking requirement is further reduced by the availability of public bicycle parking in the new parking ramp, the proximity of the site to a primary transit corridor, and different times of peak use for the concert venue.

Site Access:

East Washington Ave., South Livingston St., East Main St.

Lot Coverage:

43,454 sq. ft. (85.0%)

<u>Usable Open Space:</u>

7,669 sq. ft. (15.0%)

Hours of Operation:

Approximately 10:00 a.m.-10:00 p.m. Monday through Sunday (retail/restaurant) / approximately 7:00 a.m.-6:00 p.m. Monday through Friday (office) / approximately 5:00

p.m.-Midnight (concert venue), subject to variations based on tenant requirements or venue requirements.

Project Financial Information

Value of Land: The land is currently assessed as commercial exempt property.

Estimated Project Cost: Approximately \$12 million

Number of Construction & Full-time Equivalent Jobs on Site: Approximately 200 construction jobs and 200 full-time equivalent office, retail and restaurant jobs.

Public Subsidy Requested: None.

Urban Design District Standards

1. Building Height

- a. The proposed street level facade height of 4 stories/60 feet complies with the District requirements along East Washington Avenue of a minimum/maximum height of 3-5 stories/29-63 feet.
- b. The proposed street level facade height of 2 stories/32 feet complies with the District requirements along East Main Street of a minimum/maximum height of 3-5 stories/29-63 feet.
- c. The proposed building height of 8 stories/116 feet complies with the maximum building height of 12 stories/147 feet along East Washington Avenue and 8 stories/99 feet along East Main Street (with the potential for 2 bonus stories for a total of 10 stories/123 feet).

2. Building Location and Orientation

- a. The Project addresses East Washington Avenue, East Main Street and South Livingston Street with commercial entrances facing these primary streets.
- b. Project entrances adequately connect to public sidewalks.
- c. The primary building entrances will be visually enhanced with features to increase pedestrian interaction with the project.

3. Setback and Stepback

- a. Proposed setbacks of 15 feet along East Washington Avenue and East Main Street are in compliance with District requirements. The proposed setback along South Livingston Street varies between 5-15 feet (the District standard is 0-10 feet, but the Commission can allow for a greater setback to allow for the articulation of long building facades or the development of additional usable open public spaces).
- b. Proposed building stepbacks on East Washington Avenue, East Main Street and South Livingston Street meet the District minimum requirement of 15 feet.

13345684.1

4. Parking and Service Areas; Circulation

- a. Off-street parking for the project will be provided through an agreement with the City for the new city ramp to be constructed directly across from the project on East Main Street and South Livingston Street.
- b. Service entries such as the loading docks for the concert venue are primarily located at the back of the project along East Main Street and will not be visible from the primary building facades along East Washington Avenue, South Livingston Street and the southwest corner of East Main Street.
- c. The entry drive is perpendicular to the respective connecting street.
- d. A loading zone is being provided off-street at the East Main Street driveway. This loading zone does not impede pedestrian movement along East Main Street and will allow trucks to completely park on the project site and not encroach on the sidewalk or terrace.

5. Landscaping and Open Space

- Landscaping along East Washington Avenue, East Main Street and South Livingston Street will contain canopy trees and plantings appropriate for an urban project. Street furniture such as benches, bike racks and trash receptacles will be provided.
- b. The shared plaza with The Spark building will be extensively landscaped to provide a unique experience for occupants and visitors of the two projects.
- c. Rooftop features will be partially landscaped to provide a comfortable and attractive rooftop setting for building occupants.

6. Site Lighting and Furnishings

- a. The Project will have adequate but not excessive pedestrian-level lighting and accent lighting where appropriate, designed to complement the character of the building. Building signage will include appropriate lighting to provide proper direction to building users.
- b. Full cut-off light fixtures will be used to illuminate the site.

7. Building Massing and Articulation

- a. The building mass respects and compliments views identified on the Views and Vista Map in the Downtown Plan.
- b. The Project will have unique, primary design elements on the first floor facing East Washington Avenue, South Livingston Street and East Main Street. Secondary design elements from levels two through four will define the office and concert venue portions of the project. The office tower above the fourth floor will include compatible yet distinct design features.
- c. The ground level of the commercial areas facing East Washington Avenue, South Livingston Street and East Main Street will have increased visual interest by way of storefront glazing, canopies, signage and landscape features.
- d. Rooftop equipment will be screened with parapet walls or vegetation, or located inside the building below the tower element.

8. Materials and Colors

- a. High-quality, durable, low-maintenance exterior building materials will be used including brick, cementitous siding, metal wall panel and/or storefront glazing.
- b. Colors and building textures will be consistent with surrounding properties and are typical for urban projects.

9. Windows and Entrances

- a. No clear existing window and door pattern exists around the Project. The rhythm shown in the commercial and residential uses will be typical and appropriate for an urban project.
- b. At least 40-60% of the ground floor exterior of the commercial spaces will be dedicated to windows. All windows on the ground floor of the Project will be transparent and unobstructed.
- c. The commercial entrances will be uniquely defined and clearly discernible the public from the street.

10. Signage

Signage will be integrated with the Project's architecture. Colors and low-level lighting will be selected to coordinate with the building façade and enhance the character of the Project.

Project Team

Developer:

Gebhardt Development, LLC

222 North Street Madison, WI 53704

Project Representative: Lee Christensen

Phone: (608) 209-7568

Email: lee@gebhardtdevelopment.com

Architect:

Strang, Inc.

6411 Mineral Point Road Madison, WI 53705

Project Representative: Rick Gilbertsen

Phone: (608) 276-9201

Email: rgilbertsen@strang-inc.com

Civil:

Professional Engineering

818 North Meadowbrook Lane

Waunakee, WI 53597

Project Representative: Roxanne Johnson

Phone: (608) 849-9378 Email: rjohnson@pe-wi.com Landscape: VierbicherAssociates

999 Fourier Drive, Suite 201

Madison, WI 53717

Project Representative: Suzanne Vincent

Phone: (608) 826-0532 Email: svin@vierbicher.com

Land Use: Husch Blackwell LLP

33 East Main Street, Suite 300

Madison, WI 53703

Project Representative: Angela Black

Phone: (608) 255-4440

Email: angela.black@huschblackwell.com

We look forward to presenting these materials to you and seeking your approval of this proposal to revitalize and enhance this portion of the Capitol East District corridor.

Sincerely

Otto C. Gebhardt, III

cc: (all via email)

Marsha Rummel, District 6 Alderperson

Natalie Erdman, Director of Planning, Community and Economic Development

Heather Stouder, Planning Division Director


Tim Parks, Planning Division Al Martin, Planning Division

Matt Tucker, Zoning Administrator





STRANG, INC. 6411 MINERAL POINT ROAD MADISON, WI 53705-4395

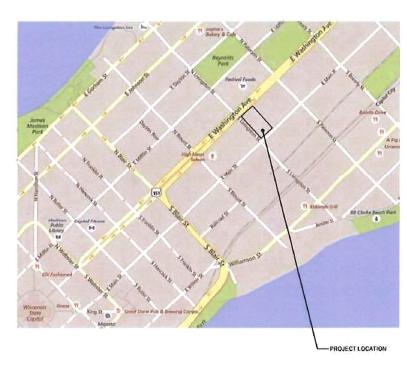

THE COSMOS PROJECT

 COPYRIGHT STRANG, INC.
 2016

 DATE
 12-21-2016

 PROJECT NO.
 2016090

 PROJECT TITLE

GEBHARDT DEVELOPMENT -THE COSMOS PROJECT

E. WASHINGTON AVENUE MADISON, WISCONSIN 53703









EESE STEVEN FIELD




GALAXIE DEVELOPMENT 14 STORIES







SITE PHOTOS

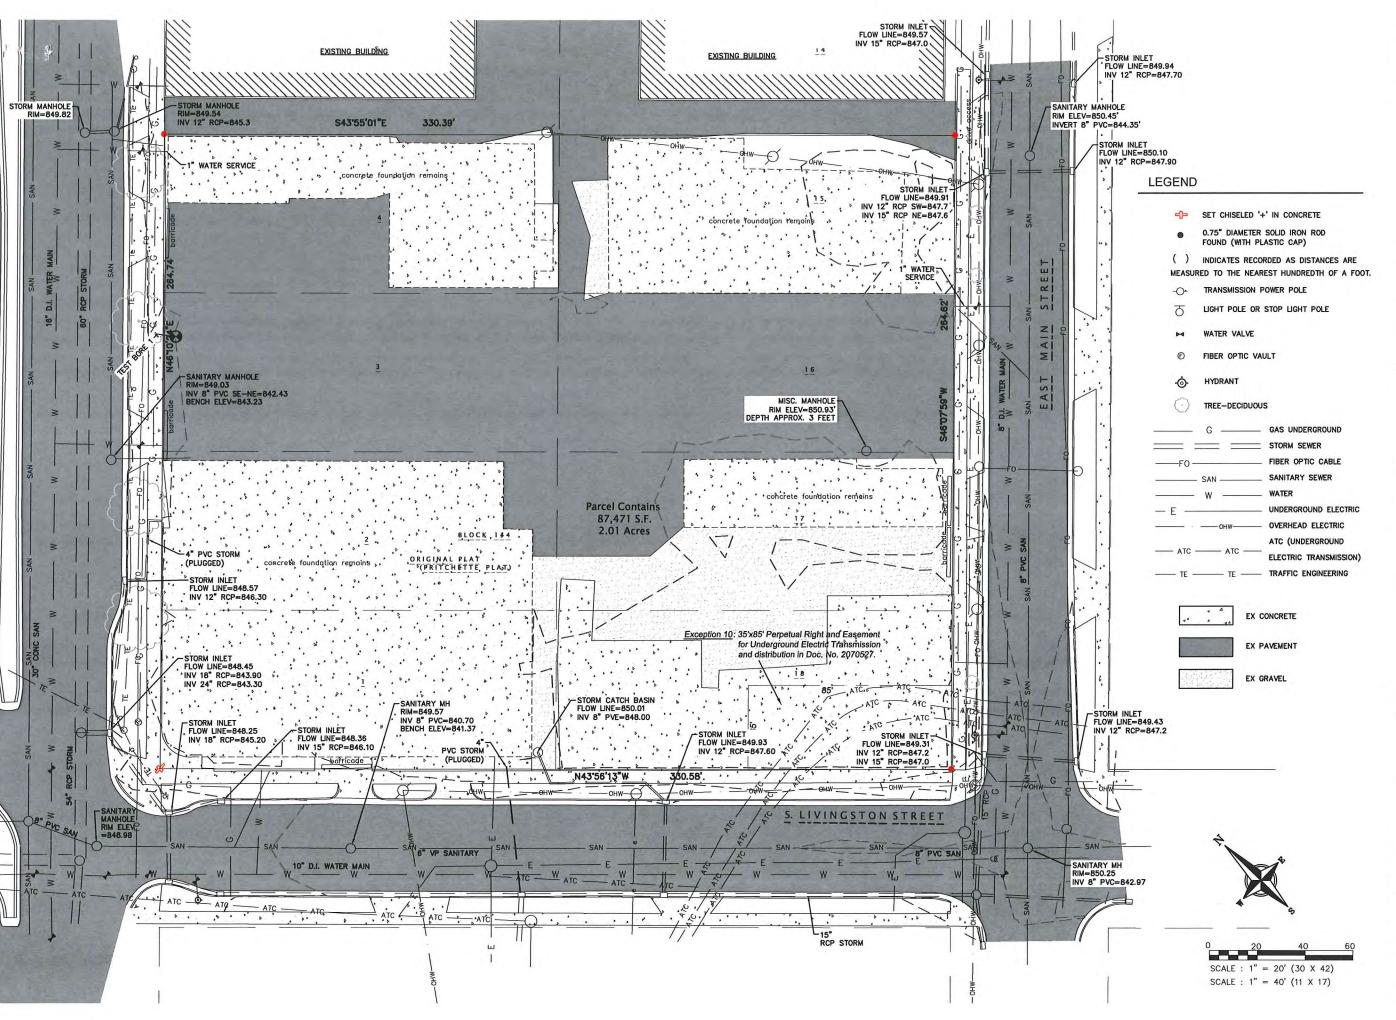



eppstein uhen : architects

milwaukee 33.3 East Chicago Street
Milwaukee, Wisconsin 53202
telephone 414 271 5300
madison
30.9 West Johnson Street 502
Madison, Wisconsin 53703
telephone 608, 442 5350



6411 Mineral Point Road Madison, WI 53705 (608) 276 - 9200



330 West Lakeside Street Madison, WI 53715 608 . 358 . 6344



818 N Meadowbrook Ln Waunakee, WI 53597 (608) 849-9378

PROJECT INFORMATION

COSMOS -THE SPARK PROJECTS

800 E WASHINGTON AVE MADISON. WI





ISSUANCE AND REVISIONS

UDC Submittal (Revised)

DATE DESCRIPTION

SHEET INFORMATION

PROGRESS DOCUMENTS NOT FOR CONSTRUCTION These documents reflect progress and innert and may be stabled to chance including additional detail. These

be subject to change, including additional data? These are not final construction documents and should not be used for final bidding or construction-related purposes.

 PROJECT MANAGER
 RJ


 PROJECT NUMBER
 1249

 DATE
 12/21/16

EXISTING

CONDITIONS

C100

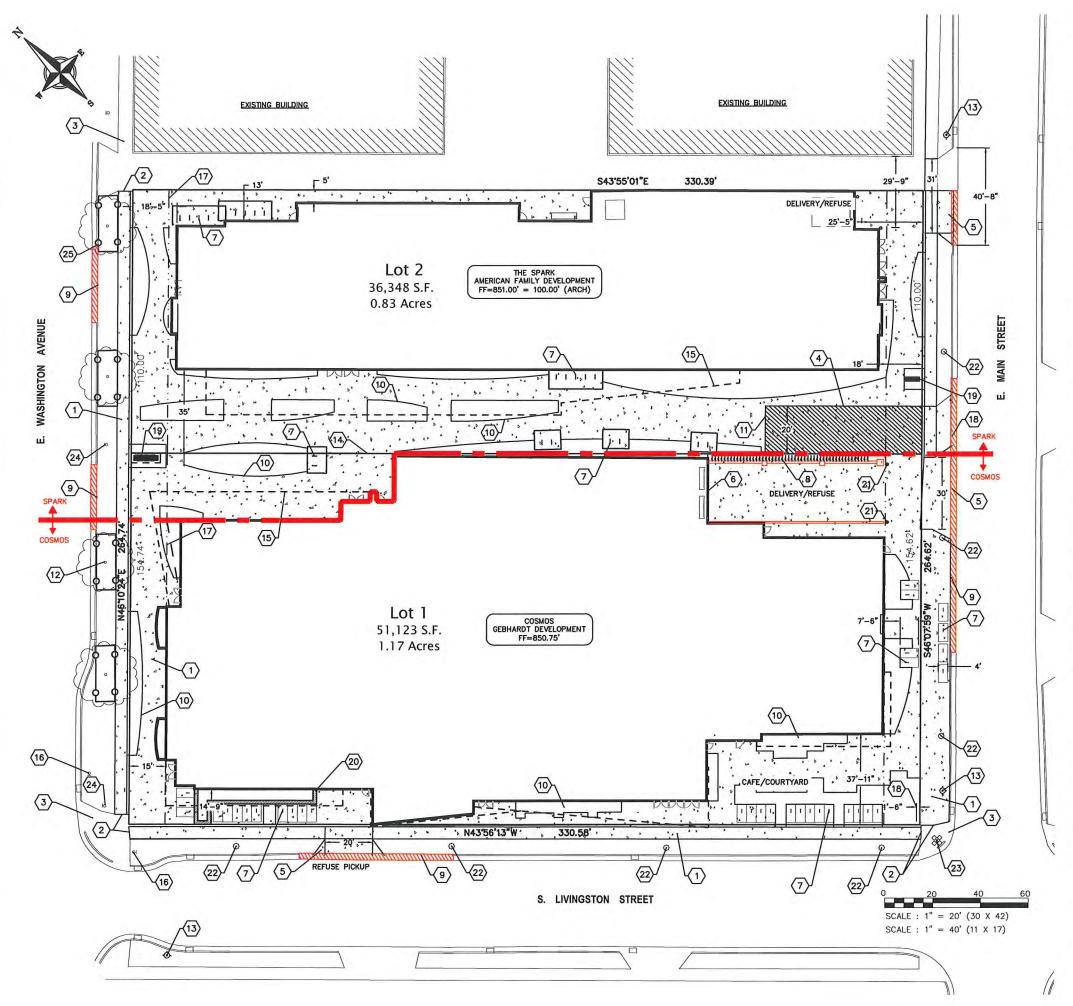

PLAN KEY

- 1) CONCRETE SIDEWALK, TYP.
- 2 MATCH EXISTING SIDEWALK, TYP.
- 3 EXISTING SIDEWALK TO REMAIN, TYP.
- 4 SIDEWALK TO BE 7" THICK IN FIRELANE SECTION
- 5 NEW DRIVEWAY APPROACH SHALL BE IN ACCORDANCE WITH CITY STANDARDS
- (6) LOADING DOCK
- 7 BICYCLE RACK (58 TOTAL STALLS), TYP.
- 8 VERTICAL BICYCLE RACK (50 TOTAL STALLS), TYP.
- EXISTING DRIVEWAY TO BE ABANDONED 9 IN ACCORDANCE WITH CITY STANDARDS W/ CURB REPLACED & TERRACE RESTORED
- LANDSCAPE AREA, TYP.
 SEE LANDSCAPE PLANS
- (11) FIRE LANE
- (12) EX TREE, TYP.
- (13) EXISTING FIRE HYDRANT
- 14) PROPOSED LOT LINE
- (15) CANOPY/UPPER FLOOR OVERHANG, TYP.
- (16) EXISTING STOP LIGHT
- (17) 15' BUILDING SETBACK
- ROLL CURB TO BE PROVIDED FOR FIRE 18 LANE ENTRANCE
- (19) MONUMENT SIGN
- LANDSCAPE PLANTER, SEE LANDSCAPE 20 PLAN
- 21 BOLLARD
- 22 PEDESTRIAN LIGHT (10' HIGH POLE)
- 23 STREET LIGHT (30' HIGH POLE)
- 24 EXISTING STREET LIGHT
- (25) TREE PROTECTION, TYP.

PAVEMENT KEY

FIRE LANE

SITE INFORMATION

SITE ADDRESS: 800 EAST WASHINGTON AVENUE

SITE ACREAGE TOTAL:

LOT 1: 51,123 SQ. FT. (1.17 ACRES) LOT 2: 36,348 SQ. FT. (0.83 ACRES)

LOT COVERAGE:

LOT 1: 43,454 SQ. FT. (85% IMPERVIOUS, INCLUDES VEGETATED ROOF)
LOT 2: 31,822 SQ. FT. (88% IMPERVIOUS)

NUMBER OF BIKE PARKING STALLS: LOT 1: 226 STALLS

(58 TRADITIONAL, 50 VERTICAL, 60 INTERIOR, 8 IN RIGHT-OF-WAY, & 50 SHARED IN PLAZA AREA)



eppstein uhen : architects

309 West Johnson Street, Suite 202 Madison, Wisconsin 53703 telephone 608 442 5350



6411 Mineral Point Road Madison, WI 53705 (608) 276 - 9200



330 West Lakeside Street Madison, WI 53715 608 , 358 , 6344



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PROJECT INFORMATION

COSMOS -THE SPARK **PROJECTS**

800 E WASHINGTON AVE MADISON, WI





ISSUANCE AND REVISIONS

UDC Submittal (Revised)

DATE DESCRIPTION


SHEET INFORMATION

PROGRESS DOCUMENTS NOT FOR CONSTRUCTION

PROJECT MANAGER PROJECT NUMBER 1249

DATE 12/21/16

SITE PLAN

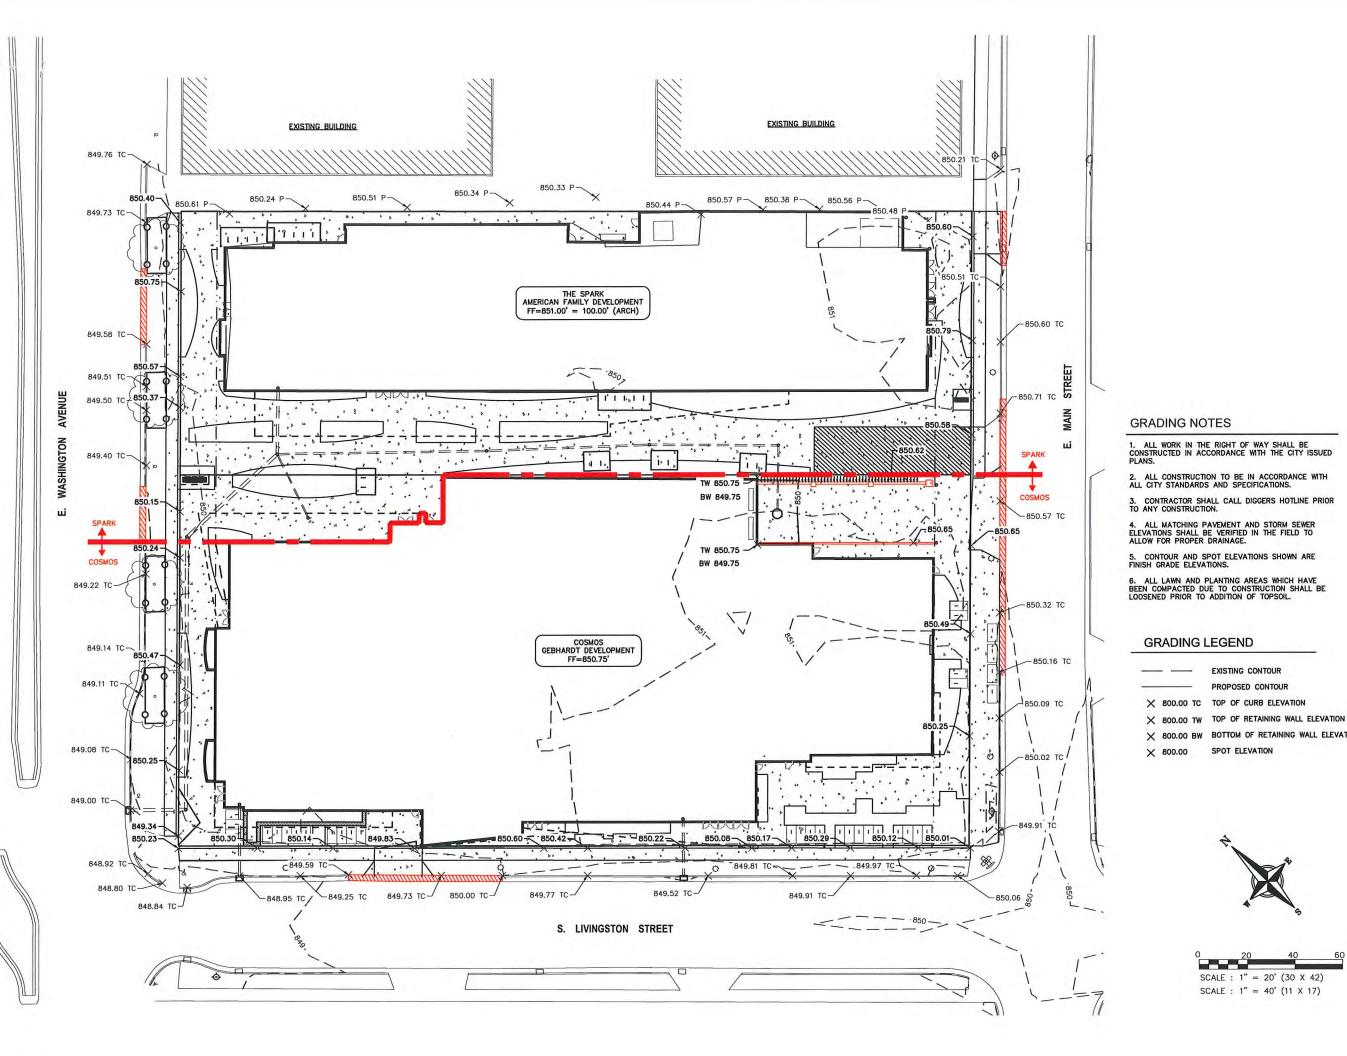



eppstein uhen : architects

milwaukee 3.3.3 East Chicago Street Milwaukee, Wisconsin 5300 telephone 414 271 5300 madison 309 West Johnson Street, Suite 202 Madison, Wisconsin 5.3703 telephone 60, 442 5390



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PROJECT INFORMATION

COSMOS -THE SPARK **PROJECTS**

800 E WASHINGTON AVE MADISON, WI





ISSUANCE AND REVISIONS

EXISTING CONTOUR

SPOT ELEVATION

SCALE: 1'' = 20' (30 X 42)

SCALE : $1" = 40' (11 \times 17)$

PROPOSED CONTOUR

BOTTOM OF RETAINING WALL ELEVATION

UDC Submittal (Revised)

DATE DESCRIPTION

SHEET INFORMATION


PROGRESS DOCUMENTS NOT FOR CONSTRUCTION

PROJECT MANAGER

PROJECT NUMBER 1249 12/21/16 DATE

GRADING PLAN

C300

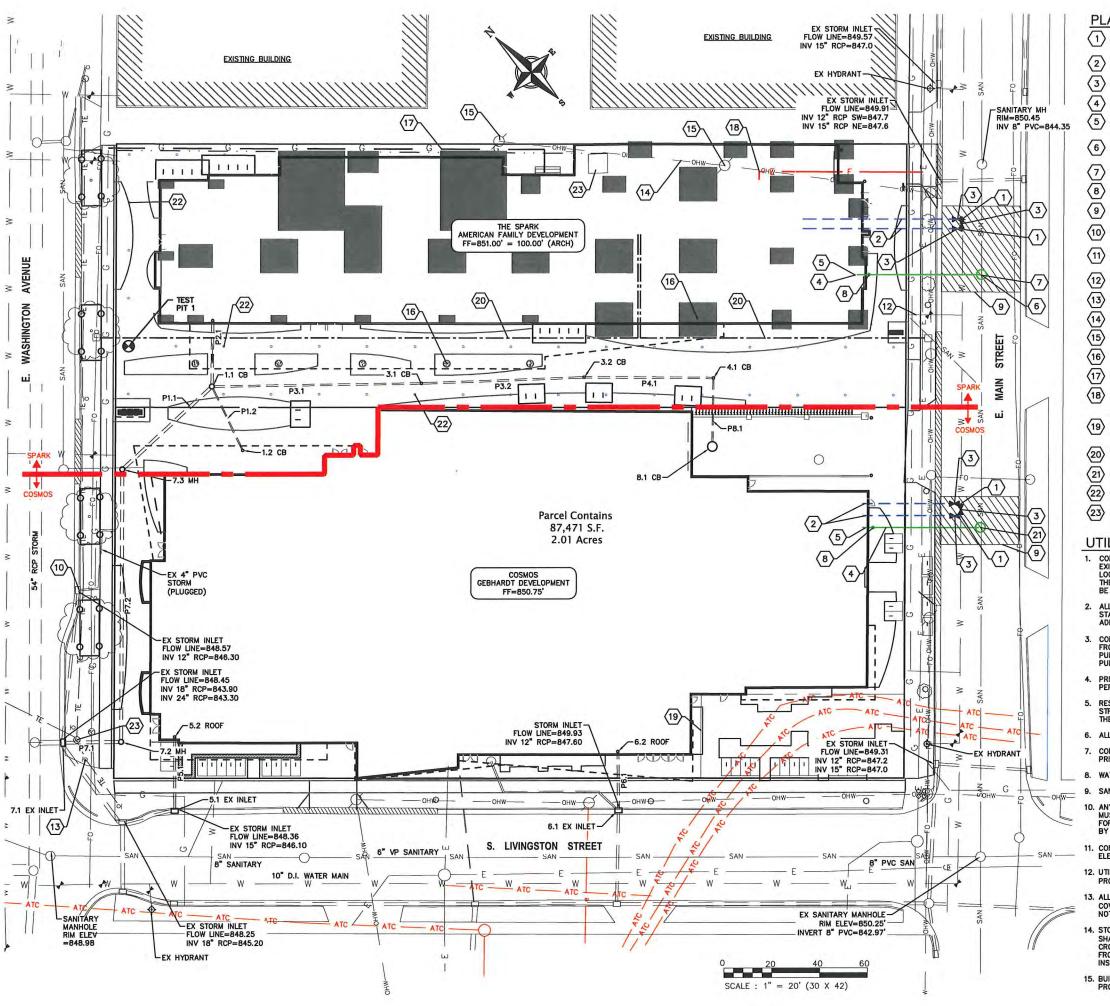

PLAN KEY

- 1) CONNECT TO EXISTING WATER MAIN WITH 8"X8"X8" CUT-IN TEE. COORDINATE INSTALLATION WITH MADISON WATER UTILITY
- 2 8" WATER SERVICE
- 3 8" VALVE
- 4 8" SANITARY LATERAL @ 0.52% MIN. SLOPE
- (5) 8" SANITARY INV=844.50". EXTEND 5 FEET INTO BUILDING
- 6 SANITARY MANHOLE PER CITY REQUIREMENTS, RIM=850.45,
- (7) RAINWATER HOLDING TANK
- (8) SEE PLUMBING PLANS FOR CLEAN OUT LOCATION
- 9 UTILITY PATCH PER CITY REQUIREMENTS
- $\langle \overline{10} \rangle$ connect to existing storm sewer inlet per city standards
- CONNECT TO ROOF DRAIN. COORDINATE WORK WITH PLUMBING CONTRACTOR.
- (12) EXISTING 1" WATER SERVICE TO BE ABANDONED
- (13) EXISTING LIGHT POLE
- (14) EXISTING OVERHEAD ELECTRICAL TO BE RELOCATED
- (15) EXISTING POWER POLE TO BE REMOVED
- (16) FOOTING CAP OR FOUNDATIONS
- (17) GAS SERVICE, COORDINATE LOCATION WITH MG&E
- (18) ELECTRIC SERVICE, COORDINATE LOCATION WITH MG&E
- EXCEPTION 10: 35'X85' PERPETUAL RIGHT AND EASEMENT FOR UNDERGROUND ELECTRIC TRANSMISSION AND DISTRIBUTION IN DOC. NO. 2020-2027
- (20) TELECOM 4" FIBER/COPPER CONDUIT, COORDINATE LOCATION WITH AT&T
- (21) SANITARY MANHOLE, RIM=850.53, INVERT=843.63
- (22) GEO-EXCHANGE WELL, TYP
- (23) INSTALL STORM UNDER TRAFFIC ENGINEERING VAULT

UTILITY NOTES

- CONTRACTOR SHALL CALL DIGGERS HOTLINE PRIOR TO ANY CONSTRUCTION. ALL EXISTING UTILITIES SHOWN ON THE PLAN ARE APPROXIMATE AND WERE FIELD LOCATED FROM GROUND MARKING OR BASED OFF OF CITY UTILITY RECORDS. THE LOCATIONS ARE SHOWN FOR INFORMATIONAL PURPOSES ONLY AND SHOULD BE FIELD VERIFIED PRIOR TO CONSTRUCTION.
- ALL SITE UTILITY WORK SHALL BE DONE IN ACCORDANCE WITH THE CITY STANDARD SPECIFICATIONS FOR PUBLIC WORKS CONSTRUCTION, LATEST ADDITION.
- 3. CONTRACTOR SHALL OBTAIN ALL NECESSARY PLUGGING/CONNECTION PERMITS FROM THE CITY PRIOR TO ANY UTILITY WORK. CONTRACTOR TO NOTIFY THE PUBLIC WORKS DEPARTMENT A MINIMUM OF 48 HOURS BEFORE CONNECTING TO DEBUT AUTILITIES.
- PRIOR TO CONSTRUCTION, CONTRACTOR SHALL OBTAIN A STREET OPENING PERMIT FOR ANY WORK TO BE DONE WITHIN THE RIGHT-OF-WAY.
- RESTORATION OF PAVEMENT, CURB & GUTTER, AND SIDEWALK WITHIN THE STREET RIGHT OF WAY IS CONSIDERED INCIDENTAL AND SHALL BE INCLUDED IN THE COST OF THE UNDERGROUND IMPROVEMENTS.
- 6. ALL STORM SEWER PIPE TO BE SDR-35 PVC OR SCHEDULE 40 PVC AS NOTED.
- CONTRACTOR SHALL CONFIRM CONNECTION ELEVATION GRADES OF ALL PIPES PRIOR TO BEGINNING CONSTRUCTION.
- 8. WATER MAIN SHALL BE DUCTILE IRON, CLASS 52.
- 9. SANITARY SEWER SERVICES SHALL BE SDR-35 PVC.
- 10. ANY PERSON WHO INSTALLS A NONCONDUCTIVE WATER OR SEWER LATERAL MUST ALSO INSTALL A LOCATION WIRE OR OTHER EQUALLY EFFECTIVE MEANS FOR MARKING THE LOCATION OF THE LATERAL METHOD SHALL BE APPROVED BY THE CITY.
- CONTRACTOR TO COORDINATE NEW, RELOCATED AND/OR ABANDONED GAS, ELECTRIC, TELEPHONE, AND CABLE WITH APPROPRIATE UTILITY COMPANIES.
- 12. UTILITIES SERVING PROPOSED BUILDINGS SHALL BE STUBBED INTO THE PROPOSED BUILDING(S) A MIN. OF 5' AND STAKED.
- 13. ALL WATER MAIN PIPE AND FITTINGS SHALL BE INSTALLED TO A MIN. DEPTH OF COVER OF 6.5'. AFTER REGRADING, EXISTING WATER MAIN PIPE WHICH DOES NOT MEET THIS REQUIREMENT SHALL BE INSULATED.
- 14. STORM SEWERS WHICH CROSS AN ACTIVE SEWER OR WATER MAIN OR LATERAL SHALL HAVE A MINIMUM CLEAR VERTICAL CLEARANCE OF THREE (3) FEET. CROSSINGS WITH LESSER VERTICAL CLEARANCE SHALL BE PROTECTED FROM FROST DAMAGE BY PLACEMENT OF 2-INCH THICK POLYSTYRENE BOARD INSULATION.
- 15. BUILDING PLUMBER SHALL VERIFY SIZE, SLOPE, AND EXACT LOCATION OF PROPOSED SANITARY LATERALS AND WATER SERVICES PRIOR TO INSTALLATION.



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PROJECT INFORMATION

COSMOS -THE SPARK PROJECTS

800 E WASHINGTON AVE MADISON, WI





ISSUANCE AND REVISIONS

UDC Submittal (Revised)

DATE DESCRIPTION

SHEET INFORMATION

PROGRESS DOCUMENTS NOT FOR CONSTRUCTION These documents reflect progress and infect and may have shaded to chance selection and effective and the construction.

be subject to change, including additional detail. These are not final construction documents and should not be used for final bidding or construction-related purposes.

PROJECT MANAGER RJ
PROJECT NUMBER 1249

UTILITY PLAN

C400

12/21/16

		STRU	CTURE TABLE		
STRUCTURE NAME	SIZE	TOP OF CASTING	PIPES IN	PIPES OUT	CASTING
1.1 CB	4' DIA. CB	850.48	P3.1, 8" INV IN =845.46 P2.1, 12" INV IN =844.88 P1.2, 6" INV IN =845.63	P1.1, 15" INV OUT =844.88	NEENAH R-2050
1.2 CB	12" DIA YARD DRAIN	850.57		P1.2, 6" INV OUT =845.92	12" GRATE
2.1 ROOF	CONNECT TO INTERIOR ROOF DRAIN	851.00		P2.1, 12" INV OUT =845.03	
3.1 CB	12" DIA YARD DRAIN	850.26	P3.2, 8" INV IN =845.92	P3.1, 8" INV OUT =845.92	12" GRATE
3.2 CB	12" DIA YARD DRAIN	850.26	P4.1, 8" INV IN =846.27	P3.2, 8" INV OUT =846.27	12" GRATE
4.1 CB	12" DIA YARD DRAIN	850.44	P8.1, 6" INV IN =846.55	P4.1, 8" INV OUT =846.55	12" GRATE
5.1 EX INLET	CONNECT TO EX INLET	847.38	P5.1, 10" INV IN =846.50		
5.2 ROOF	CONNECT TO INTERIOR ROOF DRAIN	850.75		P5.1, 10" INV OUT =846.80	
6.1 EX INLET	CONNECT TO EX INLET	848.58	P6.1, 10" INV IN =847.70		
6.2 ROOF	CONNECT TO INTERIOR ROOF DRAIN	850.75		P6.1, 10" INV OUT =847.82	
7.1 EX INLET	CONNECT TO EX INLET	849.16	P7.1, 15" INV IN =843.90		
7.2 MH	4' DIA. CB	849.87	P7.2, 15" INV IN =844.03	P7.1, 15" INV OUT =844.03	NEENAH R-1550
7.3 MH	4' DIA. CB	850.28	P1.1, 15" INV IN =844.62	P7.2, 15" INV OUT =844.62	NEENAH R-1550

8.1 CB

3' DIA. CB

849.88

NEENAH R-2050

P8.1, 6" INV OUT =846.84

PIPE TABLE						
NAME	SIZE	LENGTH	SLOPE	MATERIAL	START INVERT	END INVERT
P1.1	15"	52'	0.52%	ADS N12	844.88'	844.62'
P1.2	6"	30'	0.98%	ADS N12	845.92'	845.63'
P2.1	12"	28'	0.53%	ADS N12	845.03'	844.88'
P3.1	8"	88'	0.52%	ADS N12	845.92'	845.46'
P3.2	8"	69'	0.52%	ADS N12	846.27'	845.92'
P4.1	8"	54'	0.52%	ADS N12	846.55'	846.27
P5.1	10"	31'	0.98%	ADS N12	846.80'	846.50'
P6.1	10"	25'	0.50%	ADS N12	847.82'	847.70'
P7.1	15"	25'	0.52%	ADS N12	844.03'	843.90'
P7.2	15"	114'	0.52%	ADS N12	844.62'	844.03'
P8.1	6"	29'	1.00%	ADS N12	846.84'	846.55



eppstein uhen : architects

milwaukee 3 3 3 East Chicago Street Milwaukee Wisconsin 5202 telephone 414 271 5300 madison 30 9 West Johnson Speet, Sute 202 Madison Wisconsin 537 03 telephone 608 442 530 3



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PROJECT INFORMATION

COSMOS -THE SPARK PROJECTS

800 E WASHINGTON AVE MADISON, WI





ISSUANCE AND REVISIONS

UDC Submittal (Revised)

DATE DESCRIPTION

SHEET INFORMATION

PROGRESS DOCUMENTS NOT FOR CONSTRUCTION

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PROJECT MANAGER

PROJECT NUMBER


DATE

UTILITY PLAN

C400

1249

12/21/16

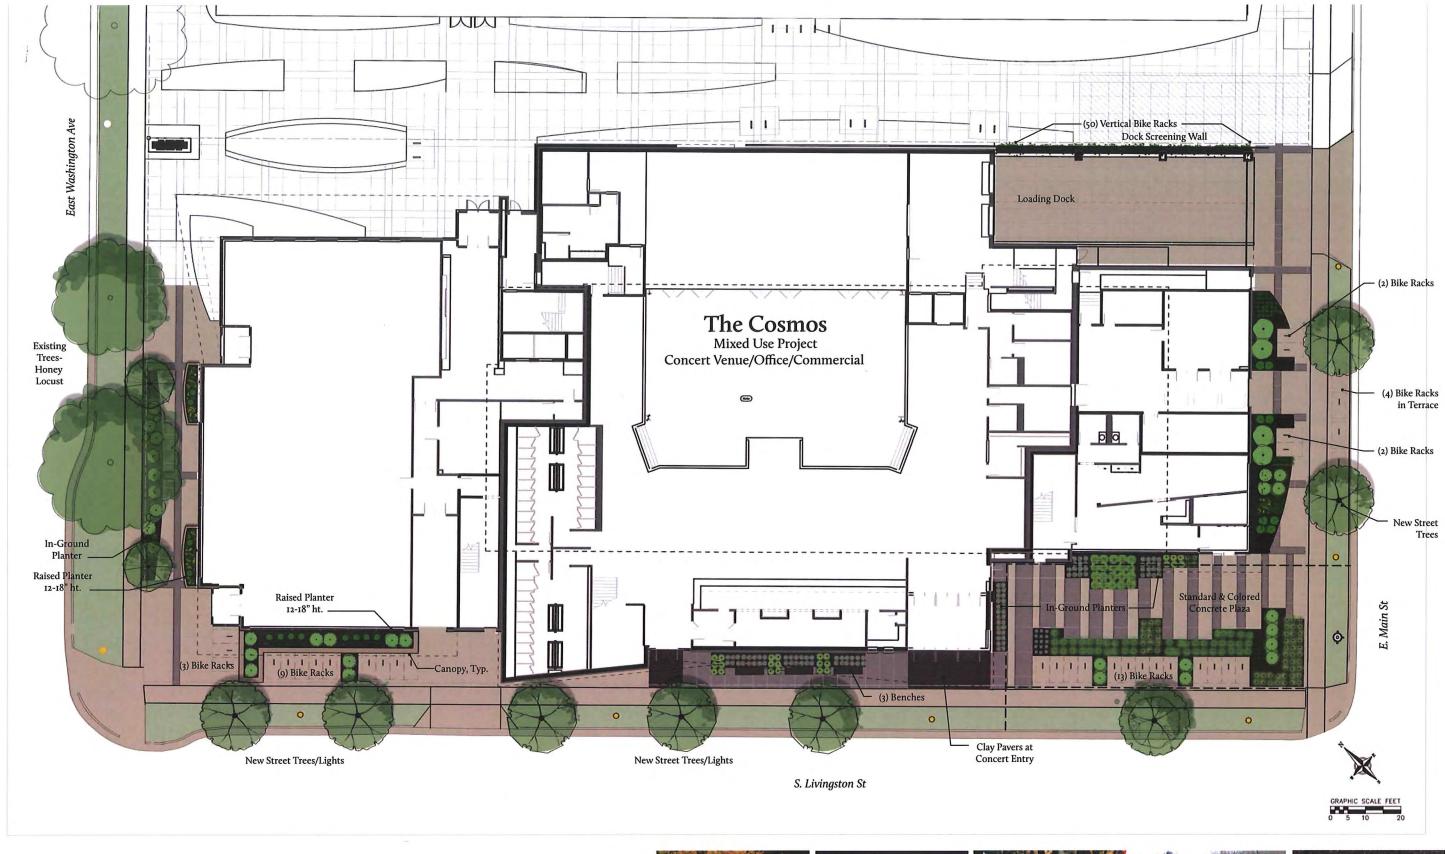

SITE PLAN Urban Design Commission 12.21.2016












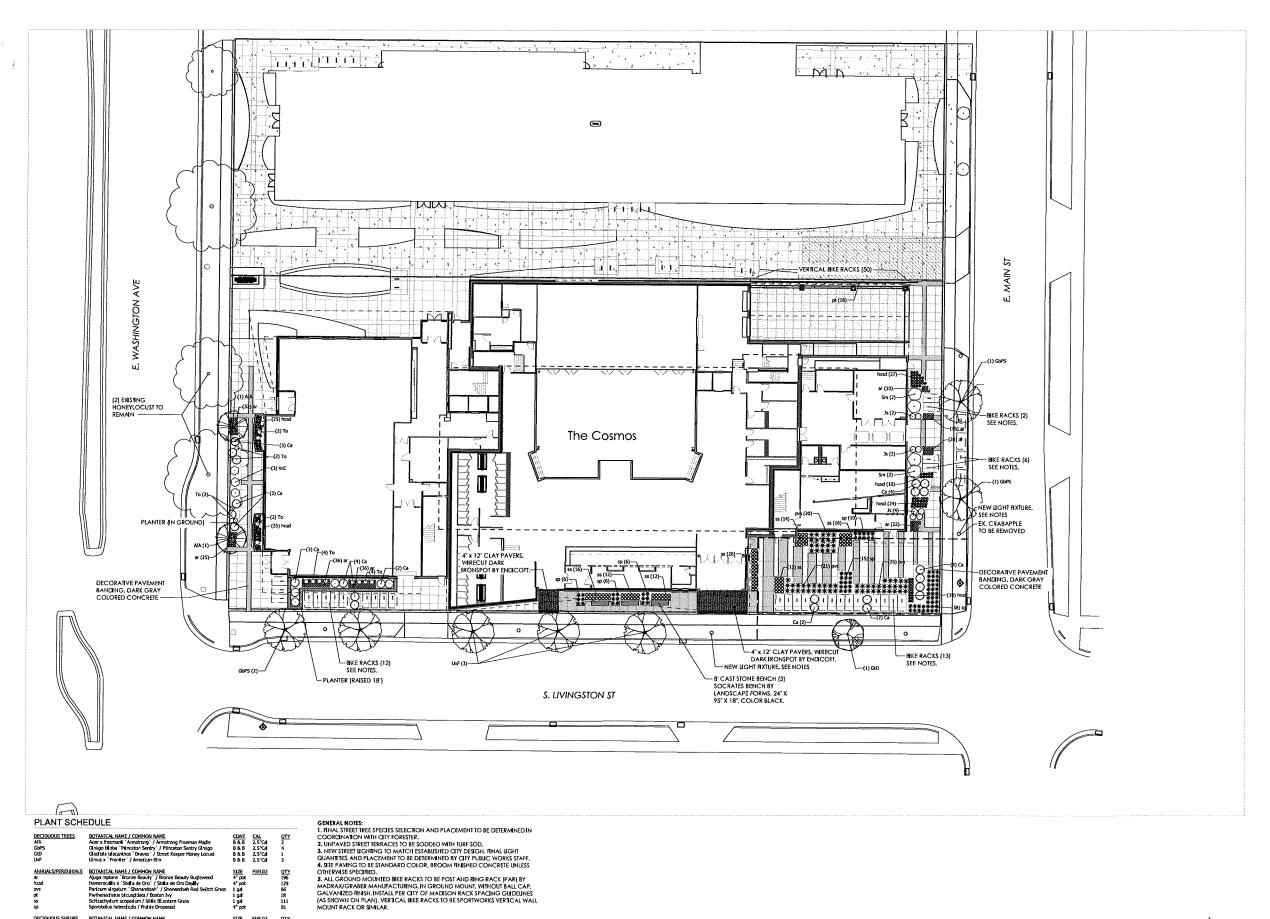

SIZE FIELD2 4* pot 1 gal 1 gal 1 gal 4* pot

FIELD2

<u>SIZE</u> <u>FIELD2</u> <u>QTY</u> 3 gal 8 5 gal 16





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UDC Submittal (Revised)

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PROJECT NO.	201609

PROJECT TITLE

GEBHARDT DEVELOPMENT -THE COSMOS **PROJECT**

801 E. WASHINGTON AVENUE MADISON, WISCONSIN 53703

SHEET NAME LANDSCAPE PLAN



SHEET NO.

L101






STRANG, INC. 6411 MINERAL POINT ROAD MADISON, WI 53705-4395

FIRST FLOOR PLAN

SCALE: 1" = 40' 0' 10' 20' 40'

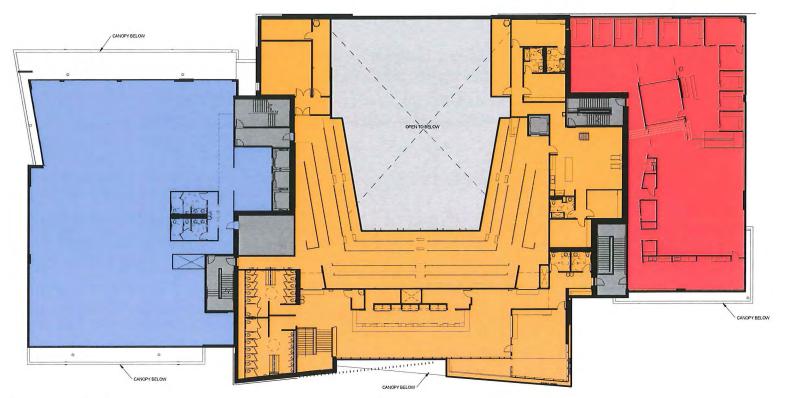

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PROJECT TITLE

LEGEND

RETAIL

OFFICE

MUSIC VENUE


SHARED SPACES (EXIT STAIRS, MECHANICAL SPACES) GEBHARDT DEVELOPMENT -THE COSMOS PROJECT

801 E. WASHINGTON AVENUE MADISON, WISCONSIN 53703

SHEET NAME FLOOR PLANS

SHEET NO.


A201

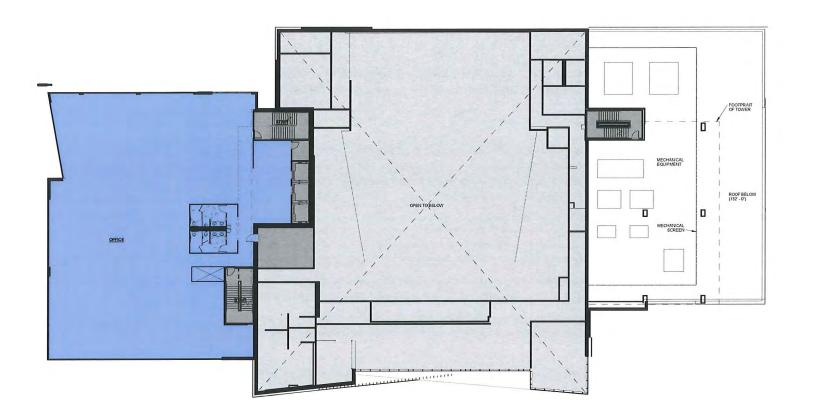



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THIRD FLOOR PLAN
SCALE: 1" = 40' 0'

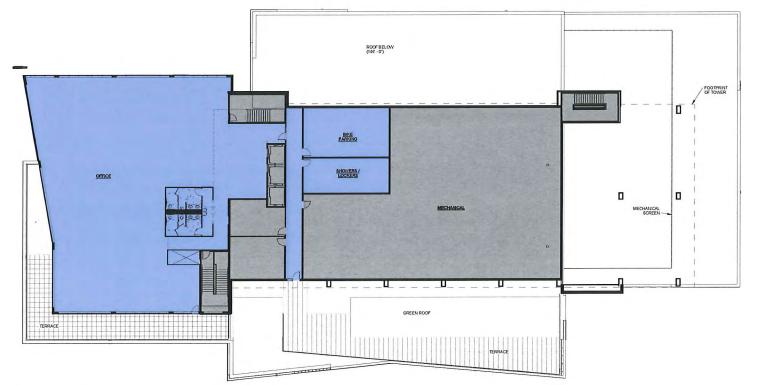

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SHEET NAME FLOOR PLANS

SHEET NO.

LEGEND

RETAIL


OFFICE

MUSIC VENUE

A202

FOURTH FLOOR PLAN
SCALE: 1" = 40' 0' 10'

SHARED SPACES (EXIT STAIRS, MECHANICAL SPACES)

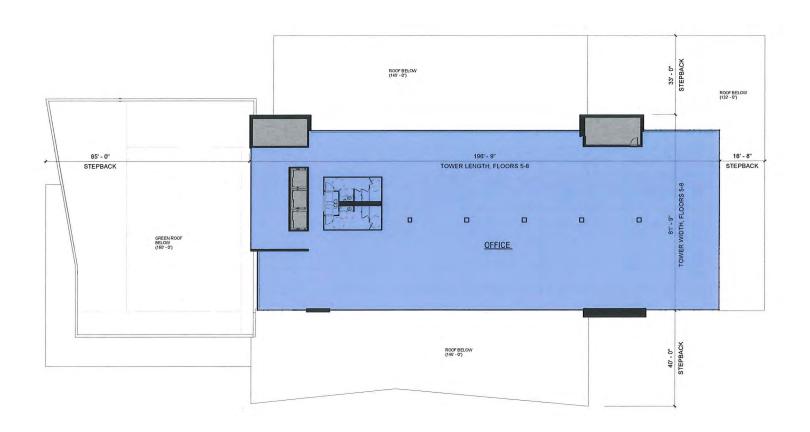



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5, 6, 7



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SHEET NAME

LEGEND

RETAIL

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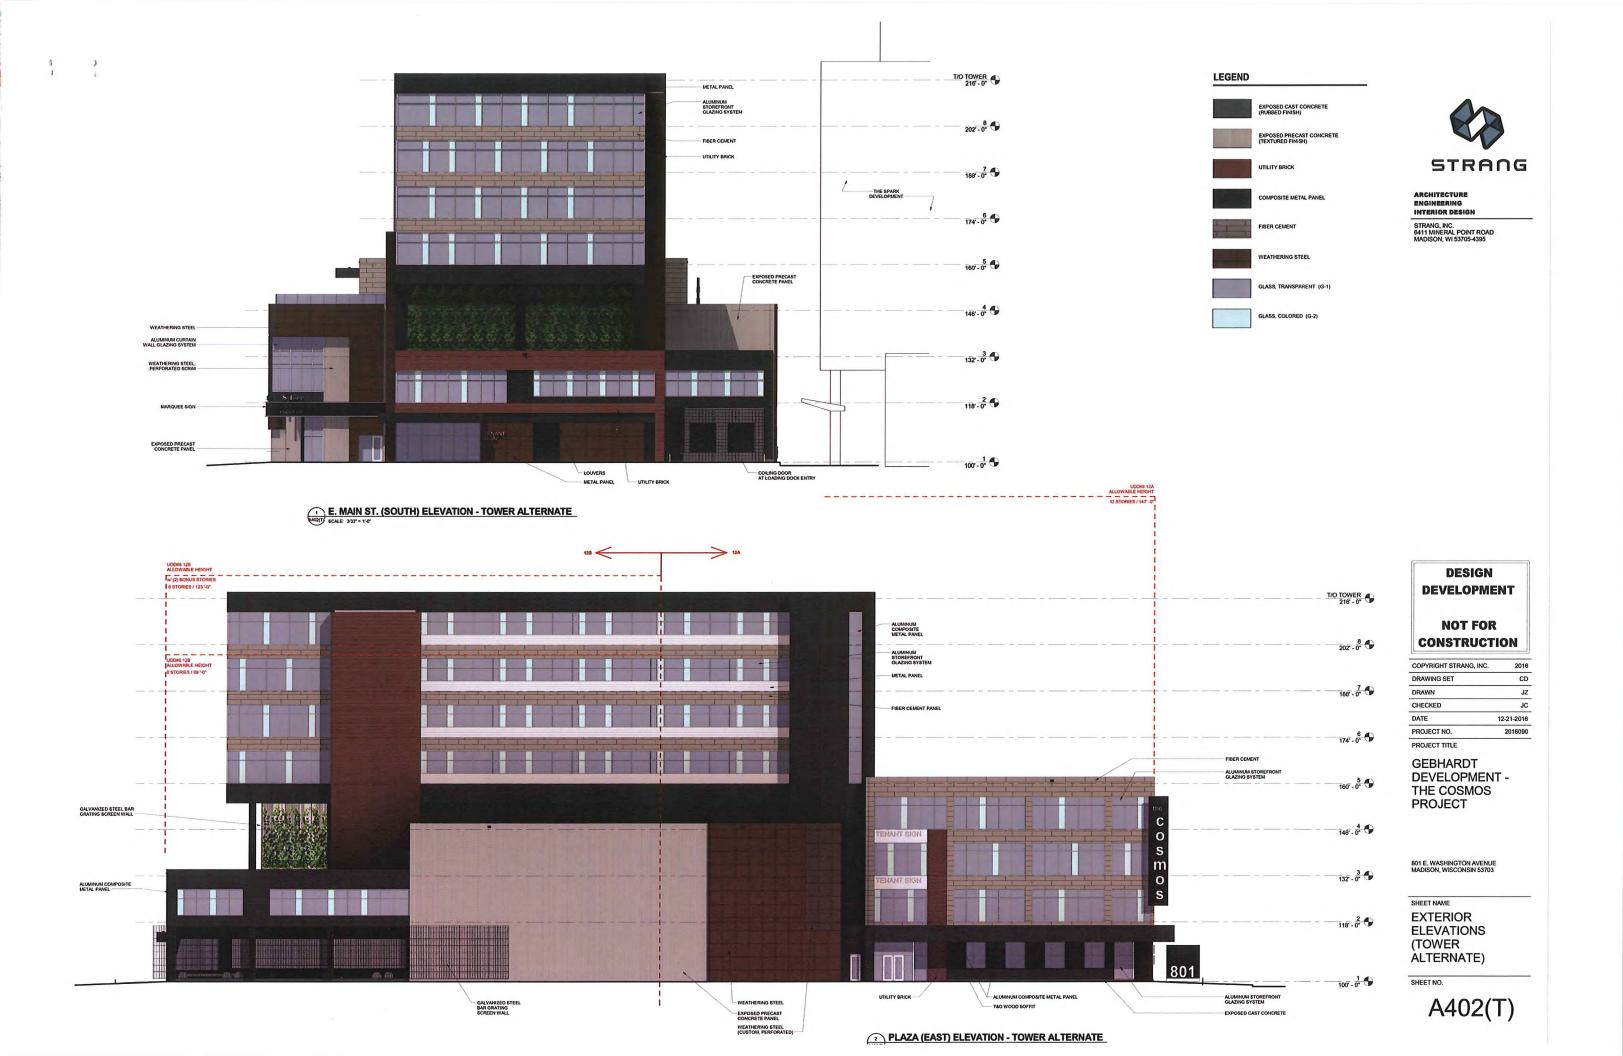
SHARED SPACES (EXIT STAIRS, MECHANICAL SPACES)

FLOOR PLANS

SHEET NO.

A203







VIEW FROM N. LIVINGSTON / E. WASHINGTON AVE. (LOOKING SOUTH)





STRANG, INC. 6411 MINERAL POINT ROAD MADISON, WI 53705-4395

 DATE
 12-21-2016

 PROJECT NO.
 2016090

 PROJECT TITLE


GEBHARDT DEVELOPMENT -THE COSMOS PROJECT

MADISON, WISCONSIN 53703

SHEET NAME
EXTERIOR
VIEWS



VIEW FROM S. LIVINGSTON (LOOKING NORTH)

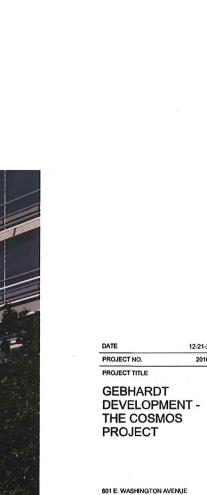






EXTERIOR VIEWS


SHEET NAME

PROJECT NO. PROJECT TITLE

VIEW FROM E. MAIN ST. (LOOKING WEST)


12-21-2016

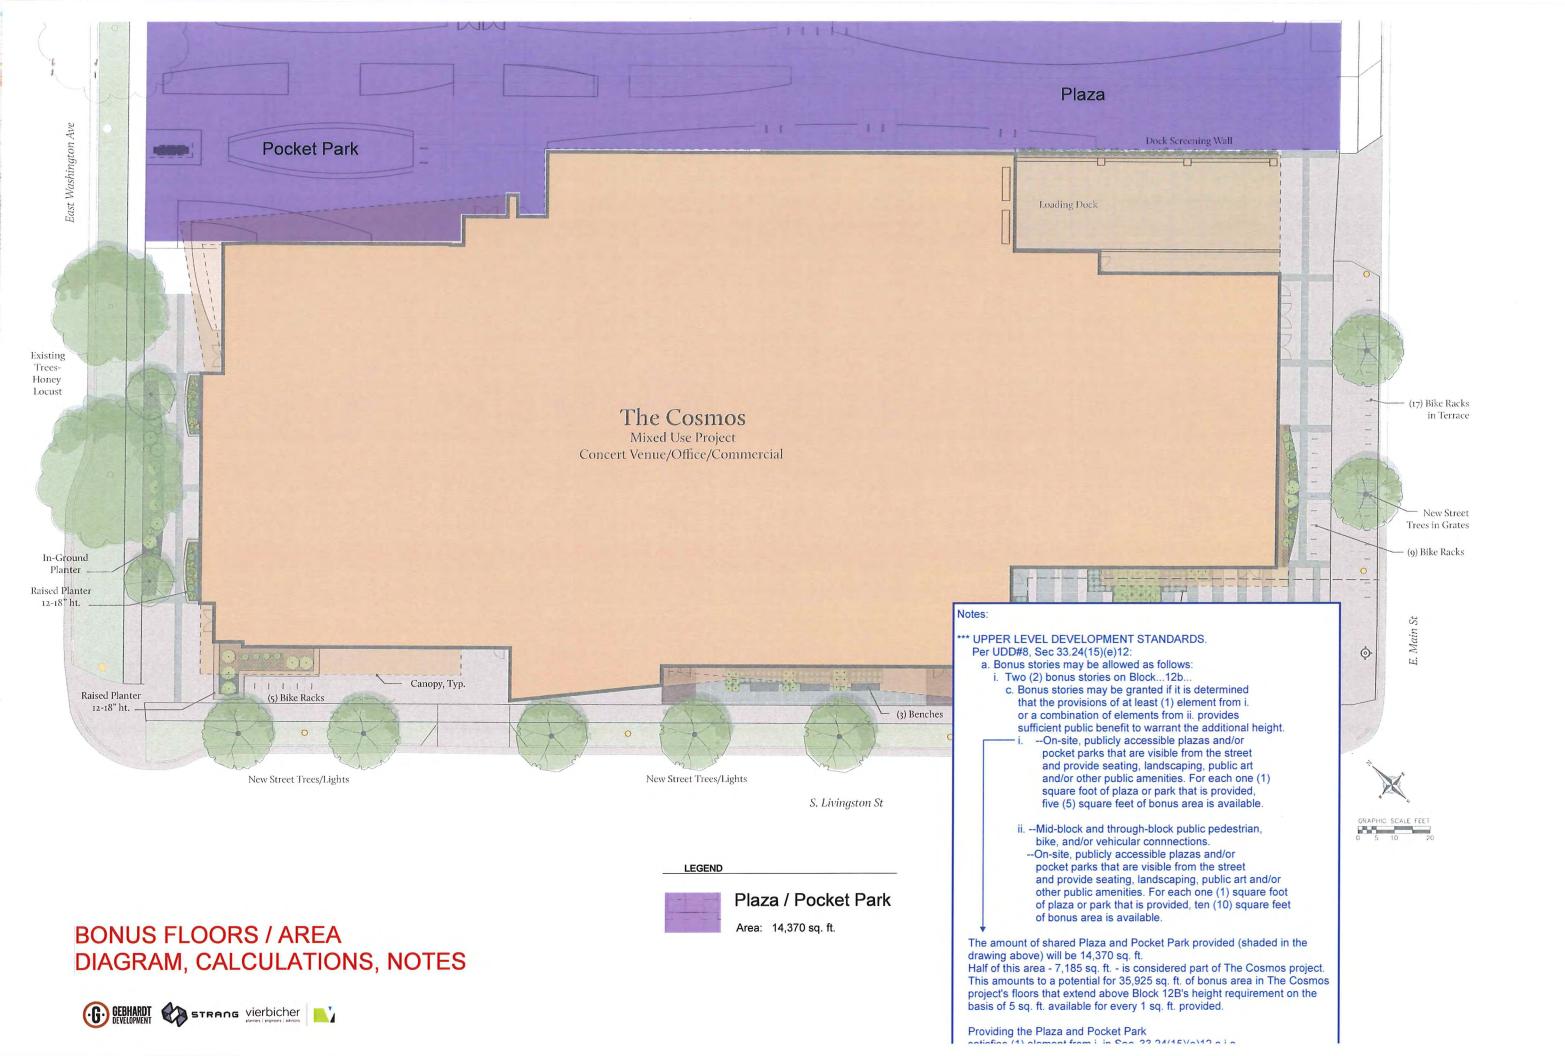


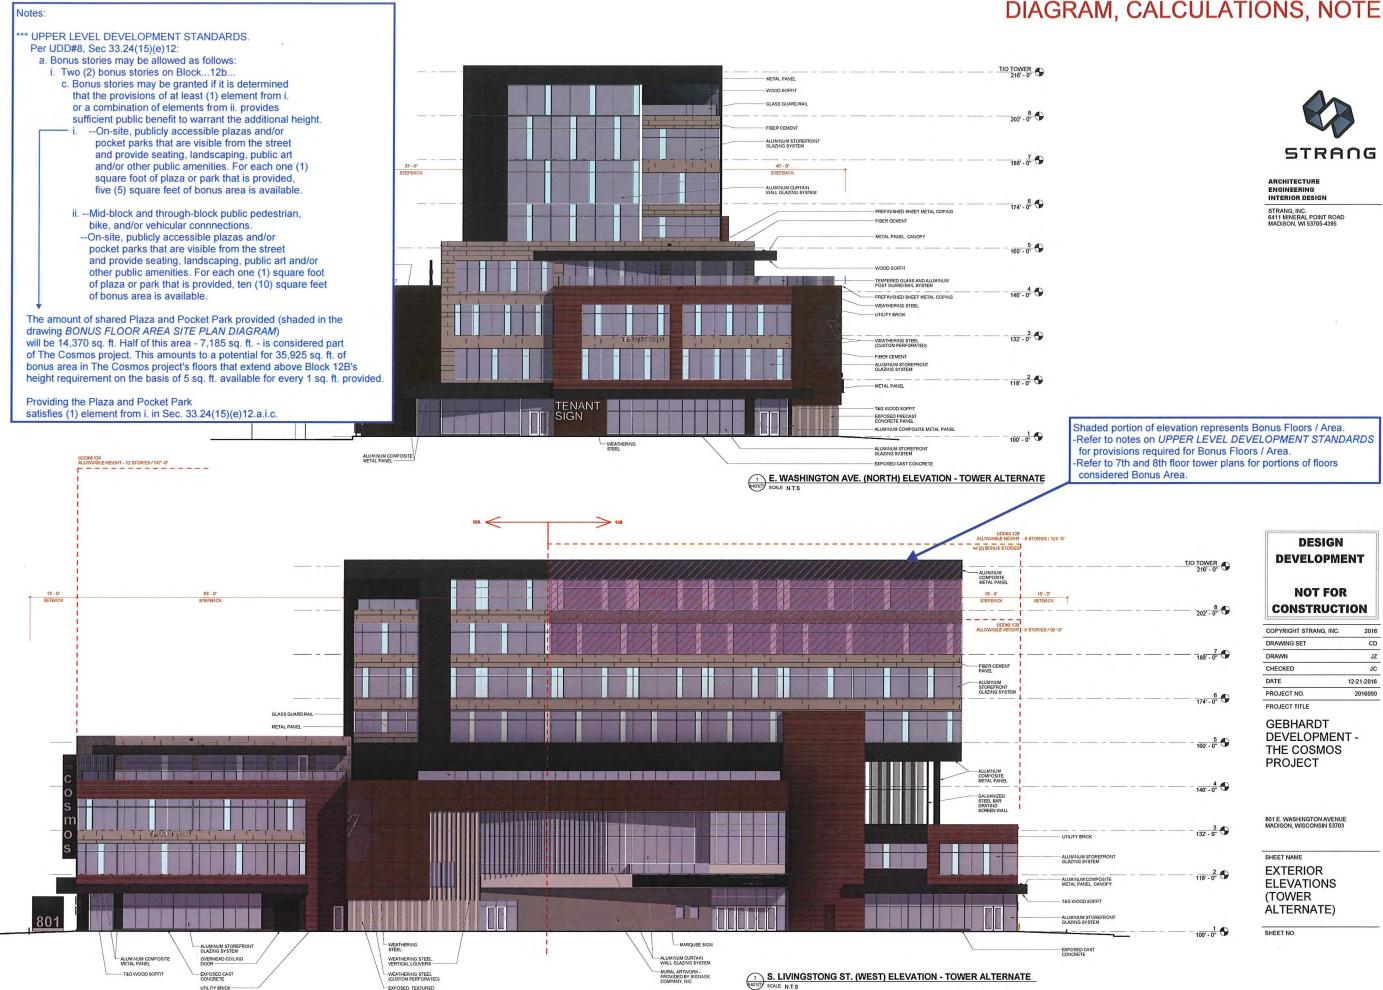

EXPOSED, TEXTURED

BONUS FLOORS / AREA DIAGRAM, CALCULATIONS, NOTES

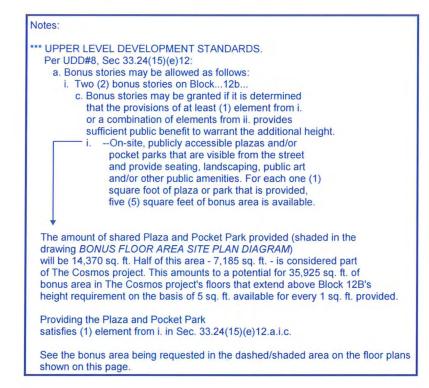

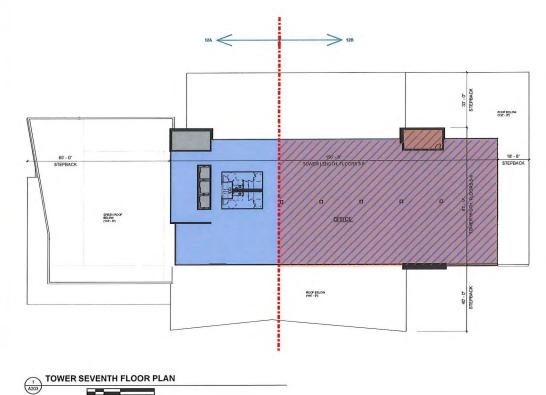

TOWER EIGHTH FLOOR PLAN

STRANG

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SHEET NAME

BONUS STORY DIAGRAM

SHEET NO.

A204

LEGEND AND CALCULATIONS



Bonus Floor / Area


Bonus Area per Floor 7th Floor: 10,050 sq. ft. 8th Floor: 10,050 sq. ft.

Total: 20,100 sq. ft.

Allowed: 35,925 sq. ft



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PROJECT TITLE	

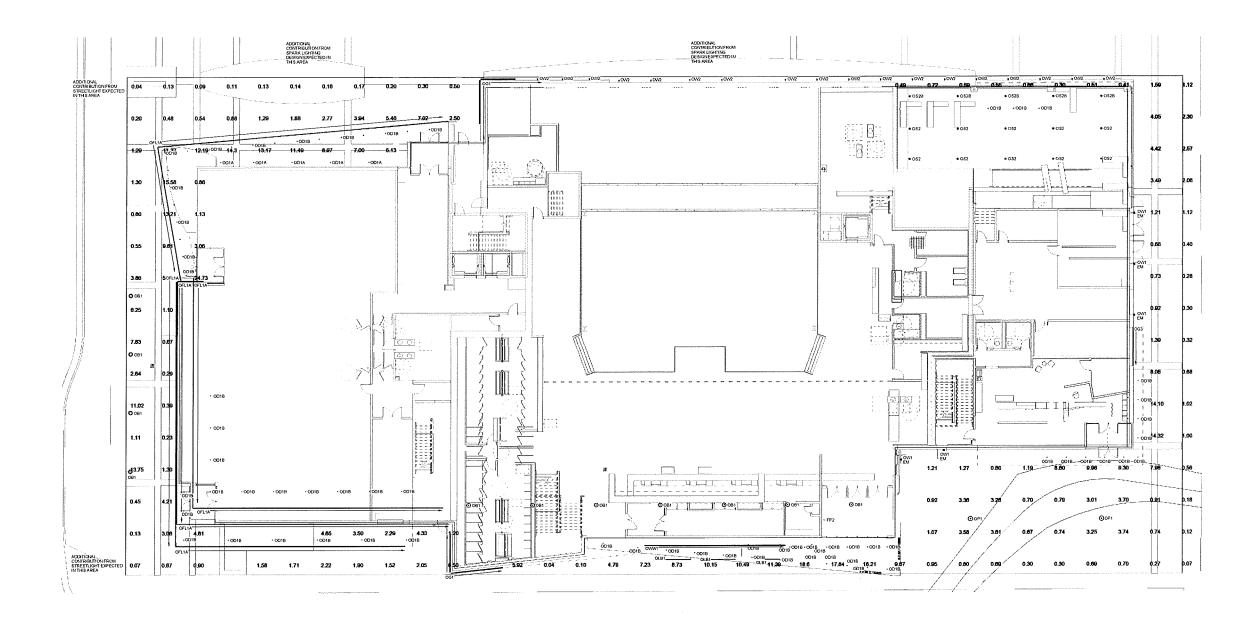GEBHARDT DEVELOPMENT -THE COSMOS PROJECT

801 E. WASHINGTON AVE

SHEET NAME

ELECTRICAL SITE LIGHTING PLAN


SHEET NO.

E201

SITE LIGHTING PLAN
SCALE: 1" = 30'


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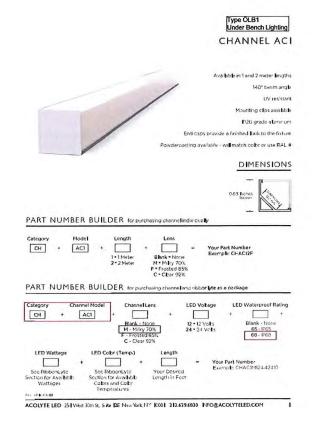


TYPE OD1

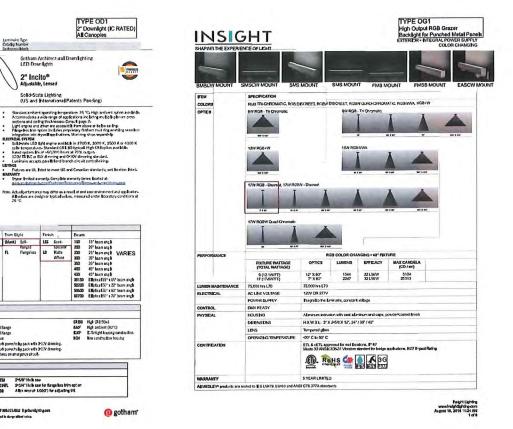
TYPE OG1



Polyt Lighting www.hsight.lighting.com October 4, 2016 4:13 PM

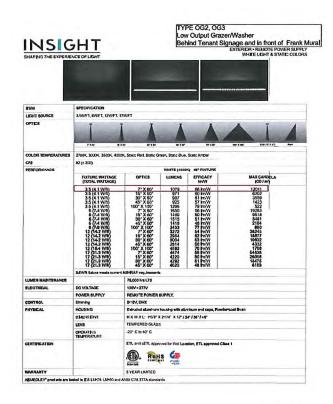

2" Incito®

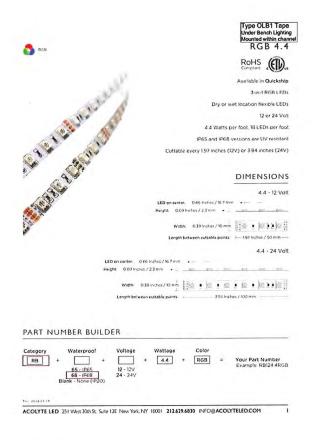

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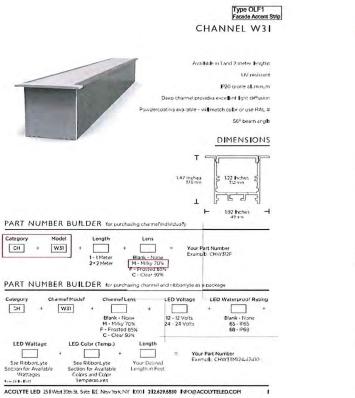
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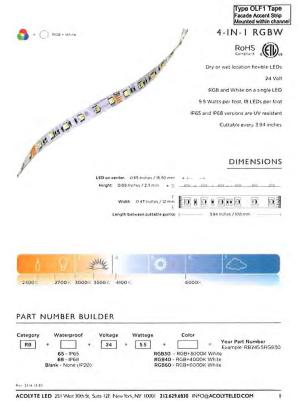
SHEET NAME LIGHTING CUTS

SHEET NO.

E301

TYPE OLB1 TAPE TYPE OLB1 TYPE OG2, OG3





TYPE OLF1 TAPE





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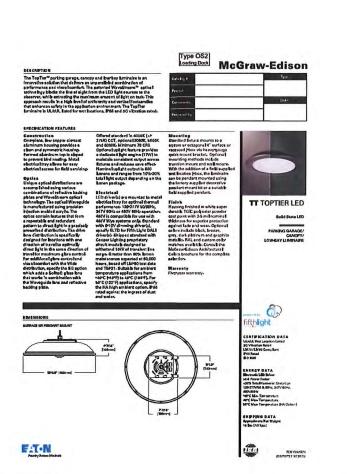
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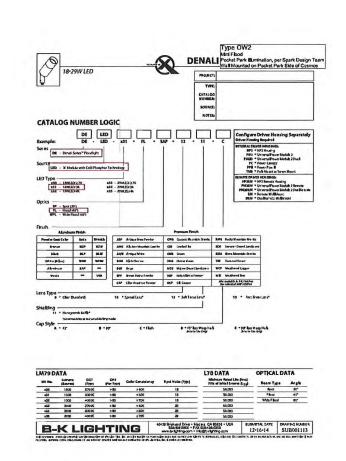
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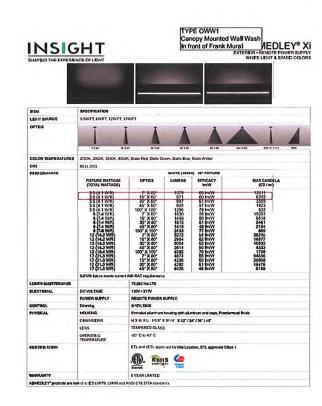
SHEET NAME
LIGHTING CUTS



TYPE OLF1







SHEET NO.

E302

TYPE OS2 TYPE OW1 TYPE OW2 TYPE OWW1