# **URBAN DESIGN COMMISSION APPLICATION**



City of Madison Planning Division Madison Municipal Building, Suite 017 215 Martin Luther King, Jr. Blvd. P.O. Box 2985 Madison, WI 53701-2985 (608) 266-4635



Complete all sections of this application, including the desired meeting date and the action requested.

If you need an interpreter, translator, materials in alternate formats or other accommodations to access these forms, please call the phone number above immediately.

FOR OFFICE USE ONLY:	
Paid	Receipt #
Date received	
Received by	
Aldermanic District	
Zoning District	2/28/22 12:10 p.m.
Urban Design District	12.10 p.m.
,	
Legistar #	

1.	Project Information				
	Address:				
	Title:				
2.	<b>Application Type</b> (check all that	apply) and Requested Date	e		
	UDC meeting date requested				
	New development	Alteration to an existing or	ng or previously-approved development		
	Informational	Initial approval	Final approval		
3.	Project Type				
	Project in an Urban Design Dis	strict	Signage		
	Project in the Downtown Core	\ <i>\</i> //	Comprehensive Design Review (CDR)		
	Mixed-Use District (UMX), or Mi	, ,	Signage Variance (i.e. modification of signage height,		
	Project in the Suburban Emplo Campus Institutional District (		area, and setback)		
	District (EC)	, , , , ,	Signage Exception		
	Planned Development (PD)		Other		
	General Development Pl	• •	Please specify		
	Specific Implementation	• •			
	Planned Multi-Use Site or Res	idential Building Complex			
4.	Applicant, Agent, and Property	Owner Information			
	Applicant name		Company		
	Street address		City/State/Zip		
	Telephone		Email		
	Project contact person		Company		
	Street address		City/State/Zip		
	Telephone		Email		
	Property owner (if not applicant	:)			
	Street address		City/State/Zip		
	Telephone		Email		
M-\ D	ANNUM C DIVISION COMMISSIONS & COMMITTEES !!!	RRANI DESIGNI COMMUSSIONI\ ARRIJICATIONI — F	EERBLIADY 2020 PAGE 1 OF A		

Urba	n Design Commission Application (continued)	unicipal de la companya de la compa
5. Re	quired Submittal Materials	
	Application Form	
	Letter of Intent	Each submittal must include fourteen (14) 11" x 17" collated
	<ul> <li>If the project is within an Urban Design District, as development proposal addresses the district criteria i</li> </ul>	s required paper copies. Landscape and
	<ul> <li>For signage applications, a summary of how the propo tent with the applicable CDR or Signage Variance revie</li> </ul>	w criteria is required.   must be full-sized and legible.
	Development Plans (Refer to checklist on Page 4 for plan	details)  Please refrain from using plastic covers or spiral binding.
	Filing fee	) prosite esters on spirat difficulties.
	Electronic Submittal*	
	<ul> <li>Notification to the District Alder</li> <li>Please provide an email to the District Alder notifying as early in the process as possible and provide a copy</li> </ul>	them that you are filing this UDC application. Please send thi of that email with the submitted application.
Bot sch	h the paper copies and electronic copies <u>must</u> be submitted eduled for a UDC meeting. Late materials will not be accepted. A	prior to the application deadline before an application will be completed application form is required for each UDC appearance
For con	projects also requiring Plan Commission approval, applicants mu sideration prior to obtaining any formal action (initial or final ap	st also have submitted an accepted application for Plan Commission proval) from the UDC. All plans must be legible when reduced.
pro not 266	npiled on a CD or flash drive, or submitted via email to <u>udc</u> ject address, project name, and applicant name. Electronic	quired. Individual PDF files of each item submitted should be applications@cityofmadison.com. The email must include the submittals via file hosting services (such as Dropbox.com) are als electronically should contact the Planning Division at (608
103		
1.	Commission staff. This application, the applicant is re 2/1/2022	equired to discuss the proposed project with Urban Design th <u>Jessica Vaughn</u> Or
2.	The applicant attests that all required materials are included is not provided by the application deadline, the application consideration.	n this submittal and understands that if any required information will not be placed on an Urban Design Commission agenda fo
Vame	of applicant Jim Stopple	Relationship to property Owner
Author	rizing signature of property owner	Data 2-2 C- 22
	FOR SIG W. WAShing	on " As Contracture owner"
Fee of t Con	s are required to be paid with the first application for either he combined application process involving the Urban Desi	initial or small approval of a project, unless the project is partial commission in conjunction with Plan Commission and/or reasurer. Credit cards may be used for application fees of less
Plea	sse consult the schedule below for the appropriate fee for y	our request:
	Urban Design Districts: \$350 (per §35.24(6) MGO).	A filing fee is not required for the following project
	Minor Alteration in the Downtown Core District (DC) or Urban Mixed-Use District (UMX): \$150 (per §33.24(6)(b) MGO)	applications if part of the combined application process involving both Urban Design Commission and Plan Commission:
	Comprehensive Design Review: \$500 (per §31.041(3)(d)(1)(a) MGO)	<ul> <li>Project in the Downtown Core District (DC), Urban Mixed-Use District (UMX), or Mixed-Use Center District (MXC)</li> </ul>
	Minor Alteration to a Comprehensive Sign Plan: \$100 (per §31.041(3)(d)(1)(c) MGO)	<ul> <li>Project in the Suburban Employment Center District (SEC), Campus Institutional District (CI), or</li> </ul>
	All other sign requests to the Urban Design Commission, including, but not limited to: appeals	Employment Campus District (EC)

from the decisions of the Zoning Administrator,

requests for signage variances (i.e. modifications of signage height, area, and setback), and additional sign

code approvals: \$300 (per §31.041(3)(d)(2) MGO)

- Planned Development (PD): General Development

Plan (GDP) and/or Specific Implementation Plan (SIP)

Planned Multi-Use Site or Residential Building Complex

# URBAN DESIGN COMMISSION APPROVAL PROCESS



# Introduction

The City of Madison's Urban Design Commission (UDC) has been created to:

- Encourage and promote high quality in the design of new buildings, developments, remodeling, and additions so as to maintain and improve the established standards of property values within the City.
- Foster civic pride in the beauty and nobler assets of the City, and in all other ways possible assure a functionally efficient and visually attractive City in the future.

# Types of Approvals

There are three types of requests considered by the UDC:

- Informational Presentation. Applicants may, at their discretion, request to make an Informational Presentation to the
  UDC prior to seeking any approvals to obtain early feedback and direction before undertaking detailed design. Applicants
  should provide details on the context of the site, design concept, site and building plans, and other relevant information
  to help the UDC understand the proposal and provide feedback. (Does not apply to CDR's or Signage Variance requests)
- <u>Initial Approval</u>. Applicants may, at their discretion, request initial approval of a proposal by presenting preliminary design information. As part of their review, the Commission will provide feedback on the design information that should be addressed at Final Approval stage.
- Final Approval. Applicants may request Final Approval of a proposal by presenting all final project details. Recommendations
  or concerns expressed by the UDC in the initial approval must be addressed at this time.

# Presentations to the Commission

Primarily, the UDC is interested in the appearance and design quality of projects. Emphasis should be given to the site plan, landscape plan, lighting plan, building elevations, exterior building materials, color scheme, and graphics.

When presenting projects to the UDC, applicants must fill out a registration slip provided in the meeting room and present it to the Secretary. Presentations should generally be limited to 5 minutes or as extended by motion by consent of the Commission. The Commission will withhold questions until the end of the presentation.

Applicants are encouraged to consider the use of various graphic presentation material including a locator map, photographs, renderings/model, scale drawings of the proposal in context with adjacent buildings/uses/signs, etc., as may be deemed appropriate to describe the project and its surroundings. Graphics should be mounted on rigid boards so that they may be easily displayed. Applicants/presenters are responsible for all presentation materials, AV equipment and easels.

# **URBAN DESIGN DEVELOPMENT PLANS CHECKLIST**



The items listed below are minimal application requirements for the type of approval indicated. Please note that the UDC and/or staff may require additional information in order to have a complete understanding of the project.

1. Informa	tional Presentation				
	Locator Map	)		Requirem	ents for All Plan Sheets
	Letter of Intent (If the project is within			1. Title	block
	an Urban Design District, a summary of how the development proposal addresses			2. Shee	et number
	the district criteria is required)		Providing additional	3. Nort	th arrow
	Contextual site information, including	\	information beyond these minimums may generate		e, both written and graphic
	photographs and layout of adjacent buildings/structures		a greater level of feedback	5. Date	e dimensioned plans, scaled
	Site Plan		from the Commission.	at 1"	'= 40' or larger
	Two-dimensional (2D) images of				ns must be legible, including great landscape and lighting
	proposed buildings or structures.	J		plans (if re	
2. Initial A	pproval				
	Locator Map			)	
	Letter of Intent (If the project is within a the development proposal addresses the			of <u>how</u>	
	Contextual site information, including phostructures	otog	raphs and layout of adjacent bu	uildings/	Providing additional information beyond these
	Site Plan showing location of existing a lanes, bike parking, and existing trees ov			res, bike	minimums may generate a greater level of feedback
	Landscape Plan and Plant List (must be le	gible	e)		from the Commission.
	Building Elevations in both black & whi material callouts)	te ar	nd color for all building sides	(include	
	PD text and Letter of Intent (if applicable	·)		J	
3. Final Ap	proval				
All the re	equirements of the Initial Approval (see ab	oove)	), <u>plus</u> :		
	Grading Plan				
	Proposed Signage (if applicable)				
	Lighting Plan, including fixture cut sheets	s and	d photometrics plan ( <i>must be le</i>	egible)	
	Utility/HVAC equipment location and scr	eeni	ng details (with a rooftop plan	if roof-mou	inted)
	PD text and Letter of Intent (if applicable	( ټ			
	Samples of the exterior building materia	ls (pr	resented at the UDC meeting)		
4. Compre	nensive Design Review (CDR) and Varia	nce l	Requests ( <i>Signage applicatio</i>	ons only)	
	Locator Map		, , , , , , , , , , , , , , , , , , , ,		
	Letter of Intent (a summary of how the prop	osec	d signage is consistent with the CI	DR or Signage	e Variance criteria is required)
	Contextual site information, including p project site	hoto	ographs of existing signage bo	th on site a	and within proximity to the
	Site Plan showing the location of existing driveways, and right-of-ways	; sign	nage and proposed signage, din	nensioned s	signage setbacks, sidewalks,
	Proposed signage graphics (fully dimensi	ione	d, scaled drawings, including m	naterials and	d colors, and night view)
	Perspective renderings (emphasis on ped	destr	rian/automobile scale viewshed	ds)	
	Illustration of the proposed signage that	mee	ets Ch. 31, MGO compared to v	vhat is being	g requested.
	Graphic of the proposed signage as it rel	ates	to what the Ch. 31, MGO wou	ld permit	

# February 28, 2022

Ms. Heather Stouder
Director, Planning Division
City of Madison Department of Planning & Community & Economic Development
215 Martin Luther King Jr. Blvd., Ste 017
Madison, Wisconsin 53703

knothe • bruce

Re: Letter of Intent 519-547 W. Washington Ave. KBA Project # 2143

Ms. Heather Stouder:

The following is submitted together with the plans and application for the staff and Plan Commission's consideration of approval.

# **Organizational Structure:**

120 Regent St.

Owner: Virtue LLC Architect: Knothe & Bruce Architects, LLC

7601 University Avenue, Ste 201

Madison WI 53715 Middleton, WI 53562
(608) 251-8777 (608) 836-3690
Contact: Jim Stopple Contact: Kevin Burow
jim@madisonproperty.com kburow@knothebruce.com

Engineer: Vierbicher Landscape Vierbicher

999 Fourier Drive, Suite 201 Design: 999 Fourier Drive, Suite 201

Madison, WI 53717 Madison, WI 53717 608-821-3970 608-821-3970

Contact: Randy Kolinske Contact: Randy Kolinske rkol@vierbicher.com rkol@vierbicher.com

# **Introduction:**

This proposed multi-family development involves the redevelopment of 519-547 W. Washington Ave. located within the Capitol Neighborhoods Neighborhood, the sites are currently occupied by rental houses. This application requests permission of removal of the existing buildings for the development of a new 4 and 6-story residential, multi-family building. The development will include 140 dwelling units and underground parking. The site is currently zoned DR2 (Downtown Residential 2) and will remain DR2 (Downtown Residential 2) zoning for the proposed redevelopment.

# **Project Description:**

The proposed project is a 4 to 6-story, multi-family development with 140 dwelling units and underground parking. The surrounding neighborhood consists of residential rental homes, mixed-use, and commercial buildings. This site is located is in between rental properties and a commercial building, which has also been planned for redevelopment into multi-family housing. This is a very walkable neighborhood with numerous amenities nearby, such as a CVS pharmacy, Food Mart/convenience store, fitness center, clothing/furniture stores, hardware store, and many restaurants. Vehicle and bicycle parking will be provided within the two basement levels of this building. The main façade along West

Letter of Intent – Land Use 519-547 W Washington Ave. February 28, 2022 Page 2 of 3

Washington Avenue has been broken down into 3 separate masses with outdoor courtyard spaces located in-between. This provides a smaller scale along the street while providing multiple connections to the sidewalks and opportunities to connect with the neighborhood. A large rooftop deck area has also been created on the 6th floor and the uppermost roof is also accessible for the residents to be able to get outside and have great views of the City. Additional green space is also being provided as the existing back yards are currently used entirely for parking. We are able to utilize one access drive for this development so there will be additional street parking available when the other two driveways are removed. We will have visitor parking on the first-floor level within the building along with the two levels of underground parking so that we can provide parking for all residents.

# **City and Neighborhood Input:**

We have met with the City on several occasions for this proposed development including a preapplication meeting on August 10, 2021 with Colin Punt of City of Madison Planning, and Jenny Kirchgatter of City of Madison Zoning. This project was reviewed at a Development Assistance Team meeting and this project was presented at an Alder sponsored neighborhood meeting on January 27, 2022. We have also since met with the Steering Committee members of the Capitol Neighborhoods Association. This input has helped shape this proposed development.

# **Demolition Standards**

The existing residential buildings are used as rental housing that is predominantly student housing. These buildings were originally single-family homes that were then divided up into rental units, and they have been well used over many years. Given the high demand for additional housing, especially in the heart of Madison where many people would like to live, it has been determined that the best use of this property is for a higher density housing. We are proposing the existing buildings be demolished. We will do our best to repurpose any of the useful items within these buildings and will allow relocation of them if an interested party would desire to utilize the entire structure. The demolition standards will be met, and a Re-use and Recycling Plan will be submitted prior to the deconstruction of the existing structures.

# **Conditional Use Approvals:**

The proposed development requires a conditional use to allow for a multi-family building with more than 8 units. The proposed building's size, scale, and use are consistent with the recently adopted Miflandia Plan. We have also met or exceeded all other standards of the DR2 (Downtown Residential 2) zoning.

# **Site Development Data:**

**Densities:** 

Lot Area 49,384 S.F. / 1.337 acres

Dwelling Units 140 D.U.
Lot Area / D.U. 352 S.F./D.U.
Density 104 units/acre
Lot Coverage 36,461 S.F. / 74 %

Usable Open Space 18,964 S.F.

Building Height: 4 & 6 Stories

Dwelling Unit Mix:		Residential Point Value for DR-2 District
Studio	22	16.5
One Bedroom	62	62
One Bedroom + Den	4	4
Two Bedroom	30	60
Three Bedroom	22	66
Total	140 D.U.	208.5 = 1.49 Average

# Vehicle Parking:

Underground	158
Visitor	10

Total 168 vehicle stalls

# **Bicycle Parking:**

Garage Floor-Mount	115
Garage Wall-Mount	36
Guest Surface	14

Total 165 bike stalls

# **Project Schedule:**

It is anticipated that construction will start in Fall 2022 and be completed in Spring 2024.

Thank you for your time and consideration of our proposal.

Sincerely

Kevin Burow, AIA, NCARB, LEED A.P.

Managing Member

Keni Bu



# **City of Madison Fire Department**

314 W Dayton Street, Madison, WI 53703-2506

Phone: 608-266-4420 • Fax: 608-267-1100 • E-mail: fire@cityofmadison.com

Project Address: 519-547 West Washington Avenue	
Contact Name & Phone #: Kevin Burow (608) 836-3690	

# FIRE APPARATUS ACCESS AND FIRE HYDRANT WORKSHEET

1. Is the building completely protected by an NFPA 13 or 13R automatic fire sprinkler system?  If non-sprinklered, fire lanes extend to within 150-feet of all portions of the exterior wall?  If sprinklered, fire lanes are within 250-feet of all portions of the exterior wall?	X Yes Yes Yes	No No X No	N/A N/A N/A
2. Is the fire lane constructed of concrete or asphalt, designed to support a minimum load of 85,000 lbs?  a) Is the fire lane a minimum unobstructed width of at least 20-feet?  b) Is the fire lane unobstructed with a vertical clearance of at least 13½-feet?  c) Is the minimum inside turning radius of the fire lane at least 28-feet?  d) Is the grade of the fire lane not more than a slope of 8%?  e) Is the fire lane posted as fire lane? (Provide detail of signage.)  f) Is a roll-able curb used as part of the fire lane? (Provide detail of curb.)  g) Is part of a sidewalk used as part of the required fire lane? (Must support +85,000 lbs.)		☐ No	<ul> <li>N/A</li> <li>N/A</li> <li>N/A</li> <li>N/A</li> <li>N/A</li> <li>N/A</li> <li>N/A</li> <li>N/A</li> <li>N/A</li> </ul>
3. Is the fire lane obstructed by security gates or barricades? If yes:  a) Is the gate a minimum of 20-feet clear opening?  b) Is an approved means of emergency operations installed, key vault, padlock or key switch?	☐ Yes ☐ Yes ☐ Yes	X No  No  No	N/A N/A N/A N/A
4. Is the Fire lane dead-ended with a length greater than 150-feet?  If yes, does the area for turning around fire apparatus comply with IFC D103?	Yes Yes	X No No	□ N/A ▼ N/A
5. Is any portion of the building to be used for high-piled storage in accordance with IFC Chapter 3206.6 If yes, see IFC 3206.6 for further requirements.	Yes	X No	□ N/A
6. Is any part of the building greater than 30-feet above the grade plane?	X Yes	☐ No	N/A
If yes, answer the following questions:  a) Is the aerial apparatus fire lane parallel to one entire side of the building and covering at least 25% of the perimeter?  b) Is the near edge of the aerial apparatus fire lane between 15' and 30' from the building?  c) Are there any overhead power or utility lines located across the aerial apparatus fire lane?  d) Are there any tree canopies expected to grow across the aerial fire lane? (Based on mature canopy width of tree species)  e) Does the aerial apparatus fire lane have a minimum unobstructed width of 26-feet?	<ul><li>X Yes</li><li>Yes</li><li>Yes</li><li>Yes</li><li>X Yes</li></ul>	<ul><li>No</li><li>X No</li><li>X No</li><li>X No</li><li>X No</li><li>No</li></ul>	□ N/A □ N/A □ N/A □ N/A □ N/A
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If yes, answer the following questions:  a) Is the aerial apparatus fire lane parallel to one entire side of the building and covering at least 25% of the perimeter?  b) Is the near edge of the aerial apparatus fire lane between 15' and 30' from the building?  c) Are there any overhead power or utility lines located across the aerial apparatus fire lane?  d) Are there any tree canopies expected to grow across the aerial fire lane? (Based on mature canopy width of tree species)  e) Does the aerial apparatus fire lane have a minimum unobstructed width of 26-feet?	<ul><li>X Yes</li><li>Yes</li><li>Yes</li><li>Yes</li><li>X Yes</li></ul>	<ul><li>No</li><li>X No</li><li>X No</li><li>X No</li><li>X No</li><li>No</li></ul>	□ N/A □ N/A □ N/A □ N/A □ N/A


Attach an additional sheet if further explanation is required for any answers.

This worksheet is based on MGO 34.503 and IFC 2015 Edition Chapter 5 and Appendix D; please see the codes for further information.

# 519-547 W Washington Ave MADISON, WI





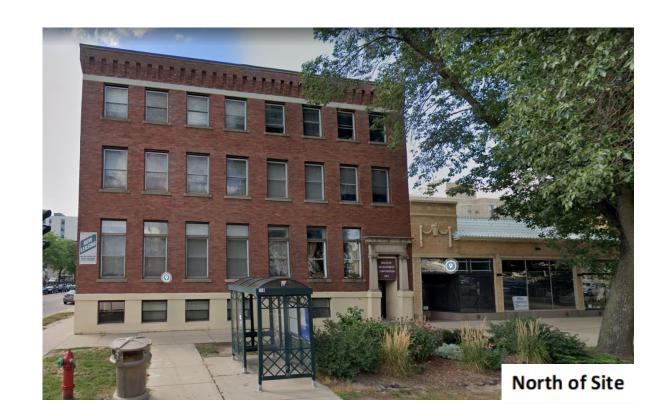







# 519-547 W Washington Ave MADISON, WI















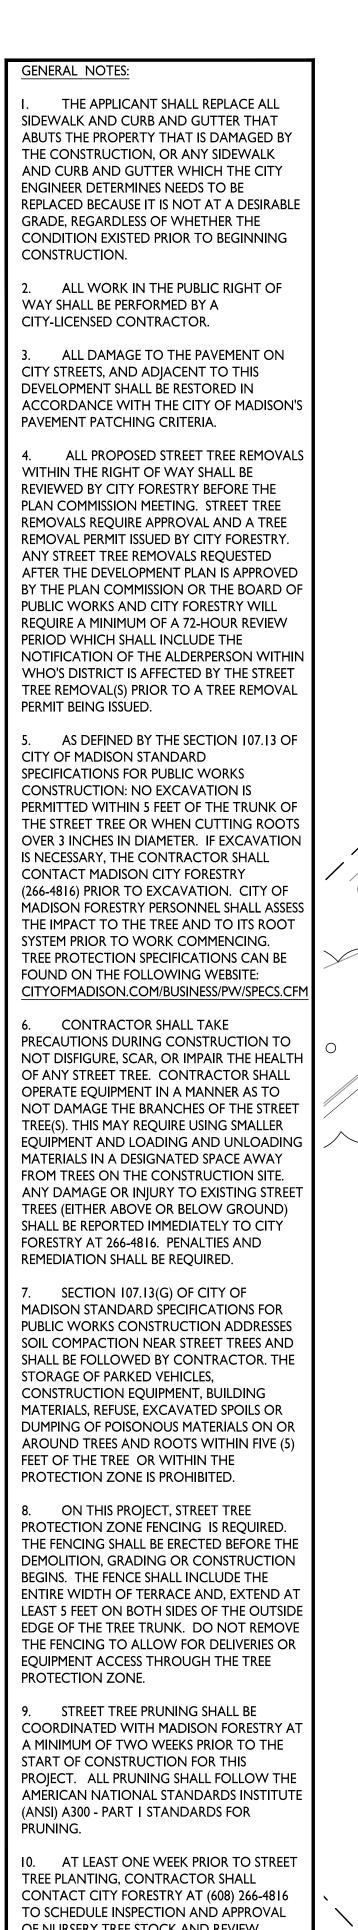


OF NURSERY TREE STOCK AND REVIEW PLANTING SPECIFICATIONS WITH THE LANDSCAPER. II. APPROVAL OF PLANS FOR THIS PROJECT DOES NOT INCLUDE ANY APPROVAL TO

PRUNE, REMOVE, OR PLANT TREES IN THE PUBLIC RIGHT-OF-WAY. PERMISSION FOR SUCH ACTIVITIES MUST BE OBTAINED FROM THE CITY FORESTER (266-4816).

12. THE PUBLIC RIGHT-OF-WAY IS THE SOLE JURISDICTION OF THE CITY OF MADISON AND IS SUBJECT TO CHANGE AT ANY TIME. NO ITEMS SHOWN ON THIS SITE PLAN IN THE RIGHT-OF-WAY ARE PERMANENT AND MAY NEED TO BE REMOVED AT THE APPLICANTS EXPENSE UPON NOTIFICATION BY THE CITY.

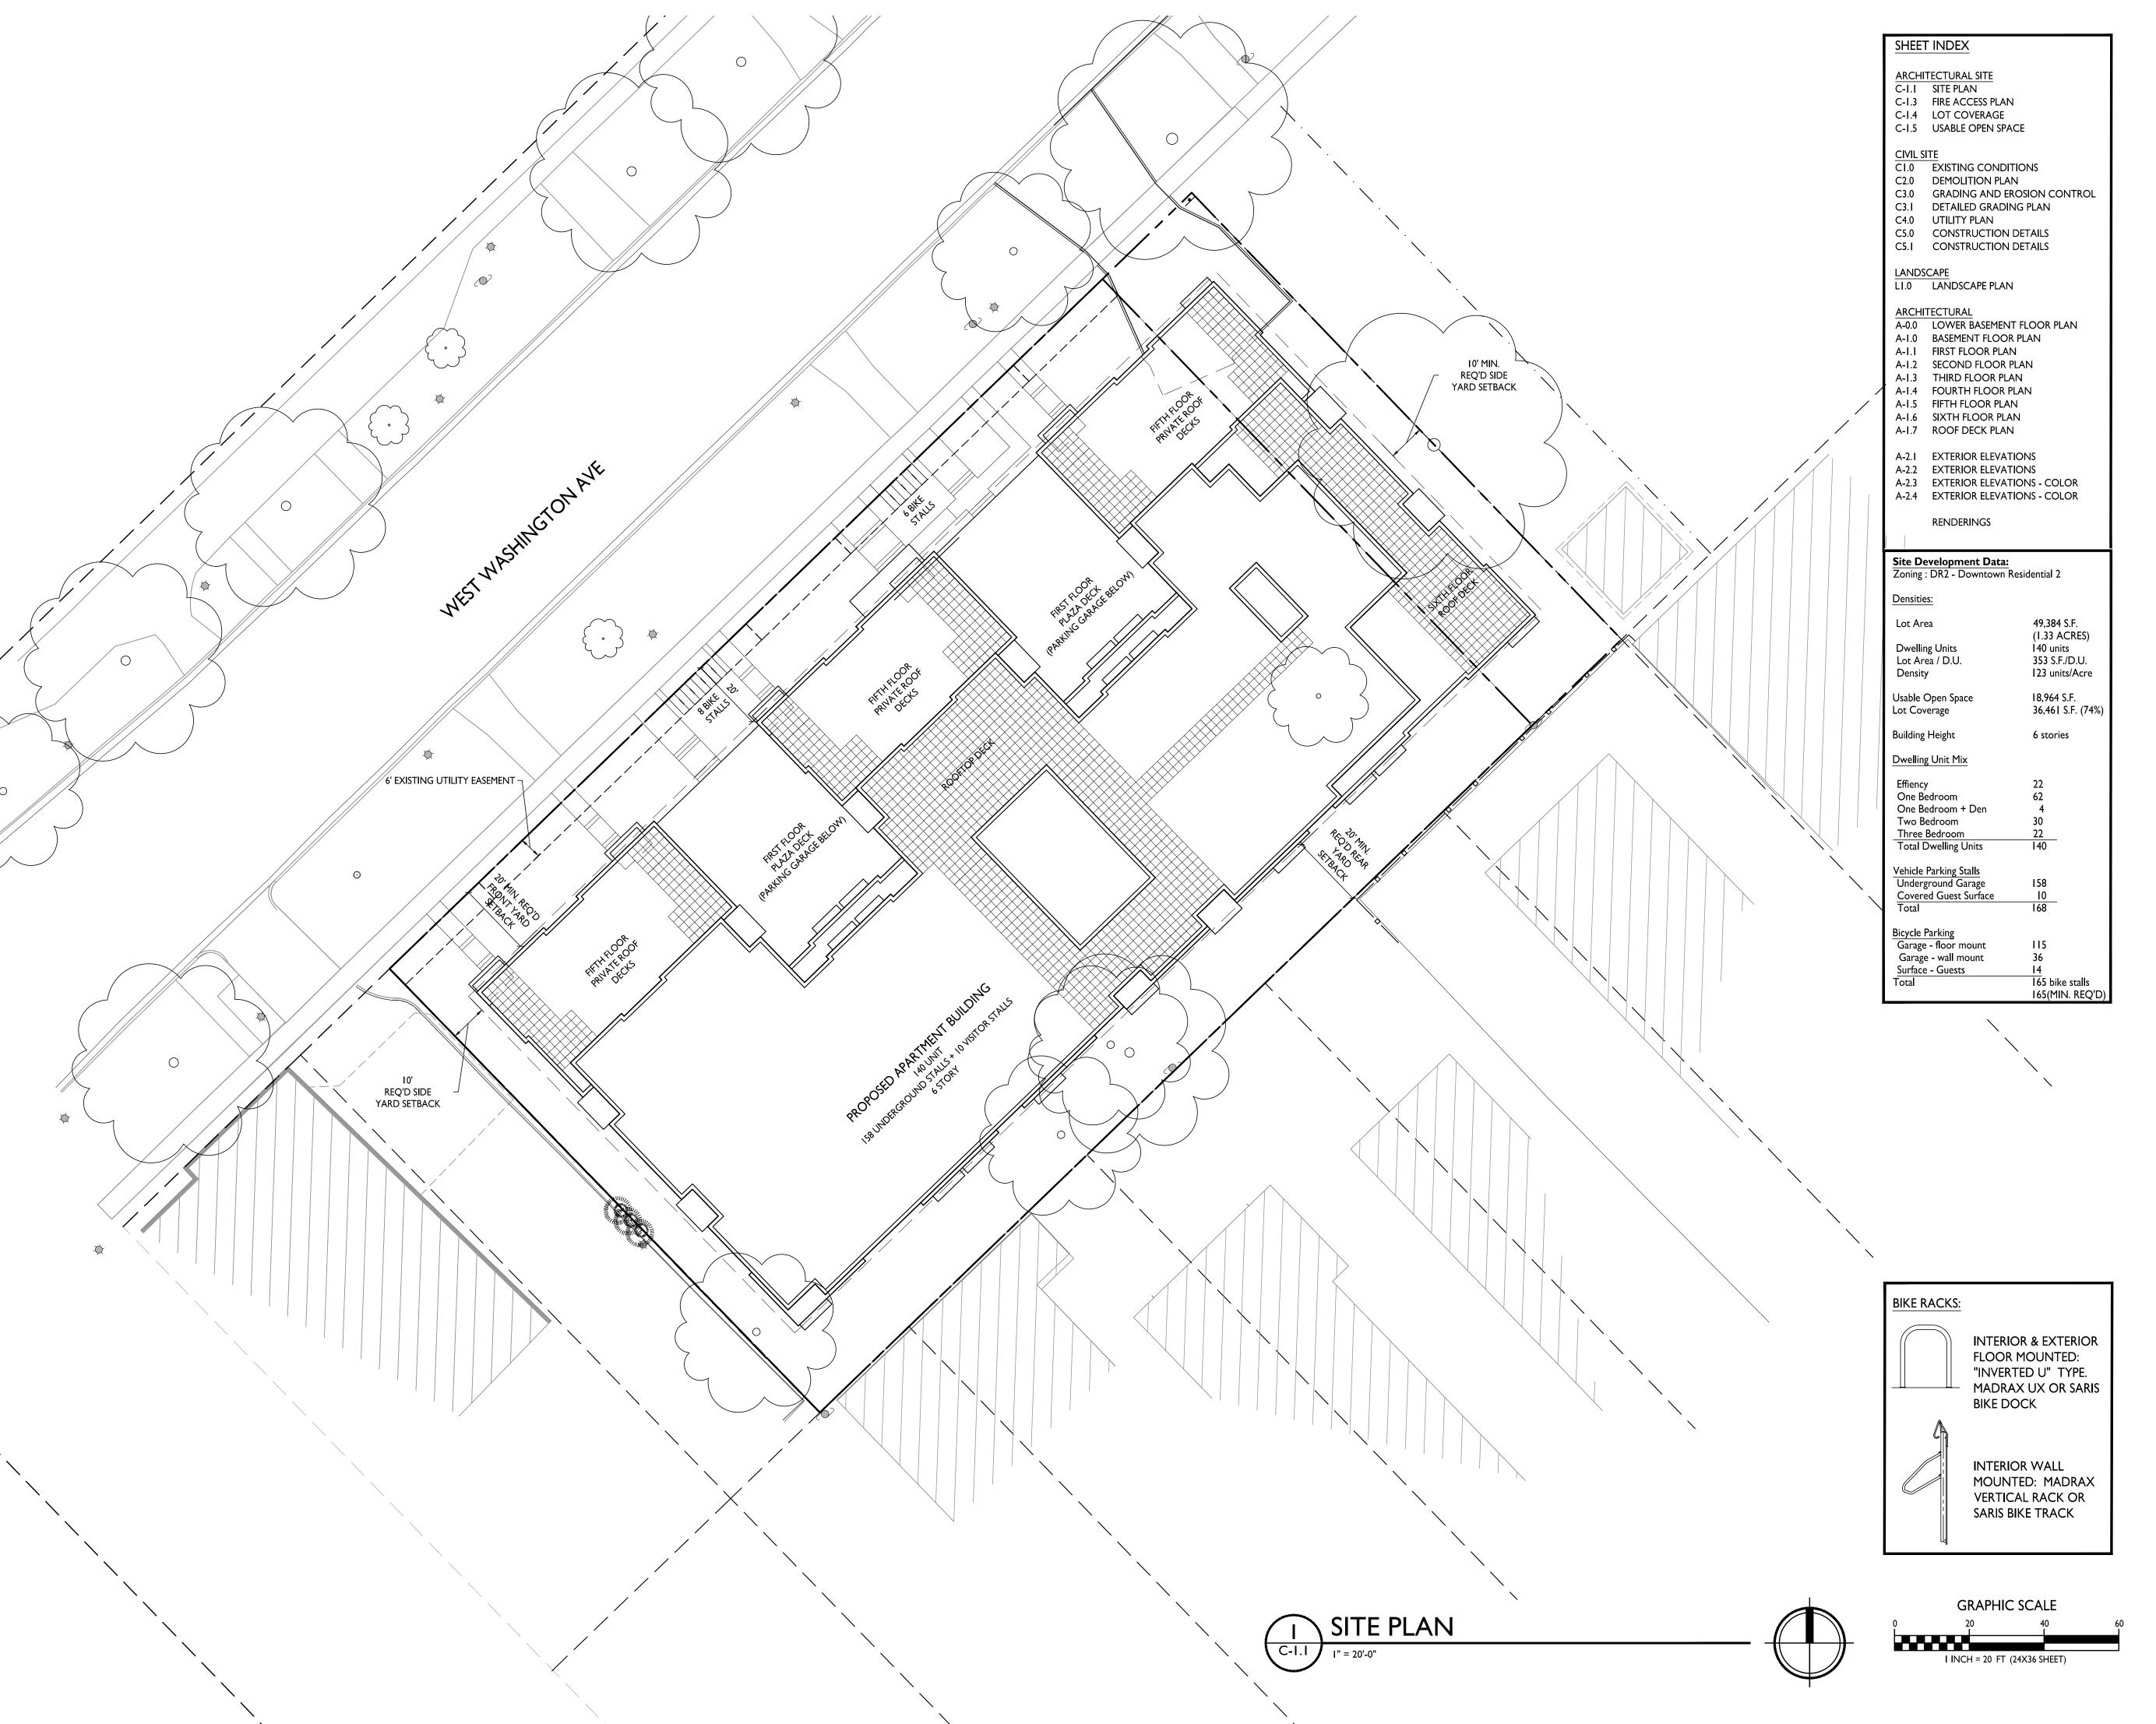

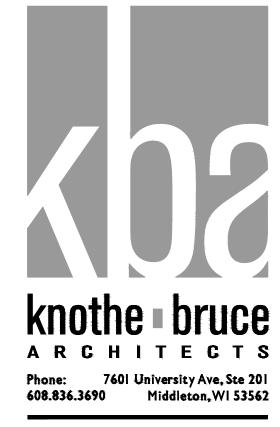

ISSUED

Issued for Review - January 10, 2022 Issued for LUA & UDC Submittal - Feb. 28, 2022

PROJECT TITLE West Washington Development


519-547 W Washington Ave.

Madison, Wisconsin

SHEET TITLE Site Plan

SHEET NUMBER

PROJECT NO.

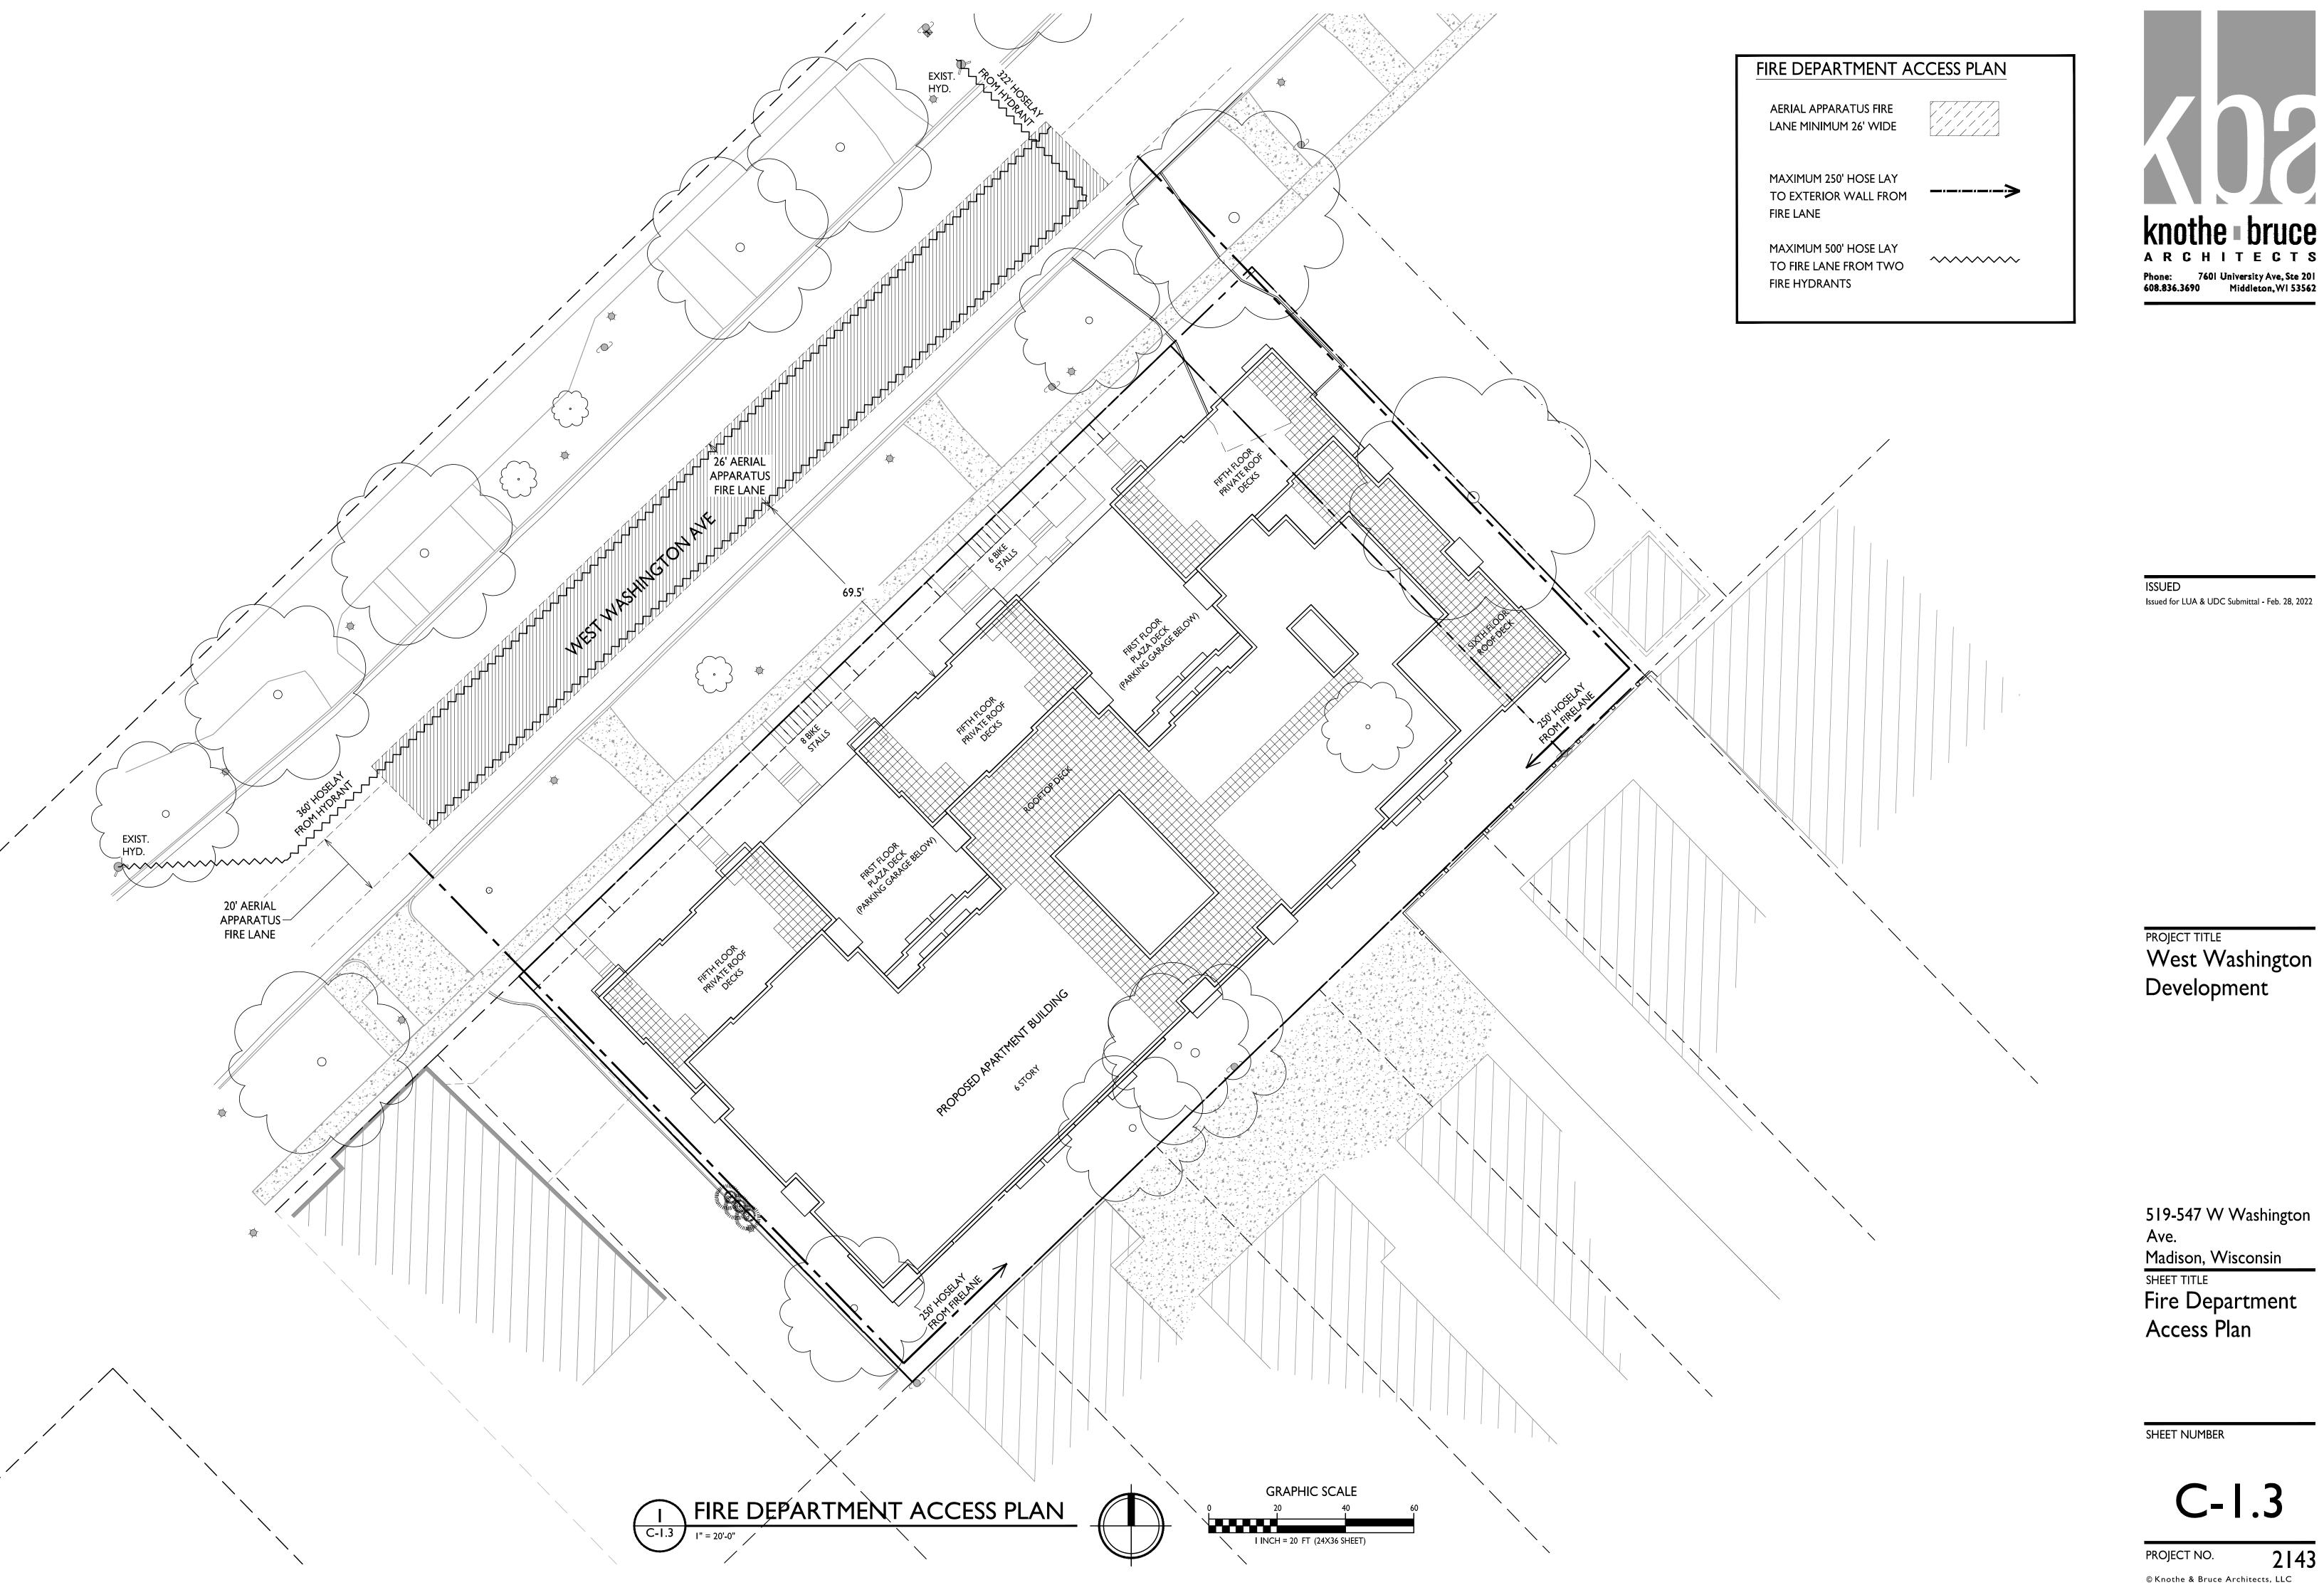



Phone: 7601 University Ave, Ste 201 608.836.3690 Middleton, WI 53562

519-547 W Washington

C-1.3

2143

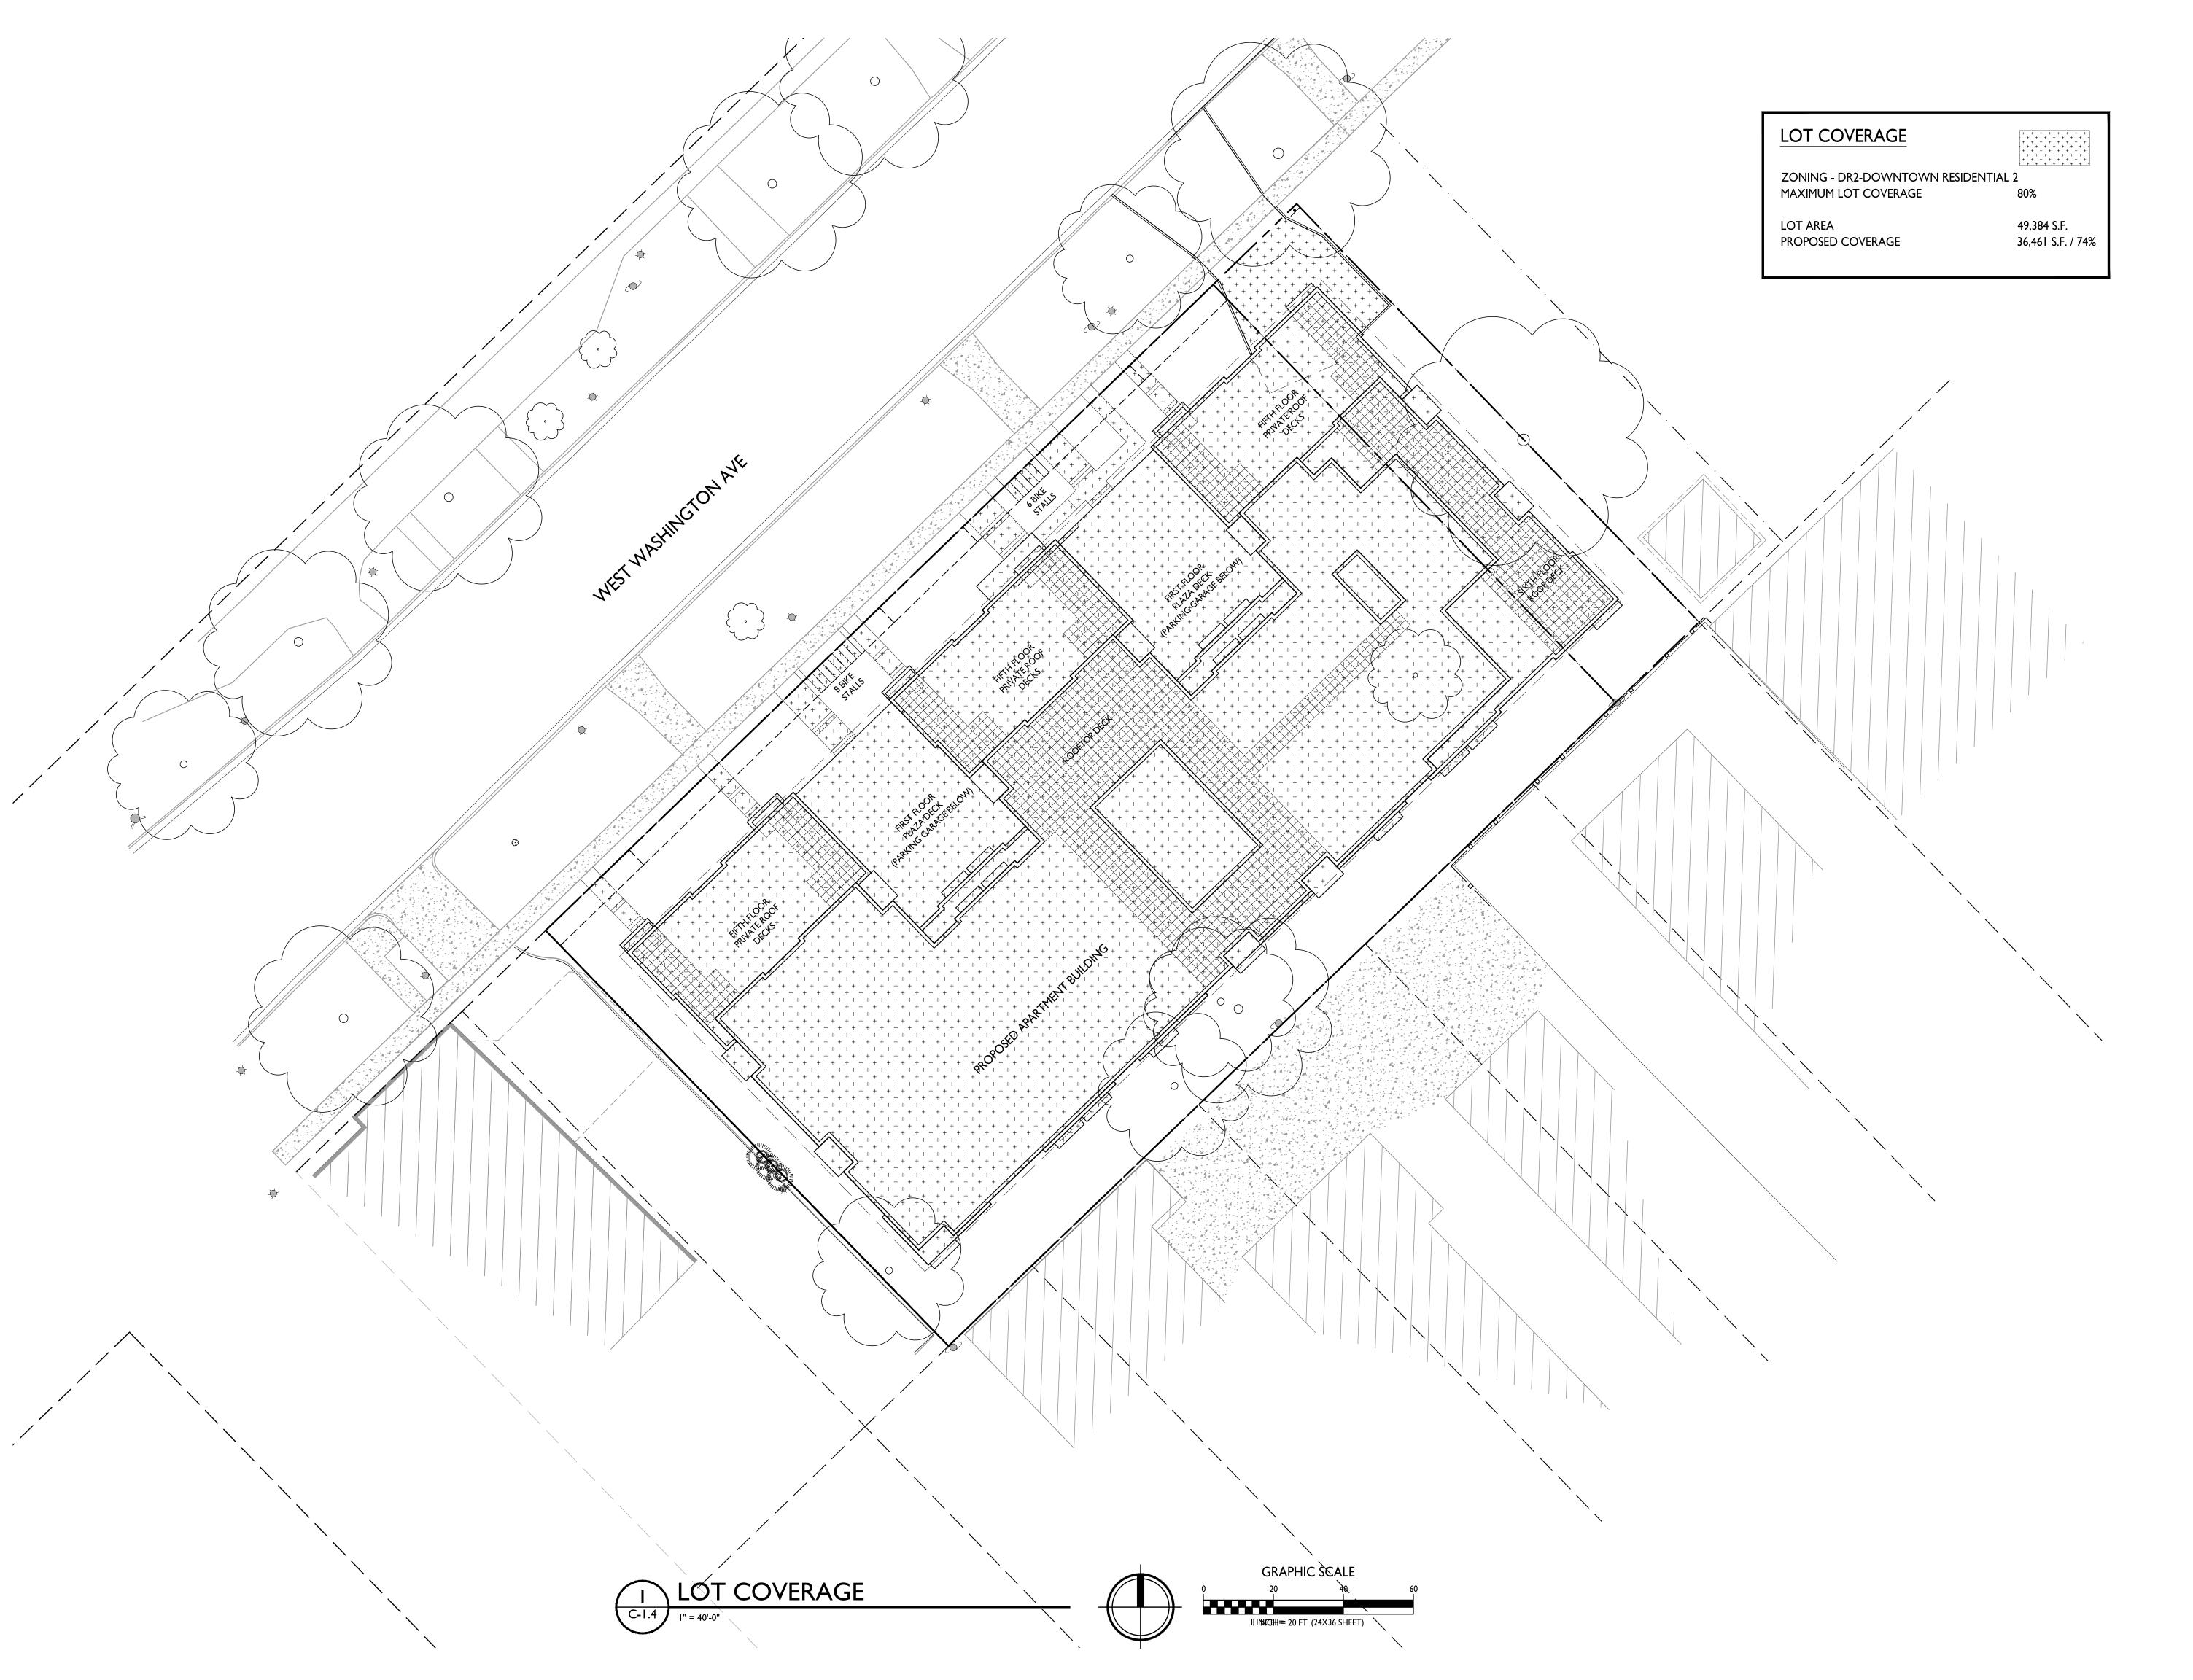

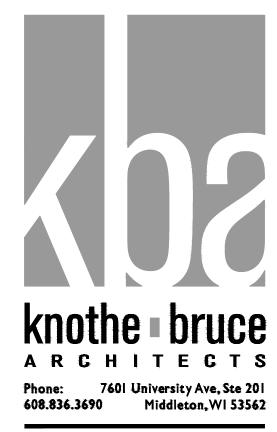

ISSUED
Issued for LUA & UDC Submittal - Feb. 28, 2022

PROJECT TITLE
West Washington
Development

519-547 W Washington Ave.

Madison, Wisconsin


SHEET TITLE

Lot Coverage

SHEET NUMBER

C-1.4

PROJECT NO. 2143

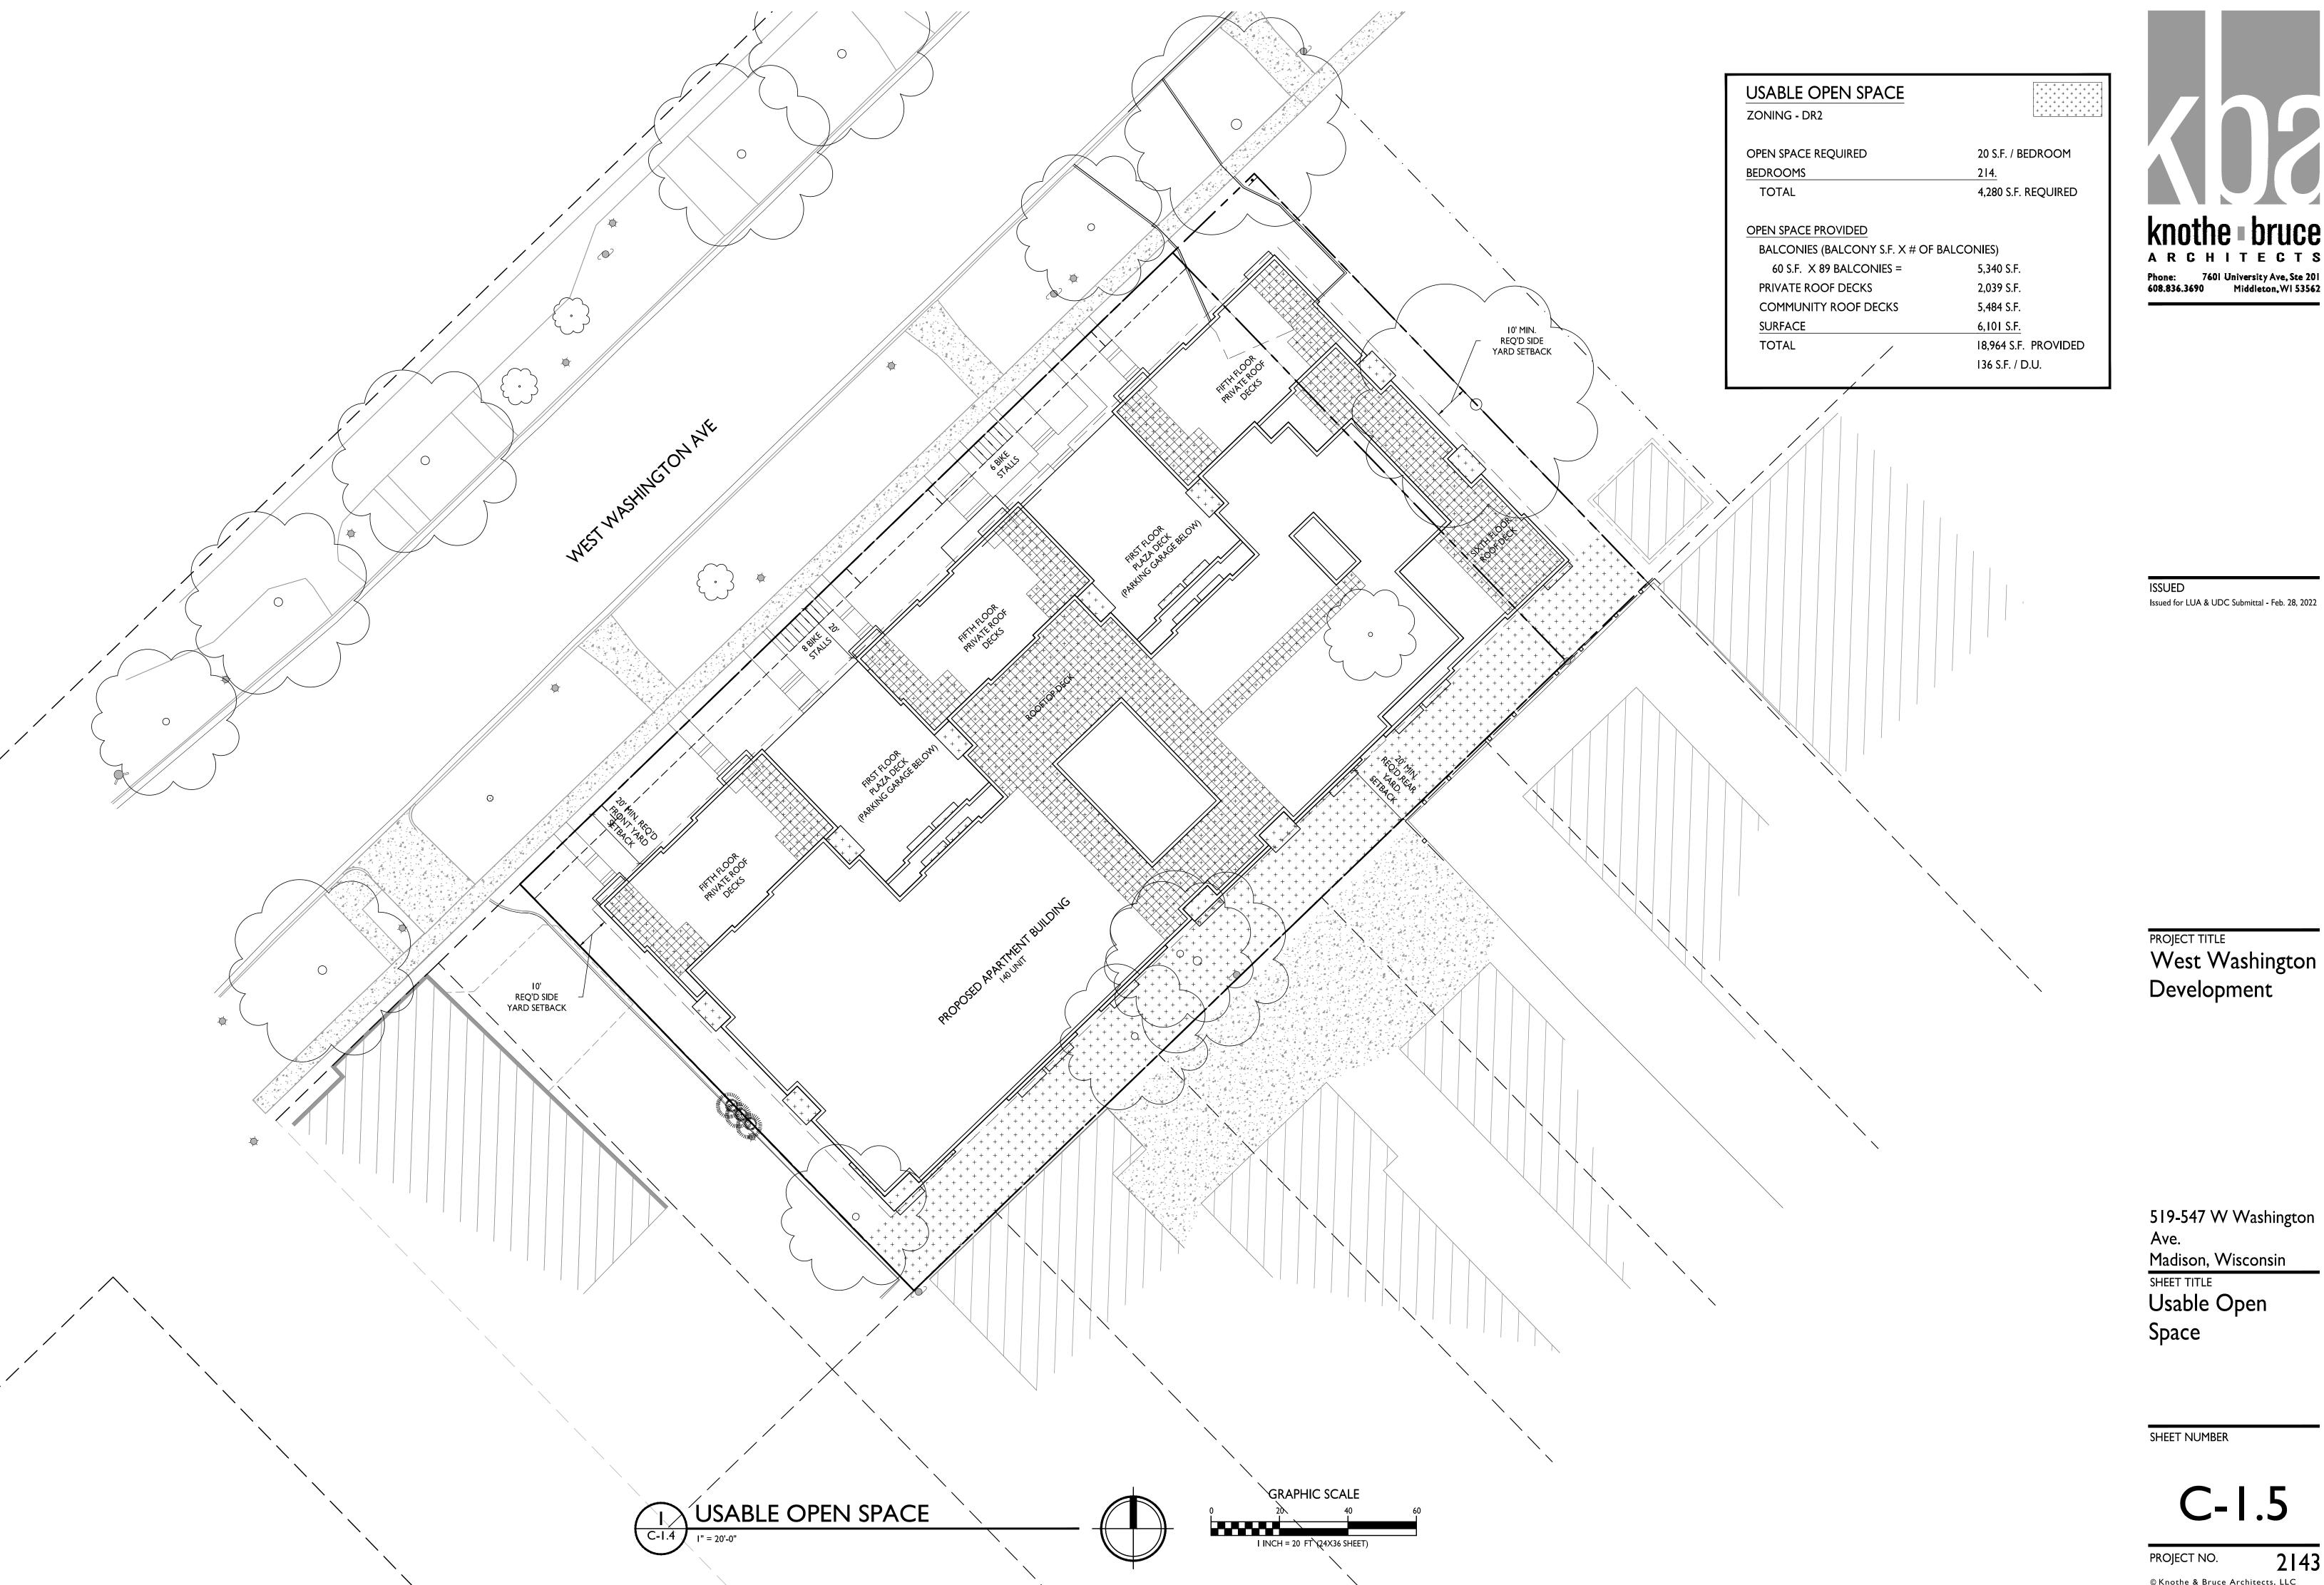

Phone: 7601 University Ave, Ste 201 608.836.3690 Middleton, WI 53562


PROJECT TITLE
West Washington

Ave.

Madison, Wisconsin

C-1.5

2143

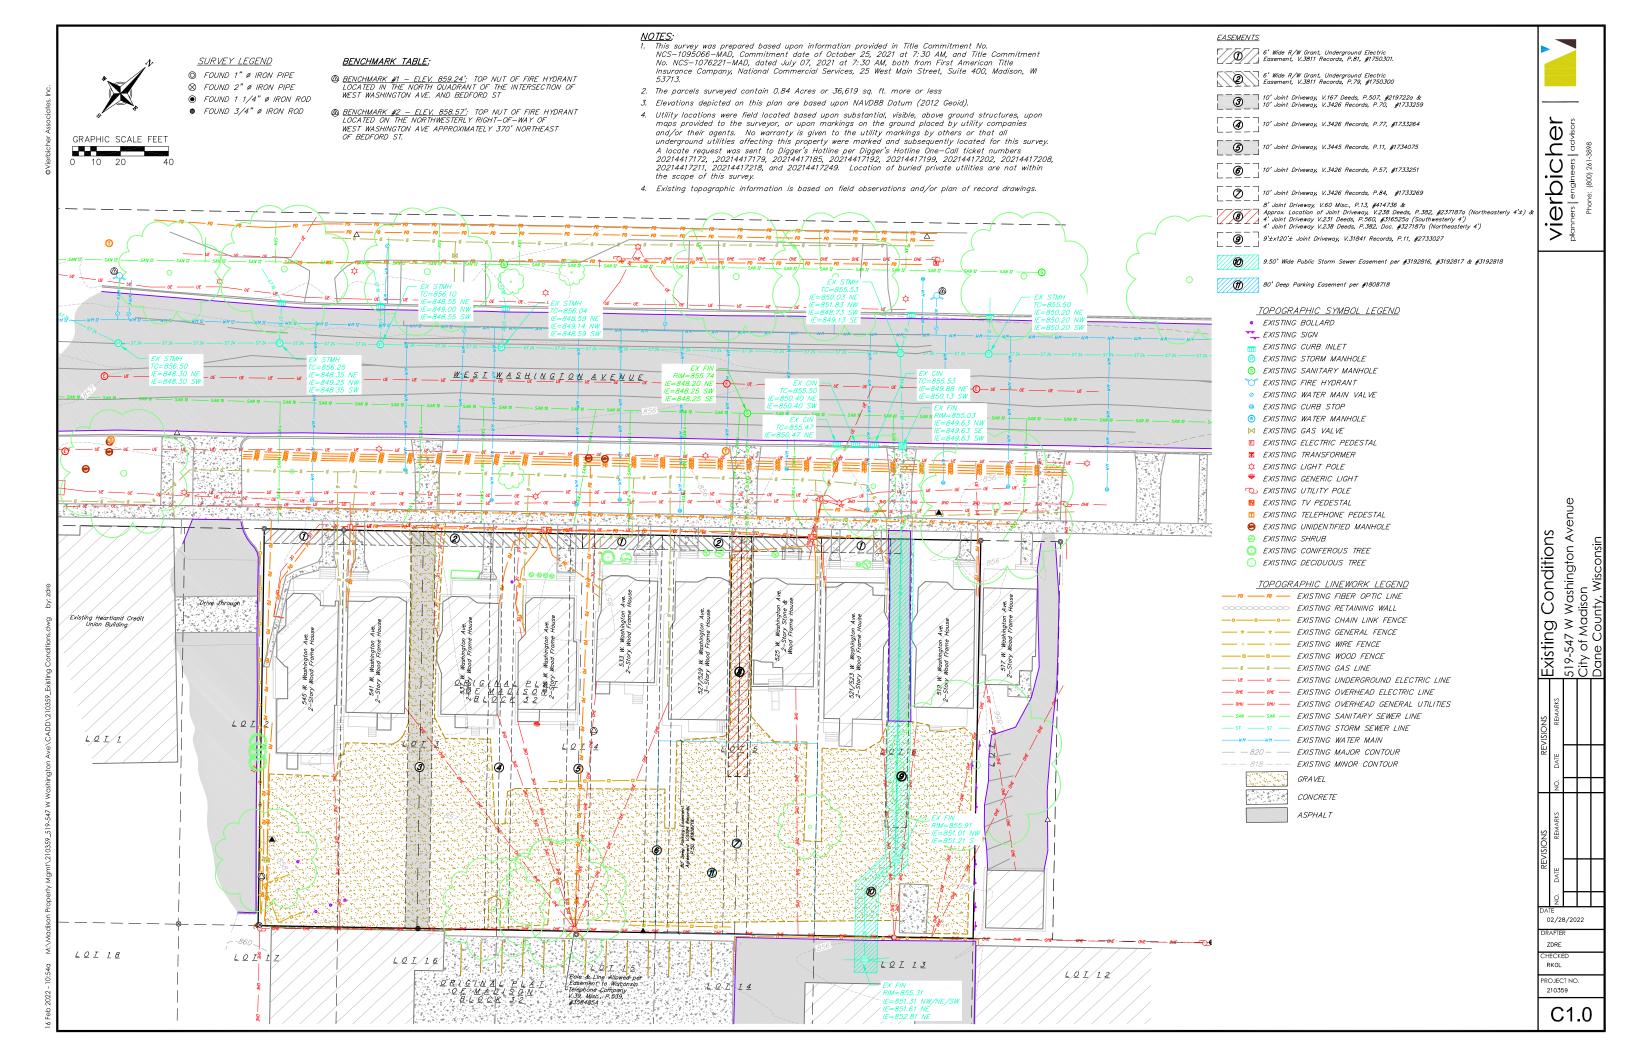



Vierbicher planners | engineers | advisors


9-547 W Washington A y of Madison ine County, Wisconsin Demolition Plan
519-547 w washington,
City of Madison

Avenue


02/28/2022 DRAFTER ZDRE CHECKED


RKOL PRO JECT NO 210359

C2.0

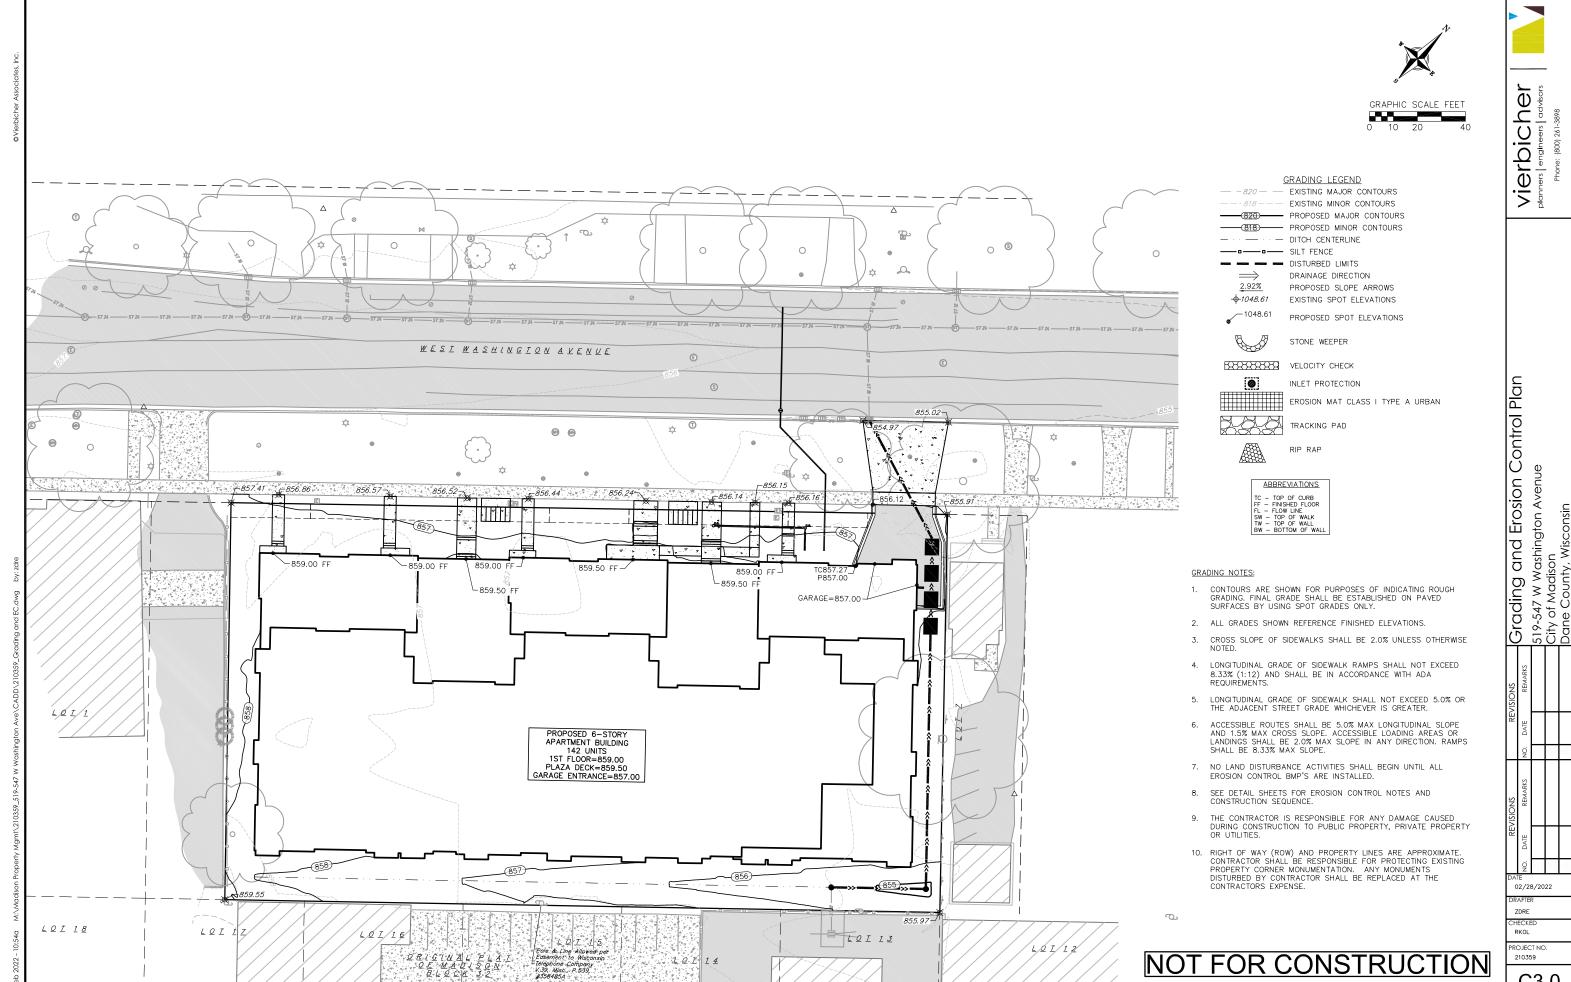

C3.0

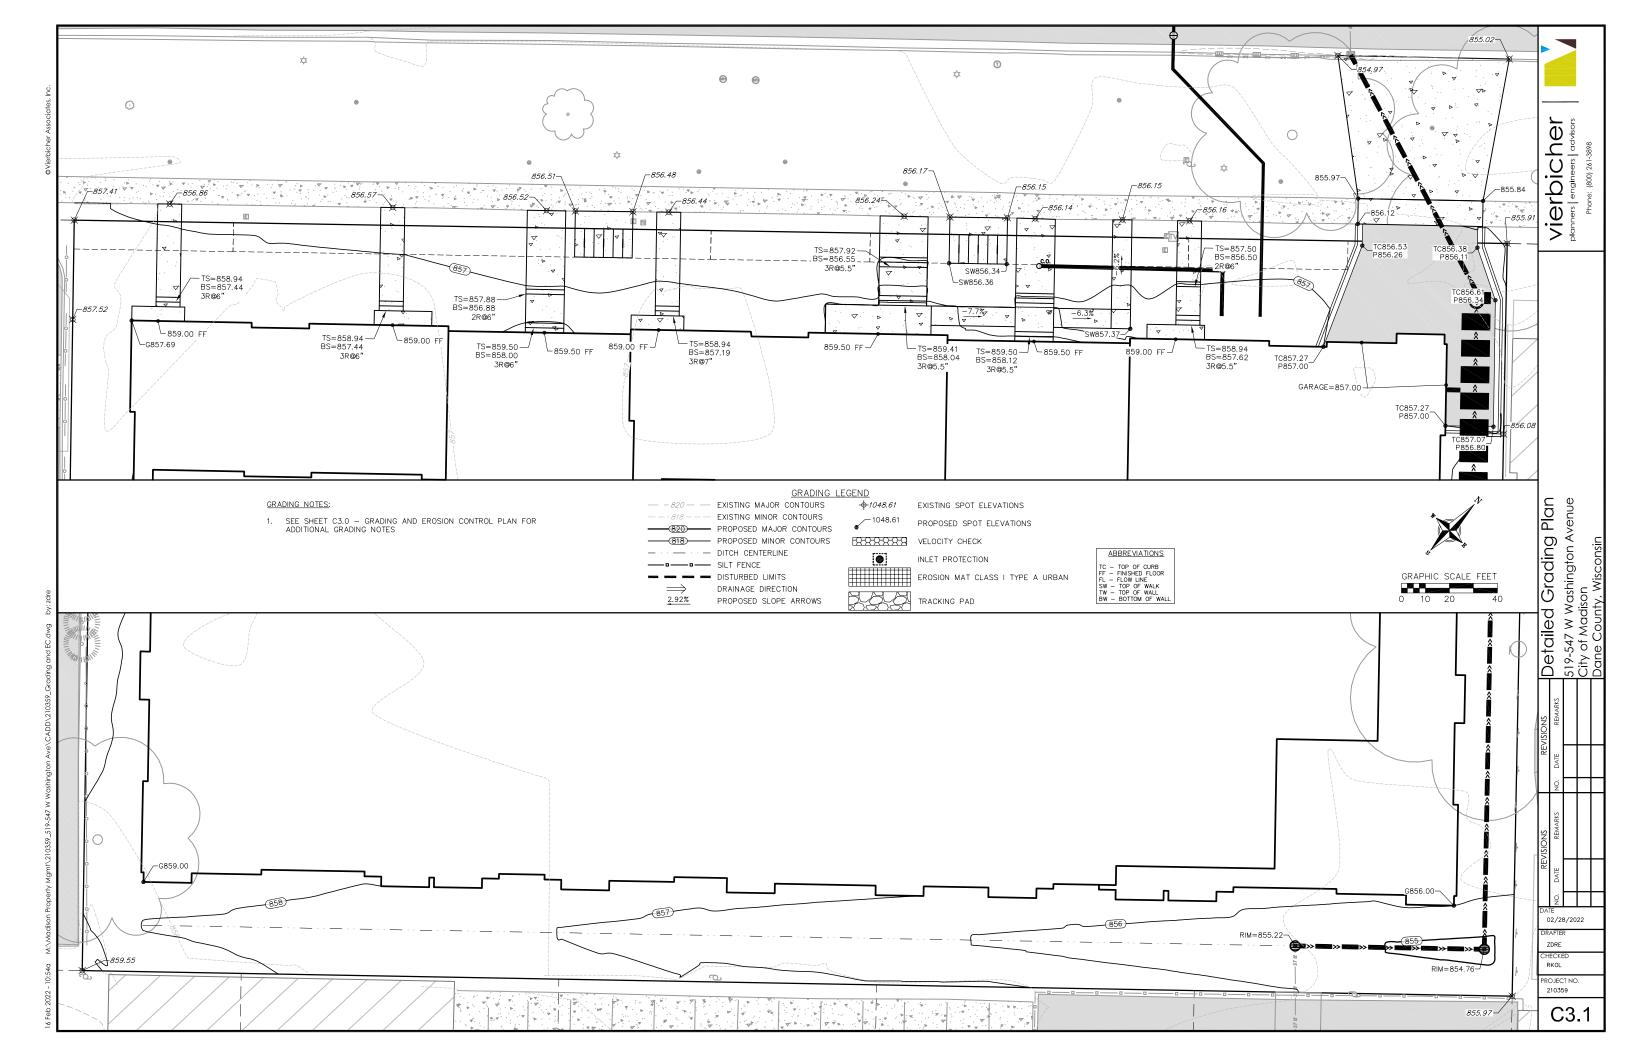

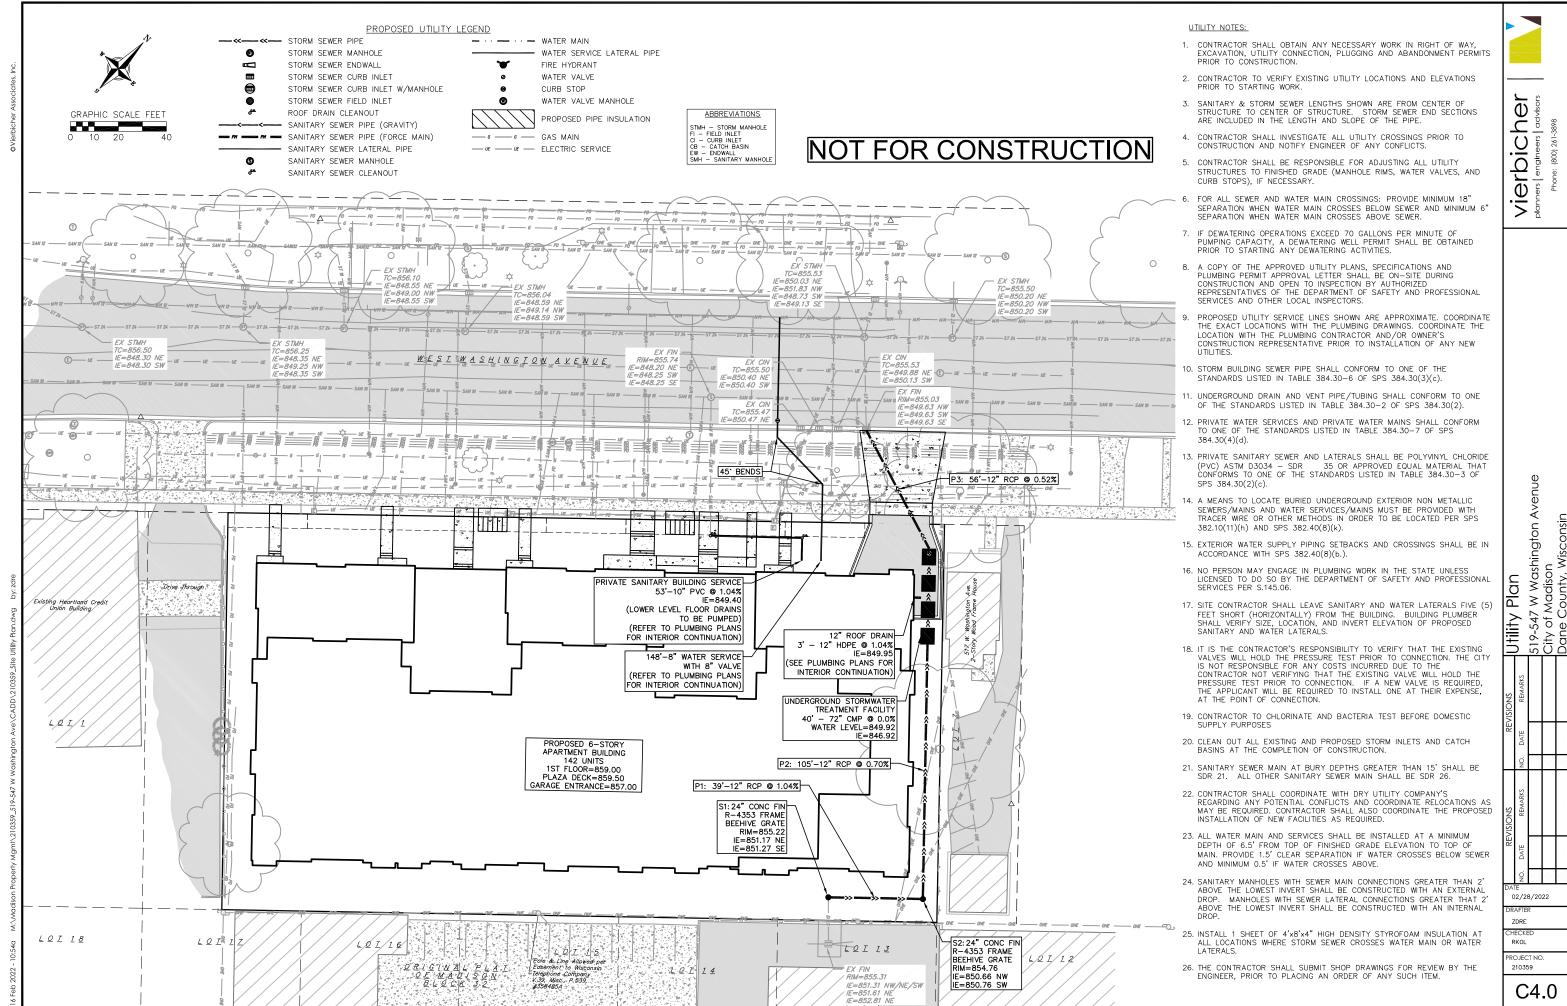

# EROSION CONTROL MEASURES

- EROSION CONTROL SHALL BE IN ACCORDANCE WITH THE CITY OF MADISON EROSION CONTROL ORDINANCE AND CHAPTER NR 216 OF THE WISCONSIN ADMINISTRATIVE CODE.
- 2. CONSTRUCT AND MAINTAIN ALL EROSION AND SEDIMENT CONTROL MEASURES IN ACCORDANCE WITH WISCONSIN DNR TECHNICAL STANDARDS (http://dnr.wi.gov/runoff/stormwater/techstds.htm) AND WISCONSIN CONSTRUCTION SITE BEST MANAGEMENT PRACTICE HANDBOOK.
- 3. INSTALL SEDIMENT CONTROL PRACTICES (TRACKING PAD, PERIMETER SILT FENCE, ETC.) PRIOR TO INITIATING OTHER LAND DISTURBING CONSTRUCTION ACTIVITIES.
- THE CONTRACTOR IS REQUIRED TO MAKE EROSION CONTROL INSPECTIONS AT THE END OF EACH WEEK AND WHEN 0.5 INCHES OF RAIN FALLS WITHIN 24 HOURS. INSPECTION REPORTS SHALL BE PREPARED AND FILED AS REQUIRED BY THE DNR AND/OR CITY. ALL MAINTENANCE WILL FOLLOW AN INSPECTION WITHIN 24
- 5. EROSION CONTROL IS THE RESPONSIBILITY OF THE CONTRACTOR UNTIL ACCEPTANCE OF THIS PROJECT. EROSION CONTROL MEASURES AS SHOWN SHALL BE THE MINIMUM PRECAUTIONS THAT WILL BE ALLOWED.

  ADDITIONAL EROSION CONTROL MEASURES, AS REQUESTED IN WRITING BY THE STATE OR LOCAL INSPECTORS, OR THE DEVELOPER'S ENGINEER, SHALL BE INSTALLED WITHIN 24 HOURS.
- A 3" CLEAR STONE TRACKING PAD SHALL BE INSTALLED AT THE END OF ROAD CONSTRUCTION LIMITS TO PREVENT SEDIMENT FROM BEING TRACKED ONTO THE ADJACENT PAVED PUBLIC ROADWAY. SEDIMENT TRACKING PAD SHALL CONFORM TO WISDNR TECHNICAL STANDARD 1057. SEDIMENT REACHING THE PUBLIC ROAD SHALL BE REMOVED BY STREET CLEANING (NOT HYDRAULIC FLUSHING) BEFORE THE END OF EACH
- 7. CHANNELIZED RUNOFF: FROM ADJACENT AREAS PASSING THROUGH THE SITE SHALL BE DIVERTED AROUND
- 8. <u>STABILIZED DISTURBED GROUND:</u> ANY SOIL OR DIRT PILES WHICH WILL REMAIN IN EXISTENCE FOR MORE THAN 7-CONSECUTIVE DAYS, WHETHER TO BE WORKED DURING THAT PERIOD OR NOT, SHALL NOT BE LOCATED WITHIN 25-FEET OF ANY ROADWAY, PARKING LOT, PAVED AREA, OR DRAINAGE STRUCTURE OR CHANNEL (UNLESS INTENDED TO BE USED AS PART OF THE EROSION CONTROL MEASURES). STABILIZATION AND CONTROL MEASURES (SEEDING, MULCHING, TARPING, EROSION MATTING, BARRIER FENCING, ETC.) ARE REQUIRED FOR THE PROTECTION OF DISTURBED AREAS AND SOIL PILES, WHICH WILL REMAIN UN-WORKED FOR A PERIOD OF MORE THAN 7-CONSECUTIVE CALENDAR DAYS. THESE MEASURES SHALL REMAIN IN PLACE UNTIL SITE HAS STABILIZED.
- SITE DE-WATERING: WATER PUMPED FROM THE SITE SHALL BE TREATED BY TEMPORARY SEDIMENTATION BASINS OR OTHER APPROPRIATE CONTROL MEASURES. SEDIMENTATION BASINS SHALL HAVE A DEPTH OF AT LEAST 3 FEET, BE SURROUNDED BY SNOWFENCE OR EQUIVALENT BARRIER AND HAVE SUFFICIENT SURFACE AREA TO PROVIDE A SURFACE SETTLING RATE OF NO MORE THAN 750 GALLONS PER SQUARE FOOT PER DAY AT THE HIGHEST DEWATERING PUMPING RATE. WATER MAY NOT BE DISCHARGED IN A MANNER THAT CAUSES EROSION OF THE SITE, A NEIGHBORING SITE, OR THE BED OR BANKS OF THE RECEIVING WATER. POLYMERS MAY BE USED AS DIRECTED BY DNR TECHNICAL STANDARD 1061
- 10. WASHED STONE WEEPERS OR TEMPORARY EARTH BERMS SHALL BE BUILT PER PLAN BY CONTRACTOR TO TRAP SEDIMENT OR SLOW THE VELOCITY OF STORM WATER.
- 11. RESTORATION (SEED, FERTILIZE AND MULCH) SHALL BE PER SPECIFICATIONS ON THIS SHEET UNLESS SPECIAL RESTORATION IS CALLED FOR ON THE LANDSCAPE PLAN OR THE DETENTION BASIN DETAIL SHEET.
- 12. TERRACES SHALL BE RESTORED WITH 6" TOPSOIL, PERMANENT SEED, FERTILIZER AND MULCH. LOTS SHALL BE RESTORED WITH 6" TOPSOIL, TEMPORARY SEED, FERTILIZER AND MULCH.
- 13. SEED, FERTILIZER AND MULCH SHALL BE APPLIED WITHIN 7 DAYS AFTER FINAL GRADE HAS BEEN ESTABLISHED. IF DISTURBED AREAS WILL NOT BE RESTORED IMMEDIATELY AFTER ROUGH GRADING, TEMPORARY SEED SHALL BE PLACED.
- FOR THE FIRST SIX WEEKS AFTER RESTORATION (E.G. SEED & MULCH, EROSION MAT, SOD) OF A DISTURBED AREA. INCLUDE SUMMER WATERING PROVISIONS OF ALL NEWLY SEEDED AND MULCHED AREAS WHENEVER 7 DAYS ELAPSE WITHOUT A RAIN EVENT.
- 15. SOIL STABILIZERS SHALL BE APPLIED TO DISTURBED AREAS WITH SLOPES BETWEEN 10% AND 3:1 (DO NOT USE IN CHANNELS). SOIL STABILIZERS SHALL BE TYPE B, PER WISCONSIN D.O.T. P.A.L. (PRODUCT ACCEPTABILITY LIST), OR EQUAL. APPLY AT RATES AND METHODS SPECIFIED PER MANUFACTURER/THIS SHEET. SOIL STABILIZERS SHALL BE RE-APPLIED WHENEVER VEHICLES OR OTHER EQUIPMENT TRACK ON
- 16. SILT FENCE OR EROSION MAT SHALL BE INSTALLED ALONG THE CONTOURS AT 100 FOOT INTERVALS DOWN THE SLOPE ON THE DISTURBED SLOPES STEEPER THAN 5% AND MORE THAN 100 FEET LONG THAT SHEET FLOW TO THE ROADWAY UNLESS SOIL STABILIZERS ARE USED.
- 17. SILT FENCE TO BE USED ACROSS AREAS OF THE LOT THAT SLOPE TOWARDS A PUBLIC STREET OR
- 18. SEDIMENT SHALL BE CLEANED FROM CURB AND GUTTER AFTER EACH RAINFALL AND PRIOR TO PROJECT ACCEPTANCE.
- 19. ALL CONSTRUCTION ENTRANCES SHALL HAVE TEMPORARY ROAD CLOSED SIGNS THAT WILL BE IN PLACE WHEN THE ENTRANCE IS NOT IN USE AND AT THE END OF EACH DAY.
- 20. ANY PROPOSED CHANGES TO THE EROSION CONTROL PLAN MUST BE SUBMITTED AND APPROVED BY DANE COUNTY LAND CONSERVATION OR PERMITTING MUNICIPALITY.
- 21. THE CITY, OWNER AND/OR ENGINEER MAY REQUIRE ADDITIONAL EROSION CONTROL MEASURES AT ANY TIME

# CONSTRUCTION SEQUENCE:

- 1. INSTALL SILT FENCE AND TRACKING
- 2. DEMOLISH EXISTING BUILDINGS
- 3. ROUGH GRADE SITE
- 4. EXCAVATE AND CONSTRUCT BUILDING FOUNDATION
- 5. CONSTRUCT UNDERGROUND UTILITIES
- 6. INSTALL INLET PROTECTION
- 7. CONSTRUCT BUILDING
- 8. CONSTRUCT PAVEMENT (STONE BASE, CURB & GUTTER, AND SIDEWALK)
- 9. RESTORE TERRACES
- 10. REMOVE TRACKING PAD AND SIL FENCE AFTER DISTURBED AREAS ARE

# SEEDING RATES:

- USE ANNUAL OATS AT 3.0 LB./1,000 S.F. FOR SPRING AND SUMMER PLANTINGS.
- 2. USE WINTER WHEAT OR RYE AT 3.0 LB./1,000 SF FOR FALL PLANTINGS STARTED

AFTER SEPTEMBER 15.

# PERMANENT:

USE WISCONSIN D.O.T. SEED MIX #40 AT 2 LB./1,000 S.F.

# FERTILIZING RATES


# TEMPORARY AND PERMANENT:

USE WISCONSIN D.O.T. TYPE A OR B AT 7 LB./1,000 S.F.

# MULCHING RATES:

# TEMPORARY AND PERMANENT:

USE ½" TO 1-½" STRAW OR HAY MULCH, CRIMPED PER SECTION 607.3.2.3, OR OTHER RATE AND METHOD PER SECTION 627, WISCONSIN D.O.T. STANDARD SPECIFICATIONS FOR HIGHWAY AND STRUCTURE CONSTRUCTION

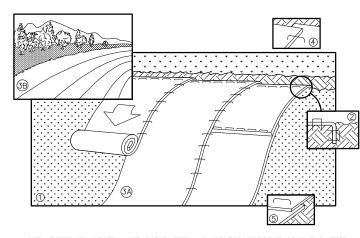


NOTE: REFER TO GENERAL STAPLE PATTERN GUIDE FOR CORRECT STAPLE PATTERN RECOMMENDATIONS FOR SLOPE INSTALLATIONS.

- 1. PREPARE SOIL BEFORE INSTALLING BLANKETS, INCLUDING APPLICATION OF FERTILIZER AND SEED.
  NOTE: WHEN USING CELL-O-SEED, DO NOT SEED PREPARED AREA.
- CELL-O-SEED MUST BE INSTALLED WITH PAPER SIDE DOWN.
  BEGIN AT THE TOP OF THE SLOPE BY ANCHORING THE BLANKET IN 6" DEEP
- BY 6" WDE TRENCH. BACKFILL AND COMPACT THE TRENCH AFTER STAPLING. ROLL THE BLANKETS <A.> DOWN, OR <B.> HORIZONTALLY ACROSS THE SLOPE
- 4. THE EDGES OF PARALLEL BLANKETS MUST BE STAPLED WITH APPROXIMATELY 2" OVERLAP WHEN BLANKETS MUST BE SPLICED DOWN THE SLOPE, PLACE BLANKETS END OVER END (SHINGLE STYLE) WITH APPROXIMATELY 4" OVERLAP. STAPLE
- THROUGH OVERLAPPED AREA, APPROXIMATELY 12" APART.
  ALL BLANKETS MUST BE SECURELY FASTENED TO THE SLOPE BY PLACING
- STAPLES/STAKES IN APPROPRIATE LOCATIONS AS RECOMMENDED BY THE MANUFACTURER


EROSION MAT

NOT TO SCALE

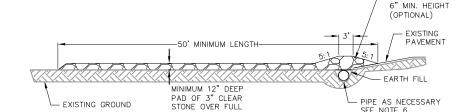

LENGTH AND WIDTH

OF STRUCTURE

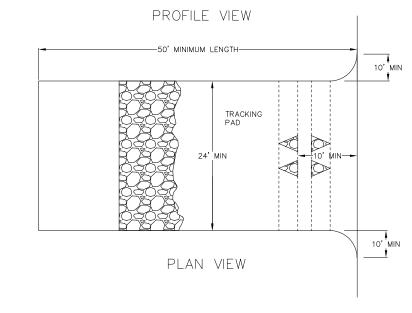


- 1. FOLLOW WISCONSIN DNR TECHNICAL STANDARD 1057 FOR FURTHER DETAILS AND INSTALLATION.
- 2. LENGTH MINIMUM OF 50'
- 3. WIDTH 24' MINIMUM, SHOULD BE FLARED AT THE EXISTING ROAD TO PROVIDE A TURNING RADIUS.

TRACKING PAD

NOT TO SCALE

- 4. ON SITES WITH A HIGH GROUND WATER TABLE OR WHERE SATURATED CONDITIONS EXIST, GEOTEXTILE FABRIC SHALL BE PLACED OVER EXISTING GROUND PRIOR TO PLACING STONE. FABRIC SHALL BE WISDOT TYPE—HR GEOTEXTILE FABRIC.
- 5. STONE CRUSHED 3" CLEAR STONE SHALL BE PLACED AT LEAST 12" DEEP OVER THE ENTIRE LENGTH AND WIDTH OF ENTRANCE.
- 6. SURFACE WATER ALL SURFACE WATER FLOWING TO OR DIVERTED TOWARDS CONSTRUCTION ENTRANCES SHALL BE PIPED THROUGH THE ENTRANCE. MAINTAINING POSITIVE DRAIMAGE. PIPE INSTALLED THROUGH THE STABILIZED CONSTRUCTION ENTRANCE SHALL BE PROTECTED WITH A MOUNTABLE BERM WITH 5:1 SLOPES AND MINIMIUM OF 6" STONE OVER THE PIPE. PIPE SHALL BE SIZED ACCORDING TO THE DRAIMAGE REQUIREMENTS. WHEN THE ENTRANCE IS LOCATED AT A HIGH SPOT AND HAS NO DRAIMAGE TO CONVEY A PIPE SHALL NOT BE NECESSARY. THE MINIMUM PIPE DIAMETER SHALL BE 6". CONTRACTOR SHALL BE RESPONSIBLE
- 7. LOCATION A STABILIZED CONSTRUCTION ENTRANCE SHALL BE LOCATED WHERE CONSTRUCTION TRAFFIC ENTERS AND/OR LEAVES THE CONSTRUCTION SITE. VEHICLES LEAVING THE SITE MUST TRAVEL OVER THE ENTIRE LENGTH OF THE TRACKING PAD.

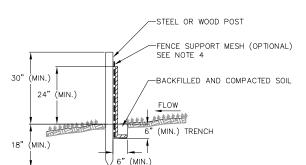

C5.0

INSTALL SILT FENCE TO FOLLOW THE GROUND CONTOURS AS CLOSELY AS POSSIBLE.

MOUNTABLE BERM

- 2. CURVE THE SILT FENCE UP THE SLOPE TO PREVENT WATER FROM RUNNING AROUND THE ENDS.
- 3. POST SPACING WITH FENCE SUPPORT MESH = 10 FT. (MAX.)

POST SPACING WITHOUT FENCE SUPPORT MESH = 6 FT. (MAX.)

4. SILT FENCE SUPPORT MESH CONSISTS OF 14-GAUGE STEEL WIRE WITH A MESH SPACING OF 6 IN. X 6 IN. OR PREFABRICATED
POLYMERIC MESH OF EQUIVALENT STRENGTH





Vier


Avenu 519-547 W Washington A City of Madison Det ction onstru

02/28/2022 7DRF

RKOL PRO IECT NO


210359

C5.0

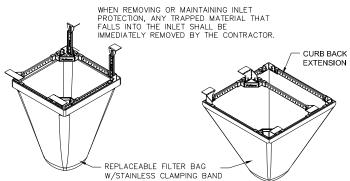

FLEXSTORM CATCH-IT INLET FITLERS FOR ROLLED CURB

FLEXSTORM CATCH-IT INLET FITLERS FOR CURB BOX OPENINGS (MAGNETIC CURB FLAP)

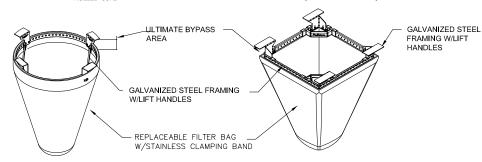

FLEXSTORM CATCH-IT INLET FILTERS FOR ROUND OPENINGS


FLEXSTORM CATCH-IT INLET FITLERS FOR SQUARE/RECTANGULAR OPENINGS

NEENAH CASTING	INLET TYPE	GRATE SIZE	OPENING SIZE	ADS P/N
1040/1642/1733	ROUND	26	24	62MRDFX
3067 W/FLAP	CURB BOX	35.25 X 17.75	33.0 X 15.0	62LCBEXTFX
3067 EXTENDED BACK	CURB BOX	35.25 X 17.75	33.0 X 15.0	62LCBEXTFX
3246A	CURB BOX	35.75 X 23.875	33.5 X 21.0	62LCBFX
3030	SQUARE/RECT	23 X 16	20.5 X 13.5	62MCBFX
3067-C	SQUARE/RECT	35.25 X 17.75	33 X 15	62LSQFX




# FRAMED INLET PROTECTION

NOT TO SCALE

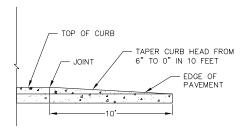


PROFILE VIEW


CURB & GUTTER TERMINATION NOT TO SCALE

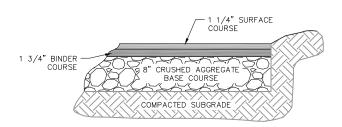


BITUMINOUS PAVEMENT

SITE PAVEMENT NOT TO SCALE

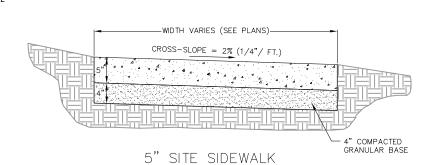

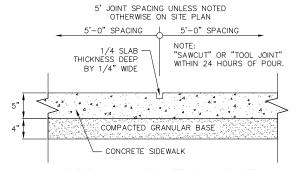


SIDEWALK CONTROL JOINT

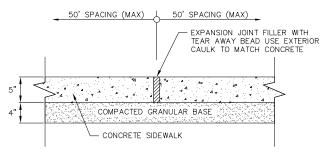


SIDEWALK EXPANSION JOINT




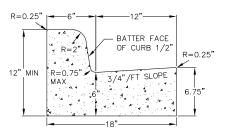


CURB AND GUTTER CROSS SECTION

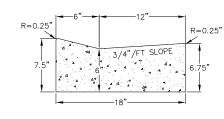

DRIVEWAY GUTTER CROSS SECTION

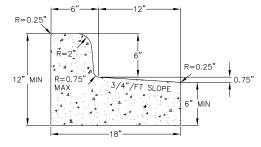


CURB AND GUTTER REJECT SECTION

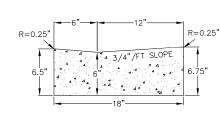

HANDICAP RAMP GUTTER CROSS SECTION



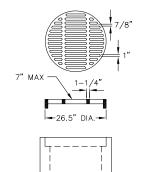

BARREL l<del>--</del>24" DIA.-

IN BELL GRATE IN CUSTOM MANUFACTURED BY THE WESTWICK FOUNDRY COMPANY TO MADISON CONCRETE PIPE SPECIFICATIONS

GRATE IS CAST GRAY IRON MANUFACTURED TO MEET ASTM A-48 CLASS 35 B AND AASHTO M105 SPECIFICATIONS

GRATES ARE AASHTO H20 LOAD RATED

GRATE SETS FLUSH WITH TOP OF CATCH BASIN BELL

PRECAST REINFORCED CONCRETE CATCH BASIN IN MANUFACTURED TO MEET ASTM C-478 AND AASHTO M199 SPECIFICATIONS STANDARD CATCH BASIN BARREL HEIGHTS:

2'-0", 3'-0" OR 4'-0" CATCH BASIN STOCK 24" DIA. CATCH BASIN HAS NO BASE, BUT MAY BE ORDERED WITH A 3"
THICK INTEGRAL BASE OR AS SPECIFIED

> CATCH BASIN JOINT MATERIAL: CONSEAL CS-102 AND/OR CS-202 OR EQUIVALENT WHICH MEETS OR EXCEEDS FEDERAL SPECIFICATION SS-S-210 (210A), AASHTO M-198B AND ASTM C-990

PIPE TO CATCH BASIN CONNECTORS: KOR-N-SEAL OR EQUIVALENT WHICH MEETS OR EXCEEDS REQUIREMENTS OF ASTM C-923



24" DIA. CATCH BASIN & GRATE



Vierbicher planners | advisors

Construction Details
519-547 W Washington Avenue
City of Madison
Dane County, Wisconsin 02/28/2022 ZDRE

CHECKE RKOL PROJECT NO. 210359

C5.1

# PLANT SCHEDULE

UNDERSTORY TREES Al Cb	BOTANICAL / COMMON NAME Amelanchier laevis / Allegheny Serviceberry Carpinus caroliniana 'J.N. Globe' TM / Ball O' Fire American Hornbeam	ROOT COND. B & B B & B	<u>SIZE</u> 7'ht. 2"Cal	NOTES Multi-Stem	<u>QTY</u> 3 2
DECIDUOUS SHRUBS Hpj Hpq Po Rg Sm	BOTANICAL / COMMON NAME Hydrangea paniculata 'Jane' TM / Little Lime Hydrangea Hydrangea paniculata 'Little Quick Fire' / Little Quick Fire Hydrangea Physocarpus opulifolius 'Donna May' TM / Little Devil Ninebark Ribes alpinum 'Green Mound' / Green Mound Alpine Currant Syringa meyeri 'Palibin' / Dwarf Korean Lilac	ROOT COND. Cont. Cont. Cont. Cont. Cont.	<u>SIZE</u> 5 Gal. 5 Gal. 5 Gal. 3 Gal. 7 Gal.	<u>NOTES</u>	QTY 8 12 21 24 3
EVERGREEN SHRUBS Jfs Tm Tom Toh	BOTANICAL / COMMON NAME Juniperus chinensis 'Sea Green' / Sea Green Juniper Taxus x media 'Everlow' / Everlow Yew Thuja occidentalis 'Hetz Midget' / Hetz Midget Arborvitae Thuja occidentalis 'Holmstrup' / Holmstrup Cedar	ROOT COND. Cont. Cont. Cont. B & B	<u>SIZE</u> 5 Gal. 5 Gal. 5 Gal. 5' ht.	NOTES	QTY 6 19 12 2
PERENNIALS ad cl pvh pvs sn	BOTANICAL / COMMON NAME Astilbe x 'Delft Lace' / Delft Lace Astilbe Chasmanthium latifolium / Northern Sea Oats Panicum virgatum 'Heavy Metal' / Heavy Metal Switch Grass Panicum virgatum 'Shenandoah' / Shenandoah Red Switch Grass Salvia nemorosa 'Blue Hill' / Woodland Sage	ROOT COND. Cont. Cont. Cont. Cont. Cont. Cont. Cont.	<u>SIZE</u> 1 Gal. 1 Gal. 1 Gal. 1 Gal. 1 Gal.	NOTES	QTY 10 56 34 20 5

BASIN SEED SCHEDULE

STORMWATER BASIN SEED MIX 835 sf



GRAPHIC SCALE FEET

# PLANT MATERIAL NOTES:

- 1. ALL PLANTINGS SHALL CONFORM TO QUALITY REQUIREMENTS AS PER ANSI 760.1.
- 2. ALL PLANT MATERIAL SHALL BE TRUE TO SPECIES, VARIETY AND SIZE SPECIFIED, NURSERY GROWN IN ACCORDANCE WITH GOOD HORTICULTURAL PRACTICES, AND UNDER CLIMATIC CONDITIONS SIMILAR TO THOSE OF THE PROJECT SITE.
- 3. CONTACT LANDSCAPE ARCHITECT, IN WRITING, TO REQUEST ANY PLANT MATERIAL SUBSTITUTIONS DUE TO AVAILABILITY ISSUES.
- ALL PLANTS SHALL BE GUARANTEED TO BE IN HEALTHY AND FLOURISHING CONDITION DURING THE GROWING SEASON FOLLOWING INSTALLATION. ALL PLANT MATERIAL SHALL BE GUARANTEED FOR ONE YEAR FROM THE TIME OF INSTALLATION.

# LANDSCAPE MATERIAL NOTES:

- 1. CONTRACTOR SHALL PROVIDE A SUITABLE AMENDED TOPSOIL BLEND FOR ALL PLANTING AREAS WHERE SOIL CONDITIONS ARE UNSUITABLE FOR PLANT GROWTH. TOPSOIL SHALL CONFORM TO QUALITY REQUIREMENTS AS PER SECTION 625.2(1) OF THE "STANDARD SPECIFICATIONS FOR HIGHWAY CONSTRUCTION." PROVIDE A MINIMUM OF 18" OF TOPSOIL IN ALL PLANTING AREAS AND 6" OF TOPSOIL IN AREAS TO BE SEEDED/SODDED.
- 2. LANDSCAPE BEDS TO BE MULCHED WITH UNDYED SHREDDED HARDWOOD BARK MULCH TO 3" DEPTH MIN. AND EDGED WITH COMMERCIAL GRADE ALUMINUM LANDSCAPE EDGING, PERMALOC CLEANLINE  $\frac{3}{16}$ "X4" OR EQUAL, COLOR BLACK ANODIZED.
- 3. ALL TREES AND/OR SHRUBS PLANTED IN LAWN AREAS TO BE INSTALLED WITH A 5' DIAMETER MULCH RING AND SHOVEL CUT EDGE. A PRE-EMERGENT GRANULAR HERBICIDE WEED-PREVENTER SHOULD BE MIXED WITH MULCH AS WELL AS TOPICALLY APPLIED TO TREE RING.

# SEEDING NOTES:

- 1. ALL DISTURBED AREAS, UNLESS OTHERWISE NOTED, TO BE SEEDED WITH 'MADISON PARKS' MIX BY 'LACROSSE SEED COMPANY' OR EQUIVALENT, PER MANUFACTURER'S SPECIFIED APPLICATION RATES. ALL SEEDED AREAS ARE TO BE WATERED DAILY TO MAINTAIN ADEQUATE SOIL MOISTURE FOR PROPER GERMINATION. AFTER VIGOROUS GROWTH IS ESTABLISHED, APPLY  $\frac{1}{2}$ " WATER TWICE WEEKLY UNTIL FINAL ACCEPTANCE.
- 2. ALL AREAS NOTED ON PLAN AS STORMWATER BASIN SEEDING, INSTALL 'DETENTION BASIN BIOSWALE' SEED MIX BY 'PRAIRIE NURSERY'. INSTALL PER MANUFACTURER'S SPECIFIED APPLICATION RATES. ALL SEEDED AREAS ARE TO BE WATERED DAILY TO MAINTAIN ADEQUATE SOIL MOISTURE FOR PROPER GERMINATION. AFTER VIGOROUS GROWTH IS ESTABLISHED, APPLY 1 WATER TWICE WEEKLY UNTIL FINAL ACCEPTANCE.

										_
Address:	525-547 W Washi	ngton	Date:	02.28.2022						
Total Square Footage o Area:	of Developed	(Site Area)	49,384	-		ootprint at ade)	33,919	=	15465	sf
Total Landscape Point	s Required (<5 ac):	15,465	/ 300 =	52	2 x 5 = 258		258			
Lansdcape Poir	nts Requried >5 ac:	0	/ 100 =	0	x 1 =	-	1 1	258		
				s/ Existing Iscaping		roposed caping				
Plant Type/ Element	Min. Size at Installation	Points	Quantity	Points Achieved	Quantity	Points Achieved				
Overstory deciduous tree	2.5" cal	35		0		0				
Tall Evergreen Tree	5-6 feet tall	35		0		0				
Ornamental tree	1.5" cal	15		0	5	75				
Upright evergreen shrub	3-4 feet tall	10		0	2	20				
Shrub, deciduous	#3 gallon container size, Min. 12-24"	3		0	68	204				
Shrub, evergreen	#3 gallon container size, Min. 12-24"	4		0	37	148				
Ornamental grasses/perennials	#1 gallon container size, Min. 8-18"	2		0	125	250				
Ornamental/decorative fencing or wall	n/a	4 per 10 LF		0		0				
Existing significant specimen tree	Min. Size 2.5" cal. Trees must be within developed area and cannot comprise more than 30% of total required points.	14 per caliper inch. Max. points per tree: 200		0		0				
Landscape Furniture for public seating and/or transit connections	Furniture must be within developed area, publicly accessible, and cannot comprise more than 5% of total required points	5 points per "seat"		0		0				
Sub Totals				0		697				
			Total Dai	nts Provided:	697					

NOT FOR CONSTRUCTION


vierbiche

Avenue 519-547 W Washington A City of Madison andscape Plan

02/28/2022 AKAN RKOL

PROJECT NO. 210359

L1.0

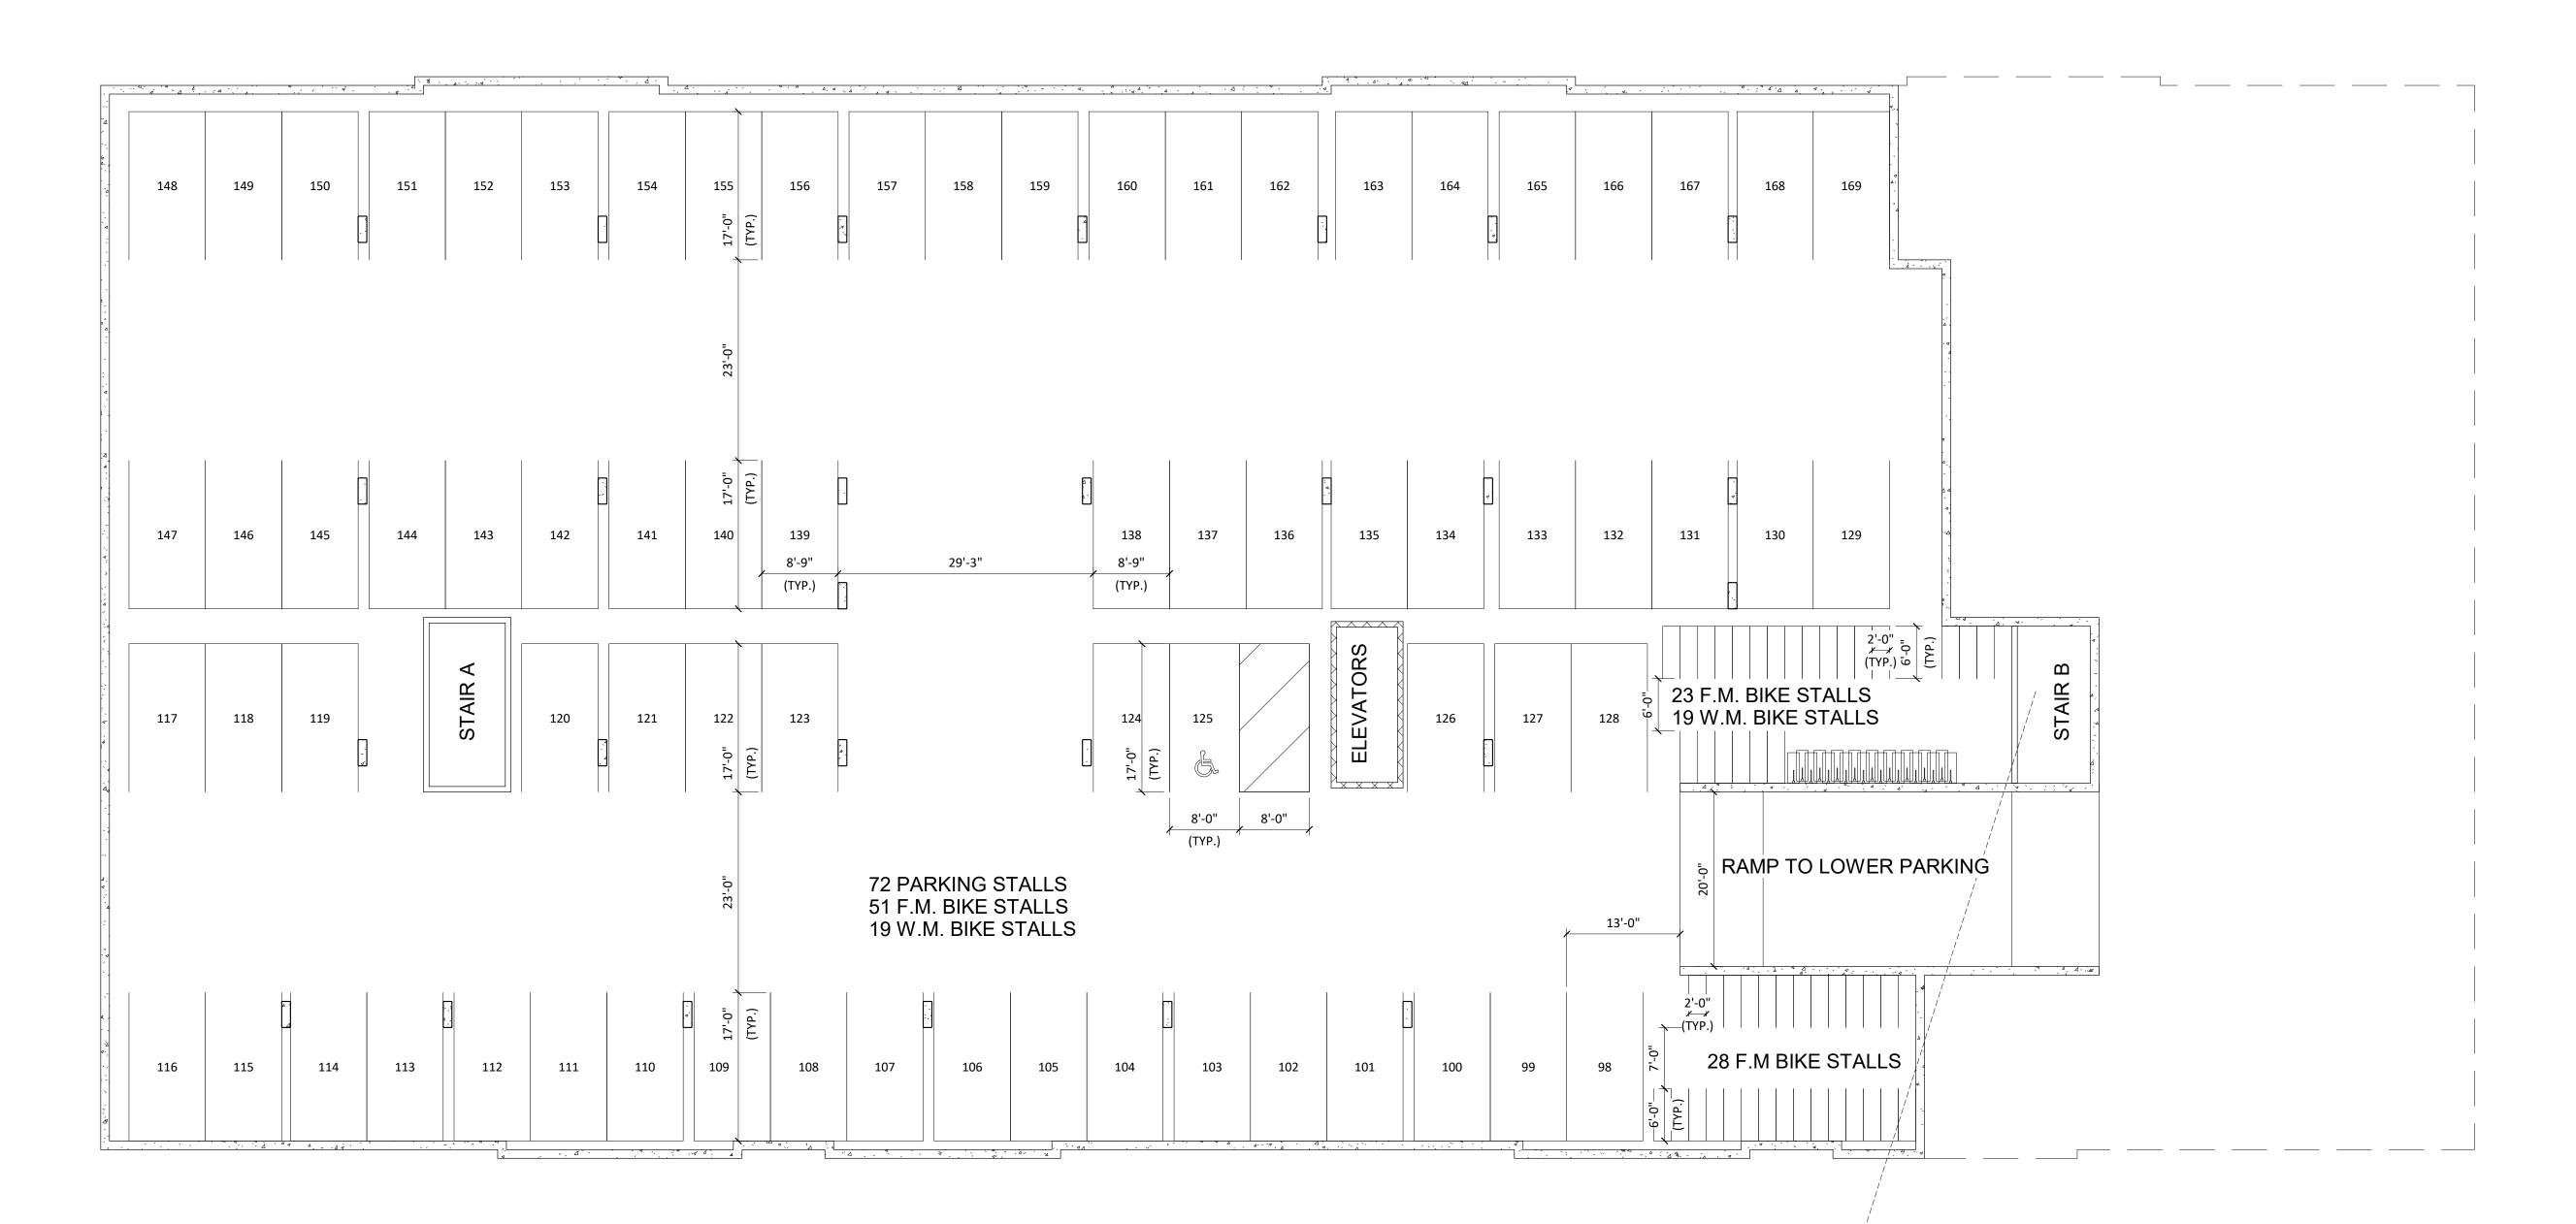

1 -00 - LOWER BASEMENT A-0.0 3/32" = 1'-0"

PROJECT TITLE

West Washington Development

608.836.3690 Middleton, WI 53562

TRUE NORTH

**KEY PLAN** 

525-547 W Washington Ave.

Madison, Wisconsin


SHEET TITLE

LOWER

**BASEMENT** FLOOR PLAN

SHEET NUMBER

A-0.0 PROJECT NUMBER 2143

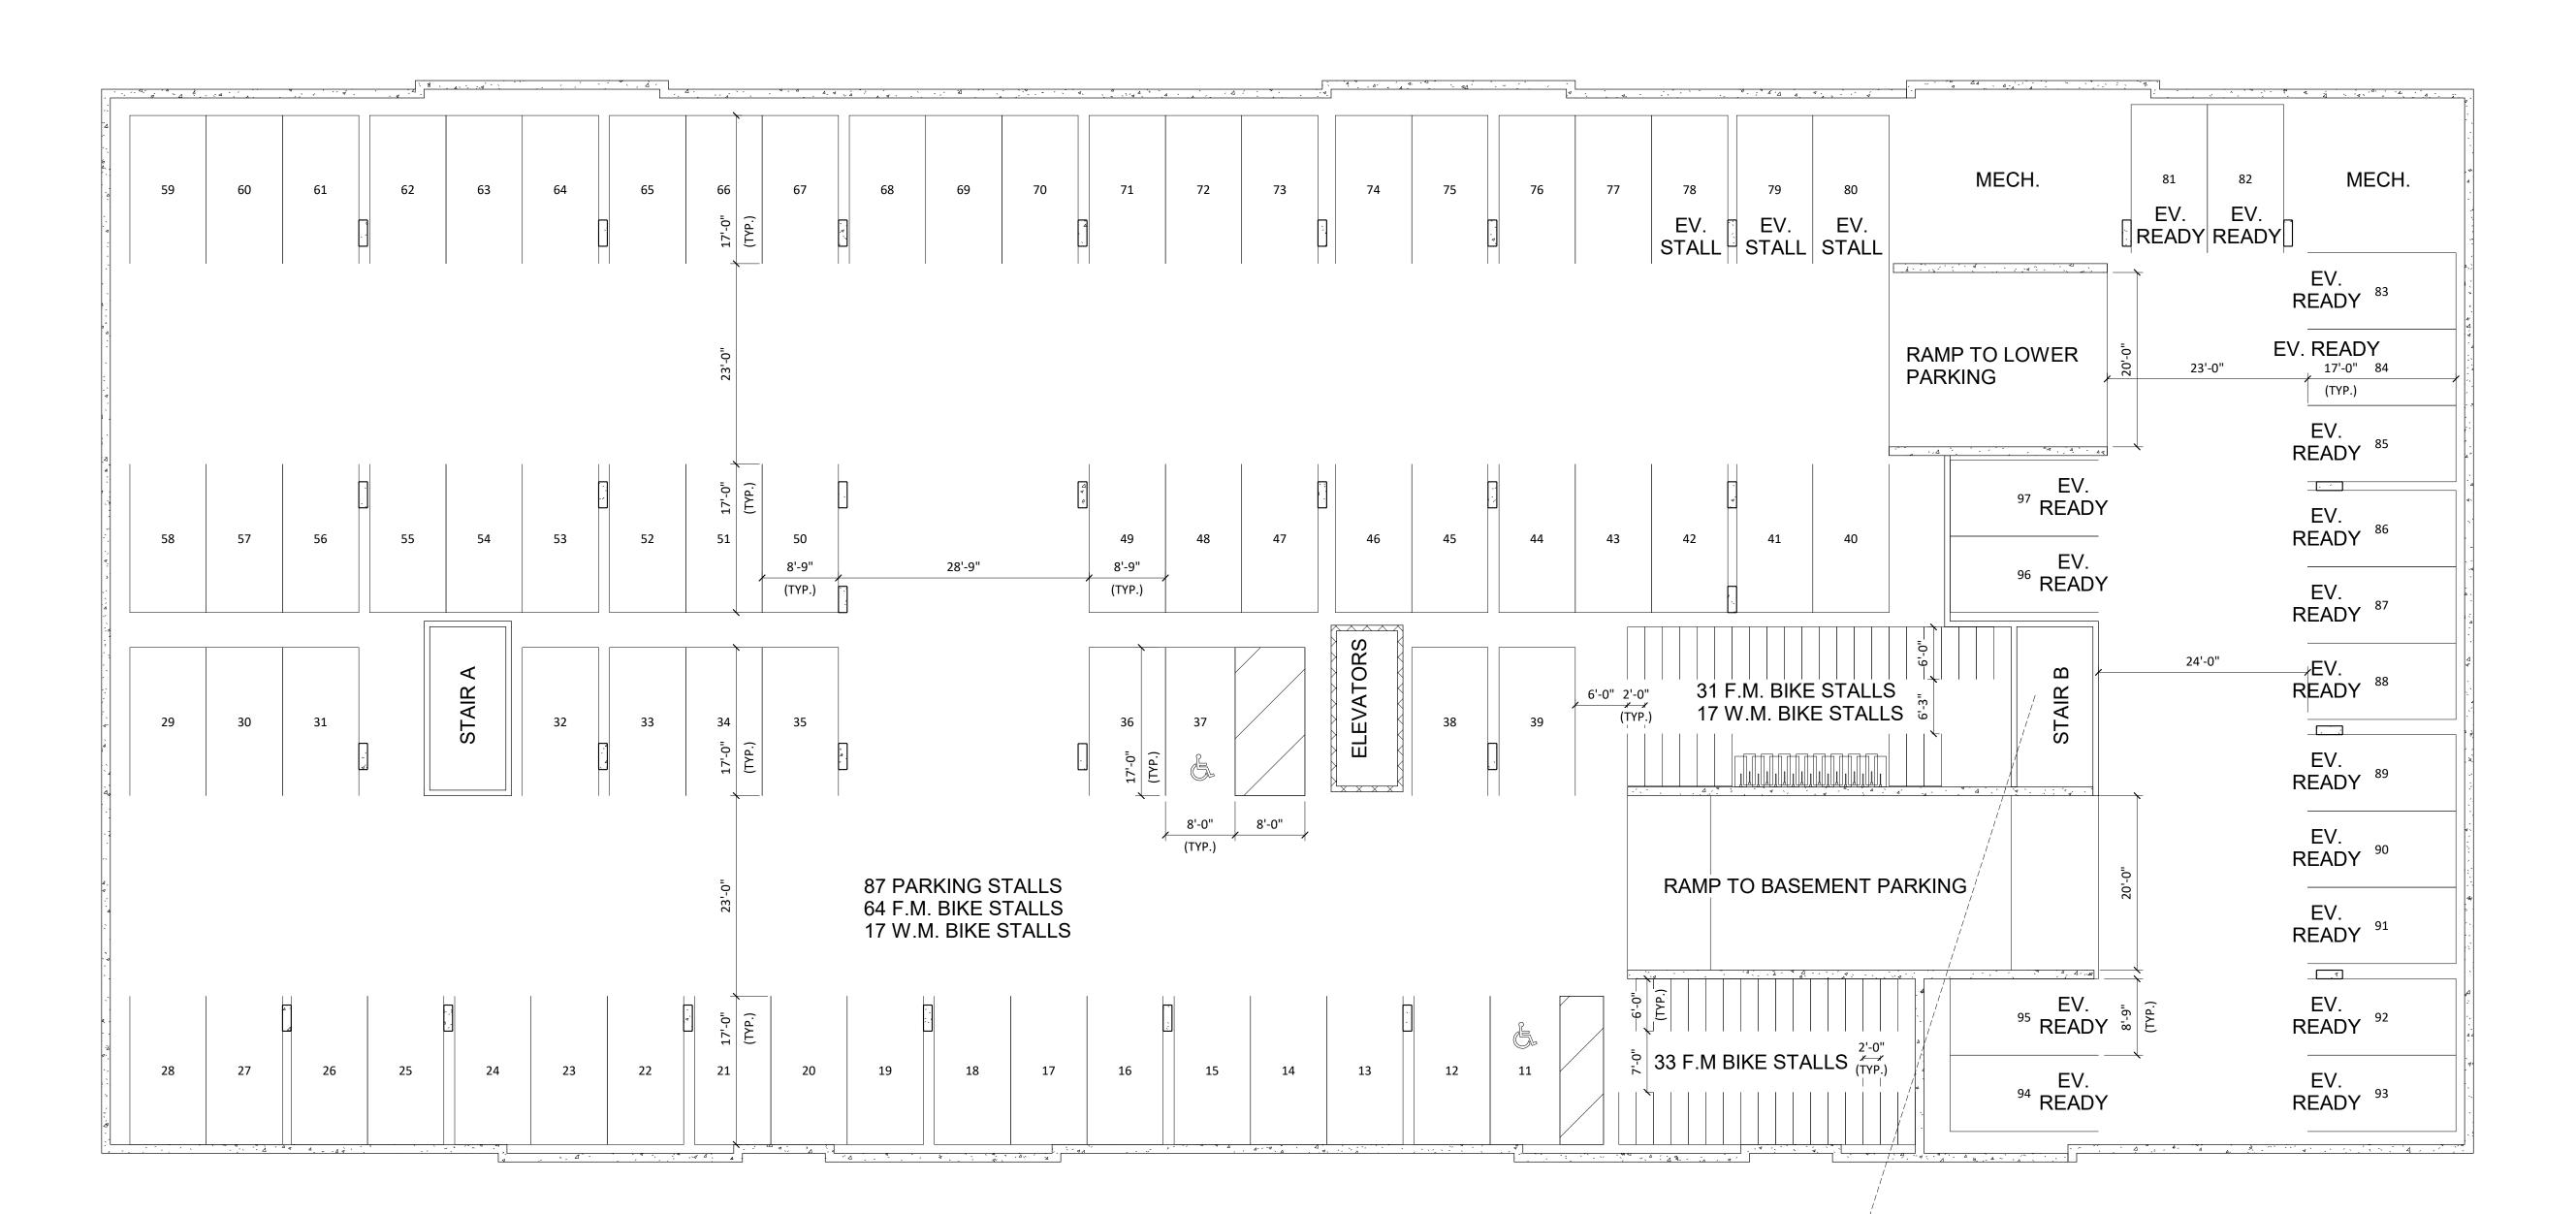

1 00 - BASEMENT A-1.0 3/32" = 1'-0"

# knothe bru A R C H I T E C Phone: 608.836.3690 TRUE NORTH KEY PLAN

ISSUED

PROJECT TITLE

West Washington Development

525-547 W Washington Ave.

Madison, Wisconsin


SHEET TITLE

BASEMENT FLOOR PLAN

SHEET NUMBER

A-1.0

PROJECT NUMBER 2143

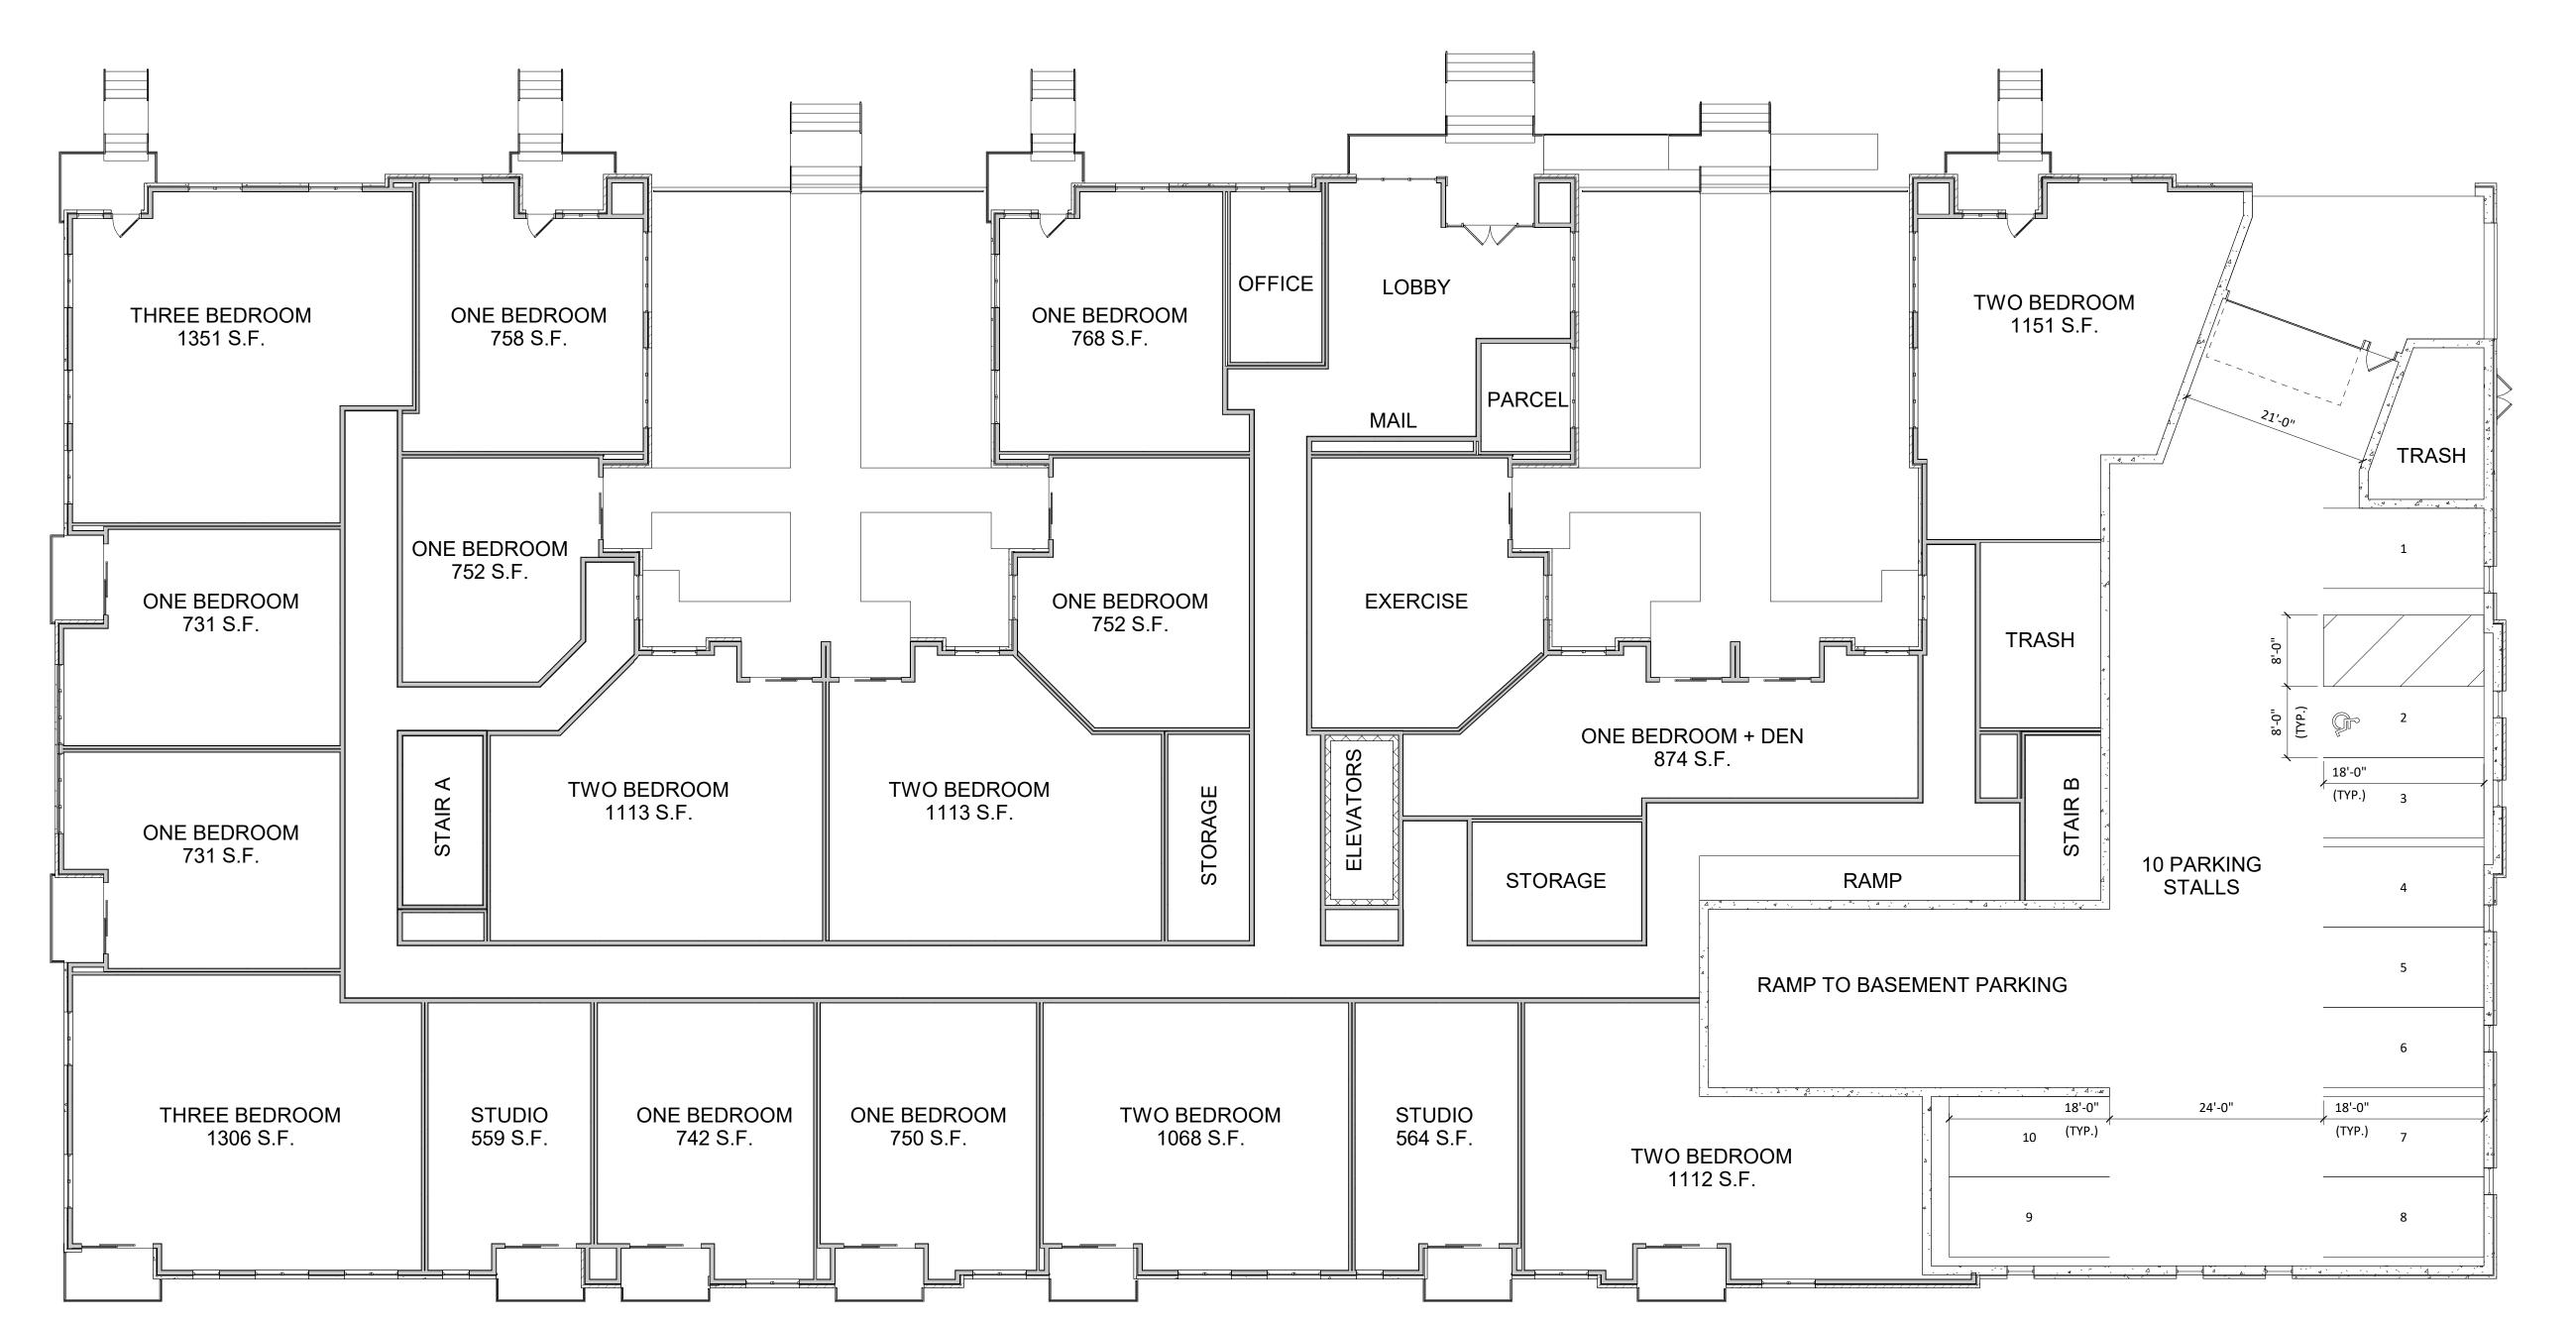

1 01 - FIRST FLOOR A-1.1 3/32" = 1'-0"

608.836.3690

**KEY PLAN** 

**ISSUED** 

TRUE NORTH

Middleton, WI 53562

PROJECT TITLE

West Washington
Development

525-547 W Washington Ave.

Madison, Wisconsin

SHEET TITLE

FIRST FLOOR PLAN

SHEET NUMBER

A-1.1

PROJECT NUMBER 2143



KEY PLAN ISSUED

PROJECT TITLE

608.836.3690

TRUE NORTH

Middleton, WI 53562

West Washington Development

525-547 W Washington Ave.

Madison, Wisconsin

SHEET TITLE

SECOND FLOOR PLAN

SHEET NUMBER

A-1.2

PROJECT NUMBER 2143



1 03 - THIRD FLOOR A-1.3 3/32" = 1'-0"

PROJECT TITLE

608.836.3690

**KEY PLAN** 

ISSUED

TRUE NORTH

Middleton, WI 53562

West Washington Development

525-547 W Washington Ave.

Madison, Wisconsin

SHEET TITLE

THIRD FLOOR PLAN

SHEET NUMBER

A-1.3

PROJECT NUMBER 2143
© Knothe & Bruce Architects, LLC



1 04 - FOURTH FLOOR A-1.4 3/32" = 1'-0"

PROJECT TITLE

608.836.3690

**KEY PLAN** 

ISSUED

TRUE NORTH

Middleton, WI 53562

West Washington Development

525-547 W Washington Ave.

Madison, Wisconsin


SHEET TITLE

FOURTH FLOOR PLAN

SHEET NUMBER

A-1.4

PROJECT NUMBER 2143

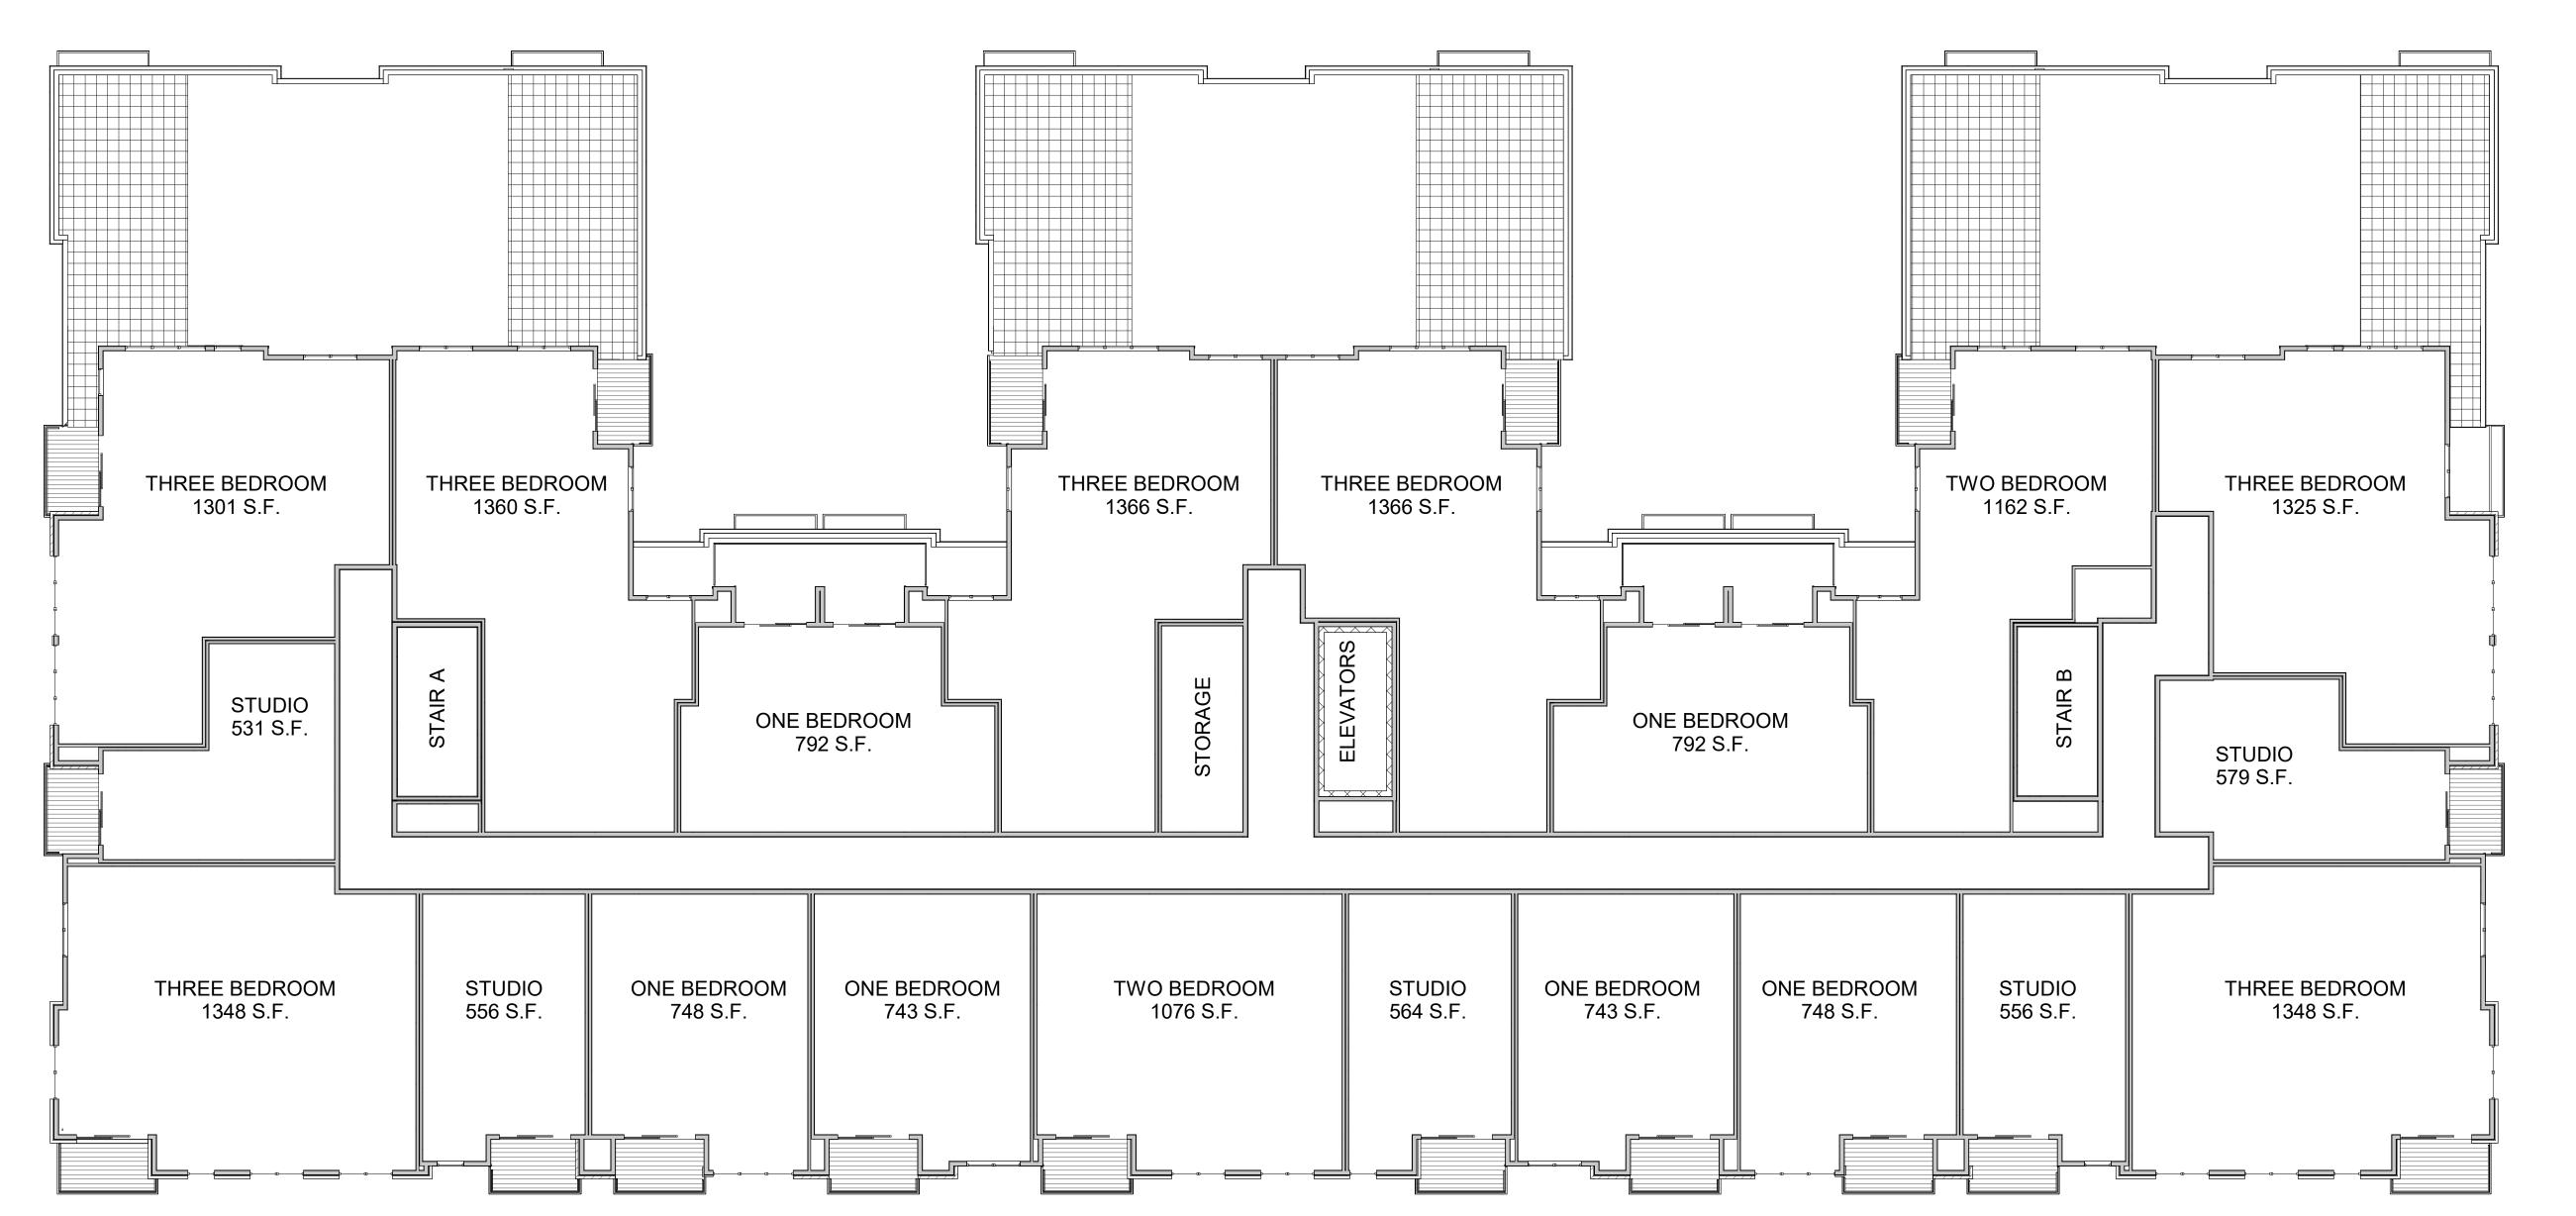

1 05 - FIFTH FLOOR A-1.5 3/32" = 1'-0"

PROJECT TITLE

608.836.3690

**KEY PLAN** 

**ISSUED** 

TRUE NORTH

Middleton, WI 53562

West Washington Development

525-547 W Washington Ave.


Madison, Wisconsin

SHEET TITLE

FIFTH FLOOR PLAN

SHEET NUMBER

A-1.5 PROJECT NUMBER 2143

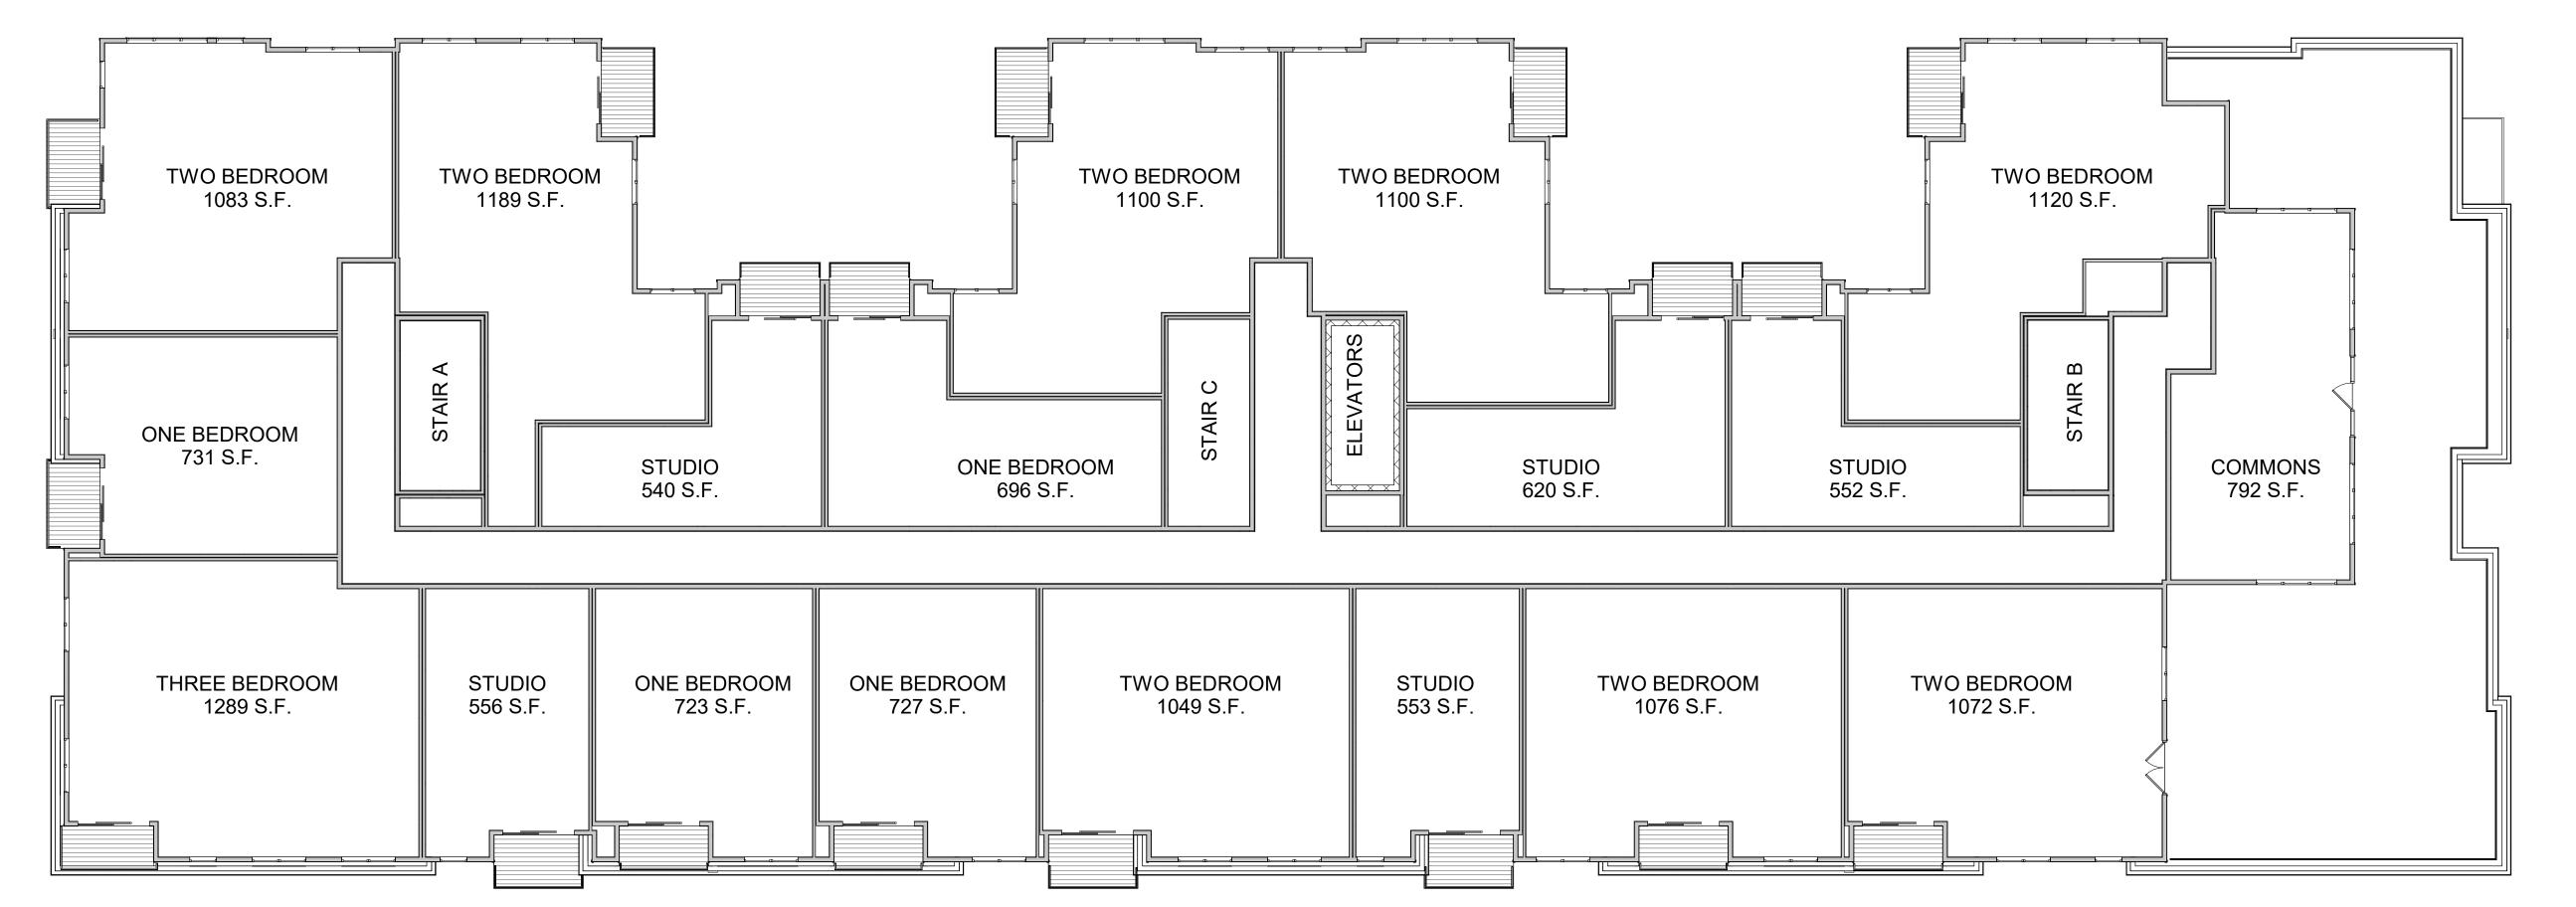

1 06 - SIXTH FLOOR A-1.6 3/32" = 1'-0"

PROJECT TITLE

608.836.3690

TRUE NORTH

KEY PLAN

ISSUED

Middleton, WI 53562

West Washington Development

525-547 W Washington Ave.

Madison, Wisconsin


SHEET TITLE

SIXTH FLOOR PLAN

SHEET NUMBER

A-1.6

PROJECT NUMBER 2143

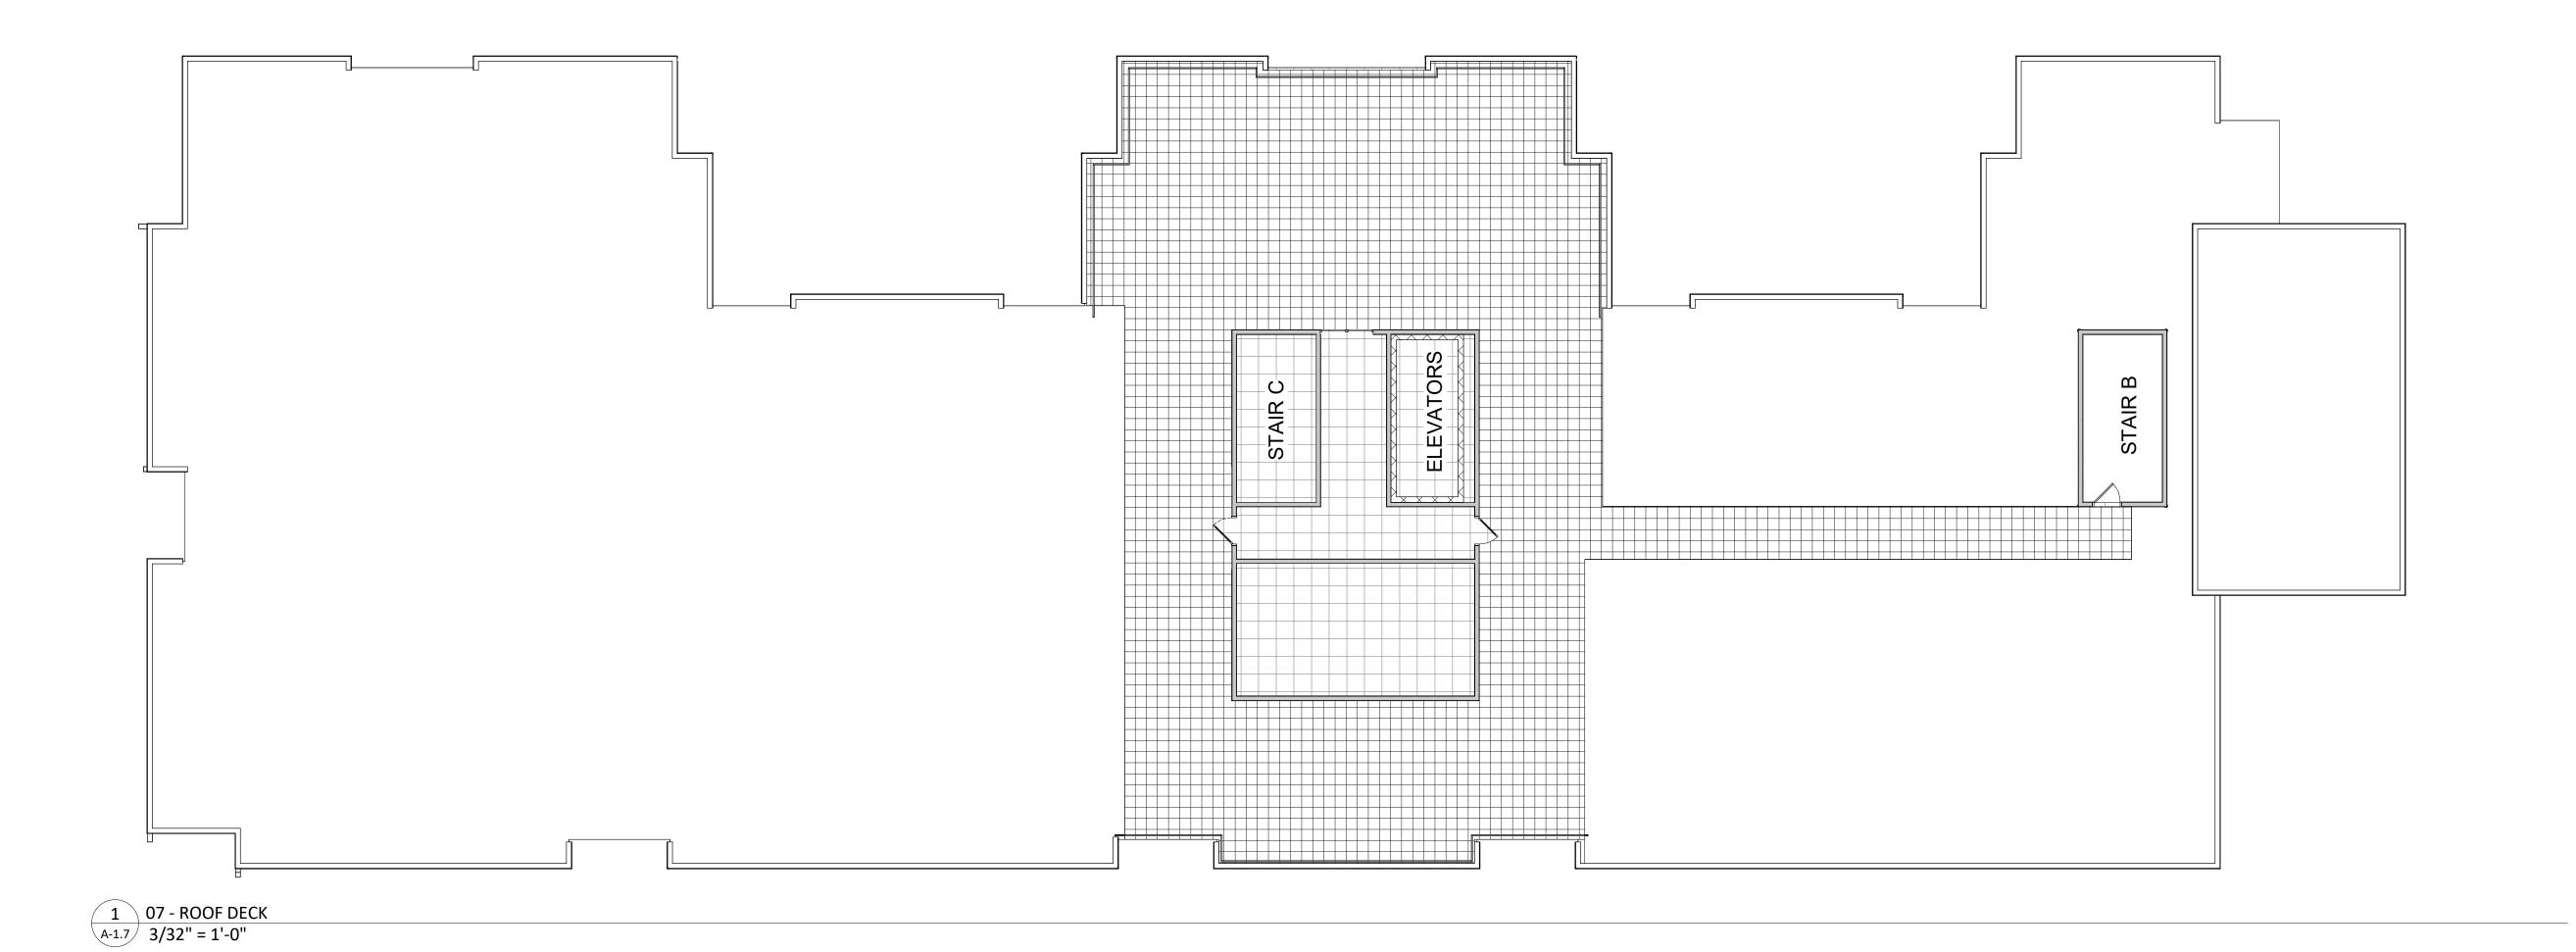

**KEY PLAN** ISSUED

PROJECT TITLE

West Washington Development

608.836.3690 Middleton, WI 53562

TRUE NORTH

525-547 W Washington Ave.

Madison, Wisconsin

SHEET TITLE

**ROOF DECK PLAN** 

SHEET NUMBER

A-1.7 PROJECT NUMBER 2143



COMPOSITE TRIM PARAPET V 166'-8 5/8" ROOF TRUSS BEAKING 163'-9 3/4" METAL SIDING SOILDIER COURSING BRICK VENEER (#2) SIXTH FLOOR 154'-0" **ALUMINIUM RAILINGS** COMPOSITE PANEL FIFTH FLOOR 142'-8" COMPOSITE WINDOWS BRICK VENEER (#1) FOURTH FLOOR 131'-4" THIRD FLOOR 121'-0" CAST STONE SILLS/BANDS/HEADERS SECOND FLOOR 110'-8" CAST STONE FIRST FLOOR 100'-0" BASEMENT \

2 ELEVATION - SOUTH A-2.1 3/32" = 1'-0"

A-2.1 3/32" = 1'-0"

		EXTERIO	MAT	ERIAL SCHEDULE		
BUILDING ELEMENT	MANUFACTURER	COLOR		BUILDING ELEMENT	MANUFACTURER	COLOR
METAL SIDING	MCELROY	ALMOND		CAST STONE BANDS & SILLS	EDWARDS CAST STONE	TBD
COMPOSITE PANEL	JAMES HARDIE	IRON GRAY		COMPOSITE WINDOWS	ANDERSEN 100	BLACK
COMPOSITE TRIM	JAMES HARDIE	MATCH ADJ. SIDING COLOR		ALUM. STOREFRONT	N/A	BLACK
BRICK VENEER (#1)	INTERSTATE BRICK	MOUNTAIN RED		INSULATED METAL DOORS/FRAMES	N/A	TBD
BRICK VENEER (#2)	INTERSTATE BRICK	SMOKEY MOUNTAIN		CANOPY & BAY SOFFITS	JAMES HARDIE	COLOR TO MATCH ADJ. TRIM/SIDING
MASONRY BASE VENEER	ARRISCRAFT	SUNSET		RAILINGS & HANDRAILS	SUPERIOR	BLACK
				TREATED-EXPOSED DECK BEAMS	N/A	BROWN TREATED



KEY PLAN

ISSUED

PROJECT TITLE

West Washington

Development

525-547 W Washington Ave.

Madison, Wisconsin

SHEET TITLE

EXTERIOR

ELEVATIONS

SHEET NUMBER

90'-8"

OWER BASEMENT 81'-4"

A-2.1

PROJECT NUMBER 2143



1 ELEVATION - EAST 3/32" = 1'-0"



EXTERIOR MATERIA COLOR BUILDING ELEMENT MANUFACTURER METAL SIDING MCELROY ALMOND **IRON GRAY COMPOSITE PANEL** JAMES HARDIE MATCH ADJ. SIDING COLOR JAMES HARDIE COMPOSITE TRIM MOUNTAIN RED BRICK VENEER (#1) INTERSTATE BRICK BRICK VENEER (#2) INTERSTATE BRICK SMOKEY MOUNTAIN SUNSET MASONRY BASE VENEER ARRISCRAFT

IAL SCHEDULE		
BUILDING ELEMENT	MANUFACTURER	COLOR
CAST STONE BANDS & SILLS	EDWARDS CAST STONE	TBD
COMPOSITE WINDOWS	ANDERSEN 100	BLACK
ALUM. STOREFRONT	N/A	BLACK
INSULATED METAL DOORS/FRAMES	N/A	TBD
CANOPY & BAY SOFFITS	JAMES HARDIE	COLOR TO MATCH ADJ. TRIM/SIDING
RAILINGS & HANDRAILS	SUPERIOR	BLACK
TREATED-EXPOSED DECK BEAMS	N/A	BROWN TREATED

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ARCHITECTS
Phone:
608.836.3690

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Middleton, WI 53562

KEY PLAN

ISSUED

PROJECT TITLE

West Washington Development

525-547 W Washington Ave.

Madison, Wisconsin

SHEET TITLE

EXTERIOR

ELEVATIONS

SHEET NUMBER

A-2.2

PROJECT NUMBER 2143



608.836.3690 Middleton, WI 53562 KEY PLAN

ISSUED

PROJECT TITLE West Washington

Development

525-547 W Washington

Madison, Wisconsin

SHEET TITLE COLORED

**EXTERIOR ELEVATIONS** 


SHEET NUMBER

A-2.3

PROJECT NUMBER 2143


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1 COLORED - ELEVATION - NORTH A-2.3 3/32" = 1'-0"

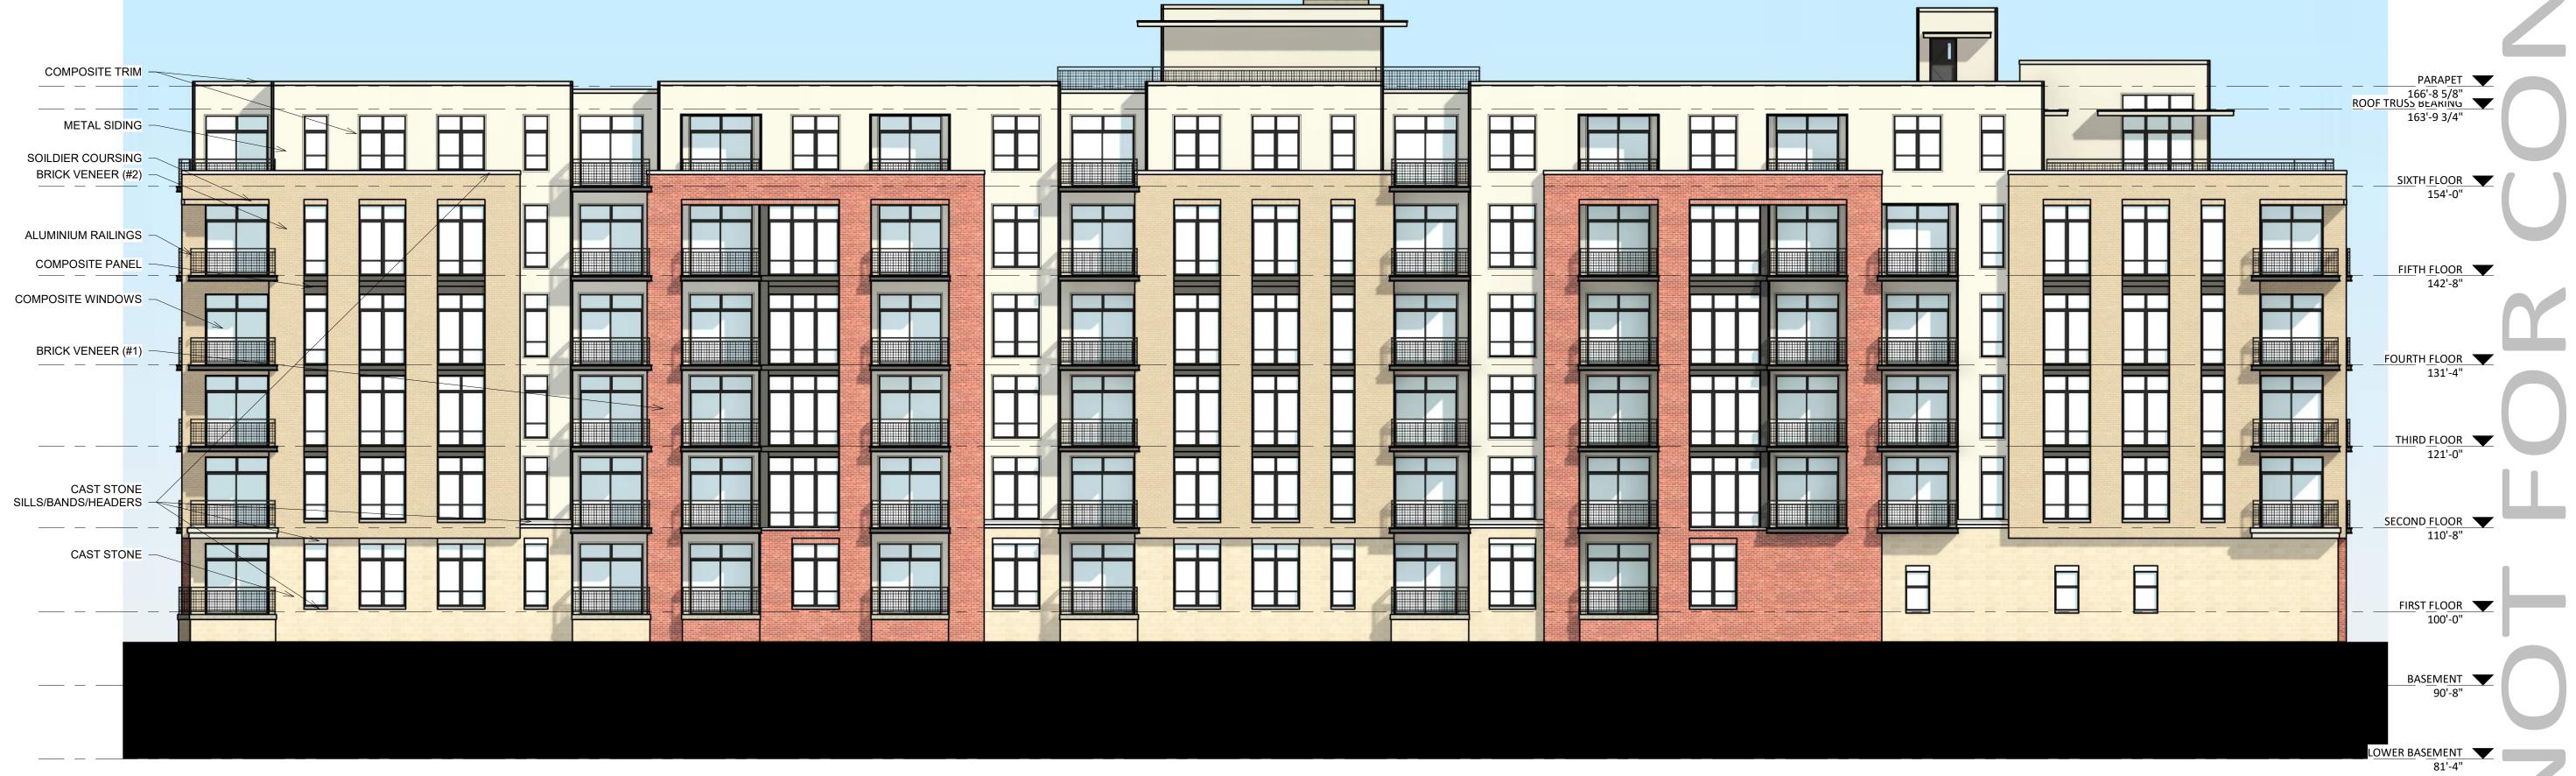


2 COLORED - ELEVATION - SOUTH A-2.3 3/32" = 1'-0"

		EXTERIO	R MATERIAL SCHEDULE		
UILDING ELEMENT	MANUFACTURER	COLOR	BUILDING ELEMENT	MANUFACTURER	COLOR
1ETAL SIDING	MCELROY	ALMOND	CAST STONE BANDS & SILLS	EDWARDS CAST STONE	TBD
OMPOSITE PANEL	JAMES HARDIE	IRON GRAY	COMPOSITE WINDOWS	ANDERSEN 100	BLACK
OMPOSITE TRIM	JAMES HARDIE	MATCH ADJ. SIDING COLOR	ALUM. STOREFRONT	N/A	BLACK
RICK VENEER (#1)	INTERSTATE BRICK	MOUNTAIN RED	INSULATED METAL DOORS/FRAMES	N/A	TBD
RICK VENEER (#2)	INTERSTATE BRICK	SMOKEY MOUNTAIN	CANOPY & BAY SOFFITS	JAMES HARDIE	COLOR TO MATCH ADJ. TRIM/SIDING
1ASONRY BASE VENEER	ARRISCRAFT	SUNSET	RAILINGS & HANDRAILS	SUPERIOR	BLACK
			TREATED-EXPOSED DECK BEAMS	N/A	BROWN TREATED

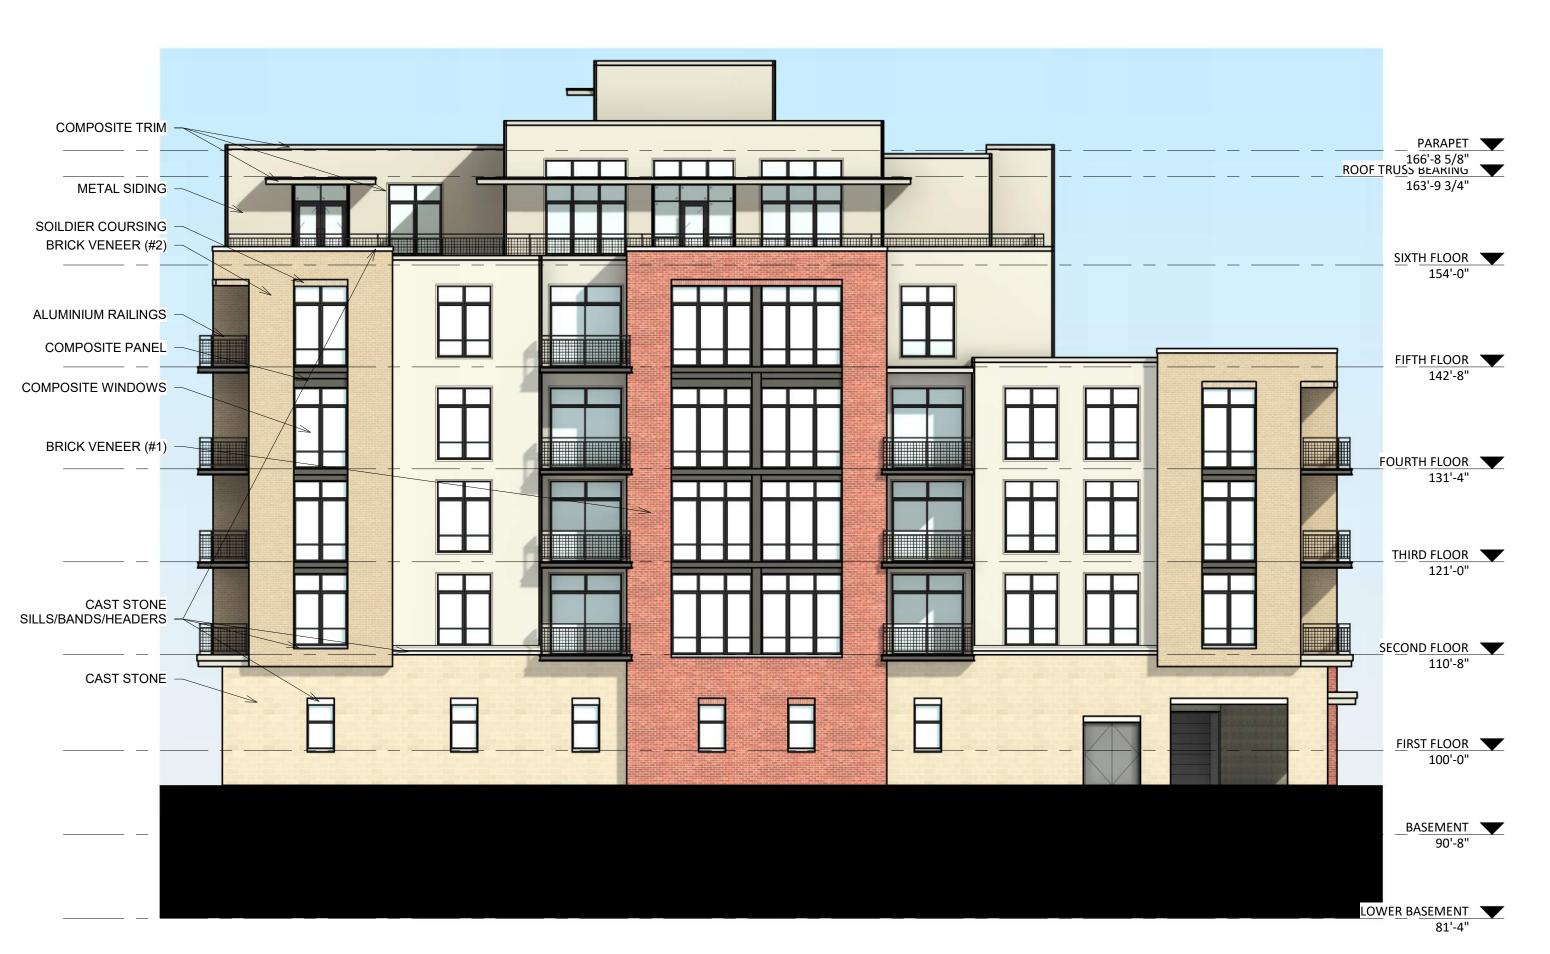

1 COLORED - ELEVATION - EAST 3/32" = 1'-0"

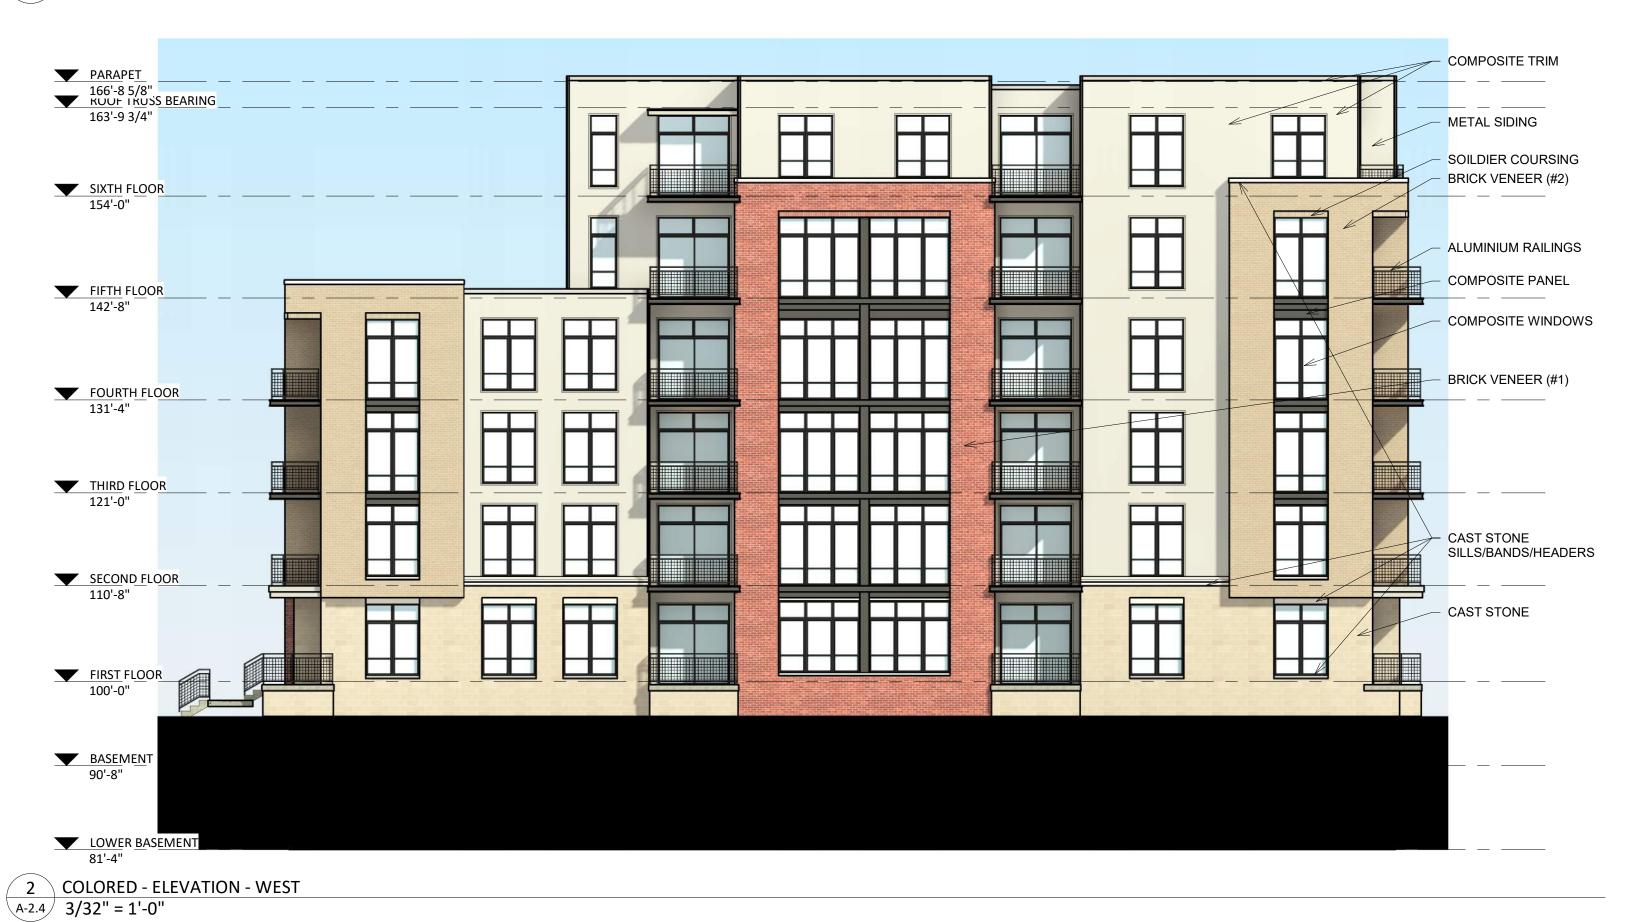

**EXTERIOR MATERIAL SCHEDULE** MANUFACTURER COLOR BUILDING ELEMENT MANUFACTURER COLOR **BUILDING ELEMENT** ALMOND TBD METAL SIDING MCELROY CAST STONE BANDS & SILLS EDWARDS CAST STONE **COMPOSITE PANEL IRON GRAY** JAMES HARDIE COMPOSITE WINDOWS ANDERSEN 100 BLACK MATCH ADJ. SIDING COLOR JAMES HARDIE BLACK COMPOSITE TRIM ALUM. STOREFRONT BRICK VENEER (#1) INTERSTATE BRICK MOUNTAIN RED INSULATED METAL DOORS/FRAMES COLOR TO MATCH ADJ. TRIM/SIDING BRICK VENEER (#2) INTERSTATE BRICK SMOKEY MOUNTAIN CANOPY & BAY SOFFITS JAMES HARDIE BLACK MASONRY BASE VENEER SUNSET RAILINGS & HANDRAILS SUPERIOR ARRISCRAFT **BROWN TREATED** TREATED-EXPOSED DECK BEAMS

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Phone:
608.836.3690

KEY PLAN

ISSUED

PROJECT TITLE

West Washington Development

525-547 W Washington Ave.

Madison, Wisconsin

SHEET TITLE
COLORED

EXTERIOR ELEVATIONS

SHEET NUMBER

A-2.4

PROJECT NUMBER 211
























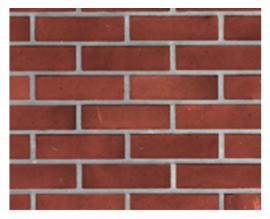

Brick Veneer #1 Interstate Brick Mountain Red



Brick Veneer #2 Interstate Brick Smokey Mountain



Composite Panel James Hardie Iron Gray



Masonry Base Veneer Arriscraft Sunset





Windows & Railings Black



		EXTERIO	R MAT
BUILDING ELEMENT	MANUFACTURER	COLOR	
METAL SIDING	MCELROY	ALMOND	8
COMPOSITE PANEL	JAMES HARDIE	IRON GRAY	
COMPOSITE TRIM	JAMES HARDIE	MATCH ADJ. SIDING COLOR	
BRICK VENEER (#1)	INTERSTATE BRICK	MOUNTAIN RED	
BRICK VENEER (#2)	INTERSTATE BRICK	SMOKEY MOUNTAIN	
MASONRY BASE VENEER	ARRISCRAFT	SUNSET	

TERIAL SCHEDULE			
BUILDING ELEMENT	MANUFACTURER	COLOR	
CAST STONE BANDS & SILLS	EDWARDS CAST STONE	TBD	
COMPOSITE WINDOWS	ANDERSEN 100	BLACK	
ALUM. STOREFRONT	N/A	BLACK	
INSULATED METAL DOORS/FRAMES	N/A	TBD	
CANOPY & BAY SOFFITS	JAMES HARDIE	COLOR TO MATCH ADJ. TRIM/SIDING	
RAILINGS & HANDRAILS	SUPERIOR	BLACK	
TREATED-EXPOSED DECK BEAMS	N/A	BROWN TREATED	

**519-547 W WASHINGTON** MADISON, WI

2/28/2022 KBA #2143