

City of Madison

Proposed Rezoning

Location 2405 Vondron Road

Applicant

Scott Zimmerman-Terra Eng. & Construction/ Kory Anderson-General Engineering Co.

From: Temp A To: IL


Existing Use Storage shed

Proposed Use

Provide zoning for recently attached property to be developed with an office building

Public Hearing Date Plan Commission 10 February 2014 Common Council

25 February 2014

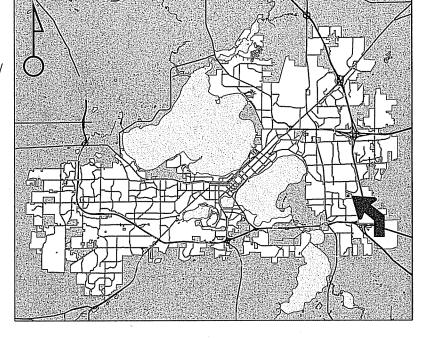


For Questions Contact: Tim Parks at: 261-9632 or tparks@cityofmadison.com or City Planning at 266-4635



Scale: 1" = 400'

City of Madison, Planning Division: RPJ: Date: 05 February 2014



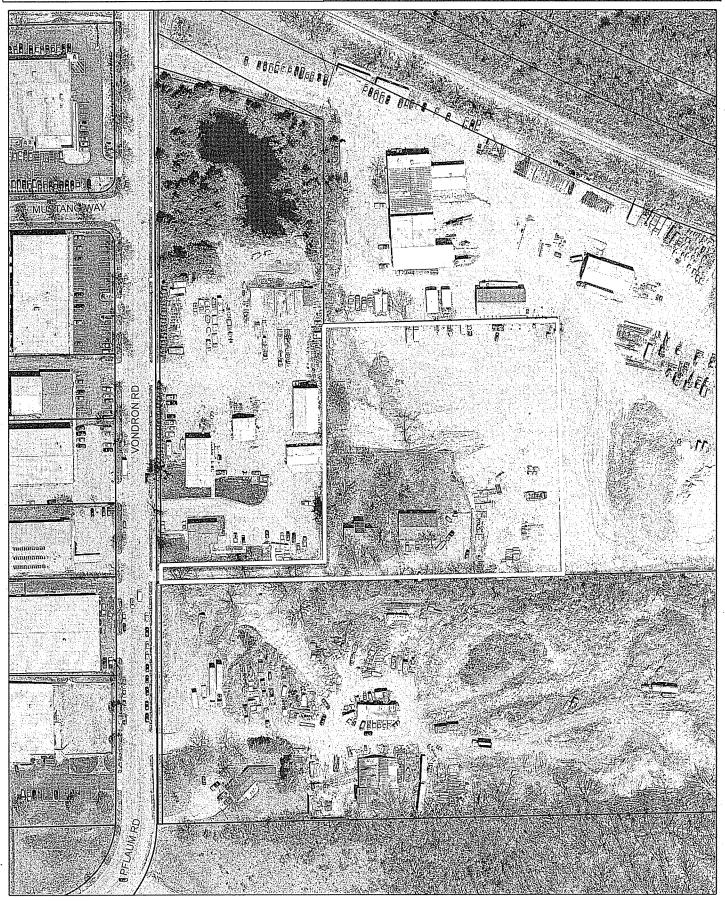

Date of Aerial Photography: Spring 2013



CITY OF MADISON



Madison

- All Land Adminis
- The follo Commis should
- This for www.ci

Madison _m	FOR OFFICE USE ONLY.
215 Martin Luther King Jr. Blvd; Room LL-100 PO Box 2985; Madison, Wisconsin 53701-2985 Phone: 608.266.4635 Facsimile: 608.267.8739	Amt. Paid Receipt No Date Received
 All Land Use Applications should be filed with the Zoning Administrator at the above address. 	Parcel No. 07/0 - 154 - (001-3) Aldermanic District
 The following information is required for all applications for Plan Commission review except subdivisions or land divisions, which should be filed using the <u>Subdivision Application</u>. This form may also be completed online at: www.cityofmadison.com/developmentcenter/landdevelopment 	Zoning District
1. Project Address: 2405 Vondron Road	Form Effective: February 21, 2013
Project Title (if any): Terra Construction & Engineering Office E	The state of the s
2. This is an application for (Check all that apply to your Land	Use Application):
✓ Zoning Map Amendment from Ag	to Industrial Limited
	Major Amendment to Approved PD-SIP Zoning
☐ Review of Alteration to Planned Development (By Plan Cor	
,	•
☐ Conditional Use, or Major Alteration to an Approved Condit	tional Use
☐ Demolition Permit	
Other Requests:	Management of the control of the con
3. Applicant, Agent & Property Owner Information: Applicant Name: Scott Zimmerman, PE Compa	ny: Terra Engineering & Construction
Street Address: 2201 Vondron Road City/State:	Madison, WI Zip: 53718
Telephone: (608) 210-3919 Fax: (608) 221-4075	Email: szimmerman@whyterra.com
Project Contact Person: Kory Anderson, PE Compa	ny: General Engineering Company
	Portage, WI Zip: 53901
710 0700	Email: kanderson@generalengineering.net
•	
Property Owner (if not applicant):	
Street Address: City/States;	Zip:
4. Project Information:	
Provide a brief description of the project and all proposed uses of the building at this location as shown on the attached plans. An existing storage shed	e site: Terra Engineering is building an office will remain.

4. Project

Provide a building at November 2014 March 2014 Completion Development Schedule: Commencement

5. Required Submittal Information All Land Use applications are required to include the following: ✓ Project Plans including:* Site Plans (fully dimensioned plans depicting project details including all lot lines and property setbacks to buildings; demolished/proposed/altered buildings; parking stalls, driveways, sidewalks, location of existing/proposed signage; HVAC/Utility location and screening details; useable open space; and other physical improvements on a property) Grading and Utility Plans (existing and proposed) Landscape Plan (including planting schedule depicting species name and planting size) Building Elevation Drawings (fully dimensioned drawings for all building sides, labeling primary exterior materials) Floor Plans (fully dimensioned plans including interior wall and room location) Provide collated project plan sets as follows: Seven (7) copies of a full-sized plan set drawn to a scale of 1 inch = 20 feet (folded or rolled and stapled) Twenty Five (25) copies of the plan set reduced to fit onto 11 X 17-inch paper (folded and stapled) One (1) copy of the plan set reduced to fit onto 8 ½ X 11-inch paper * For projects requiring review by the Urban Design Commission, provide Fourteen (14) additional 11x17 copies of the plan set. In addition to the above information, all plan sets should also include: 1) Colored elevation drawings with shadow lines and a list of exterior building materials/colors; 2) Existing/proposed lighting with photometric plan & fixture cutsheet; and 3) Contextual site plan information including photographs and layout of adjacent buildings and structures. The applicant shall bring samples of exterior building materials and color scheme to the Urban Design Commission meeting. Letter of Intent: Provide one (1) Copy per Plan Set describing this application in detail including, but not limited to: Value of Land **Building Square Footage Project Team Estimated Project Cost** Number of Dwelling Units **Existing Conditions** Number of Construction & Full-**Auto and Bike Parking Stalls Project Schedule** Time Equivalent Jobs Created Proposed Uses (and ft² of each) Lot Coverage & Usable Open **Public Subsidy Requested Space Calculations Hours of Operation** Filing Fee: Refer to the Land Use Application Instructions & Fee Schedule. Make checks payable to: City Treasurer. Flectronic Submittal: All applicants are required to submit copies of all items submitted in hard copy with their application as Adobe Acrobat PDF files on a non-returnable CD to be included with their application materials, or by e-mail to pcapplications@cityofmadison.com. Additional Information may be required, depending on application. Refer to the Supplemental Submittal Requirements. 6. Applicant Declarations Pre-application Notification: The Zoning Code requires that the applicant notify the district alder and any nearby neighborhood and business associations in writing no later than 30 days prior to FILING this request. List the alderperson, neighborhood association(s), and business association(s) AND the dates you sent the notices: Alderperson DeMarb was emailed on November 1, 2013 - see attached → If a waiver has been granted to this requirement, please attach any correspondence to this effect to this form. ☑ Pre-application Meeting with Staff: Prior to preparation of this application, the applicant is required to discuss the

The applicant attests that this form is accurately completed and all required materials are submitted:

proposed development and review process with Zoning and Planning Division staff; note staff persons and date.

Planning Staff: Tim Parks

Date: 9/5/13

Zoning Staff: Various

Date: 9/5/13

Name of Applicant Scott Zimmerman

Relationship to Property: Owner

Authorizing Signature of Property Owner

Date 12/16/13

General Engineering Company P.O. Box 340 916 Silver Lake Drive Portage, WI 53901



608-742-2169 (Office) 608-742-2592 (Fax) gec@generalengineering.net www.generalengineering.net

Engineers • Consultants • Inspectors

December 18, 2013

City of Madison Planning Commission Room LL-100, PO Box 2985 215 Martin Luther King Jr. Blvd. Madison, WI 53701-2985

RE:

Letter of Intent – Land Use Application
Terra Engineering and Construction Office Building
2405 Vondron Road, City of Madison

GEC#: 2-0513-164

To Whom It May Concern:

On behalf of Terra Engineering and Construction, we are enclosing the following documents for a proposed office building on their property located at 2405 Vondron Road in the City of Madison:

- One (1) copy of the City of Madison Planning Commission Land Use Application
- Seven (7) copies of the full-size project plans
- Twenty-Five (25) copies of the 11" x 17" project plans
- One (1) copy reduced to 8-1/2" x 11"
- Thirty-Three (33) copies of the Letter of Intent (one per plan set)
- One (1) copy of the Lighting Specifications
- Filing Fee (\$1250 for Zoning Map Amendment and \$250 for Site Plan Review = \$1500)
- One (1) copy of Email of Pre-Application Notification
- One (1) copy of the Parking Lot/Site Plan Approval Application Checklist
- One (1) copy of the Fire Apparatus Access and Fire Hydrant Worksheet
- One (1) copy of the legal description for the property
- One (1) copy of the proposed CSM to combine parcels for the property submitted under separate cover on 12/4/13
- · CD with electronic version of all documents

The existing site was attached into the City of Madison in November and contains an existing 2,400 square foot storage shed. A CSM was submitted earlier this month to the Planning Commission and was necessary to combine the tax parcels so that a proposed office building for the site can meet the required setbacks. The attached "Land Use Application" for the rezoning of the property as well as detailed civil site plans and architectural building plans are attached. It is the intent of the owners of the property, Terra Engineering and Construction c/o Scott Zimmerman (CEO), to use the proposed office building for their construction company that has existing operations on the adjacent properties to the north and east. They are exceeding the use of the available office space in the current building at that location (2201 Vondron Road).

Portage

Black River Falls

La Crosse





As requested on the Land Use Application, here is pertinent information for the project:

Project Team:

Owner Terra Engineering & Construction

Scott Zimmerman, PE, CEO

2201 Vondron Road Madison, WI 53718

Phone: (608) 210-3919

Engineer

General Engineering Company

Kory D. Anderson, PE, Project Engineer PO Box 340, 916 Silver Lake Drive

Portage, WI 53901 Phone: (608) 742-2169

General Contractor

Harmony Construction Management, Inc.

Paul Reed, President 906 Jonathon Drive Madison, WI 53713 Phone: (608) 224-3310

Existing Conditions:

Vacant except for existing storage shed and driveway.

Project Schedule:

Construction would begin in March 2014 and end in November 2014.

Proposed Uses: Hours of Operation:

Business Office (11,408 sq. ft.) Monday through Friday, 7am-5pm

Building Square Footage:

11,408 sq. ft. (2 levels)

Number of Dwelling Units:

None

None

Auto and Bike Parking Stalls:

36 Auto Stalls, 6 Bike Stalls

Lot Coverage & Usable Open Space Calculations:

refer to the attached spreadsheet

Value of Land: \$141,100

Estimated Project Cost: \$1,300,000

Number of Construction & Full-Time Equivalent Jobs Created:

None

Public Subsidy Requested:

If you have any questions or need any additional information, please do not hesitate to contact us.

Sincerely,

GENERAL ENGINEERING COMPANY

Kory D. Anderson, P.E. Project Engineer

Enclosures

CC:

Scott Zimmerman, CEO, Terra Engineering and Construction Paul Reed, President, Harmony Construction Management, Inc.

SECTION NO SHEET NO.

BUILDING

SECTION NO. SHEET NO.

WALL SECTION

DETAIL NO. SHEET NO.

ENLARGED DETAIL

DETAIL NO

ELEVATION DETAIL

DOOR LABEL

ROOM LABEL

VERTICAL ELEV.

EMERGENCY LIGHT

FIRE EXTINGUISHER

CIVIL LEGEND

EXISTING HYDRANT PROPOSED HYDRANT VALVE **CURB STOP** WELL PROPERTY CORNER LIGHT POLE POWER/TELEPHONE UTILITY PEDESTAL SIGN

MONITORING WELL Swing. POTENTIAL HAZARD BENCH MARK 0 **DECIDUOUS TREE** 0 **CONIFEROUS TREE**

SOIL BORING

ACCESSIBILITY SYMBOL

LOCATION PLAN

DANE COUNTY, WI

DIGGERS HOTLINE NOTE


CALL DIGGERS HOTLINE 1-800-242-8511

TERRA ENGINGEERING OFFICE

CITY OF MADISON DANE COUNTY, WI

DECEMBER 2013

CITY SUBMITTAL PLANS

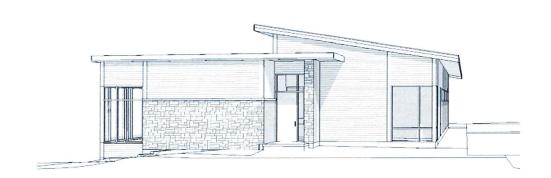

PROPOSED COMPLETED ELEVATION

SUBMITTAL TYPE PRIMARY OCCUPANCY TYPE SECONDARY OCCUPANCY TYPE OCCUPANCY SEPARATIONS

NOT TO SCALE

PROJECT LOCATION

PROJECT AREA FLOOR LEVELS 1 + LOWER LEVEL CONSTRUCTION CLASS COMPLETE NFPA 13 SPRINKLER PROTECTION

LOCATION PLAN PROJECT LOCATION

CITY OF MADISON

UTILITIES

<u>GAS</u>

ELECTRIC

MADISON GAS & ELEC. 133 S. BLAIR ST MADISON, WI 53703 PHONE: 608-252-7379

MADISON GAS & ELEC. 133 S. BLAIR ST MADISON, WI 53703 PHONE: 608-252-5618 DON McCLAIN WATER

WATER & UTILITIES

TELEPHONE XXXXXXX XXXXXXXXXXXX

XXXXXXXXXXXXX XXXXXXXXXXX PHONE: XXX-XXX-XXXX PHONE: XXXXXXX

CABLE CHARTER COMMUNICATIONS CITY OF MADISON 2701 DANIELS ST

MADISON, WI 53718 **GLEN JAKUSZ**

MUNICIPALITY 210 MARTIN LUTHER KING, JR. BLVD. MADISON, WI 53716

ABBREVIATIONS

FOP = FDGF OF PAVEMENT MFG. = MANUFACTURER BOC = BACK OF CURB DIM. = DIMENSION EOSW = EDGE OF SIDEWALK SPF = SPRUCE PINE FUR TOF = TOP OF FOOTING DF = DOUGLAS FIR FFE = FIRST FLOOR ELEVATION SP = SOUTHERN PINE TOW = TOP OF WALL CONC. = CONCRETE SFE = SECOND FLOOR ELEVATION WWF = WIRE WELDED FARRIC ELEV. = ELEVATION OC = ON CENTER RO = ROUGH OPENING EW = EACH WAY BM = BENCHMARK EF = EACH FACE SQ. FT. = SQUARE FEET WH = WATER HEATER DIA. = DIAMETER DW = DISHWASHER REF. = REFRIGERATOR TYP. = TYPICAL HM = HOLLOW METAL FRZ. = FREEZER SS = STAINLESS STEEL FTG. = FOOTING ALUM. = ALUMINUM PC = PRECAST IBC = INTERNATIONAL BUILDING CODE OHD = OVERHEAD DOOR WD = WOOD T/O = TOP OF MTL. = METAL GALV. = GALVANIZED HSS = HOLLOW STEEL STRUCTURE BRG. = BEARING STL. = STEEL OH = OVERHANG OFOI - OWNER FURNISHED OWNER INSTALLED

SEAL

INDEX OF DRAWINGS		
SHEET NO.	DESCRIPTION	
GENERAL -		
G1.0	TITLE SHEET	
CIVIL -		
C1.0	EXISTING SITE PLAN	
C2.0	PROPOSED SITE PLAN	
C3.0	PROPOSED GRADING & EC PLAN	
C4.0	PROPOSED UTILITIES PLAN	
C4.1	UTILITY PLAN PROFILE	
C5.0	WET POND DETAILS	
C5.1	INFILTRATION BASIN DETAILS	
C6.0 - 6.6	PROJECT DETAILS	
C7.0	DRIVEWAY CROSS SECTION	
C8.0 - C8.1	PROPOSED LANDSCAPING PLAN	
C9.0	LIGHTING PLAN	
ARCHITECTURAL -		
A1.0	FIRST FLOOR PLAN	
A1.1	LOWER LEVEL FLOOR PLAN	
A4.0	EXTERIOR ELEVATIONS	
A12.0	PERSPECTIVE VIEWS	

OWNER

TERRA ENGINEERING & CONSTRUCTION

MADISON, WI

DESIGN TEAM

ENGINEER OF RECORD

GENERAL ENGINEERING COMPANY CONTACT: KORY ANDERSON 916 SILVER LAKE DRIVE PORTAGE, WI 53901 FX: 608-742-2592

GENERAL CONTRACTOR

HARMONY CONSTRUCTION MANAGEMENT, INC. CONTACT: PAUL REED 906 JONATHON DRIVE MADISON, WI 53713 PH: 608-224-3310 FX: 608-223-4392

BUILDING DESIGN CRITERIA

- CODE COMPLIANCE PER 2011 WISCONSIN COMMERCIAL BUILDING CODE (WCBC) (2009 I - CODES)

- OCCUPANCY TYPE **B-BUSINESS**

- CONSTRUCTION CLASSIFICATION - VB WOOD FRAMED UNPROTECTED

- ALLOWABLE AREA 9000 SQ. FT. (TABLE 503)


- OCCUPANT LOAD 83 - TOTAL


- BUILDING IS PROTECTED BY A COMPLETE FIRE SPRINKLER SYSTEM


ARMONY


GEC FILE NO. 2-0513-164


SHEET NO. G1.0

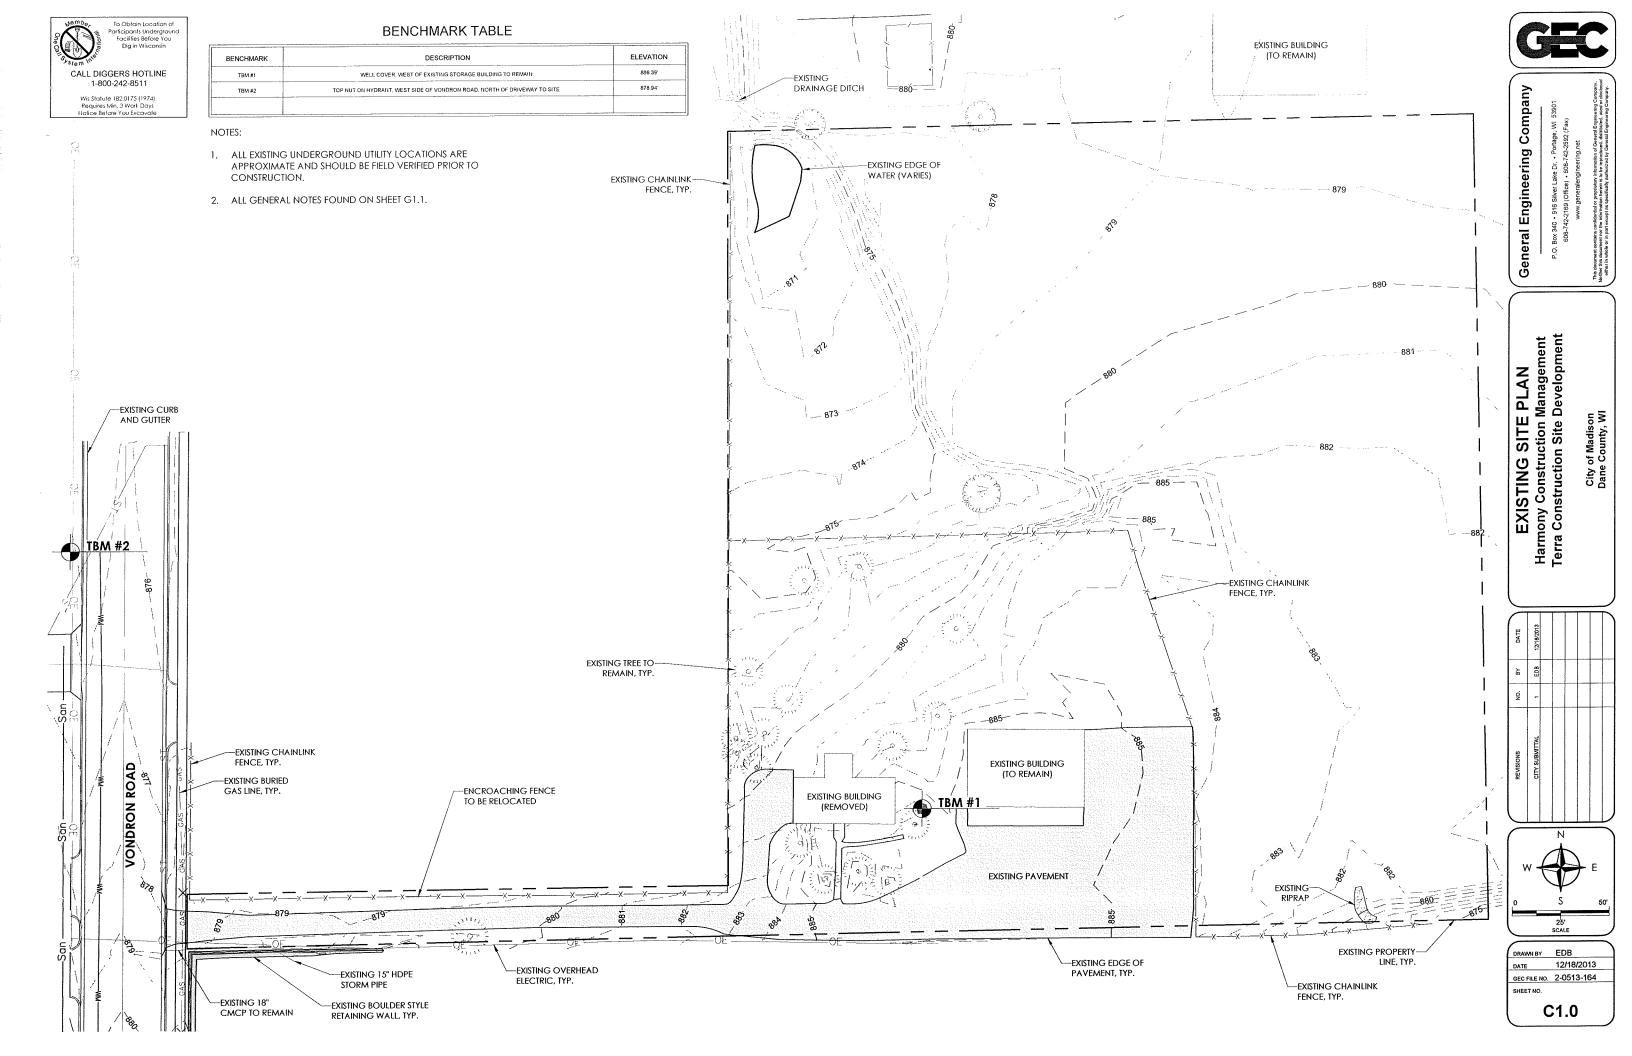

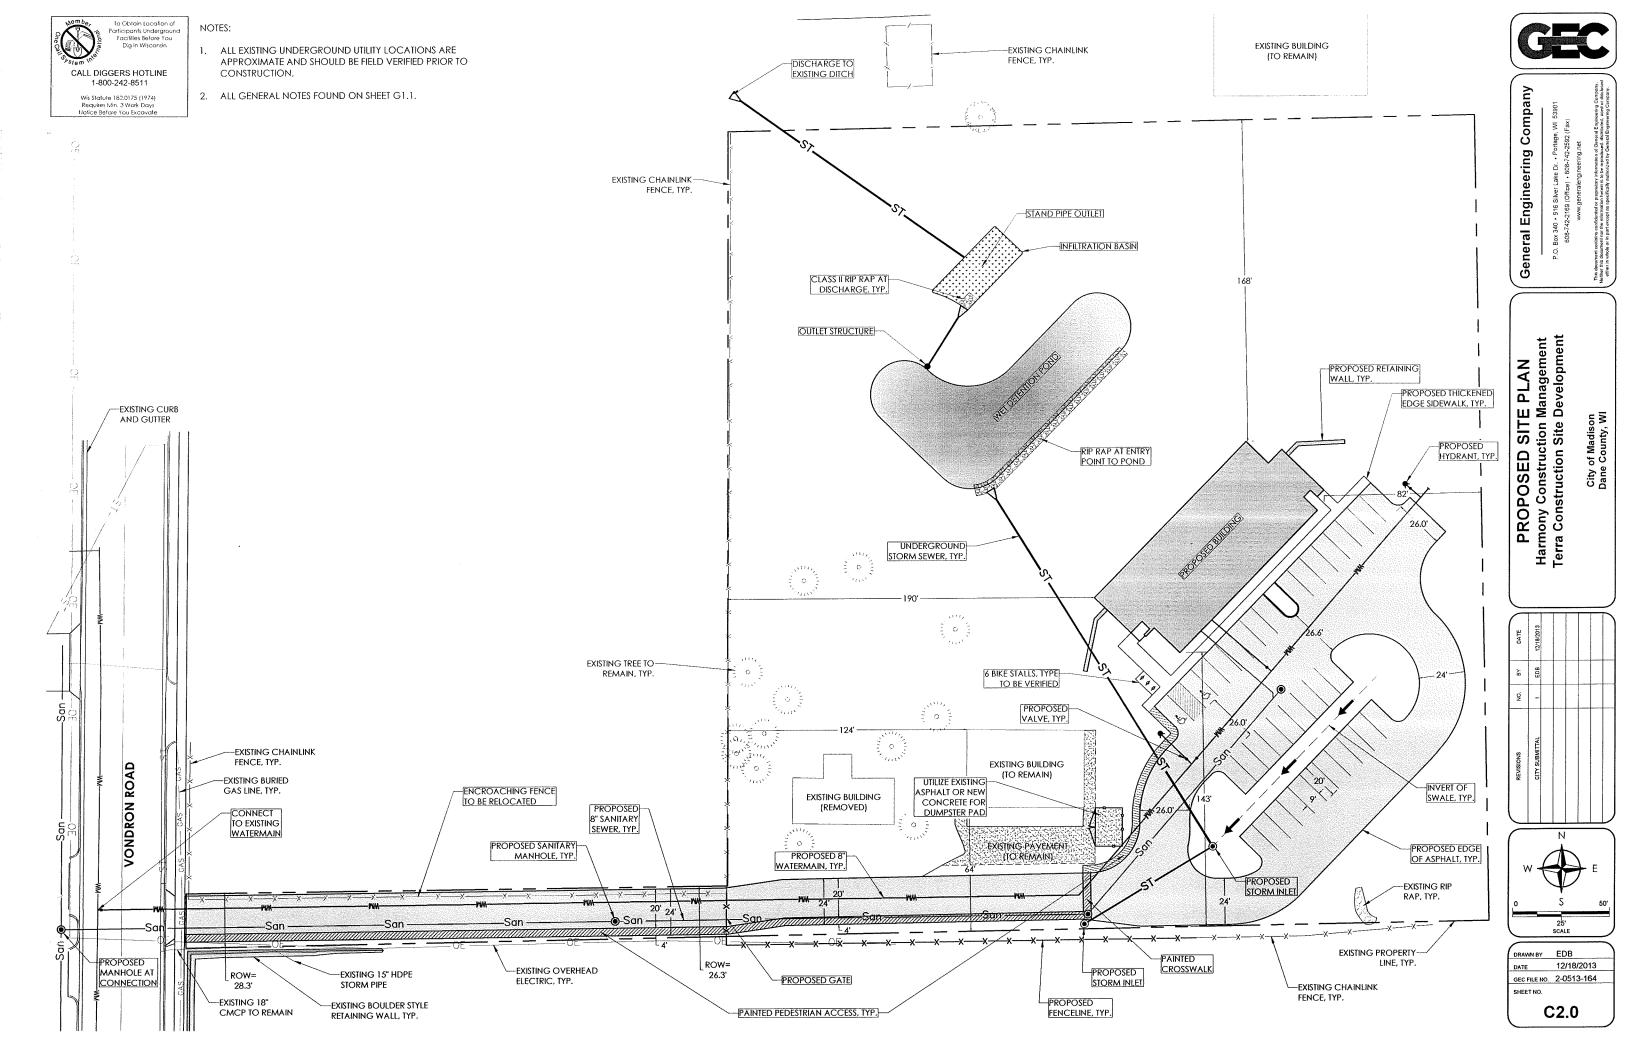

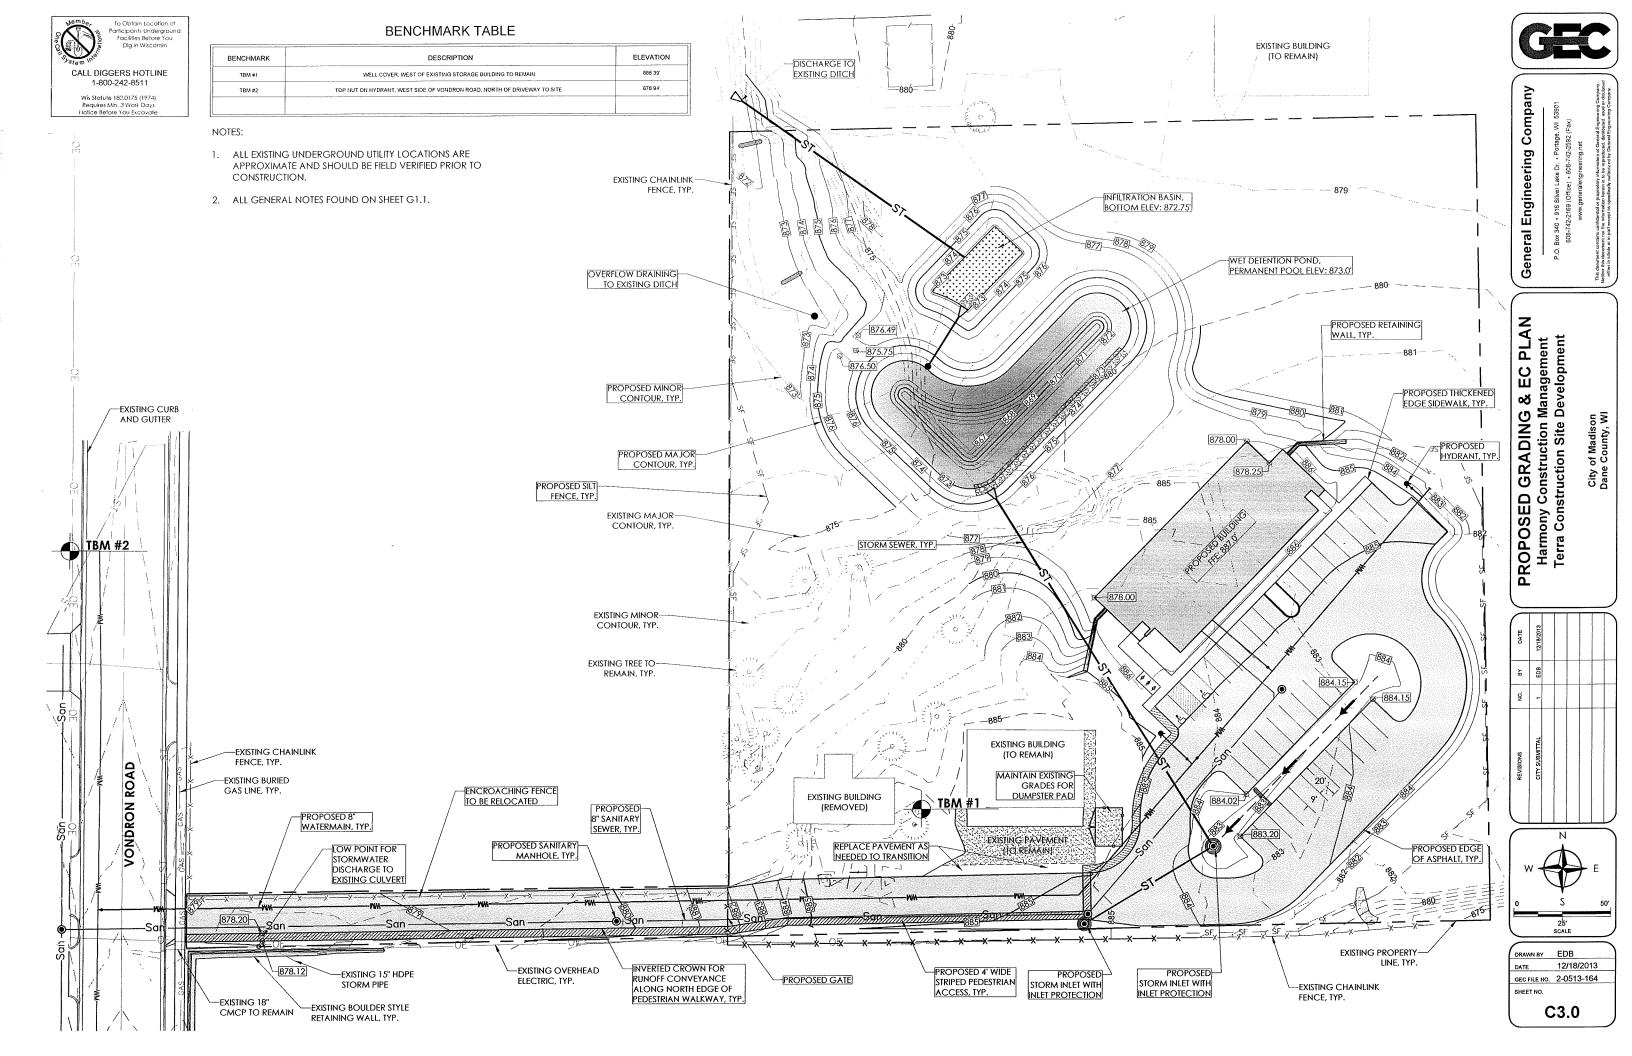

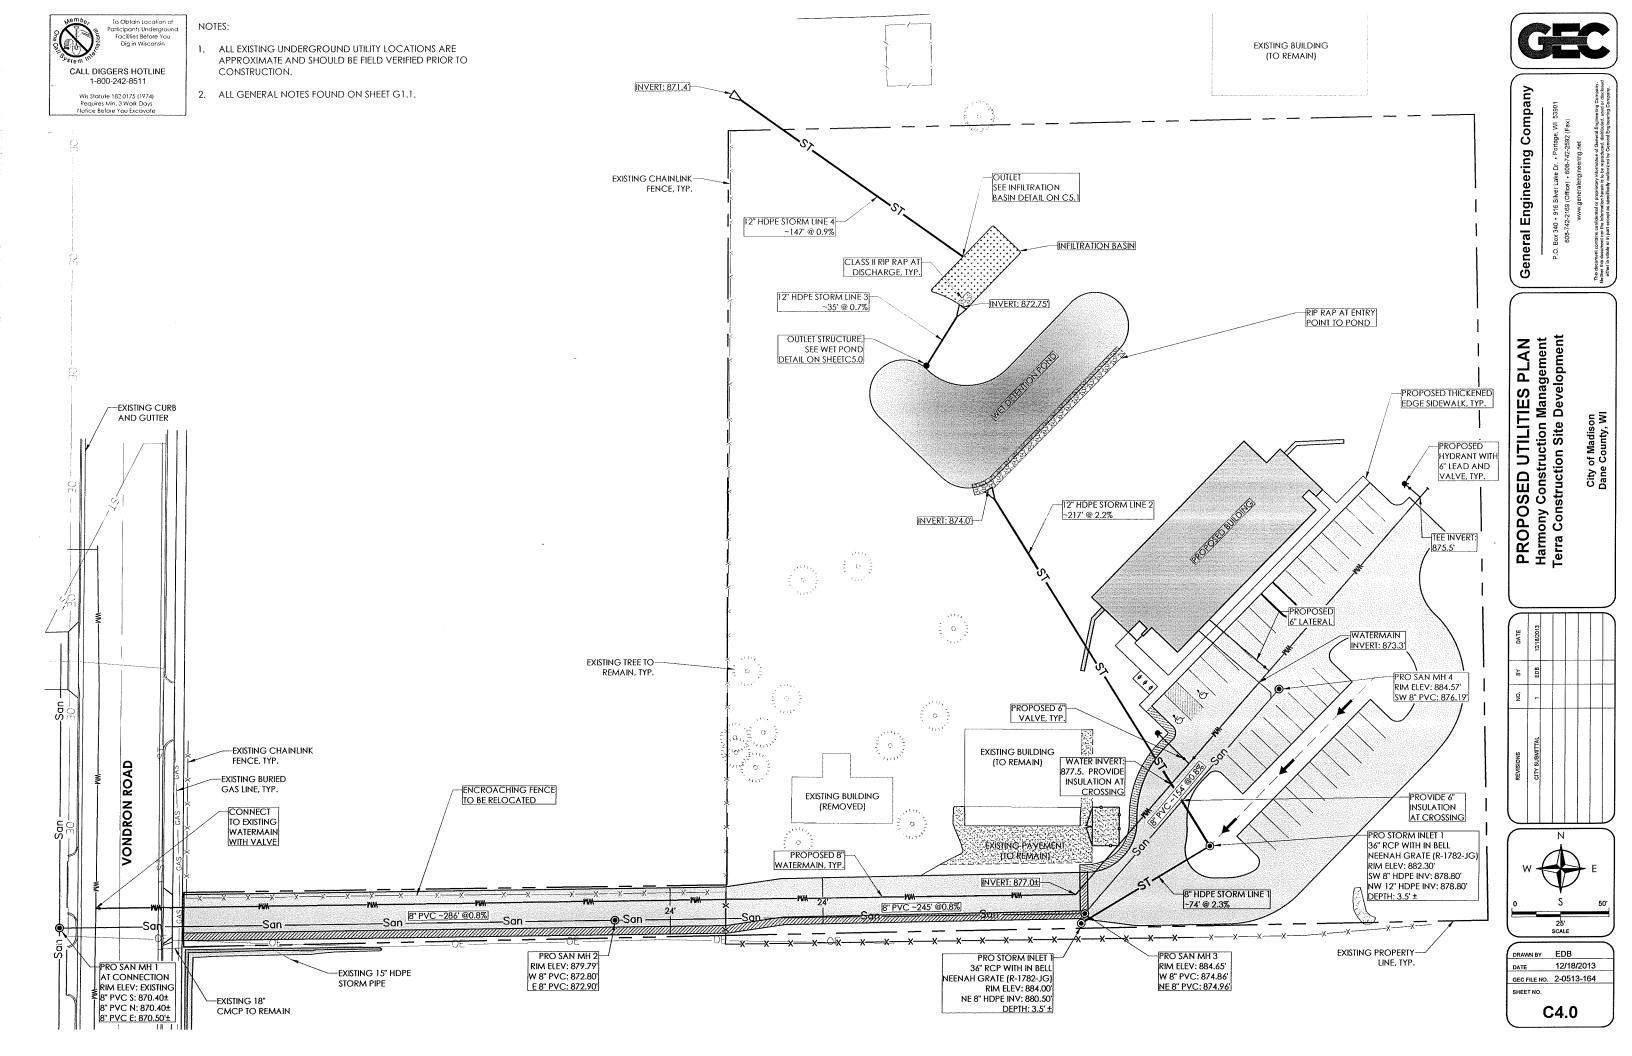

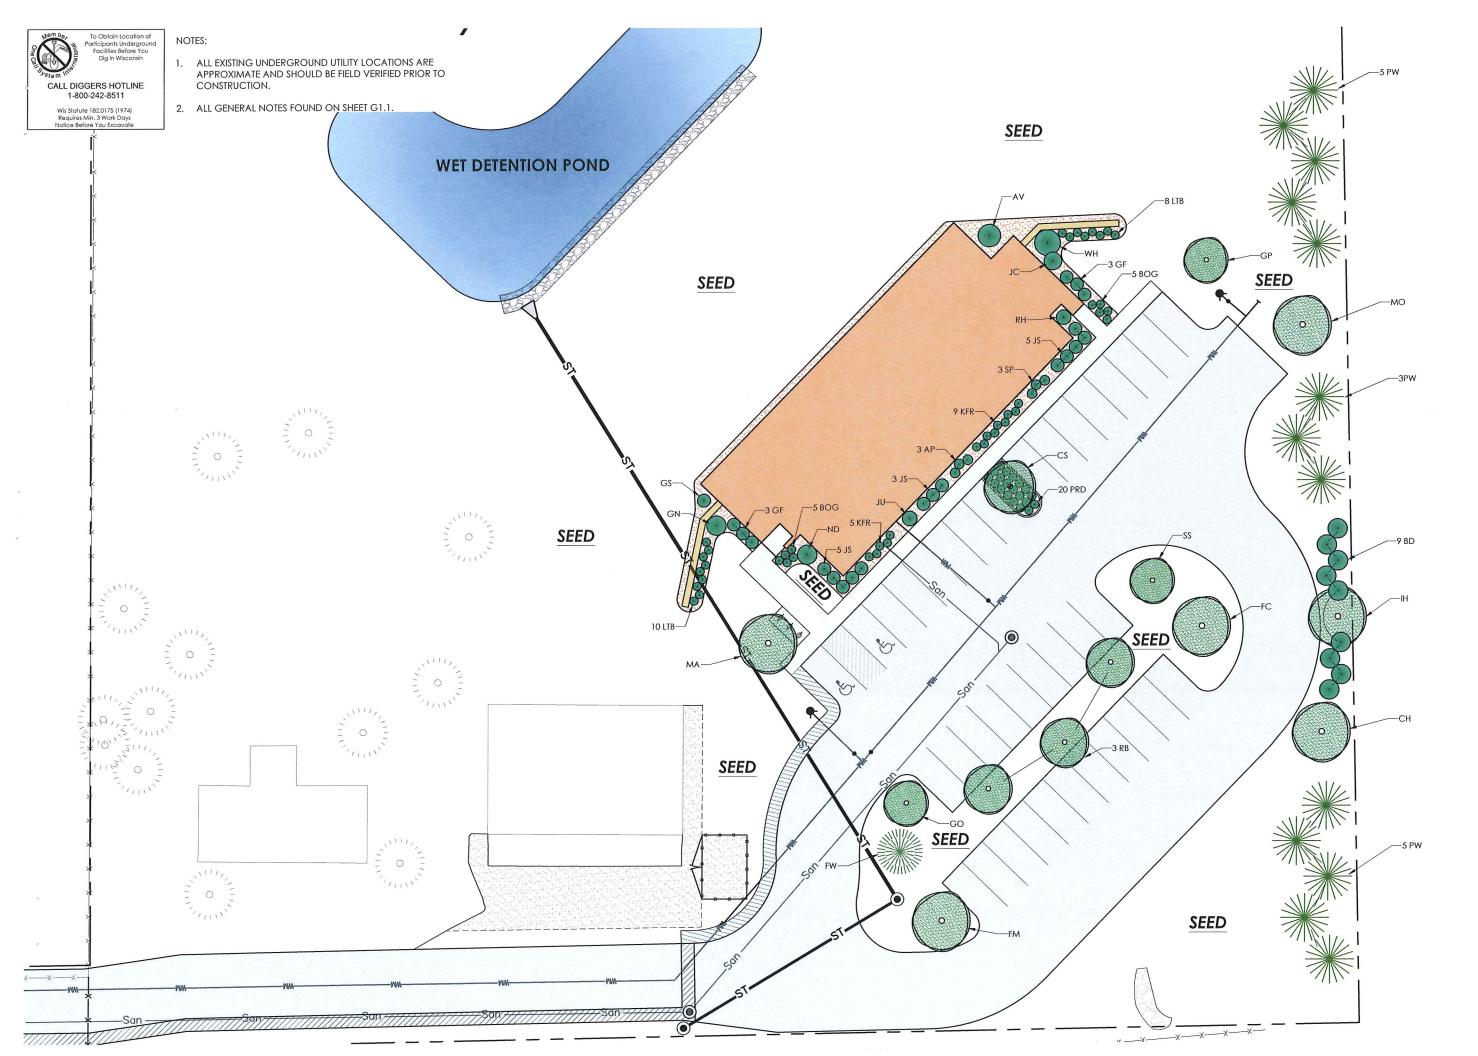



General Engineering Company

PROPOSED LANDSCAPING PLAN Harmony Construction Management Terra Construction Site Development

City of Madison Dane County, WI

DRAWN BY EDB

DATE 12/18/2013 GEC FILE NO. 2-0513-164

SHEET NO. C8.0

BD	BAILEY DOGWOOD	24-30	6½' O/C
	(CORNUS SERICEA 'BAILEYI')		
GF	GOLDFLAME SPIREA	18-24	31/2" O/C
	(SPRAEA x BUMALDA 'GOLDFLAME')		
GN	GOLDEN NINEBARK 'GOLDEN DARTS'	18-24	51/2" O/C
	(PHYSOCARPUS OPULIFOLIUS 'DARTS GOLD')		
GS	GLOBE BLUE SPRUCE	18-24	4' O/C
	(PICEA PUNGENS 'GLAUCA GLOBOSA')		

JC BLUE CHIP JUNIPER 18-24 6' O/C (JUNIPERUS HORIZONTALIS 'BLUE CHIP') 31/2' O/C, BLUE-GREEN NEEDLES BLUE STAR JUNIPER 18-24 (JUNIPERUS SQUAMATA 'BLUE STAR') MOUNTBATTEN UPRIGHT JUNIPER 3'-4' HT 4' O/C, GRAY-GREEN NEEDLES

(JUNIPEPRUS CHINENSIS 'MOUNTBATTEN') 5 O/C, RED-PURPLE FOLIAGE DIABLO NINEBARK 18-24 (PHYSOCARPUS OPULIFOLIUS 'MONLO') SUMMER CREAMY-WHITE FLOWERS RH 'PJM-HYBRID' RHODODENDRON 18-24 4' O/C. BROADLEAF EVERGREEN, FLOWERS

(RHODODENDRON 'PJM-HYBRID') 'HAKLIRO NISHIKI' DWARE WILLOW 7' O/C. TRICOLOR LEAVES 30-36 (SALIX INTEGRA 'HAKURO HISHIKI'

* Shrubs shown in container root ball condition at time of planting.

TREES			
CH	'PRAIRIE PRIDE' COMMON HACKBERRY	21/2" CAL.	YELLOW FALL COLOR
	(CELTIS OCCIDENTALIS 'PRAIRIE PRIDE')		
CS	'CLEVELAND SELECT' ORNAMENTAL PEAR	2"-CAL.	WHITE FLOWER, RED FALL COLOR
	(PYRUS CALLERYANA 'CLEVELAND SELECT')		0044055444 00400
FC	'CELEBRATION' FREEMAN MAPLE	2½"-CAL.	ORANGE FALL COLOR
EVA	(ACER x FREEMANII 'CELEBRATION')	4'-5' HT.	14' O/C
FW	WHITE FIR (ABIES CONCOLOR)		ORANGE-RED FALL COLOR
FM	'AUTUMN BLAZE' FREEMAN MAPLE	2½ "-CAL.	ORANGE-RED FALL COLOR
GO	(ACER x FREEMANII 'AUTUMN BLAZE') GINKGO (MALE PLANT)	2½"-CAL.	
00	(GINKGO BILOBA var. 'AUTUMN GOLD')	272 -OAL,	GOLDEN YELLOW FALL COLOR
ΙH	IMPERIAL HONEYLOCUST	21/2"-CAL.	YELLOW FALL COLOR
	(GLEDITSIA TRIACANTHOS INERMIS 'IMPERIAL		
MA	'AUTUMN FLAME' RED MAPLE	2½"-CAL.	EARLY RED FALL COLOR
	(ACER RUBRUM 'AUTUMN FLAME')		
MO	'OCTOBER GLORY' RED MAPLE	21/2"-CAL.	
	(ACER RUBRUM 'OCTOBER GLORY')		DP. RED TO REDDISH PURPLE FALL COLOR
MP	'PRAIRIFIRE' FLOWERING CRABAPPLE	2"-CAL.	ROSE FLOWER-LATE, REDDISH FALL COLOR
	(MALUS x 'PRAIRIFIRE'		
PW	WHITE PINE (PINUS STROBUS)	5'-6' HT.	15' O/C
RB	'HERITAGE' RIVER BIRCH	8'-10' HT.	MULTI (3+) TRUNK
	(BETULA NIGRA 'HERITAGE')		
SS	'SPRING SNOW FLOWERING CRABAPPLE	2"-CAL.	WHITE FLOWERS, NO FRUITS
	(MALUS x 'SPRING SNOW')		

* Trees shown in B&B (balled and Burlapped) root condition at time of planting.

ORNAMENTAL GRASSES

JS

Key	Common Name (Botanical Name)	Spacing (Inches O/C)	Comments
BOG	BLUE OAT GRASS (HELICTOTRICHON SEMPERVIRENS)	30	LEAVES-2' HT., SPIKES OF SILVERY BLUE LEAVES
KFR	'KARL FOERSTER' FEATHER REED GRASS	30	5'-6' HT.
	(CALAMAGROSTIS ACUTIFLORA 'KARL FOERSTER')		SEED HEADS GOLD TO SILVER
LTB	LITTLE BLUESTEM 'THE BLUES'	30	2'-3' HT, CRIMSON-RED FALL COLOR
	(SCHIZACHYRIUM SCOPARIUM 'THE BLUES')		
PRD	PRAIRIE DROPSEED (SPOROBOLUS HETEROLEPIS)	24	2' HT
	(PENNISETUM SETACEUM 'RUBRUM')		

* Ornamental grasses shown as gallon container size at time of planting

LANDSCAPING POINTS:

Foundation Plantings: 163 pts.

Interior Parking Lot Plantings: 230 pts.

Site 'Green Space' Development: 350 pts. (This area primarily utilized as screening along east property line.)

LANDSCAPE SPECIFICATIONS

A. QUALITY ASSURANCE

- . All trees, shrubs and planting material shall meet or exceed the specifications of Federal, State, and County laws requiring inspection for plant disease and insect control.
- Quality and size shall conform to the current edition of "horticultural Standards" for number one grade nursery stock as adopted by the American Association of Nurserymen.
 - All plants shall be true to name. In all cases, botanical names shall take precedence over comon names
- 4. All plant materials shall conform to varieties and sizes listed on plant "Key" list. Trees and shrubs of larger size may be used if acceptable to the owner, and if sizes of roots or balls are increased proportionately. No substitutions without written approval of owner.
- Trees and shrubs shall be grown in a recognized nursery in accordance with standard horticultural practice. Provide healthy, vigorous stock free of disease, insects, eggs, larvae, and defects such as knots, sunscald, injuries, abrasions, or disfigurement
- 7. The owner, or owner's representative, reserves the right to inspect trees and shrubs at site before planting, for compliance with requirements for name, variety, size, and quality. Maintain labels and/or plant
- identification tags on all plants at time of planting. Do not remove tags after planting.

 8. Landscaping work shall be performed by personnel familiar and experienced with planting procedures. Work shall be carried out under the supervision of a qualified planting foreman

B. DELIVERY, STORAGE, AND HANDLING

- Do not prune prior to delivery. Do not bed or bind-tie trees or shrubs in such a manner as to damage bark, break branches, or destroy the natural shape. Provide protective cover during delivery.
- 2. Deliver trees and shrubs only after preparations for planting have been completed and plant immediately. If planting is delayed more than 6 hours after delivery, set trees and shrubs in shade, protect from weather and mechanical damage, and keep roots moist

C. SITE INVESTIGATION

- Contractor shall be completely familiar with all conditions at site prior to the execution of Contractor's work.
 Prior to all landscape work, Contractor will inspect the installed work of all other trades, and verify that all such work is complete prior to commencing installation.
- 3. Contractor will determine location of underground utilities and perform work in a manner, which will avoid possible damage.

D. RETAINING WALLS (IF APPLICABLE)

- 1. All measurements, locations, and figures shown are approximate, used as reference and are to field verified.
- All retaining walls, unless shown otherwise, are to be constructed of boulder rock material, native to the area.
 A pervious soil retainer fabric, suitable for boulder wall construction, shall be installed behind boulder walls at all locations
- 4. Contractor shall be proficient at boulder wall construction and have previous work experience at boulder wall construction.
- 5. Contractor shall provide references of site locations of boulder wall construction projects previously completed, to landscape architect, 30 days prior to commencement of boulder wall work.
- 6. Contractor to visit site prior to providing an estimate of installation costs.

F. INSTALLATION OF SHRUBS AND TREES

- Plant nursery stock upon delivery to the site. If this is not feasible, regularly water all nursery stock and place them in a cool area protected from sun and drying winds.
- 2. Dig holes no deeper than the level on which the bottom of the root ball will set. Place trees and shrubs in planting pits with root collar slightly above grade when installing.
- 3. Fertilize all trees and shrubs with a commercial slow-release fertilizer tablet or packet, installed to manufacturer's specifications.
- 4. Backfill, to a minimum of 3-times the diameter of the root ball, all trees and shrubs with a soil mix rich in organic matter. Water in all plant material accordingly to provide sufficient moisture for plants during
- 5. Do not stake trees, unless exposure to windy conditions requires initial staking. Remove stakes within one year, or as conditions dictate.
- 6. Where trees are located independently in lawn areas provide a 5-tool diameter mulch bed around each tree. Mulch around trees with a 3-inch depth of shredded hardwood bark mulch, free of large chunks spread evenly. Keep mulch away from root collar of tree. Do not install a bed divider around tree nor weed barrier fabric under mulch.

E SHRUR AND TREE PLANTING REDS

- 1. Mulching material, for planting beds adjacent foundation and retaining walls, where shown, is to be #1 multi-colored
- washed stone, installed and spread evenly at a depth of 2 ½ to 3 inches.

 2. Install organic shredded hardwood bark mulch in parking lot planting bed where 'Prairie Dropseed' is located, free of large chunks, installed and spread evenly at a depth of 2½ to 3 inches.

 Do not install weed
- barrier fabric in organic mulch areas. Also install shredded hardwood bark mulch along and around 'Bailey Dogwood', located to east of parking lot width of mulch area at 5-feet.

 3. A pervious weed barrier fabric, DeWitt Co. "Pro-5", or similar product of equal quality, shall be installed under
- washed stone mulch in all shrub planting bed areas shown
- 4. Where applicable, planting bed edging to be Valley View 'Black Diamond' polyethylene bed divider, installed to manufacturer's specifications

G. PERENNIAL AND/OR ORNAMENTAL GRASSES PLANTINGS

- 1. If existing soil is inferior for sustainable plant growth, remove existing soil and replace with a rich organic soil, including peat moss, bone meal (5-6 pounds per 100 sq.ft.), and any necessary soil additives to insure rich organic matter for sustainable plant growth. Avoid manure, as it contains weed seeds. Blend and mix soil, then spread evenly to final grade, providing sufficient depth for backfilling and spreading of organic
- 2. Sustainable perennial plant soil shall be installed at a minimum depth of 8-inches. For ornamental grasses, soil shall be backfilled at a minimum depth of 15-18 inches.

H. ANNUAL PLANTING BEDS (IF APPLICABLE)

- 1. Where existing soil is inferior for sustainable plant growth, remove existing soil and replace with a rich organic soil,
- at a minimum depth of 6-inches.
- 2. Install annuals according to spacing shown on plant list. 3. Prior to, or after planting annuals, apply a 5-10-5 or 10-10-10 commercial fertilizer to soil.
- 4. Water in all plants and apply under foliage.
- 5. After installation and watering, apply the pre-emergent herbicide "PREEN", by Greenview, according to manufacturer's specifications, around plants and throughout planting bed.

I. LAWN AREAS

- 1. Provide topsoil, if contract requires.
- 2. Topsoil shall be black loam native to the area, without subsoil, stones, lumps, clods of hard earth, plants, roots, sticks, and other extraneous materials
- 2. Toposin state brack toal make to the area, without substit, stories, follows, find states, plants, follows, and states which could be a stated herein may be used.

 4. Place topsoil and spread uniformly over all lawn areas to a minimum depth of 6 inches. Do not place topsoil while in a frozen or muddy condition.
- 5. Rake topsoil until surface is friable, smooth, and of uniformly fine texture immediately prior to sodding and/or seeding. Correct all soft spots and irregularities in grade 6. Just prior to sodding and/or seeding, spread and rake lawn fertilizer into topsoil at a rate of 10 lbs. per 1,000 sq. ft.
- Commercial lawn fertilizer shall be a complete fertilizer partially derived from organic sources and containing 10% nitrogen, 10% phosphoric acid, and 10% potash, all by weight as specified.

 7. Blend in new soil to match existing grades of adjacent properties, where applicable.
- 8. Seed all new and disturbed lawn areas . If sod is called for in contract, apply the followin
- - a. Sod shall be vigorous, dense, well-rooted, healthy turf, composed of a minimum of 50% Kentucky Bluegrass mix,
- grown in the general locality where it is to be used, approximately 2 inches in height. Sod shall be free of debris,
- free from disease, insect pests, stones, weeds, and other undesirable grasses.
- b. Lay sod within 24 hours from time of stripping. Do not plant dormant sod or if ground is frozen
- c. Sod pieces shall be fitted together tightly and shall be firmed down by tamping or rolling lightly to ensure contact with subgrade. Sod joints shall alternate whenever possible.
 d. Sod on slope steeper than 2 to 1 shall be held in place by wooden pins, about 1 square and 6 long, driven through the sod into the soil until they are flush with the top of the sod.
- e. All sodded areas shall be watered adequately with a fine spray to prevent drying and shrinking of sod. f. The completed sodded surfaces shall be true to finished grade, even and firm at all points.
- g. Contractor is responsible to top dress and re-sod any excessive cracks which appear upon shrinkage, if and when applicable, during the initial growing season.

- a. Where seeding is required, seed blend shall be "Madison Parks Lawn Seed Mix", blended by Olds Seed
- Company of Madison, Wisconsin, or similar blend of equal proportion and germination rate b. Sow uniformly at a minimum rate of 6 lbs. per 1,000 sq. ft.
- c. After seeding, apply mulch consisting of clean marsh hay, or straw, as free of weeds as possible, uniformly over all seeded areas.

 11. Protect all sodded and/or seeded areas, as necessary, to prevent trampling and/or damage, by erecting temporary
- fences, barriers, signs, etc.

J. PROJECT WARRANTY

- 1. Trees and Shrubs:
- a. Guarantee trees and shrubs, for a period of one year after date of installation, against defect including death and
- unsatisfactory growth, except for abuse or damage by others.
- d. Replace trees and shrubs, which are in doubtful condition, by the end of warranty period 2. Perennials and Ornamental Grasses:
- a. Guarantee all perennials and ornamental grasses for a period of 90 days following installation. Replace any
- dead plants by the end of warranty period.

- Annuals:
 Guarantee all annuals for a period of 60 days following installation. Replace any dead plants by the end of warranty period.
- Lawn Areas (Sodding and Seeding):
 a. Lawn areas placed during the spring planting season shall be guaranteed for ninety (90) days following final placement.
- b. Lawn areas placed during fall planting season shall be guaranteed through July 1st of the following year.
 c. Remove and replace all lawn areas found dead or not in satisfactory growth. Replace lawn areas with same
- turf grass blend as originally specified. Cost of replacement shall be born by the Contractor, except replacement required due to loss or damage from Owner occupancy, vandalism, or natural disaster.

 d. Where maintenance is taken over by Owner during guarantee period, Contractor shall inspect, periodically,
 maintenance operation of Owner, and shall promptly report to Owner any method, practices, or operations which he or she considers unsatisfactory.

Company

Engineering


916 Box 340 • 608-742-

General of Madison e County, WI

CIFICATIONS ANDSCAPING SPECIFICATION Harmony Construction Management Terra Construction Site Development LAND

City o


ձ

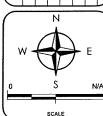

DRAWN BY EDB 12/18/2013 DATE GEC FILE NO. 2-0513-164

C8.1



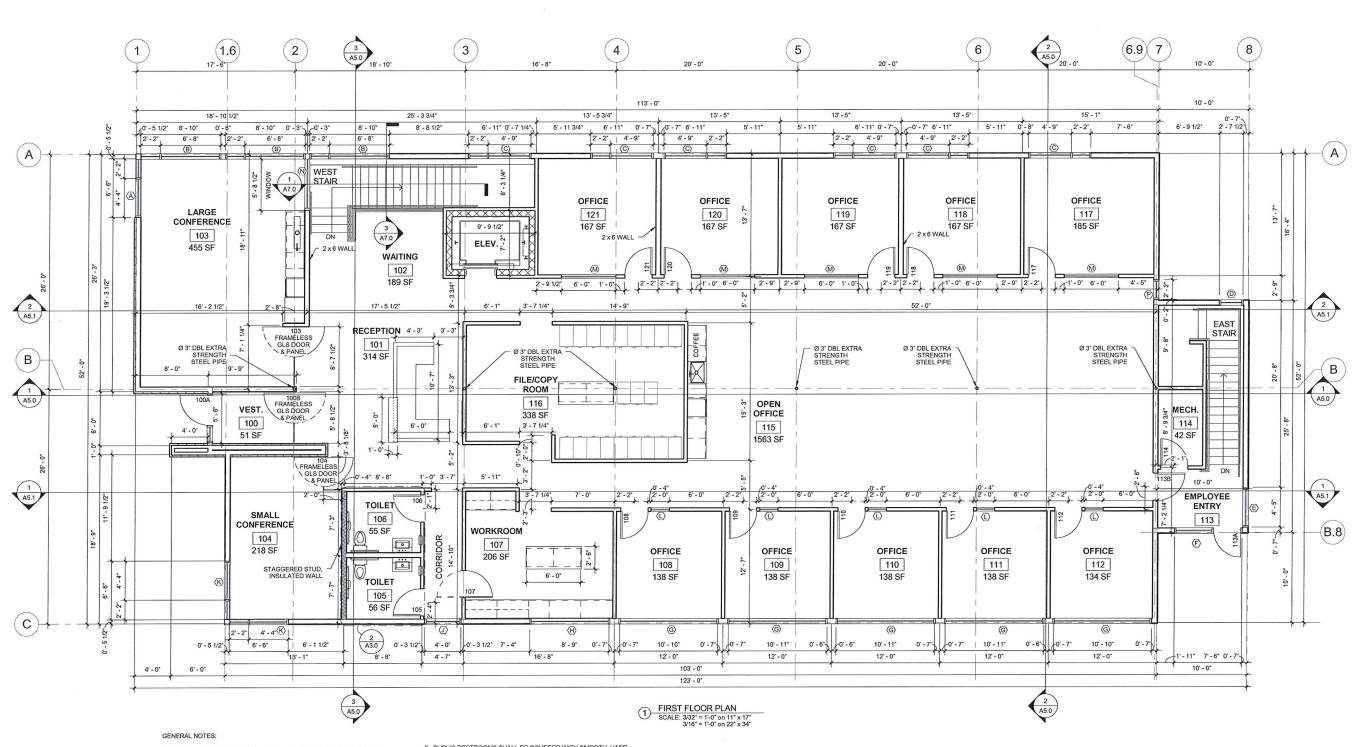

- CONTRACTOR TO PROVIDE (2) FIRE EXTINGUISHERS PER IFC 906 AND OWNER TO MAINTAIN THEM IN ACCORDANCE WITH THIS SECTION & NFPA 10. THEY SHALL BE LOCATED IN CONSPICUOUS LOCATIONS ALONG NORMAL PATHS OF TRAVEL.(CONTRACTOR TO COORDINATE WITH LOCAL FIRE INSPECTOR)
- PROVIDE EXIT SIGNS PER IBC 1011. EXIT SIGNS SHALL BE READILY VISIBLE FROM ANY DIRECTION OF EGRESS TRAVEL & SHALL BE CONTINUOUSLY LUMINATED FOR NOT LESS THAN 90 MINUTES IN CASE OF POWER LOSS.
- 3. PROVIDE EMERGENCY LIGHTS PER IBC 1006. LIGHTS AT EXTERIOR EXIT DOORS SHALL BE PROVIDED & SHALL ILLUMINATE AT ALL TIMES WHILE THE BUILDING IS OCCUPIED IN THE EVENT OF POWER SUPPLY FAILURE.
- 4. PROVIDE A SIGN STATING THE OCCUPANT LOAD PER IBC 1004.3.
 THE SIGN SHALL BE POSTED IN A CONSPICUOUS PLACE, NEAR THE
 MAIN EXIT OR EXIT ACCESS DOORWAY FROM THE ROOM OR SPACE,
 THE SIGN SHALL BE OF AN APPROVED LEGIBLE PERMANENT DESIGN.
- 5. PUBLIC RESTROOMS SHALL BE COVERED WITH SMOOTH, HARD, NONABSORBENT MATERIALS EXTENDING A MINIMUM OF 6' ABOVE FLOOR LEVEL. WALLS WITHIN 2 FT. OF URINALS OR WATER CLOSETS SHALL BE COVERED A MINIMUM OF 4 FT. ABOVE FLOOR LE
- 6. ROOM(S) WITH A MOP BASIN OR UTILITY SINK SHALL HAVE AN EXHAUST FAN WHICH RUNS CONTINUOUSLY WHILE THE BUILDING IS OCCUPIED.
- 7. ROOF TRUSS DESIGN BY OTHERS
- 8. ALL DIMENSIONS ARE FROM OUTSIDE OF EXTERIOR WALL FRAMING TO CENTER OF INTERIOR WALLS.



SAPA INVESTMENT REAL ESTATE LLC

Construction Management, Inc.

General Eng
Bug John How DRIVE
MADISON, WI 53719
PHONE 609-224-3310
FAX: 609-223-4310
FAX: 609-223-4320
FAX: 609-223-4310
FAX: 609-223-4320
FAX: 609-223-4310
FAX: 609-223-4320
FAX: 6

REVISIONS NO. BY DATE


City Submittal 1 JEO 12/18/20**

Representation of a decidence of a decid


FIRST FLOOR PLAN
TERRA ENGINEERING OFFICE FACILITY

DATE 12/13/2013
BY JEO
GEC FILE NO. 2-0513-164

A1.0

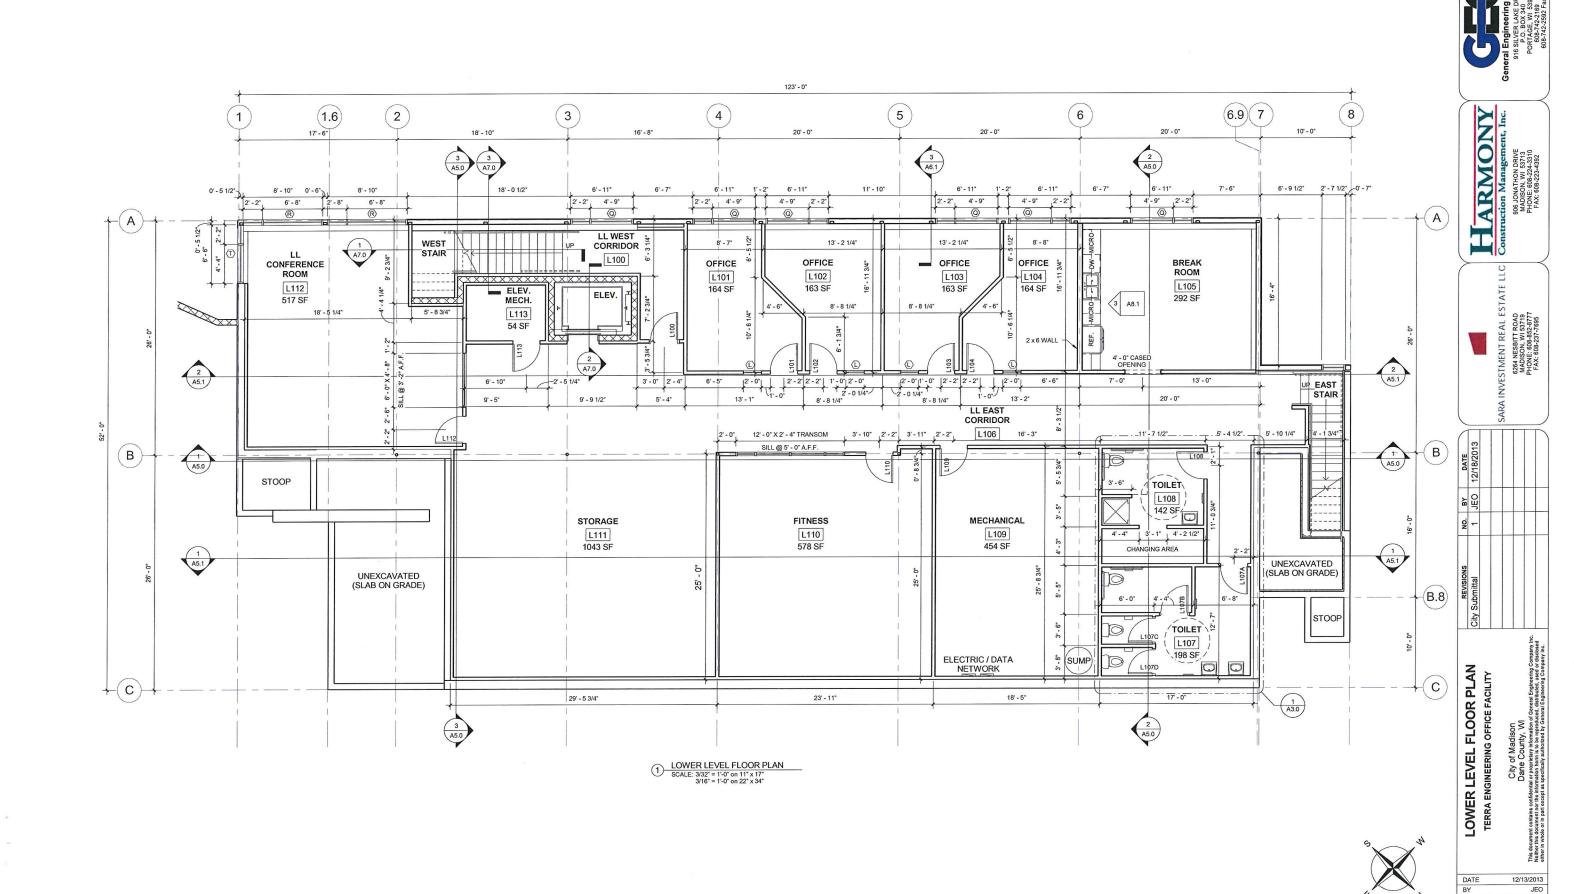

GEC FILE NO. 2-0513-164
SHEET NO. **A1.1**

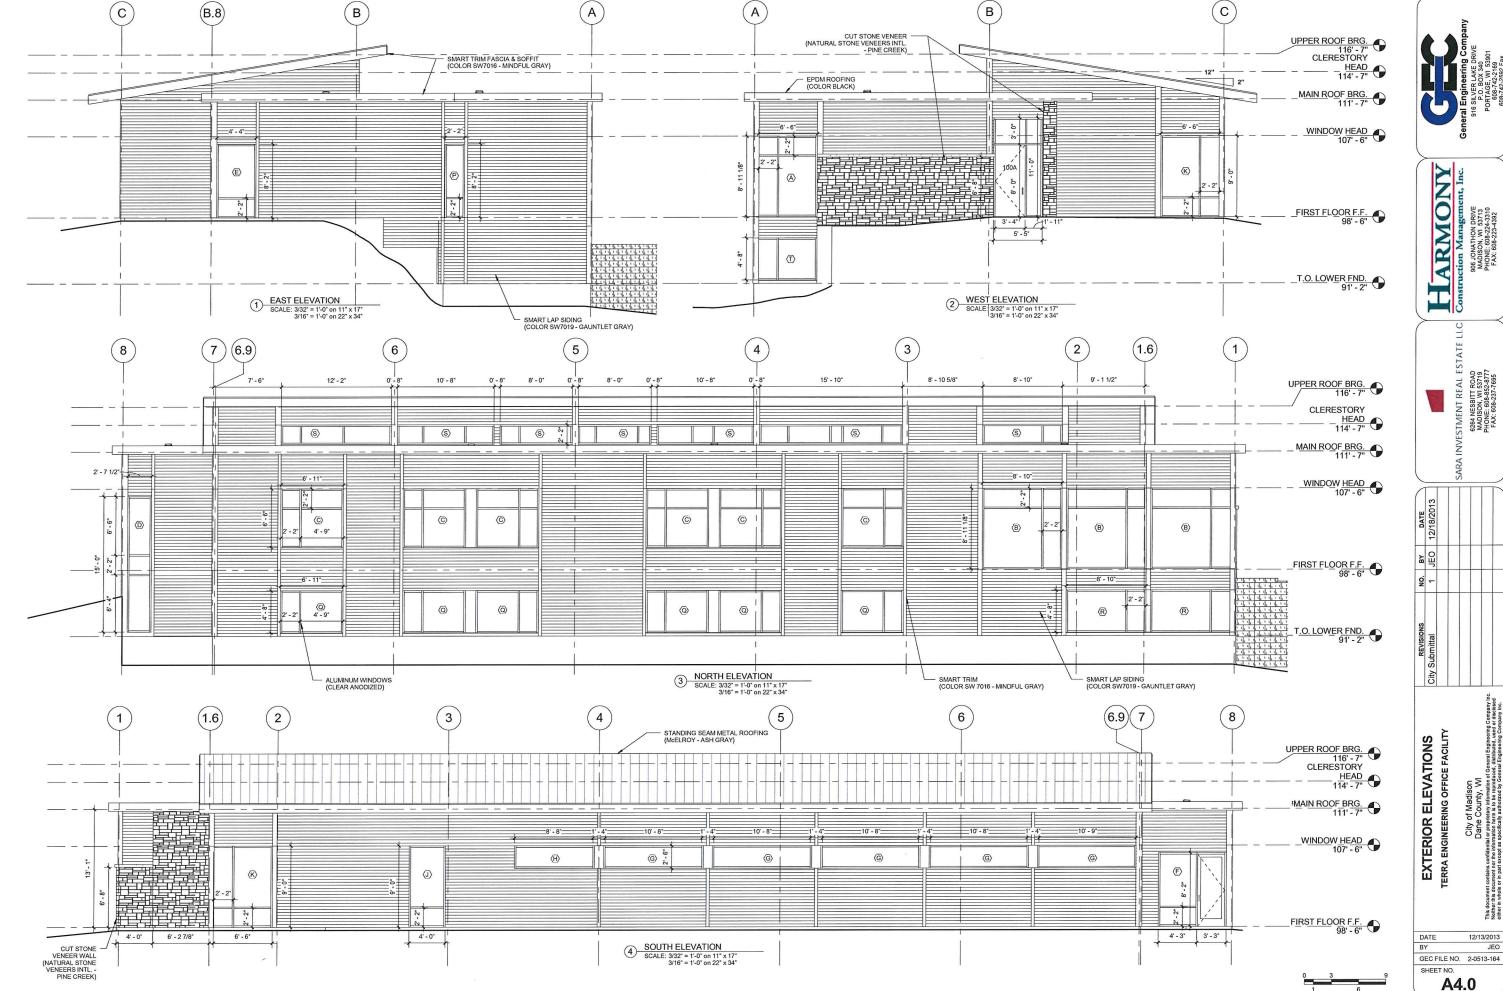

ESTMENT REAL ES 6264 NESBITT ROAD MADISON, WI 53719 PHONE: 608-852-8777 FAX: 608-237-7695

12/13/2013




3 NORTH PERSPECTIVE



2 ENTRANCE PERSPECTIVE



1 WEST PERSPECTIVE

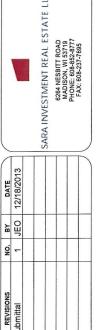

Construction Management, Inc. 906 JONATHON PRIVE MADISON, WI 53713 PHONE: 080-204-3310 FAX: 606-223-4392

PERSPECTIVE VIEWS
TERRA ENGINEERING OFFICE FACILITY

DATE

12/13/2013 JEO GEC FILE NO. 2-0513-164

SHEET NO. **A12.0**