

City of Madison Fire Department

314 W Dayton Street, Madison, WI 53703-2506

Phone: 608-266-4420 • Fax: 608-267-1100 • E-mail: fire@cityofmadison.com


Project Address: 817-821 V	817-821 Williamson St.			
Contact Name & Phone #:	Kevin Burow 608-836-3690			

FIRE APPARATUS ACCESS AND FIRE HYDRANT WORKSHEET

1. Is the building completely protected by an NFPA 13 or 13R automatic fire sprinkler system? If non-sprinklered, fire lanes extend to within 150-feet of all portions of the exterior wall? If sprinklered, fire lanes are within 250-feet of all portions of the exterior wall?	X Yes ☐ Yes X Yes	☐ No ☐ No ☐ No	N/AN/AN/A
 2. Is the fire lane constructed of concrete or asphalt, designed to support a minimum load of 85,000 lbs? a) Is the fire lane a minimum unobstructed width of at least 20-feet? b) Is the fire lane unobstructed with a vertical clearance of at least 13½-feet? c) Is the minimum inside turning radius of the fire lane at least 28-feet? d) Is the grade of the fire lane not more than a slope of 8%? e) Is the fire lane posted as fire lane? (Provide detail of signage.) f) Is a roll-able curb used as part of the fire lane? (Provide detail of curb.) g) Is part of a sidewalk used as part of the required fire lane? (Must support +85,000 lbs.) 	X Yes X Yes X Yes X Yes X Yes X Yes Yes Yes Yes Yes	☐ No	 N/A N/A N/A N/A N/A N/A N/A N/A N/A
3. Is the fire lane obstructed by security gates or barricades? If yes:a) Is the gate a minimum of 20-feet clear opening?b) Is an approved means of emergency operations installed, key vault, padlock or key switch?	☐ Yes ☐ Yes ☐ Yes	NoNoNo	N/A N/A N/A
4. Is the Fire lane dead-ended with a length greater than 150-feet? If yes, does the area for turning around fire apparatus comply with IFC D103?	☐ Yes ☐ Yes	X No No	□ N/A ▼ N/A
5. Is any portion of the building to be used for high-piled storage in accordance with IFC Chapter 3206.6 If yes, see IFC 3206.6 for further requirements.	Yes	X No	□ N/A
	_		
6. Is any part of the building greater than 30-feet above the grade plane?	X Yes	☐ No	□ N/A
 Is any part of the building greater than 30-feet above the grade plane? If yes, answer the following questions: a) Is the aerial apparatus fire lane parallel to one entire side of the building and covering at least 25% of the perimeter? It is covering one entire side but is shy of the 25% b) Is the near edge of the aerial apparatus fire lane between 15' and 30' from the building? c) Are there any overhead power or utility lines located across the aerial apparatus fire lane? d) Are there any tree canopies expected to grow across the aerial fire lane? (Based on mature canopy width of tree species) 	☐ Yes☒ Yes☐ Yes☐ Yes	NoNoNoNoNoNoNo	 N/A N/A N/A N/A N/A
If yes, answer the following questions: a) Is the aerial apparatus fire lane parallel to one entire side of the building and covering at least 25% of the perimeter? It is covering one entire side but is shy of the 25% b) Is the near edge of the aerial apparatus fire lane between 15' and 30' from the building? c) Are there any overhead power or utility lines located across the aerial apparatus fire lane? d) Are there any tree canopies expected to grow across the aerial fire lane? (Based on mature canopy width of tree species) e) Does the aerial apparatus fire lane have a minimum unobstructed width of 26-feet?	☐ Yes	☐ No ☐ No ☑ No	 N/A N/A N/A N/A N/A N/A
If yes, answer the following questions: a) Is the aerial apparatus fire lane parallel to one entire side of the building and covering at least 25% of the perimeter? It is covering one entire side but is shy of the 25% b) Is the near edge of the aerial apparatus fire lane between 15' and 30' from the building? c) Are there any overhead power or utility lines located across the aerial apparatus fire lane? d) Are there any tree canopies expected to grow across the aerial fire lane? (Based on mature canopy width of tree species) e) Does the aerial apparatus fire lane have a minimum unobstructed width of 26-feet? f) Is the space between the aerial lane and the building free of trees exceeding 20' in heights? 7. Are all portions of the required fire lanes within 500-feet of at least (2) hydrants?	☐ Yes☒ Yes☐ Yes☐ Yes	NoNoNoNoNoNo	 N/A N/A N/A N/A
If yes, answer the following questions: a) Is the aerial apparatus fire lane parallel to one entire side of the building and covering at least 25% of the perimeter? It is covering one entire side but is shy of the 25% b) Is the near edge of the aerial apparatus fire lane between 15' and 30' from the building? c) Are there any overhead power or utility lines located across the aerial apparatus fire lane? d) Are there any tree canopies expected to grow across the aerial fire lane? (Based on mature canopy width of tree species) e) Does the aerial apparatus fire lane have a minimum unobstructed width of 26-feet? f) Is the space between the aerial lane and the building free of trees exceeding 20' in heights?	☐ Yes	☐ No	 N/A N/A N/A N/A N/A N/A N/A

Attach an additional sheet if further explanation is required for any answers.

This worksheet is based on MGO 34.503 and IFC 2015 Edition Chapter 5 and Appendix D; please see the codes for further information.

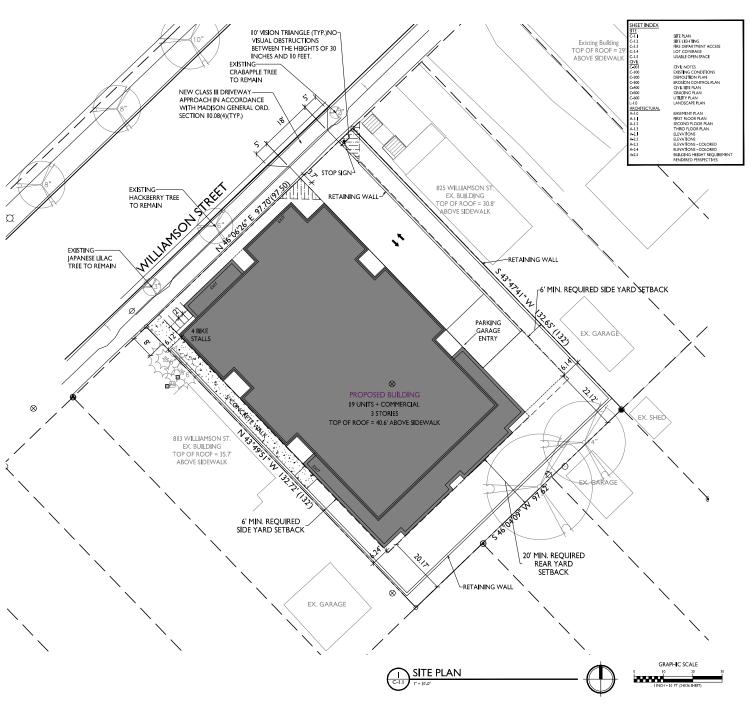

TSS (TRADITIONAL SHOPPING STREET DISTRICT 12,870 S.F./ .29 ACRES PROVIDED ZONING REQUIREMENTS 3,020 (159 \$.F./UNIT) 760 \$.F./(40 \$.F./UNIT) 9,513 \$.F. (74%) 10,940 \$.F. (85% MAX.) 3 STORJES/40.33' 3 STORJES/40' ALLOWED WITH CONDITIONAL USE (28.065(3)) 775 S.F. 26,776 S.F. (INCL. BASEMENT) 2.08 Phone: 7681 University Ave, See 281 688.836.3490 Middleson, WI 52562 VEHICLE PARKING STALLS
UNDERGROUND GARAGE 17 STALLS PROVIDED ZONING REQUIREMENTS

2 (10% OF TOTAL UNITS

SURFACE COMMERCIAL. GENERAL NOTES:

PARKING RATIO

BICYCLE PARKING: GARAGE LONG-TERM (2'X6' FLOOR MOUN SURFACE GUEST

SITE DEVELOPMENT DATA

ZONING

DWELLING UNITS LOT AREA / D.U. DENSITY

USABLE OPEN SPACE LOT COVERAGE

BUILDING HEIGHT

COMMERCIAL AREA

GROSS FLOOR AREA FLOOR AREA RATIO

DWELLING UNIT MIX: ONE BEDROOM TWO BEDROOM

I. THE APPLICANT SHALL REPLACE ALL SIDEWALK AND CURB AND GUTTER
THAT ABUTS THE PROPERTY THAT IS DAMAGED BY THE CONSTRUCTION.
OR ANY SIDEWALK AND CURB AND GUTTER WHICH THE CITY ENGINEER
DETERMINES NEEDS TO BE REPLACED BECAUSE IT IS NOT AT A DESTRABLE
GRADE, REGARDLESS OF WHETHER THE CONCITION EXISTED PRIOR TO
BEGINNING CONSTRUCTION.

2.ALL WORK IN THE PUBLIC RIGHT OF WAY SHALL BE PERFORMED BY A CITY-LICENSED CONTRACTOR.

3.ALL DAMAGE TO THE PAVEMENT ON CITY STREETS, AND ADJACENT TO THIS DEVELOPMENT SHALL BE RESTORED IN ACCORDANCE WITH THE CITY OF MADISON'S PAVEMENT PATCHING CRITERIA.

4. ALL PROPOSED STREET TREE REPOVALS WITHIN THE RIGHT OF WAY SHALL BE REMEMBED BY CITY FORESTRY BEFORE THE FLAN COMMESSION REFERMS STREET THE REPOVALS REQUEST ARROWS AND STREET THE REPOVAL FORESTRY AND STREET THE REPOVAL TREET THE REPOVAL THE REMEMBER OF THE REPOVAL THE REPOVAL THE REPOVAL THE REMEMBER OF THE REMEMBE

AS DEFINED THE SECTION (BY 1) OF CITY OF MADBON STANDARD SECRECATIONS FOR RUBLE VOMES CONSTRUCTION NO EXCAVATION IS PROPRIED FOR THE STATE THE OWNER CONTROL OF THE STREET THE OWNER CULTIVES GOTE OWNER STATE OF THE STREET THE OWNER CULTIVES GOTE OWNER STATE OF THE STATE THE OWNER CULTIVES GOTE OWNER STATE OWNER OWNER OF THE OWNER OWNER

A CONTRACTOR SHALL TAKE PRECALITIONS DURING CONSTRUCTION TO 4 CONTRACTOR SHALL TAKE PRECAUTIONS DUBING CONSTRUCTION TO ONT DIBIGLIGAE. SCA, OR PHAPE THE PLANT OF ANY STRET THEE. CONTRACTOR SHALL OFFICIATE COUPLED'S IN A PANNIER, AS TO NO INSECTION OF A PANNIER OF THE PLANT OF THE PLANT OF THE PLANT SHALLE SQUIPMENT AND LODDING SHALL DISCOUNTED HIS THE SHALL SEQUIPMENT AND LODDING SHALL BE THE SHALL SH

7. SECTION 107.13(G) OF CITY OF MADISON STANDARD SPECIFICATIONS FOR PUBLIC WORKS CONSTRUCTION ADDRESSES SOIL COMPACTION NEAF FUR FURILD WORKS CONSTRUCTION ADDRESSES SOL, COMPACTION INSET TREET TREES AND SHALL BE FOLLOWED BY CONTRACTOR. THE STORAGE OF PARKED WHICLES, CONSTRUCTION FOLUMENT, BULLDING HATBRIAS, REPUBLICATION FOR THE STORAGE OF THE TREE OR WITHIN THE FORCETOR ADDRESS FOR HISTORIAN OF THE STORAGE OF THE TREE OR WITHIN THE FORCETOR ADDRESS FOR HISTORIAN OF THE STORAGE OF THE TREE OR WITHIN THE FORCETOR ADDRESS FOR HISTORIAN OF THE STORAGE OF THE TREE OR WITHIN THE FORCETOR ADDRESS FOR HISTORIAN OF THE STORAGE OF THE STORAGE

8.ON THIS PROJECT, STREET TREE PROTECTION ZONE FENCING IS 8.00 THIS PROJECT, STREET TREE PROTECTION ZONE PENCYING. IS REQUIRED. THE FERNICA SHALL BE RECTIOR BEFORE THE DEMOLITION, GRADING OR CONSTRUCTION BEGINS. THE FENCE SHALL INCLIDE THE ENTIRE MIDTH OF TERRACE AND, DETEND AT LEAST SET FOR NOOTH SIDES OF THE OUTSIDE EDGE OF THE TREE TRUNK. DO NOT REMOVE THE FENCING TO A LUW FOR DELIVERES OR EQUIPMENT ACCESS THROUGH THE TREE PROTECTION ZONE.

9 STREET TREE PRIINING SHALL BE COORDINATED WITH MADISON 9.STREET TREE PRUNING SHALL BE COORDINATED WITH MADDSON FORESTRY AT A MINIMUM OF TWO WEEKS PRIOR TO THE START OF CONSTRUCTION FOR THIS PROJECT. ALL PRUNING SHALL FOLLOW THE AMBRICAN NATIONAL STANDARDS INSTITUTE (ANSI) A300 - PART I STANDARDS FOR PRUNING.

[0]. APPROVAL OF PLANS FOR THIS PROJECT DOES NOT INCLUDE ANY APPROVAL TO PRUNE, REMOVE, OR PLANT TREES IN THE PUBLIC RIGHT-OR-WAY, PERMISSION FOR SUCH ACTIVITIES MUST BE OBTAINED FROM THE CITY FORESTER, (26-4816).

II. THE PUBLIC RIGHT-OF-WAY IS THE SOLE JURBOICTION OF THE CITY OF MADISON AND IS SUBJECT TO CHANGE AT ANY TIME. NO ITEMS SHOWN ON THIS STEP ALM IN THE RIGHT-OF-WAY ARE PERMANENT AND MAY NEED TO BE REMOVED AT THE APPLICANTS EXPENSE UPON NOTIFICATION BY THE CITY.

BIKE RACKS:



INTERIOR & EXTERIOR FLOOR MOUNTED: "INVERTED U" TYPE. MADRAX UX OR SARIS BIKE DOCK

Issued for Land Use Submittal - May 6, 2020


Issued for Landmarks - August 04, 2020 Issued for Land Use Submittal - August 17, 2020 Issued for Land Use Submittal - November 16, 2020

PROIECT TITLE Iohn Fontain Development


817-821 Williamson St Madison, Wisconsin SHEET TITLE

Site Plan

SHEET NUMBER

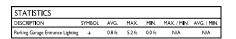

LUMINAIRE SCHEDULE						
SYMBOL LA	BEL QTY.	MANUF.	CATALOG	DESCRIPTION	FILE	MOUNTING
_ /	· 1	LITHONIA LIGHTING	LIL LED 30K MVOLT	LIL LED WALLPACK (STANDARD)	LIL_LED_30K_MVOLT.ies	8'-0" ABOVE GRADE ON BUILDING
		EXA	AMPLE LIGHT F	BOLUX CON	TOUR = 0.25 FC TOUR = 0.5 FC TOUR = 1.0 FC	

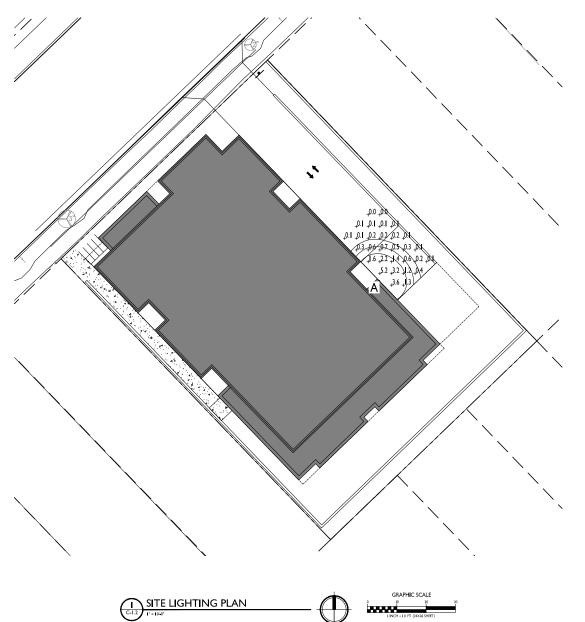

I INCH = 10 FT (24)




John Fontain
Development

817-821 Williamson St Madison, Wisconsin SHEET TITLE Site Lighting Plan

SHEET NUMBER

C-1.2

PROJECT NO. 2003

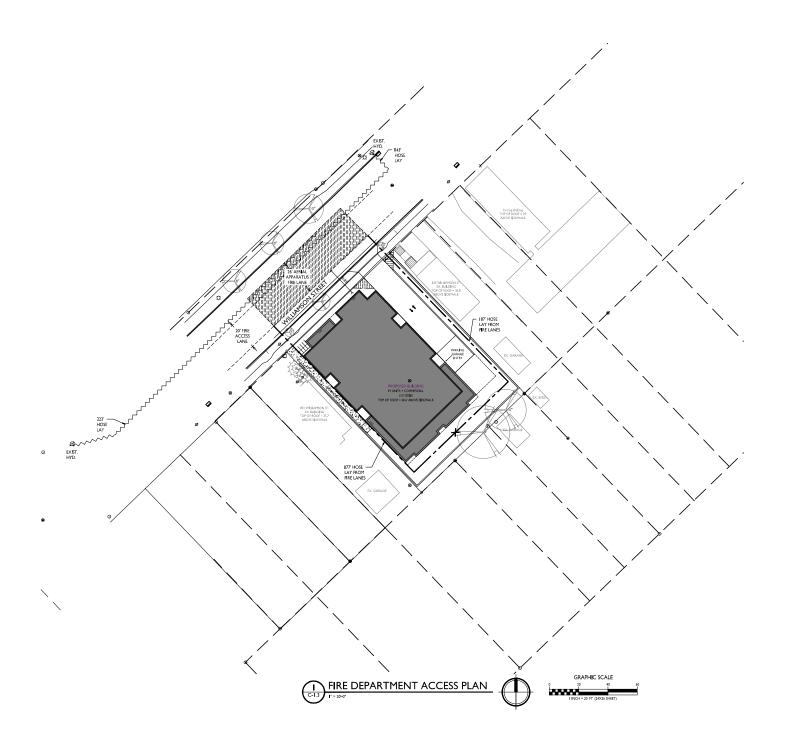



SSUED

Issued for Land Use Submittal - May 6, 2020 Issued for Land Use Submittal - August 17, 2020


PROJECT TITLE
John Fontain
Development

817-821 Williamson St Madison, Wisconsin SHEET TITLE Fire Department Access Plan

SHEET NUMBER

C-1.3

PROJECT NO. 2003

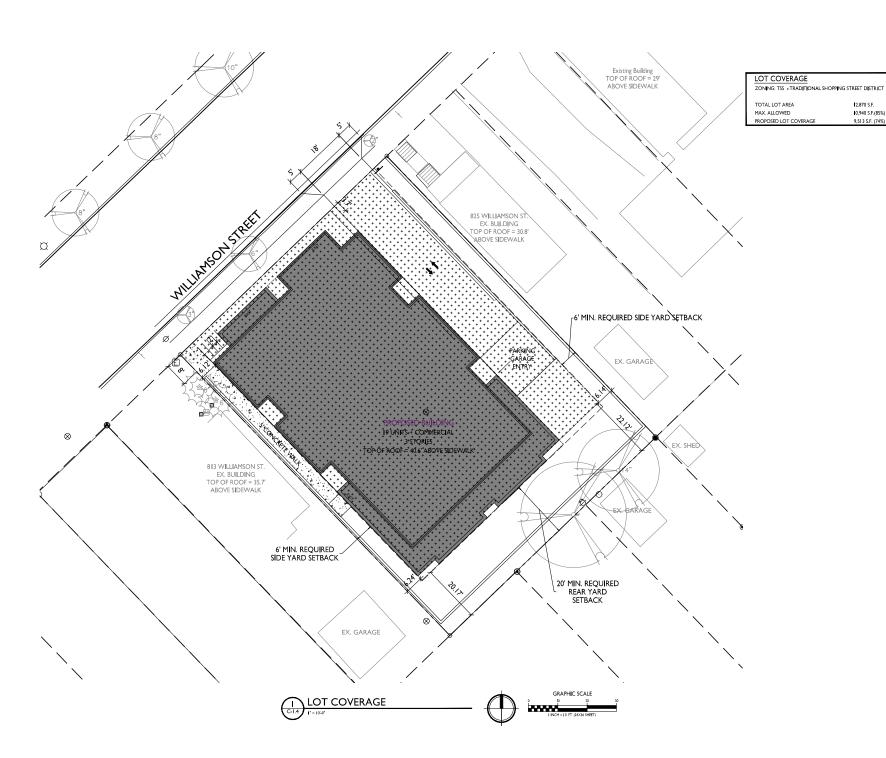



12,870 S.F.


10,940 S.F.(85%)

PROJECT TITLE

John Fontain Development

817-821 Williamson St Madison, Wisconsin
SHEET TITLE
Lot Coverage

SHEET NUMBER

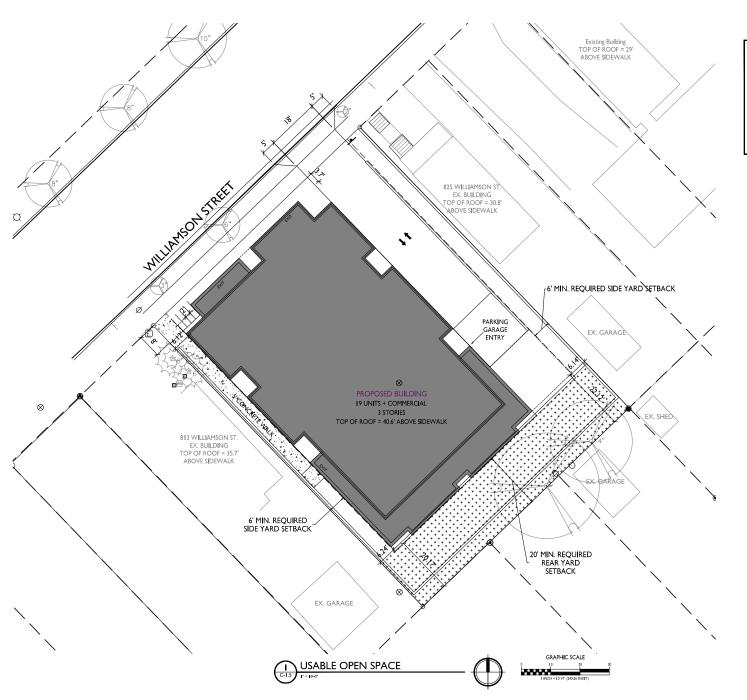

USABLE OPEN SPACE

ZONING: TSS - TRADITIONAL SHOPPING STREET DISTRICT OPEN SPACE REQUIREMENT 40 S.F / UNIT

DWELLING UNITS

960 S.F. REQUIRED

OPEN SPACE PROVIDED

BALCONIES (18) = 984 S.F. SURFACE TOTAL 2,036 S.F. 3,020 S.F. PROV**I**DED

John Fontain Development

817-821 Williamson St

Madison, Wisconsin
SHEET TITLE
Usable Open Space

SHEET NUMBER

GENERAL NOTES:

- ALL PRIVATE UTILITIES (GAS. ELECTRIC, AND TELECOMMUNICATIONS) SERVING EXISTING BUILDINGS SCHEDULED FOR DEMOLITION TO BE ABANDONED OR REMOVED BY CORRESPONDING UTILITY COMPANY.
- 2. IT IS THE CONTRACTOR'S RESPONSIBILITY TO VERIFY THE LOCATION OF UNDERGROUND UTILITIES, UTILITIES WERE LOCATED BY OBSERVED EVICENCE, MARKINGS PROVIDED BY DIGGER'S HOTLINE, AND RECORD DRAWINGS FROM THE CITY OF MADISON
- 3. CONTRACTOR SHALL VERIFY THE SIZE, TYPE, SLOPE, AND INVERTS OF ALL EXISTING STORM AND SANITARY LATERALS CALLED OUT TO BE CONNECTED TO, CONTRACTOR SHALL SUBMIT THE INFORMATION ON THE PIPES TO THE CITY INSPECTOR AND PROJECT CIVIL ENGINEE
- ANY SIDEWALK, CURB, OR OTHER PUBLIC PROPERTY DAMAGED AS PART OF THE CONSTRUCTION OF THE UTILITIES AND BUILDING SHALL BE REPLACED N-KIND PER THE CITY OF MADISON STANDARD SPECIFICATIONS.
- THE RIGHT-OF-WAY IS THE SOLE JURISDICTION OF THE CITY OF MADISON AND IS SUBJECT TO CHANGE AT ANY TIME PER THE RECOMMENDATION/PLAN OF THE CITY.
- CONTRACTOR SHALL INSTALL TREE PROTECTION FENCING IN THE AREA BETWEEN THE CURB AND SIDEWALK AND EXTEND IT AT LEAST 5 FEET FROM BOTH SIDES OF THE TREE ALONG THE LENGTH OF THE TERRACE. NO EXCAVATION IS PERMITTED WITHIN 5 FEET OF THE OUTSIDE EDGE OF A TREE TRUNK. IF EXCAVATION WITHIN 5 FEET OF ANY IREE ISNECESSARY, CONTRACTOR SHALL CONTACT CITY FOR TROUK. THE ACAVATION WITHIN SHEET OF ANY TIKES ISNEUESSARY, CONTRACTOR SHALL CONTRACT CITY FORESTRY (2004B10) PRIOR TO THE EXCAVATION TO ASSESS THE IMPACT TO THE TREE AND ROOT SYSTEM. TREE PRUNING SHALL BE (COORDINATED WITH CITY FORESTRY PRIOR TO THE START OF CONSTRUCTION. TREE PROTECTION SPECIFICATIONS CAN BE FOUND IN SECTION 107.13 OF CITY OF MADISON STANDARD SPECIFICATIONS FOR PUBLIC WORKS CONSTRUCTION http://www.otyofmacison.com/business/pw/documents/stdspecs/2018.paid1.pdf, ANY TREE REMOVALS THAT ARE REQUIRED FOR CONSTRUCTION #FTER THE DEVELOPMENT PLAN IS APPROVED WILL REQUIRE AT LEAST A 72 HOUR WAIT PERIOD BEFORE A TREE REMOVAL PERMIT CAN BE ISSUED BY FORESTRY, TO NOTIFY THE ALDER OF THE CHANGE IN THE TREE PLAN

DEMOLITION NOTES:

- THE CONTRACTOR IS RESONABILE FOR THE DENOLTON. REMOVAL AND DISPOSING IN ALCOATION APPROVED BY ALL GOVERNMEN. ANTHORITIES OF ALL STRUCTURES PAGE AND RALLS FOUNDATIONED PROVINCE DISPAGES DENOLOGY STRUCTURES UTILITIES ETC. SUCH THAT THE MPROVEMENTS SHOWN ON THE REMAINING PLANS CAN BE CONSTRUCTED. ALL FAILLIES TO BE REMOVED SHALL BE UNDERCUT TO SUTTIBLE COMPRISED FILL AMORE FOR THE SECTION OF THE STRUCTURE OF THE PROVINCE OF THE P
- THE CONTRACTOR IS RESPONSIBLE FOR OBTAINING ALL PERMITS REQUIRED FOR DEMOLITION AND DISPOSAL
- THE CONTRACTOR SHALL COORDINATE WITH THE RESPECTIVE UTILLITY COMPANIES PRIOR TO THE REMOVAL, AND/OR RELOCATION OF UTILLITIES. THE CONTRACTOR SHALL COORDINATE WITH THE UTILLY COMPANY CONSERNING PORTIONS OF WORK WHICH HAV BE PERFORMED BY THE UTILLITY COMPANY FORCING ANY FEES WHICH ARE TO BE PAID TO THE UTILLITY COMPANY FOR THER SERVICES, THE DEVELOPER IS RESPONSIBLE FOR PAYING ALL FEES AND CHARGED.
- THE LOCATIONS OF ALL EXISTING UTILITIES SHOWN ON THIS PLAN HAVE BEEN DETERMINED FROM THE BEST INFORMATION AVAILABLE AND ARE GIVEN FOR THE CONVENIENCE OF THE CONTRACTOR. THE ENGINEER ASSUMES NO RESPONSBILITY FOR THEIR ACCURACY, PRIOR TO THE START OF ANY DEMOLITION ACTIVITY, THE CONTRACTOR SHALL NOTIFY THE UTILITY COMPANIES FOR ONSITE LOCATIONS OF EXISTING UTILITIES, NOTIFY THE ENGINEER OF ANY DISCREPANCIES.
- ALL EXISTING GENERIC, PIPING, AND UTLITIES SHOWN ARE NOT TO BE INTERPRETED AS THE EXACT LOCATION, OR AS THE ONLY OSSTACLES THAT MY OCCUR ON THE SITE VERBIT EXISTING CONDITIONS AND PROCEDED WITH CAUTED AND WAS AND TABLE BELLINESS BY OTHER TO ALL UTLITY COMPANIES REGARDING DESTRUCTION AND REMOVAL OF ALL SERVICE LINES BEFORE PROCEDING WITH THE WORK, UTLITIES DETERMINED TO BE ABMONOCED AND LETFI IN PLACE OF AULIES OF INDRESBULL DISCOVERY.
- ELECTRICAL, TELEPHONE, CABLE, WATER, FIBER OPTIC CABLE, AND/OR GAS LINES NEEDING TO BEREMOVED OR RELOCATED SHALLBE COORDINATED WITH THE AFFECTED UTILITY "COMPANY, ADEQUATE TIME SHALL BE FROV DEDFORRELOCATION AND CLOSE COORDINATION WITH THE UTILITY COMPANY IS NECESSARY TO PROVIDE A SMOOTH TRANSITION IN UTILITY SERVICE.
- CONTRACTOR SHALL PROTECT THE PUELIC AT ALL TIMES WITH FENCING, BARRICADES, ENCLOSURES, COVERED WALKWAYS, ETC. CONTRACTOR SHALL SUBMIT THEIR STREET OCCUPANCY PLAN TO TRAFFIC ENGINEERING FOR APPROVAL.
- PRIOR TO DEMOLITION OCCURRING, ALL APPLICABLE EROSION CONTROL DEVICES ARE TO BE INSTALLED.
- THE CONTRACTOR MAY LIMIT SAWCUT AND FAVEMENT REMOVAL TO ONLY THOSE AREAS WHERE IT IS REQUIRED AS SHOWN ON THESE CONSTRUCTION PLANS, BUT IF ANY DAMAGE IS INCURRED ON ANY OF THE SURROUNDING PAYEMENT, ETC. THE CONTRACTOR SHALL BE RESPONSIBLE FOR ITS REMOVAL AND REPAIR IN KIND.
- 10 DAMAGE TO ALL EXISTING CONDITIONS TO REMAIN WILL BE REPLACED AT THE CONTRACTOR'S EXPENSE.
- CONTINUOUS ACCESS SHALL BE MAINTAINED FOR THE SURROUNDING PROPERTIES AT ALL TIMES DURING DEMOLITION OF THE EXISTING FACILITIES.

SITE PLAN NOTES:

- 1. PAVEMENT DESIGN SHALL BE PER THE RECOMMENDATION OF THE SOILS CONSULTANT.
- THE RIGHT-OF-WAY IS THE SOLE JURISDICTION OF THE CITY OF MADISON AND IS SUBJECT TO CHANGE AT ANY TIME PER THE RECOMMENDATION PLAN OF TRAFFIC ENGINEERING AND CITY ENGINEERING DEPARTMENTS.
- TRAFFIC CONTROL SIGNAGE SHALL BE IN ACCORDANCE WITH FEDERAL, STATE, COUNTY, CITY, AND LOCAL CODE, WHICHEVER HAS JURISDICTION.
- CITY SIDEWALK AND CURB DAMAGED IN THE COURSE OF CONSTRUCTION TO BE REPLACED PER SRADING PLAN AND PER CITY OF MAD SON STANDARD SPECIFICATIONS.
- NEW APRONS SHALL BE CONSTRUCTED AND PLACED IN CONFORMANCE WITH THE CITY OF MADISON STANDARD DETAIL 3.02 FOR COMMERCIAL

GRADING PLAN NOTES:

ALL GRADES ARE FINISH ELEVATION UNLESS NOTED OTHERWISE

EROSION CONTROL NOTES/SPECIFICATIONS:

- EROSION CONTROL DEVICES AND/OR STRUCTURES SHALL BE INSTALLED PRIOR TO CLEARING AND GRUBBING OPERATIONS. THESE SHALL BE PROPERLY MAINTAINED FOR MAXIMUM EFFECTIVENESS UNTIL VEGETATION S. RE-ESTABLISHED.
- EROSIO CONTROL IS THE RESPONSIBILITY OF THE CONTRACTOR UNTIL ACCEPTANCE OF THIS PROJECT. EROSION CONTROL MEASURES AS SHOWN SHALL BET FEMILIMAN PRECALTIONS THAT WILL BEALLOWS.) THE CONTRACTOR SHALL BE RESPONSIBLE FOR RECORDING AD CORRECTING ALL EROSION CONTROL PROGLEMS THAT ARE THE RESULT OF CONSTRUCTION ACTIVITIES. ADDITIONAL EROSION CONTROL MEASURES, AS REQUESTED IN MET TIME SY THE STATE OF LOCAL INSPECTORS, OR THE DEVELOPER'S RENINEER, SHALLE BE INSTALLED WITHIN 24
- ALL EROSION CONTRO. MEASURES AND STRUCTURES SERVING THE SITE MUST BE INSPECTED AT LEAST WEEKLY OR WITHIN 24 HOURS OF THE TIME 0.5 INCHES OF RAIN S PRODUCED, ALL MAINTENANCE WILL FOLLOW AN INSPECTION WITHIN 24 HOURS. INSPECTION SCHEDULE AND RECO TIME 0.5 INCHES OF RAIN'S PRODUCED, ALL MAINTENANCE WILL POLLOW AN INSPECTION WITHIN 24 HOURS, INSP KEEPING SHALL COMPLY WITH NR 216.46(9), WIS, ADM, CODE AND CITY OF MADISON FEPORTING REQUIREMENTS.
- CONSTRUCTION ENTRANCES PROVIDE A STONE TRACKING PAD AT EACH POINT OF ACCESS. INSTALL ACCORDING TO WORK STANDARD 1057. REFER TO WIDNES STORMWATER WEB PAGE OF TECHNICAL STANDARDS AT HTHF/IDNER, W. GOVITO-PICSTORMWATER/STANDARDS/CONST, STANDARDS, HTML. THE TRACKING PAD MUST BE MAINTAINED IN A CONDITION THAT PREVENTS THE TRACKING OF MATERIAL ONTO THE PUBLIC STREET.
- TEMPORARY STABILIZATION JSING ARIONIC POLYMER. AFTER NOVEMBER 1, 2020. ANONIC POLYACRYLAMDE WILL BE APPLIED TO ALL DISTURBED AREAS WHERE THE MUNICIPALITY'S EXCHAERE OR WORN REPRESENTATIVES DEED STABILIZATION AND/OR EROSIGN TO 3E PROBLEMATIC. APPLICATION 3F PROFULY CANONIC MEMORY TO AND THE APPLICATION STAD CANONIC PROSIDE ON THE APPLICATION APPLICATION OF AND/OR CANONIC FEFER TO WORNS STORMWATER WEB PAGE OF TEX-INICAL STANDARDS AT: HTH TEXTIONE WE GOVERNOUS OF STANDARD SECONDS STANDARD SECONDS STANDARD SECONDS STANDARDS AT:
- SOIL STOCKPILES A ROW OF SILT FENCE PLACED DOWNSLOPE AND AT LEAST 10 FEET AWAY FROM THE STOCKPILE SHALL PROTECT ALL STOCKPILES BOL STOCKPILES THAT ARE INACTIVE FOR MORE THAN 14 CONSECUTIVE DAYS SHALL BE STABILIZED WITH SEED & MULCH, EROSION MAT, POLYMER, OR COVERED WITH TARPS OR SIMILAR MATERIAL. NO STOCKPILE SHALL BE PLACED WITHN 20 FEET OF A DRAINAGE WAY.
- DEMATERYS. MATER PURIED FROM THE SITE SHALL SETENCINED BY USING A TEMPORARY SEDIMENTATION BROW, POSTREAD EDEMATERING BROWN DEFECTIVE BROWN DEFECTIVE DOCATIONS OF DEMATERING ACTIVITY. AND PROVIDE AN ENGINEERING DETAIL OF THE CENVATERING SYSTEM, DEVISES SHALL COMPLY WITH WORN TECHNICAL STANDARD ING FOUNDE AT HATTER PROVIDED AND STANDARD THE PURIED STANDARD THE THAT DOES AT THE PURIED AND STANDARD THE PURIED STANDARD THE PURI NOT NDUCE EROSION OF THE SITE OR ADJACENT PROPERTY. PUMP SIZE (MAX GPN) TYPE I BAG SIZE (SQ-FT)

- STORM SEWER (INLETS FROVIDE WOOT TYPE D "CATCHALL" INLET PROTECTION OR EQUIVALENT, REFER "O WOOT PRODUCT ACCEPTABILITY LIST AT: HTTP://WWW.OOT WISCONDIN, GOVERNINESSIENGRSERVPAL.HTM. INLET PROTECTION SHALL BE INSTALLED PRIOR TO THE STORM SEWER SYSTEM RECEIVING SI'E RUNOFF. OTHER THAM FOR PERFORMING MANTENANCE. THESE DEMCES SHALLAND TE BERMOUNT. SITE STABILIZATION IS COMPLETE.
- BUILDING AND WASTE MATERIALS SHALL BE PREVENTED FROM RUNNING-OFF THE SITE AND EXTERING WATERS OF THE STATE IN CONFORMANCE
- NO SOLID MATERIAL SHALL BE DISCHARGED OR DEPOSITED INTO WATERS OF THE STATE IN VIOLATION OF CH. 30 CR 31 OF THE WISCONSIN STATE STATUTES OR 33 USC "344 PERMITS.
- EROSION CONTROL DEVICES SHALL ADHERE TO THE TECHNICAL STANDARDS FOUND AT HTTF://DNR.W. GOV/RUNGESTORMWATER/TECHSTDS.HTM AND COMPLY WITH ALL CITY OF MADISON ORGINANCES.
- 12. ALL DEBRIS TRACKED ONTO PUBLIC STREETS SHALL BE SWEPT OR SCRAPED CLEAN 3Y THE END OF EACH WORKDAY
- 13. ALL BUILDING AND WASTE MATERIAL SHALL BE HANDLED PROPERLY TO PREVENT RUNOFF OF THESE MATERIALS OFF OF THE SITE.
- ALL DISTURBED AREAS, EXCEPT PAVED AREAS, SHALL RECEIVE A MINMUM OF FOUR (4) INCHES OF TOPSOIL, FERT LIZER, SEED, AND MULCH, SEED MAXT JRES SHALL BE SILLCTIED APPROPRIATE TO THE INTERMED FUNCTION AS JULILIED LANDSCAPING CONTRACTOR, LANDSCAPE ARCHITECT MAXTHES SHALL BE FROYINGED BY THE SEED SHAPE LIZER CAN BE APPLIED TO THE PROMOTE OF SOWNHE BUT AS A STATE AS EED FOR RECOMMENDED TO DETERMINE THE TYPE ARC AMOUNT OF FERTILIZER TO BE APPLIED ALL SEEDING AND RESTORATION SHALL BE IN COMPONING TO WIGHT STORAGE ASTRONANCES. STANDARD SHAPE LIZER AND ADDRESS TORATION SHALL BE IN COMPONING TO WIGHT STORAGE ASTRONANCES. STANDARD SHAPE LIZER AND ADDRESS TORATION SHALL BE IN SECOND AND ASSESS TO ADDRESS TORATION. STANDARD SHAPE LIZER AND ADDRESS TORATION SHAPE AS A STANDARD SHAPE AS A STAND
- FOR THE FRST SIX (6) WEEKS AFTER THE INITIAL STABILIZATION OF A DISTURBED AREA, WATERING SHALL BE PERFORMED WHENEVER WORE THAN SEVEN (7) DAYS OF DRY WEATHER ELAPSE.

EMERGENCY CONTACT

BRANDON COOK JOHN FONTAIN REALTY P O BOX 594 MADISON, WI 53701 608-807-8982

SCHEDULE:

MAY 1, 2021 SILT FENCE AND CONSTRUCTION ENTRANCE INSTALLED.

MAY 2, 2021 EXISTING BUILDING DEMOLITON START.

BUILDING EXCAVATION COMPLETE. MAY 30, 2021

AUGUST 30, 2021 INSTALL MULCH ON DISTURBED AREAS OUTSIDE OF BUILDING FOOTPRINT.

SEPTEMBER 20, 2021 BUILDING COMPLETE.

SEPTEMBER 28, 2021 PLACE ASPHAIT.

LEGEND							
	ACCESSIBLE ROUTE						
	EXISTING EASEMENT	ı			_		
	PROPERTY BOUNDARY	I.	_	2	P	L	m
⟨#⟩	PARKING STALL COUNT	ı	٠		Survey	ng a	nd Engk
LS.	LANDSCAPED AREA	ı	28	801 lr	iterna	tions	ıl Lane,
BIT.	BITUMINOUS PAVEMENT	ı		P	hone: 6	608	NI 5370 -250-9
CONC.	CONCRETE PAVEMENT	ı		e-ma	alt Mbs	irse	50-92 8BSE-1
1041.02	SPOT GRADE	ı		NV	w.burs	CSII	reyeng
≠ FG	FINISH GRADE	ı					_
sw	SIDEWALK	ı		•	_		
EP	EDGE OF PAVEMENT	ı					
FL.	FLOW LINE	L	-	_		_	
LP	LOW POINT	I	PPROVALS	i and	M. B	E E	DRH See
GB	GRADE BREAK	I	l a	MOJECT SHE	1	KIWEE	400
HP	HIGH POINT	K		14	90	å	10
TC	TOP OF CURB	I					
TW	TOP OF WALL	I					
BW	BOTTOM OF WALL	I					
BOW	BACK OF WALK	I					
FOW	FRONT OF WALK	I					
EXP	EXPOSURE	I					
SAN	PROPOSED SANITARY SEWER	I					
sr	PROPOSED STORM SEWER	I	1	₹			
»	PROPOSED DRAIN TILE	I	L	ĸ.			>
— w —	PROPOSED WATER LATERAL	ı	1	≝.	eet		품
~~~~	UTILITY LINE DEMOLITION	ı	ľĊ	ก	tt :	8	ě
)×(	TREE REMOVAL	I	١,	Ė	817/821 Williamson Stree	Madison, WI 53703	John Fontain Realty
	EXISTING MINOR CONTOUR	I	1	5	E :	₹	₩.
1040	EXISTING MAJOR CONTOUR	I	0	ñ	₿	5	Ħ
1041	PROPOSED MINOR CONTOUR	I	18	=	2:	ŝ	Е
1040	PROPOSED MAJOR CONTOUR	I	ŀ	₹.	1,82	≊∣	Ξ
	PROPOSED RIDGE LINE	I	lΞ	Ξ	8		₽
	PROPOSED SWALE/DITCH	I	۱	5			_
	ACCESSIBLE PARKING SIGN	ı	>	>			
$\triangle$	VISION TRIANGLE (NO VISUAL OBSTRUCTIONS BETWEEN HEIGHTS OF 30" AND 10")						
<i>59</i>	RIPRAP	I					

83

SHEET LIST TABLE			
SHEET NUMBER	SHEET TITLE		
C001	CIVIL DETAILS		
C100	EXISTING CONDITIONS		
C300	EROSION CONTROL		
C400	CIVIL SITE PLAN		
C500	GRADING PLAN		
C600	UTILITY PLAN		

CONSTRUCTION ENTRANCE

SILT FENCE

CHECK DAM

INLET PROTECTION

USLE FLOW PATH


SAW CUT / REMOVAL LIMITS DISTURBANCE LIMITS




REVISION DATES SSUE DATES: CIVIL DETAILS

neering, Inc.

DRAWING NUMBER C001

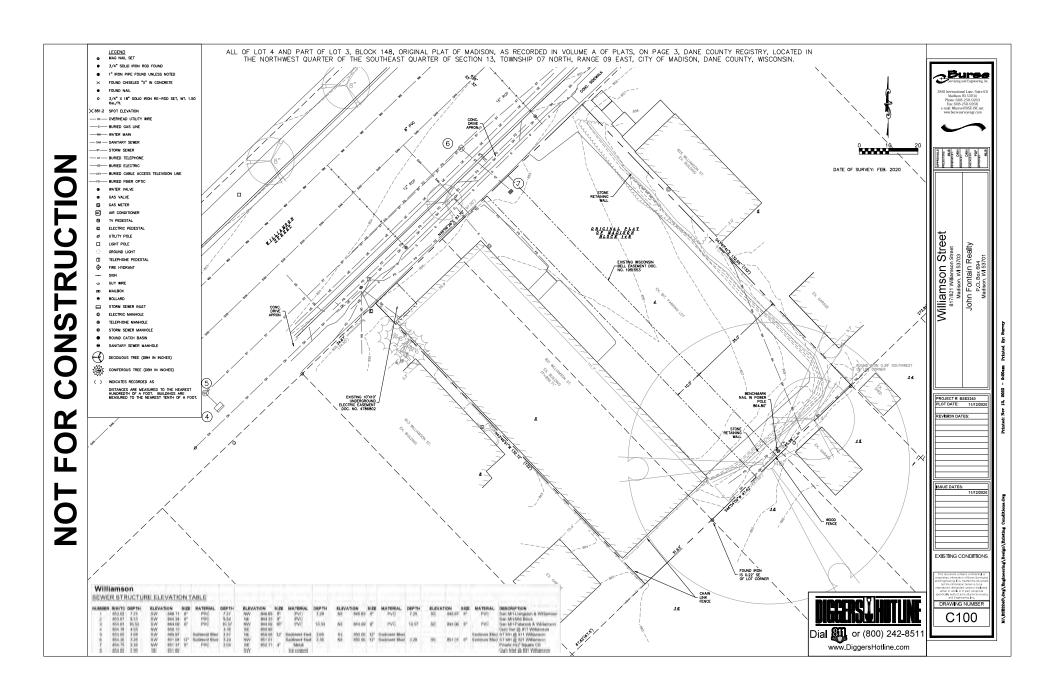

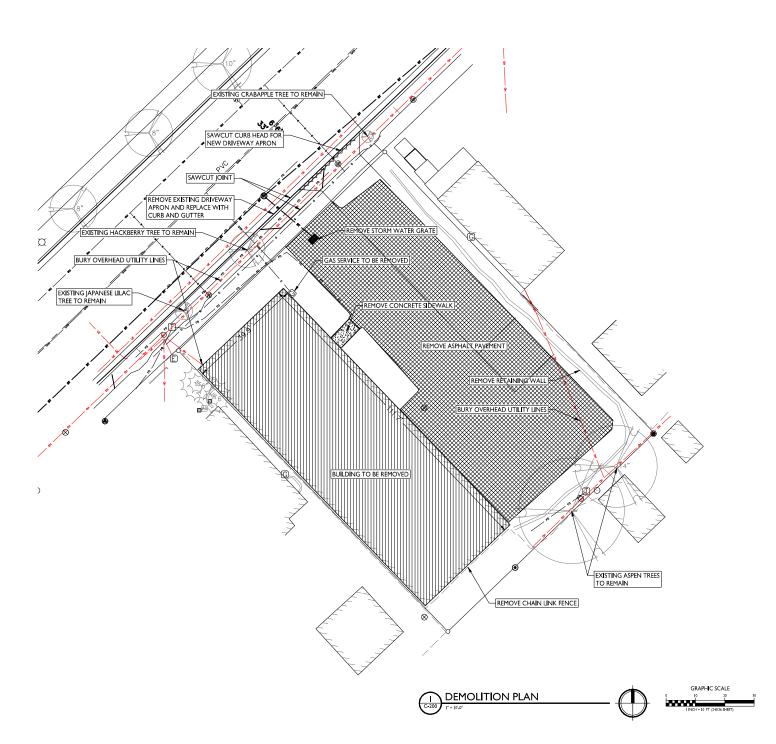



DEMOLITION PLAN LEGEND

CURB & GUTTER REMOVAL

CONCRETE REMOVAL

BUILDING REMOVAL

----- SAWCUT

■ UTILITY STRUCTURE REMOVAL
 ■ UTILITY LINE REMOVAL

TREE REMOVAL

SSUED

ksued for Land Use Submittal - May 6, 2020 ksued for Land Use Submittal - November 16, 2020

John Fontain
Development

817-821 Williamson St Madison, Wisconsin SHEET TITLE Demolition Plan




THE LOCATION OF PUSTING UTILITES, BOTH UNDERGORUDO AND OVERHEAD ARE APPROXIMATE ONLY ADDIVING NOT BEEN INDEPRODUCTIVE.


FOR CONTRACTORISM, DEPRODUCTIVE OF THE PUSTING OF T


SHEET NUMBER


C- 200


ROJECT NO. 2003

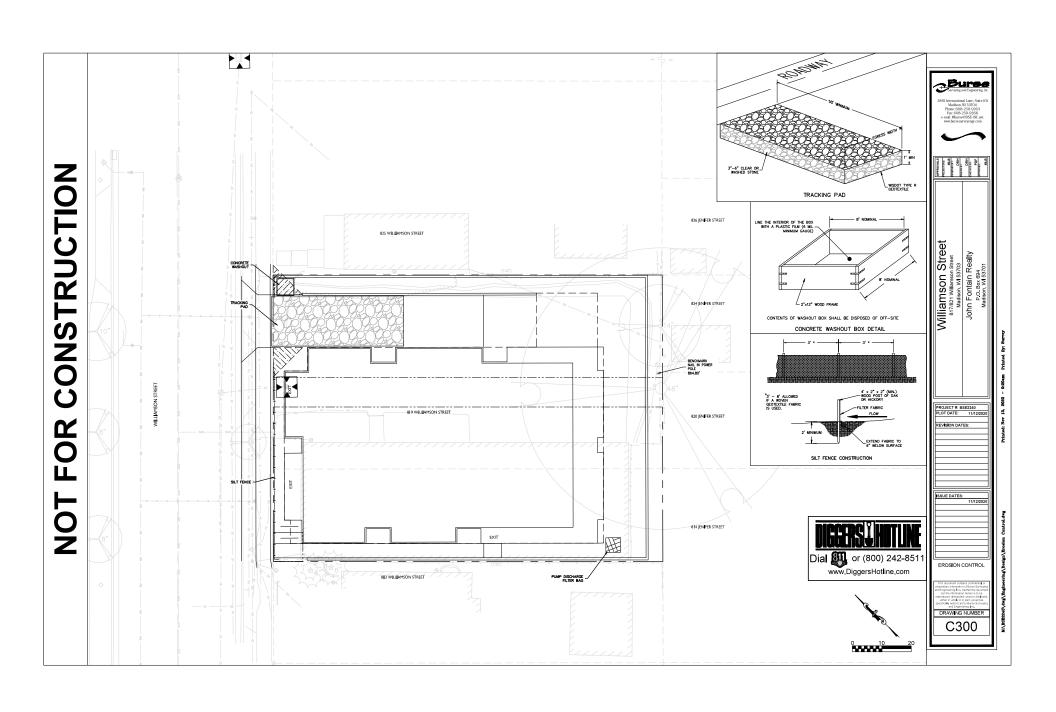

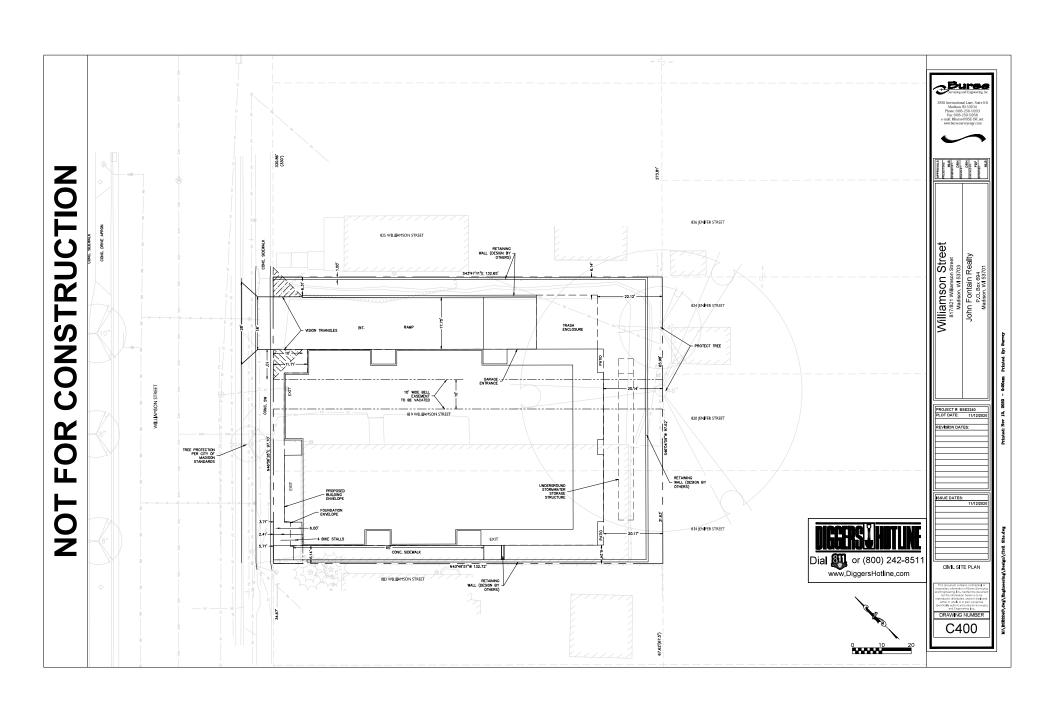

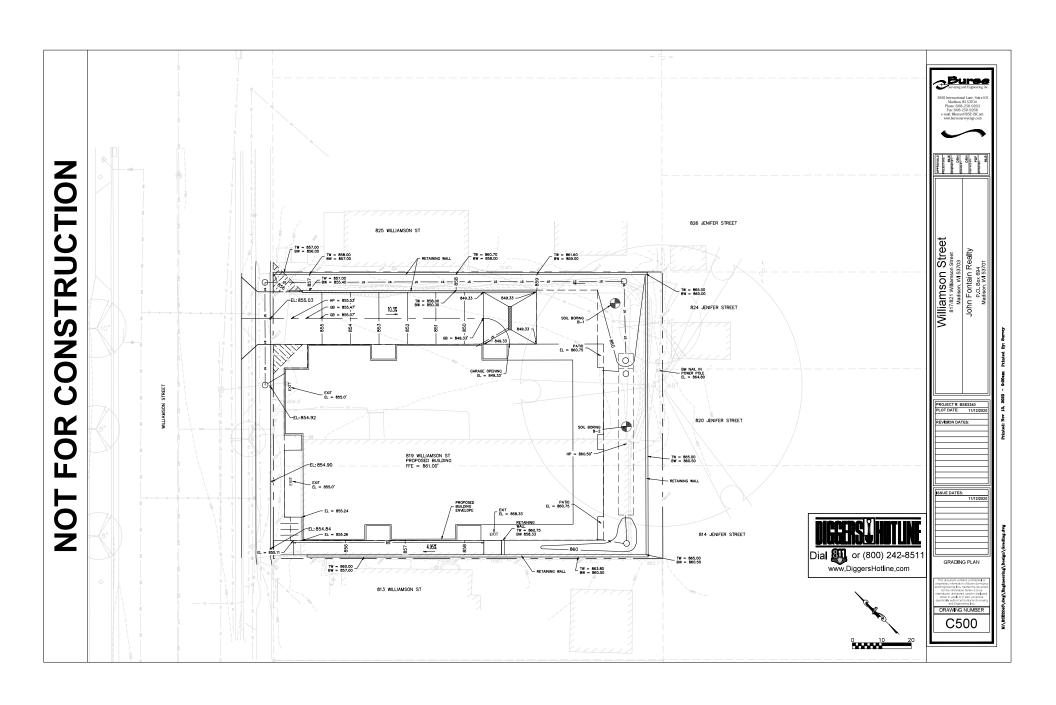

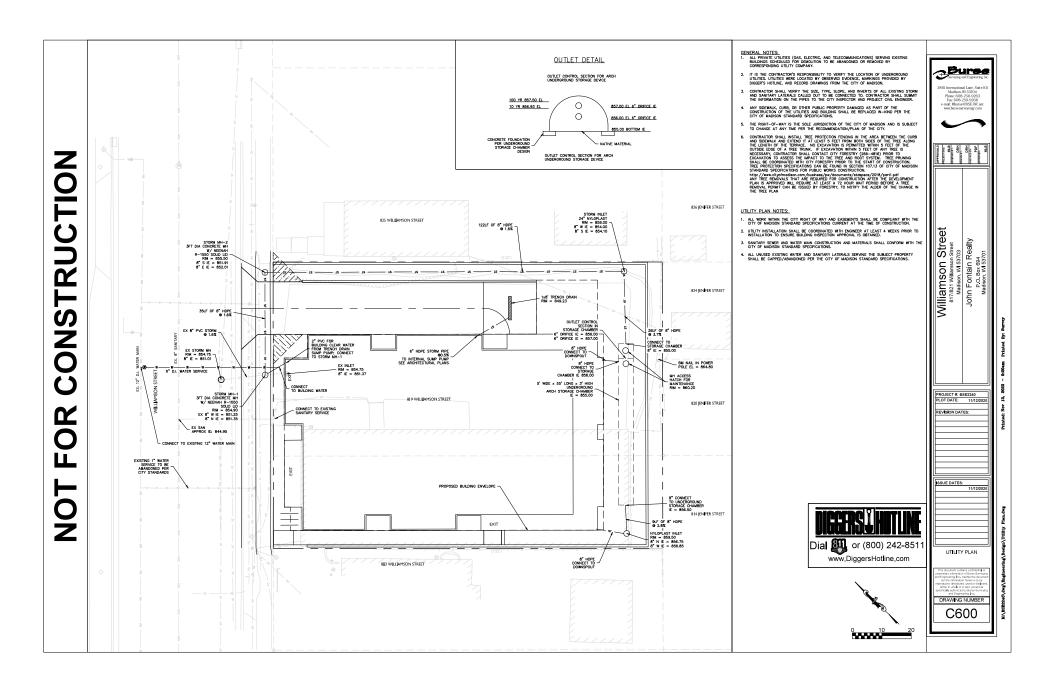

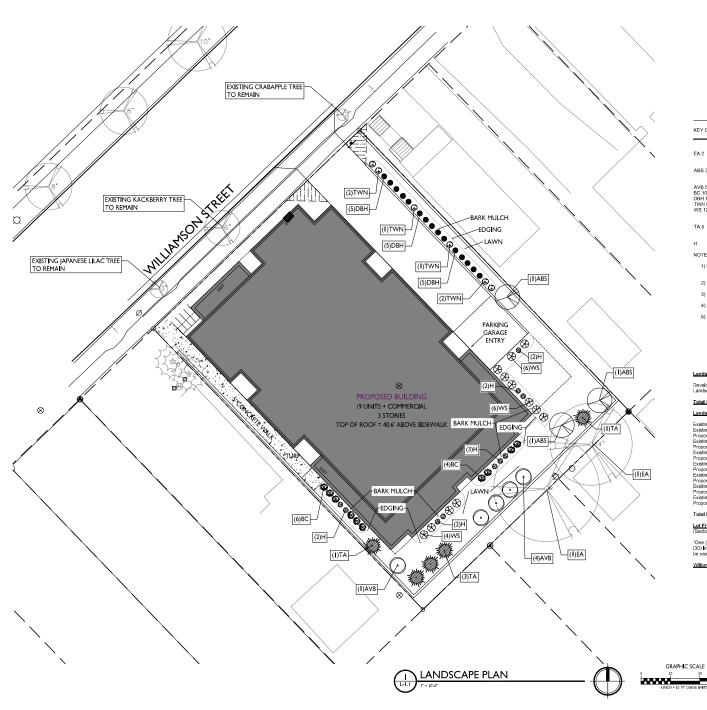

#### PLANT LIST

ILI QUAIT	SIZE COMMON NAME	ROOT
(2) EA 2	Canopy Trees 12" + Existing Aspen	EX
ABS 3	2" Autumn Brilliance Serviceberry	ВВ
(48) AVB 5	Deciduous Shrubs 34" Arrowood Viburnum	BB
BC 10	24" Black Chokeberry	Pot
DBH 15	18" Dwarf Bush Honevsuckle	Pot
TWN 6	24 Tiny Wine Ninebark	Pot
WS 12	24" White Snowberry	Pot
(5) TA 5	Upright evergreen Shrubs 5' Emerald Arborvitae	ВВ
(32) H 32	Perennials 1 G Hosta	BB

- 1) New lawn areas and existing from areas disturted by construction shall receive a minimum of 4" of topset seed (Medison Perks mix), starter fortilizer, and mulch (starter or starw ma).

  2) New fur areas shall receive a minimum of 4" of topset, seed (no mow turf mix), starter fertilizer, and mulch (starw or starw ma).

  3) Designated planting beds to be mulched with #2 streed ded harwood back spread to a depth of 3".

  4) Individual trees and shrung groupings in twen areas to receive shreedded harwood mulch planting beds to be separated from flawn areas with 3" tlack viryledging.

#### LANDSCAPE WORKSHEET

#### Landscape Points Required

Developed Area = Landscape Points: 9,015/300 x 5 =	9,015 SF 150 points
Total Landscape Points Required	150 points
Landscape Points Supplied	
Existing canopy trees – 2 @ 35 = Existing specime canopy trees – 0 @ 200 = Proposed canopy trees – 0 @ 35 = Proposed canopy trees – 0 @ 35 = Proposed evergreen trees – 0 @ 35 = Proposed evergreen trees – 0 @ 35 = Proposed evergreen trees – 0 @ 15 = Existing ourserfast frees – 0 @ 15 = Proposed ornamental trees – 0 @ 10 = Proposed durgit evergreen and/se – 5 @ 10 = Proposed durgit evergreen and/se – 5 @ 10 = Existing ourserfast evergreen and/se – 5 @ 10 = Existing overgreen shrubs – 0 @ 4 = Proposed dependence of @ 4 = Proposed dependence shrubs – 0 @ 4 = Propo	70 points 0 points 0 points 0 points 0 points 0 points 0 points 45 points 45 points 50 points 50 points 14 points 144 points 0 points 10 points 10 points
Existing perennials & grasses 0 @ 2 = Proposed perennials & grasses 32 @ 2 = Total landscape points supplied =	0 points 64 points 387 points

#### Lot Frontage Landscape Required (Section 28.142(5) Development Frontage Landscaping)

"One (1) over-story deciduous tree and five (5) shrubs shall be planted for each thirty (30) lineal feet of lot frontage. Two (2) omamental trees or two (2) evergreen trees may be used in place of one (1) over-story deciduous tree."

(Not Applicable - Zero lot line - no planting areas along lot frontage.)



Issued for Land Use Submittal - May 6, 2020 Issued for Land Use Submittal - November 16, 2020



John Fontain Development


817-821 Williamson St Madison, Wisconsin SHEET TITLE

Landscape Plan

SHEET NUMBER



2003

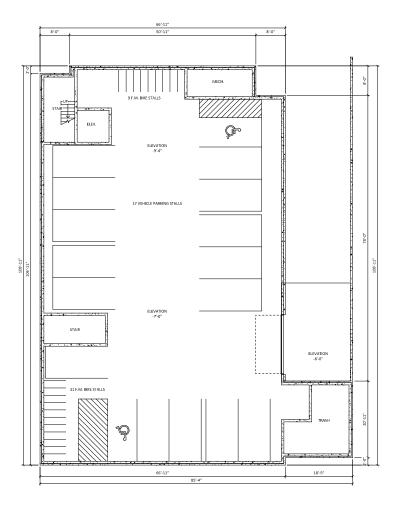

BASEMENT FLOOR PLAN

Anothebrece.com 608.836.3410 7881 Helsensity Bas. + Baite 701 + Middletse VI 53587 KEY PLAN

ISSUED Issued for Landmarks - August 04, 2020 Issued for Land Use - November 16, 2020


PROJECT TITLE

John Fontain Development

817-821 Williamson Street, Madison Wisconsin

SHEET TITLE BASEMENT FLOOR PLAN

SHEET NUMBER

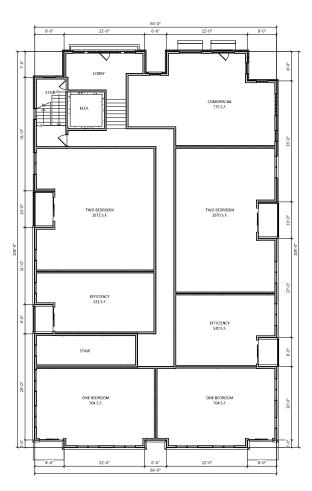

FIRST FLOOR PLAN



ISSUED Issued for Landmarks - August 04, 2020 Issued for Land Use - November 16, 2020


PROJECT TITLE

John Fontain Development

817-821 Williamson Street, Madison Wisconsin

SHEET TITLE
FIRST FLOOR PLAN

SHEET NUMBER

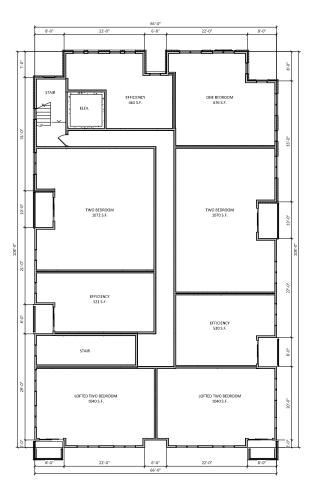

SECOND FLOOR PLAN



ISSUED Issued for Landmarks - August 04, 2020 Issued for Land Use - November 16, 2020


PROJECT TITLE

John Fontain Development

817-821 Williamson Street, Madison Wisconsin

SHEET TITLE SECOND FLOOR PLAN

SHEET NUMBER

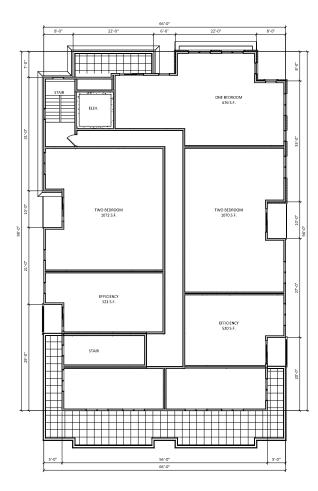

THIRD FLOOR PLAN



ISSUED Issued for Landmarks - August 04, 2020 Issued for Land Use - November 16, 2020


PROJECT TITLE

John Fontain Development

817-821 Williamson Street, Madison Wisconsin

SHEET TITLE
THIRD FLOOR PLAN

SHEET NUMBER

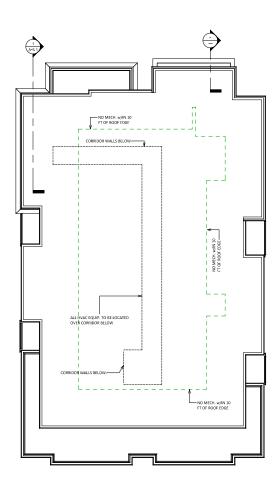





ISSUED Issued for Landmarks - August 04, 2020 Issued for Land Use - November 16, 2020

PROJECT TITLE

John Fontain Development

817-821 Williamson Street, Madison Wisconsin

SHEET TITLE ROOF PLAN

SHEET NUMBER



NorthEast 1/8" = 1'-0"





ISSUED Issued for Landmarks - August 04, 202

John Fontain
Development

817-821 Williamson Street, Madison Wisconsin

SHEET TITLE
EXTERIOR
ELEVATIONS

SHEET NUMBER







ISSUED Issued for Landmarks

Issued for Landmarks - August 04, 2020

PROJECT TITLE

John Fontain Development

817-821 Williamson Street, Madison Wisconsin

SHEET TITLE
EXTERIOR
ELEVATIONS

SHEET NUMBER



## NorthEast COLORED 1/8" = 1'-0"





ISSUED Issued for Landmarks - August 04, 2020

John Fontain Development

817-821 Williamson Street, Madison Wisconsin SHEET TITLE EXTERIOR

EXTERIOR ELEVATIONS -COLORED

SHEET NUMBER





SouthWest COLORED



ISSUED Issued for Landmarks - August 04, 2021

John Fontain
Development

817-821 Williamson Street, Madison Wisconsin SHEET TITLE EXTERIOR

EXTERIOR ELEVATIONS -COLORED

SHEET NUMBER

A-2.4











