URBAN DESIGN COMMISSION APPLICATION



City of Madison Planning Division Madison Municipal Building, Suite 017 215 Marianas P.O. Box 2985 Madison, WI 53701-2985



Paid	Receipt #	
Date received		
Received by		
Aldermanic District		
Zoning District		-
Urban Design District		
Submittal reviewed by	8.23.22 10:49 a.m.	received
Legistar #		

FOR OFFICE USE ONLY:

	(608) 266-4635	-2985		ed by							
		odd a sa'r ddaddol am Chillean a channa a chann a chan	Alderm	nanic District							
	Complete all section	ns of this application, including	Zoning District								
	•	g date and the action requested.	Urban Design District								
	formats or other accon	ter, translator, materials in alternate nmodations to access these forms, umber above immediately.		tal reviewed by							
1.	Project Informatio	n									
	Address: 4205 Por	tage Rd									
	Title: The Winston										
			· · ·			***************************************					
2.		check all that apply) and Requested D	ate								
	UDC meeting date r	equested October 12									
	New developm		· · _	, , ,	elopment						
	☐ Informational	☐ Initial approval	Ø	Final approval							
3.	Project Type										
	☐ Project in an Ur	ban Design District	Sigr	nage							
	•	owntown Core District (DC), Urban	, 🗆	Comprehensive Des	ign Review (CDR)						
		ct (UMX), or Mixed-Use Center District (MXC Iburban Employment Center District (SEC)	· 📙	Signage Variance (i.e	e. modification of	signage height,					
		ional District (CI), or Employment Campu	5	area, and setback)							
	District (EC)	45-3	☐ Signage Exception								
	☐ Planned Develo ☐ General De	pment (PD) evelopment Plan (GDP)	Oth	er							
		plementation Plan (SIP)		Please specify							
		Jse Site or Residential Building Complex									
4.	Applicant, Agent, a	and Property Owner Information									
••	Applicant name	Nick Patterson	Con	npany T. Wall Ente	rprises Developme	ent, LLC					
	Street address	1818 Parmenter Street, Ste. 400		/State/Zip Middlet							
	Telephone	608-220-8940		ail nick@twallenter							
	Project contact per	son Nick Patterson	 Con	npany T. Wall Ente	rprises Developme	ent, LLC					
	Street address	1818 Parmenter Street, Ste. 400		/State/Zip Middlet							
	Telephone	608-220-8940		nick@twallenter		***************************************					
		not applicant) Winston at Churchill, L				**************************************					
	Street address	1818 Parmenter Street, Ste. 400		/State/Zip Middlet	on, WI 53562						
	Telephone	608-826-4000		ail terrence@twaller	nterprises.com						
	-										

Each submittal must include

fourteen (14) 11" x 17" collated

paper copies. Landscape and

Lighting plans (if required)

must be full-sized and legible.

Please refrain from using

plastic covers or spiral binding.

5.	Rea	uired	Submittal	Materials
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- **Application Form**
- Letter of Intent
 - If the project is within an Urban Design District, a summary of how the development proposal addresses the district criteria is required
 - For signage applications, a summary of how the proposed signage is consistent with the applicable CDR or Signage Variance review criteria is required.
- V Development Plans (Refer to checklist on Page 4 for plan details)
- Filing fee
- 74 **Electronic Submittal***
- V Notification to the District Alder
 - Please provide an email to the District Alder notifying them that you are filing this UDC application. Please send this as early in the process as possible and provide a copy of that email with the submitted application.

Both the paper copies and electronic copies must be submitted prior to the application deadline before an application will be scheduled for a UDC meeting. Late materials will not be accepted. A completed application form is required for each UDC appearance.

For projects also requiring Plan Commission approval, applicants must also have submitted an accepted application for Plan Commission consideration prior to obtaining any formal action (initial or final approval) from the UDC. All plans must be legible when reduced.

*Electronic copies of all items submitted in hard copy are required. Individual PDF files of each item submitted should be compiled on a CD or flash drive, or submitted via email to udcapplications@cityofmadison.com. The email must include the project address, project name, and applicant name. Electronic submittals via file hosting services (such as Dropbox.com) are not allowed. Applicants who are unable to provide the materials electronically should contact the Planning Division at (608) 266-4635 for assistance.

6. Applicant Declarations

- Prior to submitting this application, the applicant is required to discuss the proposed project with Urban Design Commission staff. This application was discussed with Jessica Vaughn, Jenny Kirchgatter, Kevin Firchow June 2, 2022
- The applicant attests that all required materials are included in this submittal and understands that if any required information is not provided by the application deadline, the application will not be placed on an Urban Design Commission agenda for consideration.

Name of applicant Nick Patterson Relationship to property Owner's Representative Winston at Chur Authorizing signature of property owner By: Terrence R. Wall, President of T. Manager, LLC Its Manager

7. Application Filing Fees

Fees are required to be paid with the first application for either initial or final approval of a project, unless the project is part of the combined application process involving the Urban Design Commission in conjunction with Plan Commission and/or Common Council consideration. Make checks payable to City Treasurer. Credit cards may be used for application fees of less than \$1,000.

Please consult the schedule below for the appropriate fee for your request:

Urban Design Districts: \$350 (per §35.24(6) MGO).
Minor Alteration in the Downtown Core District (DC) or Urban Mixed-Use District (UMX): \$150 (per §33.24(6)(b) MGO)
Comprehensive Design Review: \$500 (per §31.041(3)(d)(1)(a) MGO)
Minor Alteration to a Comprehensive Sign Plan: \$100 (per §31.041(3)(d)(1)(c) MGO)
All other sign requests to the Urban Design Commission, including, but not limited to: appeals

- A filing fee is not required for the following project applications if part of the combined application process involving both Urban Design Commission and Plan Commission:
- Project in the Downtown Core District (DC), Urban Mixed-Use District (UMX), or Mixed-Use Center District (MXC)
- Project in the Suburban Employment Center District (SEC), Campus Institutional District (CI), or Employment Campus District (EC)
- Planned Development (PD): General Development Plan (GDP) and/or Specific Implementation Plan (SIP)
 - Planned Multi-Use Site or Residential Building Complex

from the decisions of the Zoning Administrator,

requests for signage variances (i.e. modifications of signage height, area, and setback), and additional sign

code approvals: \$300 (per §31.041(3)(d)(2) MGO)

URBAN DESIGN COMMISSION APPROVAL PROCESS



Introduction

The City of Madison's Urban Design Commission (UDC) has been created to:

- Encourage and promote high quality in the design of new buildings, developments, remodeling, and additions so as to maintain and improve the established standards of property values within the City.
- Foster civic pride in the beauty and nobler assets of the City, and in all other ways possible assure a functionally efficient
 and visually attractive City in the future.

Types of Approvals

There are three types of requests considered by the UDC:

- <u>Informational Presentation</u>. Applicants may, at their discretion, request to make an Informational Presentation to the
 UDC prior to seeking any approvals to obtain early feedback and direction before undertaking detailed design. Applicants
 should provide details on the context of the site, design concept, site and building plans, and other relevant information
 to help the UDC understand the proposal and provide feedback. (Does not apply to CDR's or Signage Variance requests)
- <u>Initial Approval</u>. Applicants may, at their discretion, request initial approval of a proposal by presenting preliminary design information. As part of their review, the Commission will provide feedback on the design information that should be addressed at Final Approval stage.
- <u>Final Approval</u>. Applicants may request Final Approval of a proposal by presenting all final project details. Recommendations
 or concerns expressed by the UDC in the initial approval must be addressed at this time.

Presentations to the Commission

Primarily, the UDC is interested in the appearance and design quality of projects. Emphasis should be given to the site plan, landscape plan, lighting plan, building elevations, exterior building materials, color scheme, and graphics.

When presenting projects to the UDC, applicants must fill out a registration slip provided in the meeting room and present it to the Secretary. Presentations should generally be limited to 5 minutes or as extended by motion by consent of the Commission. The Commission will withhold questions until the end of the presentation.

Applicants are encouraged to consider the use of various graphic presentation material including a locator map, photographs, renderings/model, scale drawings of the proposal in context with adjacent buildings/uses/signs, etc., as may be deemed appropriate to describe the project and its surroundings. Graphics should be mounted on rigid boards so that they may be easily displayed. Applicants/presenters are responsible for all presentation materials, AV equipment and easels.

URBAN DESIGN DEVELOPMENT PLANS CHECKLIST



The items listed below are minimal application requirements for the type of approval indicated. Please note that the UDC and/or staff may require additional information in order to have a complete understanding of the project.

1. Informational Presentation

Locator Map
Letter of Intent (If the project is within an Urban Design District, a summary of how the development proposal addresses the district criteria is required)
Contextual site information, including photographs and layout of adjacent buildings/structures
Site Plan
Two-dimensional (2D) images of proposed buildings or structures.

Providing additional information beyond these minimums may generate a greater level of feedback from the Commission.

Requirements for All Plan Sheets

- 1. Title block
- 2. Sheet number
- 3. North arrow
- 4. Scale, both written and graphic
- 5. Date
- 6. Fully dimensioned plans, scaled at 1"= 40' or larger

** All plans must be legible, including the full-sized landscape and lighting plans (if required)

2. Initial Approval

- Letter of Intent (If the project is within a Urban Design District, a summary of <u>how</u> the development proposal addresses the district criteria is required)
- Contextual site information, including photographs and layout of adjacent buildings/ structures
- ☑ Site Plan showing location of existing and proposed buildings, walks, drives, bike lanes, bike parking, and existing trees over 18" diameter
- ▲ Landscape Plan and Plant List (must be legible)
- Building Elevations in both black & white and color for all building sides (include material callouts)
- PD text and Letter of Intent (if applicable)

Providing additional information beyond these minimums may generate a greater level of feedback from the Commission.

3. Final Approval

All the requirements of the Initial Approval (see above), plus:

- ☑ Grading Plan
- ☑ Proposed Signage (if applicable)
- Lighting Plan, including fixture cut sheets and photometrics plan (must be legible)
- Utility/HVAC equipment location and screening details (with a rooftop plan if roof-mounted)
- PD text and Letter of Intent (if applicable)
- Samples of the exterior building materials (presented at the UDC meeting)

4. Comprehensive Design Review (CDR) and Variance Requests (Signage applications only)

Locator Map
Letter of Intent (a summary of how the proposed signage is consistent with the CDR or Signage Variance criteria is required)
Contextual site information, including photographs of existing signage both on site and within proximity to the project site
Site Plan showing the location of existing signage and proposed signage, dimensioned signage setbacks, sidewalks, driveways, and right-of-ways
Proposed signage graphics (fully dimensioned, scaled drawings, including materials and colors, and night view)
Perspective renderings (emphasis on pedestrian/automobile scale viewsheds)
Illustration of the proposed signage that meets Ch. 31, MGO compared to what is being requested.
Graphic of the proposed signage as it relates to what the Ch. 31, MGO would permit



City of Madison Madison Municipal Building 215 Martin Luther King, Jr. Blvd. Madison, WI 53703

August 23, 2022

RE: The Winston – Conditional Use for a Multi-Family Development

Dear Commission and Committee Member:

Winston at Churchill, LLC ("The Winston") is pleased to present a proposal for a multi-family development located at 4205 Portage Road, in East Madison. The Winston is hereby requesting a conditional-use permit to develop a multi-family community at a time when the City of Madison is desperately short of housing.

The Winston is proposing the following for the neighborhood and the city:

- Additional Housing: This development will provide 484 units. This proposal is the
 missing middle-income housing; it is not low income, but it is not high income
 either. This development will contain units that are of high quality with a variety of
 unit types. Plenty of studios for individuals on a budget, but also one's, two's, and
 three-bedroom units for people who need more space.
- 2. **Tax Base**: The property, which was formerly located in the Town of Burke, is now serviced by the City of Madison. The property is currently not an income producing property for the City of Madison but when developed will provide an additional \$50 million in additional tax base. Which equates to more than \$1 million in taxes per year that go to the City and school district.
- 3. Revitalize East Madison: The Winston will create a diverse community which will bring in individuals that will help to build up East Madison. Individuals that will bolster the local workforce of American Center, UW Health, East Towne Mall, and the East Washington corridor. In turn, The Winston will bring millions of dollars of discretionary income to support local businesses that have been struggling from the aftermath of Covid.
- 4. **Thoughtful Design**: An incredible amount of thought and design has been placed to ensure the development is respectful to the scale and character of a traditional urban district. The earth tone color palette, traditional and



contemporary materials, and arrangement defines the scale and aesthetic that is complementary to the overall context and urban district design approach. The development received great feedback from Urban Design Committee in an informational meeting. The development has addressed that feedback with a more simplified façade, reduced material variations, and reduced the size of timbers and brackets at the corner elements. Natural stone, wood, fiber cement siding, and architectural metal panels will contribute to the overall quality of construction and design. The overall master plan focuses on creating an inner courtyard with greenspace and screened parking. This design approach creates a street friendly presence and additional screening of parking areas.

5. **Signage**: Each building is proposed with mounted vertical and/or horizontal signage. The signage will be a complimentary material to the building façade and materials. A monument sign is shown on the corner of Portage Road and Diloreto Avenue and another monument sign on the corner of Portage Road and West Creekwood Lane.

Development Overview

Building	STUDIO	1 BD /	2 BD / 2	3 BD / 2	Total	Total
Name		1 BATH	BATH	BATH	Units	Parking
Building A	40	49	25	4	118	94
Building B	32	39	28	3	106	96
Building C	35	32	12	8	93	113
Building D	31	32	19	1	87	119
Building E	35	36	20	3	83	143
Total	173	188	104	19	484	565



Project Team

Owner/Developer:

Interstate Overlook, LLC 1818 Parmenter St., Ste 400 Middleton, WI 53562

Civil Engineer:

Vierbicher Associates 999 Fourier Dr, Ste 201 Madison, WI 53717

Landscape Architect:

Bruce Company 2830 Parmenter St. Middleton, WI 53562 Architect:

JLA Architects 800 W Broadway, Ste 200 Monona, WI 53713

Geotechnical Engineer:

CGC, Inc 2921 Perry St Madison, WI 53713

This is a very exciting undertaking and is a step in the right direction to close the housing gap in the City of Madison. The Winston is a major investment in the community that will provide benefits to East Madison and the greater community.

Thank you for your consideration.

Sincerely,

Nick Patterson Project Manager

T. Wall Enterprises Development, LLC












THE WINSTON

MADISON, WI



CONDITIONAL USE SUBMITTAL

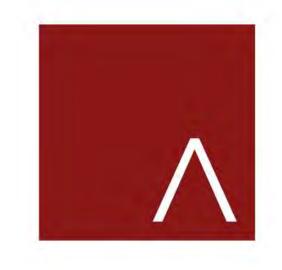



SEPTEMBER 7, 2022

JLA PROJECT NUMBER:

19-1104

WINSTON @ CHURCHILL

CONCEPTUAL BUILDING DATA

August 8, 2022

OVER	ALL SITE																																												
BI	ILDING NAME			(A) STUI	DIO				(B) 1 B	EDROOM				(C) 1	BEDROO	M +			(D) 2 BEDRO	ОМ				(E) 2 BEDRC	OM +				(F) 3 BED	ROOM			\L MS		NET LEASABLE AREA		N C	SS .F.)	Cζ	NG F.)	ZED G	щo		
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>	SUB-TOTAL	72	0	0	0	0	0	79	9	0	0	0	9	0	0	0	0	10	7	15	5	7	9	0	0	0	0	0	7	0	0	0	220	287	179,385	0	179,385	36,535	215,920	83.1%	47,75	5 126	64	0.86 0.	.66
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STF	BLDG E	32	0	3	0	0	0	32	2	0	0	0	4	0	0	0	0	8	4	1	2	1	4	0	0	0	0	3	0	0	0	0	94	120	71,839	0	71,839	19,941	91,780	78.3%	⁷ 22,742	2 62	81	1.52 1	.19
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	PERCENT	34.5%	6 0.0%	1.2%	0.0%	0.0%	0.0%	34.	5% 0	0.0%	.0%	0.0%	4.3%	0.0%	0.0%	0.0%	0.0%	9.5%	2.3%	3.3%	1.4%	1.7%	3.3%	0.09	0.0%	0.0%	0.0%	2.59	% 1.4%	0.09	% 0.0%	0.0%											Į	PER UNIT PER BR	ķ
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WEST PARCEL
ALLOWABLE DENSITY
ALLOWABLE UNITS
DESIGN DENSITY

EAST PARCEL

3.18 Acres
70 Units Per Acre
469.18

ALLOWABLE DENSITY 40 Units Per Acre
ALLOWABLE UNITS 266
DESIGN DENSITY 39.70

BIKE PARKING DATA

Building	Total Bike Parking Stalls	Interior Bike Parking (Floor)	Interior Bike Parking (Hanging)	Exterior Bike Parking
Α	95	13	58	24
В	115	71	22	22
С	100	27	52	21
D	91	70	3	18
E	90	13	58	19

OPEN SPACE CALCULATION

	# of Units	Required Open Space* (sq ft)	Actual Open Space (sq ft)
Lot 1, Building A	118	18,880	21,205
Open Space		10,000	14,174
Roof Deck			1,160
Balconies & Patios**			5,871
Lot 2, Building B	102	16,320	22,919
Open Space		1,2	17,457
Roof Deck			1,160
Balconies & Patios**			4,302
Lot 3, Building C & Clubhouse	87	13,920	31,668
Open space			20,795
Balconies & Patios**			2,573
Pool Deck			7,100
Dog Run			1,200
Lot 4, Building D & E		28,320	23,076
Open Space			19,157
Building D	83	13,280	
Balconies & Patios**			2,755
Building E	94	15,040	
Roof Deck			1,160
Balconies & Patios**			4.028

* Required Open Space = # of Units X 160 sq/ft/unit

785 Average N.S.F. per unit

959 Average G.S.F per unit

(gross areas of above grade levels only)

SHEET DISCIPLINE AND NUMBER		SHEET DISCIPLINE AN
NOMBER		NOMBER

DEMOLITION PLAN

GRADING PLAN - BUILDING B

GRADING PLAN - BUILDING C

GRADING PLAN - BUILDING D &
CLUBHOUSE

GRADING PLAN - BUILDING E

OVERALL LANDSCAPE

WEST QUADRANT

NORTH QUADRANT
SOUTHEAST QUADRANT

PLANT PICTURES

ARCHITECTURAL SITE

ARCHITECTURAL - BLDG A

SCHEDULES AND NOTES

OVERALL LANDSCAPE COLOR

ELEVATION PLANTING KEY

ARCHITECTURAL SITE PLAN

BUILDING A - LL FLOOR PLAN

BUILDING A - 1ST FLOOR PLAN

BUILDING A - 2ND-4TH FLOOR PLAN

BUILDING A - 3RD FLOOR PLAN

BUILDING A - 5TH FLOOR PLAN

BUILDING A - ROOF PLAN

BUILDING A - EXTERIOR ELEVATIONS

BUILDING A - EXTERIOR ELEVATIONS

BUILDING A - EXTERIOR ELEVATIONS B&W BUILDING A - EXTERIOR ELEVATIONS

BUILDING SECTIONS

SITE DETAILS
SITE DETAILS
SITE DETAILS
SITE DETAILS
SITE DETAILS

	_	ARCHITECTURAL - BLDG B	
COVER		SD100-B	BUILDING B - LL FLOOR PLAN
BUILDING DATA MATRIX & INDEX		SD101-B	BUILDING B - 1ST FLOOR PLAN
		SD102-B	BUILDING B - 2ND-3RD FLOOR PLAN
	_	SD103-B	BUILDING B - 4TH FIRST FLOOR PLAN
TITLE SHEET		SD104-B	BUILDING B - ROOF PLAN
NOTES & LEGENDS		SD200-B	BUILDING B - EXTERIOR ELEVATIONS
existing conditions		SD201-B	BUILDING B - EXTERIOR ELEVATIONS

VERALL SITE & UTILITY PLAN	SD203-B	B&W
TE PLAN - BUILDING A	SD300-B	BUILDING B SECTIONS
TE PLAN - BUILDING B		
TE PLAN - BUILDING C	ARCHITECTURAL - BLDC	G C
TE PLAN - BUILDING D & LUBHOUSE	SD100-C	BUILDING C - LL FLOOR PLAN
TE PLAN - BUILDING E	SD101-C	BUILDING C - FIRST FLOOR PLAN
TILITY PLAN - BUILDING A	SD102-C	BUILDING C - 2ND-4TH FLOOR PLAN
TILITY PLAN - BUILDING B	SD103-C	BUILDING C - ROOF PLAN
TILITY PLAN - BUILDING C	SD200-C	BUILDING C - EXTERIOR ELEVATIONS
TILITY PLAN - BUILDING D & LUBHOUSE	SD201-C	BUILDING C - EXTERIOR ELEVATIONS
TILITY PLAN - BUILDING E	SD202-C	BUILDING C - EXTERIOR ELEVATIONS
VERALL GRADING & EROSION ONTROL PLAN	SD202-C	BUILDING C - EXTERIOR ELEVATIONS
RADING PLAN - BUILDING A	SD300-C	BUILDING C SECTIONS

SD100-D	BUILDING D - FIRST FLOOR PLAN
SD101-D	BUILDING D - 2ND FLOOR PLAN
SD102-D	BUILDING D - 3RD FLOOR PLAN
SD103-D	BUILDING D - 4TH FLOOR PLAN
SD105-D	BUILDING D - ROOF PLAN
SD200-D	BUILDING D - EXTERIOR ELEVATION
SD201-D	BUILDING D - EXTERIOR ELEVATION
SD202-D	BUILDING D - EXTERIOR ELEVATION
SD203-D	BUILDING D - EXTERIOR ELEVATION B&W
SD204-D	BUILDING D - EXTERIOR ELEVATION B&W
SD205-D	BUILDING D - EXTERIOR ELEVATION B&W
SD300-D	BUILDING D SECTIONS

380 Average S.F. per space

UILDING B - EXTERIOR ELEVATIONS

ARCHITECTURAL - CLUBHOUSE	
SD100-CH	CLUBHOUSE - FLOOR PLAN
SD200-CH	CLUBHOUSE - EXTERIOR ELEVATIONS
SD201-CH	CLUBHOUSE - EXTERIOR ELEVATIONS
SD202-CH	CLUBHOUSE - EXTERIOR ELEVATIONS B&W
SD203-CH	CLUBHOUSE - EXTERIOR ELEVATIONS B&W
SD300-CH	CLUBHOUSE - BUILDING SECTIONS

SD100-E	BUILDING E - FIRST FLOOR PLAN
SD101-E	BUILDING E - 2ND FLOOR PLAN
SD102-E	BUILDING E - 3RD FLOOR PLAN
SD103-E	BUILDING E - 4TH FLOOR PLAN
SD105-E	BUILDING E - ROOF PLAN
SD200-E	BUILDING E - EXTERIOR ELEVATIONS
SD201-E	BUILDING E - EXTERIOR ELEVATIONS
SD202-E	BUILDING E - EXTERIOR ELEVATIONS
SD203-E	BUILDING E - EXTERIOR ELEVATIONS
SD300-E	BUILDING E SECTIONS

ARCHITECTURAL	
SD400	EXTERIOR MATERIALS BOARD

SITE LIGHTING LAYOUT



JLA PROJECT NUMBER:

19-1104

THE WINSTON

CONDITIONAL USE SUBMITTAL

PROGRESS DOCUMENTS

These documents reflect progress and intent and may be subject to change, including additional detail. These are not final construction documents and should not be used for final bidding or construction-related purposes.

DATE OF ISS	UANCE	AUGUST 8, 202
	revision schei	DULE
Mark	Description	Date
Mark	Description	Date
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4		

BUILDING DATA

Sheet Number

SHEET TITLE

G001

^{**} Balconies and patios are no less than 10'-0" x 5'-0"



1 ARCHITECTURAL SITE PLAN
1" = 50'-0"

ARCHITECTS

JLA-AP.COM

19-1104

THE WINSTON

CONDITIONAL USE SUBMITTAL

PROGRESS DOCUMENTS

These documents reflect progress and intent and may be subject to change, including additional detail. These are not final construction documents and should not be used for final bidding or construction-related purposes.

AUGUST 17, 2022 REVISION SCHEDULE Date

Description


ARCHITECTURAL SITE PLAN

SHEET NUMBER

ASP-100

THE WINSTON

SITE IMPROVEMENTS CITY OF MADISON

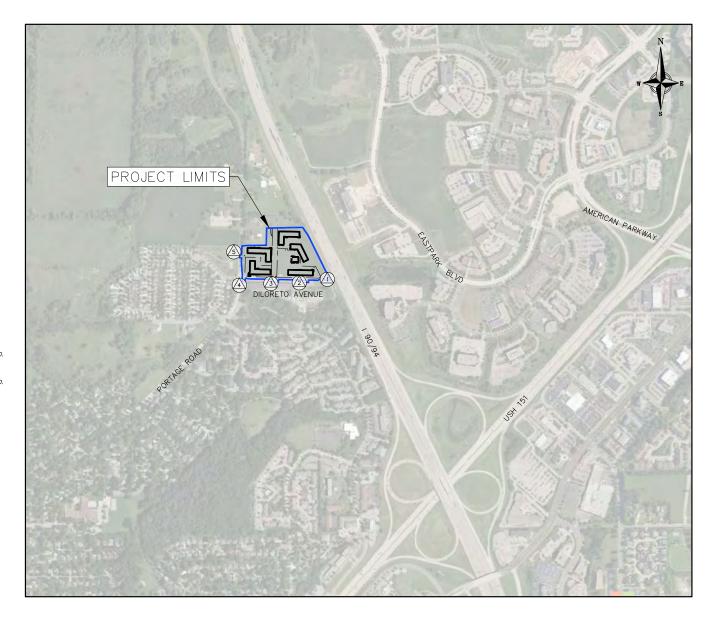



BENCHMARK 1 - ELEV. = 909.58;
TOP NUT OF FIRE HYDRANT LOCATED IN THE CUL-DE-SAC AT THE EAST END OF DILORETO AVE.

BENCHMARK 2 - ELEV. = 906.02':
TOP NUT OF FIRE HYDRANT LOCATED ON THE SOUTHERLY R/W OF DILORETO AVE. 740'± EAST OF THE INTERSECTION WITH PORTAGE ROAD.

BENCHMARK 3 — ELEV. = 896.19';
TOP NUT OF FIRE HYDRANT LOCATED ON THE SOUTHERLY R/W OF DILORETO AVE. 380'± EAST OF THE INTERSECTION WITH PORTAGE ROAD.


(4) BENCHMARK 4 - FLEV. = 887.87: TOP NUT OF FIRE HYDRANT LOCATED AT THE SOUTHWEST CORNER OF THE INTERSECTION OF DILORETO AVE. AND PORTAGE ROAD.

(5) BENCHMARK 5 - ELEV. = 902.20';
TOP NUT OF FIRE HYDRANT LOCATED ON THE WESTERLY R/W OF PORTAGE RD. 400'± NORTH OF THE INTERSECTION WITH DILORETO AVE.



THE LOCATION OF EXISTING UTILITIES, BOTH UNDERGROUND AND OVERHEAD ARE APPROXIMATE ONLY AND HAVE NOT BEEN INDEPENDENTLY VERIFIED BY THE OWNER OR ITS REPRESENTATIVE. THE CONTRACTOR SHALL BE RESPONSIBLE FOR DETERMINING THE EXACT LOCATION OF ALL EXISTING UTILITIES WHETHER SHOWN ON THEES PLANS OR NOT, BEFORE COMMENCING WORK, AND SHALL BE FULLY RESPONSIBLE FOR ANY AND ALL DAMAGES WHICH MIGHT BE CAUSED BY THE CONTRACTOR'S FAILURE TO EXACTLY LOCATE AND PRESERVE ANY AND ALL UTILITIES.

CALL DIGGER'S HOTLINE 1-800-242-8511

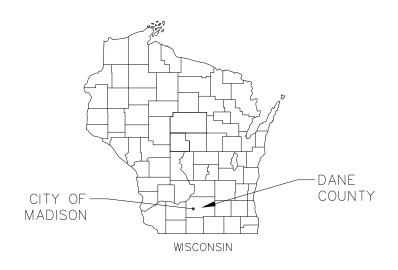

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SHEET NO.	DESCRIPTION					
C1	TITLE SHEET					
C2	NOTES & LEGENDS					
С3	EXISTING CONDITIONS					
C4	DEMOLITION PLAN		- z		_	
C5	OVERALL SITE & UTILITY PLAN			Υ, Μ		
C6	SITE PLAN — BUILDING A		e Sheet WINSTON Y OF MADISC		N	
C7	SITE PLAN — BUILDING B	\\\\\\\\\\\\\\\\\\\\\\\\\\\\\\\\\\\\\\		VINS.	OF V	C
C8	SITE PLAN — BUILDING C		ם ב	THE V	CIT	ZY
С9	SITE PLAN — BUILDING D & CLUBHOUSE	╠	Ī	Ħ	П	_
C10	SITE PLAN — BUILDING E		REMARKS			
C11	UTILITY PLAN — BUILDING A	REVISIONS	ž.			
C12	UTILITY PLAN- BUILDING B	RE	DATE			1
C13	UTILITY PLAN — BUILDING C		Ö.	4	10	9
C14	UTILITY PLAN — BUILDING D & CLUBHOUSE		S			
C15	UTILITY PLAN — BUILDING E	Z SZ	REMARKS			
C16	OVERALL GRADING & EROSION CONTROL PLAN	REVISIONS			Ц	
C17	GRADING PLAN — BUILDING A		DATE			
C18	GRADING PLAN — BUILDING B	DA	g ZF	-	21	10
C19	GRADING PLAN — BUILDING C		8/8/2022 DRAFTER			
C20	GRADING PLAN — BUILDING D & CLUBHOUSE	BBAR CHECKED		_		
C21	GRADING PLAN — BUILDING E	TSCH PROJECT NO.				
C22-C26	SITE DETAILS	190233		_		

NOT FOR CONSTRUCTION



— — 820 — EXISTING MAJOR CONTOUR

--- 818 --- Existing Minor Contour

TOPOGRAPHIC SYMBOL LEGEND

EXISTING BOLLARD

EXISTING MAILBOX

EXISTING FLAG POLE

GRADING LEGEND — −820 — EXISTING MAJOR CONTOURS — - 818 — — EXISTING MINOR CONTOURS ■ PUBLIC LAND CORNER AS NOTED · · - DITCH CENTERLINE - DISTURBED LIMITS \Longrightarrow 2.92% -048.61 EXISTING SPOT ELEVATIONS <u>___1048.61</u> FARREST VELOCITY CHECK 0

SURVEY LEGEND

X FOUND CHISELED "X"

O FOUND 1" Ø IRON PIPE

⊗ FOUND 2" ø IRON PIPE

FOUND 1 1/4" Ø IRON ROD

● FOUND 3/4" Ø IRON ROD

₩ FOUND RAILROAD SPIKE

SET 1 1/4" Ø IRON ROD

⚠ GENERAL CONTROL POINT

DEMOLITION PLAN LEGEND

ASPHALT REMOVAL

CONCRETE REMOVAL

UTILITY STRUCTURE REMOVAL

BUILDING REMOVAL

TREE REMOVAL

— SAWCUT

(X)

◆ SET 3/4" Ø IRON ROD

X SET RAILROAD SPIKE

★ SET CHISELED "X"

SET NAIL

Δ SET P.K. NAIL

▲ FOUND P.K. NAIL

■ BENCHMARK

FOUND NAIL

PROPOSED UTILITY LEGEND STORM SEWER MANHOLE STORM SEWER ENDWALL STORM SEWER CURB INLET STORM SEWER CURB INLET W/MANHOLE STORM SEWER FIELD INLET -<---- SANITARY SEWER PIPE (GRAVITY)</p> SANITARY SEWER LATERAL PIPE (3) SANITARY SEWER MANHOLE SANITARY SEWER CLEANOUT - · · - WATER MAIN WATER SERVICE LATERAL PIPE ABBREVIATIONS FIRE HYDRANT STMH - STORM MANHOLE WATER VALVE MH — STORM MANHOLE — FIELD INLET — CURB INLET — CATCH BASIN — ENDWALL H — SANITARY MANHOLE CURB STOP WATER VALVE MANHOLE PROPOSED PIPE INSULATION — 6 — GAS MAIN

DRAINAGE DIRECTION

STONE WEEPER

INLET PROTECTION

TRACKING PAD

- UE - UE - ELECTRIC SERVICE

EROSION MAT CLASS_

EROSION MAT CLASS__

PROPOSED SLOPE ARROWS

PROPOSED SPOT ELEVATIONS

SITE PLAN LEGEND PROPERTY BOUNDARY CURB AND GUTTER (REVERSE CURB HATCHED) - PROPOSED CHAIN LINK FENCE PROPOSED CONCRETE ABBREVIATIONS - TOP OF CURB - FINISHED FLOOR PROPOSED LIGHT-DUTY ASPHALT FL - FLOW LINE SW - TOP OF WALK TW - TOP OF WALL BW - BOTTOM OF WAL PROPOSED HEAVY-DUTY ASPHALT PROPOSED SIGN PROPOSED LIGHT POLE

PROPOSED ADA DETECTABLE WARNING FIELD

PROPOSED HANDICAP PARKING

PROPOSED BOLLARD

NOT FOR CONSTRUCTION

GENERAL NOTES:

- THE CONTRACTOR IS RESPONSIBLE FOR ANY DAMAGE CAUSED DURING CONSTRUCTION TO PUBLIC PROPERTY, PRIVATE PROPERTY OR UTILITIES.
- 2. THE CONTRACTOR SHALL SUBMIT SHOP DRAWINGS FOR REVIEW BY THE ENGINEER, PRIOR TO PLACING AN ORDER OF ANY SUCH ITEM.
- EXISTING TOPOGRAPHIC INFORMATION IS BASED ON FIELD OBSERVATIONS AND/OR PLAN OF RECORD DRAWINGS. CONTRACTOR SHALL VERIFY TOPOGRAPHIC INFORMATION PRIOR TO STARTING CONSTRUCTION.
- RIGHT OF WAY (ROW) AND PROPERTY LINES ARE APPROXIMATE. CONTRACTOR SHALL BE RESPONSIBLE FOR PROTECTING EXISTING PROPERTY CORNER MONUMENTATION. ANY MONUMENTS DISTURBED BY CONTRACTOR SHALL BE REPLACED AT THE CONTRACTORS EXPENSE.
- CONTRACTOR SHALL COORDINATE WITH DRY UTILITY COMPANY'S REGARDING ANY POTENTIAL CONFLICTS AND COORDINATE RELOCATIONS AS MAY BE REQUIRED. CONTRACTOR SHALL ALSO COORDINATE THE PROPOSED INSTALLATION OF NEW FACILITIES AS REQUIRED.

SITE PLAN NOTES:

- CONCRETE TO BE 5" THICK, CONSTRUCTED ON A BASE OF 4" COMPACTED SAND OR CRUSHED STONE.
- 2. CONCRETE FOR DRIVEWAYS AND SIDEWALK AT DRIVEWAY ENTRANCES SHALL BE 7" THICK, CONSTRUCTED ON A BASE OF 5" COMPACTED SAND OR CRUSHED STONE.
- 3. ALL DIMENSIONS WITH CURB & GUTTER ARE REFERENCED TO THE FACE OF CURB.
- CONTRACTOR SHALL DEEP TILL ANY DISTURBED AREAS AFTER CONSTRUCTION IS COMPLETE AND BEFORE
- CONTRACTOR TO OBTAIN ANY NECESSARY DRIVEWAY CONNECTION, RIGHT OF WAY AND EXCAVATION PERMITS
- ANY SIDEWALK AND CURB & GUTTER ABUTTING THE PROPERTY SHALL BE REPLACED IF IT IS DAMAGED DURING CONSTRUCTION OR IF THE CITY ENGINEERING DEPARTMENT DETERMINES THAT IT IS NOT AT A DESIRABLE GRADE, REGARDLESS OF WHETHER THE CONDITION EXISTED PRIOR TO BEGINNING CONSTRUCTION.

- CONTOURS ARE SHOWN FOR PURPOSES OF INDICATING ROUGH GRADING. FINAL GRADE SHALL BE ESTABLISHED ON PAVED SURFACES BY USING SPOT GRADES ONLY.
- 2. ALL GRADES SHOWN REFERENCE FINISHED ELEVATIONS
- 3. CROSS SLOPE OF SIDEWALKS SHALL BE 2.0% UNLESS OTHERWISE NOTED.
- LONGITUDINAL GRADE OF SIDEWALK RAMPS SHALL NOT EXCEED 8.33% (1:12) AND SHALL BE IN ACCORDANCE WITH ADA REQUIREMENTS.
- LONGITUDINAL GRADE OF SIDEWALK SHALL NOT EXCEED 5.0% OR THE ADJACENT STREET GRADE WHICHEVER IS GREATER.
- ACCESSIBLE ROUTES SHALL BE 5.0% MAX LONGITUDINAL SLOPE AND 1.5% MAX CROSS SLOPE. ACCESSIBLE LOADING AREAS OR LANDINGS SHALL BE 2.0% MAX SLOPE IN ANY DIRECTION. RAMPS SHALL BE 8.33% MAX
- 7. NO LAND DISTURBANCE ACTIVITIES SHALL BEGIN UNTIL ALL EROSION CONTROL BMP'S ARE INSTALLED.
- 8. SEE DETAIL SHEETS FOR EROSION CONTROL NOTES AND CONSTRUCTION SEQUENCE

- CONTRACTOR SHALL OBTAIN ANY NECESSARY WORK IN RIGHT OF WAY, EXCAVATION, UTILITY CONNECTION, PLUGGING AND ABANDONMENT PERMITS PRIOR TO CONSTRUCTION.
- 2. CONTRACTOR TO VERIFY EXISTING UTILITY LOCATIONS AND ELEVATIONS PRIOR TO STARTING WORK
- 3. SANITARY & STORM SEWER LENGTHS SHOWN ARE FROM CENTER OF STRUCTURE TO CENTER OF STRUCTURE. STORM SEWER END SECTIONS ARE INCLUDED IN THE LENGTH AND SLOPE OF THE PIPE.
- 4. CONTRACTOR SHALL INVESTIGATE ALL UTILITY CROSSINGS PRIOR TO CONSTRUCTION AND NOTIFY ENGINEER
- 5. CONTRACTOR SHALL BE RESPONSIBLE FOR ADJUSTING ALL UTILITY STRUCTURES TO FINISHED GRADE (MANHOLE RIMS, WATER VALVES, AND CURB STOPS), IF NECESSARY.
- 6. FOR ALL SEWER AND WATER MAIN CROSSINGS: PROVIDE MINIMUM 18" SEPARATION WHEN WATER MAIN CROSSES BELOW SEWER AND MINIMUM 6" SEPARATION WHEN WATER MAIN CROSSES ABOVE SEWER.
- 7. IF DEWATERING OPERATIONS EXCEED 70 GALLONS PER MINUTE OF PUMPING CAPACITY, A DEWATERING WELL PERMIT SHALL BE OBTAINED PRIOR TO STARTING ANY DEWATERING ACTIVITIES.
- 8. A COPY OF THE APPROVED UTILITY PLANS, SPECIFICATIONS AND PLUMBING PERMIT APPROVAL LETTER SHALL BE ON-SITE DURING CONSTRUCTION AND OPEN TO INSPECTION BY AUTHORIZED REPRESENTATIVES OF THE DEPARTMENT OF SAFETY AND PROFESSIONAL SERVICES AND OTHER LOCAL INSPECTORS.
- 9. PROPOSED UTILITY SERVICE LINES SHOWN ARE APPROXIMATE. COORDINATE THE EXACT LOCATIONS WITH THE PLUMBING DRAWINGS. COORDINATE THE LOCATION WITH THE PLUMBING CONTRACTOR AND/OR OWNER'S CONSTRUCTION REPRESENTATIVE PRIOR TO INSTALLATION OF ANY NEW UTILITIES.
- 10. SITE CONTRACTOR SHALL LEAVE SANITARY AND WATER LATERALS FIVE (5) FEET SHORT (HORIZONTALLY) FROM THE BUILDING. BUILDING PLUMBER SHALL VERIFY SIZE, LOCATION, AND INVERT ELEVATION OF PROPOSED SANITARY AND WATER LATERALS.
- 11. IT IS THE CONTRACTOR'S RESPONSIBILITY TO VERIFY THAT THE EXISTING VALVES WILL HOLD THE PRESSURE TEST PRIOR TO CONNECTION. THE CITY IS NOT RESPONSIBLE FOR ANY COSTS INCURRED DUE TO THE CONTRACTOR NOT VERIFYING THAT THE EXISTING VALVE WILL HOLD THE PRESSURE TEST PRIOR TO CONNECTION. IF A NEW VALVE IS REQUIRED, THE APPLICANT WILL BE REQUIRED TO INSTALL ONE AT THEIR EXPENSE, AT THE POINT OF CONNECTION.
- 12. CLEAN OUT ALL EXISTING AND PROPOSED STORM INLETS AND CATCH BASINS AT THE COMPLETION OF
- 13. CONTRACTOR SHALL COORDINATE WITH DRY UTILITY COMPANY'S REGARDING ANY POTENTIAL CONFLICTS AND COORDINATE RELOCATIONS AS MAY BE REQUIRED. CONTRACTOR SHALL ALSO COORDINATE THE PROPOSED INSTALLATION OF NEW FACILITIES AS REQUIRED.
- 14. ALL WATER MAIN AND SERVICES SHALL BE INSTALLED AT A MINIMUM DEPTH OF 6.5' FROM TOP OF FINISHED GRADE ELEVATION TO TOP OF MAIN.
- 15. INSTALL 1 SHEET OF 4'x8'x4" HIGH DENSITY STYROFOAM INSULATION AT ALL LOCATIONS WHERE STORM SEWER CROSSES WATER MAIN OR WATER LATERALS.



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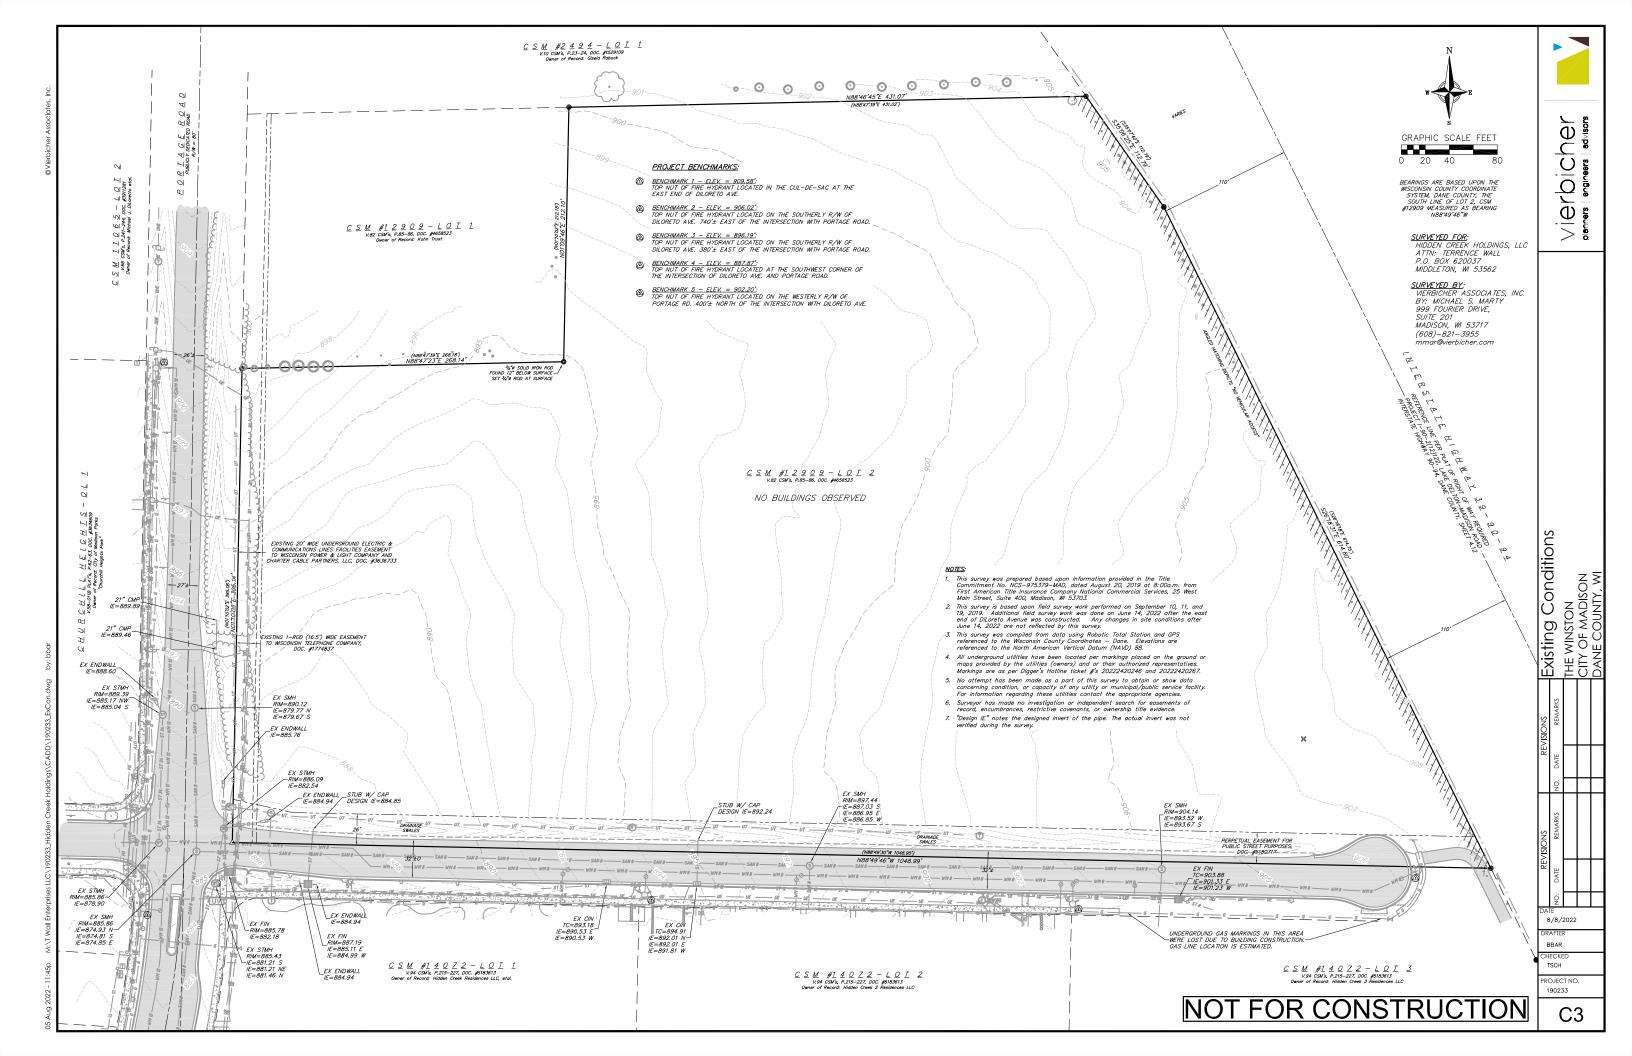
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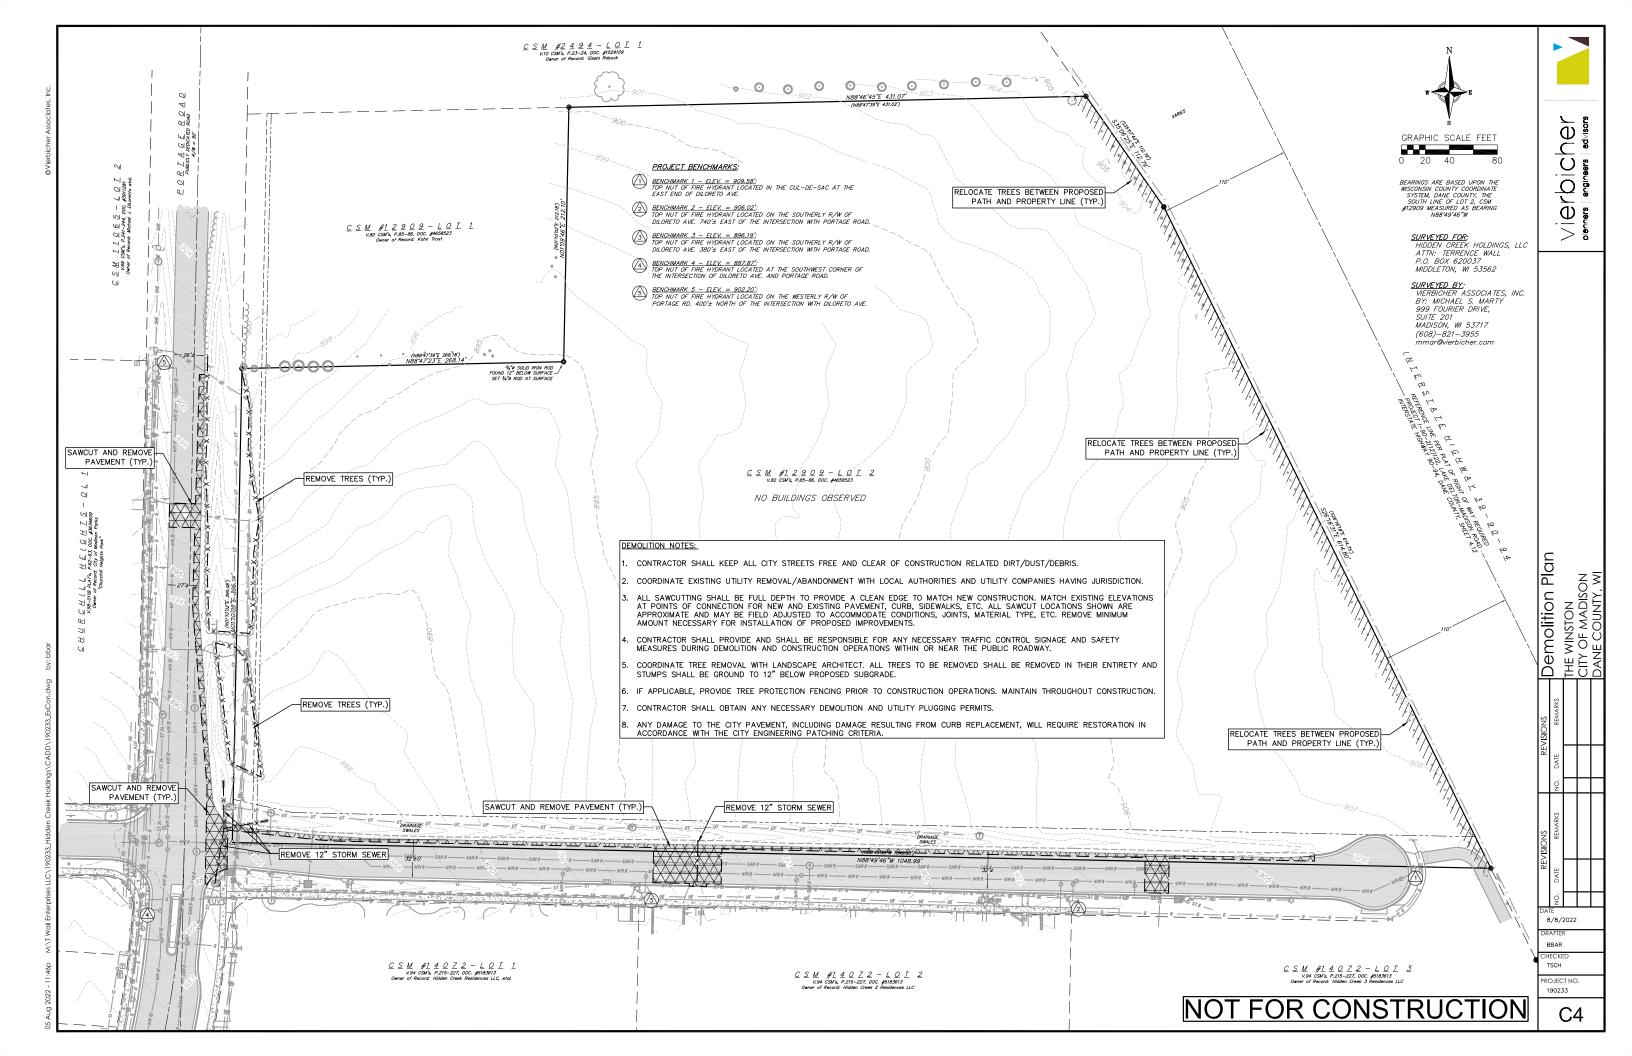
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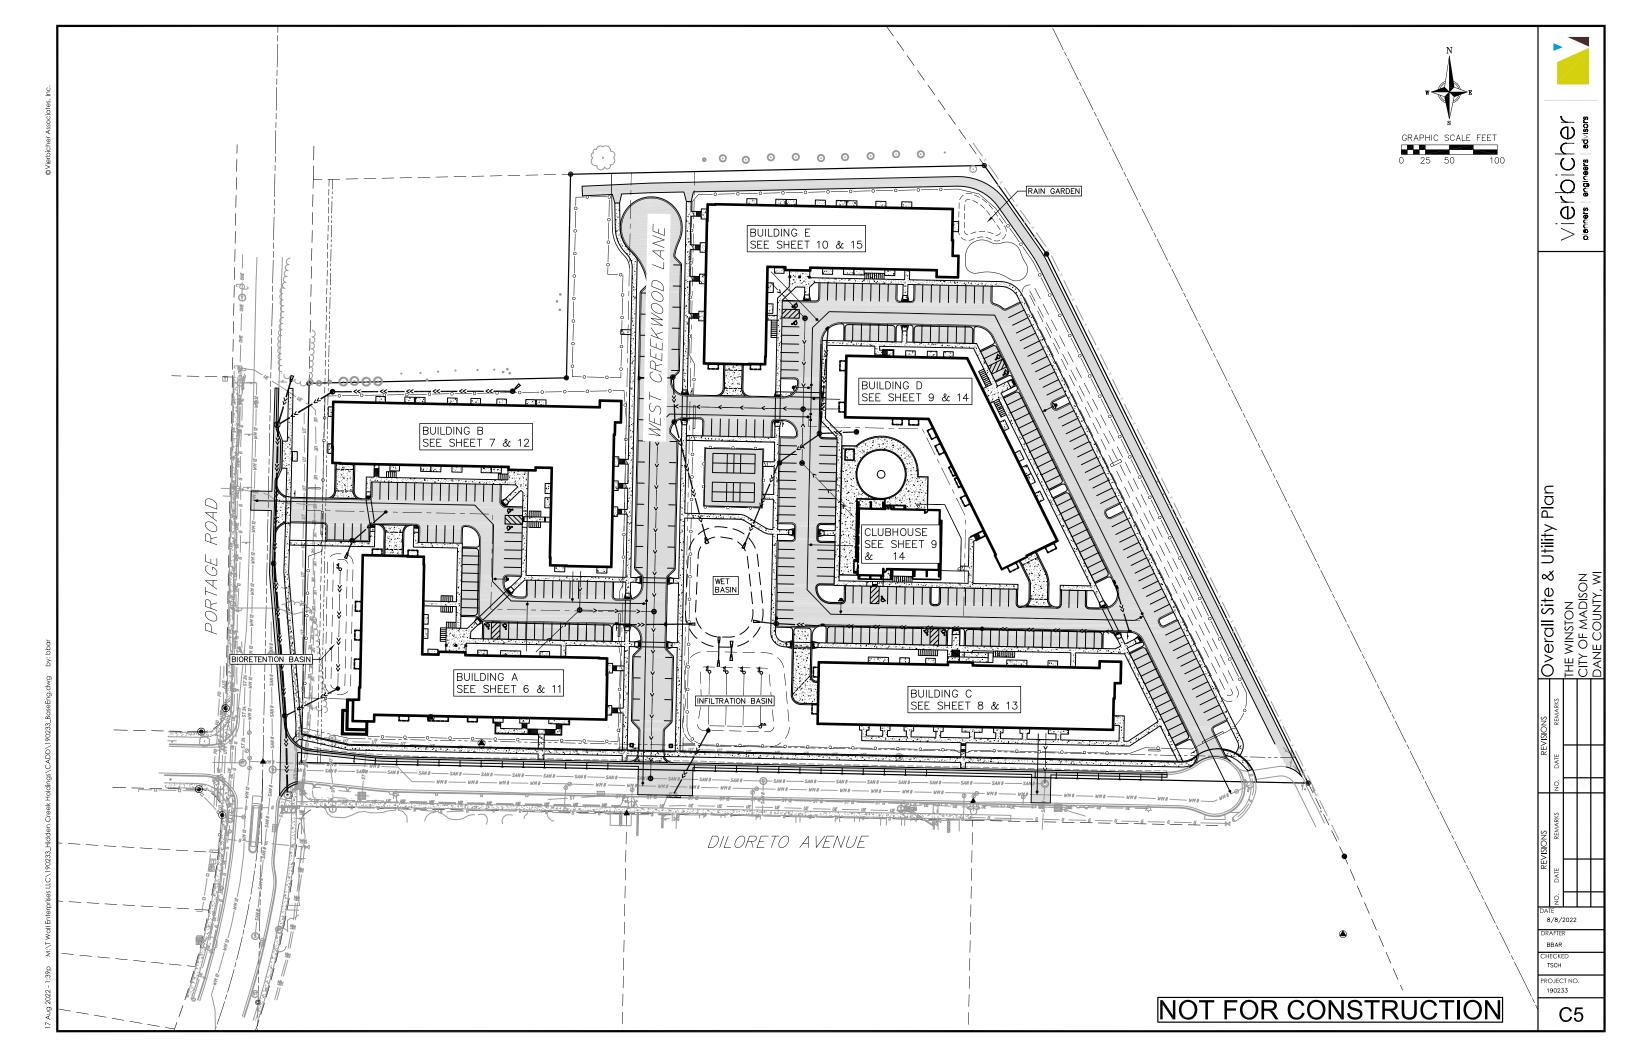
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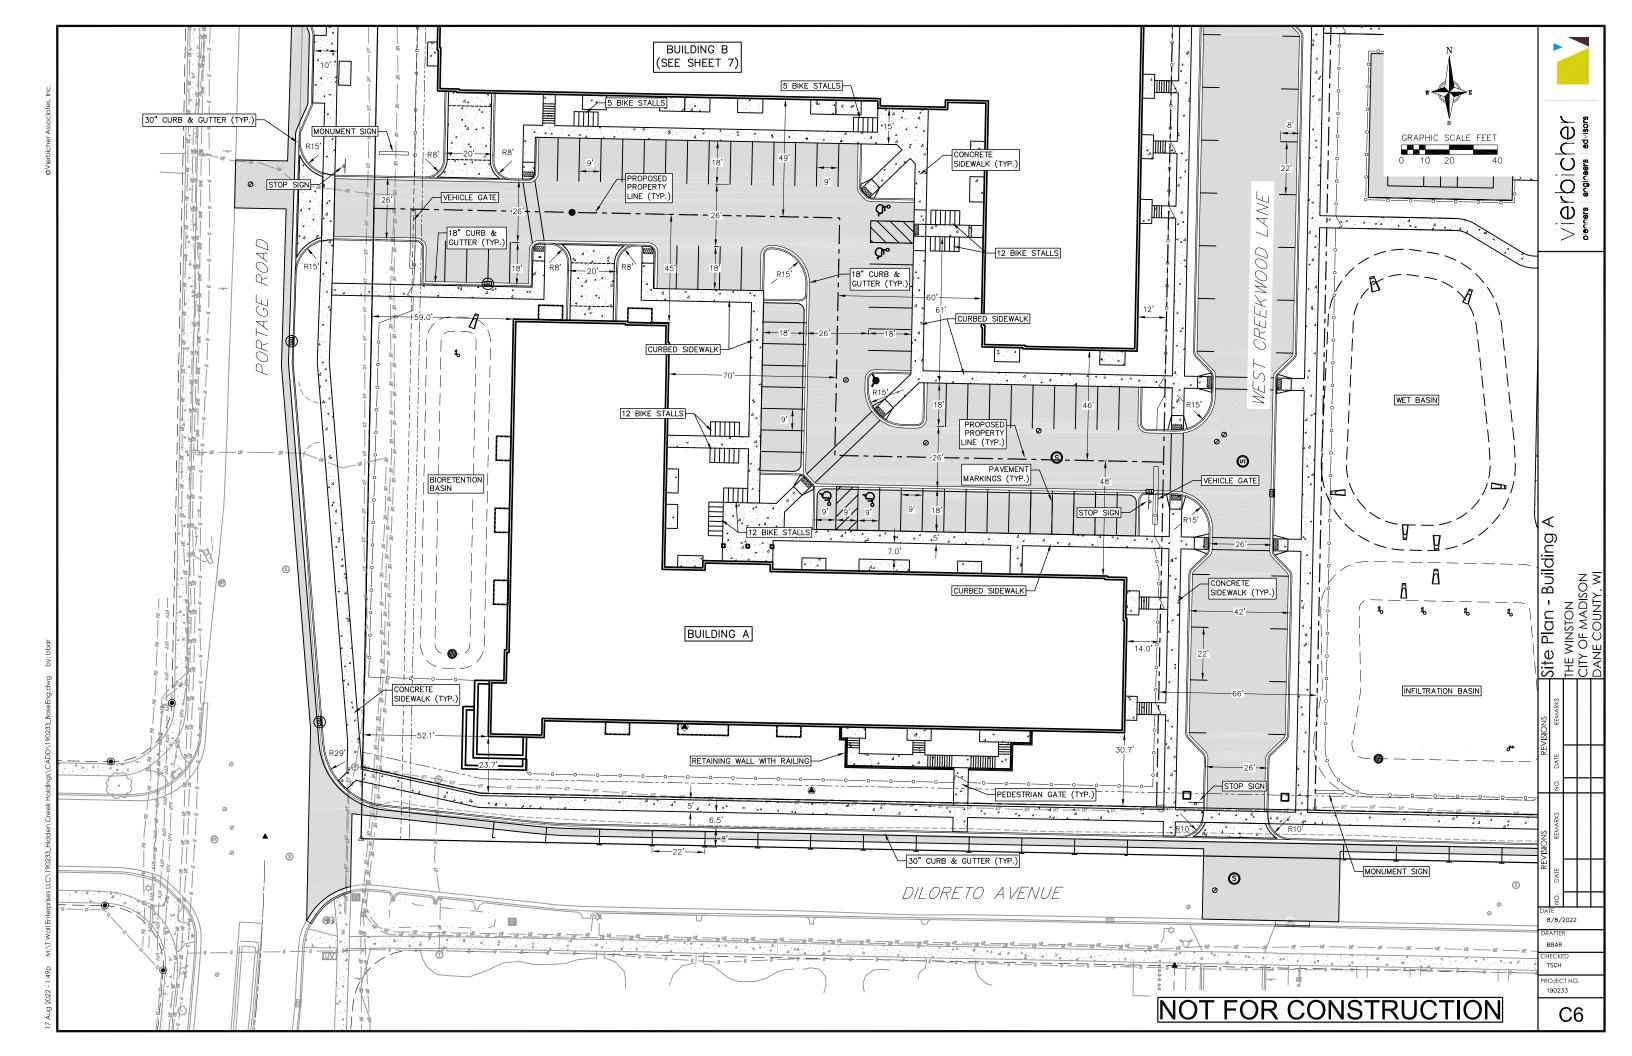
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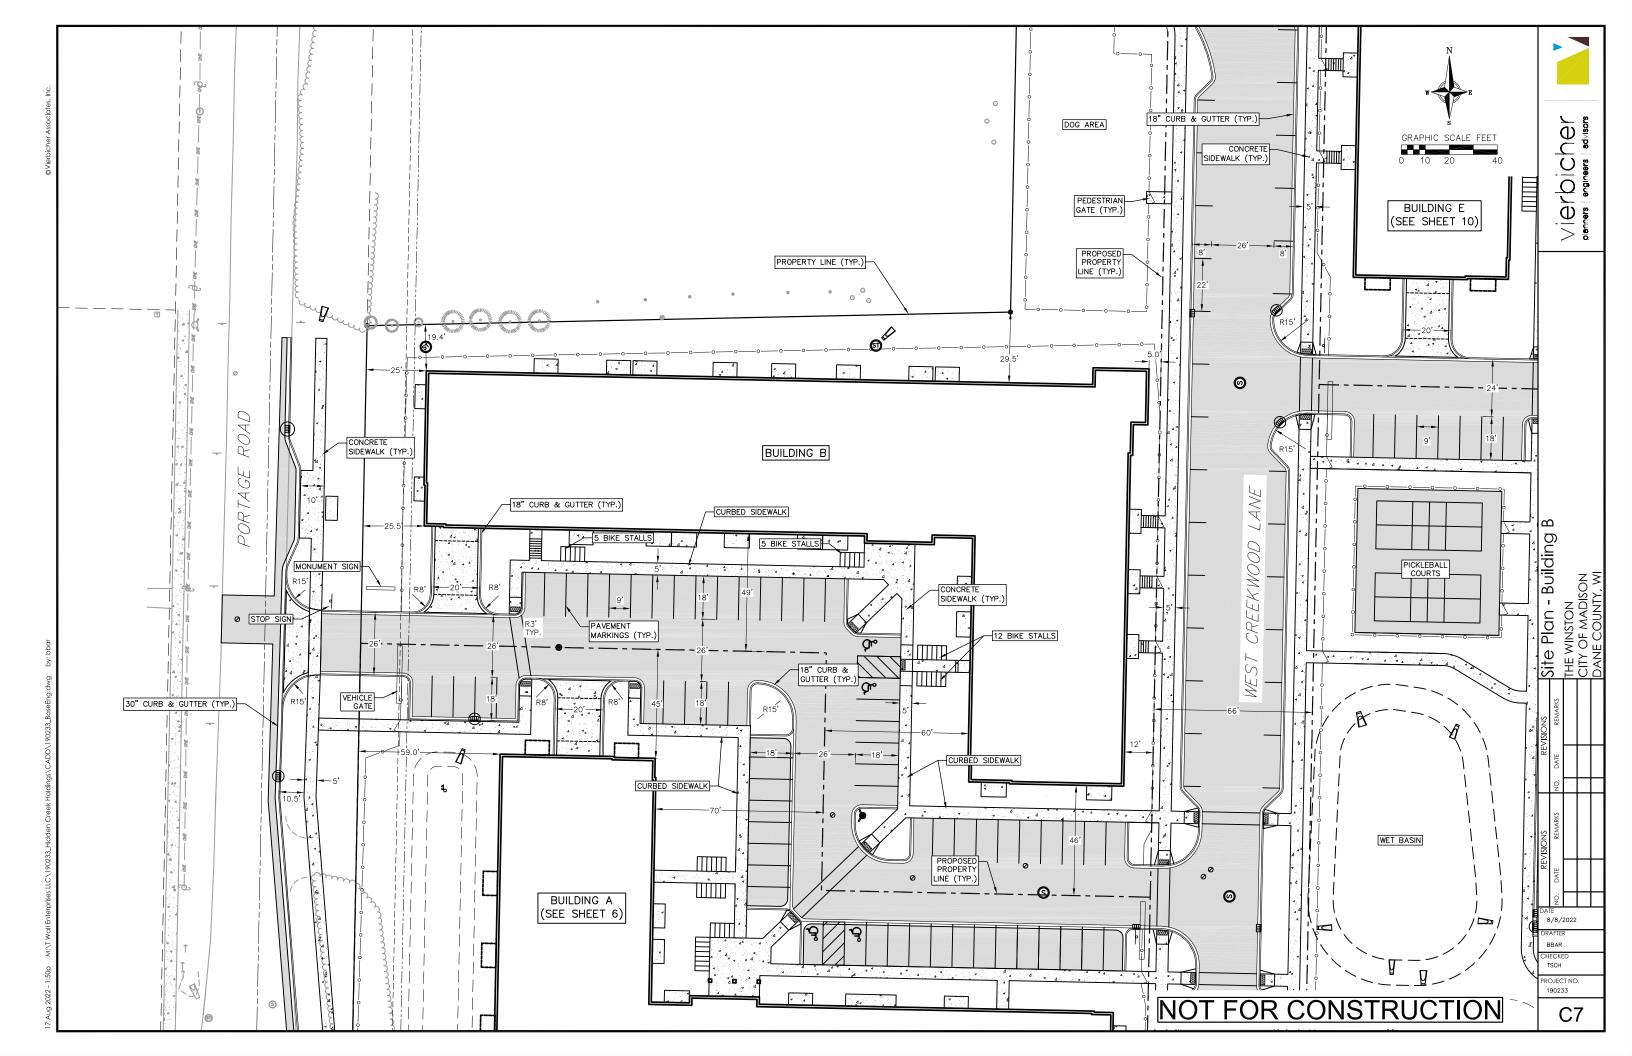
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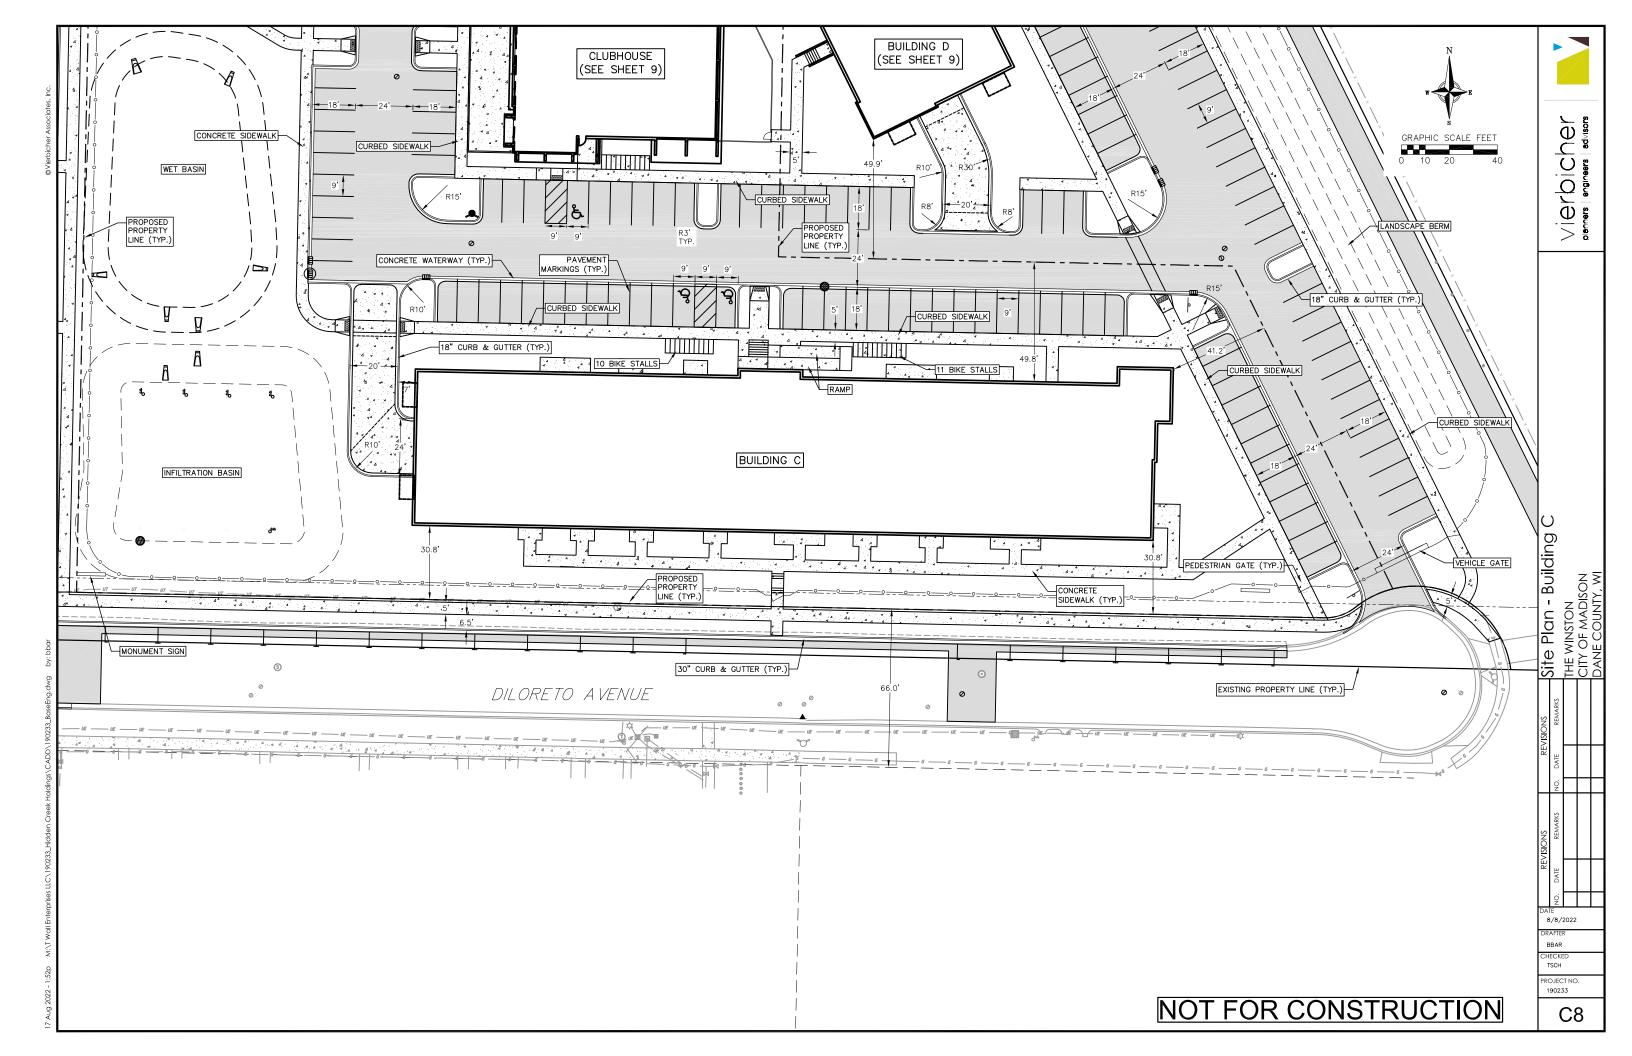

















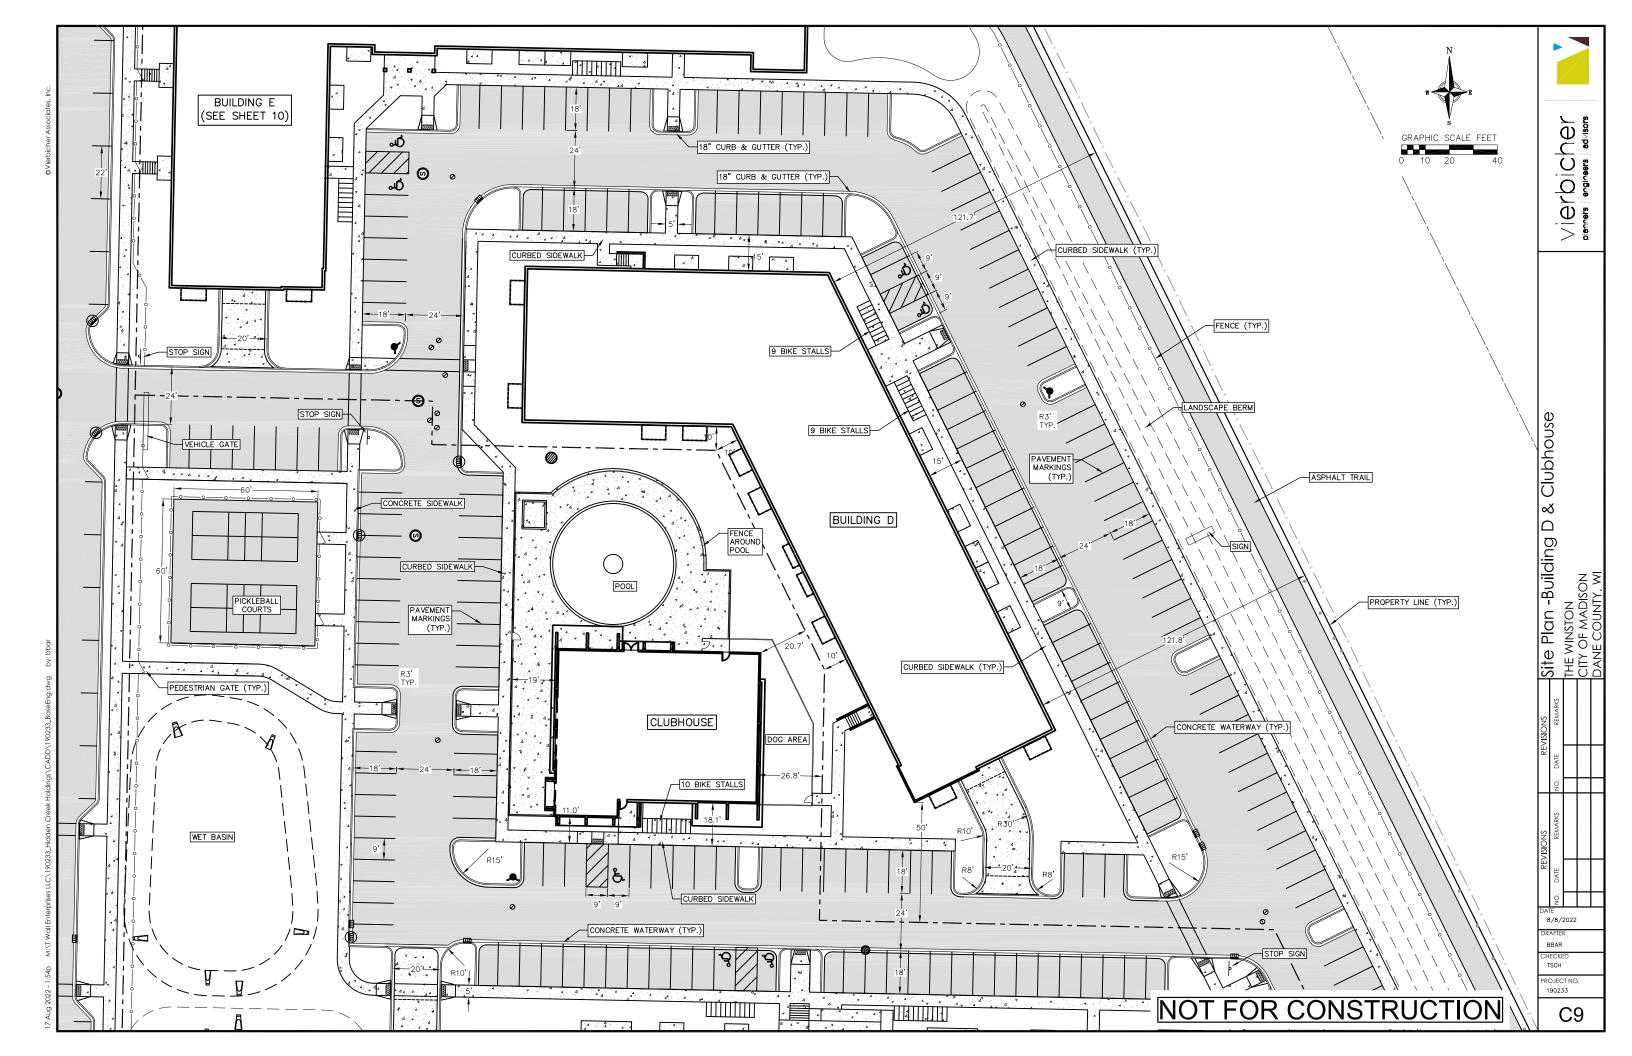


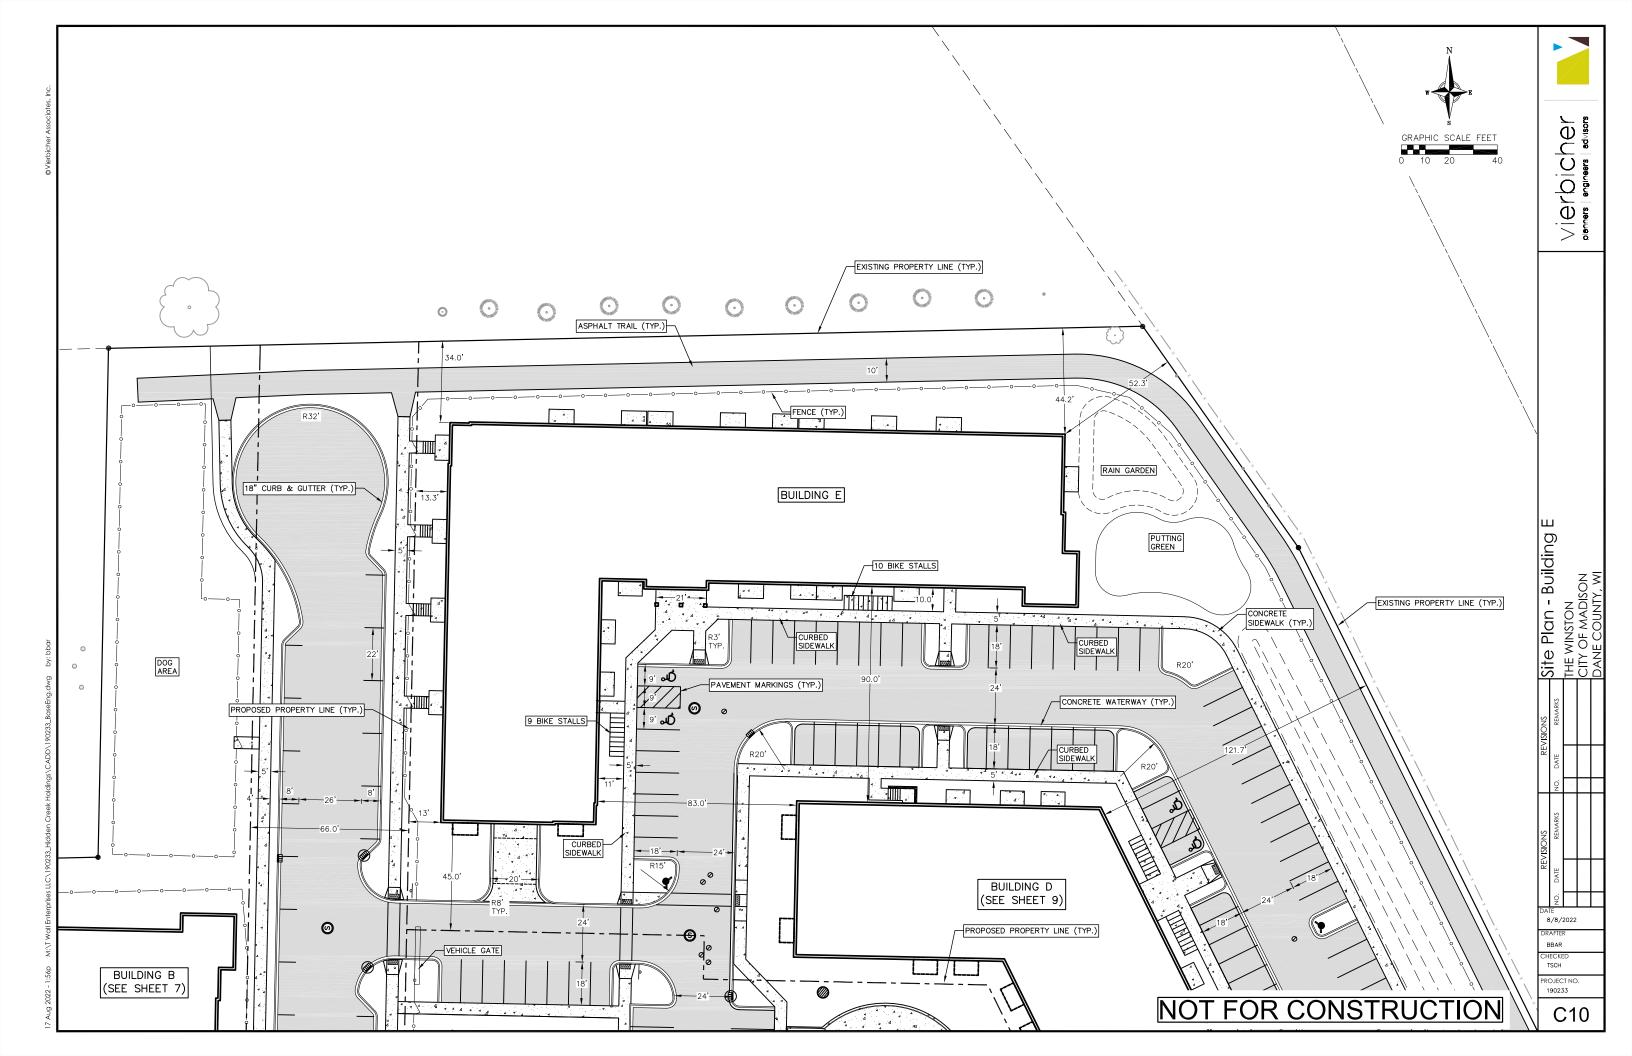


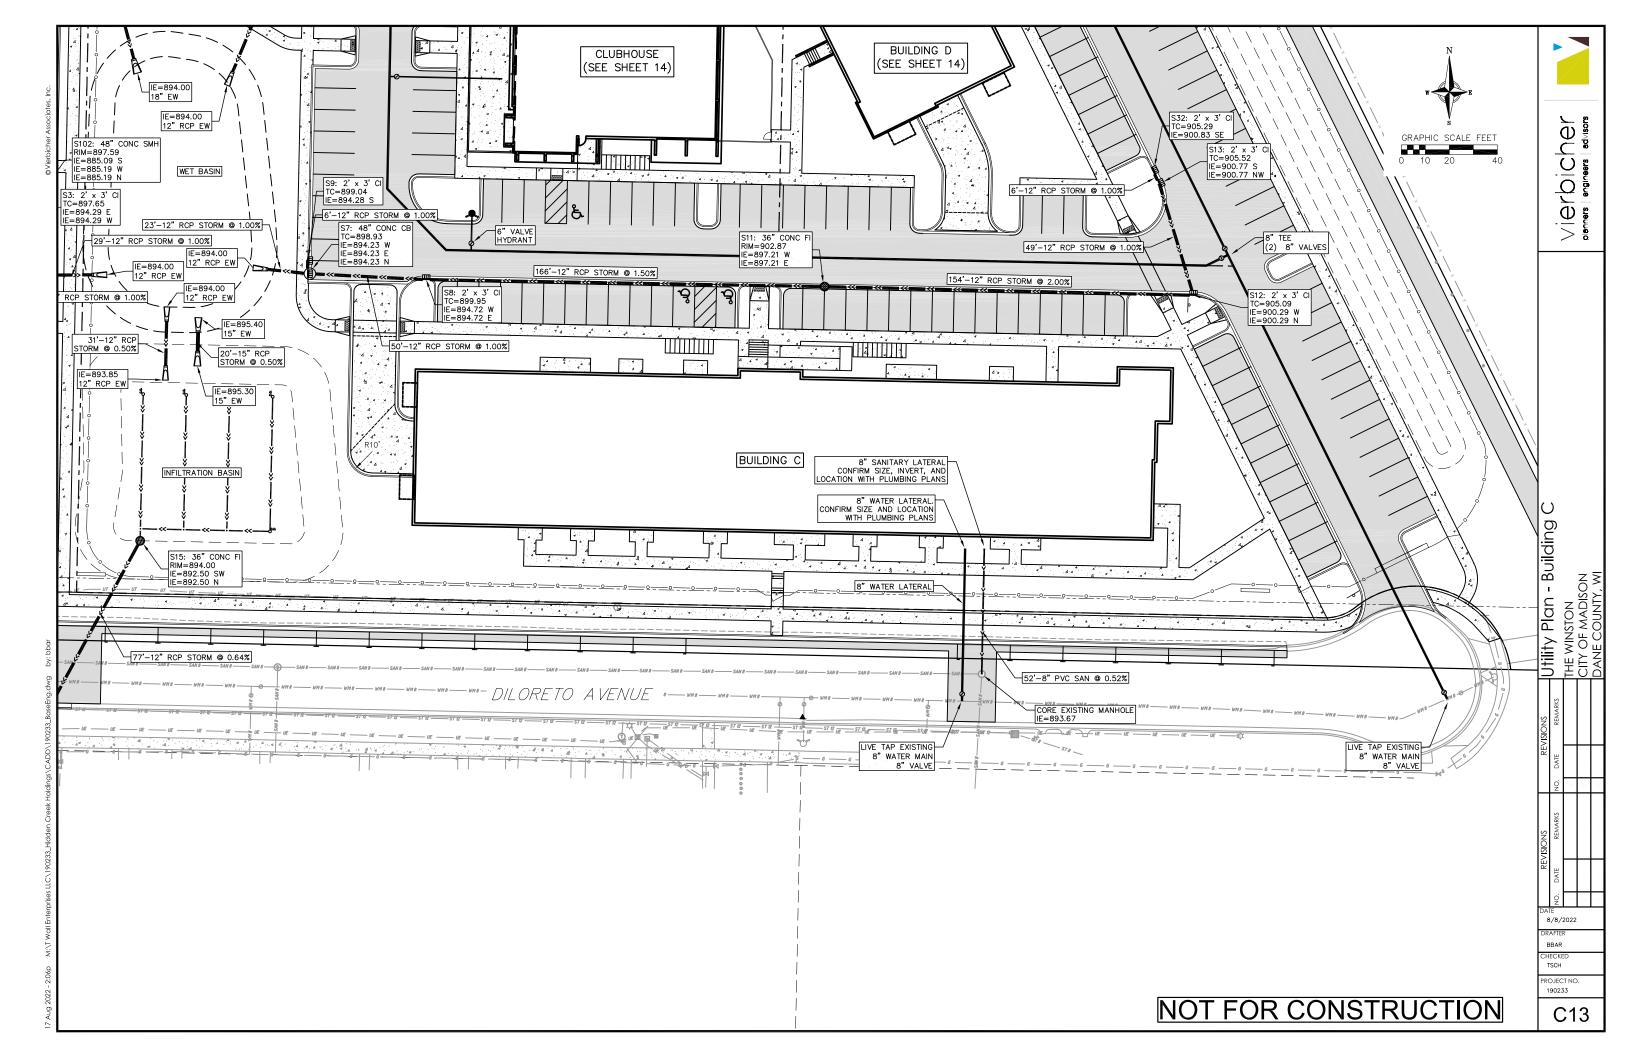


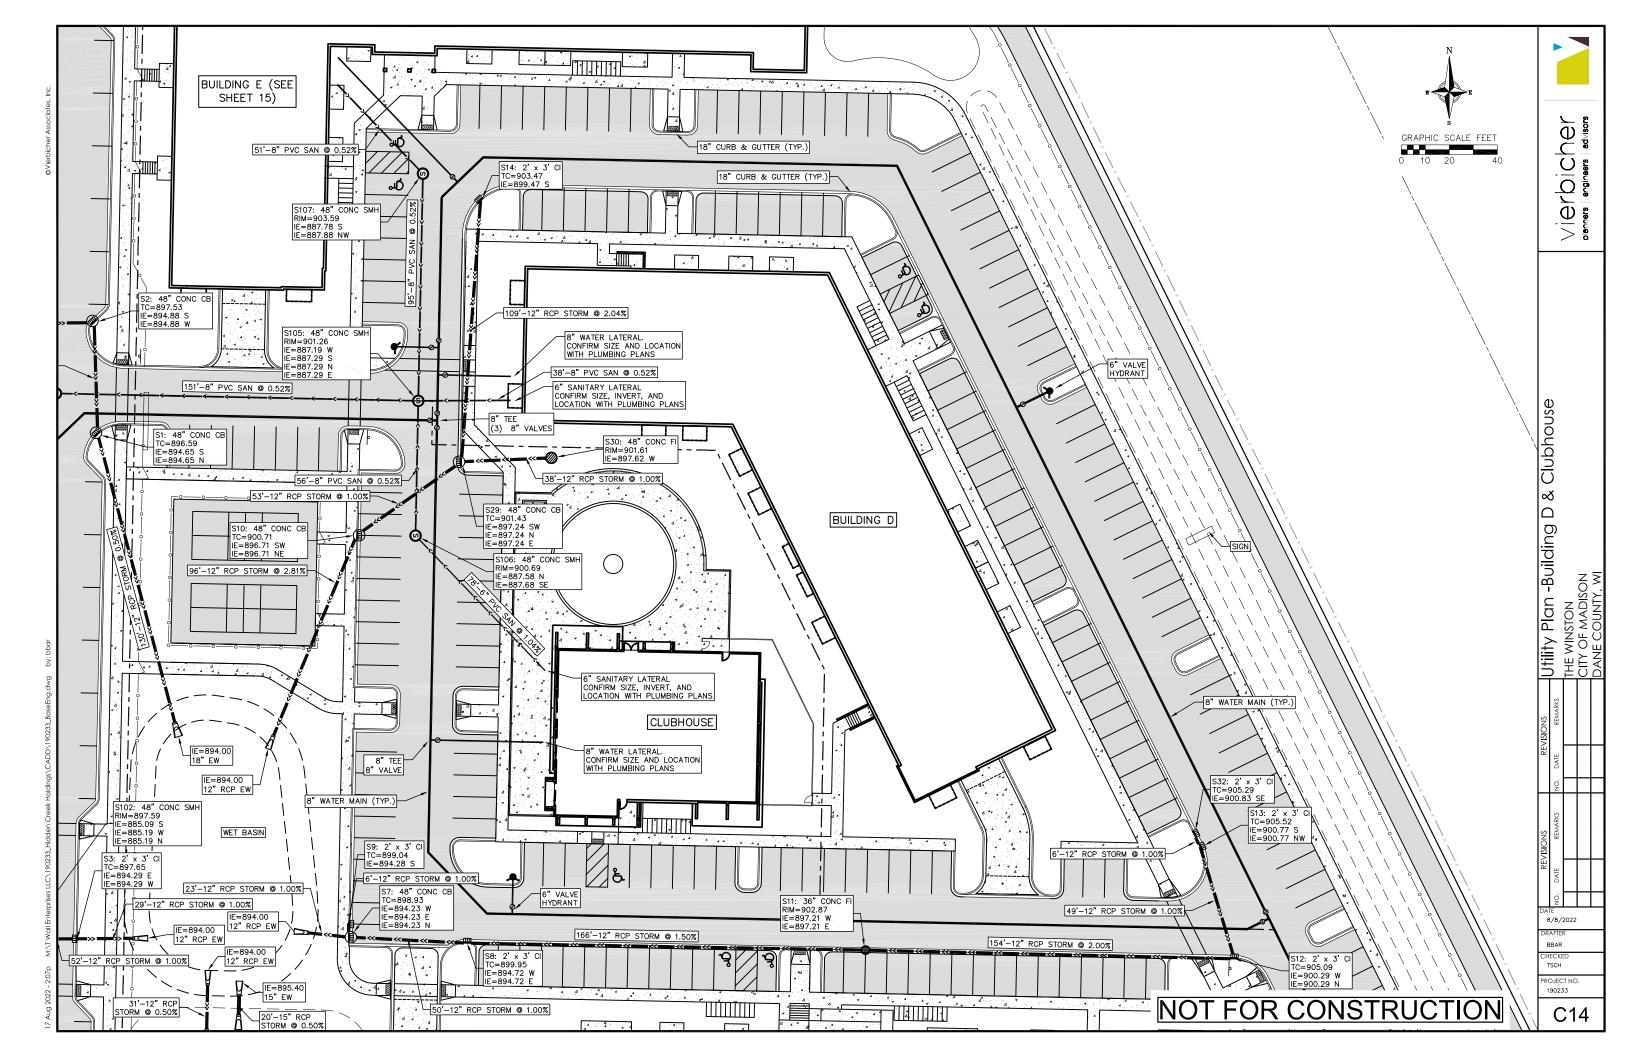


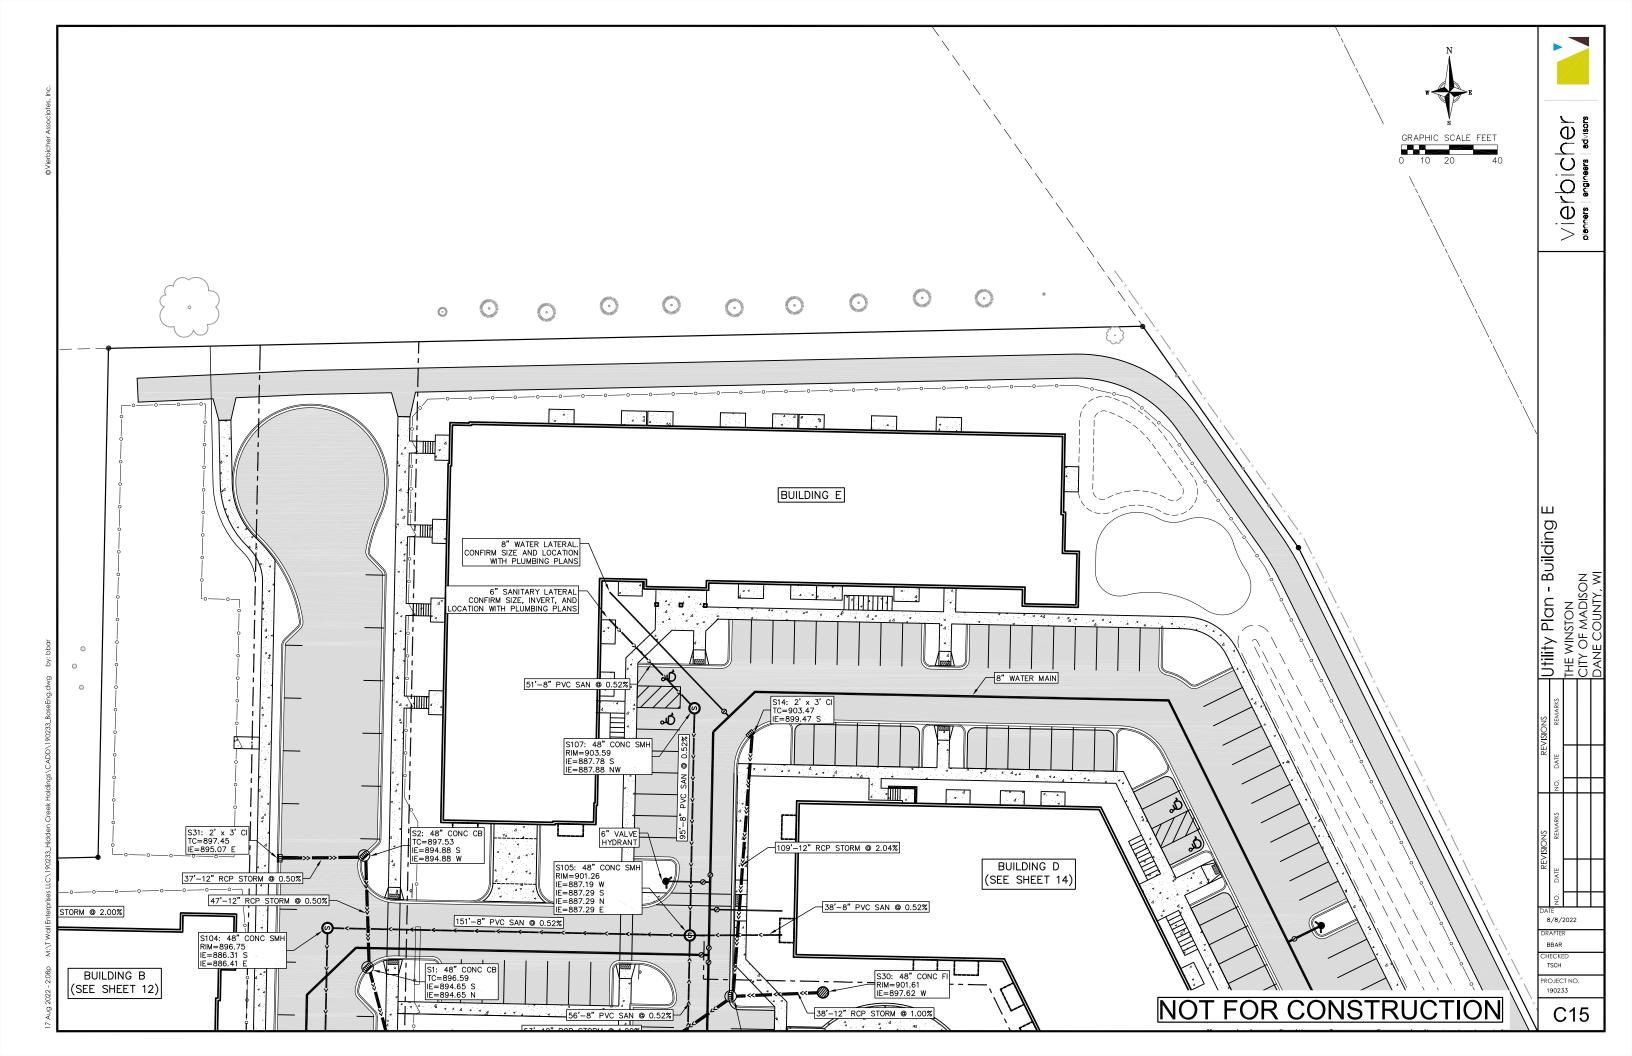


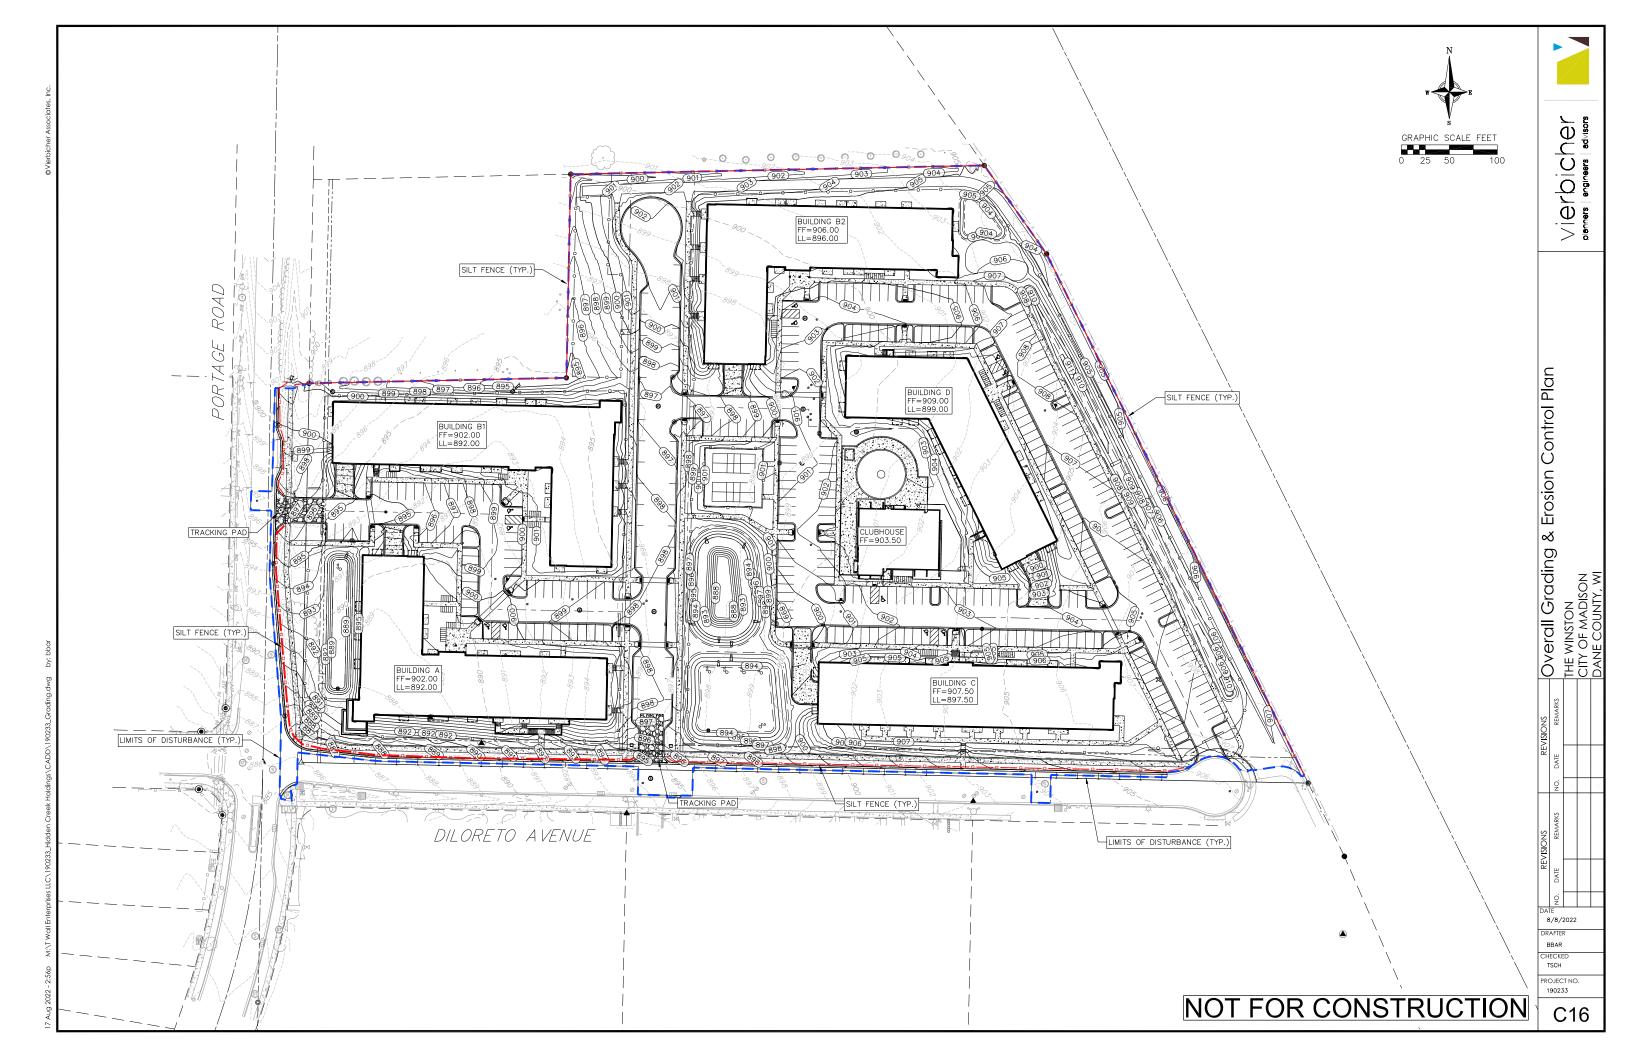

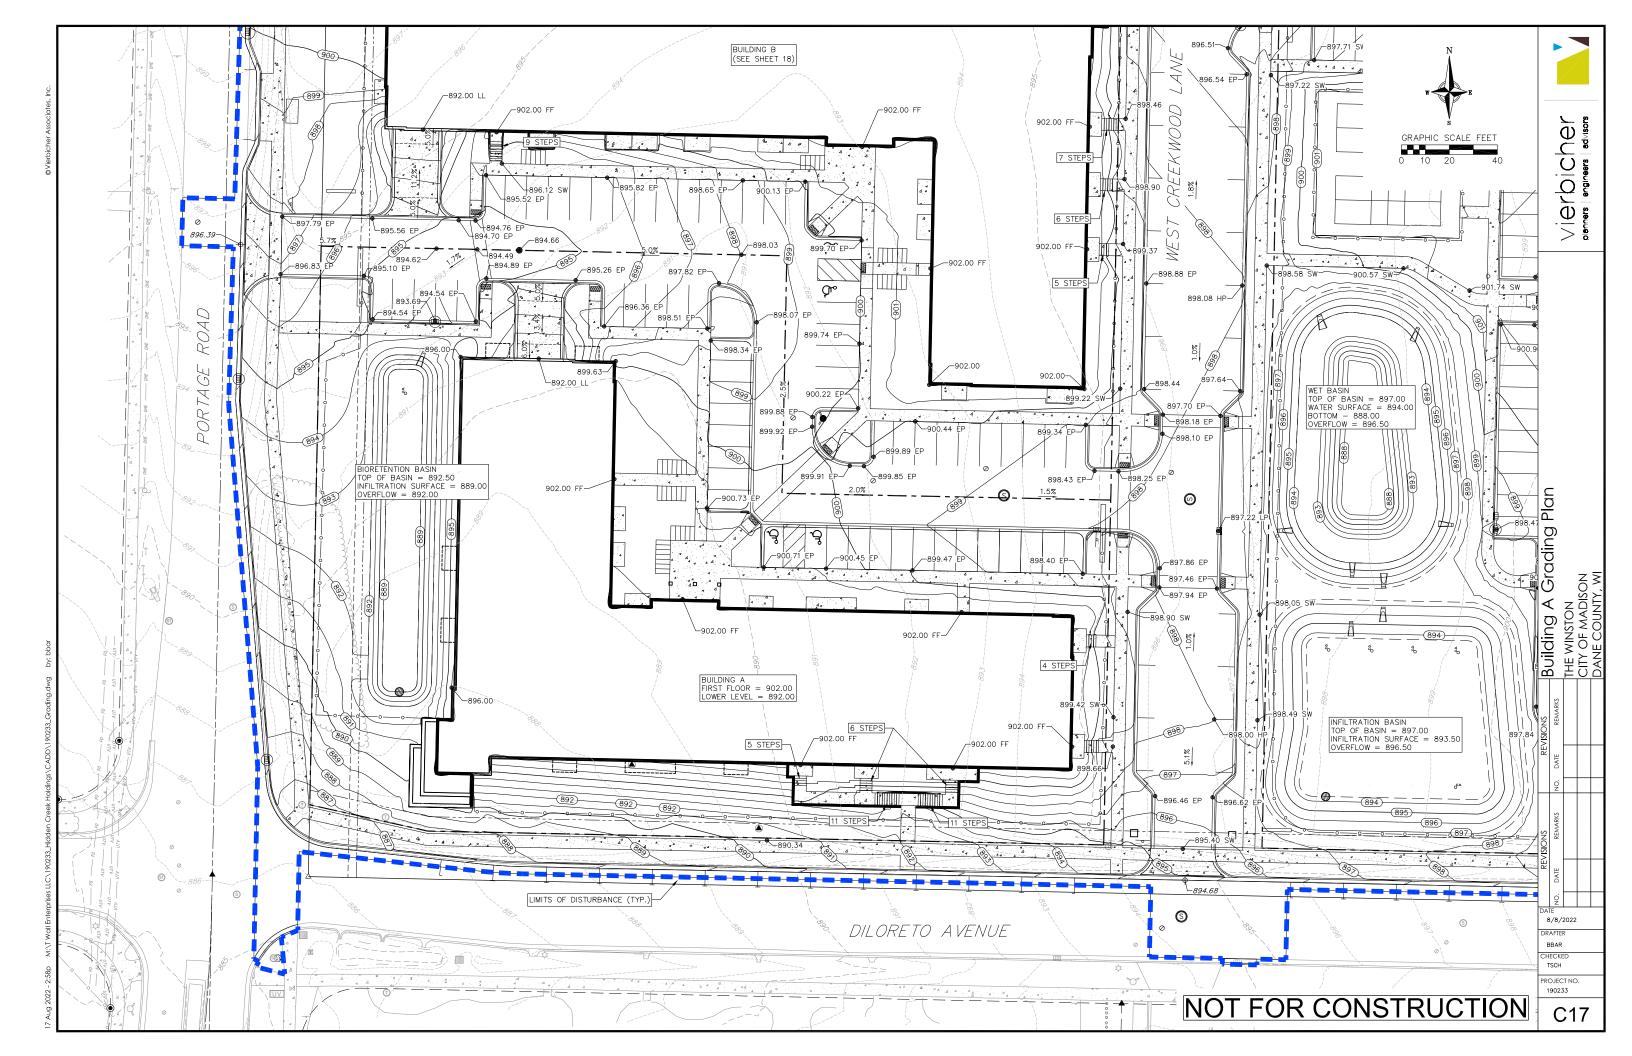

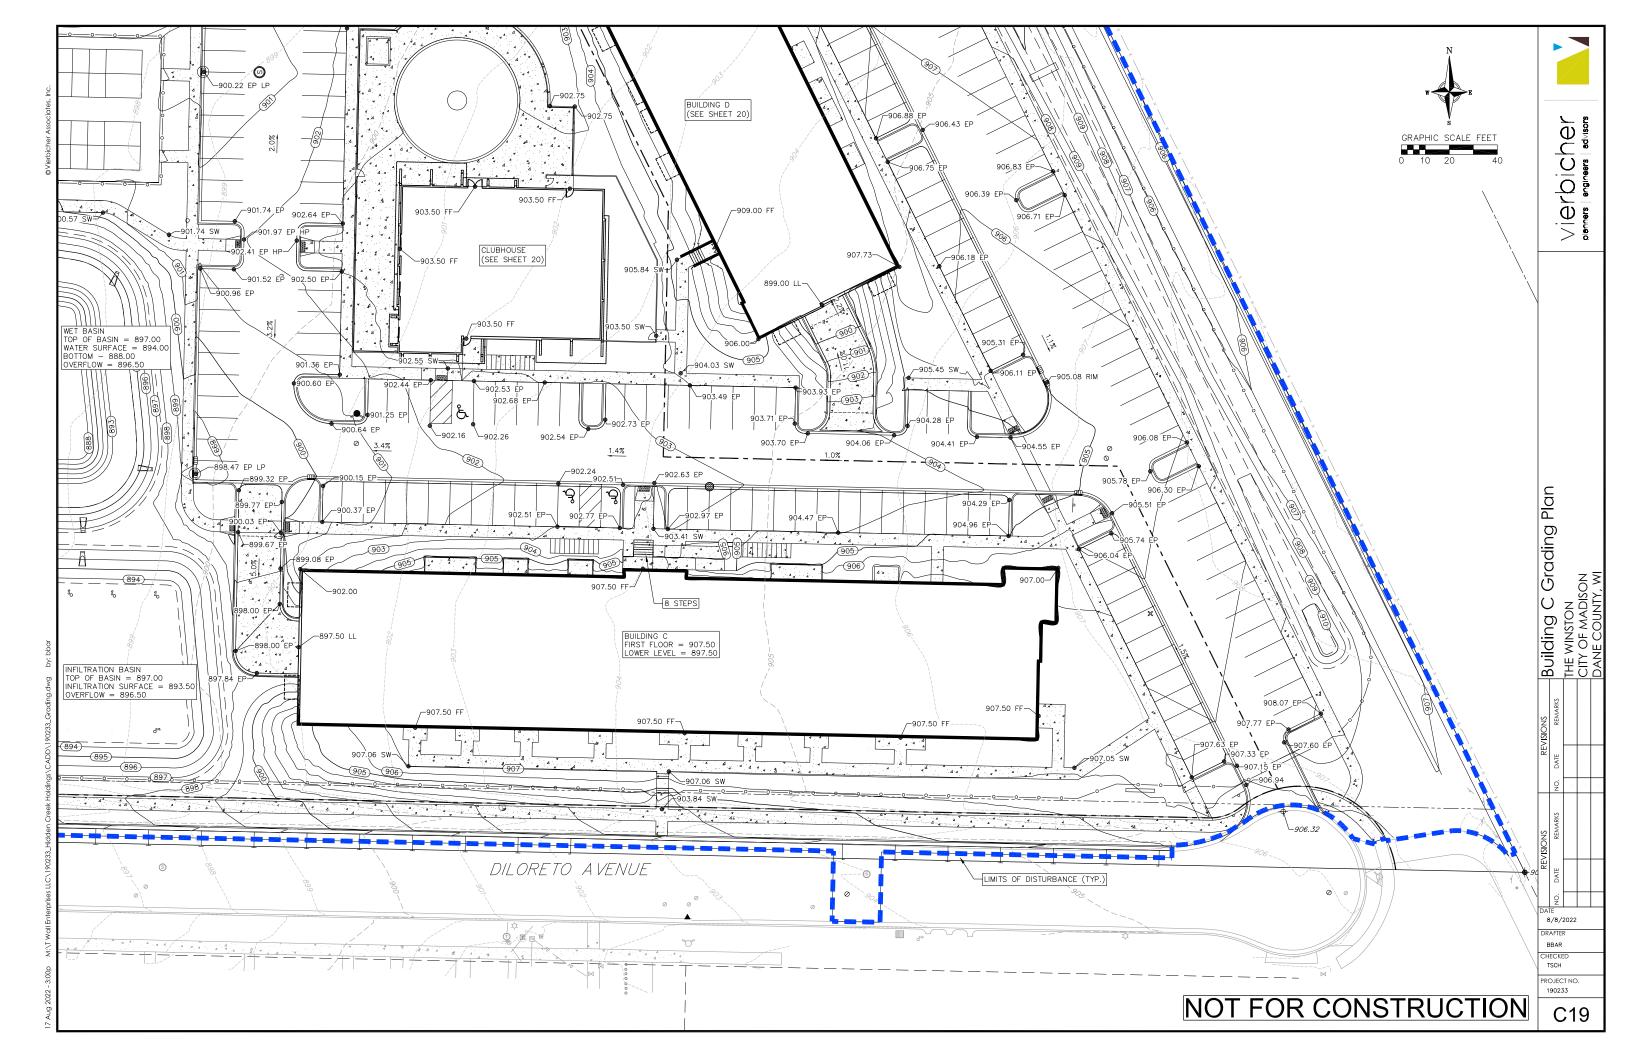


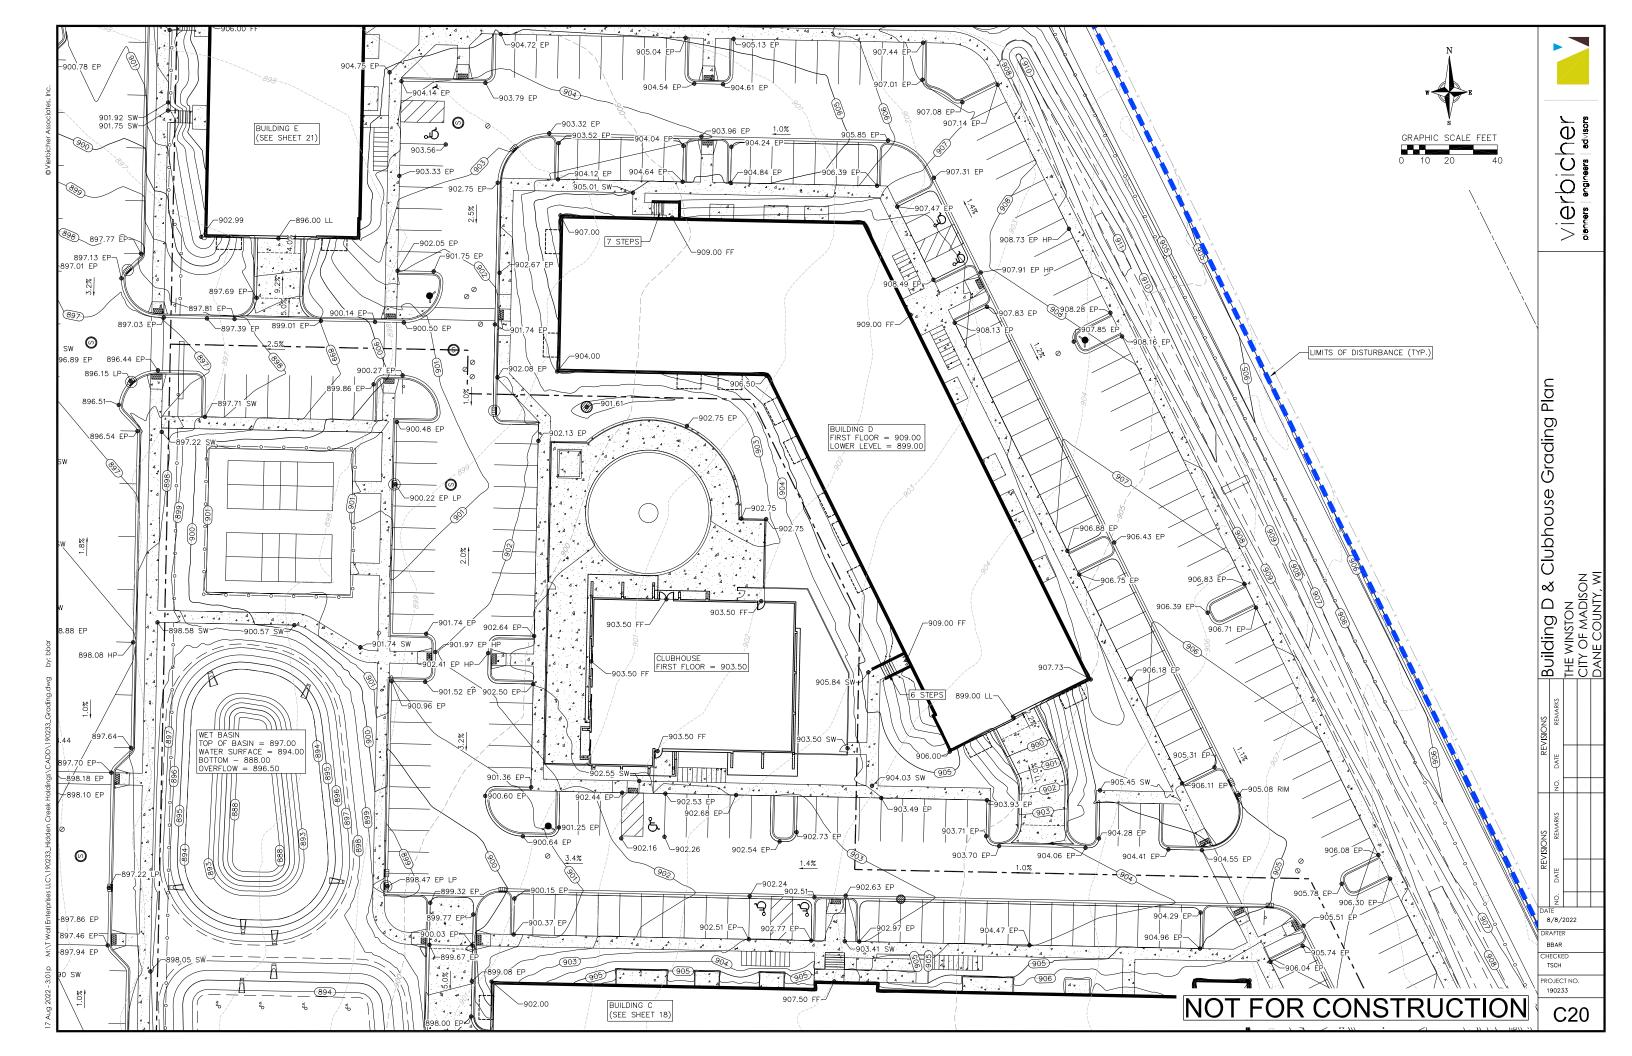


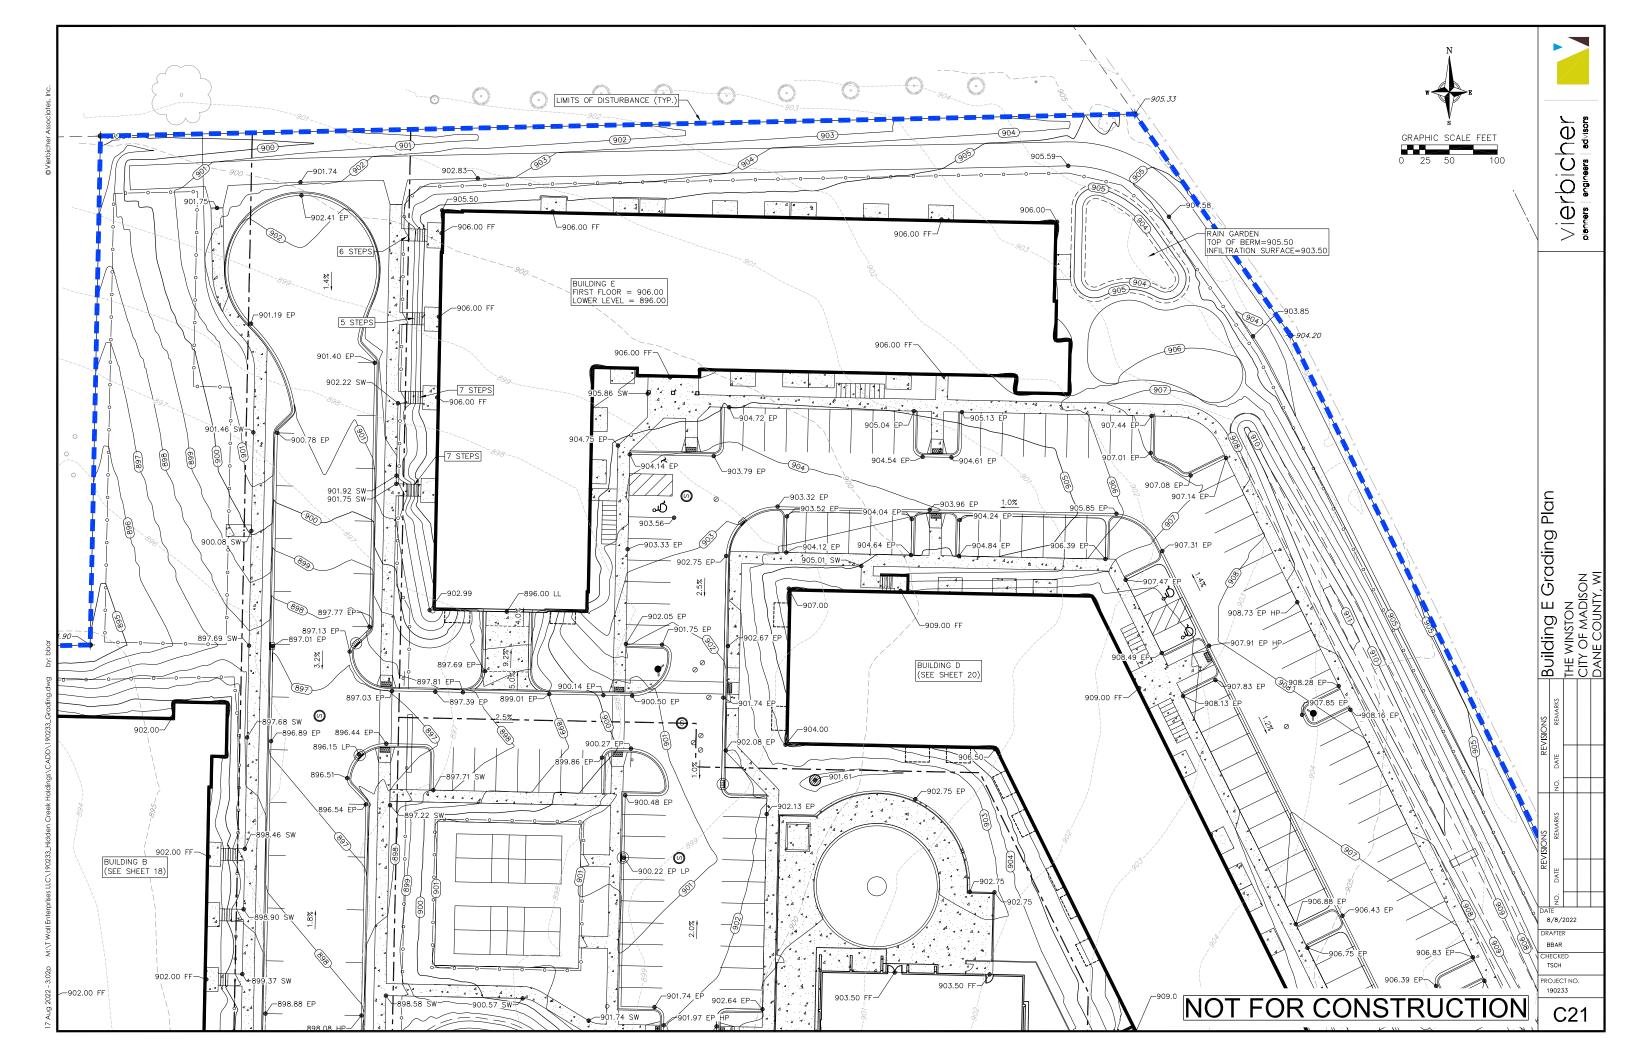

EROSION CONTROL MEASURES

- 1. EROSION CONTROL SHALL BE IN ACCORDANCE WITH THE CITY & COUNTY EROSION CONTROL ORDINANCE AND
- CONSTRUCT AND MAINTAIN ALL EROSION AND SEDIMENT CONTROL MEASURES IN ACCORDANCE WITH WISCONSIN DNR TECHNICAL STANDARDS (http://dnr.wi.gov/runoff/stormwater/techstds.htm) AND WISCONSIN CONSTRUCTION SITE BEST MANAGEMENT PRACTICE HANDBOOK
- 3. INSTALL SEDIMENT CONTROL PRACTICES (TRACKING PAD, PERIMETER SILT FENCE, SEDIMENT BASINS, ETC.)
 PRIOR TO INITIATING OTHER LAND DISTURBING CONSTRUCTION ACTIVITIES.
- THE CONTRACTOR IS REQUIRED TO MAKE EROSION CONTROL INSPECTIONS AT THE END OF EACH WEEK AND WHEN 0.5 INCHES OF RAIN FALLS WITHIN 24 HOURS. INSPECTION REPORTS SHALL BE PREPARED AND FILED AS REQUIRED BY THE DNR AND/OR COUNTY. ALL MAINTENANCE WILL FOLLOW AN INSPECTION WITHIN
- EROSION CONTROL IS THE RESPONSIBILITY OF THE CONTRACTOR UNTIL ACCEPTANCE OF THIS PROJECT. EROSION CONTROL MEASURES AS SHOWN SHALL BE THE MINIMUM PRECAUTIONS THAT WILL BE ALLOWED. ADDITIONAL EROSION CONTROL MEASURES, AS REQUESTED IN WRITING BY THE STATE OR LOCAL INSPECTORS, OR THE DEVELOPER'S ENGINEER, SHALL BE INSTALLED WITHIN 24 HOURS.
- A 3" CLEAR STONE TRACKING PAD SHALL BE INSTALLED AT THE END OF ROAD CONSTRUCTION LIMITS TO PREVENT SEDIMENT FROM BEING TRACKED ONTO THE ADJACENT PAVED PUBLIC ROADWAY. SEDIMENT TRACKING PAD SHALL CONFORM TO WISDNR TECHNICAL STANDARD 1057. SEDIMENT REACHING THE PUBLIC ROAD SHALL BE REMOVED BY STREET CLEANING (NOT HYDRAULIC FLUSHING) BEFORE THE END OF EACH WORK DAY.
- 7. CHANNELIZED RUNOFF: FROM ADJACENT AREAS PASSING THROUGH THE SITE SHALL BE DIVERTED AROUND
- 8. <u>STABILIZED DISTURBED GROUND:</u> ANY SOIL OR DIRT PILES WHICH WILL REMAIN IN EXISTENCE FOR MORE THAN 7-CONSECUTIVE DAYS, WHETHER TO BE WORKED DURING THAT PERIOD OR NOT, SHALL NOT BE LOCATED WITHIN 25-FEET OF ANY ROADWAY, PARKING LOT, PAVED AREA, OR DRAINAGE STRUCTURE OR CHANNEL (UNLESS INTENDED TO BE USED AS PART OF THE EROSION CONTROL MEASURES). TEMPORARY STABILIZATION AND CONTROL MEASURES (SEEDING, MULCHING, TARPING, EROSION MATTING, BARRIER FENCING, ETC.) ARE REQUIRED FOR THE PROTECTION OF DISTURBED AREAS AND SOIL PILES, WHICH WILL REMAIN UN-WORKED FOR A PERIOD OF MORE THAN 7-CONSECUTIVE CALENDAR DAYS. THESE MEASURES SHALL REMAIN IN PLACE UNTIL SITE HAS STABILIZED.
- SITE DE-WATERING: WATER PUMPED FROM THE SITE SHALL BE TREATED BY TEMPORARY SEDIMENTATION BASINS OR OTHER APPROPRIATE CONTROL MEASURES. SEDIMENTATION BASINS SHALL HAVE A DEPTH OF AT LEAST 3 FEET, BE SURROUNDED BY SNOWFENCE OR EQUIVALENT BARRIER AND HAVE SUFFICIENT SURFACE AREA TO PROVIDE A SURFACE SETTLING RATE OF NO MORE THAN 750 GALLONS PER SQUARE FOOT PER DAY AT THE HIGHEST DEWATERING PUMPING RATE. WATER MAY NOT BE DISCHARGED IN A MANNER THAT CAUSES EROSION OF THE SITE, A NEIGHBORING SITE, OR THE BED OR BANKS OF THE RECEIVING WATER. POLYMERS MAY BE USED AS DIRECTED BY DNR TECHNICAL STANDARD 1061 (DE-WATERING).
- 10. WASHED STONE WEEPERS OR TEMPORARY EARTH BERMS SHALL BE BUILT PER PLAN BY CONTRACTOR TO TRAP SEDIMENT OR SLOW THE VELOCITY OF STORM WATER.
- 11. SEE DETAIL SHEETS FOR RIP-RAP SIZING. IN NO CASE WILL RIP-RAP BE SMALLER THAN 3" TO 6".
- 12. INLET FILTERS ARE TO BE PLACED IN STORMWATER INLET STRUCTURES AS SOON AS THEY ARE INSTALLED. ALL PROJECT AREA STORM INLETS NEED WISCONSIN D.O.T. TYPE D INLET PROTECTION. THE FILTERS SHALL BE MAINTAINED UNTIL THE TOWN HAS ACCEPTED THE BINDER COURSE OF ASPHALT.
- 13. USE DETENTION BASINS AS SEDIMENT BASINS DURING CONSTRUCTION (DO NOT USE INFILTRATION AREAS). AT THE END OF CONSTRUCTION, REMOVE SEDIMENT AND RESTORE PER PLAN.
- 14. RESTORATION (SEED, FERTILIZE AND MULCH) SHALL BE PER SPECIFICATIONS ON THIS SHEET UNLESS SPECIAL RESTORATION IS CALLED FOR ON THE LANDSCAPE PLAN OR THE DETENTION BASIN DETAIL SHEET.
- 15. TERRACES SHALL BE RESTORED WITH 6" TOPSOIL, PERMANENT SEED, FERTILIZER AND MULCH. LOTS SHALL BE RESTORED WITH 6" TOPSOIL, TEMPORARY SEED, FERTILIZER AND MULCH.
- 16. AFTER DETENTION BASIN GRADING IS COMPLETE, THE BOTTOM OF DRY BASINS SHALL RECEIVE 6" TOPSOIL AND SHALL BE CHISEL-PLOWED TO A MINIMUM DEPTH OF 12" PRIOR TO RESTORATION.
- 17. SEED, FERTILIZER AND MULCH SHALL BE APPLIED WITHIN 7 DAYS AFTER FINAL GRADE HAS BEEN ESTABLISHED. IF DISTURBED AREAS WILL NOT BE RESTORED IMMEDIATELY AFTER ROUGH GRADING,
- 18. FOR THE FIRST SIX WEEKS AFTER RESTORATION (E.G. SEED & MULCH, EROSION MAT, SOD) OF A DISTURBED AREA, INCLUDE SUMMER WATERING PROVISIONS OF ALL NEWLY SEEDED AND MULCHED AREAS WHENEVER 7 DAYS ELAPSE WITHOUT A RAIN EVENT.
- 19. CHANNEL EROSION MAT (CLASS I, TYPE B URBAN PER WISCONSIN D.O.T. P.A.L.) SHALL BE INSTALLED ON THE BOTTOM (INVERT) OF ROADSIDE DITCHES/SWALES AS SHOWN ON THIS PLAN, 1 ROLL WIDTH.
- 20. SILT FENCE OR EROSION MAT SHALL BE INSTALLED ALONG THE CONTOURS AT 100 FOOT INTERVALS DOWN THE SLOPE ON THE DISTURBED SLOPES STEEPER THAN 5% AND MORE THAN 100 FEET LONG THAT SHEET FLOW TO THE ROADWAY UNLESS SOIL STABILIZERS ARE USED.
- 21. SILT FENCE TO BE USED ACROSS AREAS OF THE LOT THAT SLOPE TOWARDS A PUBLIC STREET OR WATERWAY. SEE DETAILS.
- 22. SEDIMENT SHALL BE CLEANED FROM STREETS AND ROADSIDE DITCHES AFTER EACH RAINFALL AND PRIOR TO PROJECT ACCEPTANCE.
- 23. ACCUMULATED CONSTRUCTION SEDIMENT SHALL BE REMOVED FROM ALL PERMANENT BASINS TO THE ELEVATION SHOWN ON THE GRADING PLAN FOLLOWING THE STABILIZATION OF DRAINAGE AREAS.
- 24. ALL CONSTRUCTION ENTRANCES SHALL HAVE TEMPORARY ROAD CLOSED SIGNS THAT WILL BE IN PLACE WHEN THE ENTRANCE IS NOT IN USE AND AT THE END OF EACH DAY.
- 25. ANY PROPOSED CHANGES TO THE EROSION CONTROL PLAN MUST BE SUBMITTED AND APPROVED BY DANE
- 26. THE COUNTY, OWNER AND/OR ENGINEER MAY REQUIRE ADDITIONAL EROSION CONTROL MEASURES AT ANY TIME DURING CONSTRUCTION.

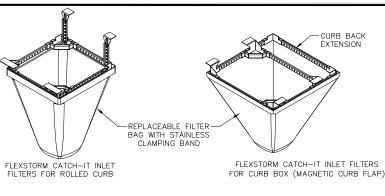

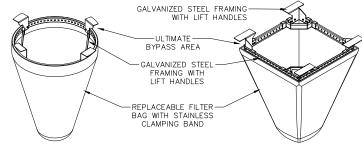


FLEXSTORM CATCH-IT INLET FILTERS FOR ROUND OPENINGS FLEXSTORM CATCH—IT INLET FILTERS FOR SQUARE/RECTANGULAR OPENINGS

- 1. INLET PROTECTION DEVICES SHALL BE MAINTAINED OR REPLACED AT THE DIRECTION OF THE ENGINEER
- WHEN REMOVING OR MAINTAINING INLET PROTECTION, ANY TRAPPED MATERIAL THAT FALLS INTO THE INLET SHALL BE IMMEDIATELY REMOVED BY THE CONTRACTOR.



FRAMED INLET PROTECTION

NOT TO SCALE

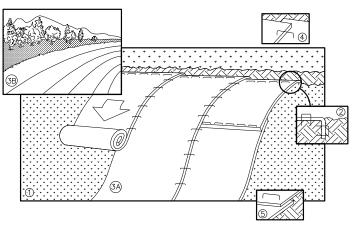

NOTE: REFER TO GENERAL STAPLE PATTERN GUIDE FOR CORRECT STAPLE PATTERN RECOMMENDATIONS FOR SLOPE INSTALLATIONS.


- PREPARE SOIL BEFORE INSTALLING BLANKETS, INCLUDING APPLICATION OF FERTILIZER AND SEED. NOTE: WHEN USING CELL—O—SEED, DO NOT SEED PREPARED AREA CELL—O—SEED MUST BE INSTALLED WITH PAPER SIDE DOWN.
- BEGIN AT THE TOP OF THE SLOPE BY ANCHORING THE BLANKET IN 6" DEEP BY 6" WIDE TRENCH. BACKFILL AND COMPACT THE TRENCH AFTER STAPLING.
 ROLL THE BLANKETS <A.> DOWN, OR <B.> HORIZONTALLY ACROSS THE SLOPE.
 THE EDGES OF PARALLEL BLANKETS MUST BE STAPLED WITH APPROXIMATELY.
- 5. WHEN BLANKETS MUST BE SPLICED DOWN THE SLOPE, PLACE BLANKETS END OVER END (SHINGLE STYLE) WITH APPROXIMATELY 4" OVERLAP. STAPLE
- THROUGH OVERLAPPED AREA, APPROXIMATELY 12" APART.
 ALL BLANKETS MUST BE SECURELY FASTENED TO THE SLOPE BY PLACING STAPLES/STAKES IN APPROPRIATE LOCATIONS AS RECOMMENDED BY THE




EROSION MAT

CONSTRUCTION SEQUENCE:

- 1. INSTALL SILT FENCE AND TRACKING PAD
- 2. STRIP TOPSOIL-DETENTION BASINS
- 3. ROUGH GRADE DETENTION BASINS
- 4. SEED DETENTION BASINS
- 5. STRIP TOPSOIL-STREETS & LOTS
- 6. ROUGH GRADE STREETS & LOTS
- 8. CONSTRUCT UNDERGROUND UTILITIES
- 9. INSTALL INLET PROTECTION
- 10. CONSTRUCT ROADS (STONE BASE, CURB & GUTTER, AND SIDEWALK).
- 11. RESTORE TERRACES
- 12. REMOVE TRACKING PAD, AND SILT FENCE AFTER DISTURBED AREAS ARE RESTORED

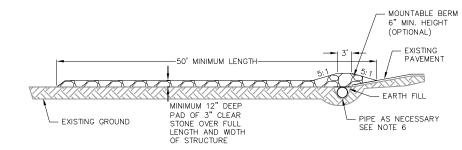

PROFILE VIEW

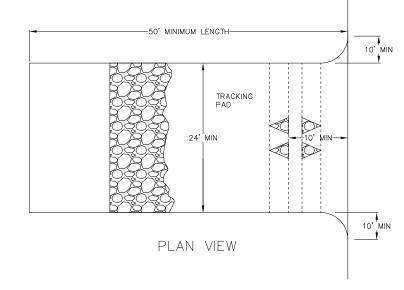

- 1. FOLLOW WISCONSIN DNR TECHNICAL STANDARD 1057 FOR FURTHER DETAILS AND INSTALLATION.
- LENGTH MINIMUM OF 50
- 3. WIDTH 24' MINIMUM, SHOULD BE FLARED AT THE EXISTING ROAD TO PROVIDE A TURNING RADIUS.
- 4. ON SITES WITH A HIGH GROUND WATER TABLE OR WHERE SATURATED CONDITIONS EXIST, GEOTEXTILE FABRIC SHALL BE PLACED OVER EXISTING GROUND PRIOR TO PLACING STONE, FABRIC SHALL BE WISDOT TYPE—HR GEOTEXTILE FABRIC.
- 5. STONE CRUSHED 3" CLEAR STONE SHALL BE PLACED AT LEAST 12" DEEP OVER THE ENTIRE LENGTH
- 6. SURFACE WATER ALL SURFACE WATER FLOWING TO OR DIVERTED TOWARDS CONSTRUCTION ENTRANCES SHALL BE PIPED THROUGH THE ENTRANCE. MAINTAINING POSITIVE DRAINAGE. PIPE INSTALLED THROUGH THE STABILIZED CONSTRUCTION ENTRANCE SHALL BE PROTECTED WITH A MOUNTABLE BERM WITH 5:1 SLOPES AND MINIMIUM OF 6" STONE OVER THE PIPE. PIPE SHALL BE SIZED ACCORDING TO THE DRAINAGE REQUIREMENTS. WHEN THE ENTRANCE IS LOCATED AT A HIGH SPOT AND HAS NO DRAINAGE TO CONVEY A PIPE SHALL NOT BE NECESSARY. THE MINIMUM PIPE DIAMETER SHALL BE 6". CONTRACTOR SHALL BE RESPONSIBLE FOR THE MAINTENANCE OF SAID PIPE.
- 7. LOCATION A STABILIZED CONSTRUCTION ENTRANCE SHALL BE LOCATED WHERE CONSTRUCTION TRAFFIC ENTERS AND/OR LEAVES THE CONSTRUCTION SITE. VEHICLES LEAVING THE SITE MUST TRAVEL OVER THE ENTIRE LENGTH OF THE TRACKING PAD.



TRACKING PAD

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NOT FOR CONSTRUCTION

Details Φ

8/8/2022

RO IECT NO 190233

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TEMPORARY:

- ILMPORARI.

 1. USE ANNUAL OATS AT 3.0 LB./1,000 S.F. FOR SPRING AND SUMMER PLANTINGS.

 2. USE WHITER WHEAT OR RYE AT 3.0 LB./1,000 SF FOR FALL PLANTINGS STARTED

AFTER SEPTEMBER 15.

PERMANENT:
1. USE WISCONSIN D.O.T. SEED MIX #40 AT 2 LB./1,000 S.F.


FERTILIZING RATES:


IEMPORARY AND PERMANENT: USE WISCONSIN D.O.T. TYPE A OR B AT 7 LB./1,000 S.F.

MULCHING RATES:


TEMPORARY AND PERMANENT:

USE ½" TO 1-½" STRAW OR HAY MULCH, CRIMPED PER SECTION 607.3.2.3, OR OTHER RATE AND METHOD PER SECTION 627, WISCONSIN D.O.T. STANDARD SPECIFICATIONS FOR HIGHWAY AND STRUCTURE CONSTRUCTION

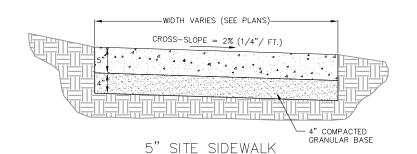

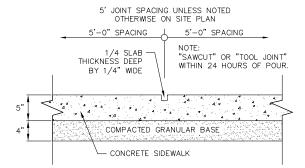


SIDEWALK CONTROL JOINT

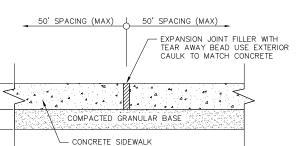

SIDEWALK EXPANSION JOINT

'SIDEWALK NOT TO SCALE

NOT FOR CONSTRUCTION

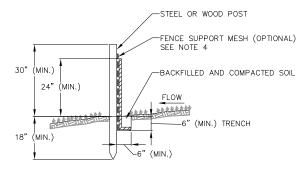


- 1. INSTALL SILT FENCE TO FOLLOW THE GROUND CONTOURS AS CLOSELY AS
- CURVE THE SILT FENCE UP THE SLOPE TO PREVENT WATER FROM RUNNING AROUND THE ENDS.
- 3. POST SPACING WITH FENCE SUPPORT MESH = 10 FT. (MAX.)


POST SPACING WITHOUT FENCE SUPPORT MESH = 6 FT. (MAX.)

4. SILT FENCE SUPPORT MESH CONSISTS OF 14-GAUGE STEEL WIRE WITH A MESH SPACING OF 6 IN. X 6 IN. OR PREFABRICATED POLYMERIC MESH OF EQUIVALENT STRENGTH




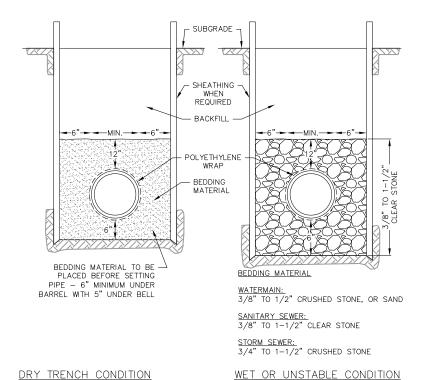




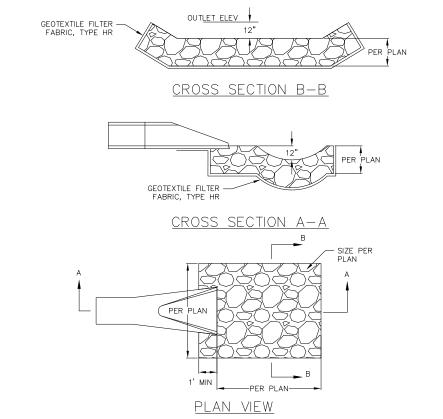



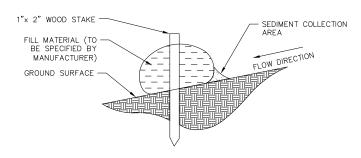



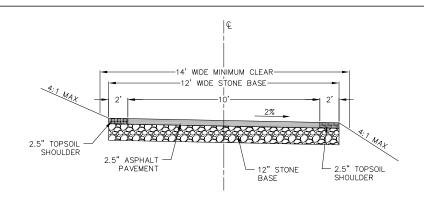



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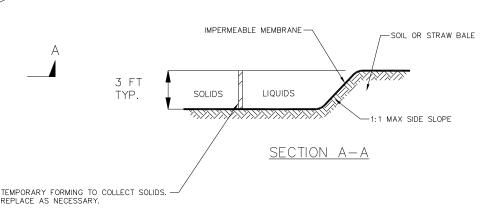
190233

8/8/2022 BBAR

PROJECT NO 190233

C24

- 1.LOCATE WASHOUT STRUCTURE A MINIMUM OF 50 FEET AWAY FROM OPEN CHANNELS, STORM DRAIN INLETS, SENSITIVE AREAS, WETLANDS, BUFFERS AND WATER COURSES AND AWAY FROM CONSTRUCTION TRAFFIC.
- 2.PREPARE SOIL BASE FREE OF ROCKS OR OTHER DEBRIS THAT MAY CAUSE TEARS OR HOLES IN THE LINER. FOR LINER, USE 10 MIL OR THICKER UV RESISTANT, IMPERMEABLE SHEETING, FREE OF HOLES AND TEARS OR OTHER DEFECTS THAT COMPROMISE IMPERMEABILITY OF THE MATERIAL.
- 3.KEEP CONCRETE WASHOUT STRUCTURE WATER TIGHT. REPLACE IMPERMEABLE LINER IF DAMAGED (E.G., RIPPED OR PUNCTURED). EMPTY OR REPLACE WASHOUT STRUCTURE THAT IS 75 PERCENT FULL, AND DISPOSE OF ACCUMULATED MATERIAL PROPERLY. DO NOT REUSE PLASTIC LINER. WEIT—VACUUM STORED LIQUIDS THAT HAVE NOT EVAPORATED AND DISPOSE OF IN AN APPROVED MANNER. REMOVE HARDENED SOLIDS, WHOLE OR BROKEN UP, FOR DISPOSAL OR RECYCLING. MAINTAIN RUNOFF DIVERSION AROUND EXCAVATED WASHOUT STRUCTURE UNTIL STRUCTURE IS REMOVED.





TEMPORARY CONCRETE WASHOUT NOT TO SCALE

REPLACE AS NECESSARY.

IMPERMEABLE MEMBRANE THROUGHOUT

EVAPORATION BASIN FOR LIQUIDS

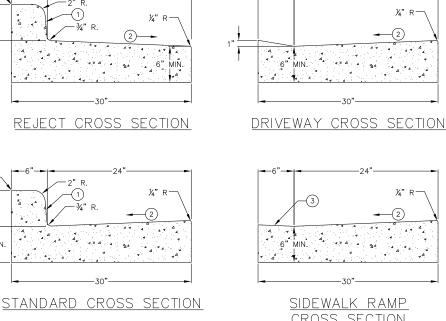

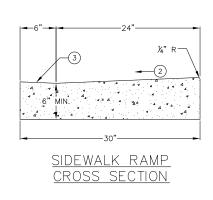

- 1.) BATTER FACE OF CURB 1/2".
- (2) USE 4% GUTTER CROSS SLOPE UNLESS OTHERWISE NOTED IN THE PLANS.

8 FT


PLAN


BASIN FOR SOLIDS-


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(3) USE 4% SLOPE UNLESS OTHERWISE NOTED. GRADE CHANGE BETWEEN GUTTER FLAG SLOPE AND THE CURB RAMP SLOPE SHALL NOT EXCEED 11% MAXIMUM.





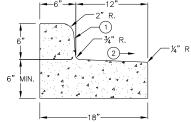

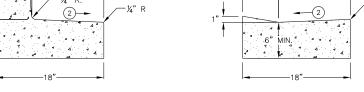

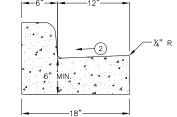
SIDEWALK RAMP


CROSS SECTION

DRIVEWAY CROSS SECTION

STANDARD CROSS SECTION

- 1.) BATTER FACE OF CURB 1/2".
- $\widehat{\mbox{2.}}$ USE 4% GUTTER CROSS SLOPE UNLESS OTHERWISE NOTED IN THE PLANS.
- (3) USE 4% SLOPE UNLESS OTHERWISE NOTED. GRADE CHANGE BETWEEN GUTTER FLAG SLOPE AND THE CURB RAMP SLOPE SHALL NOT EXCEED 11% MAXIMUM.

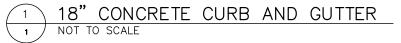

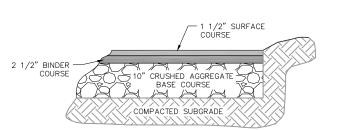

BITUMINOUS PAVEMENT DRIVES

CURBED SIDEWALK SITE DETAIL

-VARIES (5' TYP.)-

5" CONCRETE

4" GRANULAR


BASE

ASPHALT PAVEMENT

CRUSHED AGGREGATE

BASE COURSE

NOT TO SCALE

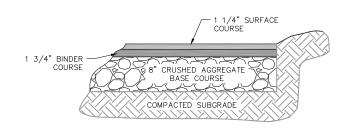

BITUMINOUS PAVEMENT PARKING LOT

SITE PAVEMENT NOT TO SCALE

NOT FOR CONSTRUCTION

SIDE VIEW

PIPE DIA. X=SETTING
INCHES INCHES 2 12 8 13 12 21

VALVES SHALL BE AMERICAN FLOW CONTROL'S SERIES 2500 DUCTILE IRON, RESILIENT WEDGE, OR EQUAL. VALVE BOXES SHALL CONFORM TO CHAPTER 8.29.0 OF THE STANDARD SPECIFICATIONS FOR SEWER AND WATER CONSTRUCTION IN WISCONSIN, SIXTH EDITION, SPECIFIED FOR 7-FOOT BURY (OR AS REQUIRED FOR VARYING DEPTHS), AND INCLUDE A VALVE BOX ADAPTOR, ADAPTOR INC, OR EQUAL. VALVE BOX COVER SHALL BE MARKED "WATER."

FRONT VIEW

ENCASE VALVE IN POLYETHYLENE WRAI

(NOT REQUIRED)

8"x8"x16" MINIMUM SOLID

STANDARD GATE VALVE BOX SETTING

NOT TO SCALE

MANHOLE CASTING: NEENAH R-1550 W/ TYPE "B" LID. SELF SEALING FOR SANITARY, NON-ROCKING FOR STORM.

ADJUST FRAME WITH A MINIMUM OF 2 ADJOST FRAME WITH A MINIMOM OF 2 PRECAST CONCRETE RINGS OF VARIABLE THICKNESS, 2" MIN. TO 6" MAX. CONCRETE RINGS SHALL BE REINFORCED WITH ONE LINE OF STEEL CENTERED WITHIN THE RING WHERE NECESSARY, RINGS SHALL BE GROOVED TO RECEIVE STEP.

CONCRETE AND STEEL REINFORCEMENT SHALL CONFORM TO ASTM C478.

JOINTS SHALL BE WATERTIGHT: RUBBER GASKETS OR FLEXIBLE BUTYL RUBBER GASKETS/ROPE.

INSTALLED STEPS SHALL WITHSTAND A HORIZONTAL PULLOUT LOAD OF 400 POUNDS WITH THE LOAD APPLIED OVER A WIDTH OF 3-1/2" AND CENTERED ON THE RUNG.

STEPS SHALL BE EQUALLY SPACED VERTICALLY N THE ASSEMBLED MANHOLE AT A MAXIMUM DISTANCE OF 16" ON CENTER.

STEPS SHALL BE GRAY CAST IRON OR FABRICATED OF 1/2" DIA. GRADE 60 STEEL REINFORCING ROD WITH MOLDED PLASTIC COVERING.

SEAL FOR ALL FLEXIBLE SEWER CONNECTIONS. FILL SPACE BETWEEN PIPE AND MANHOLE BARREL WITH GROUT. LIFT HOLES SHALL BE FILLED WITH NON-SHRINK GROUT.

STORM MANHOLE - 1" PER FOOT SANITARY MANHOLE - 2" PER FOOT

PRECAST CONCRETE MANHOLE

NOT TO SCALE

6" INTEGRAL

BASE

48" UNLESS


OTHERWISE INDICATED

GRADE TO BE FLUSH WITH WALK WHERE APPROPRIATE HANDICAPPED SIGN PER ADA REQUIREMENTS CONCRETE CURB 18, SITE Ğ VAN-ACCESS PARKING SPACE 4" WIDE YELLOW TWO COATS

HANDICAP STRIPING

NOT TO SCALE


12" MAX

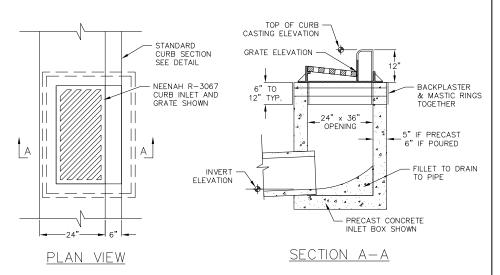

- TOP OF CURB AND PIPE INVERT ELEVATIONS ARE SHOWN ON THE PLANS.

- THE GRATE ELEVATION SHALL BE DEPRESSED 0.1' FROM STRAIGHT GUTTER GRADE STARTING 5' FROM THE INLET AND EXTENDING IN BOTH DIRECTIONS.
- THE CASTING SHALL BE NEENAH FOUNDRY R-3067 CURB INLET WITH REVERSIBLE GRATES WHERE RUNOFF REACHES THE INLET FROM BOTH DIRECTIONS. WHERE RUNOFF REACHES THE INLET FROM ONE DIRECTION A NEENAH R-3067-L CASTING SHALL BE USED. DIRECTIONAL SLOTS TO BE LOCATED TO DIRECT THE FLOW
- FRAME ADJUSTING RINGS SHALL BE AT LEAST TWO CONCRETE RINGS OF VARIABLE THICKNESS. MASTIC BETWEEN RINGHS AND BACKPLASTER A SMOOTH LAYER OF GROUT OVER THE ENTIRE INNER AND OUTER SURFACES OF THE RINGS.
- INLETS WITH SUMPS REQUIRE A 4" DIA HOLE IN THE CENTER OF THE BOTTOM FLOOR ON THE STRUCTURE

RECTANGULAR STREET INLET

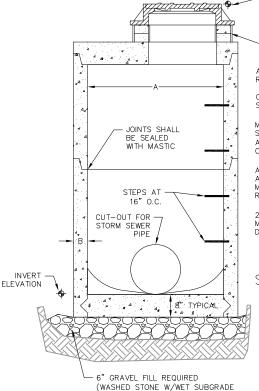

CASTING SHALL BE $\mbox{\ensuremath{\mathcal{U}}}$ " TO $\mbox{\ensuremath{\mathcal{U}}}$ " MAX BELOW FINISHED PAVEMENT OR AS ESTABLISHED BY THE ENGINEER

- HDPE ADJUSTING RINGS

ADJUST FRAME TO GRADE WITH AT LEAST TWO HDPE RINGS OF DIFFERENT THICKNESSES.

CONCRETE SHALL BE 4000 PSI, 28 DAY COMPRESSIVE STRENGTH, 6.5 BAG MIX WITH $1{\sim}2\%$ AIR ENTRAINMENT.

MANHOLE STEPS SHALL CONFORM TO ASTM-C478 & SHALL BE NEENAH FOUNDRY CO. R-1981-N OR APPROVED EQUAL. STEPS SHALL BE SPACED 16" ON

A MINIMUM OF 4" TO A MAXIMUM OF 12" OF ADJUSTING RINGS SHALL BE USED TO ADJUST THE MANHOLE CASTING TO THE FINISHED GRADE. ALL RINGS SHALL BE SEALED TOGETHER.

 $2{\it x3}$ opening is required for storm inlet manholes with casting and rings as specified in detail 02721—A.

STORM MANHOLE DIMENSIONS


MANHOLE	DIME	NSION
SIZE	Α	B (MIN.)
48"	48"	5"
60"	60"	6"
72"	72"	7"
84"	84"	7"
96"	96"	9"

STORM SEWER MANHOLE NOT TO SCALE

SIGNAGE NOTES:

- ALL SIGNS SHALL BE FABRICATED AND INSTALLED IN ACCORDANCE WITH THE MANUAL ON UNIFORM TRAFFIC CONTROL DEVICES.
- 2. SIGNS SHALL BE A DISTANCE OF 7' FROM GROUND LEVEL TO THE BOTTOM OF THE SIGN MOUNTED ON THE POST AND LOCATED 3' BEHIND THE BACK OF CURB.

 3. STREET NAME SIGNS SHALL HAVE WHITE LETTERS AND GREEN BACKGROUND
- 4. SIGN POSTS SHALL BE 2-3/8" O.D., GALVANIZED 10 FT LONG, 13 GAUGE, AND 0.095 WALL THICKNESS. MOUNT SIGN AT TOP OF THE POST, AND INSTALL POSTS 3' DEEP AND MIX 1/2 BAG OF 80 LB SAKRETE CONCRETE, POURING IT AROUND THE POST BELOW THE GROUND BEFORE COVERING WITH 8" OF TOPSOIL

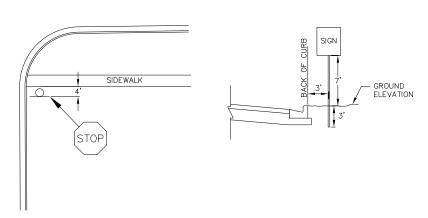

STOP SIGN NOT TO SCALE

NOT FOR CONSTRUCTION

THE WINSTON CITY OF MADISON DANE COUNTY, WI Details Site 8/8/2022 BBAR PRO IECT NO 190233

VIELDICK

C25

" OR WASHED USDA COARSE SAND - .02"-.04"

RAIN GARDEN AREA RESTORATION SPECIFICATIONS

NOTE: RAIN GARDEN AREA MUST NOT BE CONSTRUCTED (INSTALLED) UNTIL THE SITE IS STABILIZED, I.E. THE GRASS COVER IS WELL ESTABLISHED.

RAIN GARDEN AREA MUST CONFORM TO WISCONSIN DNR TECHNICAL STANDARD 1009 (RAIN GARDEN)

USE RAINWATER SEED MIX FROM AGRECOL (SUNNY, SHORT, OR MEDIUM STATURE), OR OTHER QUALITY, DEEP-ROOTED SEED MIX FROM A LICENSED LOCAL NURSERY, AS APPROVED BY ENGINEER OR OWNER.

PLANTING, MULCH, AND MAINTENANCE NOTES:
PLANTING SHOULD TAKE PLACE BETWEEN AVAILABILITY OF PLANTS IN SPRING AND JUNE 30TH, OR BETWEEN
SEPTEMBER 1ST AND OCTOBER 15TH. IF PLANTED JULY 1ST THROUGH AUGUST 31ST, HEAVILY WATER THE PLANTS AT
THE TIME THEY ARE PLANTED, AND EVERY OTHER DAY FOR A TOTAL OF 4 WATERINGS. A RAIN EVENT GREATER THAN
0.5 INCHES CONSTITUTES A WATERING. IF PLANTED SEPTEMBER 1ST THROUGH OCTOBER 15TH, PLACE CERTIFIED WEED-FREE STRAW MULCH AT 3" MINIMUM THICKNESS BETWEEN PLANTS TO HELP PREVENT FROST HEAVE. IF PLANTING IS TO OCCUR AFTER OCTOBER 15TH, IT MUST BE POSTPONED UNTIL THE FOLLOWING SPRING (MAY). FOR THE FIRST 3 YEARS AFTER PLANTING, SPOT TREAT THE AREA WITH HERBICIDE TO REMOVE WEEDS.

RESTORATION OF THE INFILTRATION AREA (NOT INCLUDING SIDE SLOPES):

1. OVER-EXCAVATE THE AREA TO INFILTRATIVE LAYER TO BE DETERMINED IN THE

FIELD, DURING EXCAVATION BY DESIGN ENGINEER

CHISEL PLOW, OR ROTO-TILL THE BASE OF THE AREA TO BREAK UP ANY HARDPAN IN THE NATIVE SOIL LAYER PLACE WASHED SAND (FREE OF P200 PARTICLES) TO 46 INCHES BELOW GROUND PLACE 24 INCHES OF ENGINEERED SOIL, COMPRISED OF: SURFACE (IF REQUIRED).

70-85% WASHED SAND 15-30% COMPOST (MUST MEET WDNR S100 SPECIFICATION SEED, MULCH, WATER, AND MAINTAIN AS DIRECTED ABOVE.

> RAIN GARDEN NOT TO SCALE

BIORETENTION AREA SPECIFICATIONS:

1. BIORETENTION AREA MUST CONFORM TO WISCONSIN DNR

TECHNICAL STANDARD 1004 (BIORETENTION FOR INFILTRATION). HEAVY EQUIPMENT SHALL NOT BE ALLOWED ON AREA OF INFILTRATION DURING CONSTRUCTION OPERATIONS INFILTRATION INFILIRATION DURING CONSTRUCTION OPERATIONS. INFILIRATION AREA MUST NOT BE CONSTRUCTED (INSTALLED) UNTIL THE SITE IS STABILIZED, I.E. THE GRASS COVER IS WELL ESTABLISHED; OTHERWISE, CONSTRUCTION SITE RUNOFF FROM DISTURBED AREAS SHALL BE DIVERTED AWAY FROM BIORETENTION DEVICE. DO NOT ALLOW SURROUNDING SOILS TO ERODE INTO BASINS ONCE ENGINEERED SOIL AND PLANTINGS HAVE BEEN INSTALLED.

USE RAINWATER GARDEN LIVE NATIVE PLANT PLUGS FROM AGRECOL (SUNNY, SHORT, OR MEDIUM STATURE), OR OTHER QUALITY, DEEP-ROOTED PLANTS FROM A LICENSED LOCAL NURSERY, AS APPROVED BY ENGINEER OR OWNER. CONTRACTOR IS RESPONSIBLE FOR PREPARING VEGETATION

PLAN, ENSURING PLANT ESTABLISHMENT, INITIAL MAINTENANCE (SEE BELOW), AS WELL AS MAINTAINING PROPER INFILTRATION RATES OVER INFILTRATIVE SURFACE (I.E. NO PONDED WATER 24 HOURS AFTER RAIN EVENT) THROUGHOUT WARRANTY PERIOD AND ONE COMPLETE GROWING SEASON, OR UNTIL ACCEPTANCE BY THE OWNER (WHICHEVER IS SOONER).

RESTORATION AND INITIAL MAINTENANCE NOTES (DURING FIRST

GROWING SEASON): PLANTING IS RECOMMENDED TO TAKE PLACE BETWEEN AVAILABILITY OF PLANTS IN SPRING AND JUNE 30TH, OR BETWEEN SEPTEMBER 1ST AND OCTOBER 15TH. IF PLANTED JULY 1ST THROUGH AUGUST 31ST, HEAVILY WATER THE PLANTS AT THE TIME THEY ARE PLANTED. AND EVERY OTHER DAY FOR AT THE TIME THEY ARE PLANTED, AND EVENT OTHER DAY FOR A TOTAL OF 4 WATERINGS. A RAIN EVENT GREATER THAN 0.5 INCHES CONSTITUTES A WATERING. IF PLANTED SEPTEMBER 1ST THROUGH OCTOBER 15TH, PLACE CERTIFIED WEED-FREE STRAW MULCH AT 3" MINIMUM THICKNESS BETWEEN PLANTS TO HELP PREVENT FROST HEAVE. IF PLANTING IS TO OCCUR AFTER OCTOBER 15TH, IT SHOULD BE POSTPONED UNTIL THE

FOLLOWING SPRING (MAY). EROSION MAT CLASS II SHALL CONFORM TO THE CRITERIA LOCATED IN DNR TECHNICAL STANDARD 1052 (NON-CHANNEL EROSION MAT). DO NOT USE WOOD CHIPS, UNLESS EROSION MAT IS PLACED OVER TOP TO PREVENT FLOATING.

DO NOT FERTILIZE NATIVE PLANTINGS, UNLESS DIRECTED BY NURSERY

4. WATER PLANTS AS NECESSARY, DEPENDING ON WEATHER.
TREAT DISEASED OR DISTRESSED PLANTS, SPOT TREAT THE
AREA WITH HERBICIDE TO REMOVE WEEDS, REMOVE DEBRIS AND LITTER, AND INSPECT AND REPAIR ERODED AREAS, AS NEEDED.

> NOTE: TEST PITS SHALL BE COMPLETED BY A GEOTECHNICAL ENGINEER TO VERIFY NATIVE SOLS. IT IS ASSUMED THAT THE INFILTRATION RATE IS 0.5 INCHES/HOUR.

CLEANOUT/ 36" RISER PIPE-GRATE RIM=890.50 RIM=889.00 NOTE: OVERFILL BASIN BY 2" TO ALLOW FOR SOME SETTLING OF ENGINEERED SOIL PLANTINGS (RESTORATION NOTES) BOTTOM OF BIO-RETENTION BASIN ELEVATION=889.00 ENGINEERED SOIL MIXTURE 70%-85% WASHED SAND 15%-30% COMPOST (MUST MFFT WDNR S100 SPECIFICATION) 6" PERFORATED UNDERDRAIN 6" PERFORATED UNDERDRAIN EMBEDDED IN 6" PEA GRAVEL GRANULAR STORAGE LAYER I.E.=886.50 GRANULAR STORAGE - LASSUMED NATIVE SOILS ARE SANDY LOAM (0.50 IN/HR) BOTTOM EL=883.00 (AS APPROVED BY GEOTECHNICAL ENGINEER) SOILS OVER EXCAVATE TO EL=883.00*

*GRADATIONS SHOULD BE COLLECTED DURING CONSTRUCTION CHECK THAT THE TEXTURE OF THE BLENDED SOIL IS CONSISTANT WITH THE DESIGN INFILTRATION RATE OF 0.50 IN/HR.

SAND SHALL MEET ONE OF THE FOLLOWING GRADATION REQUIREMENTS:

• USDA COARSE SAND (0.02 - 0.04 INCHES)

ASTM C33 (FINE AGGREGATE CONCRETE SAND WISCONSIN STANDARDS AND SPECIFICATIONS FOR HIGHWAY AND STRUCTURE CONSTRUCTION, SECTION 501.2.5.3.4 (FINE AGGREGATE CONCRETE SAND) 2005 EQUIVALENT AS APPROVED BY THE ADMINISTERING AUTHORITY

GRAVEL SHALL MEET:

• COARSE AGGREGATE #2 AND OTHER SPECIFICATIONS OF WISCONSIN STANDARDS AND OTHER SPECIFICATIONS OF WISCONS OF SPECIFICATIONS FOR HIGHWAY AND STRUCTURE CONSTRUCTION, SECTION 501.2.5, 203 EDITION OR AN EQUIVALENT AS APPROVED BY THE ADMINISTERING AUTHORITY. GRAVEL SHALL BE DOUBLE-WASHED.

EMBANKMENT MATERIAL

CONSTRUCT WITH NON-ORGANIC SOILS, COMPACTED TO 90%
STANDARD PROCTOR PER ASTM D-698 PROCEDURES OR BY

USING USDA NRCS, WISCONSIN CONSTRUCTION SPECIFICATION

BIO-RETENTION BASIN NOT TO SCALE

CONSTRUCTION NOTES (NOT INCLUDING SIDESLOPES):

1. LIMIT CONSTRUCTION TRAFFIC IN EXCAVATION AND USE ONLY TRACKED VEHICLES.

SEE UTILITY PLAN-

12" STORM SEWER

EMERGENCY SPILLWAY-ELEVATION=892.00

TOP ELEV=892.50

EXCAVATE TO FINAL DEPTH DURING DRY
WEATHER AND HAVE ALL MATERIALS ON SITE TO COMPLETE CONSTRUCTION PRIOR TO FORECASTED

OVER-EXCAVATE THE AREA TO INFILTRATIVE LAYER REQUIRED PER DETAIL. NATIVE LAYER OF DEVICE TO BE VISUALLY INSPECTED BY DESIGN ENGINEER IN THE FIELD AFTER THE AREA IS

ENGINEER IN THE FIELD AFTER THE AREA IS EXCAVATED.

CHISEL PLOW, OR ROTO—TILL THE BASE OF THE AREA TO BREAK UP ANY HARDPAN IN THE NATIVE SOIL LAYER.

PLACE GRANULAR FILL, DEPTH AS REQUIRED BY

DETAIL, AND UNDERDRAIN COMPONENTS.
PLACE ENGINEERED SOIL IN MAXIMUM 12" LIFTS

(OVERFILL BY 2" TO ALLOW FOR SETTLING), COMPRISED OF: 70-85% WASHED SAND

15-30% COMPOST (PER DNR TECHNICAL STANDARD S100)

PLANT PLUGS, EROSION MAT, WATER, AND MAINTAIN AS DIRECTED ABOVE. LEAVE UNDERDRAIN DRAWDOWN OPEN UNTIL PLANT **ESTABLISHMENT**

LONG-TERM MAINTENANCE OF BIORETENTION AREA:

1. REFER TO DNR TECHNICAL STANDARD 1004

INCREASE EMBANKMENT HEIGHT BY 5% TO ACCOUNT FOR SETTLING. COVER WITH 6" MIN. TOPSOIL TOP WIDTH 36" RISER PIPE EMERGENCY SPILLWAY GRATE RIM=895.00 ELEVATION=896.50 -15" I.E. = 895.30 EMBANKMENT MATERIAL CONSTRUCT WITH NON-ORGANIC SOILS, COMPACTED TO 90% 6" ORIFICE I.E =894.00 TOP WIDTH STANDARD PROCTOR PER ASTM D-698 PROCEDURES OR BY USING USDA NRCS, WISCONSIN CONSTRUCTION SPECIFICATION 3. INCREASE EMBANKMENT HEIGHT TO ACCOUNT FOR SETTLING. CLEANOUT/ EMERGENCY SPILLWAY 15" I.E. = 895,40 DRAWDOWŃ NOTE: OVERFILL BASIN BY 2" TO ALLOW ELEVATION=896.80 RIM= 893.50 FLEV=897.50 15" STORM SEWER @ 0.50% FOR SOME SETTLING OF ENGINEERED SOIL COVER WITH 6" MIN. TOPSOIL. 12" I.E. = 894.00 PLANTINGS (RESTORATION NOTES) 10' SAFETY SHELF BOTTOM OF INFILTRATION BASIN 12" STORM SEWER @ 0.50% ELEVATION=893.50 12" I.E. = 893.85 FNGINFFRED SOI 893.00 893.00 BOTTOM FI = 893.0012" STORM SEWER NOTE: TEST PITS SHALL BE COMPLETED BY A GEOTECHNICAL ENGINEER TO VERIFY NATIVE SOLS. IT IS ASSUMED THAT THE ENGINEERED SOIL MIXTURE 70%-85% WASHED SAND 6" PERFORATED UNDERDRAIN @ 0.00% 6" UNDERDRAIN I.E =892.50 15%-30% COMPOST (MUST MEET WDNR S100 POND BOTTOM 4' GRANULAR STORAGE LAYER SPECIFICATION) SEE UTILITY PLAN-INFILTRATION RATE IS 0.5 INCHES/HOUR 888.00 BOTTOM ELEV. = 888.50 FOR I.E. NATIVE SOILS (AS APPROVED BY ENGINEER) NATIVE SOILS

INFILTRATION AREA MUST CONFORM TO WISCONSIN DNR TECHNICAL STANDARD 1003 (INFILTRATION BASIN).

HEAVY EQUIPMENT SHALL NOT BE ALLOWED ON AREA OF INFILTRATION DURING CONSTRUCTION OPERATIONS. INFILTRATION AREA MUST NOT BE CONSTRUCTED (INSTALLED) UNTIL THE SITE IS STABILIZED, I.E. THE GRASS COVER IS WELL ESTABLISHED; OTHERWISE, CONSTRUCTION SITE RUNOFF FROM DISTURBED AREAS SHALL BE DIVERTED AWAY FROM INFILTRATION DEVICE. DO NOT ALLOW SURROUNDING SOILS TO ERODE INTO BASINS ONCE ENGINEERED SOIL AND PLANTINGS HAVE BEEN INSTALLED.

NATIVE SEEDING -NATIVE VEGETATION SHALL BE ESTABLISHED IN CONFORMANCE WITH RECOMMENDATIONS FROM A QUALIFIED NATIVE NURSERY IN THE AREA. IF TREES ARE TO BE USED, SPECIES SHALL BE SELECTED THAT WILL NOT INTERFERE WITH THE FUNCTION OF THE BASIN, OR CAUSE MAINTENANCE

CONTRACTOR IS RESPONSIBLE FOR PREPARING VEGETATION PLAN, ENSURING PLANT ESTABLISHMENT, INITIAL MAINTENANCE (SEE BELOW), AS WELL AS MAINTAINING PROPER INFILTRATION RATES OVER INFILTRATIVE SURFACE (I.E. NO PONDED WATER 24 HOURS AFTER RAIN EVENT) THROUGHOUT WARRANTY PERIOD AND ONE COMPLETE GROWING SEASON, OR UNTIL ACCEPTANCE BY THE OWNER (WHICHEVER IS SOONER).

WET POND/INFILTRATION FACILITY CROSS-SECTION

RESTORATION AND INITIAL MAINTENANCE NOTES (DURING FIRST GROWING SEASON):

1. NATIVE (PRAIRIE) SEEDING SHALL BE COMPLETED IN THE FALL (AS DORMANT SEEDING PRIOR TO FIRST SNOWFALL) OR IN THE SPRING (BETWEEN MAY 1 AND JUNE 20), OR PLUGS SHALL BE USED.

2. FERTILIZER — SOIL TESTING SHALL BE USED TO DETERMINE PROPER APPLICATIONS FOR NUTRIENTS AND LIMING, FERTILIZER APPLICATION SHALL CONFORM TO THE CRITERIA LOCATED IN NRCS

CONSERVATION PRACTICE STANDARD, CRITICAL AREA PLANTING (342) OR WDNR TECHNICAL STANDARD SEEDING FOR CONSTRUCTION SITE EROSION CONTROL (1059).

3. MULCH OR EROSION MAT -MULCH SHALL CONFORM TO THE CRITERIA LOCATED IN WDNR TECHNICAL STANDARD MULCHING FOR CONSTRUCTION SITES (1058). EROSION MAT SHALL BE CLASS II AND PLACED ON THE SURFACE OF THE INFILTRATION AREA.

WATER AS NECESSARY, DEPENDING ON WEATHER RE-MULCH VOID AREAS, TREAT DISEASED OR DISTRESSED PLANTS, SPOT TREAT THE AREA WITH HERBICIDE TO REMOVE WEEDS, REMOVE DEBRIS AND LITTER, AND INSPECT AND REPAIR ERODED AREAS, AS NEEDED.

CONSTRUCTION NOTES (NOT INCLUDING SIDESLOPES):
1. OVER-EXCAVATE THE AREA TO INFILTRATIVE LAYER REQUIRED PER DETAIL. NATIVE LAYER OF DEVICE TO BE VISUALLY INSPECTED BY DESIGN ENGINEER IN THE FIELD AFTER THE AREA IS EXCAVATED.

CHISEL PLOW, OR ROTO-TILL THE BASE OF THE AREA TO BREAK UP ANY HARDPAN IN THE NATIVE SOIL LAYER

PLACE GRANULAR FILL, DEPTH AS REQUIRED BY DETAIL, AND UNDERDRAIN COMPONENTS.
PLACE ENGINEERED SOIL IN MAXIMUM 12" LIFTS (OVERFILL BY 2" TO ALLOW FOR SETTLING), COMPRISED OF:

70-85% WASHED SAND 15-30% COMPOST (PER DNR TECHNICAL STANDARD S100)

SEED, MULCH/EROSION MAT, WATER, AND MAINTAIN AS DIRECTED ABOVE. LEAVE UNDERDRAIN DRAWDOWN OPEN UNTIL PLANT ESTABLISHMEN

LONG-TERM MAINTENANCE OF INFILTRATION AREA:

1. REFER TO DNR TECHNICAL STANDARD 1003

NOT FOR CONSTRUCTION

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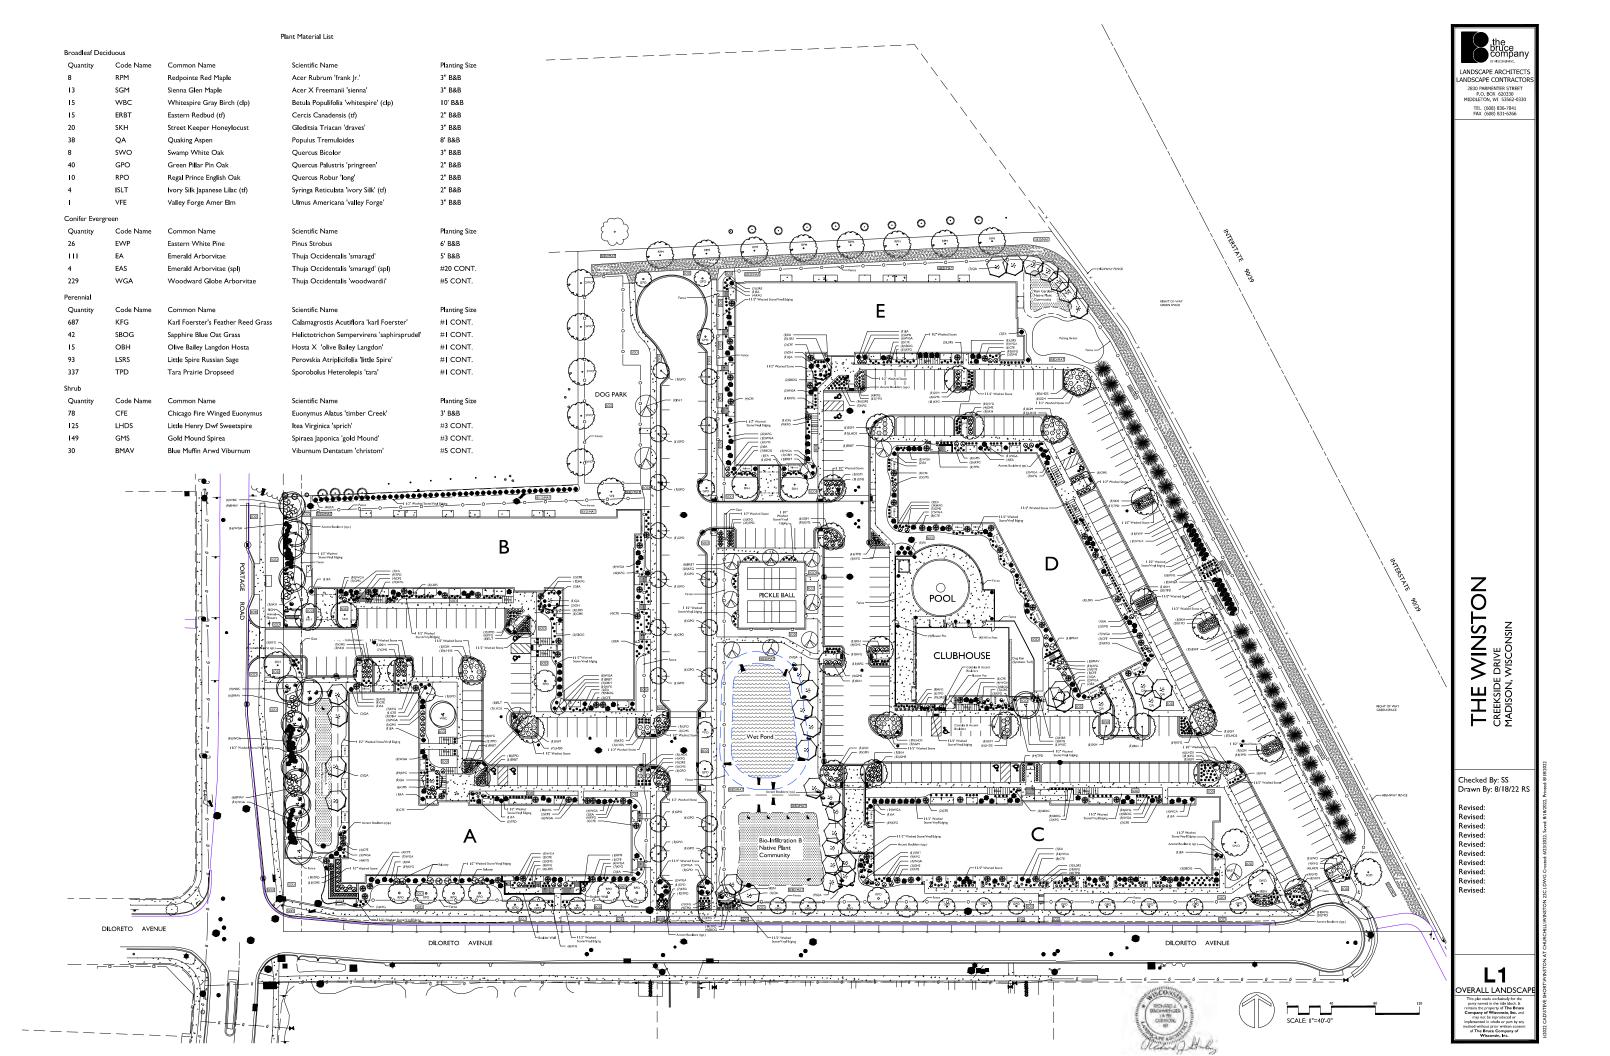
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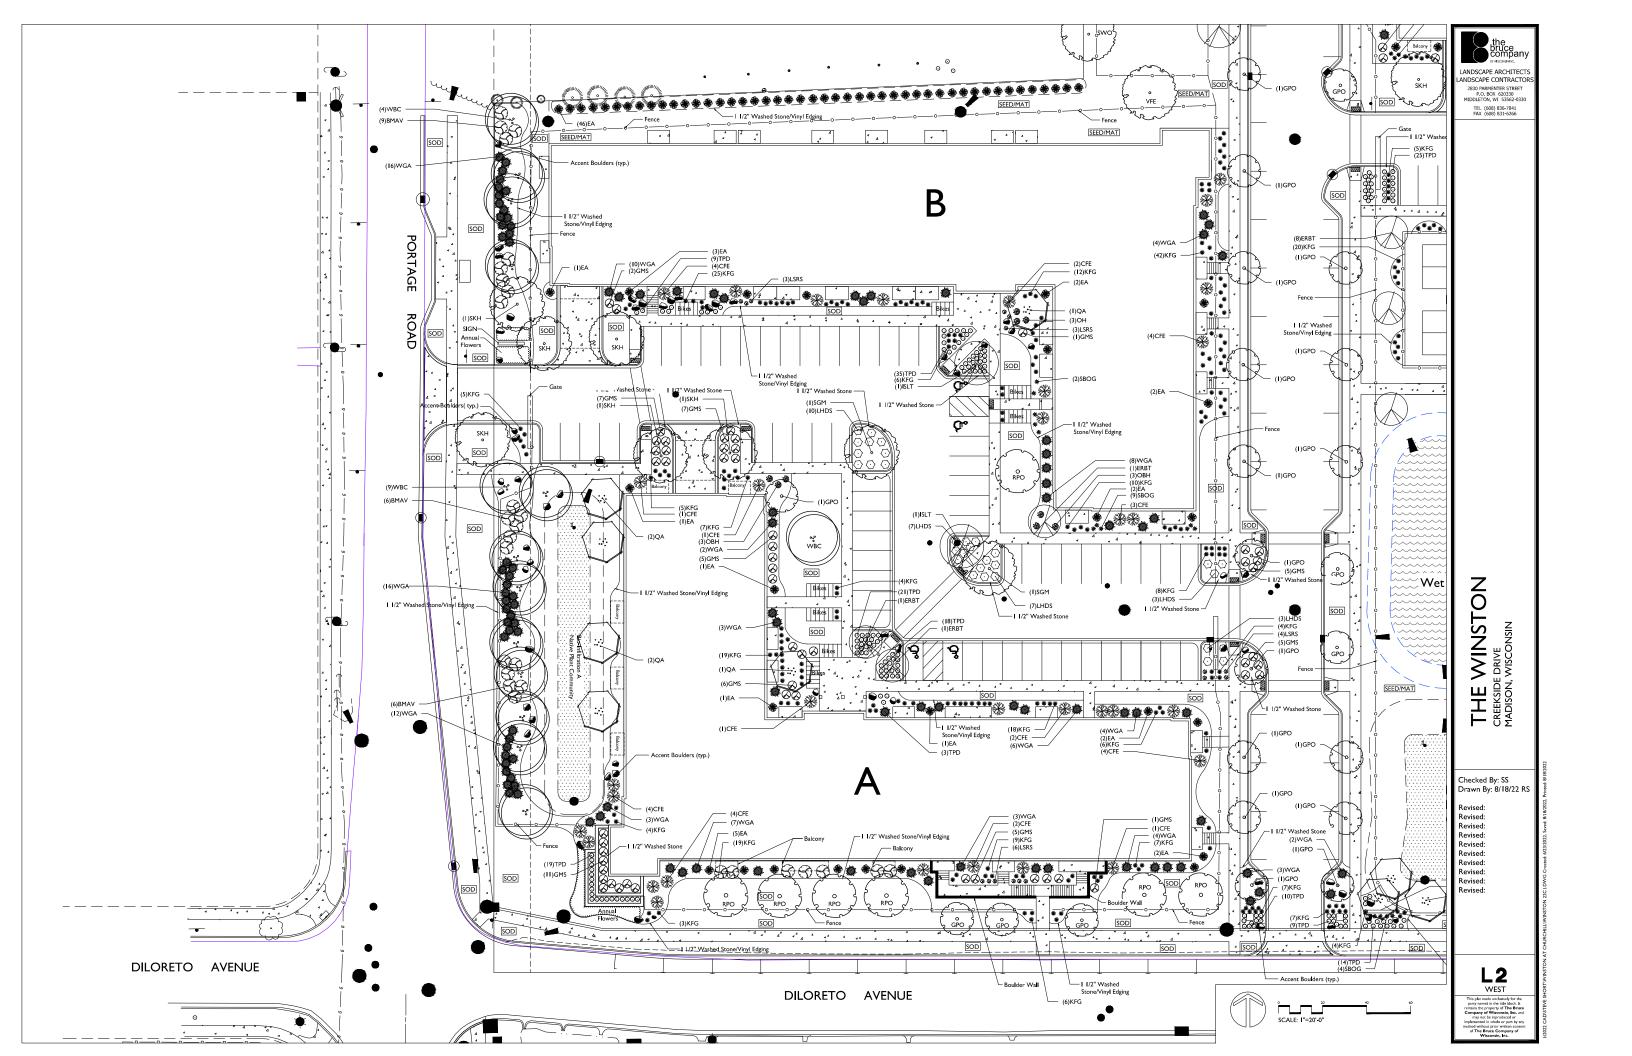
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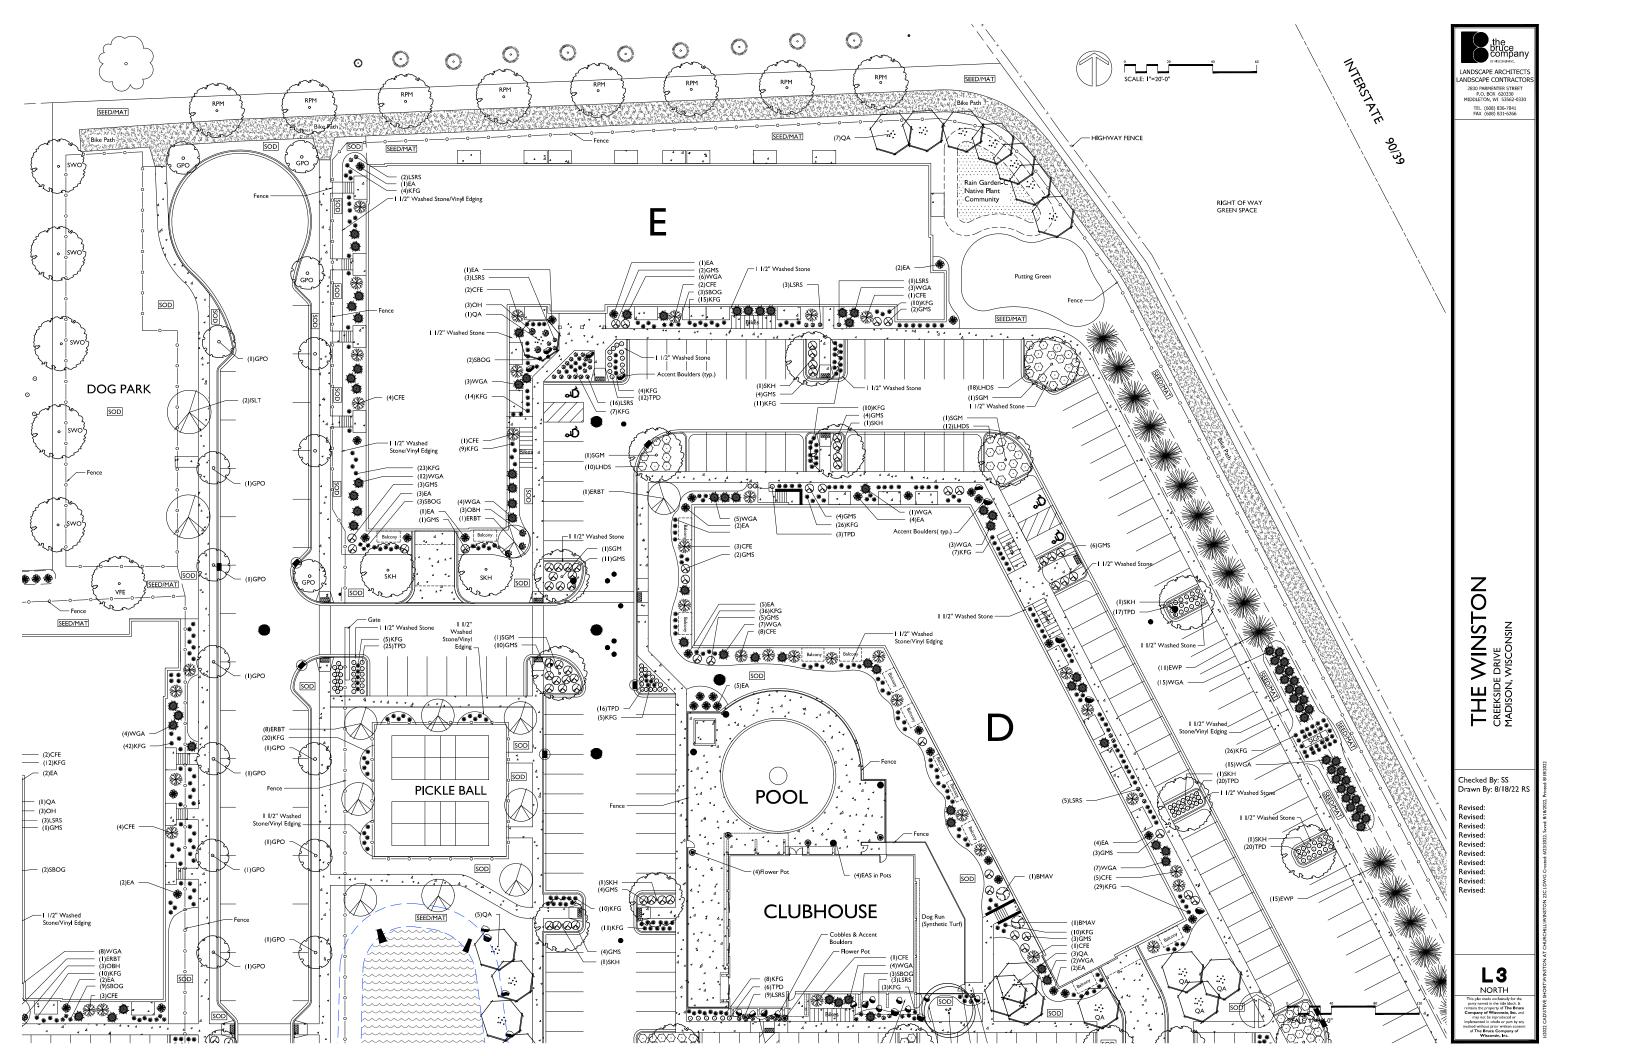
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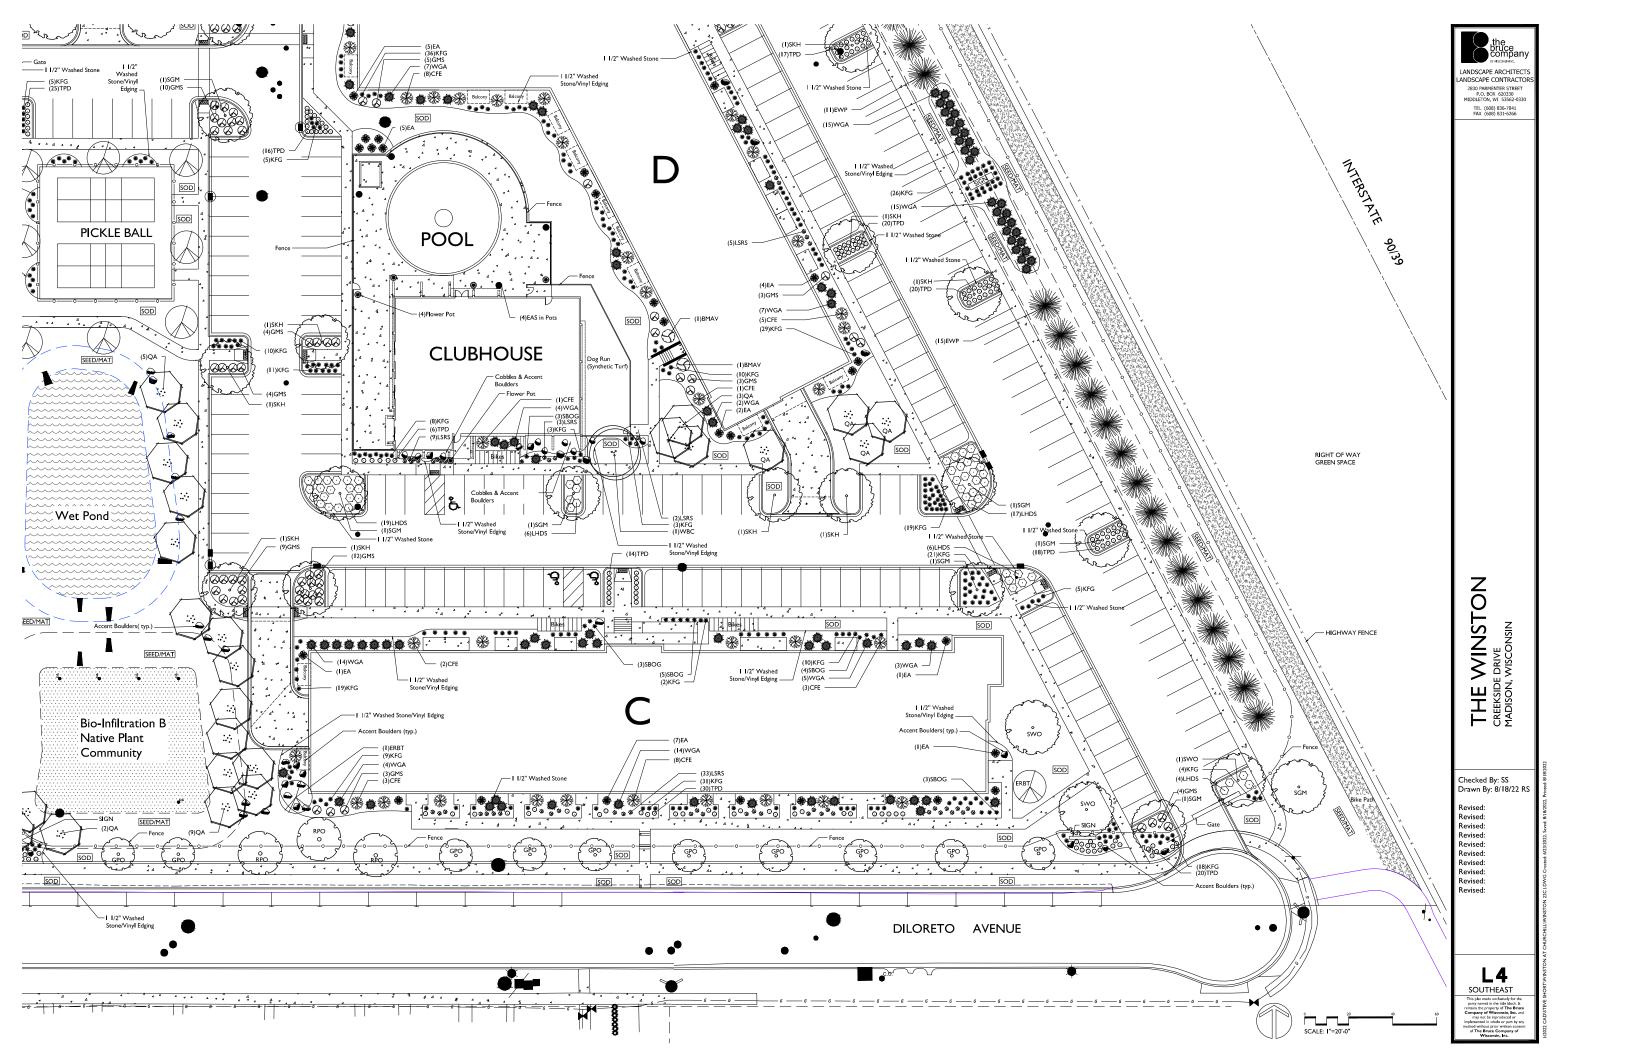
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BIO-	RETETION / INF	ILTRATION DEV	/ICE /	A PLANT LIST
Quantity	Common Name		Planting Size	Plant Spacing (Total Basin Area = 1,940 SF
	GRASSES AND	SEDGES (Planting	schedule ba	sed on 12" on center spacing
288 288 288 288 288	VIRGINIA WILD RYE SWITCH GRASS LITTLE BLUESTEM INDIAN GRASS	ELYMUS VIRGINICUS PANICUM VIRGATUM SCHIZACHYRIUM SCOPARIUM SORBASTRUM NUTANS	2.5" POT 2.5" POT 2.5" POT 2.5" POT	12" O.C. Rect. Spacing 12" O.C. Rect. Spacing 12" O.C. Rect. Spacing 12" O.C. Rect. Spacing
	FORBS			
96 96 96 96 96 96 96	NEW ENGLAND ASTER PURPLE CONEFLOWER FALSE SUNFLOWER WILD IRIS CARDINAL FLOWER BERGAMOT SWEET BLACK-EYED SUSAN STIFF GOLDENROD	ASTER NOVAE-ANGLIAE ECHINACEA PURPUREA HELIOPISI BELIANTHODIES IRIS VIRGINIANA SHREVEI LOBELIA CARDINALIS MONARDA FISTULOSA RUDBECKIA SUBTOMENTOSA SOLIDAGO RIGIDA	2.5" POT 2.5" POT 2.5" POT 2.5" POT 2.5" POT 2.5" POT 2.5" POT 2.5" POT	12" O.C. Rect. Spacing 12" O.C. Rect. Spacing 12" O.C. Rect. Spacing

BIO-	RETETION / INI	ILTRATION DE	VICE E	B PLANT LIST
Quantity	Common Name	Scientific Name		Plant Spacing (Total Basin Area = 4,893 SF)
	GRASSES AND	SEDGES (Planting		sed on 12" on center spacing)
704 736 736 704	VIRGINIA WILD RYE SWITCH GRASS LITTLE BLUESTEM INDIAN GRASS		2.5" POT 2.5" POT 2.5" POT	12" O.C. Rect. Spacing 12" O.C. Rect. Spacing 12" O.C. Rect. Spacing 12" O.C. Rect. Spacing
704		SORBASTROPH NOTAINS	2.3 FOT	12 O.C. Rect apacing
	TORBS			
256 256 256	NEW ENGLAND ASTER PURPLE CONEFLOWER	ASTER NOVAE-ANGLIAE ECHINACEA PURPUREA	2.5" POT 2.5" POT	12" O.C. Rect. Spacing 12" O.C. Rect. Spacing 12" O.C. Rect. Spacing
256 224	WILD IRIS CARDINAL FLOWER	IRIS VIRGINIANA SHREVEI LOBELIA CARDINALIS	2.5" POT 2.5" POT	12" O.C. Rect. Spacing 12" O.C. Rect. Spacing 12" O.C. Rect. Spacing
256 256	SWEET BLACK-EYED SUSAN STIFF GOLDENROD			12" O.C. Rect. Spacing 12" O.C. Rect. Spacing
	Quantity 704 736 736 704 256 256 256 256 224 256 224 256	Quantity Common Name GRASSES AND 704 VIRGINIA WILD BYE 736 SWITCH GRASS 736 LITTLE BLUSTEM 1NDIAN GRASS FORBS 256 NEW PECALAND ACTER 758 PALSE SUNRICOVER 258 CARDINAL FLOWER 258 CARDINAL FLOWER 258 SOME PLACE SUSPAN	Quantity Common Name Scientific Name GRASSES AND SEDGES (Flanting 704 VIRGINIA VILLD BYE 736 SWITCH GRASS SAND SEDGES) FORBS FORBS 256 NEW EXCLAND ASTER 258 NEW EXCLAND ASTER 258 NEW EXCLAND ASTER 259 LANGUAGE CONTROLLE 250 VILLD BIR CONTROLLE 250 VILLD BIR CARDINAL SERVICE 250 VILLD BIR CARDINAL SERVICE 250 SWITCH CONTROLLE 250 VILLD BIR CARDINAL SERVICE 251 CARDINAL SERVICE 252 SWITCH SERVICE 253 VILLD BIR CARDINAL SERVICE 254 CARDINAL SERVICE 255 VILLD BIR CARDINAL SERVICE 255 VILLD BIR CARDINAL SERVICE 255 VILLD BIR CARDINAL SERVICE 256 SWITCH SERVICE 257 VILLD BIR CARDINAL SERVICE 258 SWITCH SERVICE 258 SWITCH SERVICE 259 VILLD BIR CONTROLLE 259 VILLD BIR CARDINAL SERVICE 250 VILLD BIR CARDINAL SERVICE 251 VILLD BIR CARDINAL SERVICE 252 VILLD BIR CARDINAL SERVICE 253 VILLD BIR CARDINAL SERVICE 254 CARDINAL SERVICE 255 VILLD BIR CARDINAL SERVICE 256 VILLD BIR CARDINAL SERVICE 257 VILLD BIR CARDINAL SERVICE 258 VILLD BIR CARDINAL SERVICE 259 VILLD BIR CARDINAL SERVICE 259 VILLD BIR CARDINAL SERVICE 250 VILLD BIR CARDINAL SERVICE 250 VILLD BIR CARDINAL SERVICE 250 VILLD BIR CARDINAL SERVICE 257 VILLD BIR CARDINAL SERVICE 258 VILLD BIR CARDINAL SERVICE 259 VILLD BIR CARDINAL SERVICE 259 VILLD BIR CARDINAL SERVICE 250 VILLD BIR CARDINAL SERVICE 2	GRASSES AND SEDGES (Planting schedule baseling) 704 VIRGINIA WILD AYE 1724 VIRGINIA WILD AYE 1724 VIRGINIA WILD AYE 1724 VIRGINIA WILD AYE 1725 VIRGINIA WILD AYE 1726 VIRGINIA WILD AYE 1727 VIRGINIA WILD

	Rain C	Garden C PLANT	LIST	
Quantity	Common Name		Planting Size	Plant Spacing (Total Basin Area = 4,893 S
	GRASSES AND	SEDGES (Planting	schedule b	ased on 12" on center spacin
28 28 28 28	VIRGINIA WILD RYE SWITCH GRASS LITTLE BLUESTEM INDIAN GRASS	ELYMUS VIRGINICUS PANICUM VIRGATUM SCHIZACHYRIUM SCOPARIUM SORBASTRUM NUTANS	2.5" POT 2.5" POT 2.5" POT 2.5" POT	12" O.C. Rect. Spacing
	FORBS			
64 64 32 32 32 32 64 64 32	NEW ENGLAND ASTER PURPLE CONEFLOWER FALSE SUNFLOWER WILD IRIS CARDINAL FLOWER BERGAMOT SWEET BLACK-EYED SUSAN STIFF GOLDENROD	ASTER NOVAE-ANGLIAE ECHINACEA PURPUREA HELIOPISI BELIANTHODIES IRIS VIRGINIANA SHREVEI LOBELIA CARDINALIS MONARDA FISTULOSA RUDBECKIA SUBTOMENTOSA SOLIDAGO RIGIDA	2.5" POT 2.5" POT 2.5" POT 2.5" POT 2.5" POT 2.5" POT 2.5" POT 2.5" POT	12" O.C. Rect. Spacing 12" O.C. Rect. Spacing

Plant Material List

Broadleaf Dec	ciduous			
Quantity	Code Name	Common Name	Scientific Name	Planting Size
8	RPM	Redpointe Red Maple	Acer Rubrum 'frank Jr.'	3" B&B
13	SGM	Sienna Glen Maple	Acer X Freemanii 'sienna'	3" B&B
15	WBC	Whitespire Gray Birch (clp)	Betula Populifolia 'whitespire' (clp)	10' B&B
15	ERBT	Eastern Redbud (tf)	Cercis Canadensis (tf)	2" B&B
20	SKH	Street Keeper Honeylocust	Gleditsia Triacan 'draves'	3" B&B
38	QA	Quaking Aspen	Populus Tremuloides	8' B&B
8	SWO	Swamp White Oak	Quercus Bicolor	3" B&B
40	GPO	Green Pi ll ar Pin Oak	Quercus Palustris 'pringreen'	2" B&B
10	RPO	Regal Prince English Oak	Quercus Robur 'long'	2" B&B
4	ISLT	Ivory Silk Japanese Lilac (tf)	Syringa Reticulata 'ivory Silk' (tf)	2" B&B
I	VFE	Valley Forge Amer Elm	Ulmus Americana 'valley Forge'	3" B&B
Conifer Everg	reen			
Quantity	Code Name	Common Name	Scientific Name	Planting Size
26	EWP	Eastern White Pine	Pinus Strobus	6' B&B
111	EA	Emerald Arborvitae	Thuja Occidentalis 'smaragd'	5' B&B
4	EAS	Emerald Arborvitae (spl)	Thuja Occidentalis 'smaragd' (spl)	#20 CONT.
229	WGA	Woodward Globe Arborvitae	Thuja Occidentalis 'woodwardii'	#5 CONT.
Perennial				
Quantity	Code Name	Common Name	Scientific Name	Planting Size
687	KFG	Karl Foerster's Feather Reed Grass	Calamagrostis Acutiflora 'karl Foerster'	#I CONT.
42	SBOG	Sapphire Blue Oat Grass	Helictotrichon Sempervirens 'saphirsprudel'	#I CONT.
15	ОВН	Olive Bailey Langdon Hosta	Hosta X 'olive Bailey Langdon'	#I CONT.
93	LSRS	Little Spire Russian Sage	Perovskia Atriplicifolia 'little Spire'	#I CONT.
337	TPD	Tara Prairie Dropseed	Sporobolus Heterolepis 'tara'	#I CONT.
Shrub				
Quantity	Code Name	Common Name	Scientific Name	Planting Size
78	CFE	Chicago Fire Winged Euonymus	Euonymus Alatus 'timber Creek'	3' B&B
125	LHDS	Little Henry Dwf Sweetspire	Itea Virginica 'sprich'	#3 CONT.
149	GMS	Gold Mound Spirea	Spiraea Japonica 'gold Mound'	#3 CONT.
30	BMAV	Blue Muffin Arwd Viburnum	Viburnum Dentatum 'christom'	#5 CONT.

MADISON LANDSCAPE WORKSHEET

	Point	NI	EW	EXIS	TING	
PLANT TYPE or ELEMENT	Value	Qty.	Points Achieved	Qty.	Points Achieved	
Overstory Deciduous Tree : 2-1/2" (dbh)	35	153	5,355			
Tall Evergreen Tree : 5-6 feet tall	35	26	910			
Ornamental Tree : I-I/2" Caliper (dbh)	15	19	285			
Upright Evergreen Shrub : 3-4 feet tall	10	115	1,150			
Shrub, deciduous : 3 gallon / 12"-24"	3	382	1,146			
Shrub, evergreen : 3 gallon / 12"-24"	4	233	932			
Ornamental grass/perennial : Igallon / 8"-18"	2	1,174	2,348			
Ornamental / Decorative fencing	4 per 10 l.f.	4,043	1,616			
Existing significant specimen tree	I 4 per Cal. In.					TOTAL
Landscape furniture for public seating and /or transit connections	5 per 'seat'					POINTS PROVIDED
	Sub	Totals	13,742	+	NA	= 13,742

Street Frontage Landscape Required	
Street Frontage =I,443LF Canopy Trees Required: I per 30 LF Frontage = Shrubs Required : 5 per 30 LF Frontage =	
Street Frontage Landscape Supplied	
Proposed Canopy Trees = 48 Proposed Shrubs = 173 Shrubs and 1,226 LF of Ornamental Fence	

GENERAL NOTE

A) Individual trees found along perimeter of property as well as those found within lawn areas to receive wood mulch rings (and wood mulch beds) consisting of a mixture of recycled wood mulch, colored brown, spread to a minimum 3" depth (3' wide beds for shrub groupings).

- B) "Vinyl Edging" to be Valley View Black Diamond Vinyl Edging or equivalent.
- C) Areas labeled "washed stone" to receive I-I/2" washed stone spread to a 3" depth over fabric weed barrier.
- D) "Seed" areas shall be finish-graded and seeded at a rate of 4 lbs. per 1,000 sq. ft.
- E) Seed shall consist of the following mixture:
 10% Palmer IV Perennial Ryegrass
 20% Dragon Kentucky Bluegrass
 20% Diva Kentucky Bluegrass
 20% Foxy II Creeping Red Fescue
 15% Vail II Perennial Ryegrass
 15% Ginney Kentucky Bluegrass
- F) Areas labeled "Seed/Mat" shall be seeded with the above-noted premium lawn seed mixture and overlaid with DS75 straw erosion control netting that is then pegged into the soil with metal staples.
- G) Areas labeled "Sod" shall receive only No. I grade nursery-grown bluegrass sod.
- H) Plant beds adjacent to building foundation to be mulched with I-1/2" diameter washed stone mulch spread to a 3" depth over fabric weed barrier.

LANDSCAPE ARCHITECTS
LANDSCAPE CONTRACTORS
2830 PARMENTER STREET
P.O. BOX 620330
MIDDLETON, WI 53562-0330
TEL (608) 836-7041
FAX (608) 831-6566

THE WINSTON CREEKSIDE DRIVE MADISON, WISCONSIN

Checked By: SS Drawn By: 8/18/22 RS

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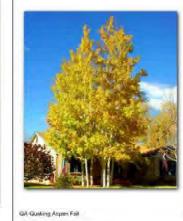
NOTES & SCHEDULES

This plan made exclusively for the pury named in the side block. It remains the property of The Bruce
Company of Wisconsin, lin. and may not be reproduced or may not be reproduced or

Broadleaf De	ciduous			
Quantity	Code Name	Common Name	Scientific Name	Planting Size
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15	ERBT	Eastern Redbud (tf)	Cercis Canadensis (tf)	2" B&B
20	SKH	Street Keeper Honeylocust	Gleditsia Triacan 'draves'	3" B&B
38	QA	Quaking Aspen	Populus Tremuloides	8' B&B
8	swo	Swamp White Oak	Quercus Bicolor	3" B&B
40	GPO	Green Pillar Pin Oak	Quercus Palustris 'pringreen'	2" B&B
10	RPO	Regal Prince English Oak	Quercus Robur 'long'	2" B&B
4	ISLT	Ivory Silk Japanese Lilac (tf)	Syringa Reticulata 'ivory Silk' (tf)	2" B&B
1	VFE	Valley Forge Amer Elm	Ulmus Americana 'valley Forge'	3" B&B
Conifer Everg	green			
Quantity	Code Name	Common Name	Scientific Name	Planting Size
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111	EA	Emerald Arborvitae	Thuja Occidentalis 'smaragd'	5' B&B
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229	WGA	Woodward Globe Arborvitae	Thuja Occidentalis 'woodwardii'	#5 CONT.
Perennial				
Quantity	Code Name	Common Name	Scientific Name	Planting Size
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42	SBOG	Sapphire Blue Oat Grass	Helictotrichon Sempervirens 'saphirsprudel'	#I CONT.
15	ОВН	Olive Bailey Langdon Hosta	Hosta X 'olive Bailey Langdon'	#I CONT.
93	LSRS	Little Spire Russian Sage	Perovskia Atriplicifolia 'little Spire'	#I CONT.
337	TPD	Tara Prairie Dropseed	Sporobolus Heterolepis 'tara'	#I CONT.
Shrub				
Quantity	Code Name	Common Name	Scientific Name	Planting Size
78	CFE	Chicago Fire Winged Euonymus	Euonymus Alatus 'timber Creek'	3' B&B
125	LHDS	Little Henry Dwf Sweetspire	Itea Virginica 'sprich'	#3 CONT.
149	GMS	Gold Mound Spirea	Spiraea Japonica 'gold Mound'	#3 CONT.
30	BMAV	Blue Muffin Arwd Viburnum	Viburnum Dentatum 'christom'	#5 CONT.



































EA-Emerald Arbandus

WBC-Whitespire Biren

ERBT-Eastern Ruland

LHDS Little Henry Dwarf Swantspiro

GPO-Green Pillar Pin Oak

GMS Gold Mound Sprea

SBOG Sapphini Blue Oat Grass

TPD-Taru Prairie Dropseed













WGA-Woodward Globa Arboryl

CFE-Chicago Fire Winged Elumymus

BMAV-Blue Multin Arrowwood Viounium

KFG-Karl Foerstor's Firether Reset Grace

LSRS-Little Spite Russian Sequ

OBH-Olive Bailey Langdon Hostu

THE WINSTON CREEKSIDE DRIVE MADISON, WISCONSIN

the bruce company of discosts like.

LANDSCAPE ARCHITECTS LANDSCAPE CONTRACTOR: 280 PARMENTER STREET P.O. BDX 620330 MIDULETON, WI 5356-20330 TE. (609) 836-7041 FAX (608) 831-6266

Checked By: SS Drawn By: 8/18/22 RS

Revised: Revised: Revised: Revised: Revised: Revised: Revised: Revised: Revised: Revised:

L6

PLANT PICTURES





TYPICAL BUILDING ELEVATION with PLANTINGS BUILDING C - SOUTH

Globe Small Reed Perennial Emerald Shade Ornamental Shrub Shrub Arborvitae Arborvitae Tree Tree


ELEVATION PLANTING KEY

THE WINSTON CREEKSIDE DRIVE MADISON, WISCONSIN

Checked By: SS Drawn By: 8/18/22 RS

Revised: Revised: Revised: Revised: Revised: Revised: Revised: Revised: Revised: Revised:

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1 ARCHITECTURAL SITE PLAN
1" = 50'-0"

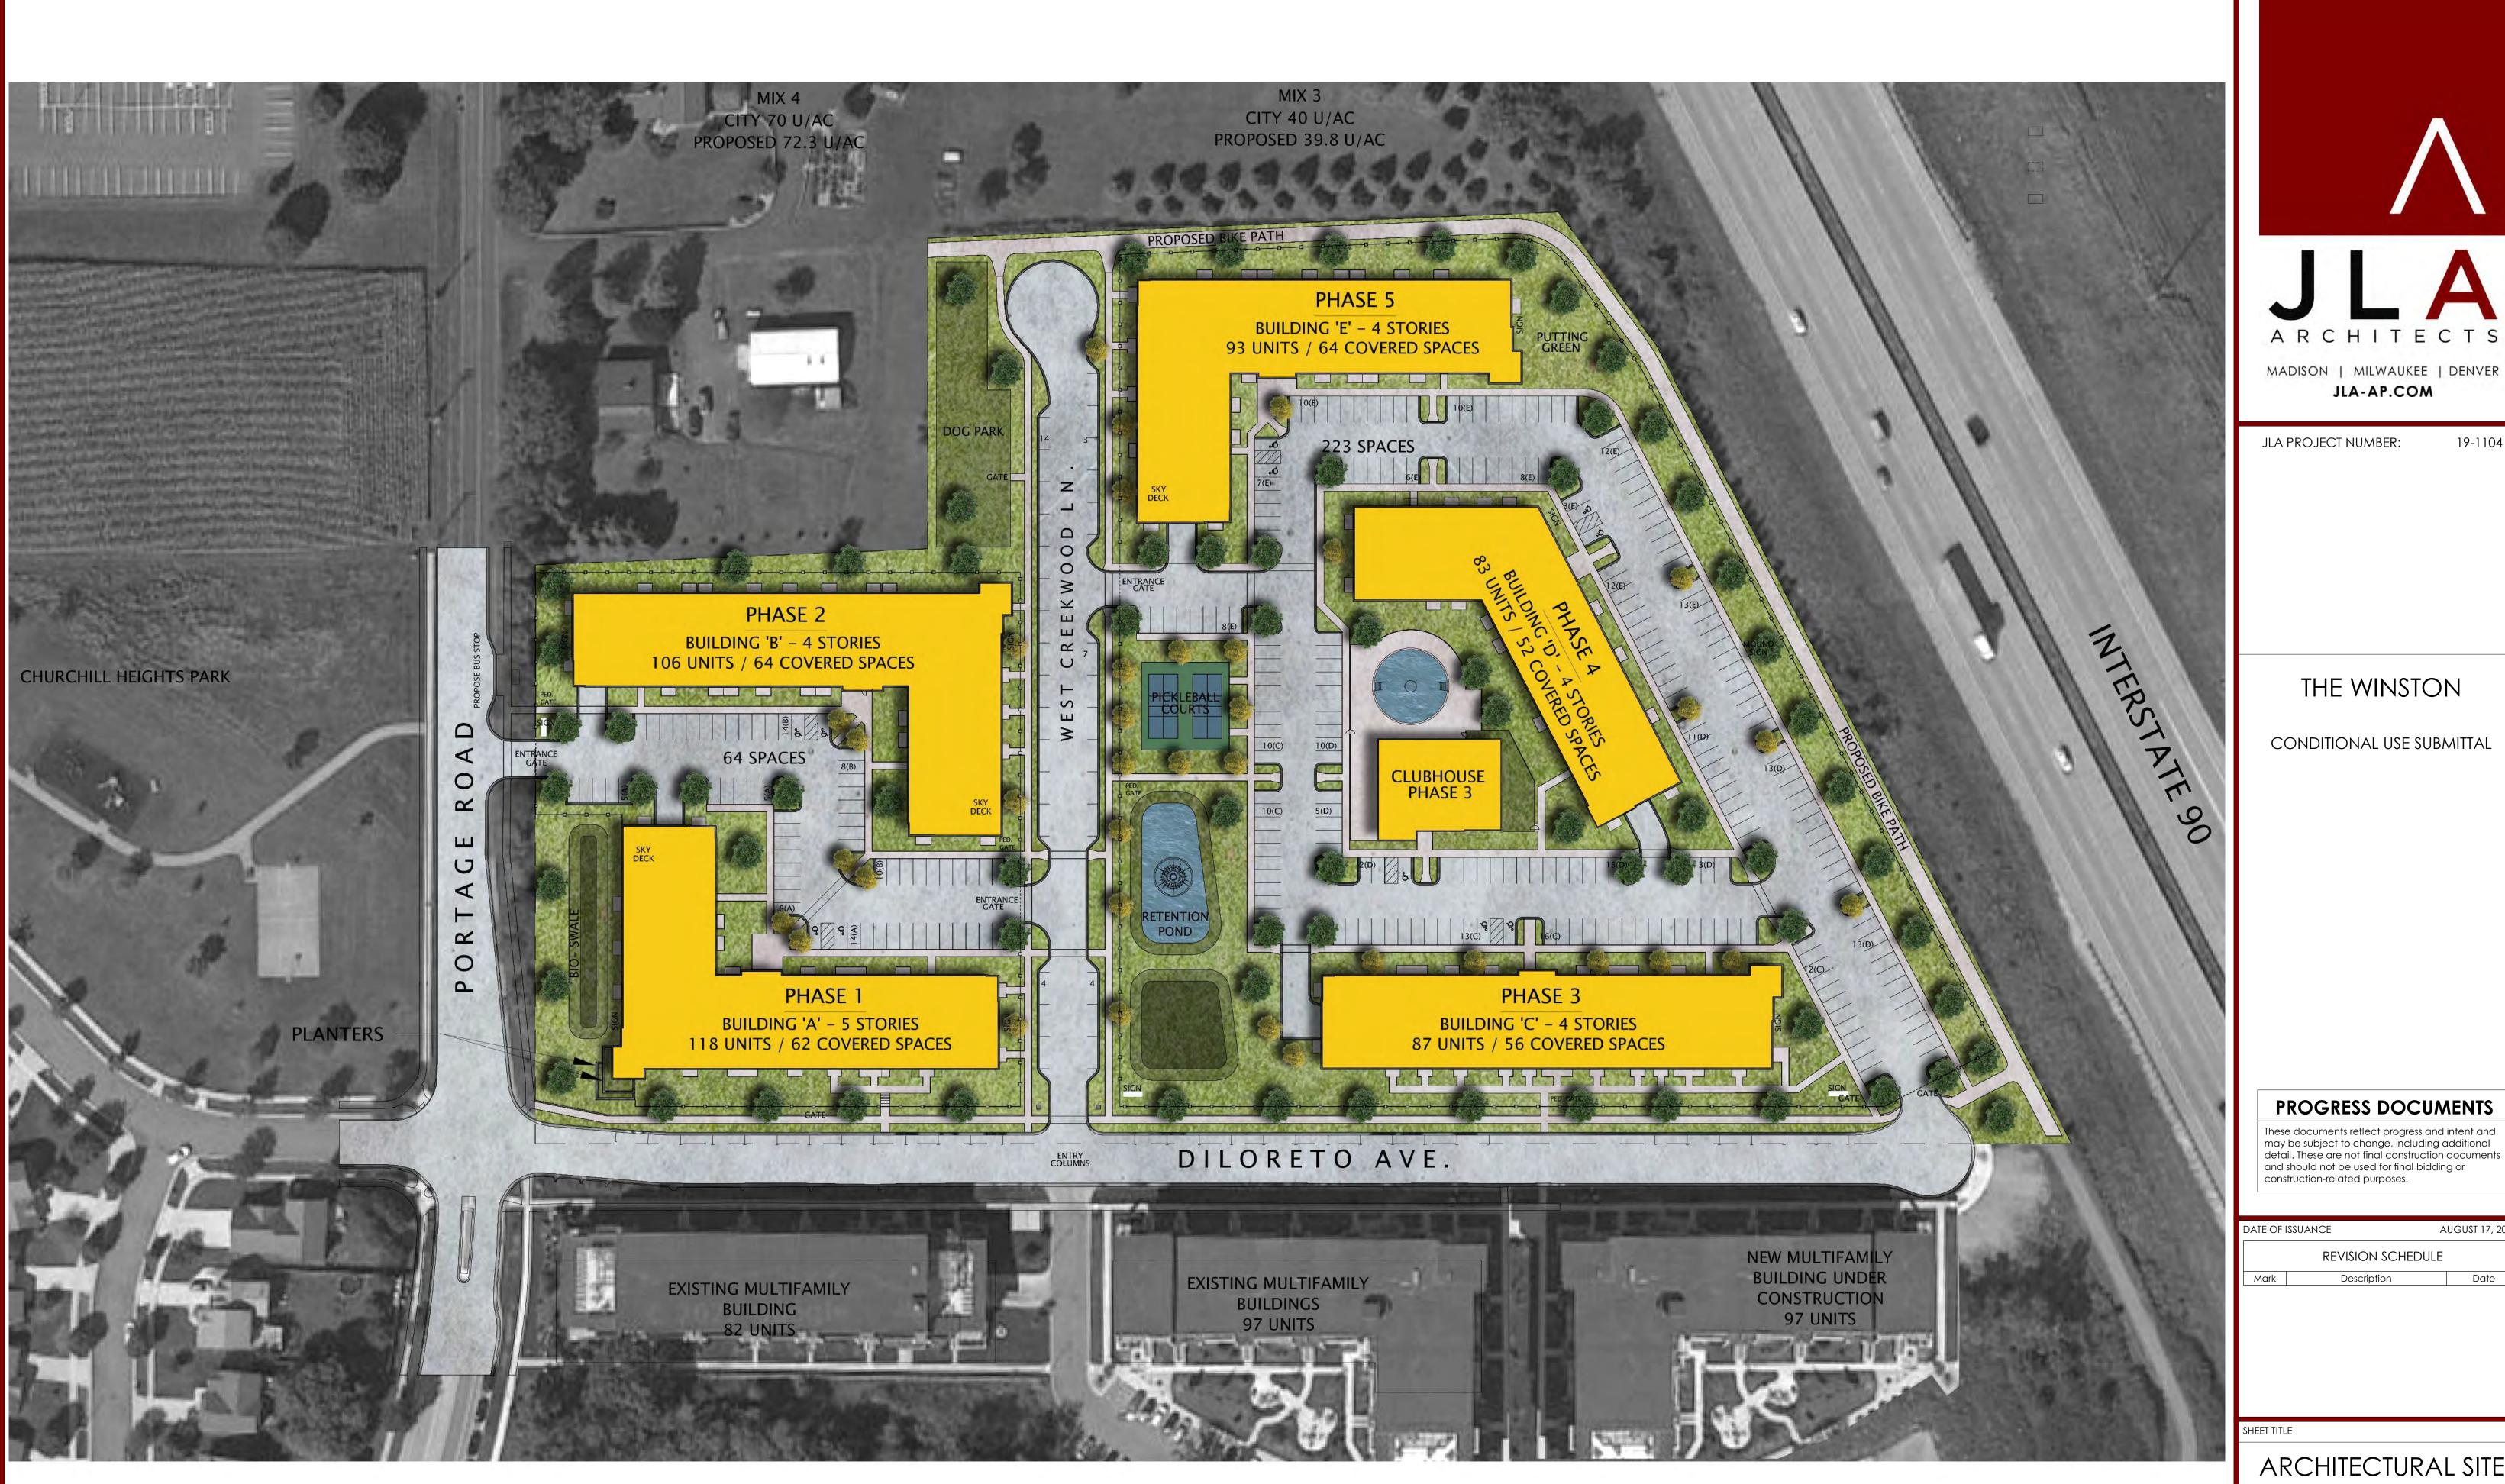

JLA-AP.COM

19-1104

JLA PROJECT NUMBER:

THE WINSTON

CONDITIONAL USE SUBMITTAL

PROGRESS DOCUMENTS


These documents reflect progress and intent and may be subject to change, including additional detail. These are not final construction documents and should not be used for final bidding or construction-related purposes.


AUGUST 17, 2022 REVISION SCHEDULE Description Date


ARCHITECTURAL SITE PLAN


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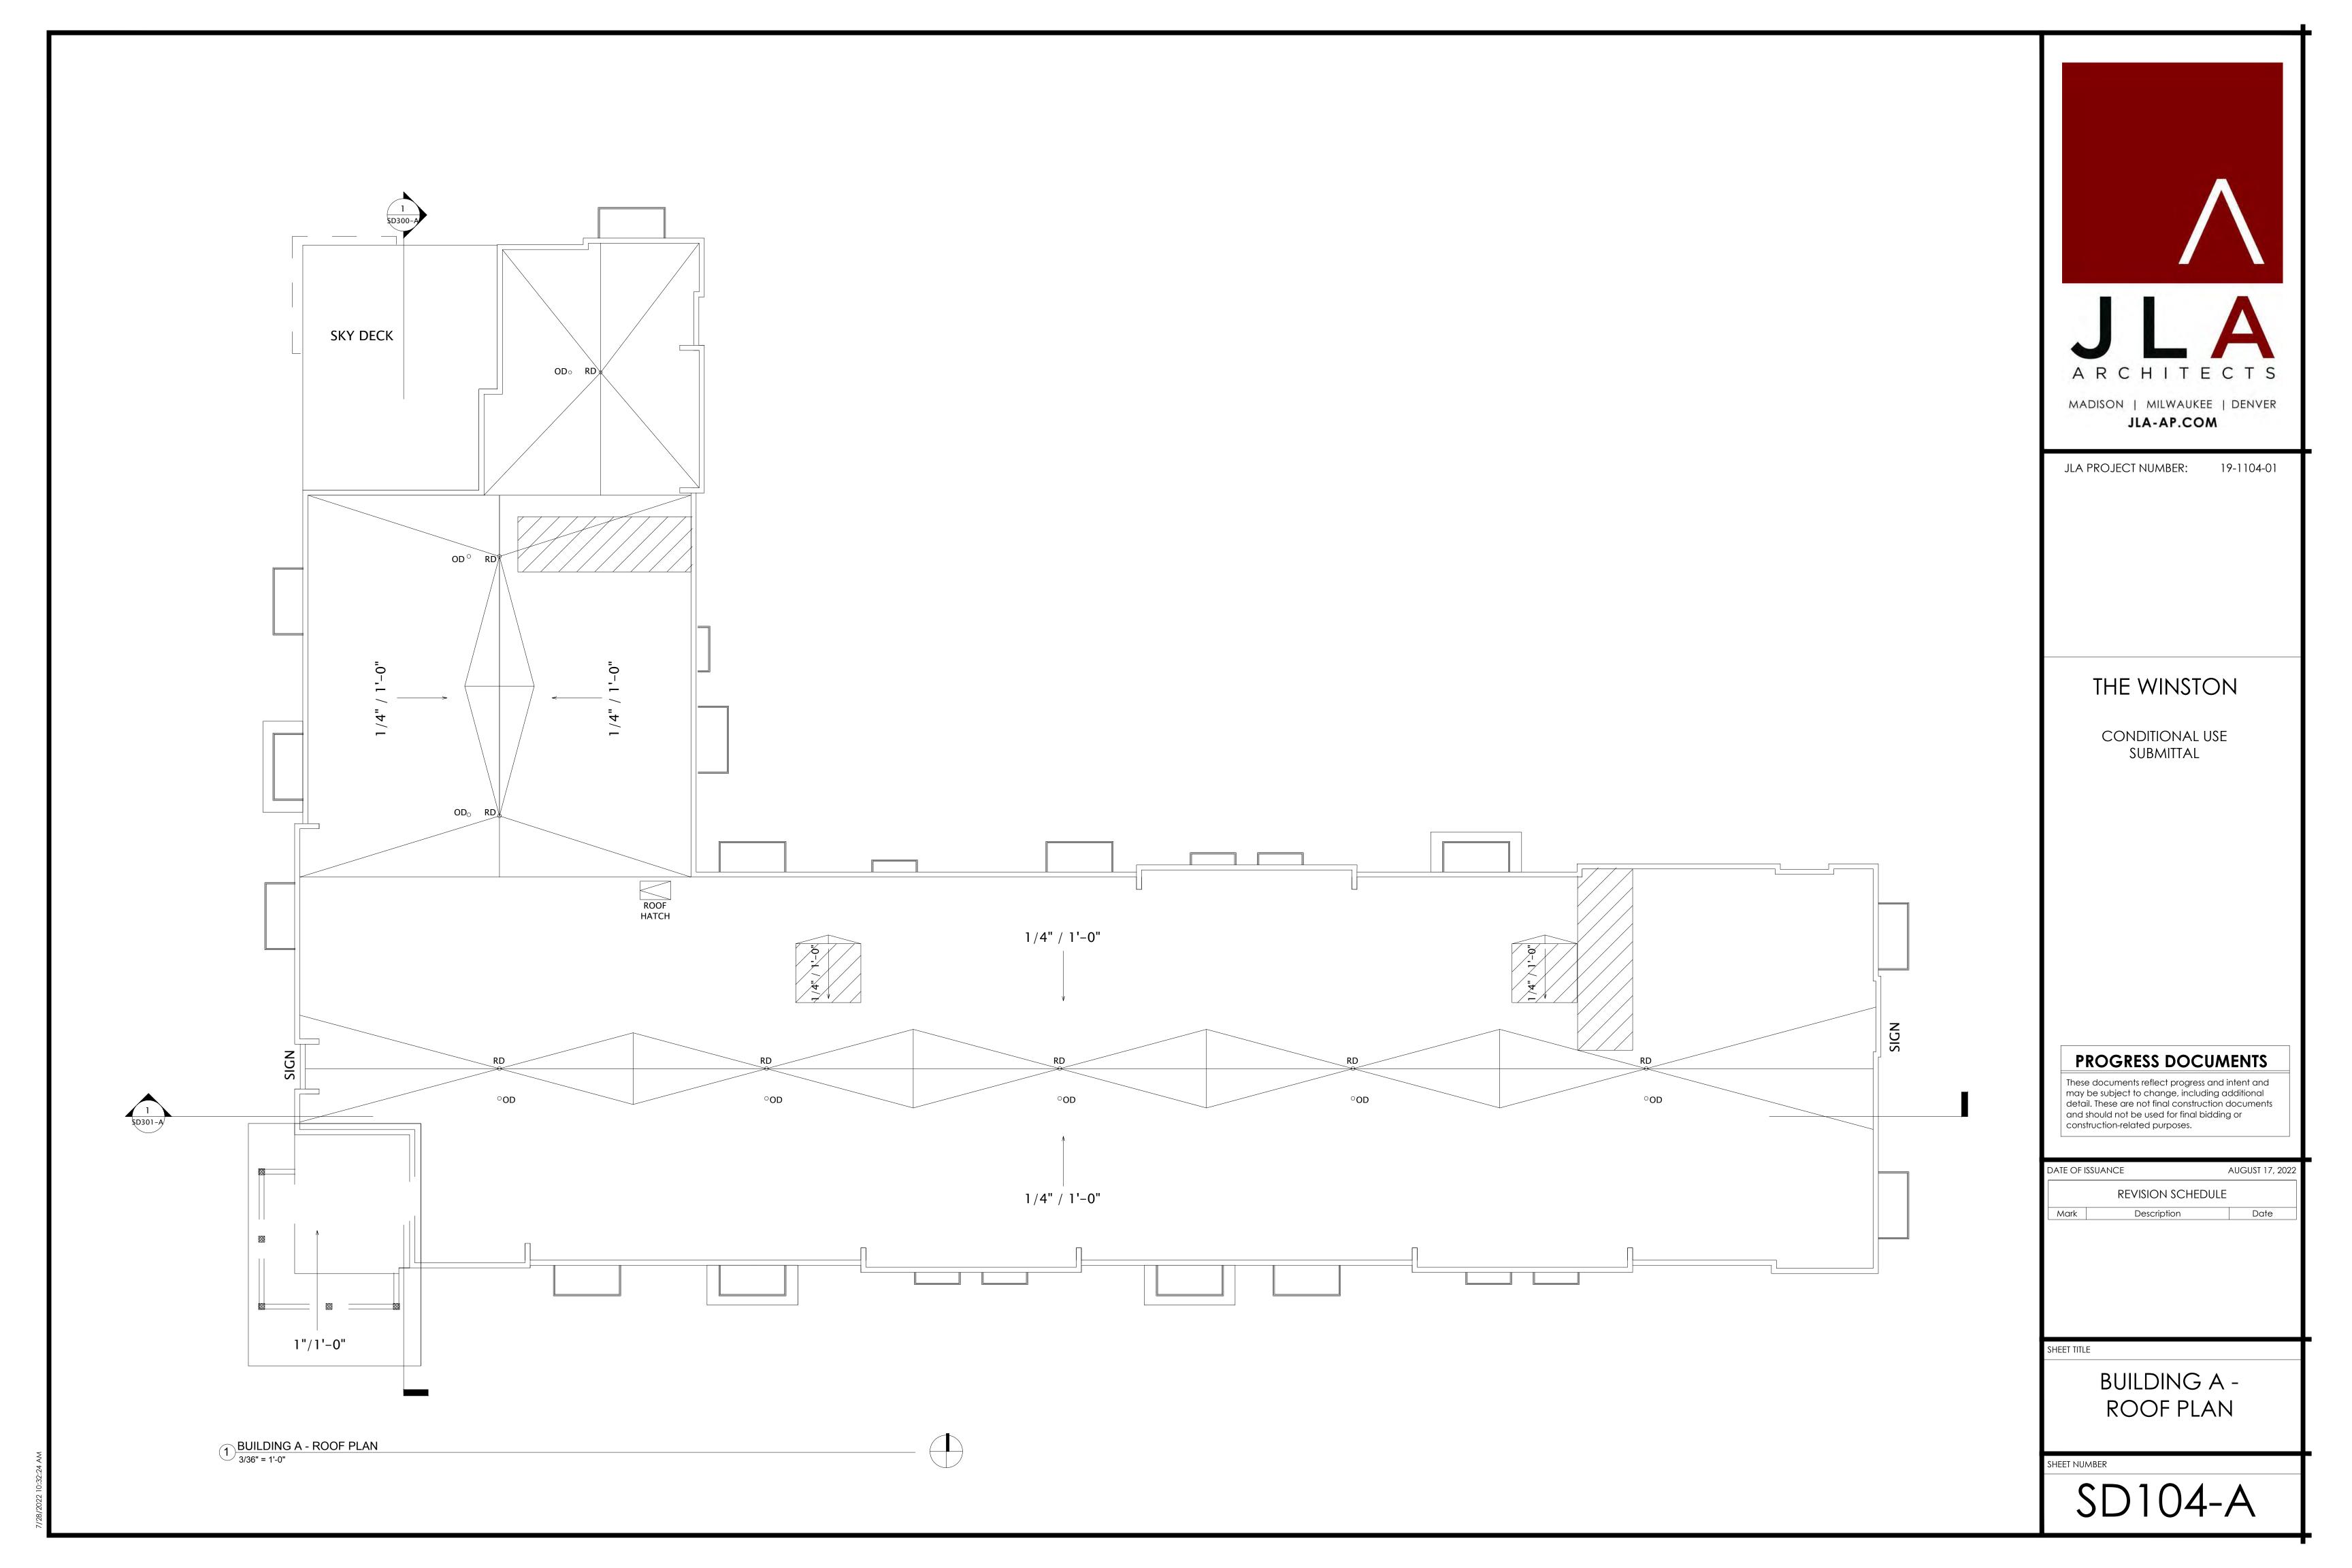




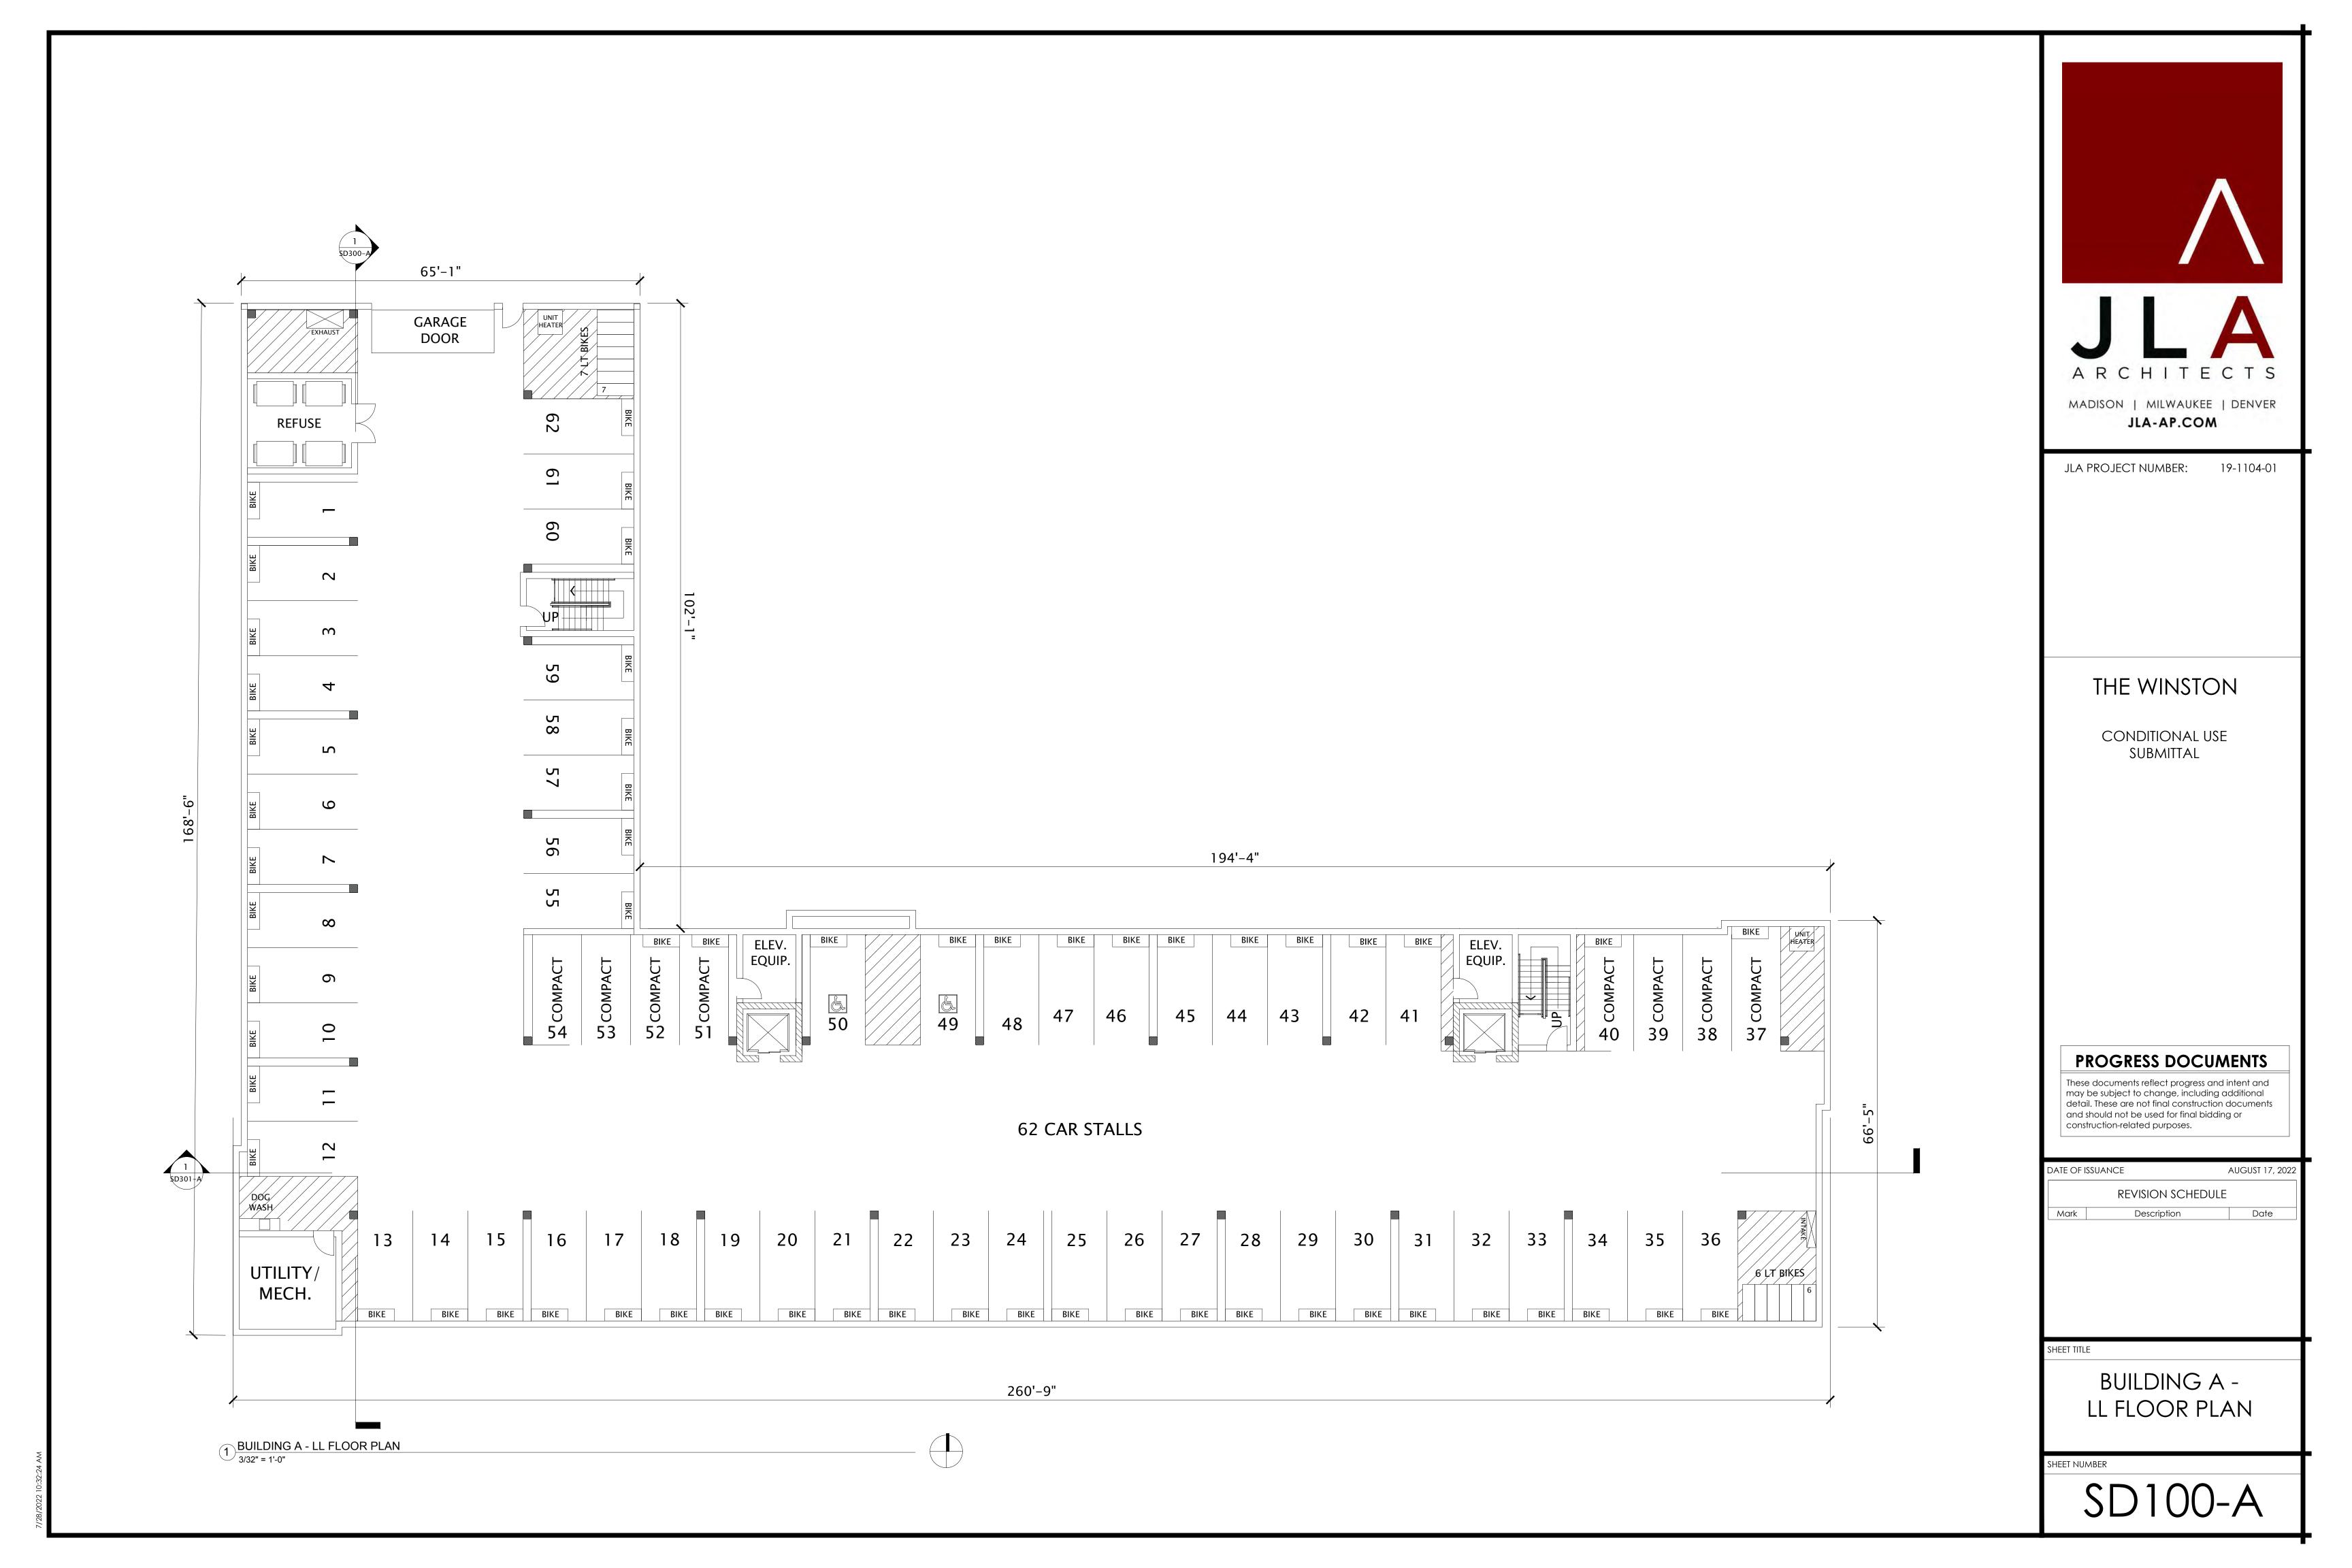

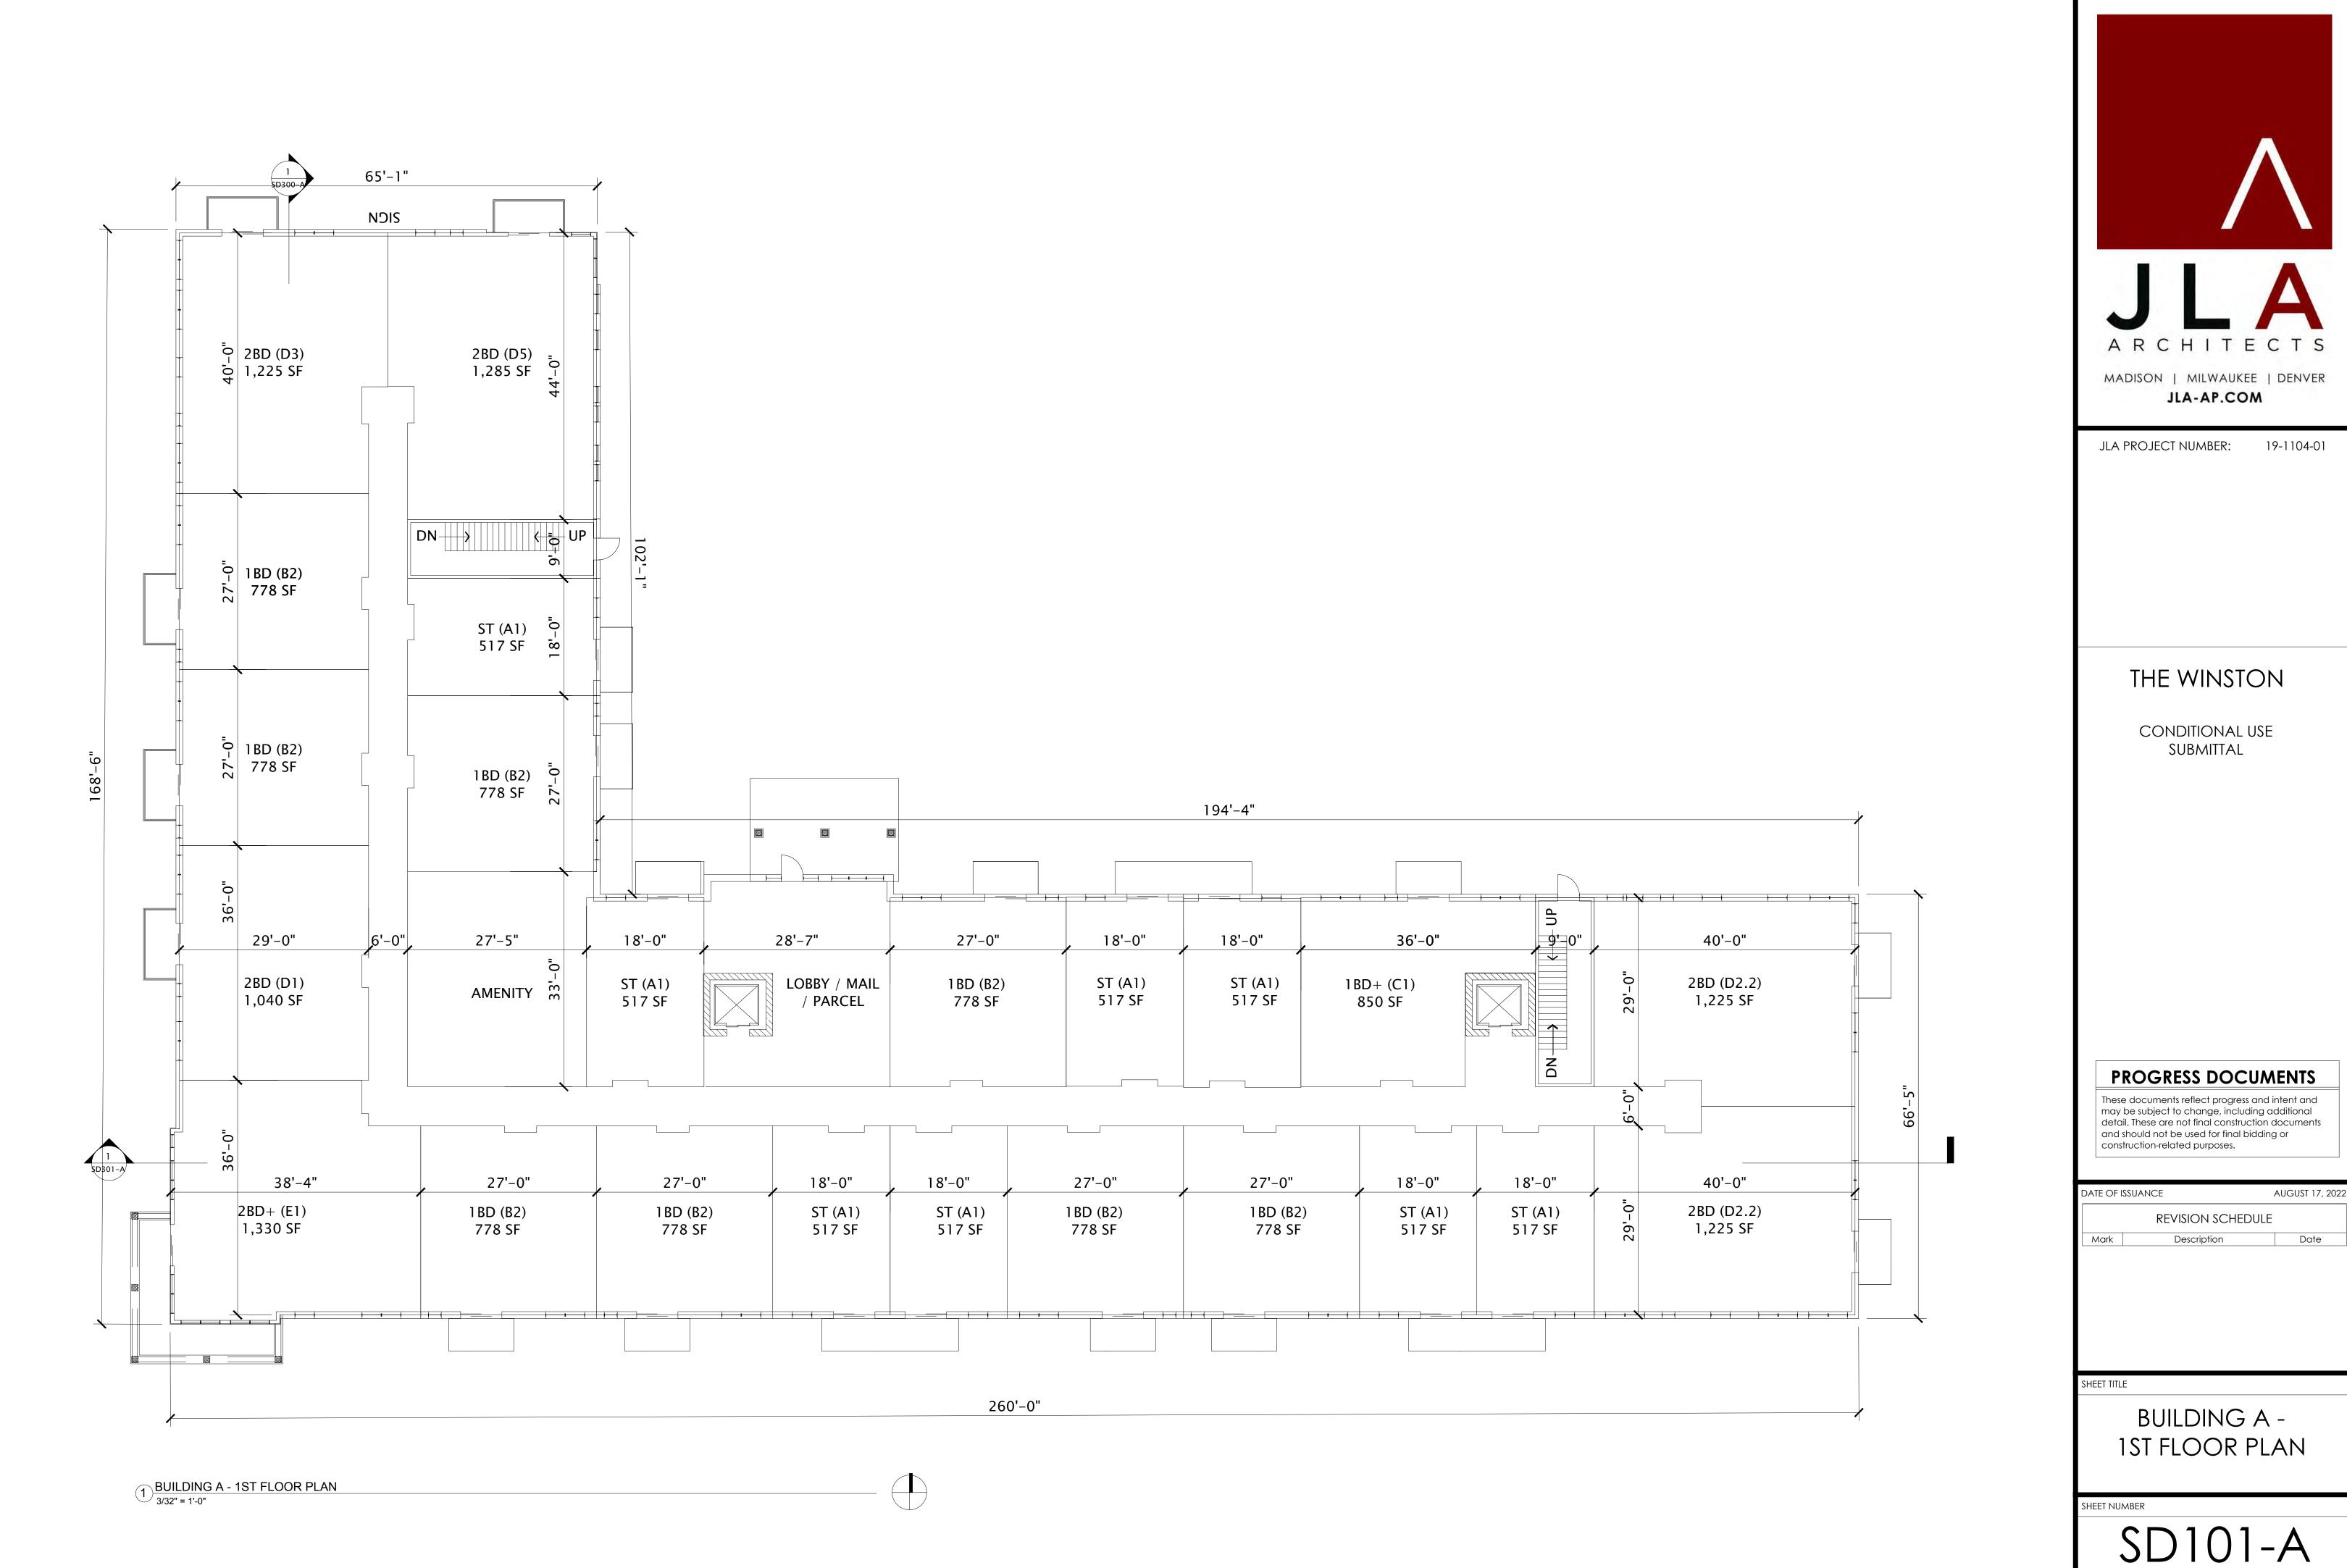

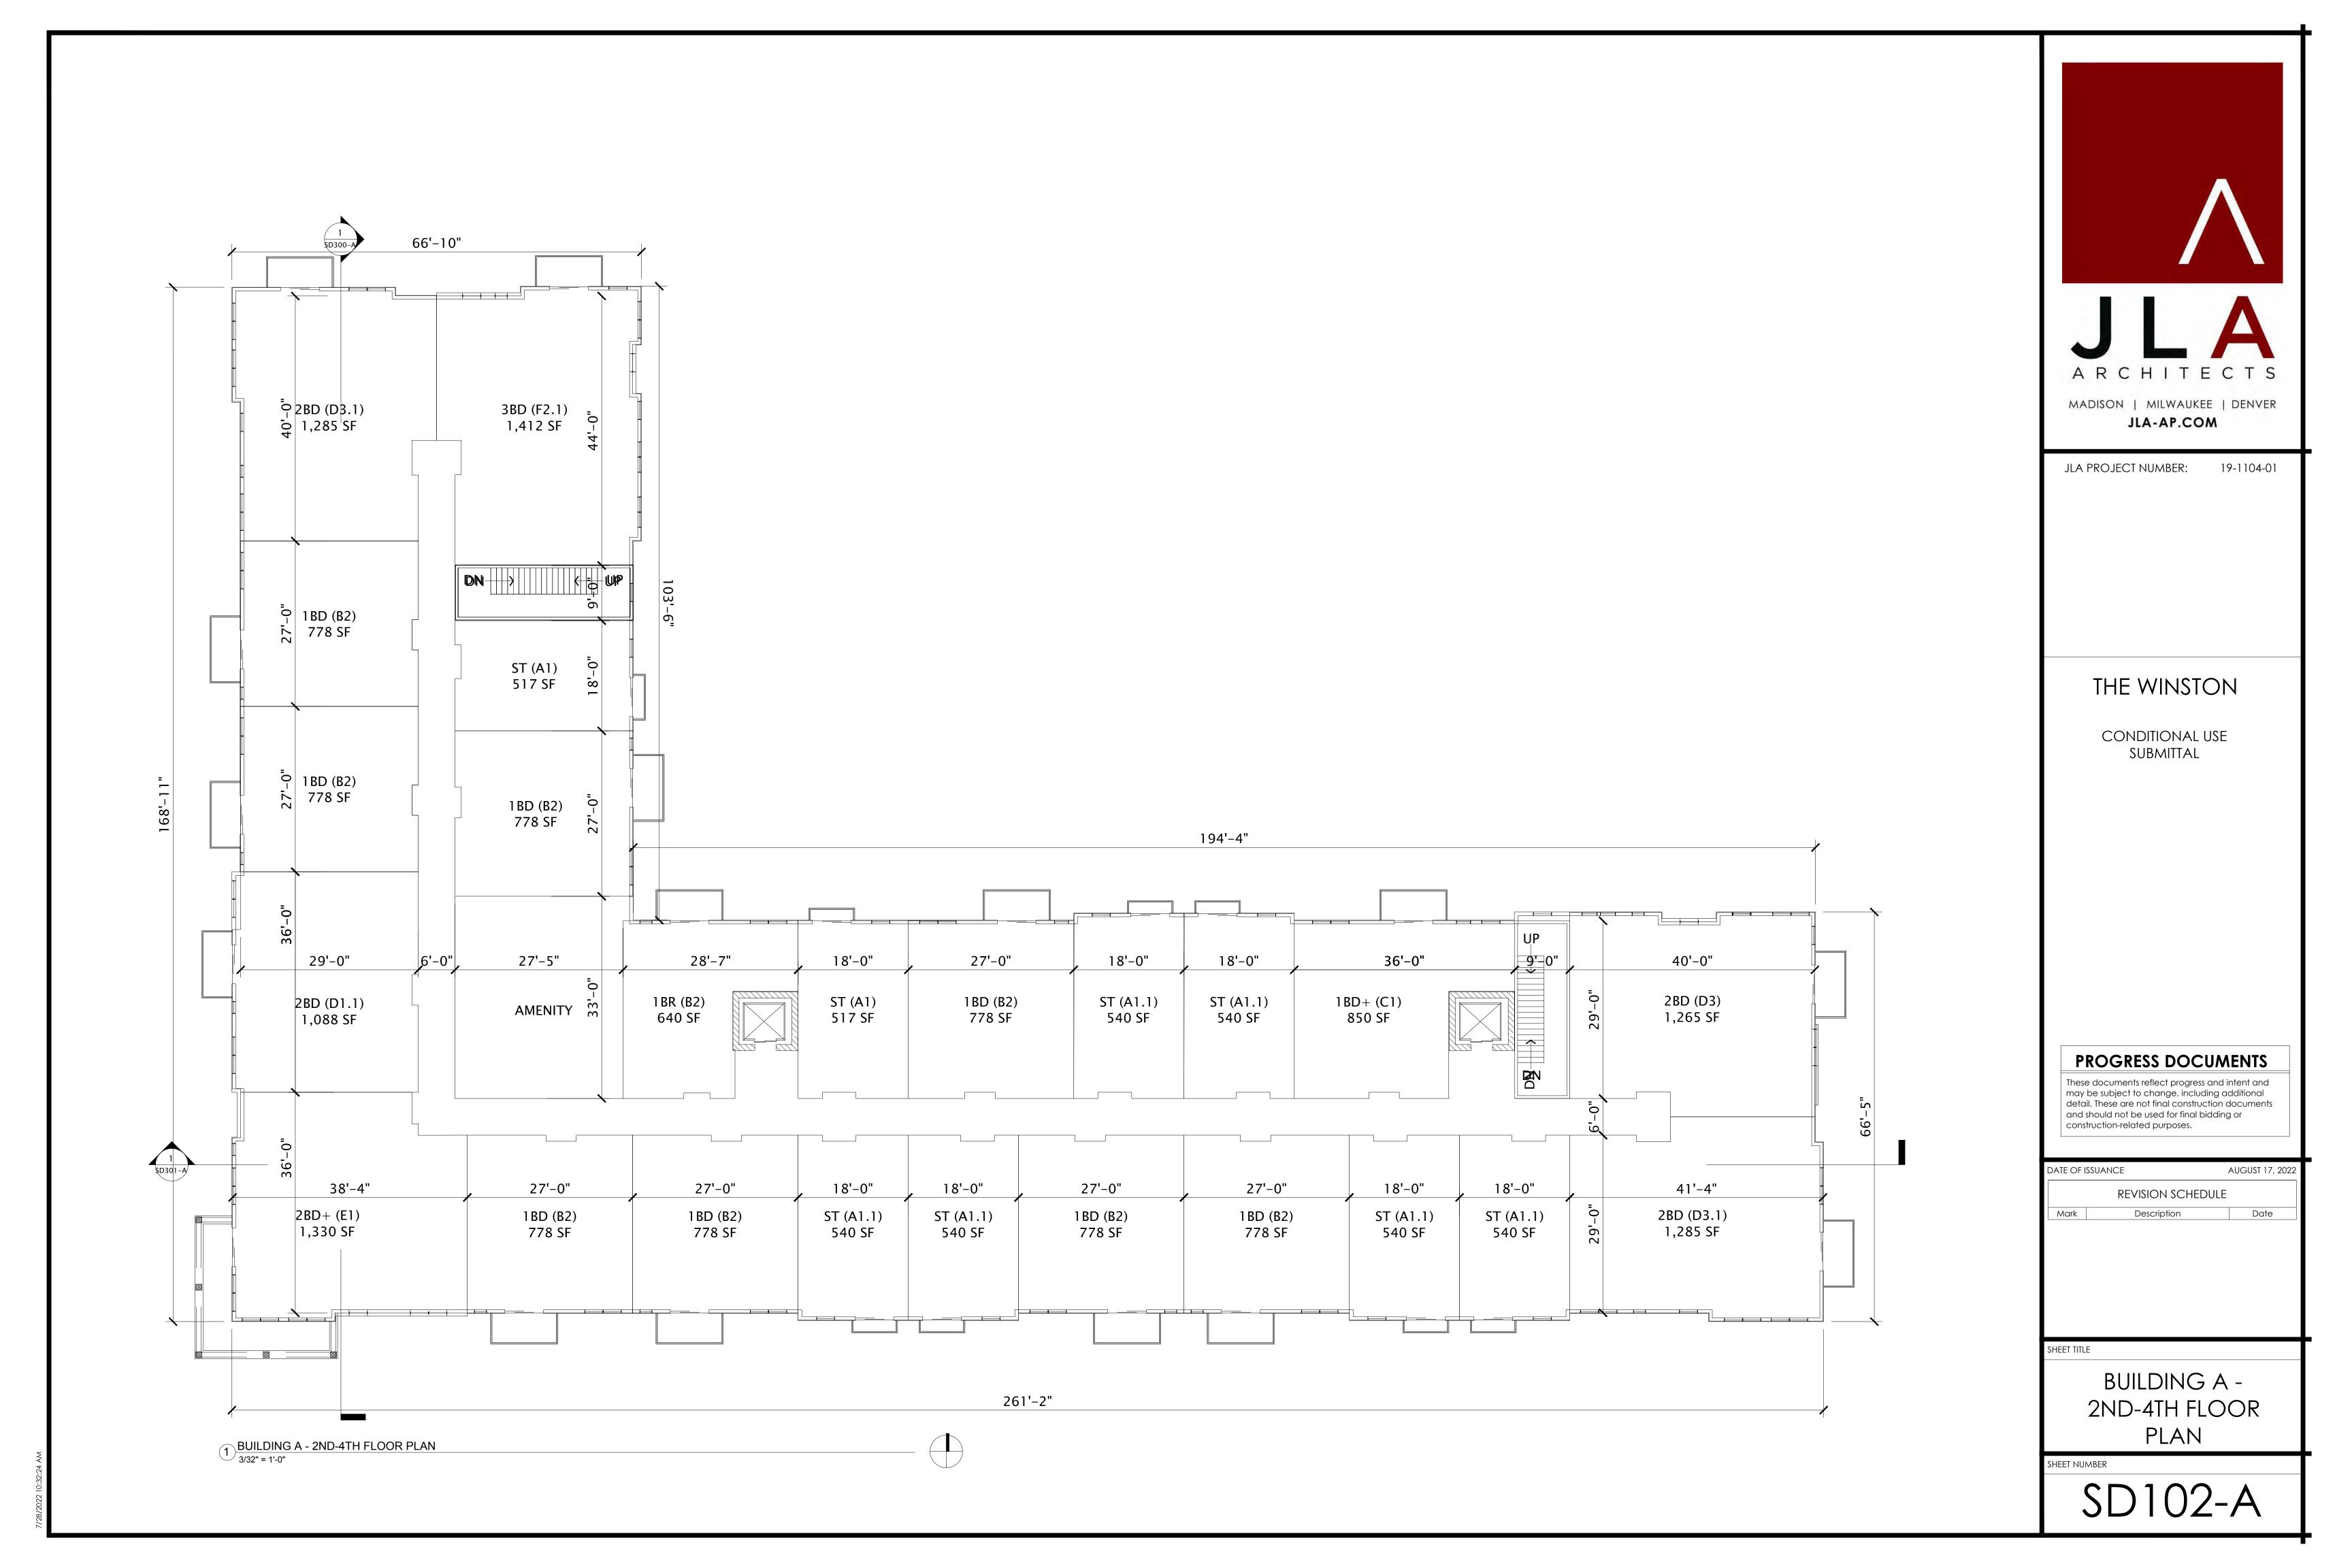
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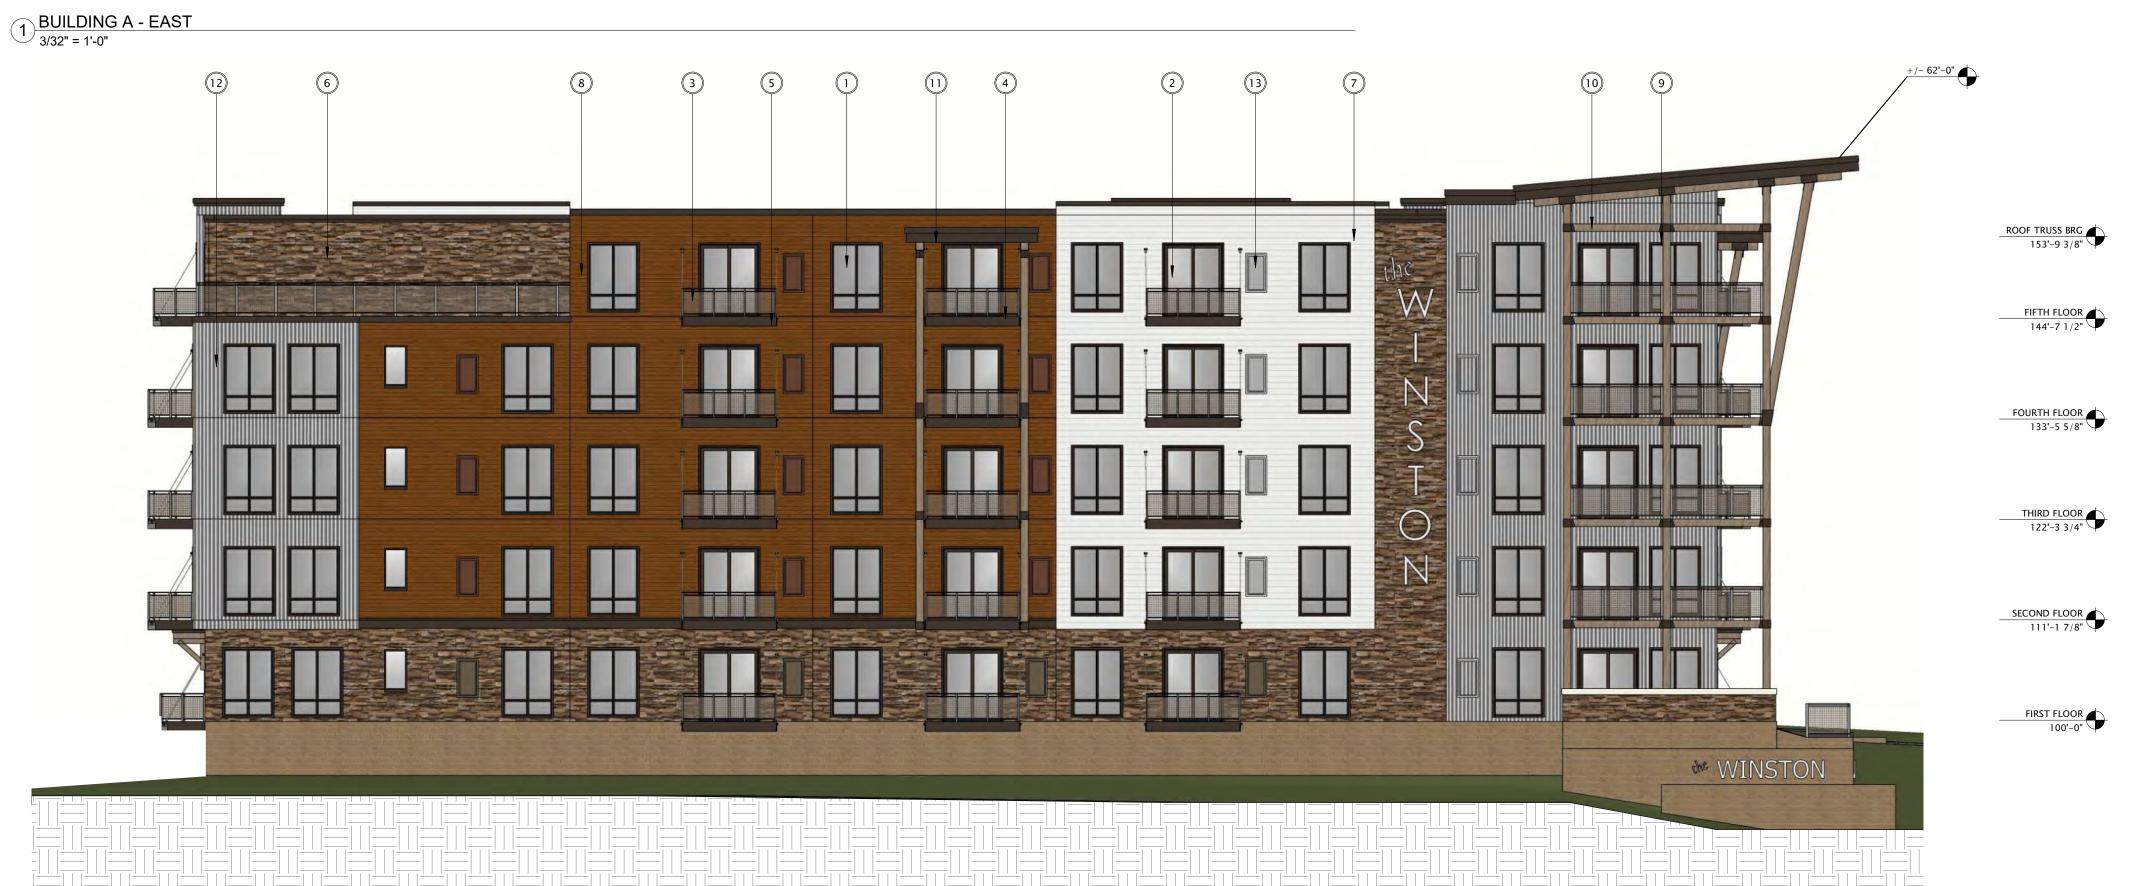


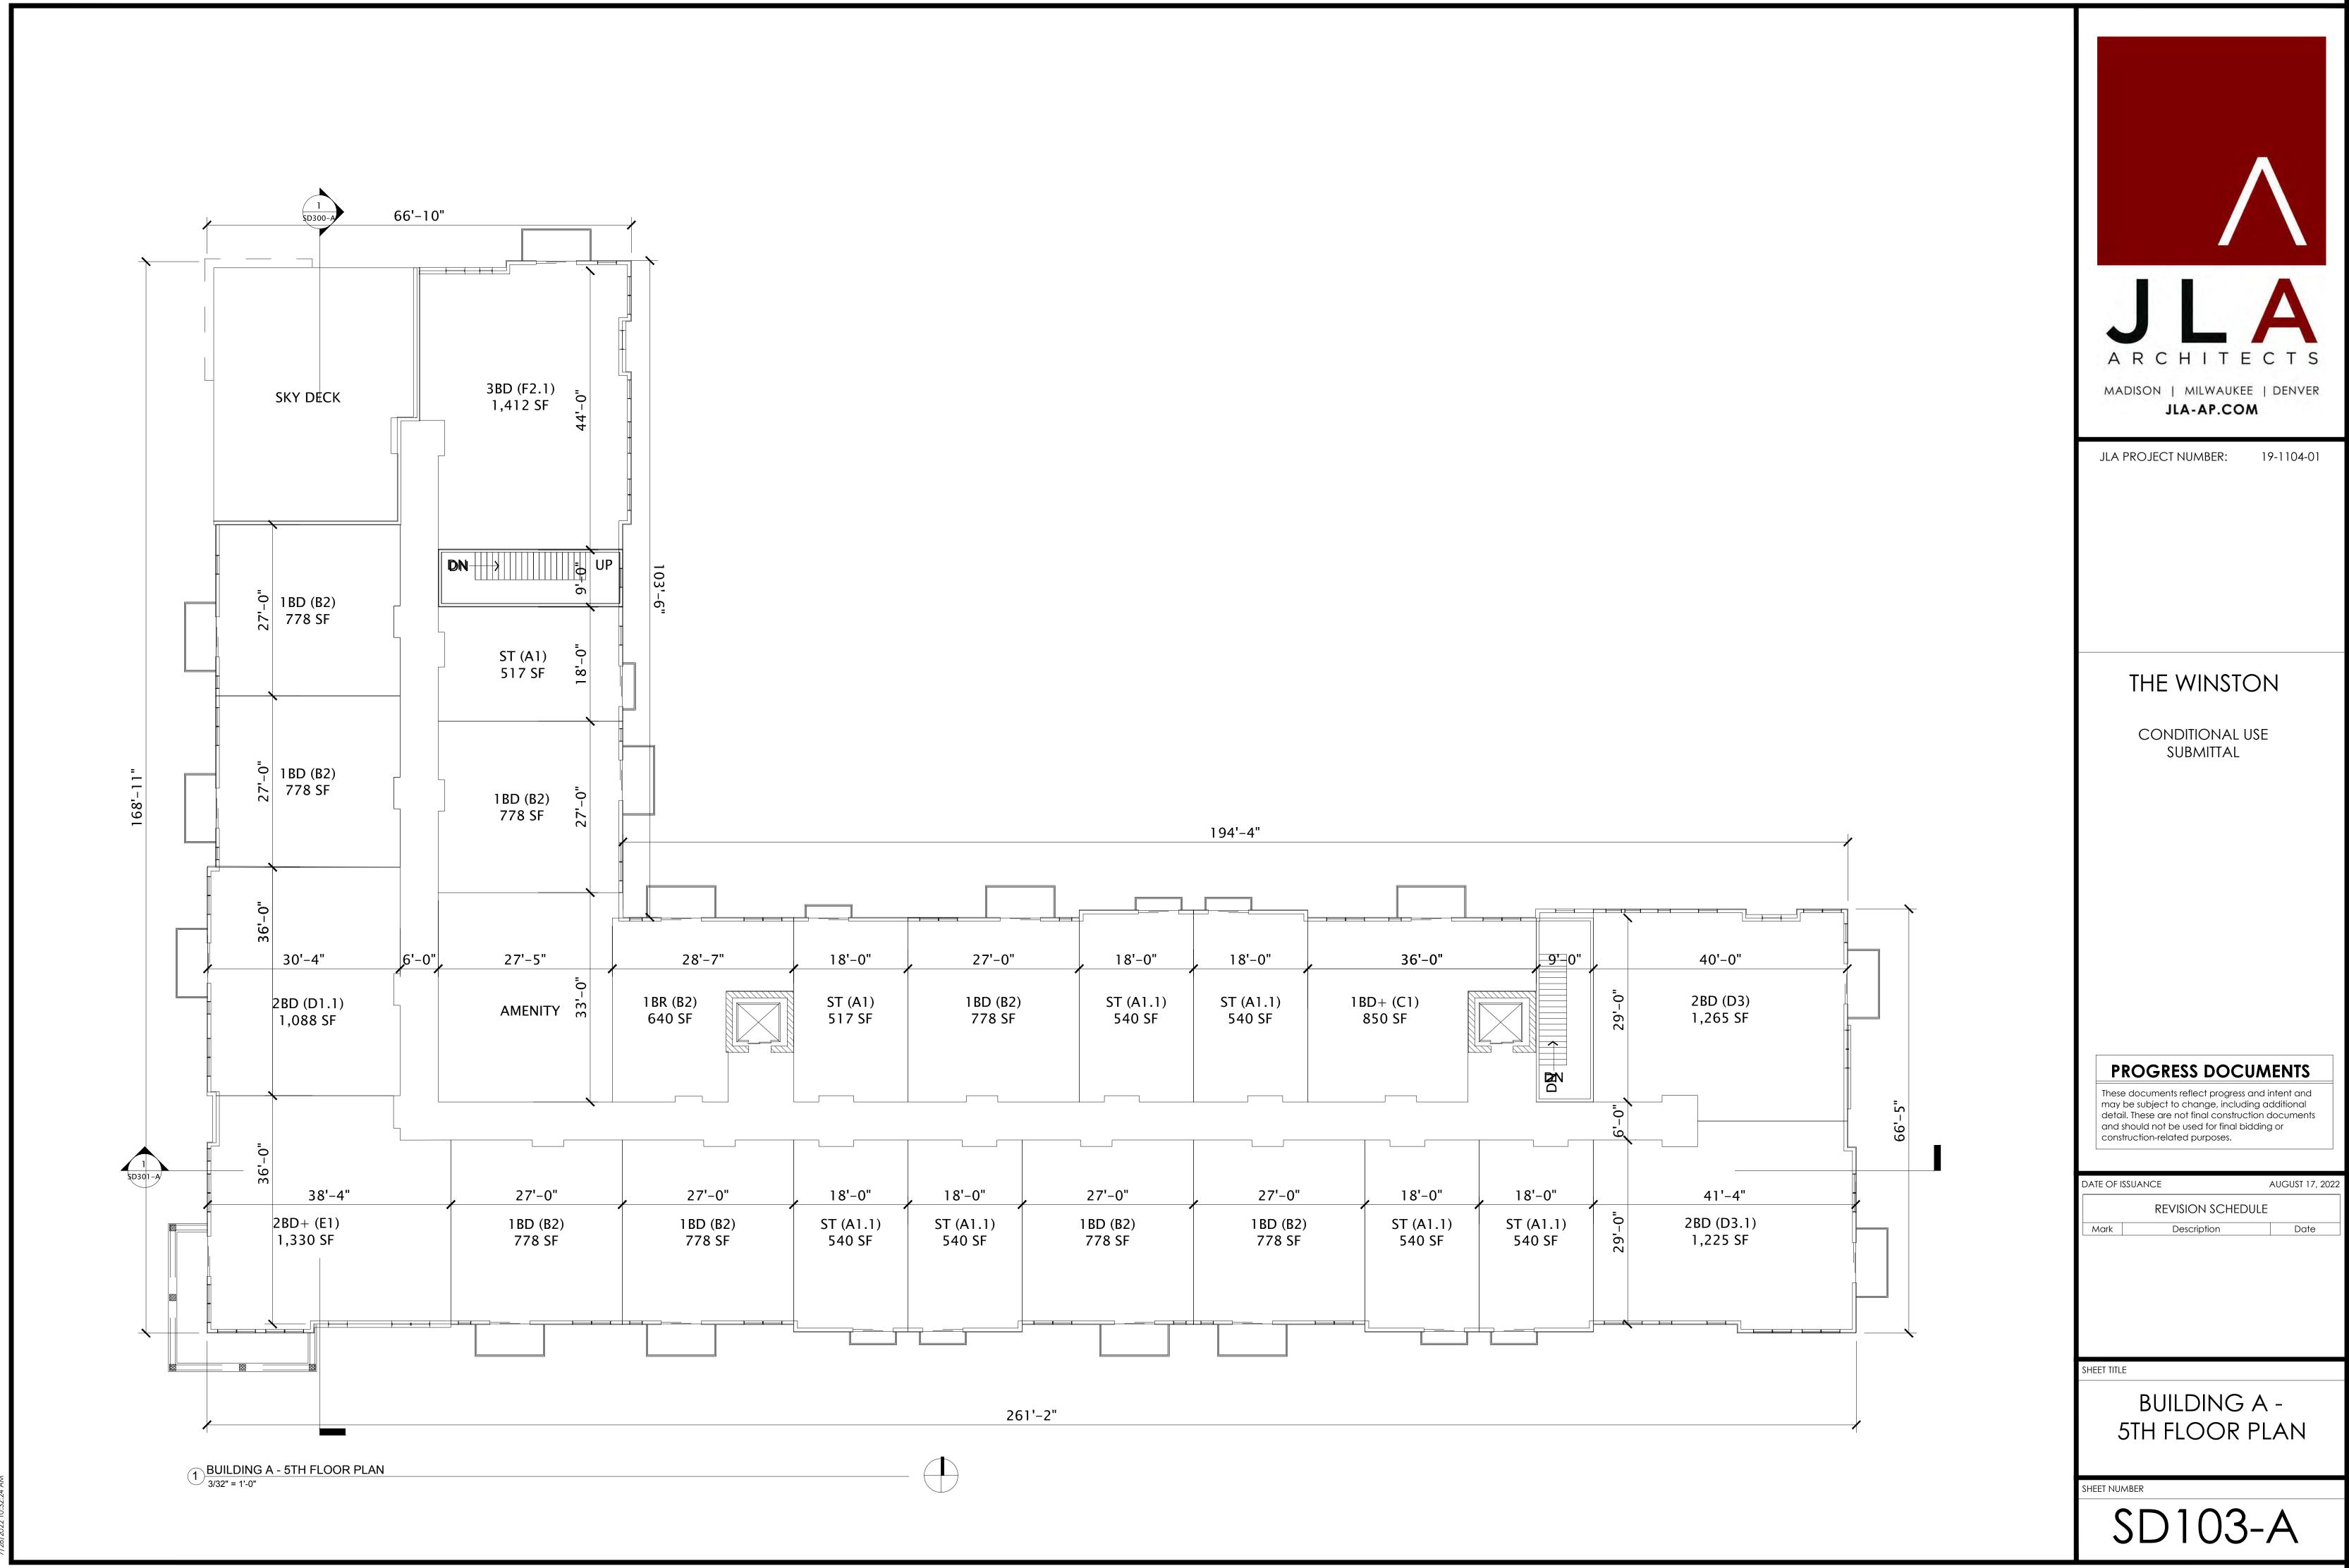

	EXTERIOR MATERIALS SCHEDULE					
MARK	DESCRIPTION	TYPE / STYLE	COLOR			
1	VINYL WINDOWS	LINDSAY WINDOWS & DOORS	BLACK			
2	VINYL PATIO DOORS	LINDSAY WINDOWS & DOORS	BLACK			
3	BALCONY RAILING	PAINTED METAL	BLACK			
4	BALCONY / DECK	COMPOSITE	TBD			
5	BALCONY FASCIA & TRIM	TBD	WALNUT			
6	MASONRY - STONE	DRY STACKED STONE	STAKLEDGE			
7	SIDING - 1 (LIGHT)	ULTRASHIELD	TEAK			
8	SIDING - 1 (DARK)	ULTRASHIELD	WALNUT			
9	DECORATIVE COLUMN	WOOD/WOOD COMPOSITE	TBD			
10	DECORATIVE BEAM	WOOD/WOOD COMPOSITE	TBD			
11	ACCENT CANOPY / ROOF	STANDING SEAM	WALNUT			
12	METAL PANEL	CORRUGATED	GALVANIZED			
13	RESIDENTIAL HVAC LOUVER / GRILLE	EXTRUDED ALUMINUM	PAINT TO MATCH ADJACENT MATERIALS			
14	PRECAST CONCRETE BANDING	PRECAST CONCRETE - SMOOTH FACE	TBD			
16	ALLIMINUM ENTRANCE DOOR(S)	PREFINISHED ALLIMINI IM	BLACK			

BUILDING A - SIGNAG	SE AREA
SIGNAGE TYPE	AREA
WEST ELEVATION	
WALL - RAISED	208 SF



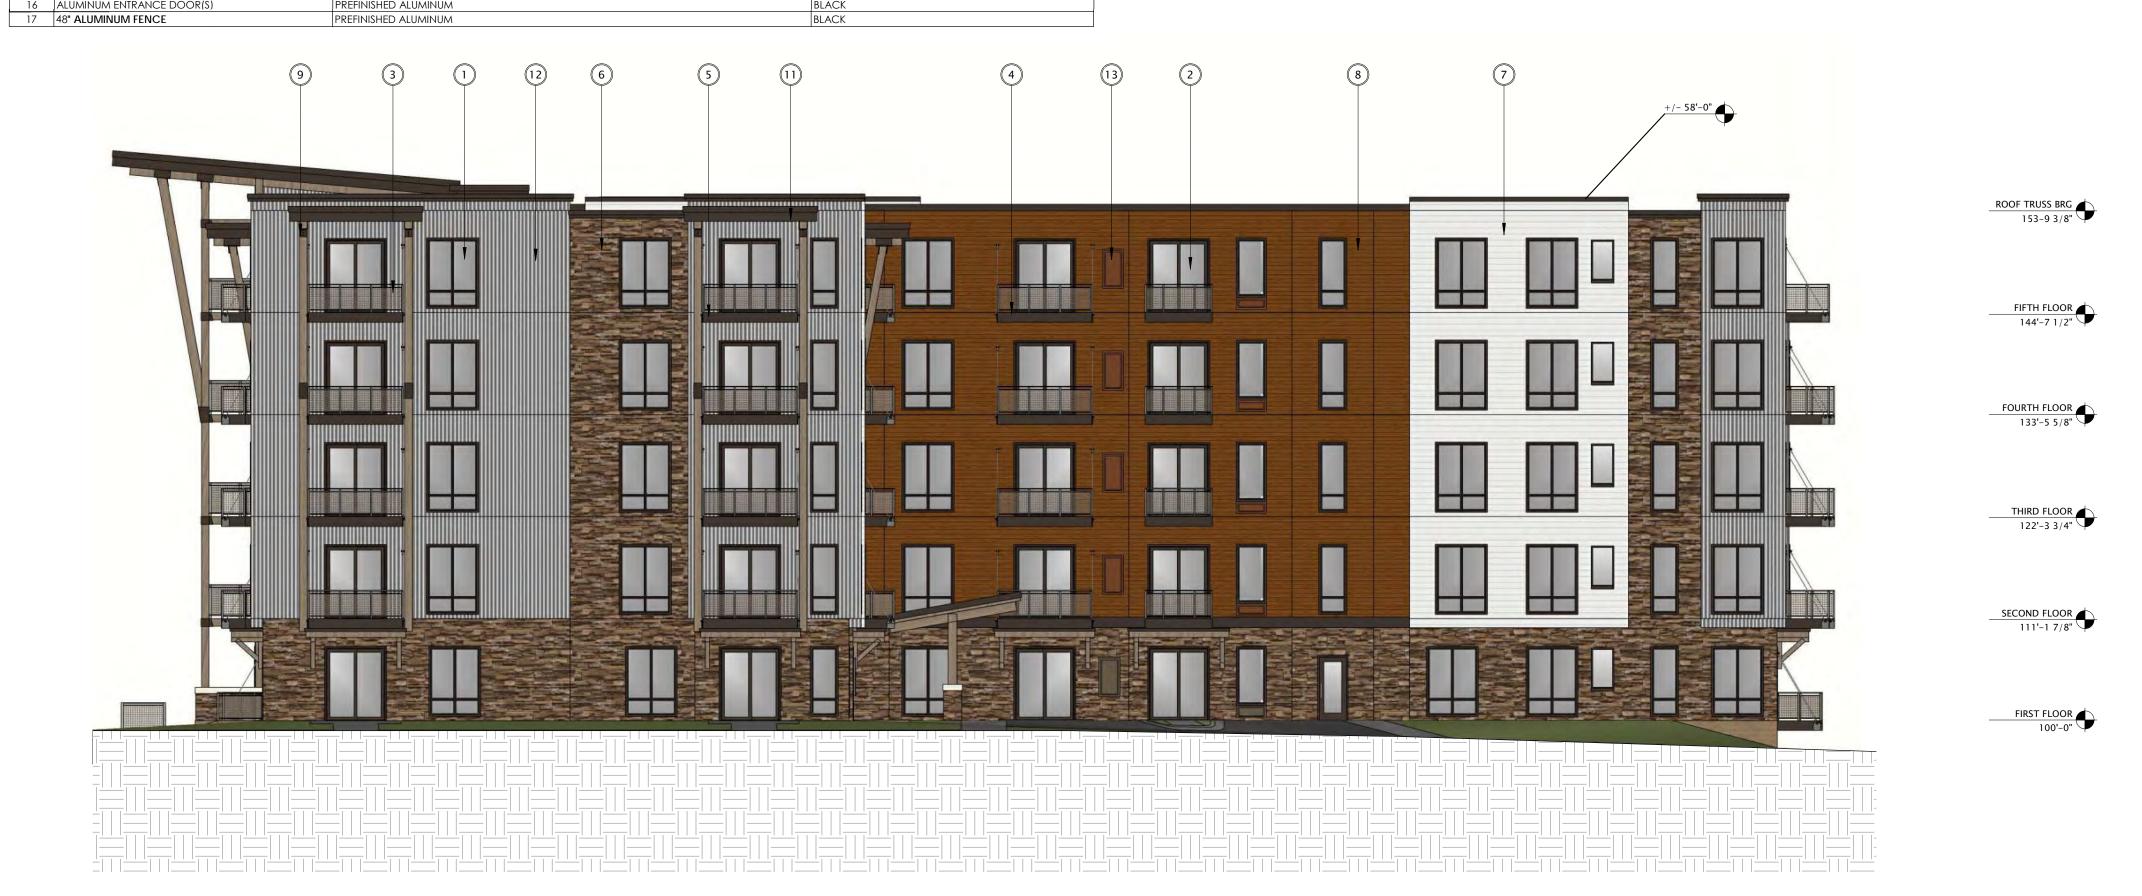



JLA PROJECT NUMBER:

THE WINSTON

19-1104

CONDITIONAL USE SUBMITTAL

PROGRESS DOCUMENTS

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	UGUST 17, 2022
REVISION SCHEDULE	
Mark Description	Date

SHEET

BUILDING A -EXTERIOR ELEVATIONS

SHEET NUMBER

SD201-A



DESCRIPTION	EXTERIOR MATERIALS SCHEDULE TYPE / STYLE COLOR	BUILDING A - SIGNAGE AREA SIGNAGE TYPE AREA
INYL WINDOWS INYL PATIO DOORS ALCONY RAILING ALCONY / DECK	LINDSAY WINDOWS & DOORS LINDSAY WINDOWS & DOORS BLACK PAINTED METAL COMPOSITE BLACK TBD	WEST ELEVATION WALL - RAISED 208 SF
ALCONY FASCIA & TRIM ASONRY - STONE DING - 1 (LIGHT) DING - 1 (DARK)	TBD WALNUT DRY STACKED STONE STAKLEDGE ULTRASHIELD TEAK ULTRASHIELD WALNUT	
CORATIVE COLUMN CORATIVE BEAM CCENT CANOPY / ROOF	WOOD/WOOD COMPOSITE TBD WOOD/WOOD COMPOSITE TBD STANDING SEAM WALNUT	
ETAL PANEL SIDENTIAL HVAC LOUVER / GRILLE ECAST CONCRETE BANDING UMINUM ENTRANCE DOOR(S)	EXTRUDED ALUMINUM PAINT TO MATCH ADJACENT MATERIALS PRECAST CONCRETE - SMOOTH FACE PREFINISHED ALUMINUM BLACK	
BUILDING A - EAST 3/32" = 1'-0"	PREFINSHED ALLIANIM PREFINSHE	FOURTH PLOOF & 113 0 3 4 4 114 0 3 5 4 115 0 3 5 4 116 7 10 7 10 7 10 7 10 7 10 7 10 7 10 7
		1137-9 3/8 ◆ THIS BOX 1137-9 3/8 ◆ THIS BOX 1137-9 3/8 ◆
		SECOND FLOOR 1111-1 7/8* FIRST FLOOR 1007-0*

2 BUILDING A - WEST 1
3/32" = 1'-0"



JLA PROJECT NUMBER:

19-1104

THE WINSTON

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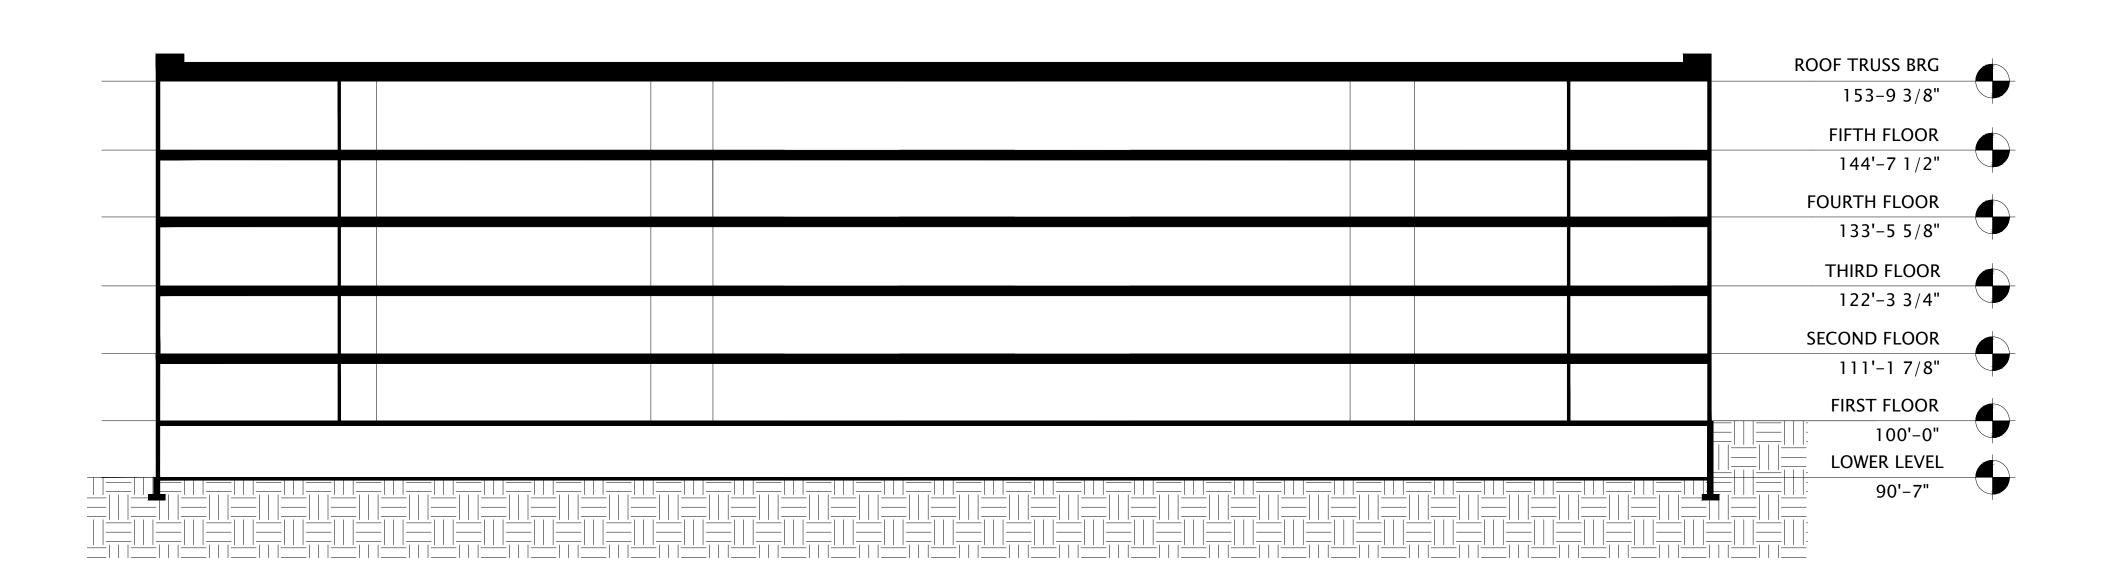
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	REVISION SCHEE	DULE	
Mark	Description	Date	
Mark	Description	Date	

SHEET


BUILDING A -EXTERIOR ELEVATIONS B&W

SHEET NUMBER

SD203-A



1 BUILDING A - SECTION 1 1/16" = 1'-0"

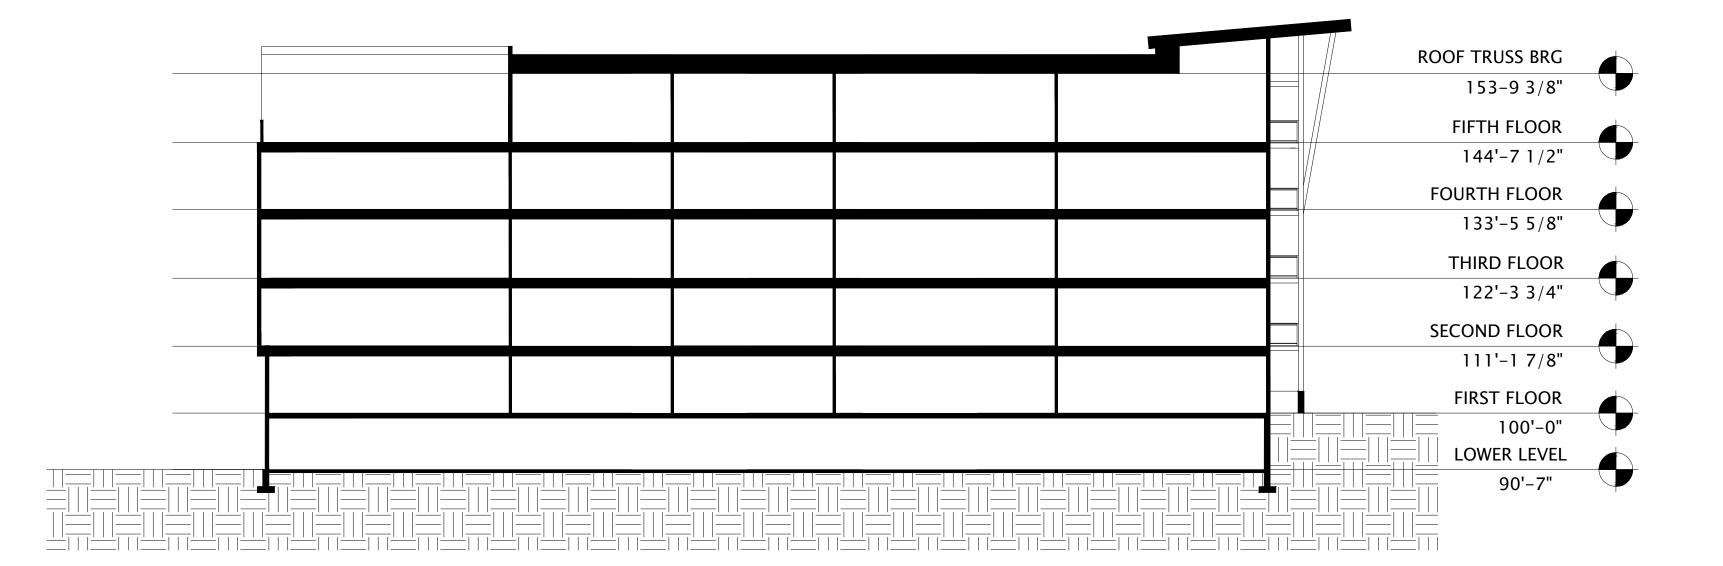

2 BUILDING A - SECTION 2 1/16" = 1'-0"



JLA PROJECT NUMBER: 19-1104-01

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CONDITIONAL USE SUBMITTAL

PROGRESS DOCUMENTS

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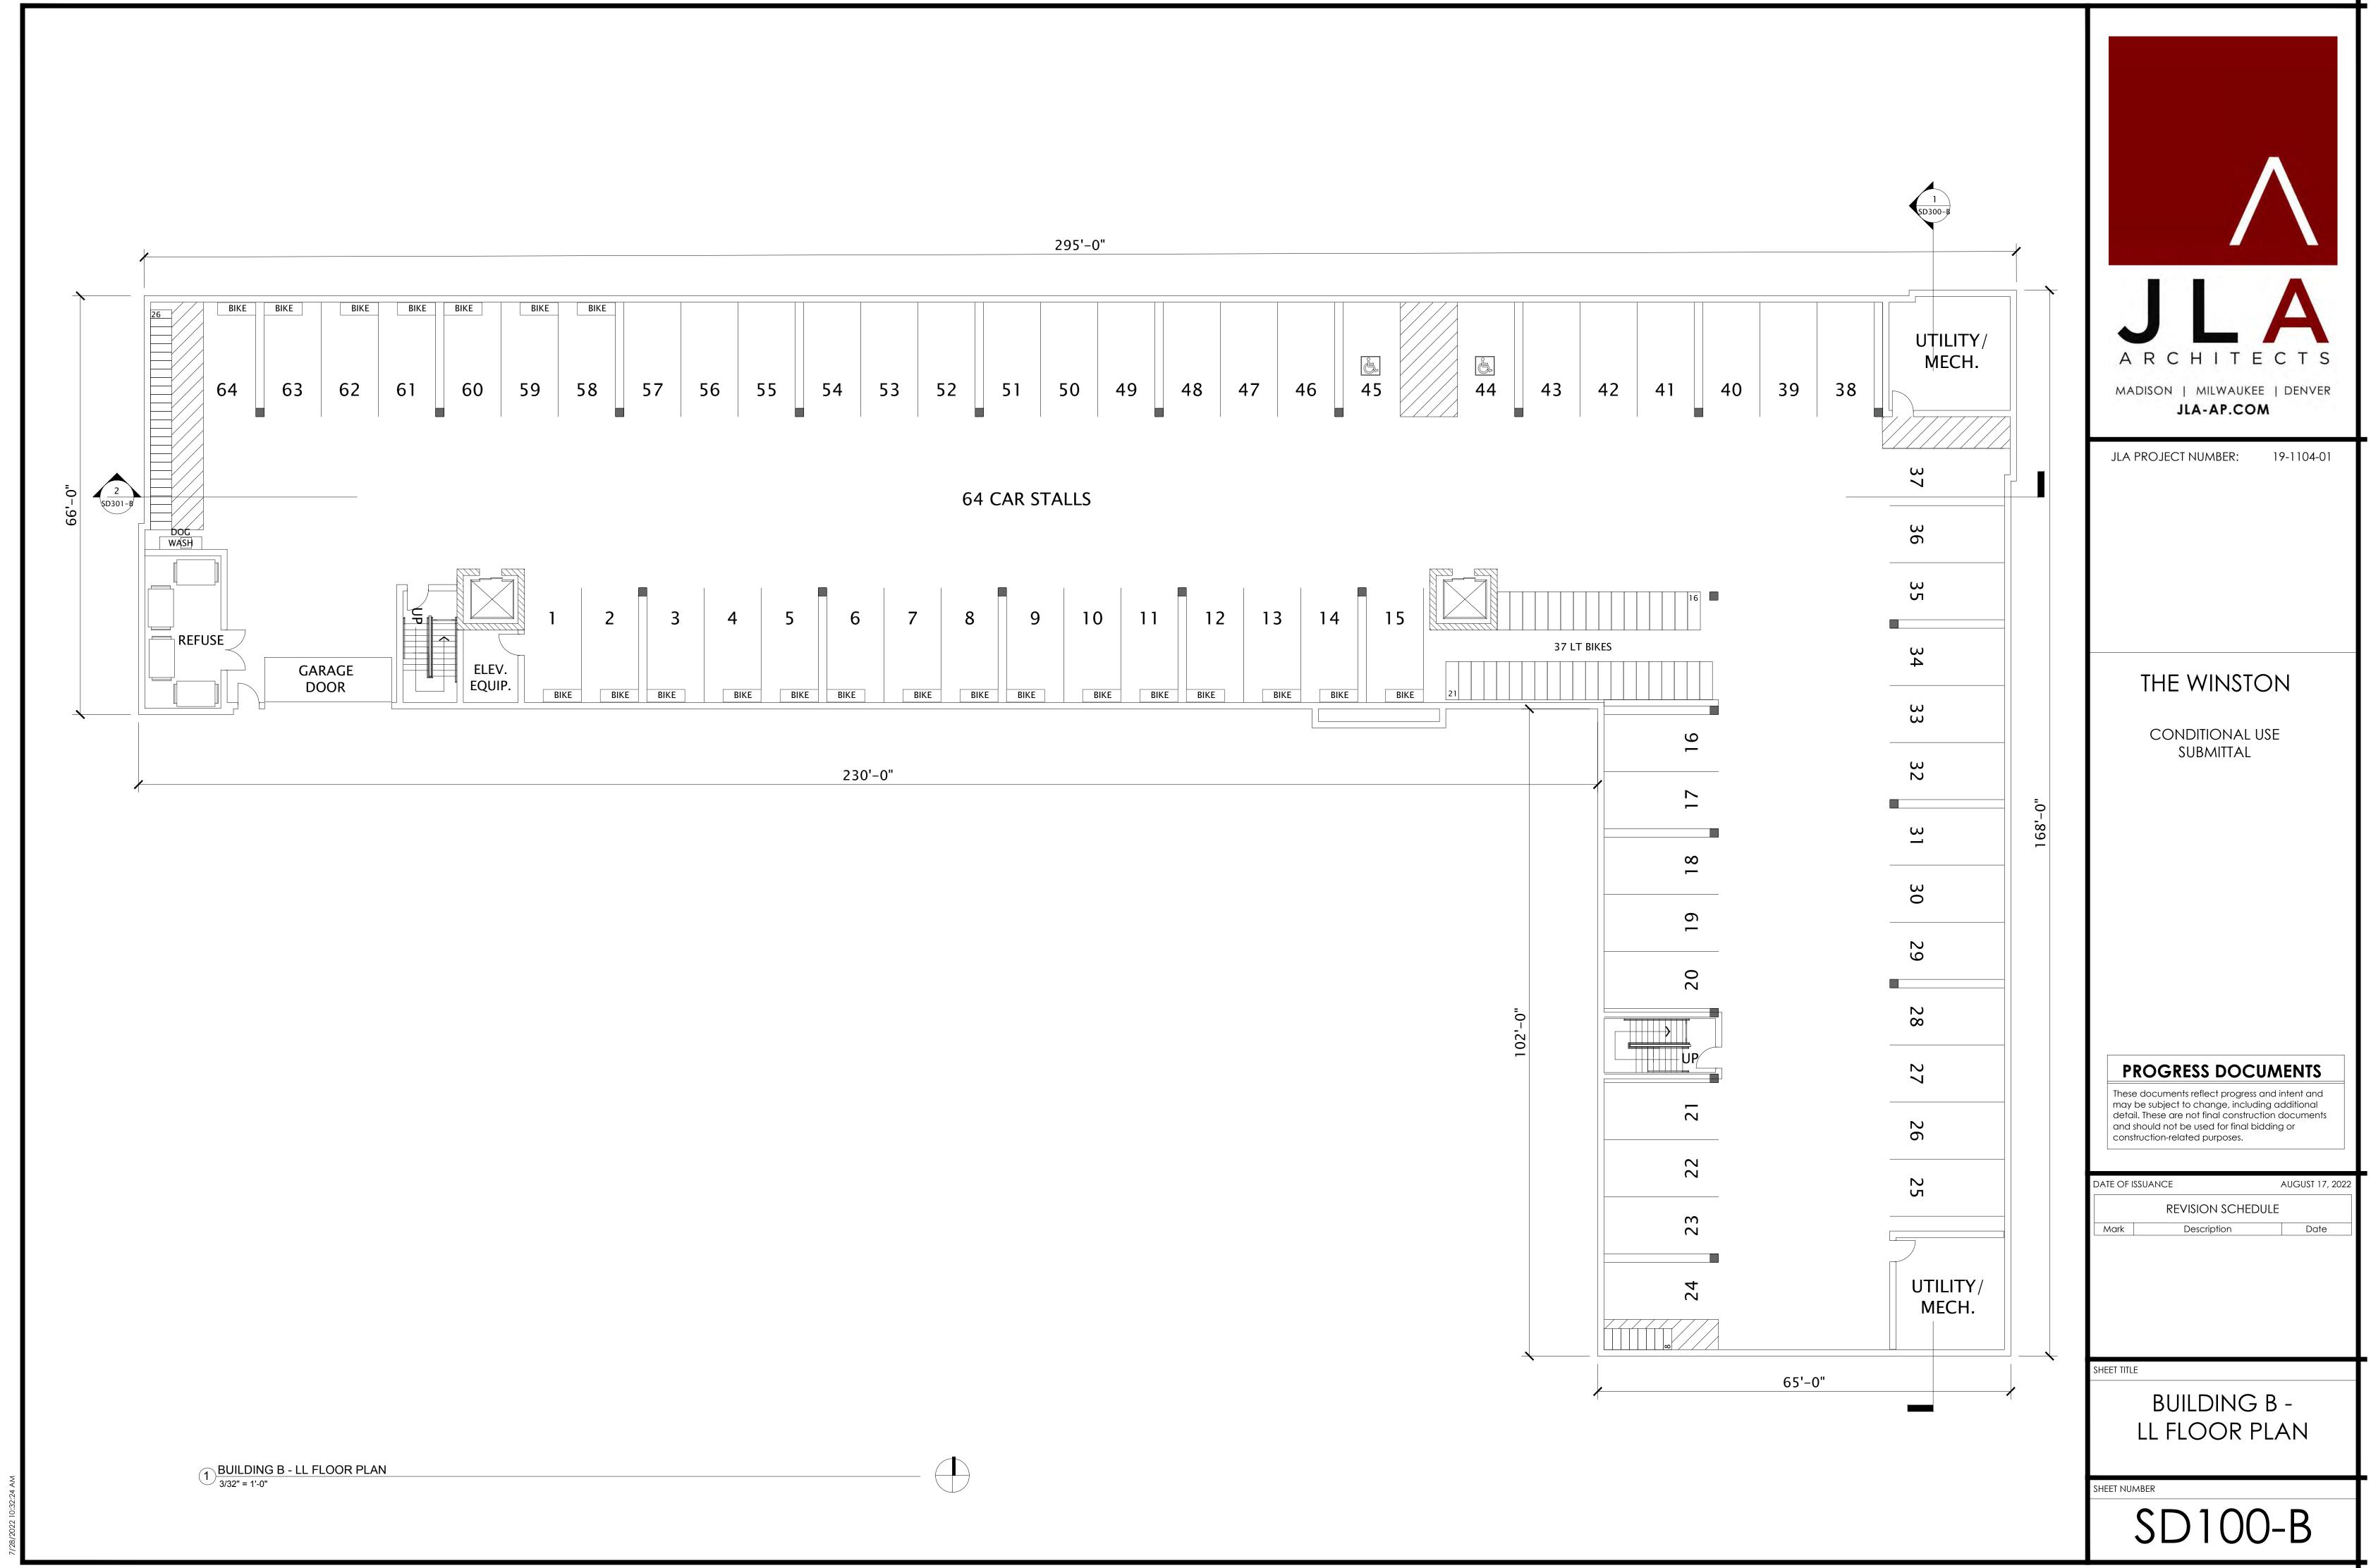
DATE OF ISSUANCE AUGUST 17, 2022 REVISION SCHEDULE Date Mark Description


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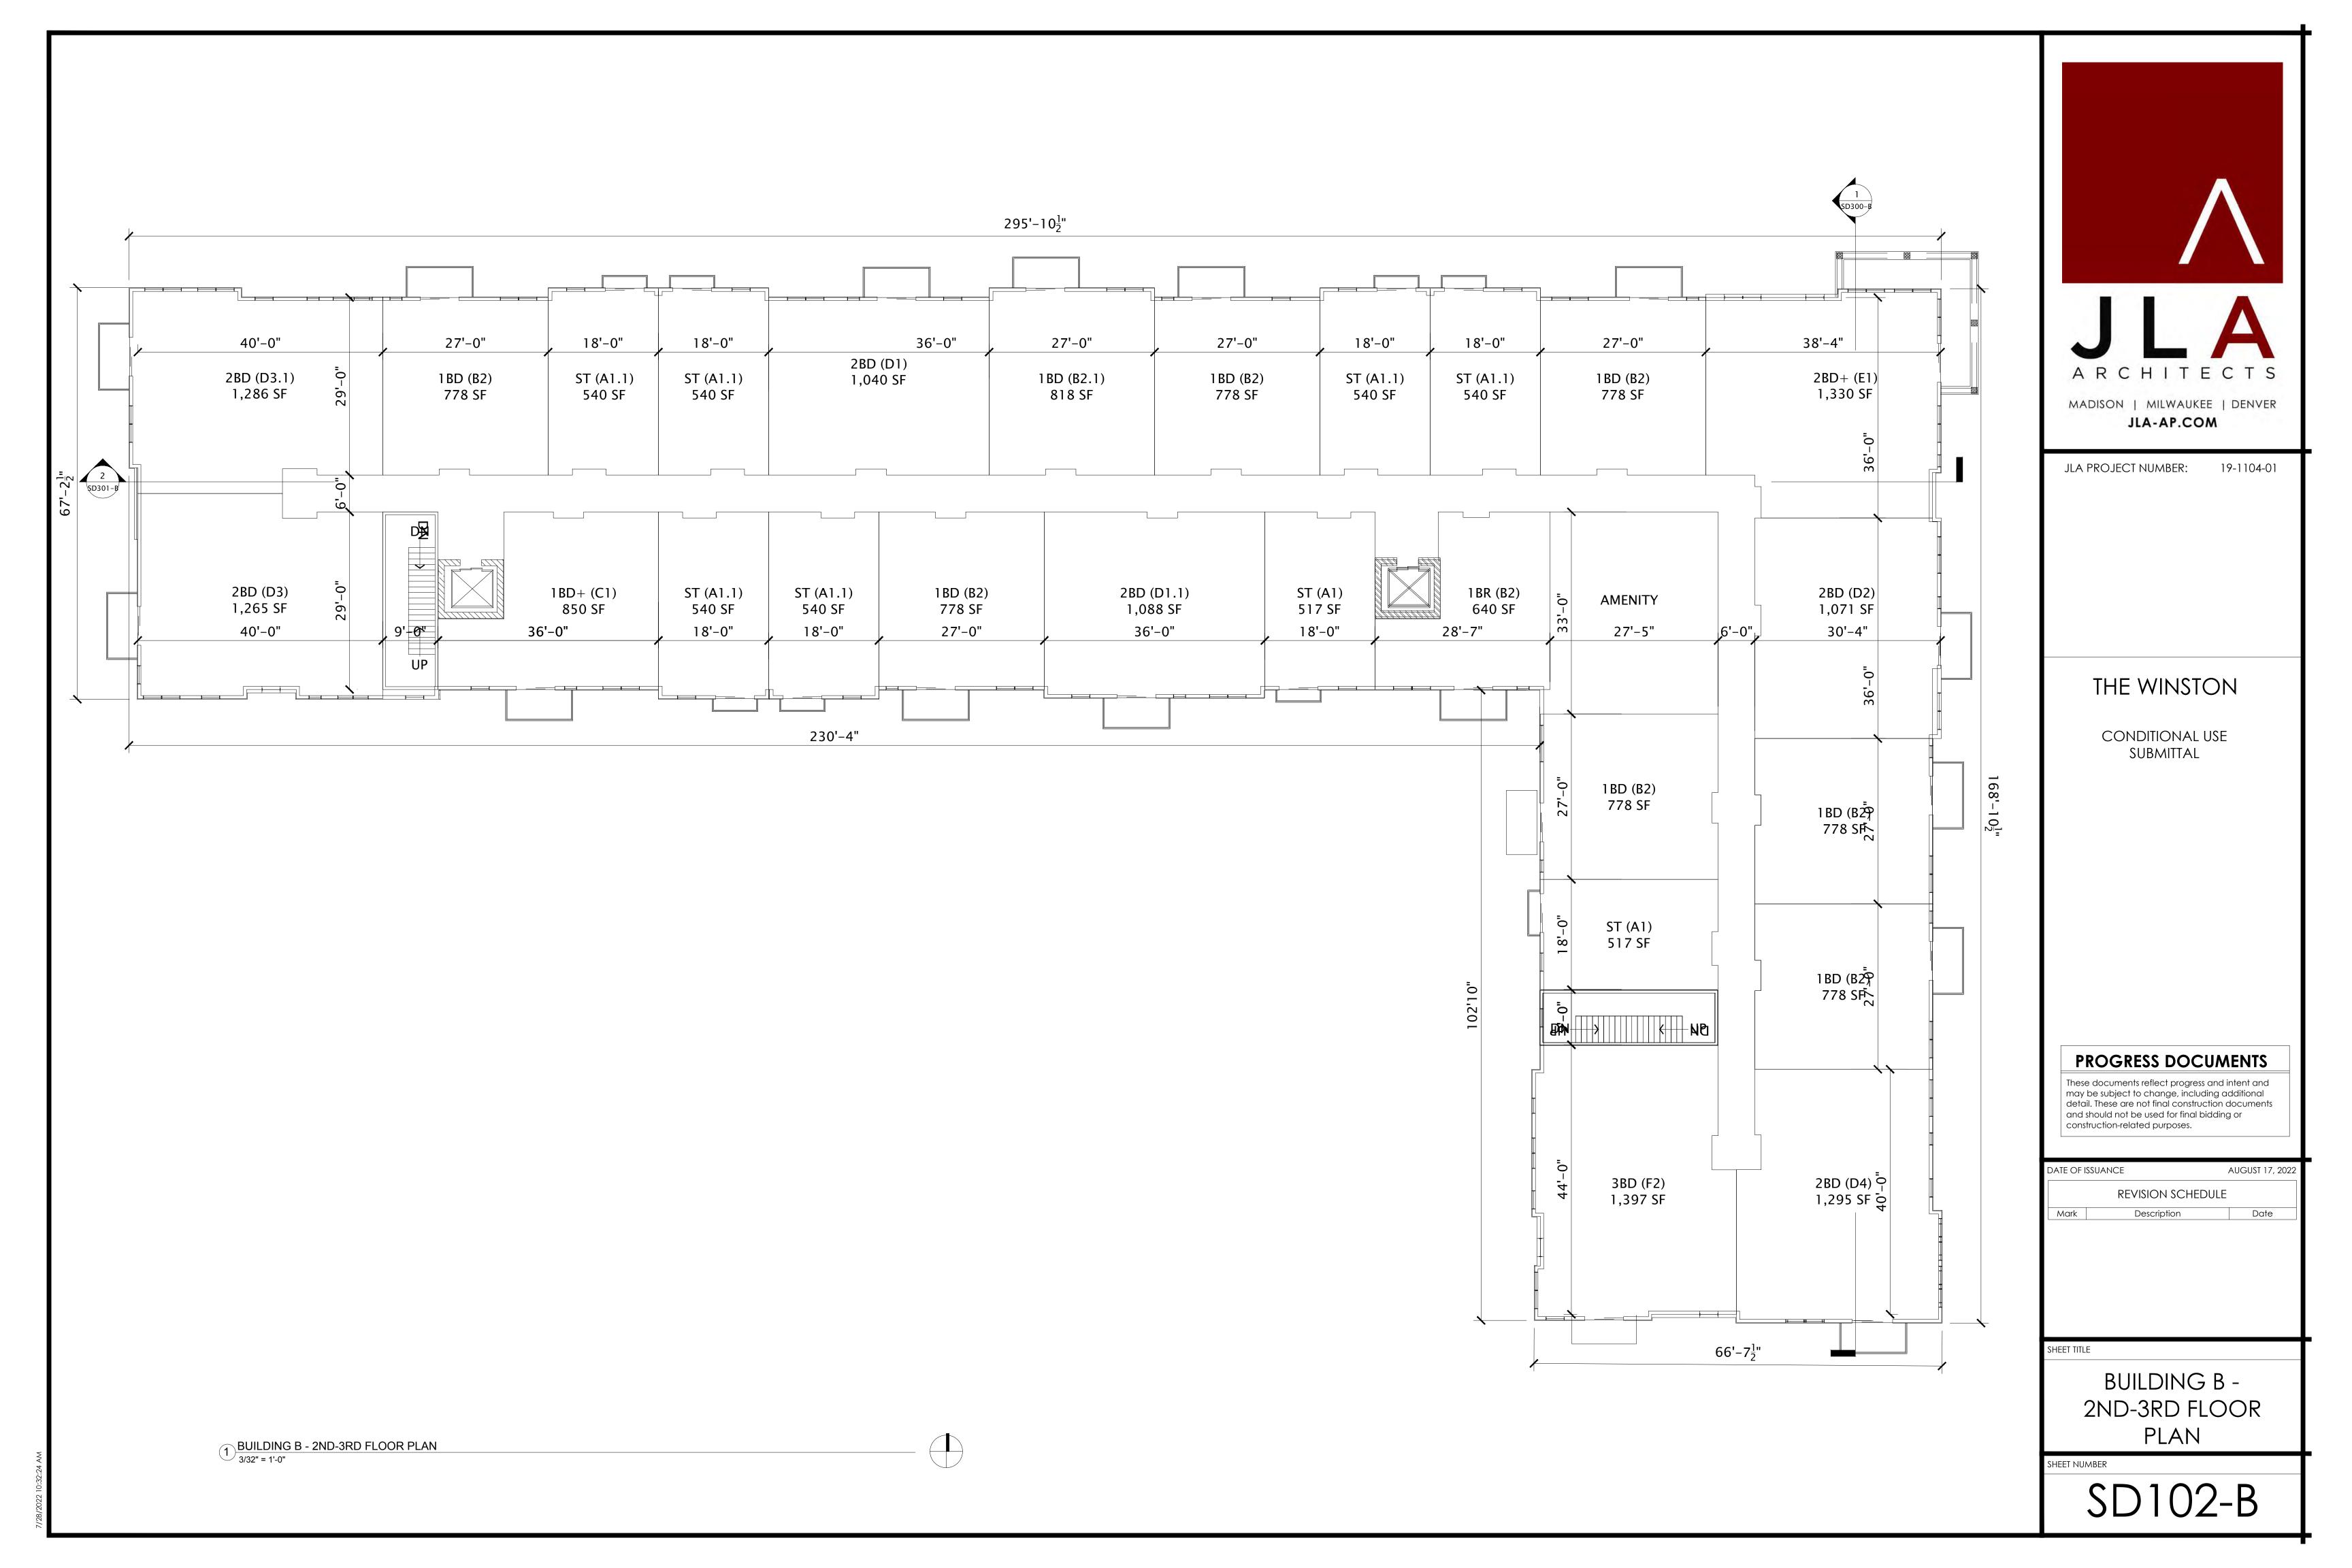
BUILDING A -SECTIONS


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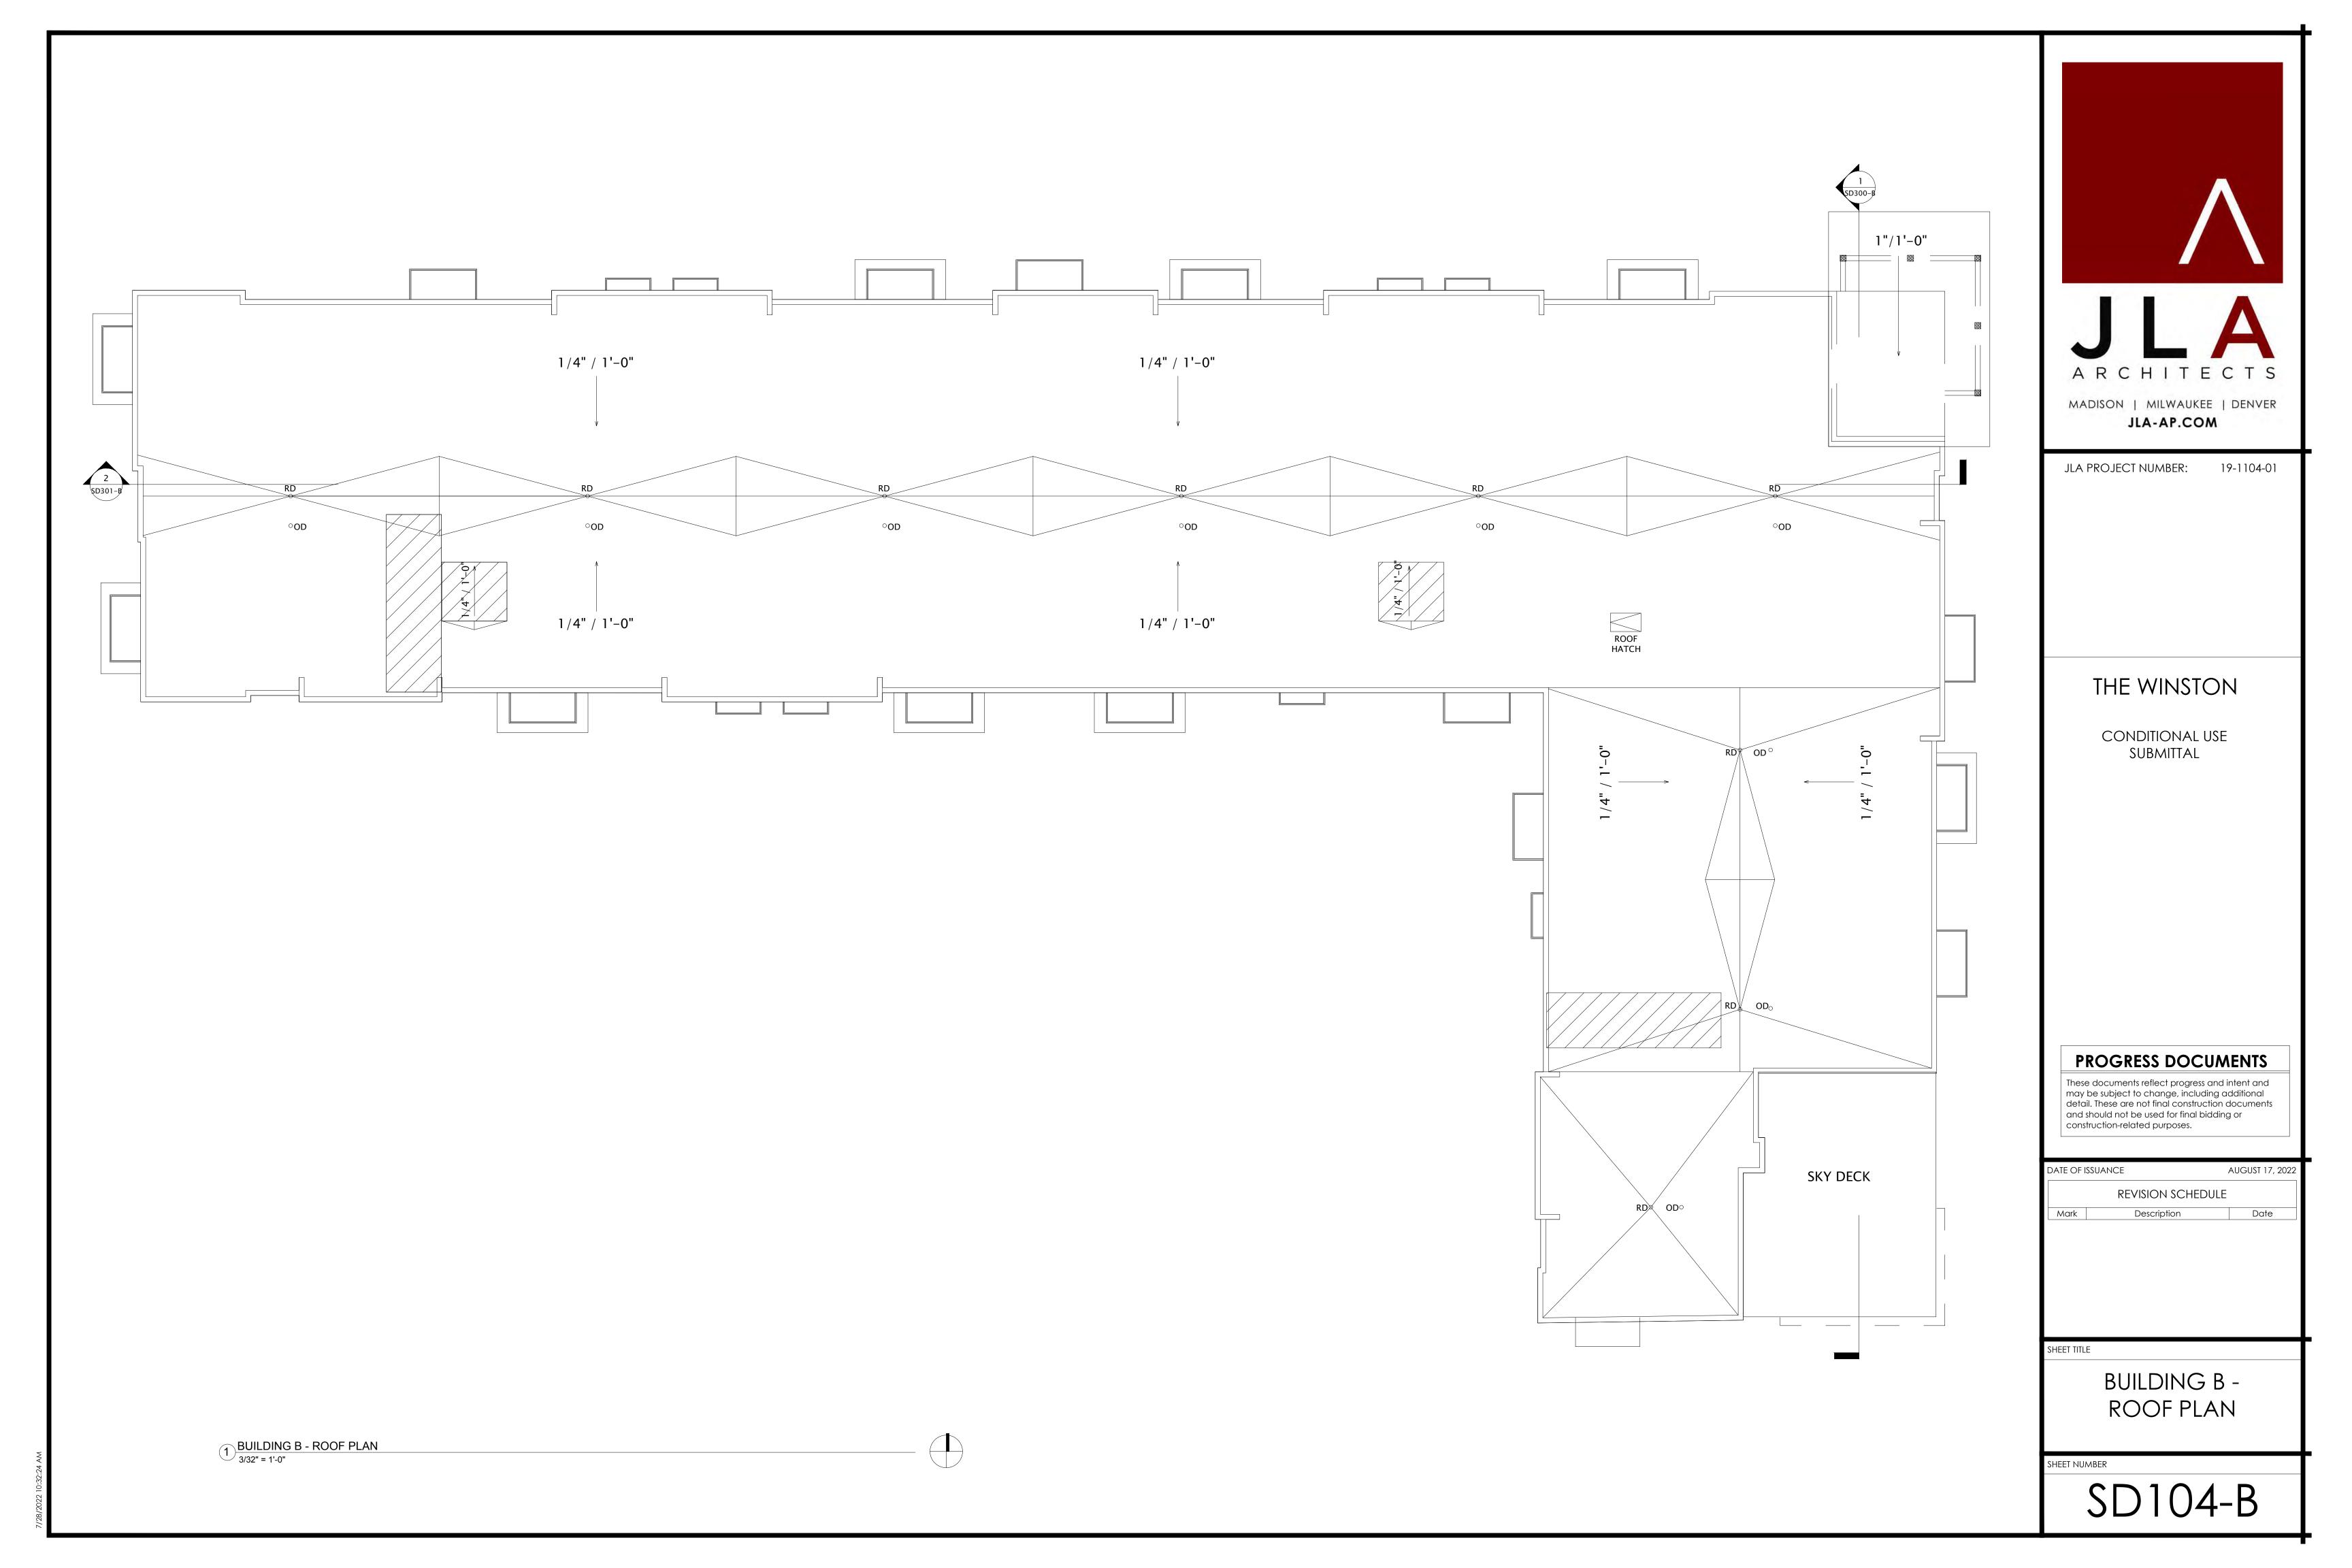
SD300-A







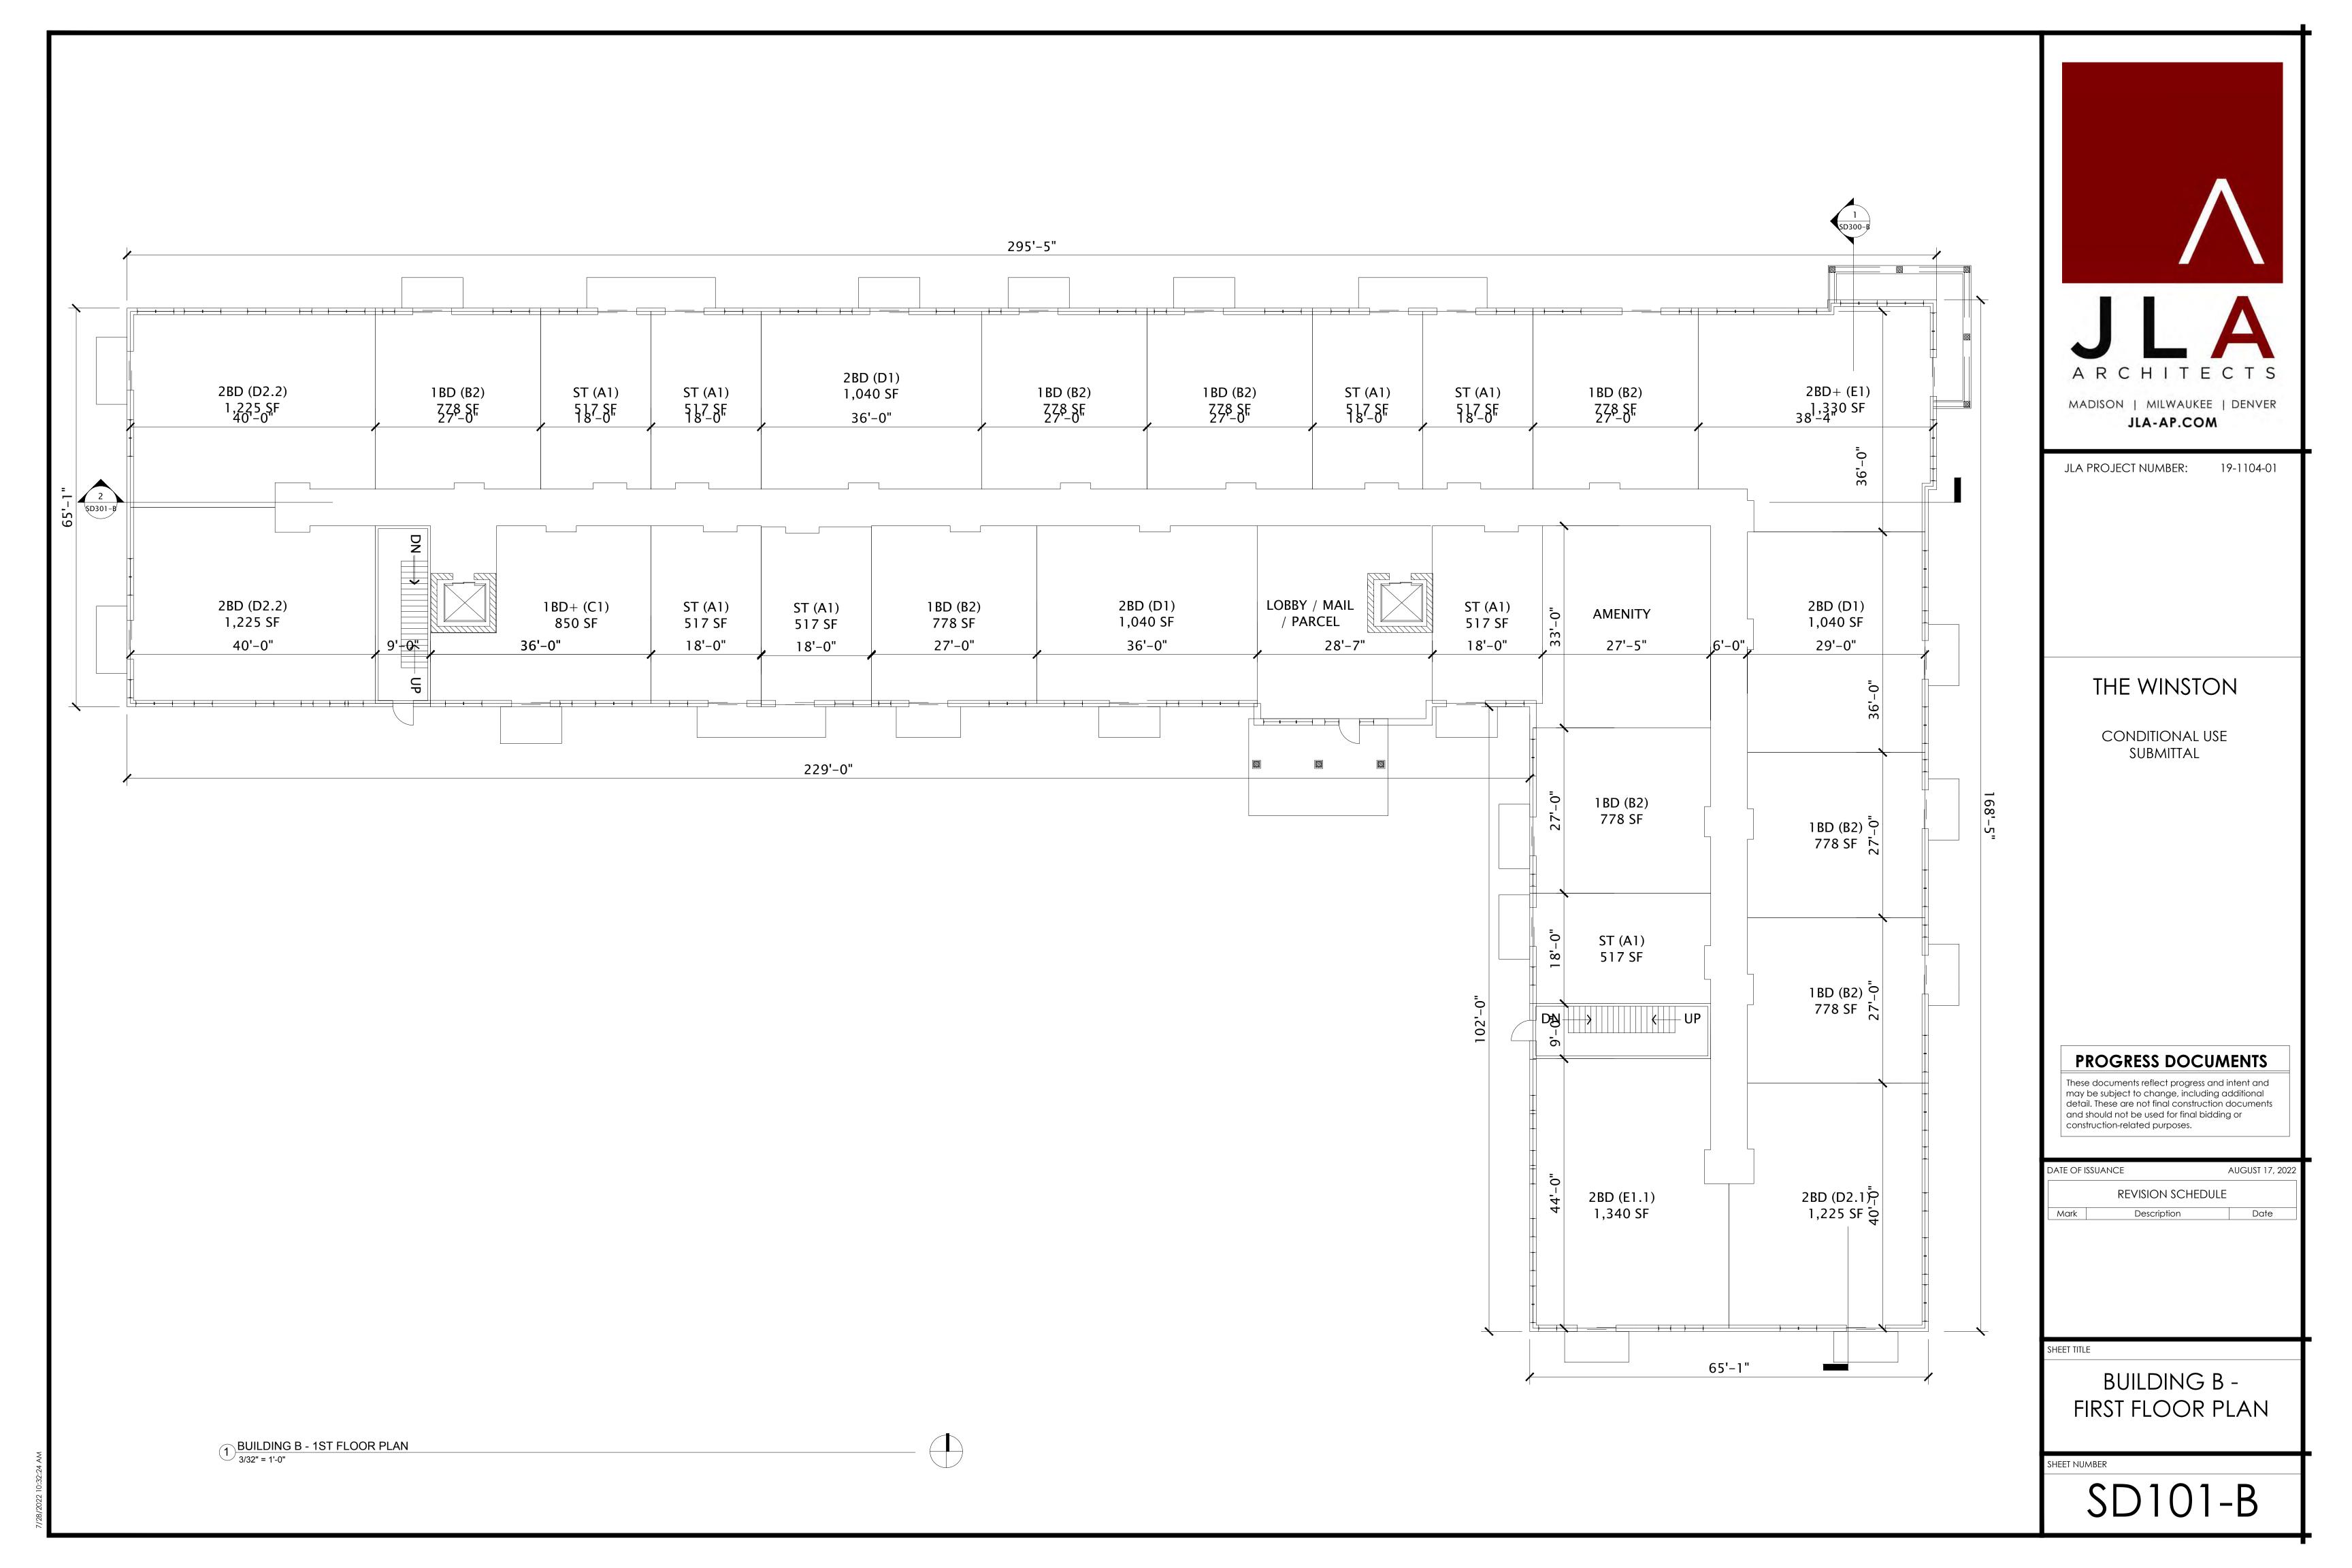

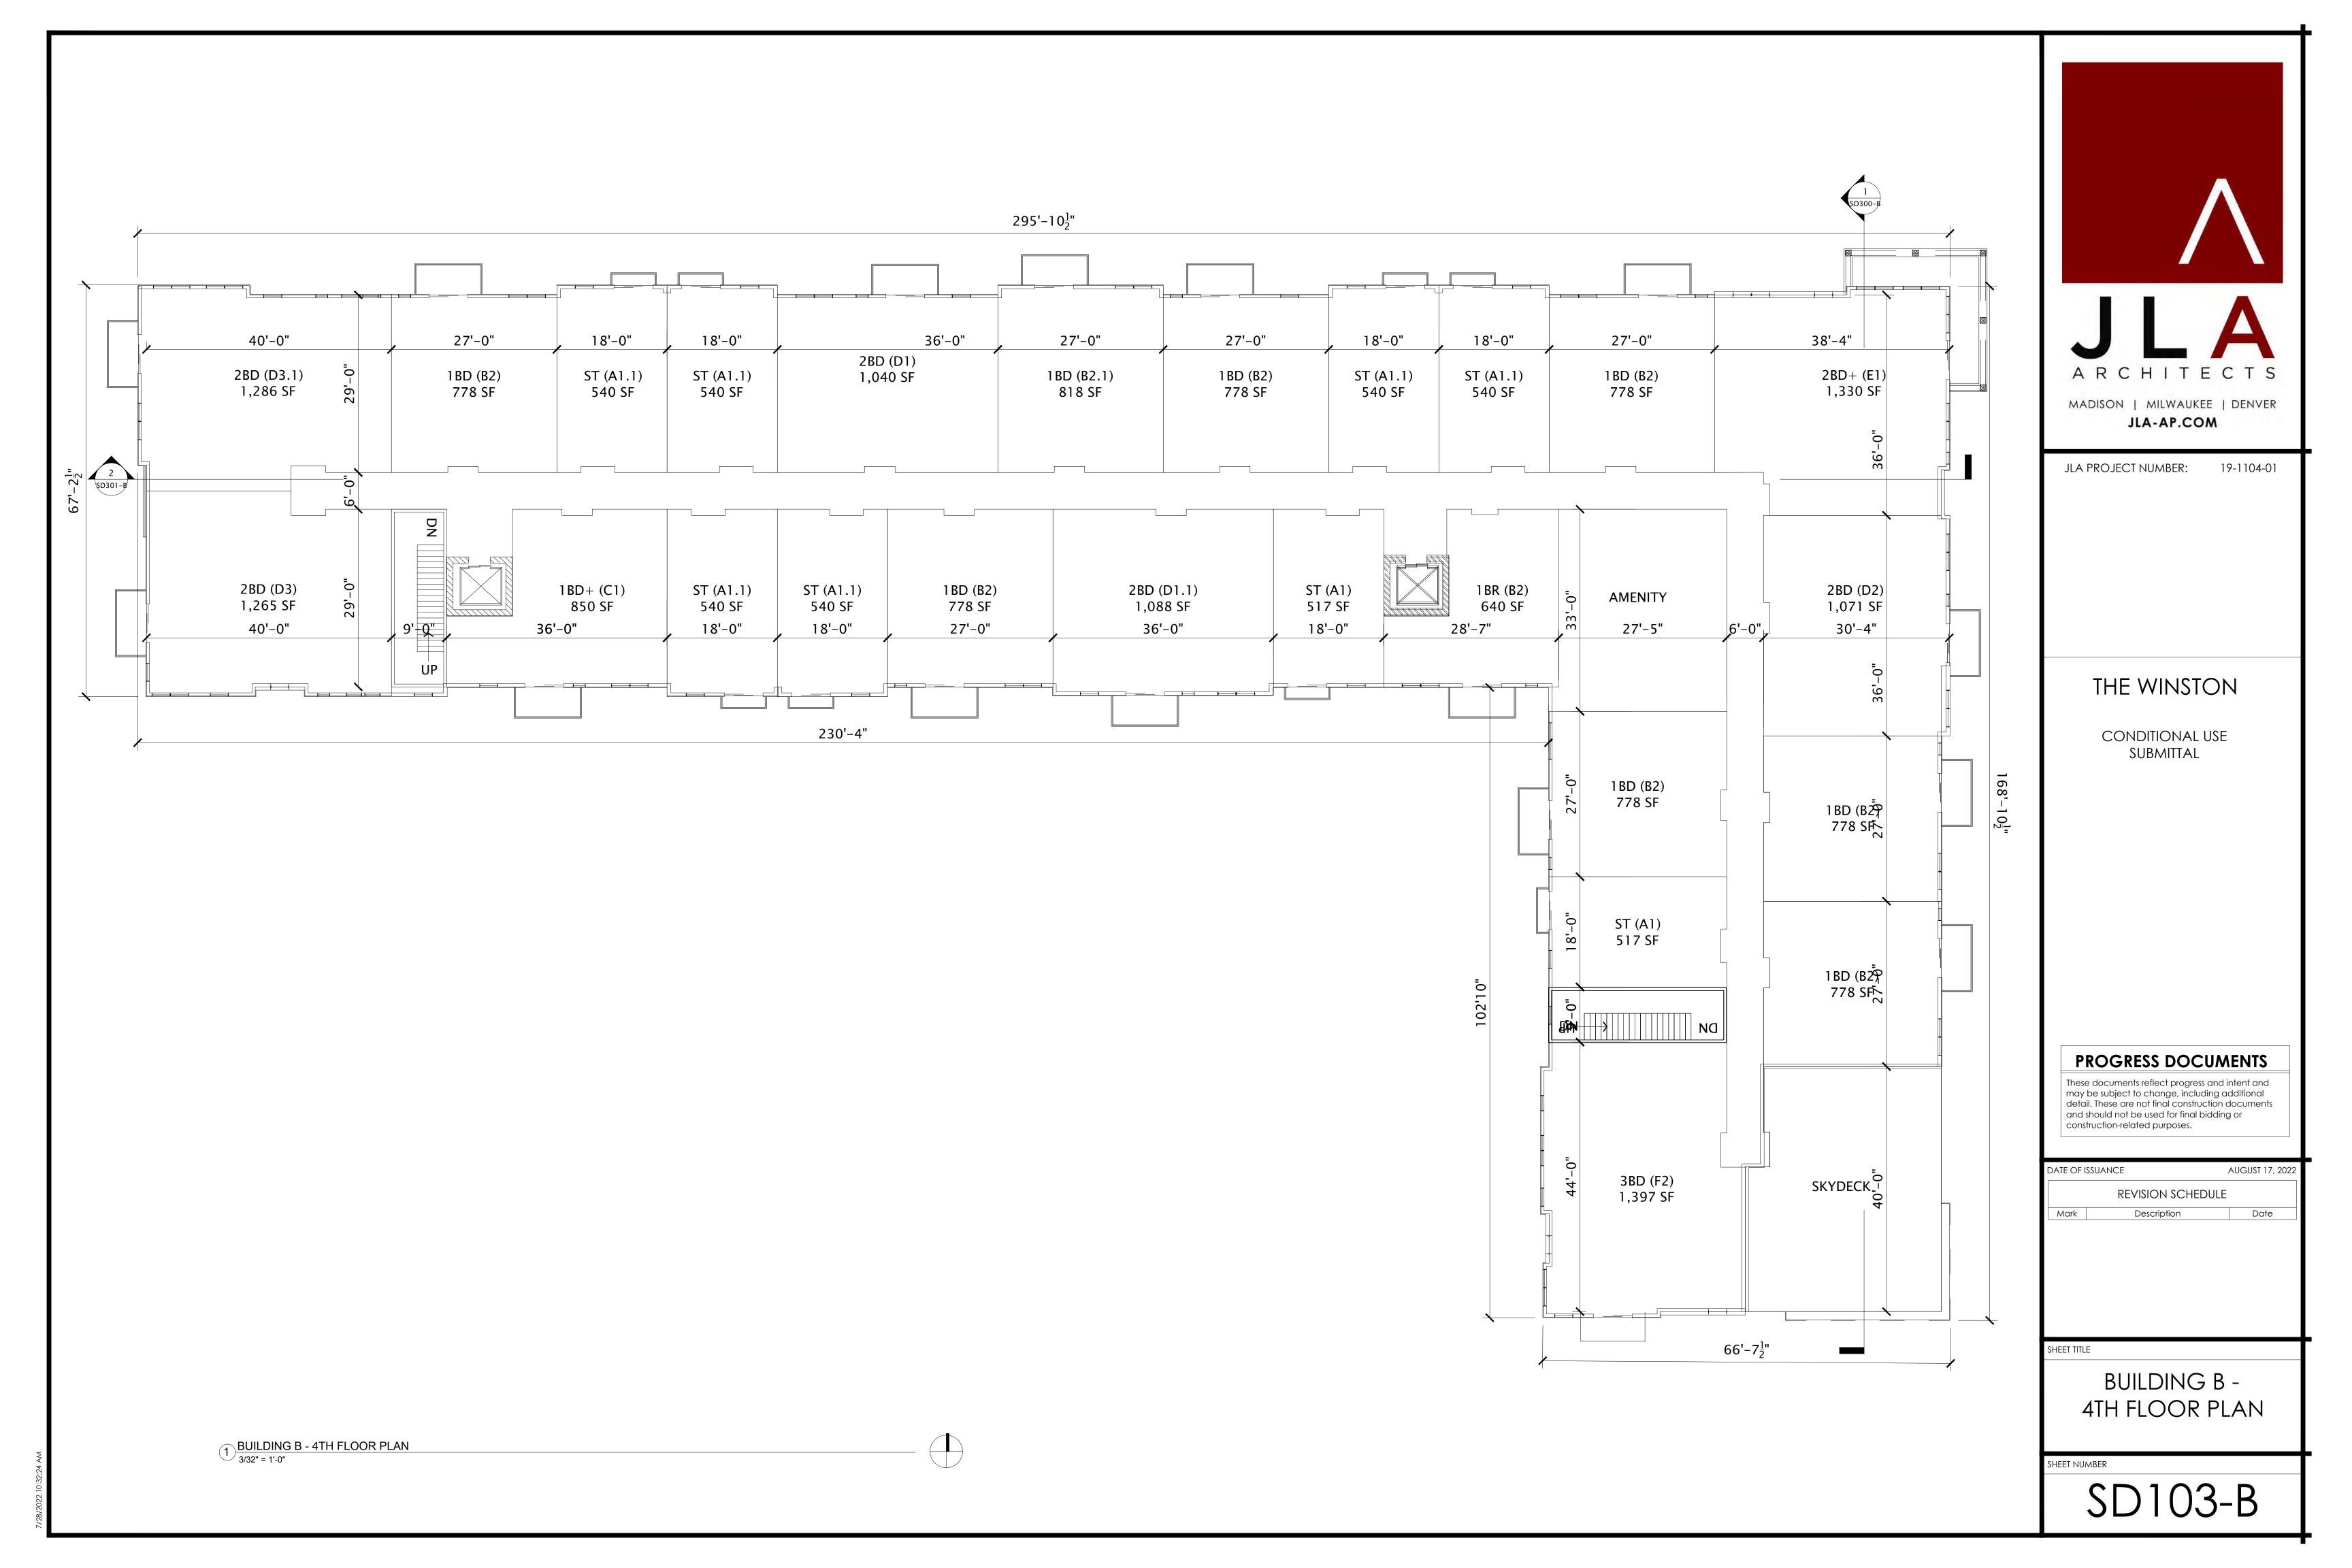



2 BUILDING B - SOUTH
3/32" = 1'-0"

SD200-B

EXTERIOR MATERIALS SCHEDULE			
MARK	DESCRIPTION	TYPE / STYLE	COLOR
1	VINYL WINDOWS	LINDSAY WINDOWS & DOORS	BLACK
2	VINYL PATIO DOORS	LINDSAY WINDOWS & DOORS	BLACK
3	BALCONY RAILING	PAINTED METAL	BLACK
4	BALCONY / DECK	COMPOSITE	TBD
5	BALCONY FASCIA & TRIM	TBD	WALNUT
6	MASONRY - STONE	DRY STACKED STONE	STAKLEDGE
7	SIDING - 1 (LIGHT)	ULTRASHIELD	TEAK
8	SIDING - 1 (DARK)	ULTRASHIELD	WALNUT
9	DECORATIVE COLUMN	WOOD/WOOD COMPOSITE	TBD
10	DECORATIVE BEAM	WOOD/WOOD COMPOSITE	TBD
11	ACCENT CANOPY / ROOF	STANDING SEAM	WALNUT
12	METAL PANEL	CORRUGATED	GALVANIZED
13	RESIDENTIAL HVAC LOUVER / GRILLE	EXTRUDED ALUMINUM	PAINT TO MATCH ADJACENT MATERIALS
14	PRECAST CONCRETE BANDING	PRECAST CONCRETE - SMOOTH FACE	TBD
16	ALUMINUM ENTRANCE DOOR(S)	PREFINISHED ALUMINUM	BLACK


BUILDING B - SIGNAGE AREA		
SIGNAGE TYPE	AREA	
WEST ELEVATION		
WALL - RAISED	208 SF	



BUILDING B - EAST

3/32" = 1'-0"



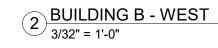



JLA PROJECT NUMBER:

THE WINSTON

19-1104

CONDITIONAL USE SUBMITTAL

PROGRESS DOCUMENTS

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DATE OF ISSUANCE		AUGUST 17, 2022	
	REVISION SCHEDI	JLE	
Mark	Description	Date	
Mark	Description	Date	

SHEET TIT

BUILDING B - EXTERIOR ELEVATIONS B&W

SHEET NUMBER

SD201-B



EXTERIOR MATERIALS SCHEDULE			
MARK	DESCRIPTION	TYPE / STYLE	COLOR
1	VINYL WINDOWS	LINDSAY WINDOWS & DOORS	BLACK
2	VINYL PATIO DOORS	LINDSAY WINDOWS & DOORS	BLACK
3	BALCONY RAILING	PAINTED METAL	BLACK
4	BALCONY / DECK	COMPOSITE	TBD
5	BALCONY FASCIA & TRIM	TBD	WALNUT
6	MASONRY - STONE	DRY STACKED STONE	STAKLEDGE
7	SIDING - 1 (LIGHT)	ULTRASHIELD	TEAK
8	SIDING - 1 (DARK)	ULTRASHIELD	WALNUT
9	DECORATIVE COLUMN	WOOD/WOOD COMPOSITE	TBD
10	DECORATIVE BEAM	WOOD/WOOD COMPOSITE	TBD
11	ACCENT CANOPY / ROOF	STANDING SEAM	WALNUT
12	METAL PANEL	CORRUGATED	GALVANIZED
13	RESIDENTIAL HVAC LOUVER / GRILLE	EXTRUDED ALUMINUM	PAINT TO MATCH ADJACENT MATERIALS
14	PRECAST CONCRETE BANDING	PRECAST CONCRETE - SMOOTH FACE	TBD
1.6	ALLIMINIUM ENTRANCE DOOR(S)	PREEINISHED ALLIMINIUM	BI ACK

BUILDING B - SIGNAGE AREA		
SIGNAGE TYPE	AREA	
WEST ELEVATION		
WALL - RAISED	208 SF	



1 BUILDING B - EAST 1
3/32" = 1'-0"



2 BUILDING B - WEST 1
3/32" = 1'-0"



JLA PROJECT NUMBER:

19-1104

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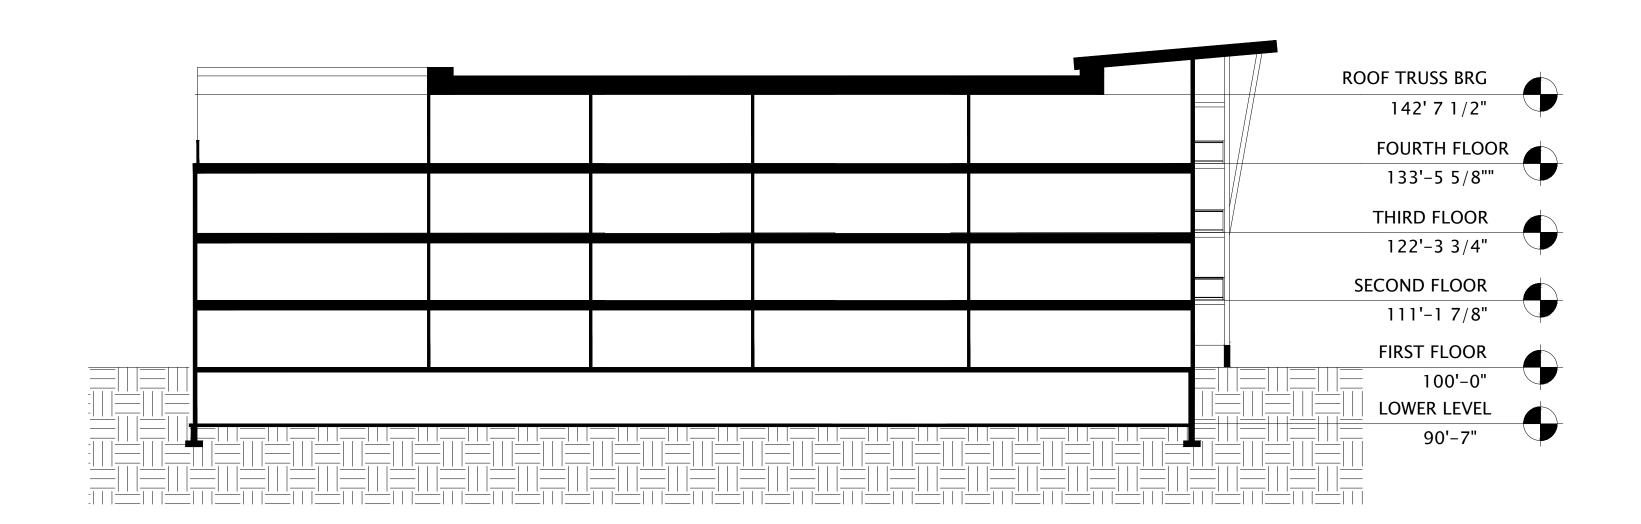
DATE OF ISSUANCE A		UGUST 17, 2022		
	REVISION SCHEDULE			
Mark	Description	Date		

SHEET TIT


BUILDING B - EXTERIOR ELEVATIONS BW

SHEET NUMBER

SD203-B



1) BUILDING B - SECTION 1
1/16" = 1'-0"

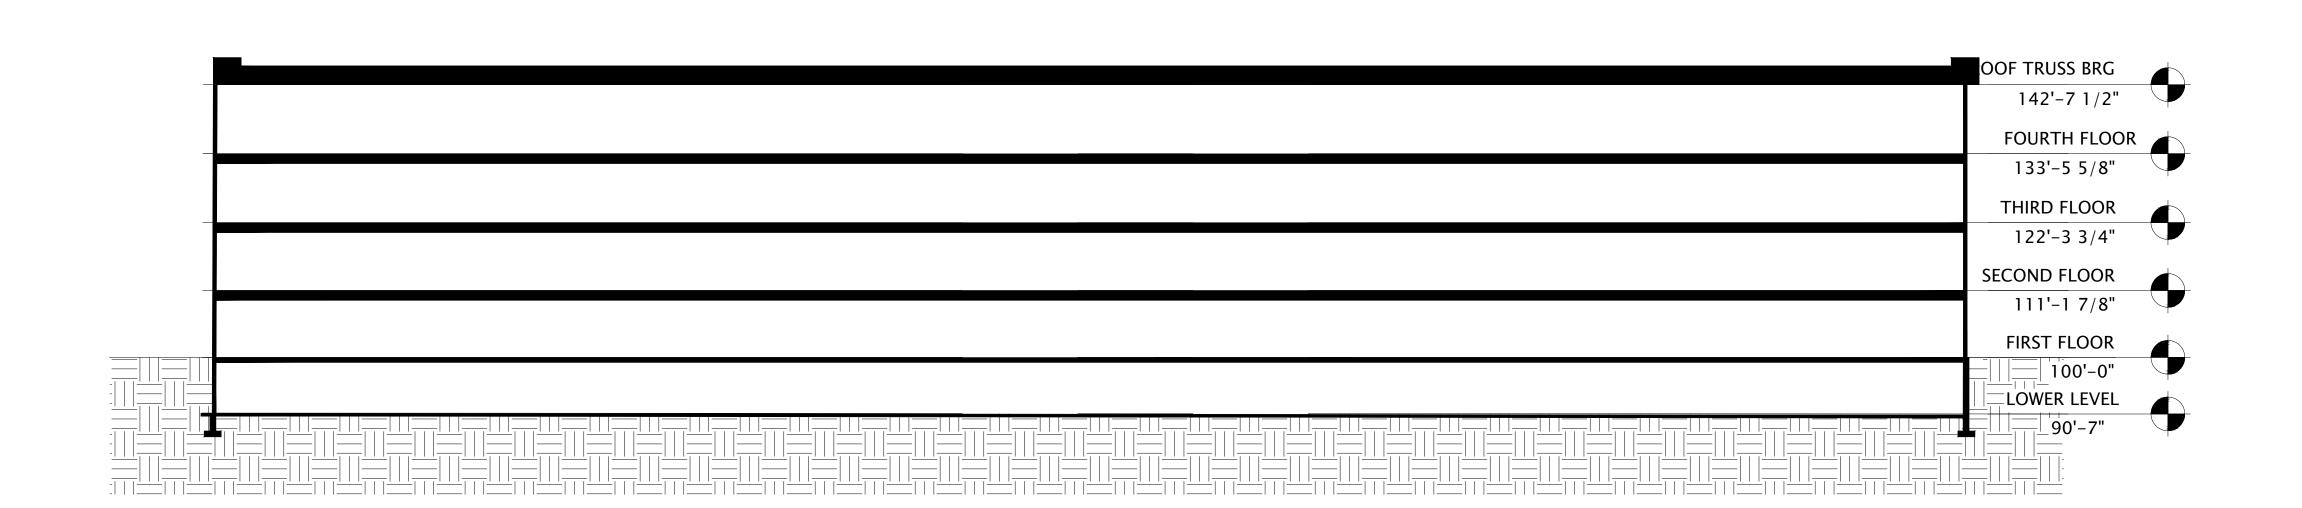

2 BUILDING B - SECTION 2 1/16" = 1'-0" J L A A A R C H I T E C T S

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JLA PROJECT NUMBER: 19-1104-01

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DATE OF ISSUANCE AUGUST 17, 2022

REVISION SCHEDULE


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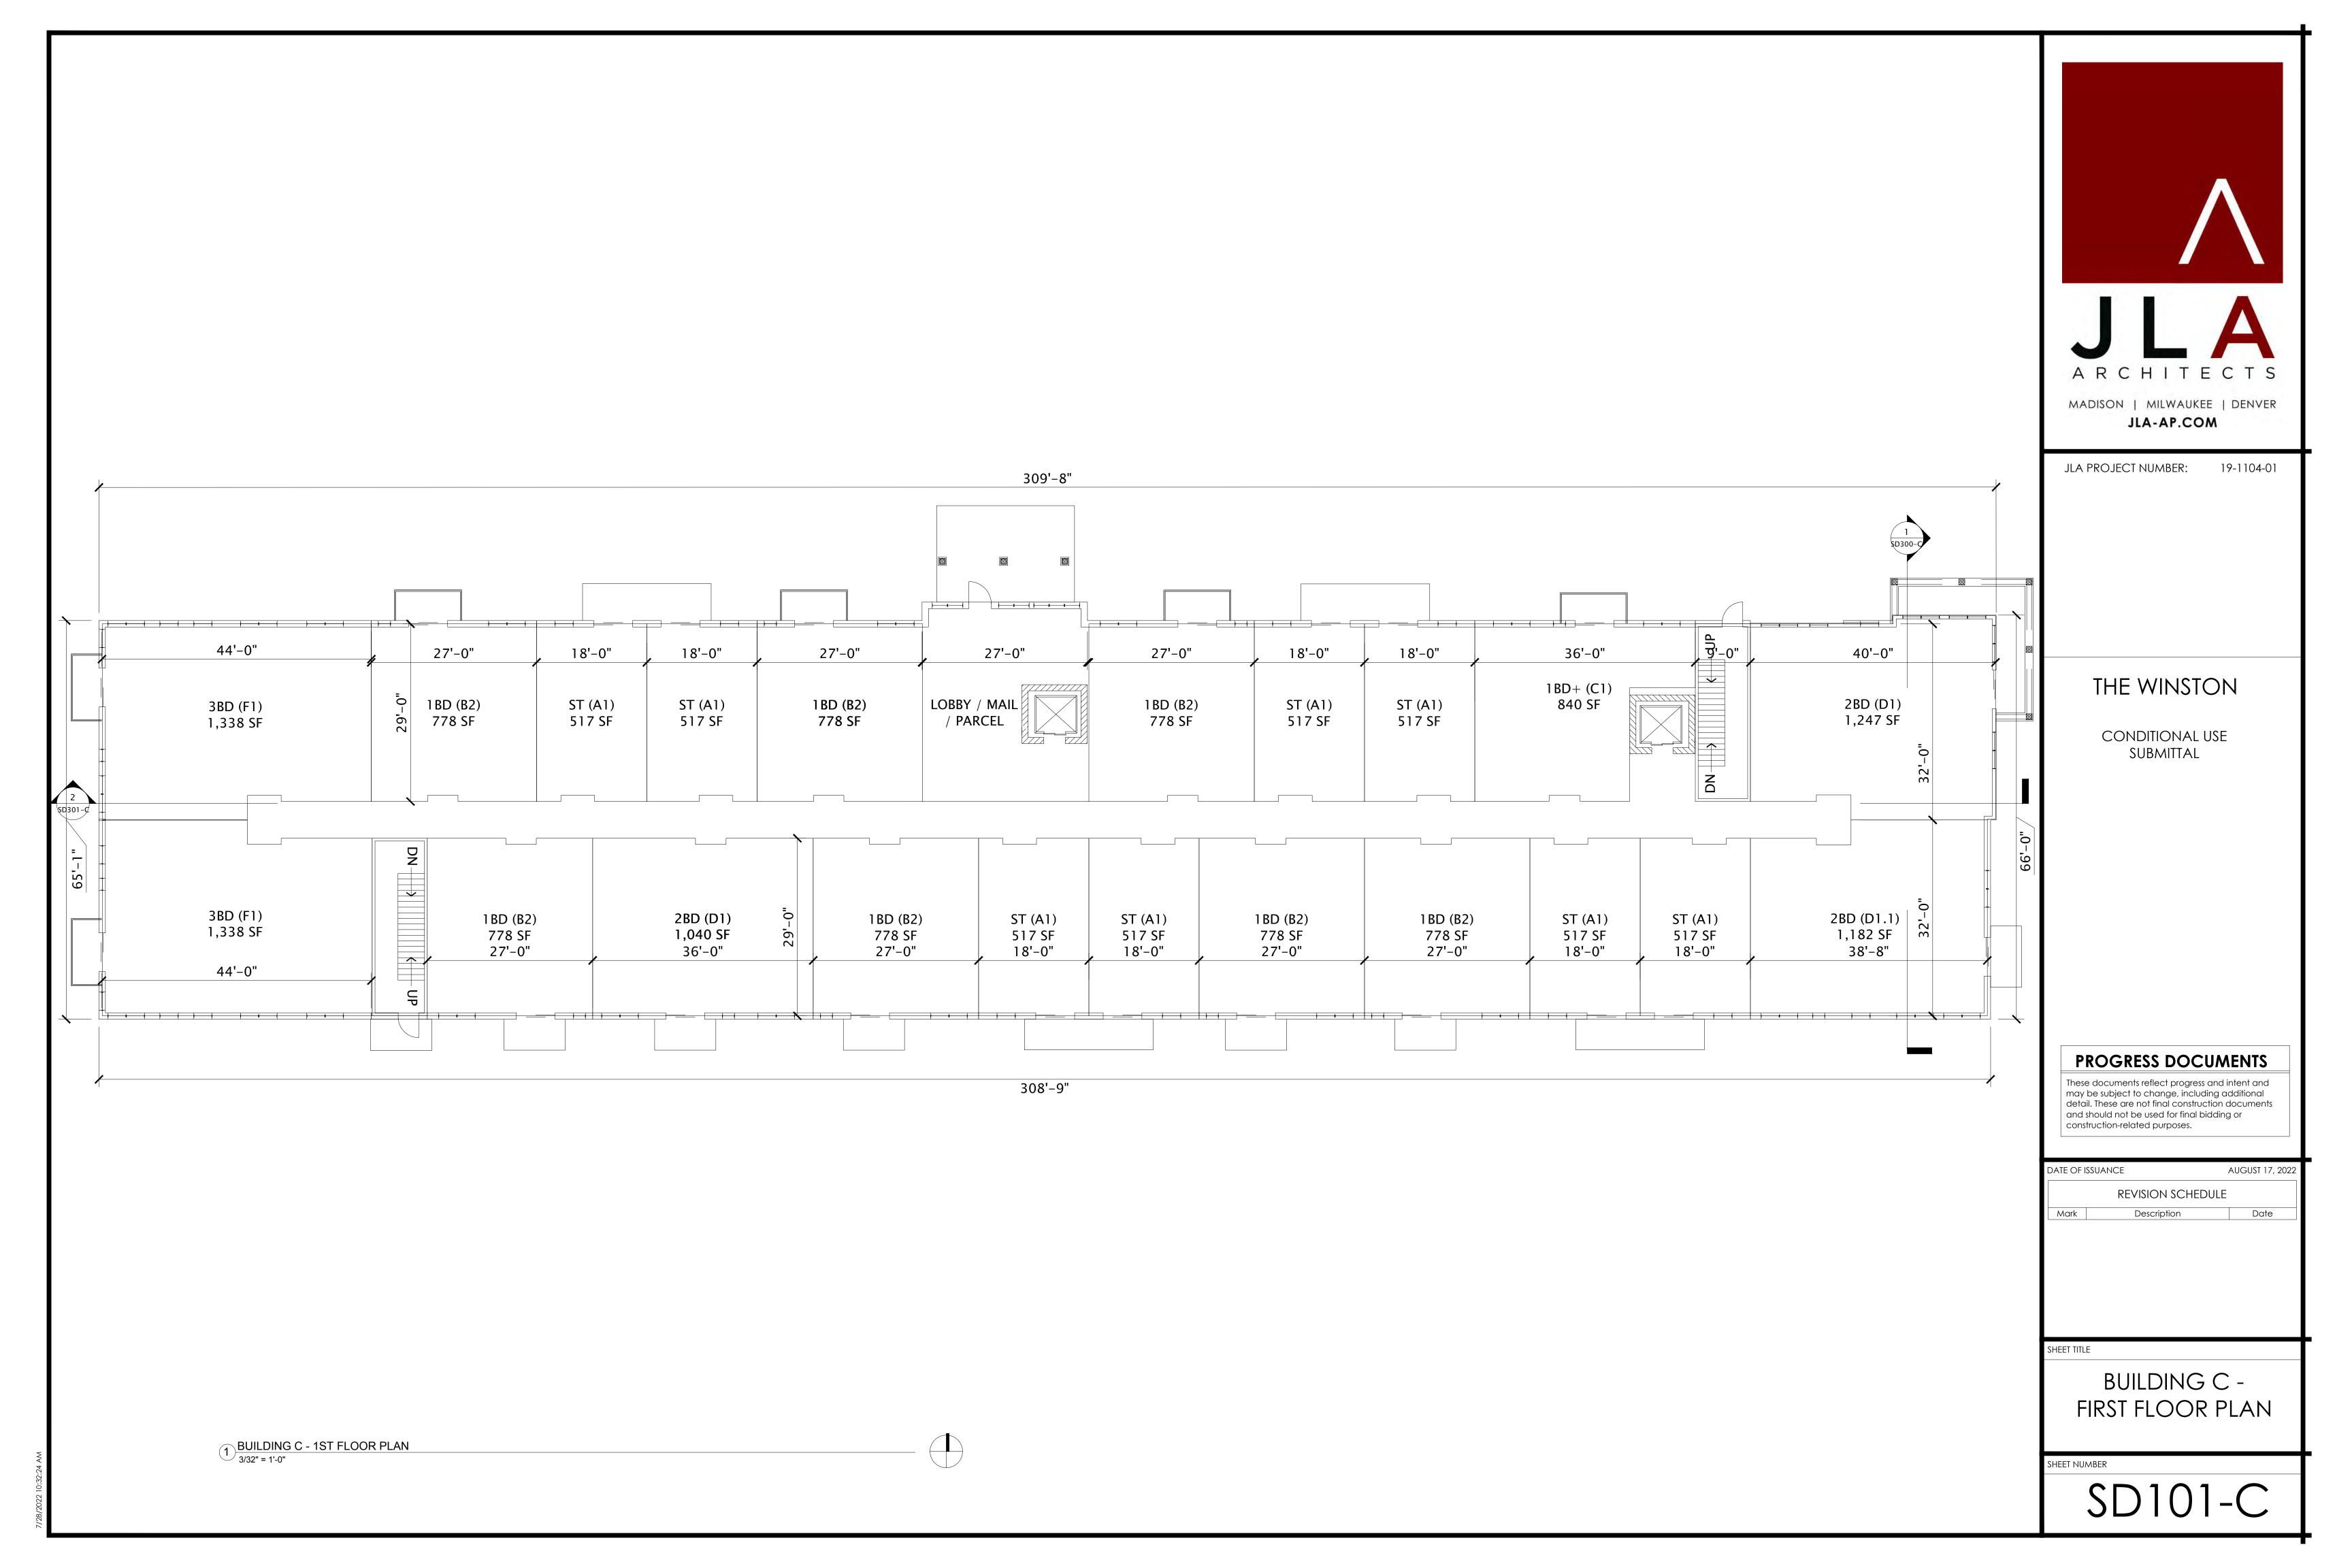
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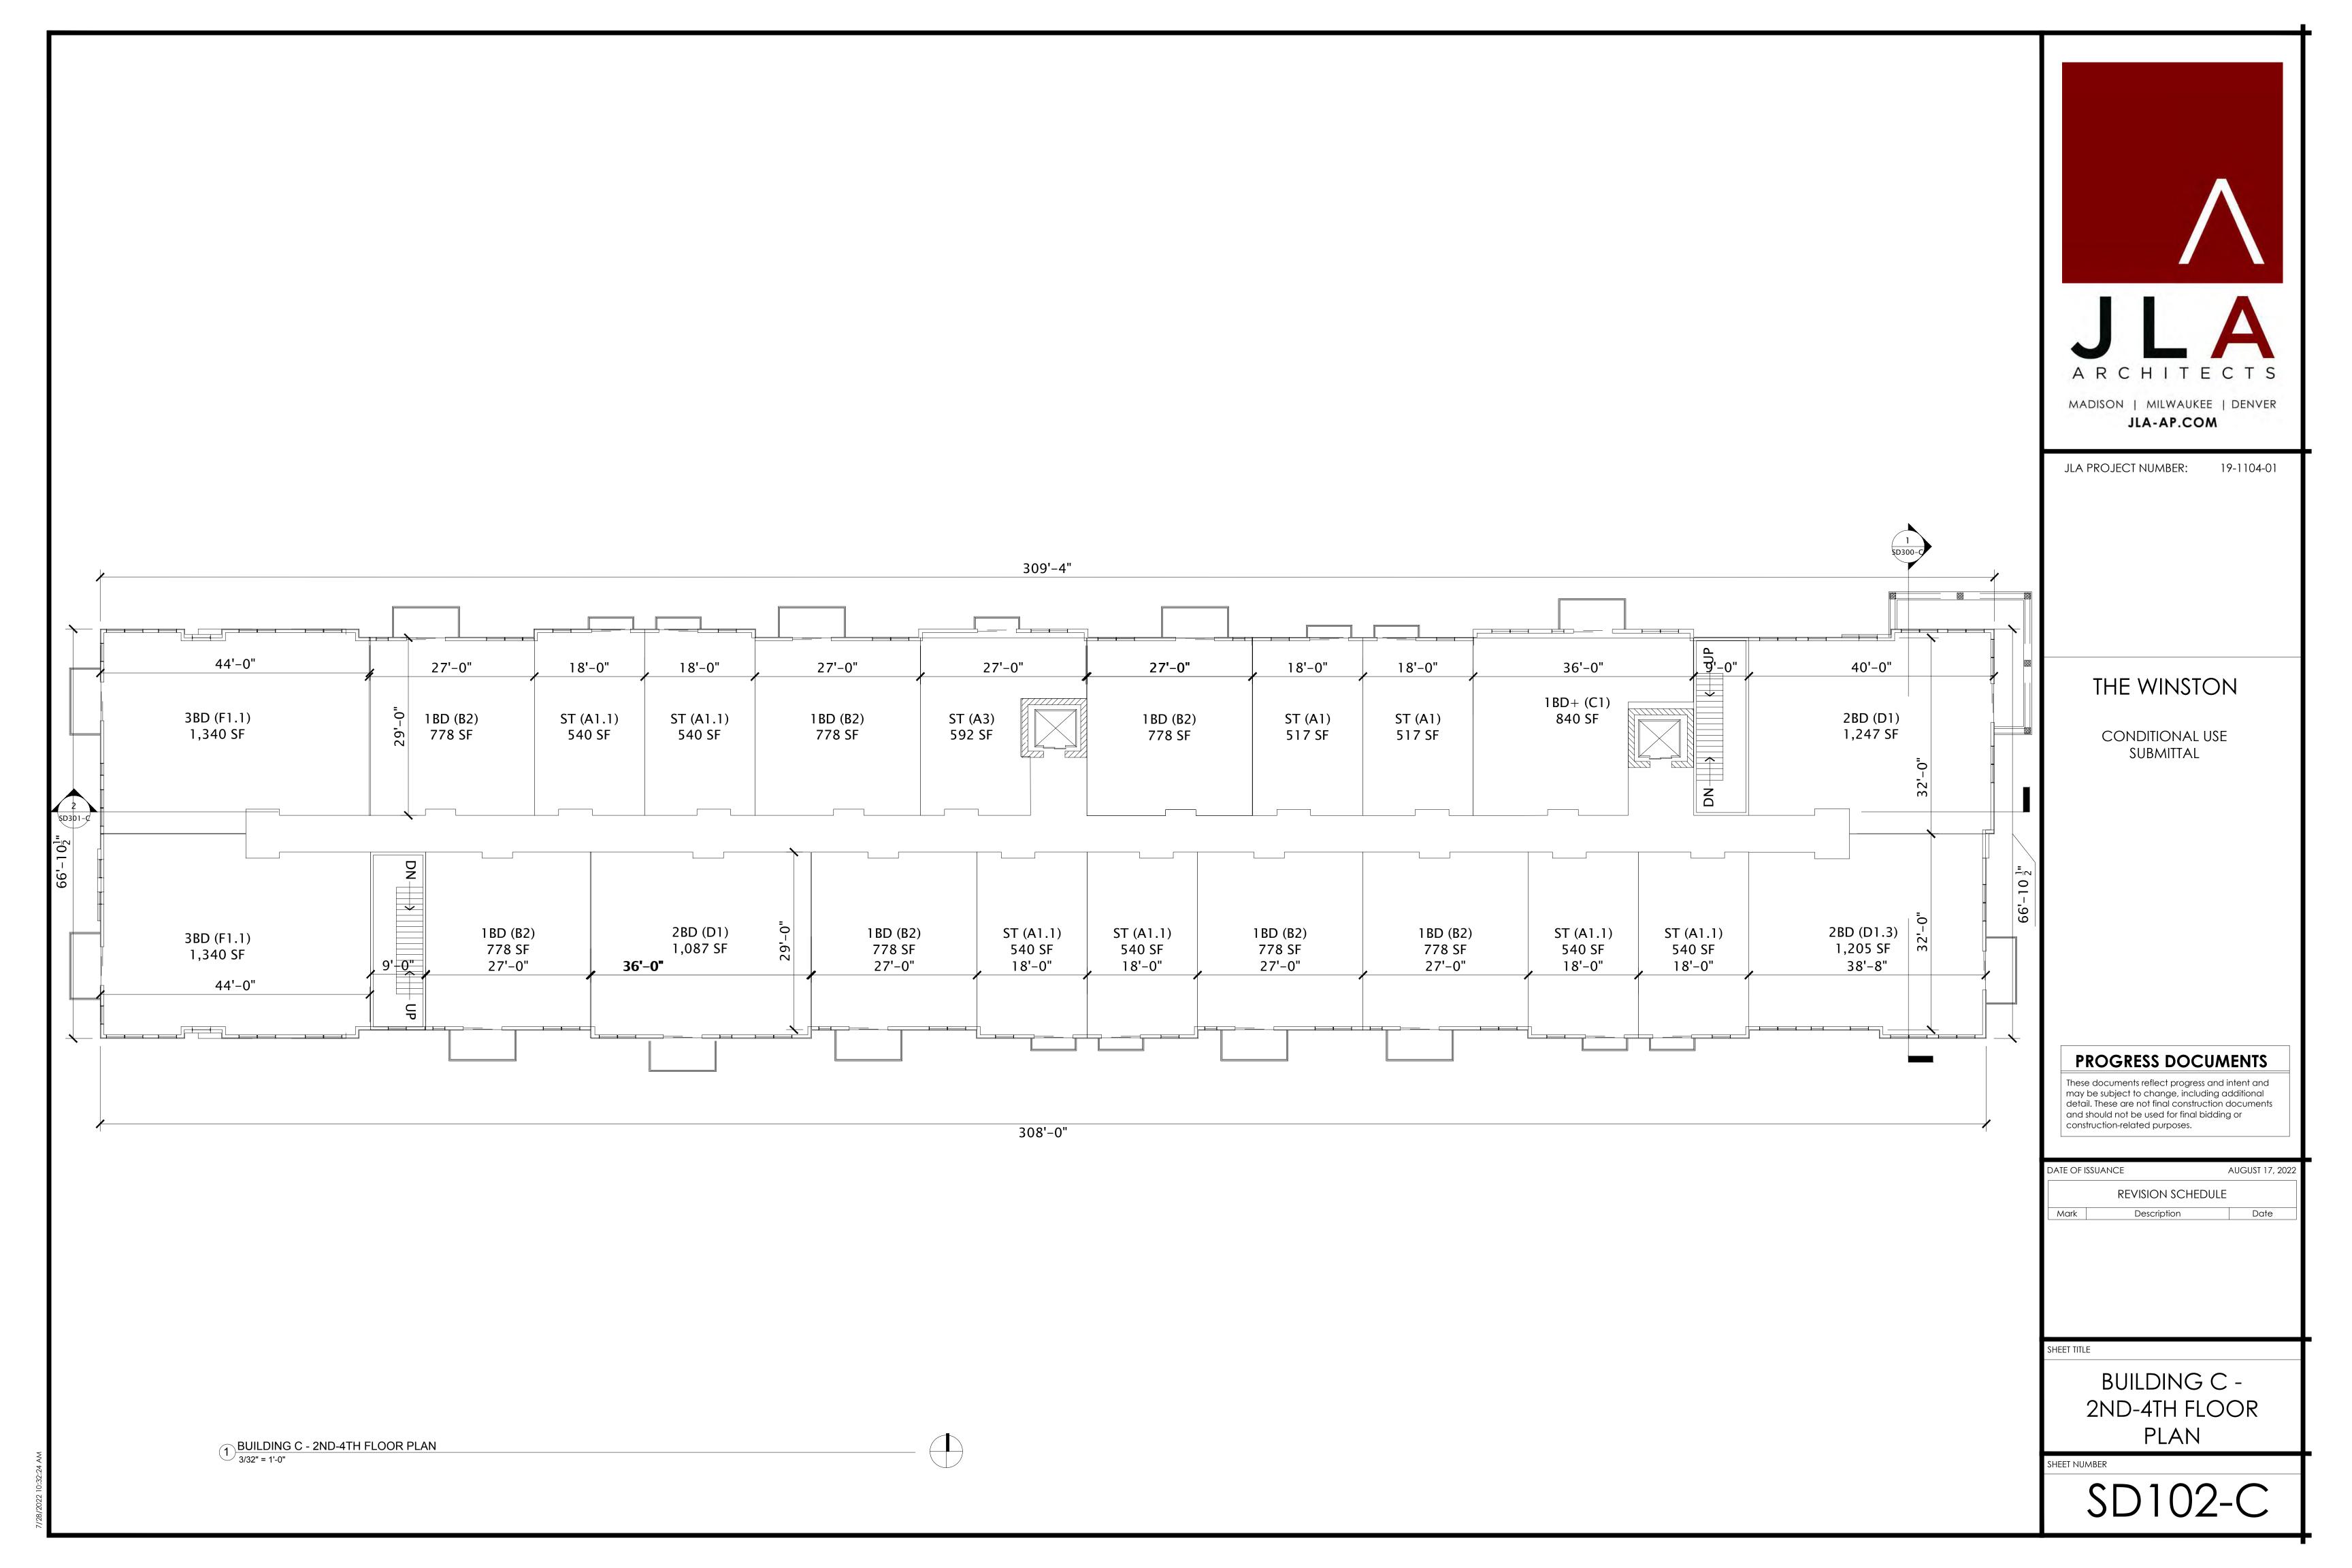
BUILDING B -SECTIONS


SHEET NUMBER

SD300-B





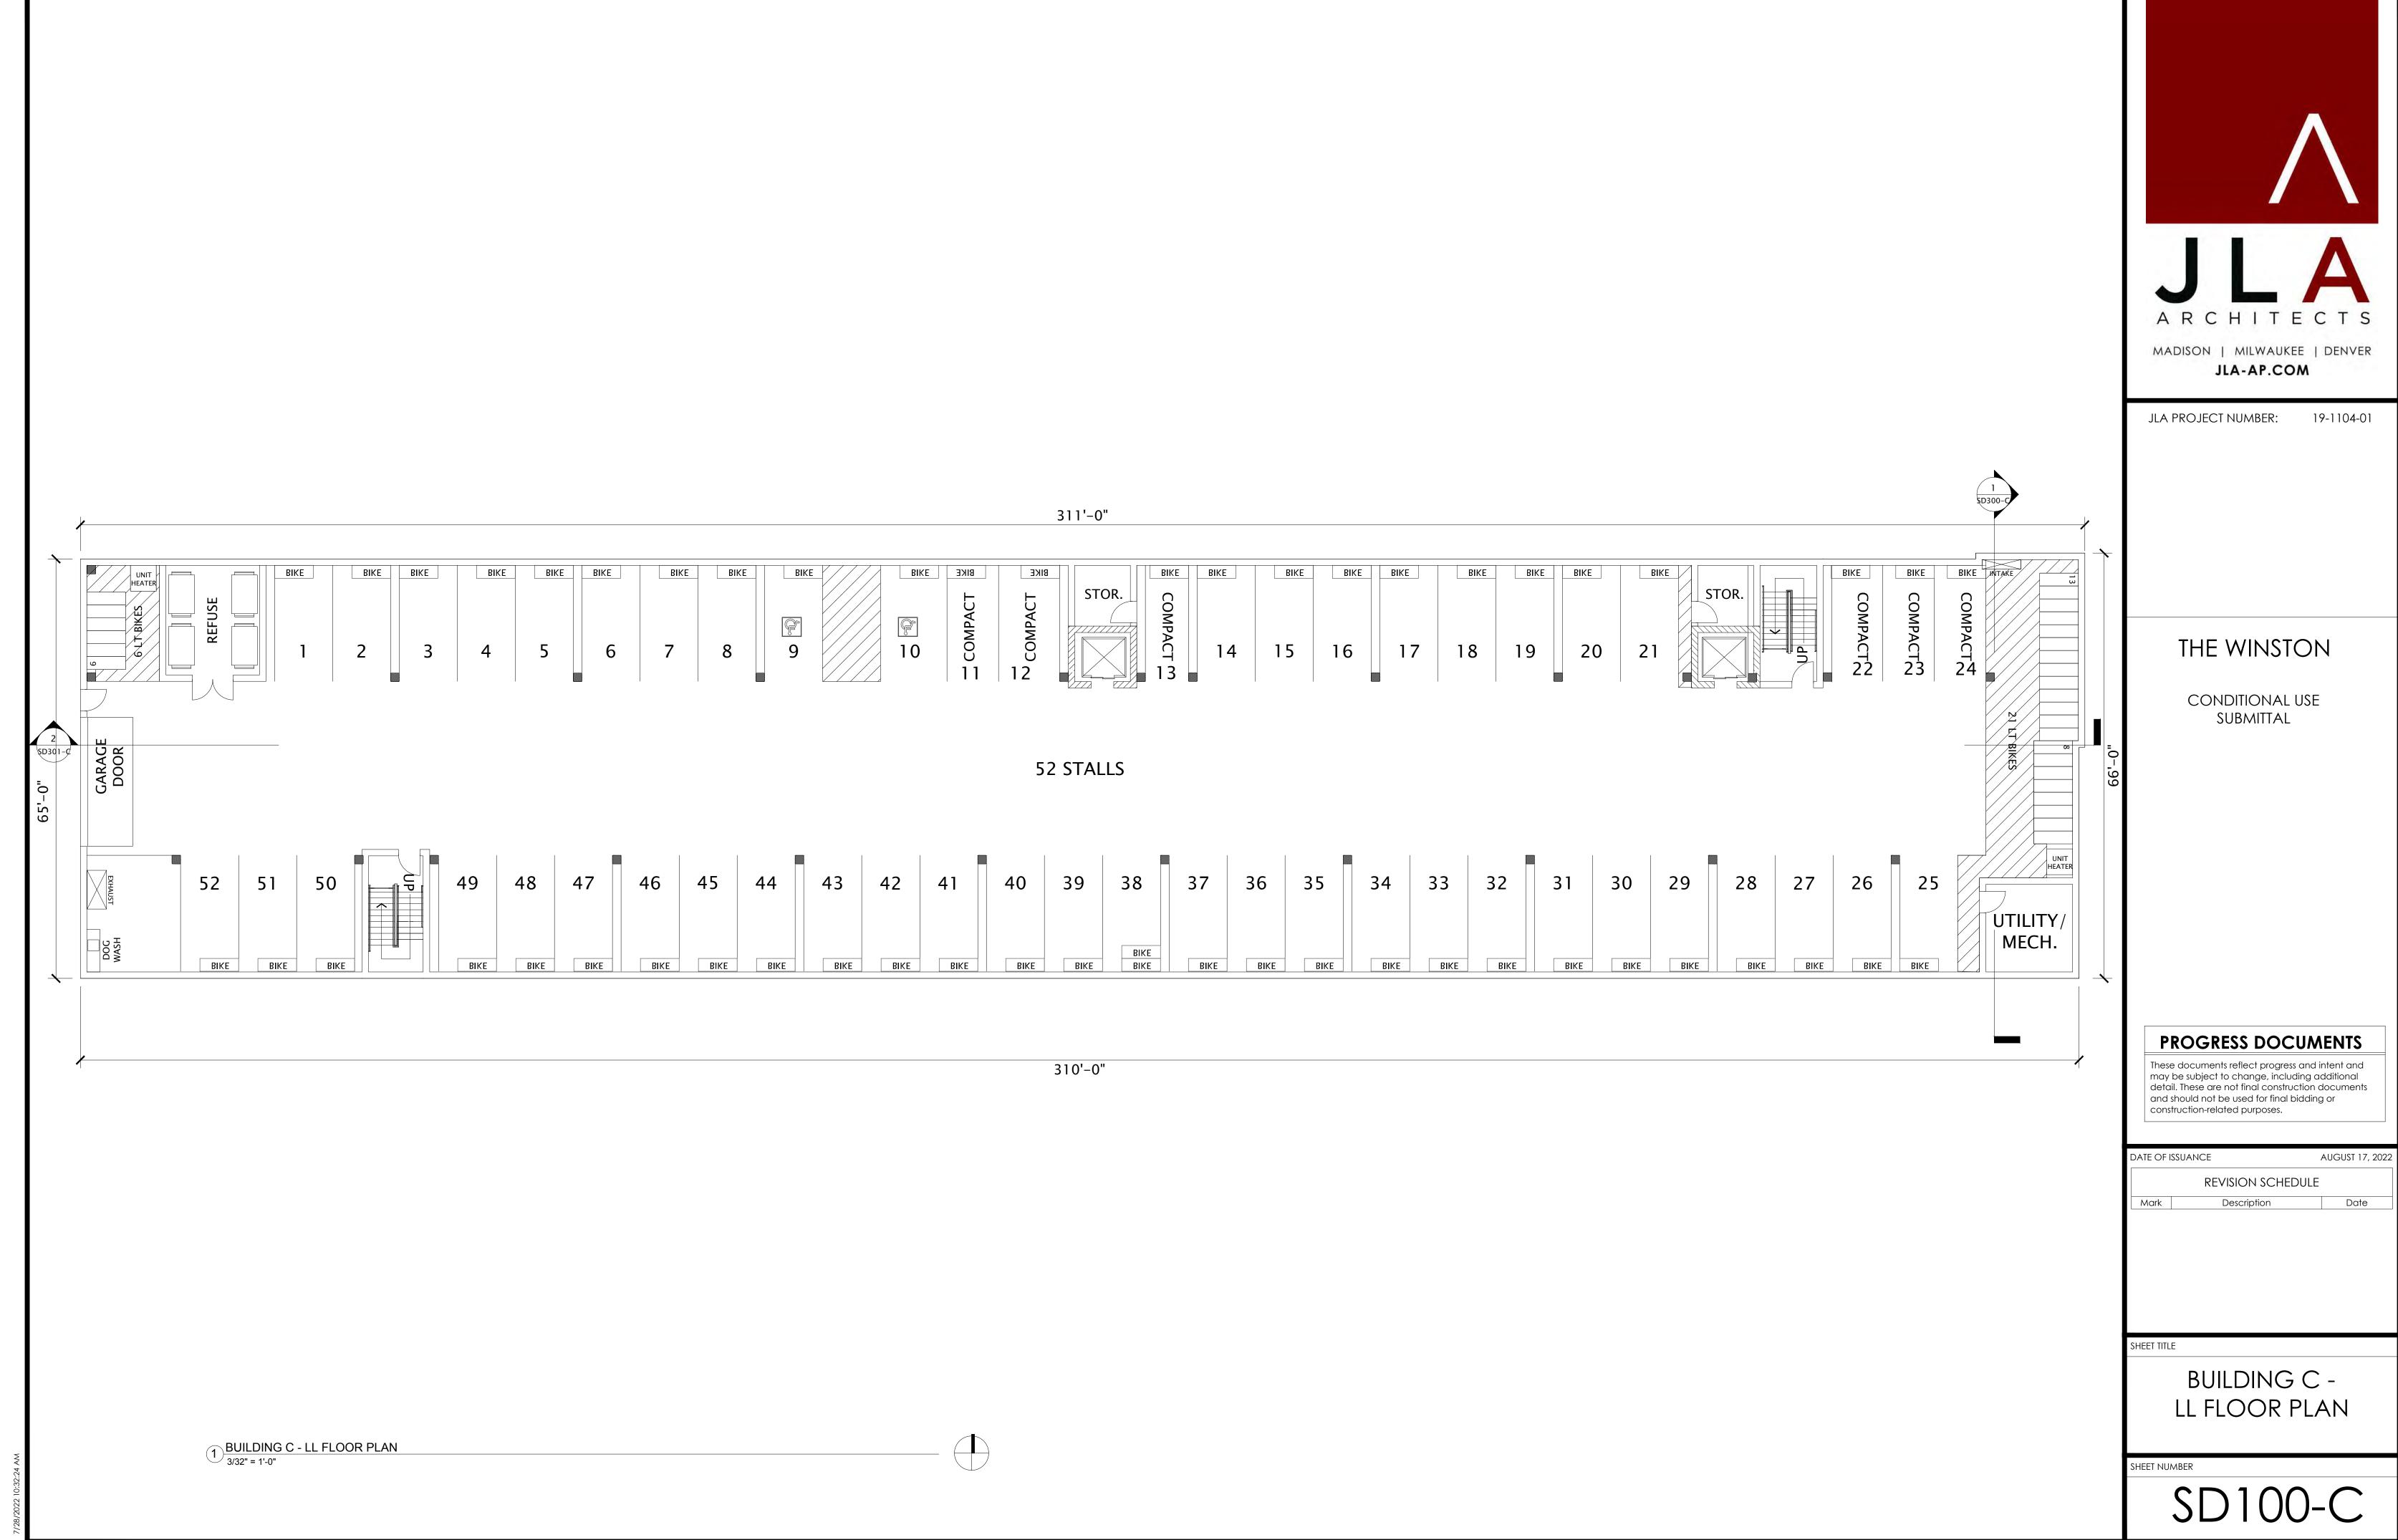

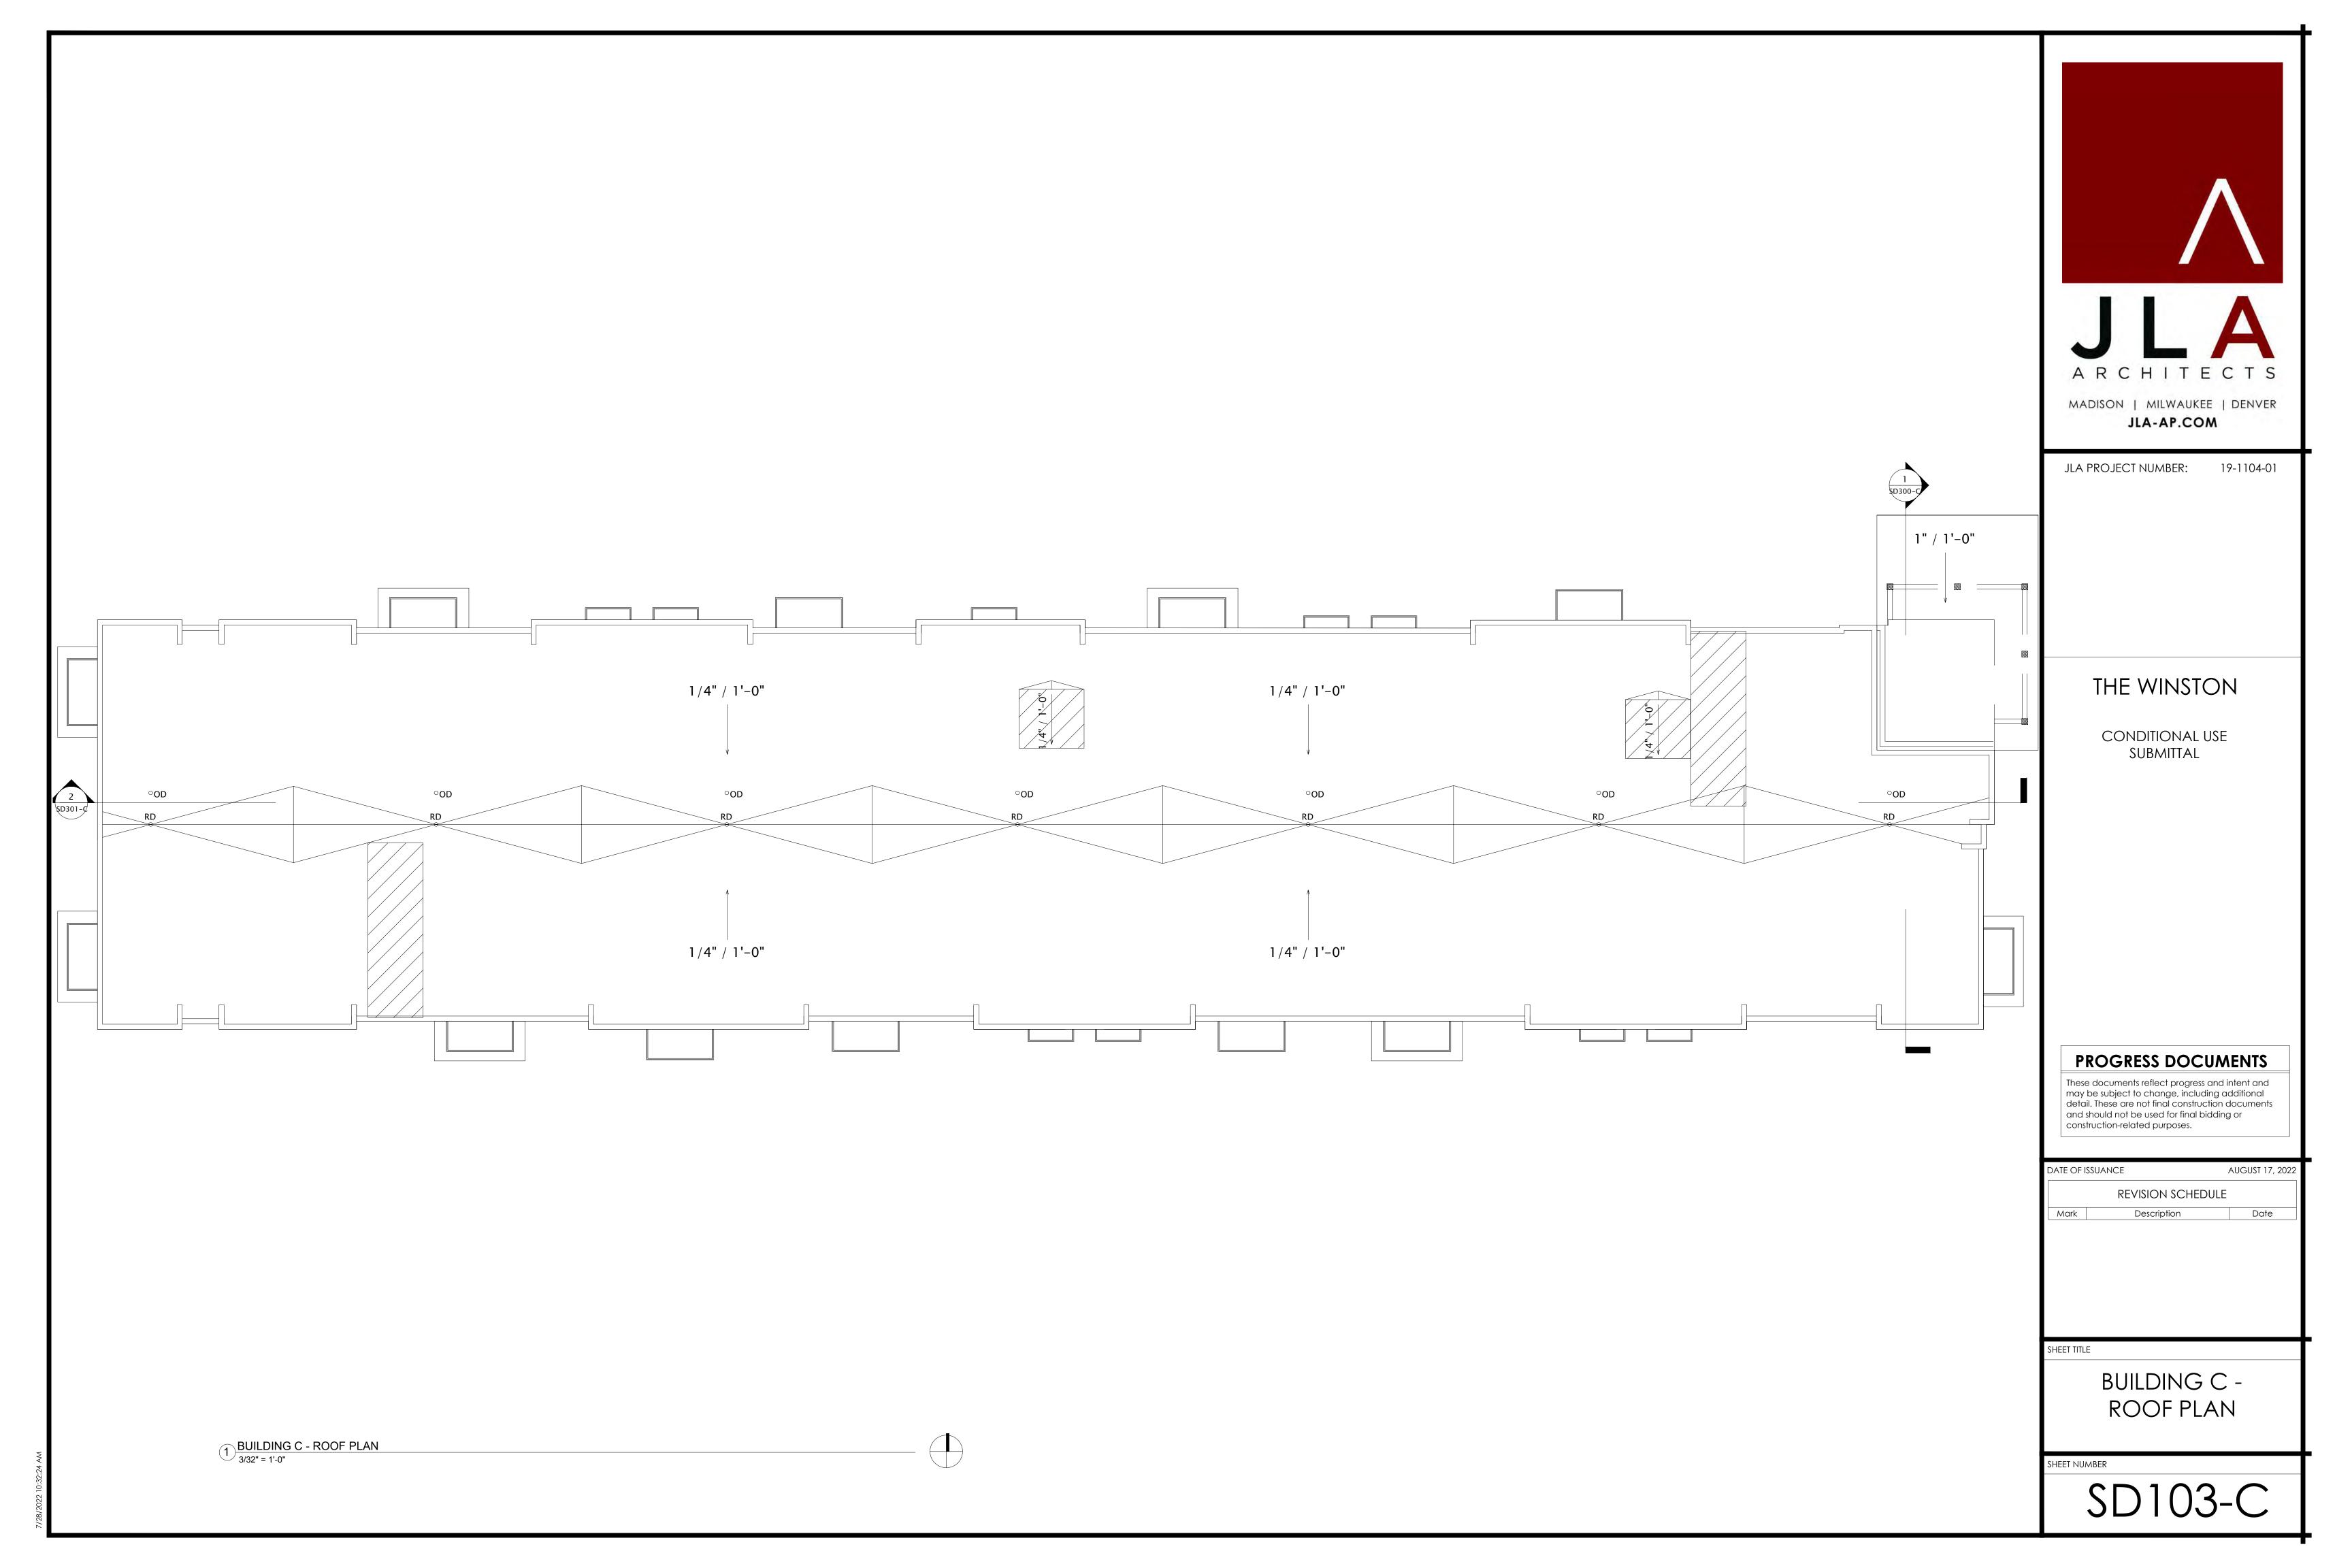

	EXTERIOR MATERIALS SCHEDULE				
MARK	DESCRIPTION	TYPE / STYLE	COLOR		
1	VINYL WINDOWS	LINDSAY WINDOWS & DOORS	BLACK		
2	VINYL PATIO DOORS	LINDSAY WINDOWS & DOORS	BLACK		
3	BALCONY RAILING	PAINTED METAL	BLACK		
4	BALCONY / DECK	COMPOSITE	TBD		
5	BALCONY FASCIA & TRIM	TBD	WALNUT		
6	MASONRY - STONE	DRY STACKED STONE	STAKLEDGE		
7	SIDING - 1 (LIGHT)	ULTRASHIELD	TEAK		
8	SIDING - 1 (DARK)	ULTRASHIELD	WALNUT		
9	DECORATIVE COLUMN	WOOD/WOOD COMPOSITE	TBD		
10	DECORATIVE BEAM	WOOD/WOOD COMPOSITE	TBD		
11	ACCENT CANOPY / ROOF	STANDING SEAM	WALNUT		
12	METAL PANEL	CORRUGATED	GALVANIZED		
13	RESIDENTIAL HVAC LOUVER / GRILLE	EXTRUDED ALUMINUM	PAINT TO MATCH ADJACENT MATERIALS		
14	PRECAST CONCRETE BANDING	PRECAST CONCRETE - SMOOTH FACE	TBD		
16	ALUMINUM ENTRANCE DOOR(S)	PREFINISHED ALUMINUM	BLACK		
17	48" ALUMINUM FENCE	PREFINISHED ALUMINUM	BLACK		

BUILDING C - SIGNAGE AREA	
SIGNAGE TYPE	AREA
EAST ELEVATION	
WALL - RAISED	208 SF



1) BUILDING C - NORTH 1/16" = 1'-0"



2 BUILDING C - SOUTH 1/16" = 1'-0"



JLA PROJECT NUMBER:

THE WINSTON

19-1104

CONDITIONAL USE SUBMITTAL

PROGRESS DOCUMENTS

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f ISSUANCE	AUGUST 1
REVISION	SCHEDULE

Mark Description Date

SHEET


BUILDING C -EXTERIOR ELEVATIONS

SHEET NUMBER

SD200-C

	EXTERIOR MATERIALS SCHEDULE				
MARK	DESCRIPTION	TYPE / STYLE	COLOR		
1	VINYL WINDOWS	LINDSAY WINDOWS & DOORS	BLACK		
2	VINYL PATIO DOORS	LINDSAY WINDOWS & DOORS	BLACK		
3	BALCONY RAILING	PAINTED METAL	BLACK		
4	BALCONY / DECK	COMPOSITE	TBD		
5	BALCONY FASCIA & TRIM	TBD	WALNUT		
6	MASONRY - STONE	DRY STACKED STONE	STAKLEDGE		
7	SIDING - 1 (LIGHT)	ULTRASHIELD	TEAK		
8	SIDING - 1 (DARK)	ULTRASHIELD	WALNUT		
9	DECORATIVE COLUMN	WOOD/WOOD COMPOSITE	TBD		
10	DECORATIVE BEAM	WOOD/WOOD COMPOSITE	TBD		
11	ACCENT CANOPY / ROOF	STANDING SEAM	WALNUT		
12	METAL PANEL	CORRUGATED	GALVANIZED		
13	RESIDENTIAL HVAC LOUVER / GRILLE	EXTRUDED ALUMINUM	PAINT TO MATCH ADJACENT MATERIALS		
14	PRECAST CONCRETE BANDING	PRECAST CONCRETE - SMOOTH FACE	TBD		
16	ALUMINUM ENTRANCE DOOR(S)	PREFINISHED ALUMINUM	BLACK		
17	48" ALUMINUM FENCE	PREFINISHED ALUMINUM	BLACK		

BUILDING C - SIGNAC	GE AREA
SIGNAGE TYPE	AREA
EAST ELEVATION	
WALL - RAISED	208 SF

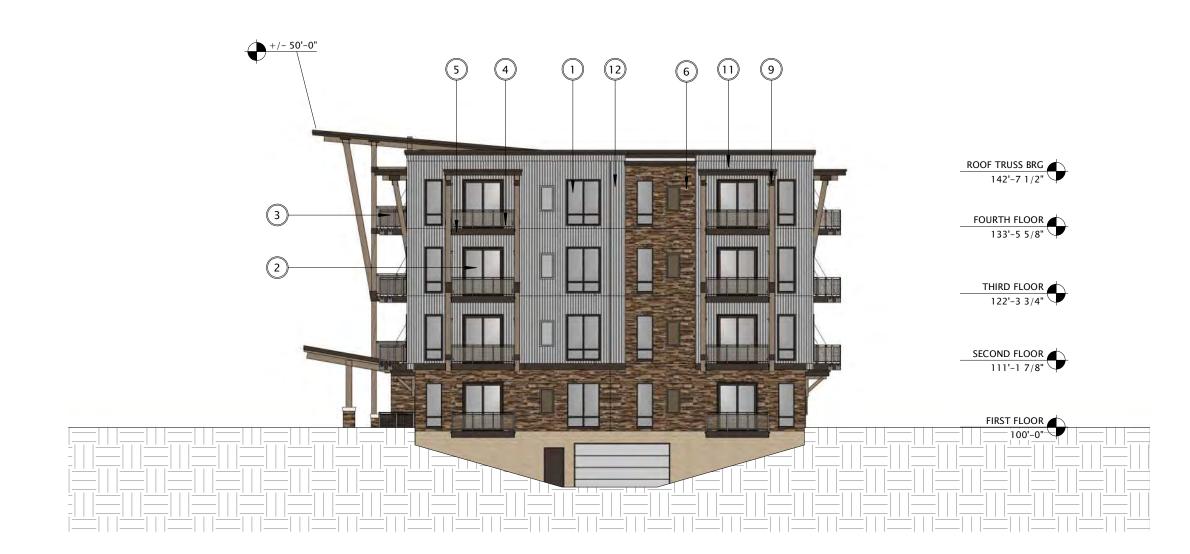

1) BUILDING C - WEST 1/16" = 1'-0"



2 BUILDING C - EAST
1/16" = 1'-0"



JLA PROJECT NUMBER:

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CONDITIONAL USE SUBMITTAL

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REVISION SCHEDULE

Mark Description Date

SHEET TIT

BUILDING C -EXTERIOR ELEVATIONS

SHEET NUMBER

SD201-C

	EXTERIOR MATERIALS SCHEDULE			
MARK	DESCRIPTION	TYPE / STYLE	COLOR	
1	VINYL WINDOWS	LINDSAY WINDOWS & DOORS	BLACK	
2	VINYL PATIO DOORS	LINDSAY WINDOWS & DOORS	BLACK	
3	BALCONY RAILING	PAINTED METAL	BLACK	
4	BALCONY / DECK	COMPOSITE	TBD	
5	BALCONY FASCIA & TRIM	TBD	WALNUT	
6	MASONRY - STONE	DRY STACKED STONE	STAKLEDGE	
7	SIDING - 1 (LIGHT)	ULTRASHIELD	TEAK	
8	SIDING - 1 (DARK)	ULTRASHIELD	WALNUT	
9	DECORATIVE COLUMN	WOOD/WOOD COMPOSITE	TBD	
10	DECORATIVE BEAM	WOOD/WOOD COMPOSITE	TBD	
11	ACCENT CANOPY / ROOF	STANDING SEAM	WALNUT	
12	METAL PANEL	CORRUGATED	GALVANIZED	
13	RESIDENTIAL HVAC LOUVER / GRILLE	EXTRUDED ALUMINUM	PAINT TO MATCH ADJACENT MATERIALS	
14	PRECAST CONCRETE BANDING	PRECAST CONCRETE - SMOOTH FACE	TBD	
16	ALUMINUM ENTRANCE DOOR(S)	PREFINISHED ALUMINUM	BLACK	


BUILDING C - SIGNAGE AREA		
SIGNAGE TYPE	AREA	
EAST ELEVATION		
WALL - RAISED	208 SF	



2 BUILDING C - NORTH 1
1/16" = 1'-0"



1 BUILDING C - SOUTH 1 1/16" = 1'-0"

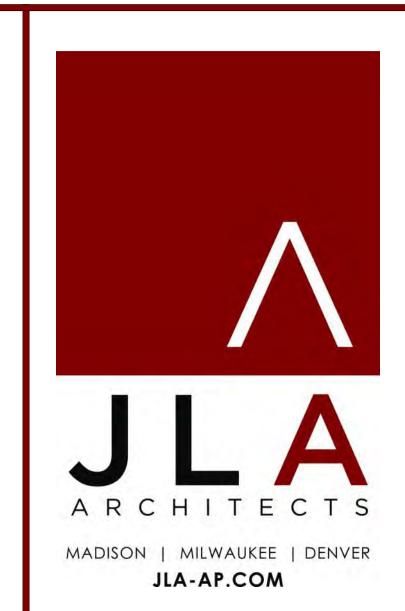

JLA PROJECT NUMBER:

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DATE OF	ISSUANCE /	AUGUST 17, 2022
REVISION SCHEDULE		
Mark	Description	Date
1		

SHEET


BUILDING C -EXTERIOR ELEVATIONS B&W

SHEET NUMBER

SD202-C

EXTERIOR MATERIALS SCHEDULE				
MARK	DESCRIPTION	TYPE / STYLE	COLOR	
1	VINYL WINDOWS	LINDSAY WINDOWS & DOORS	BLACK	
2	VINYL PATIO DOORS	LINDSAY WINDOWS & DOORS	BLACK	
3	BALCONY RAILING	PAINTED METAL	BLACK	
4	BALCONY / DECK	COMPOSITE	TBD	
5	BALCONY FASCIA & TRIM	TBD	WALNUT	
6	MASONRY - STONE	DRY STACKED STONE	STAKLEDGE	
7	SIDING - 1 (LIGHT)	ULTRASHIELD	TEAK	
8	SIDING - 1 (DARK)	ULTRASHIELD	WALNUT	
9	DECORATIVE COLUMN	WOOD/WOOD COMPOSITE	TBD	
10	DECORATIVE BEAM	WOOD/WOOD COMPOSITE	TBD	
11	ACCENT CANOPY / ROOF	STANDING SEAM	WALNUT	
12	METAL PANEL	CORRUGATED	GALVANIZED	
13	RESIDENTIAL HVAC LOUVER / GRILLE	EXTRUDED ALUMINUM	PAINT TO MATCH ADJACENT MATERIALS	
14	PRECAST CONCRETE BANDING	PRECAST CONCRETE - SMOOTH FACE	TBD	
16	ALUMINUM ENTRANCE DOOR(S)	PREFINISHED ALUMINUM	BLACK	

BUILDING C - SIGNAGE AREA	
SIGNAGE TYPE AREA	
EAST ELEVATION	
WALL - RAISED	208 SF
	208 SF

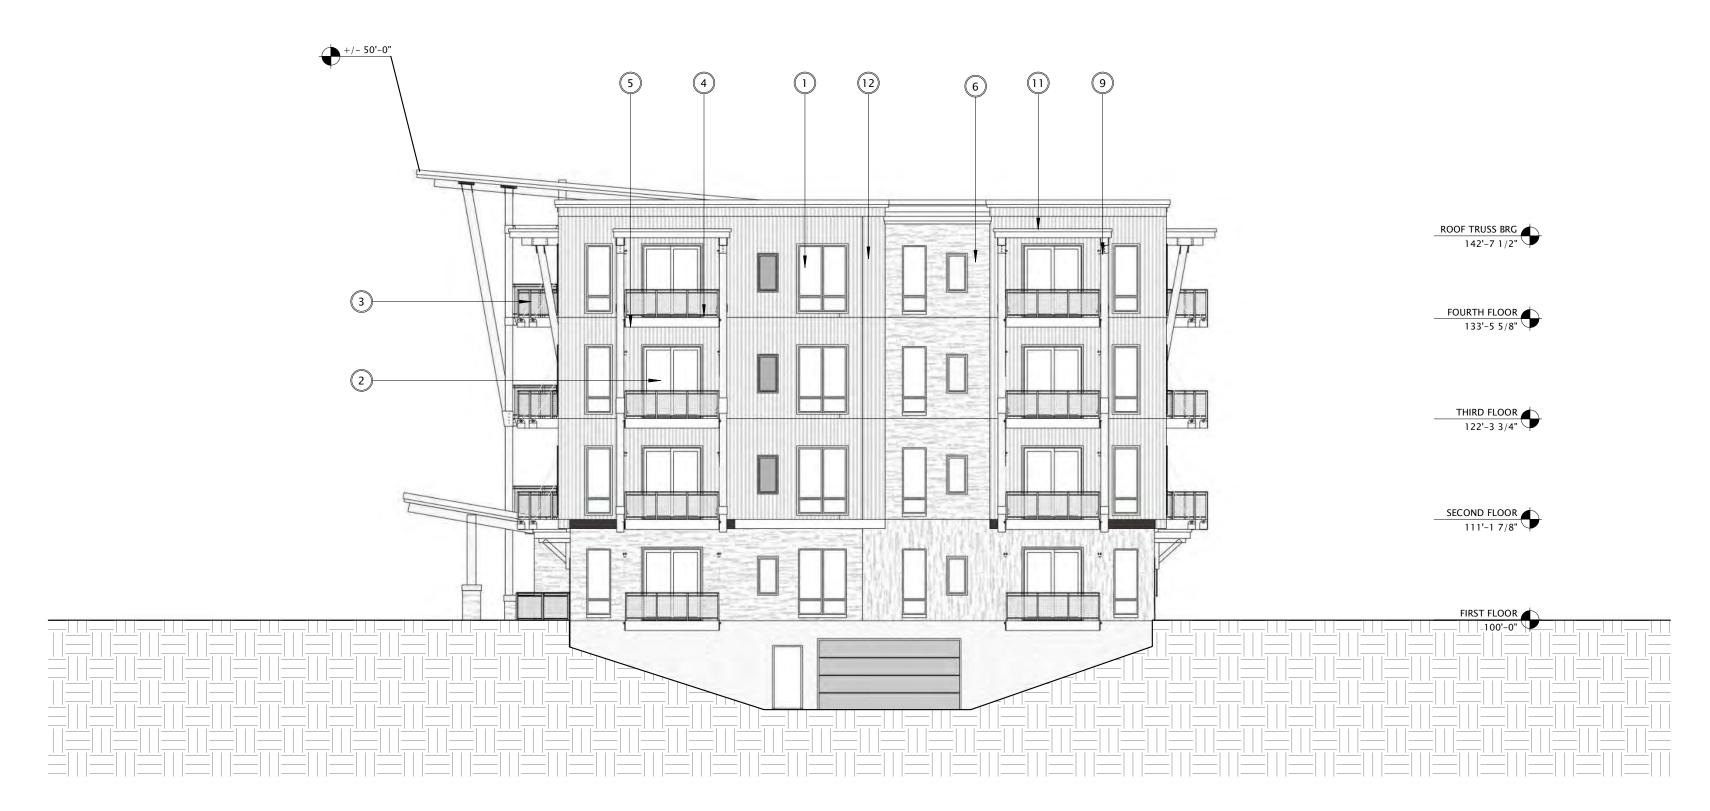

2 BUILDING C - WEST 1
3/32" = 1'-0"



1 BUILDING C - EAST 1 3/32" = 1'-0"



JLA PROJECT NUMBER:

19-1104

THE WINSTON

CONDITIONAL USE SUBMITTAL


PROGRESS DOCUMENTS

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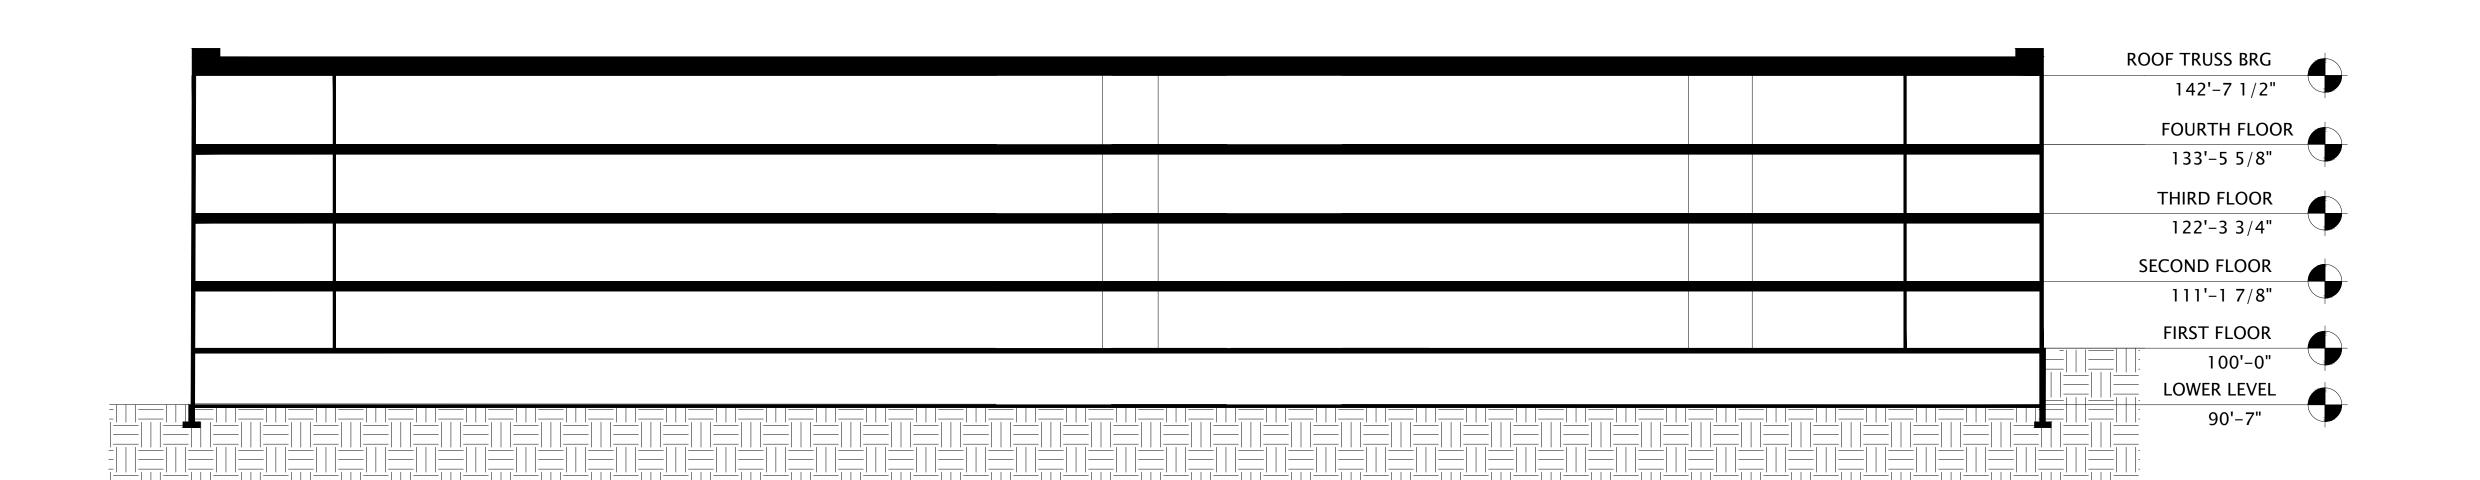
DATE OF ISSUANCE A		
REVISION SCHEDULE		
Description	Date	
	REVISION SCHEDULE	

BUILDING C -EXTERIOR ELEVATIONS B&W

Sheet number

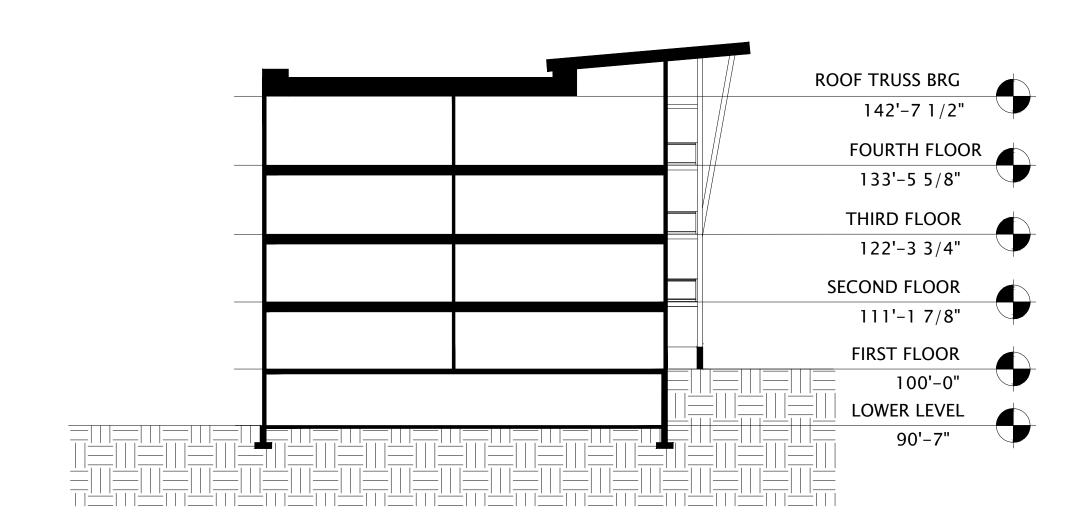

1 BUILDING C - SECTION 1 1/16" = 1'-0"



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JLA PROJECT NUMBER: 19-1104-01

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PROGRESS DOCUMENTS

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DATE OF I	SSUANCE	AUGUST 17, 2022
	REVISION SCHEDULE	
Mark	Description	Date


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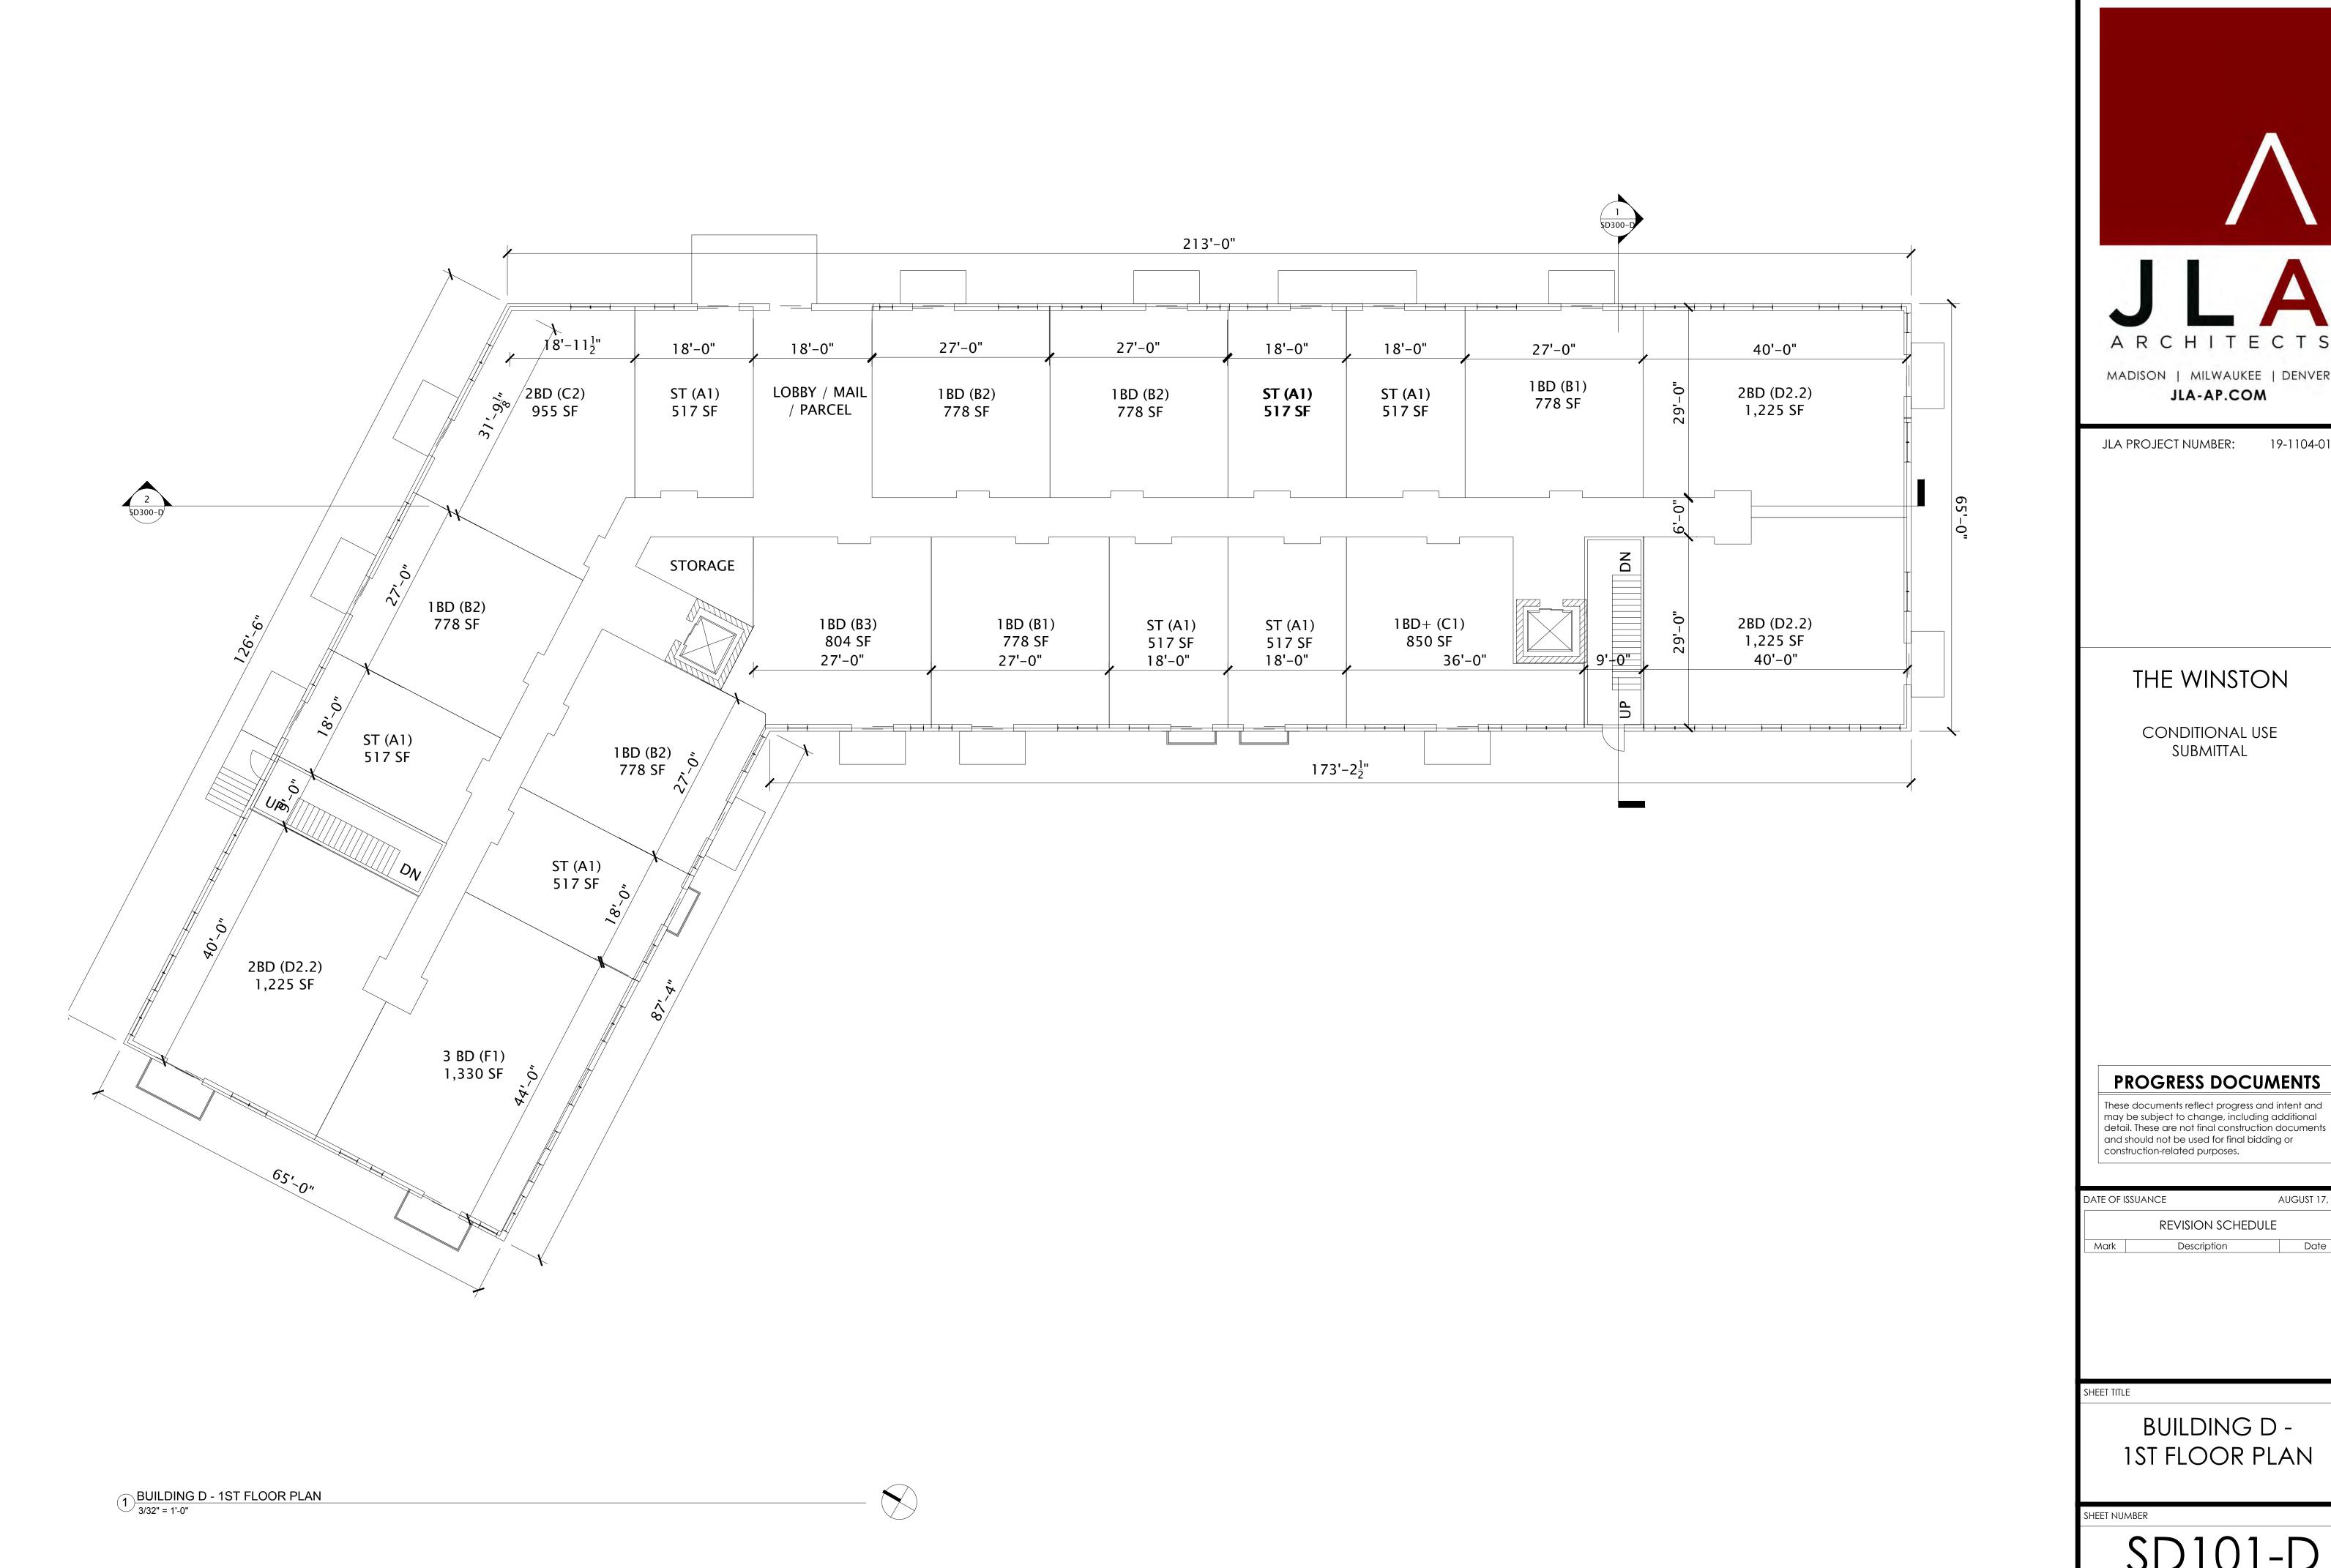
BUILDING C -SECTIONS

SHEET NUMBER

SD300-C

2 BUILDING C - SECTION 2 1/16" = 1'-0"



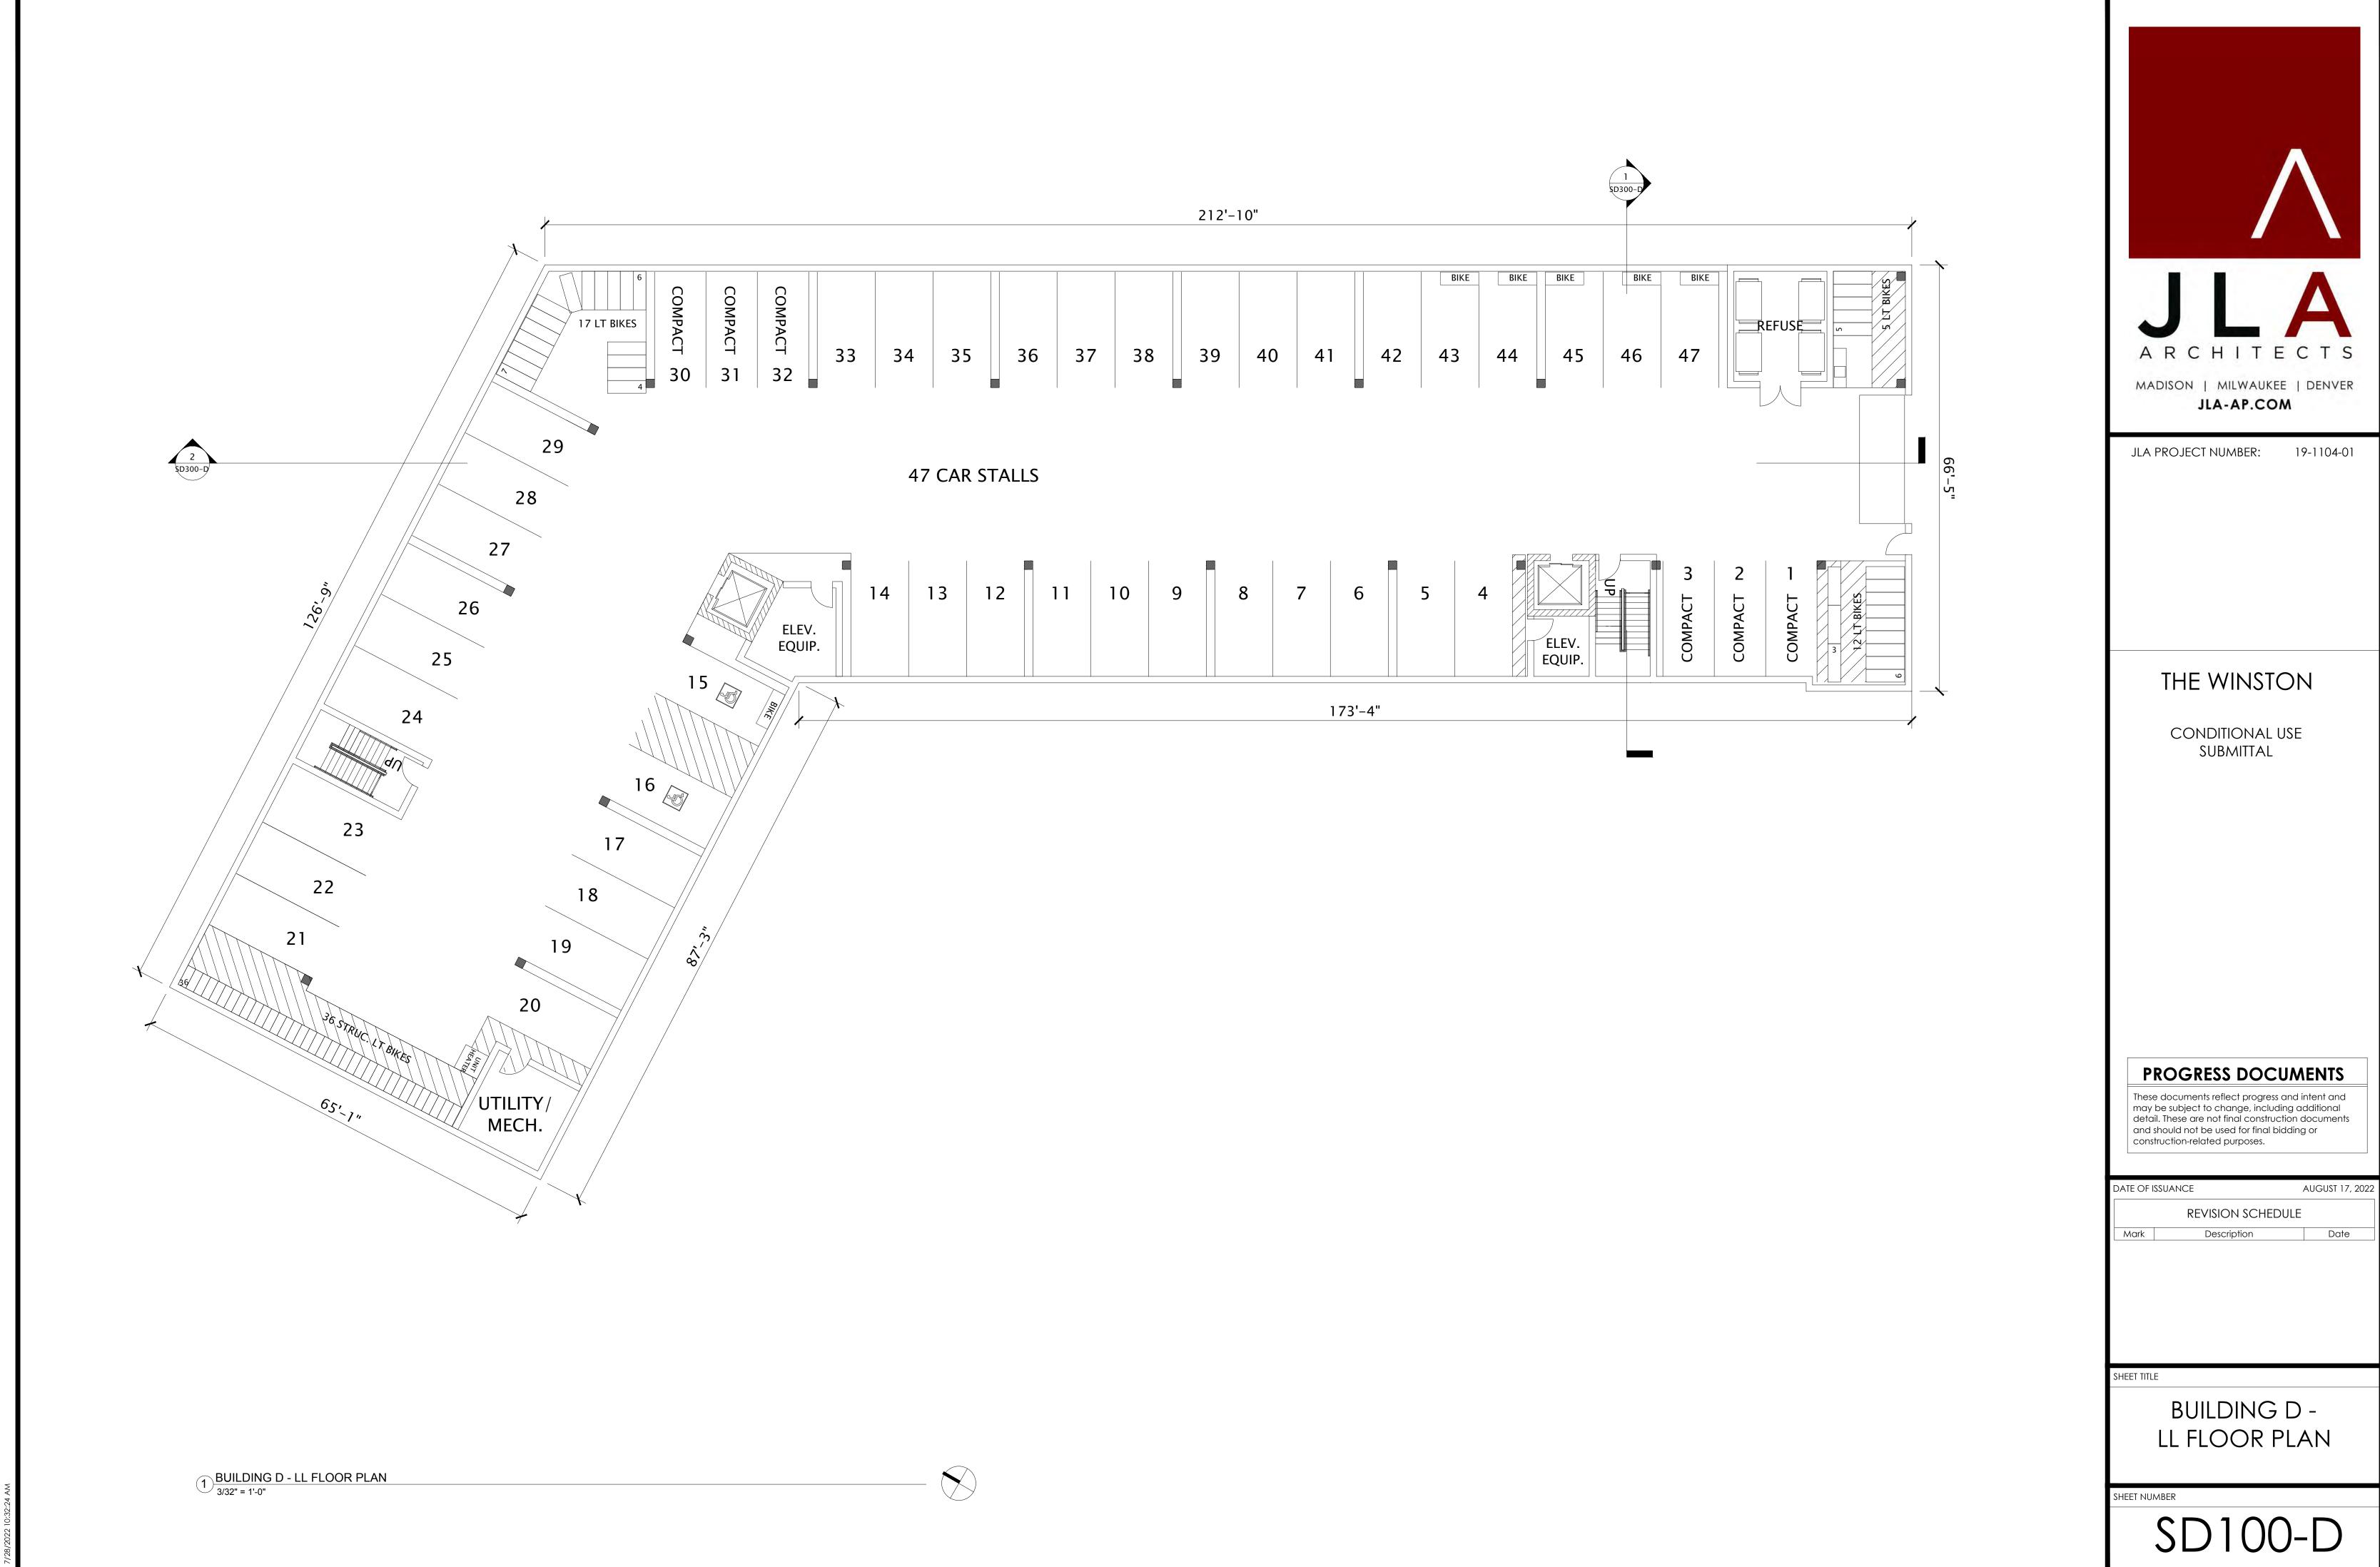


ARCHITECTS MADISON | MILWAUKEE | DENVER


19-1104-01

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AUGUST 17, 2022 REVISION SCHEDULE Date

> BUILDING D -1ST FLOOR PLAN



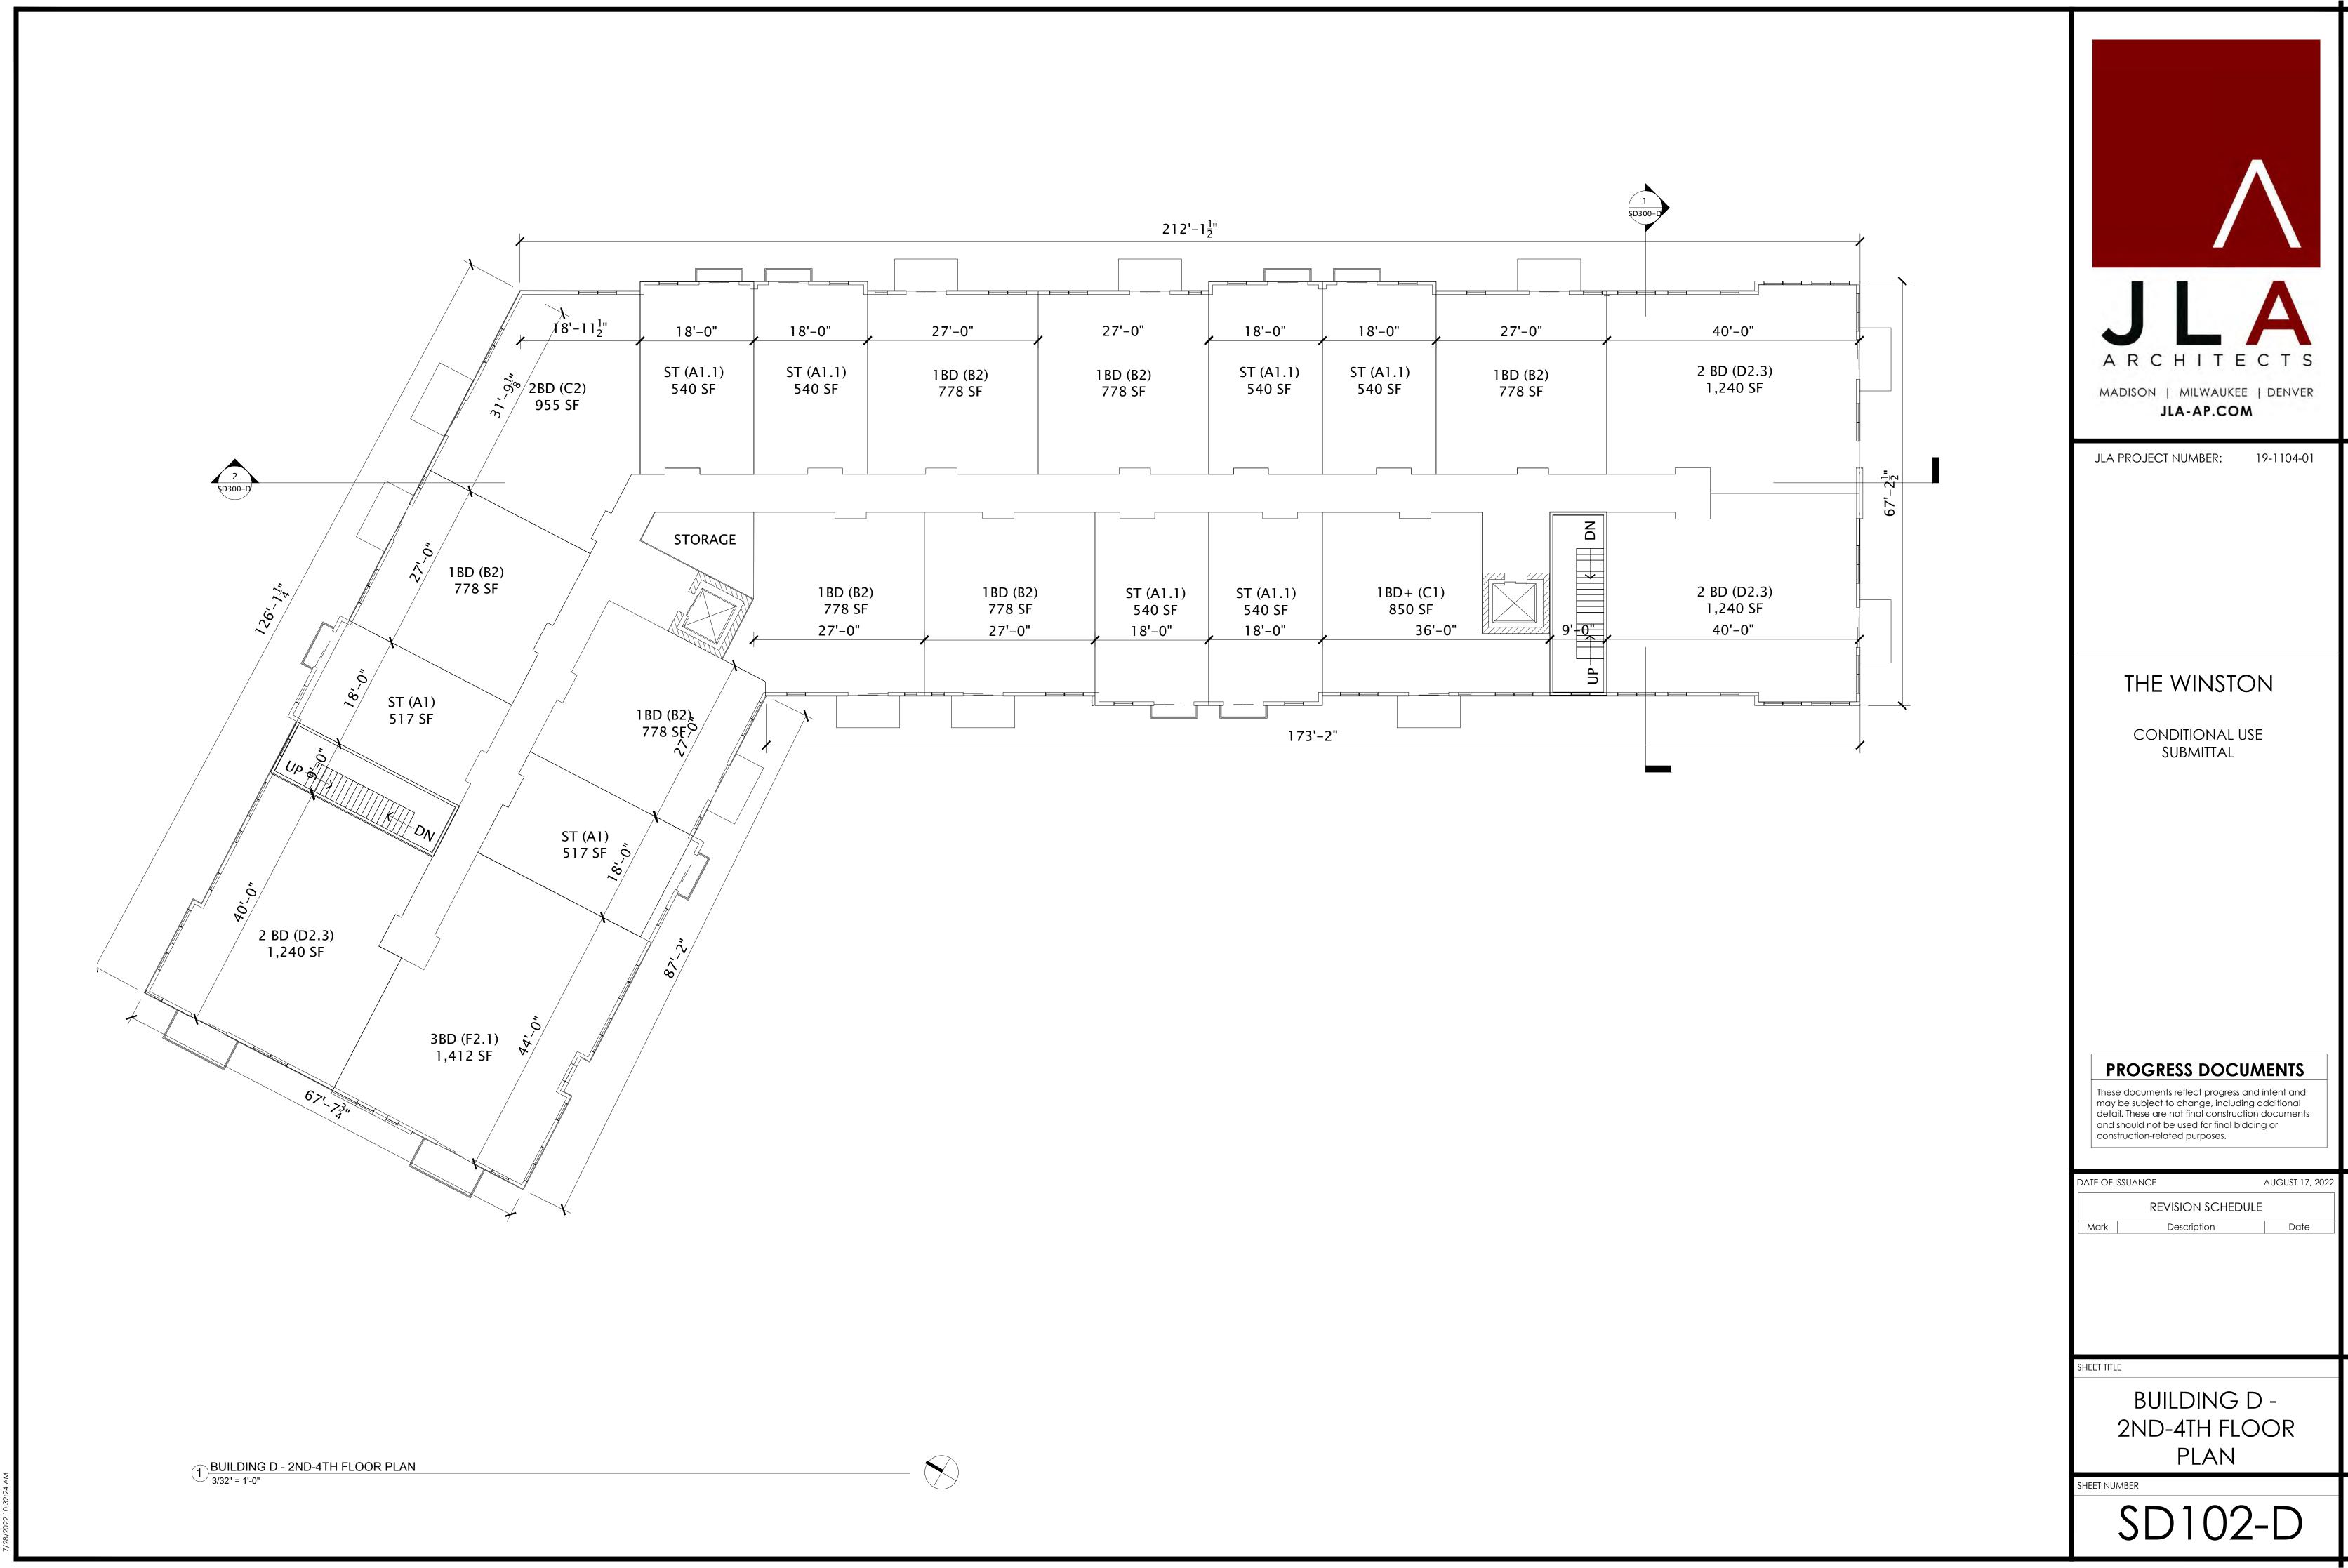

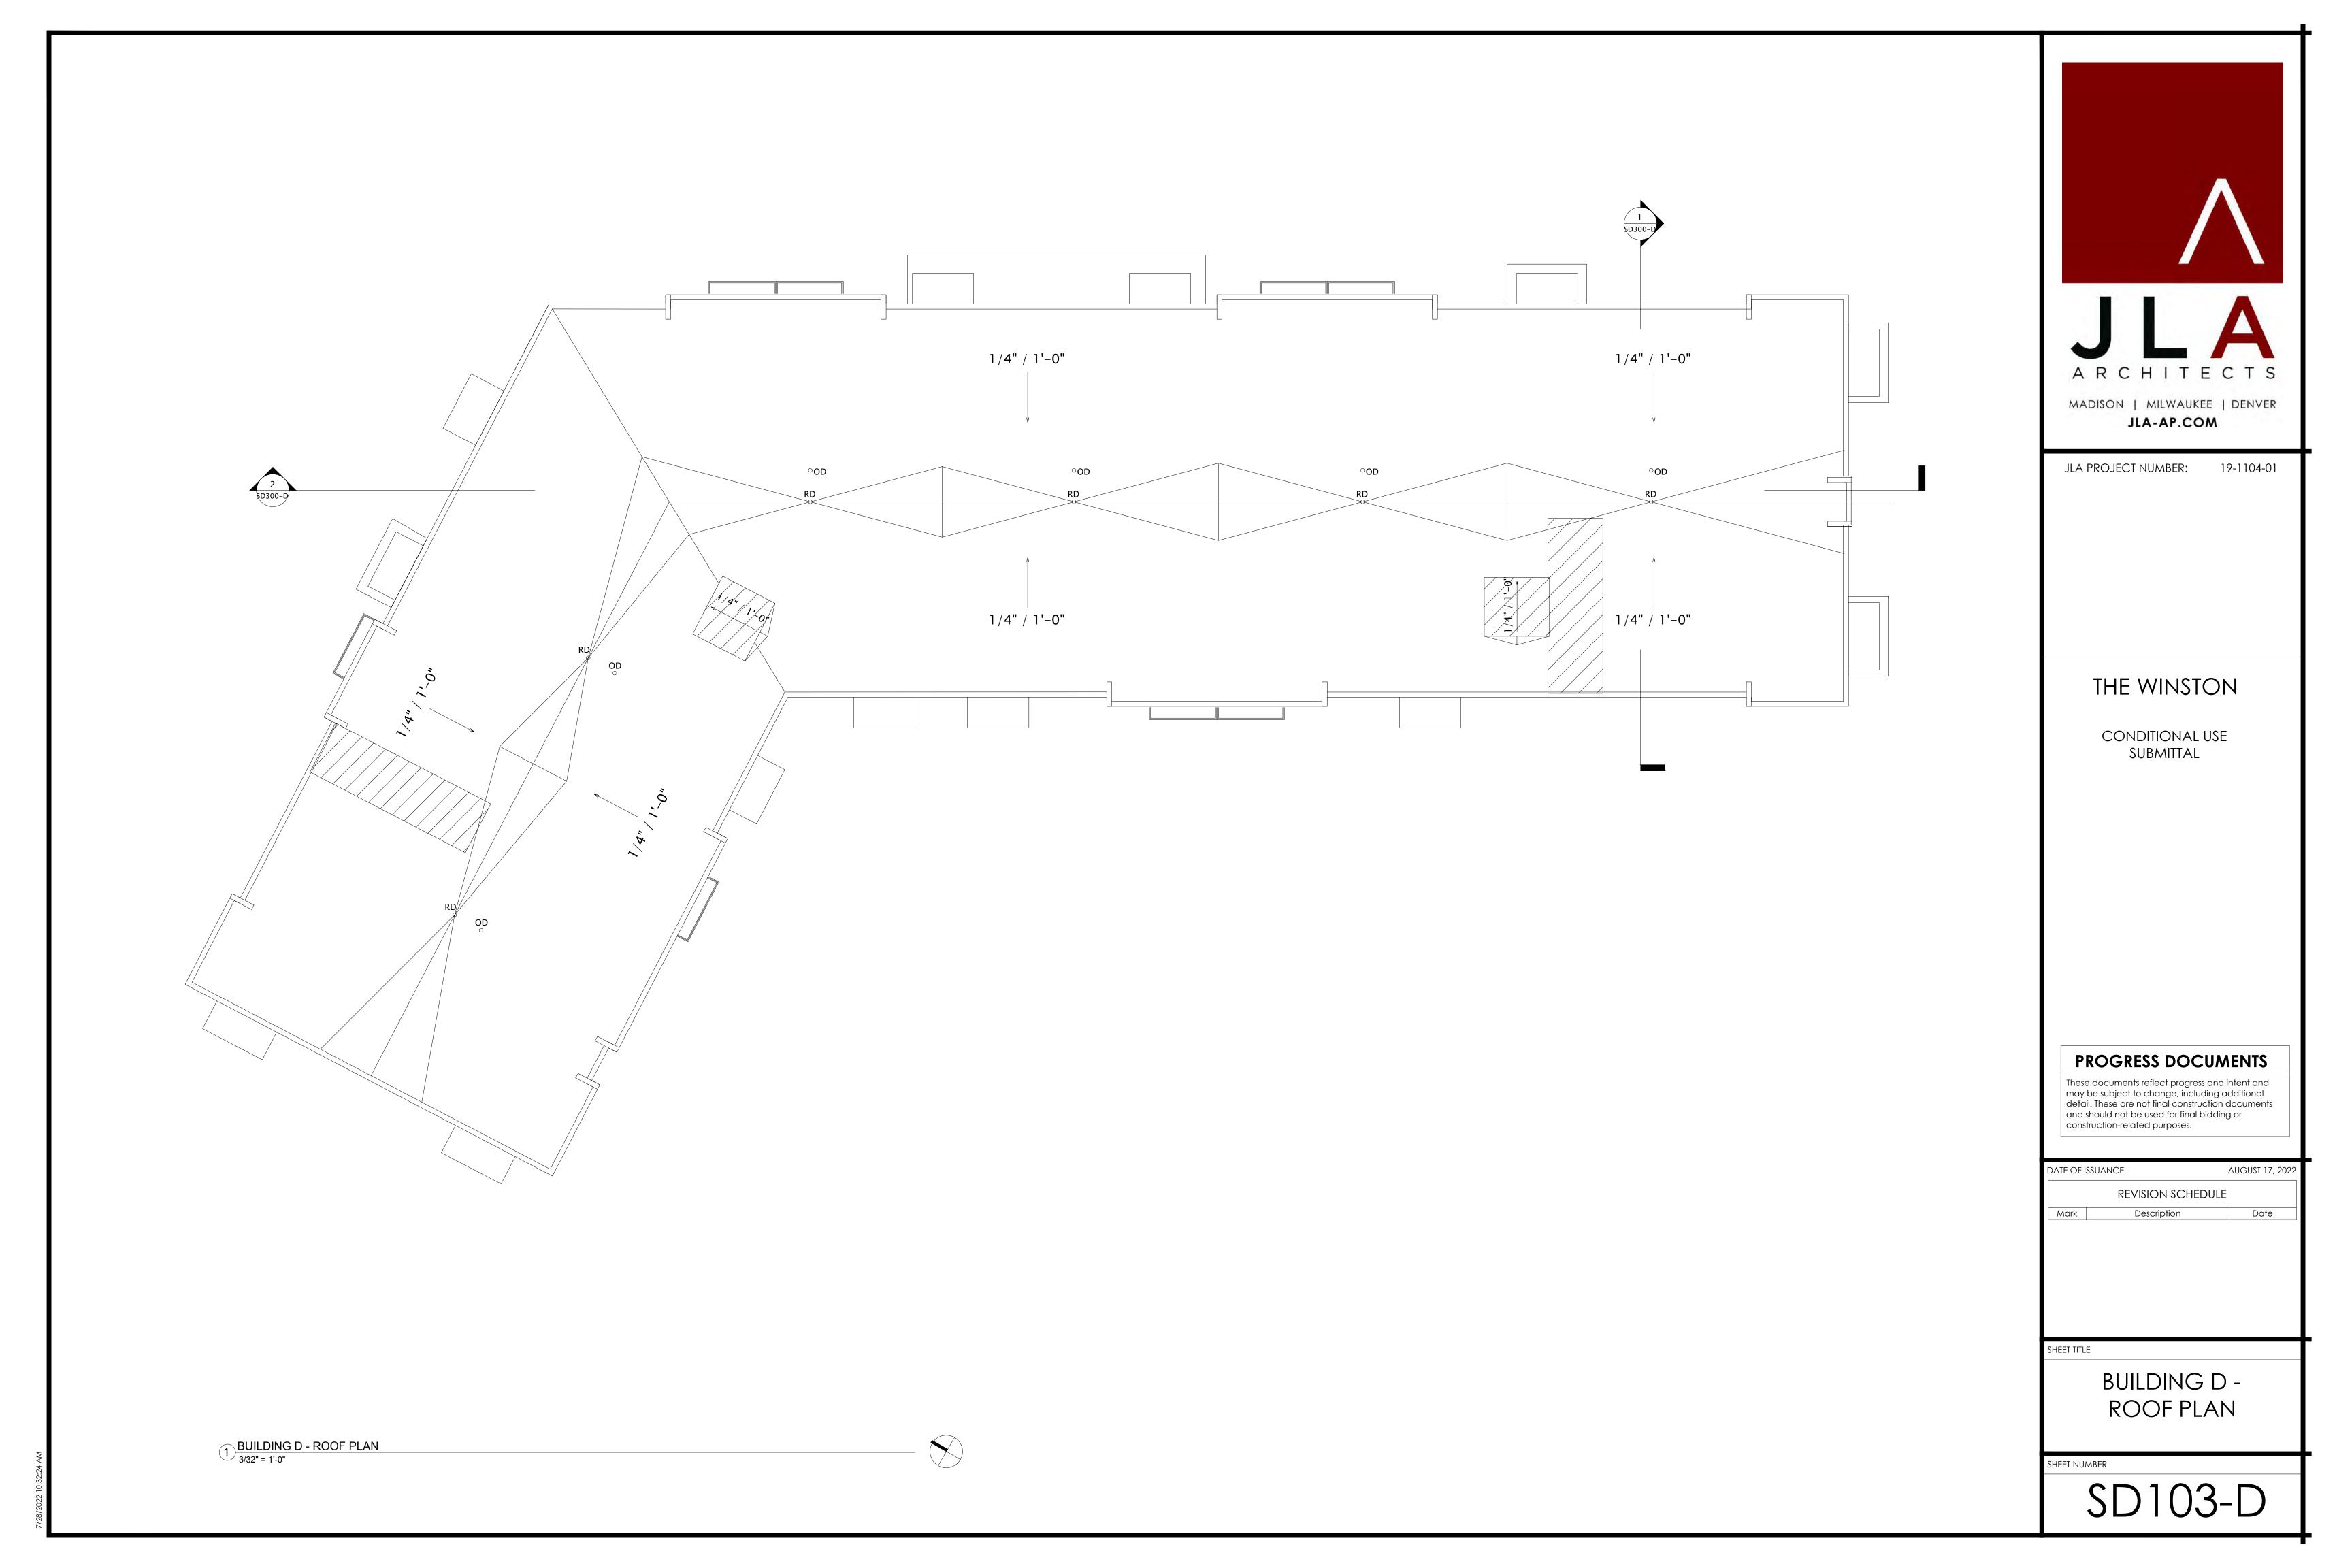EXTERIOR MATERIALS SCHEDULE					
MARK	DESCRIPTION	TYPE / STYLE	COLOR		
1	VINYL WINDOWS	LINDSAY WINDOWS & DOORS	BLACK		
2	VINYL PATIO DOORS	LINDSAY WINDOWS & DOORS	BLACK		
3	BALCONY RAILING	PAINTED METAL	BLACK		
4	BALCONY / DECK	COMPOSITE	TBD		
5	BALCONY FASCIA & TRIM	TBD	WALNUT		
6	MASONRY - STONE	DRY STACKED STONE	STAKLEDGE		
7	SIDING - 1 (LIGHT)	ULTRASHIELD	TEAK		
8	SIDING - 1 (DARK)	ULTRASHIELD	WALNUT		
9	DECORATIVE COLUMN	WOOD/WOOD COMPOSITE	TBD		
10	DECORATIVE BEAM	WOOD/WOOD COMPOSITE	TBD		
11	ACCENT CANOPY / ROOF	STANDING SEAM	WALNUT		
12	METAL PANEL	CORRUGATED	GALVANIZED		
13	RESIDENTIAL HVAC LOUVER / GRILLE	EXTRUDED ALUMINUM	PAINT TO MATCH ADJACENT MATERIALS		
14	PRECAST CONCRETE BANDING	PRECAST CONCRETE - SMOOTH FACE	TBD		
16	ALUMINUM ENTRANCE DOOR(S)	PREFINISHED ALUMINUM	BLACK		

BUILDING D - SIGNAGE AREA		
SIGNAGE TYPE AREA		
EAST ELEVATION		
CANOPY - RAISED	208 SF	

ROOF TRUSS BRG 142'-7 1/2"

FOURTH FLOOR 133'-5 5/8"

THIRD FLOOR 122'-3 3/4"

SECOND FLOOR

FIRST FLOOR



1 BUILDING D - SOUTH LONG
3/32" = 1'-0"

11 5 4 ROOF TRUSS BRG 142'-7 1/2" FOURTH FLOOR THIRD FLOOR SECOND FLOOR
111'-1 7/8"

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THE WINSTON

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DATE OF IS	DATE OF ISSUANCE		
REVISION SCHEDULE			
Mark	Description		Date
Mark	Description		Date

SHEET TITLE

BUILDING D -EXTERIOR ELEVATIONS

Sheet Number

2 BUILDING D - SOUTH SHORT
3/32" = 1'-0"

	EXTERIOR MATERIALS SCHEDULE			
MARK	DESCRIPTION	TYPE / STYLE	COLOR	
1	VINYL WINDOWS	LINDSAY WINDOWS & DOORS	BLACK	
2	VINYL PATIO DOORS	LINDSAY WINDOWS & DOORS	BLACK	
3	BALCONY RAILING	PAINTED METAL	BLACK	
4	BALCONY / DECK	COMPOSITE	TBD	
5	BALCONY FASCIA & TRIM	TBD	WALNUT	
6	MASONRY - STONE	DRY STACKED STONE	STAKLEDGE	
7	SIDING - 1 (LIGHT)	ULTRASHIELD	TEAK	
8	SIDING - 1 (DARK)	ULTRASHIELD	WALNUT	
9	DECORATIVE COLUMN	WOOD/WOOD COMPOSITE	TBD	
10	DECORATIVE BEAM	WOOD/WOOD COMPOSITE	TBD	
11	ACCENT CANOPY / ROOF	STANDING SEAM	WALNUT	
12	METAL PANEL	CORRUGATED	GALVANIZED	
13	RESIDENTIAL HVAC LOUVER / GRILLE	EXTRUDED ALUMINUM	PAINT TO MATCH ADJACENT MATERIALS	
14	PRECAST CONCRETE BANDING	PRECAST CONCRETE - SMOOTH FACE	TBD	
16	ALUMINUM ENTRANCE DOOR(S)	PREFINISHED ALUMINUM	BLACK	

2 BUILDING D - WEST LONG
3/32" = 1'-0"

	BUILDING D - SIGNAGE AREA		
	AREA		
•	EAST ELEVATION		
CANOPY - RAISED 208 SF		208 SF	



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THE WINSTON

CONDITIONAL USE SUBMITTAL

PROGRESS DOCUMENTS


These documents reflect progress and intent and may be subject to change, including additional detail. These are not final construction documents and should not be used for final bidding or construction-related purposes.

SHEET I

BUILDING D -EXTERIOR ELEVATIONS

SHEET NUMBER

SD201-D

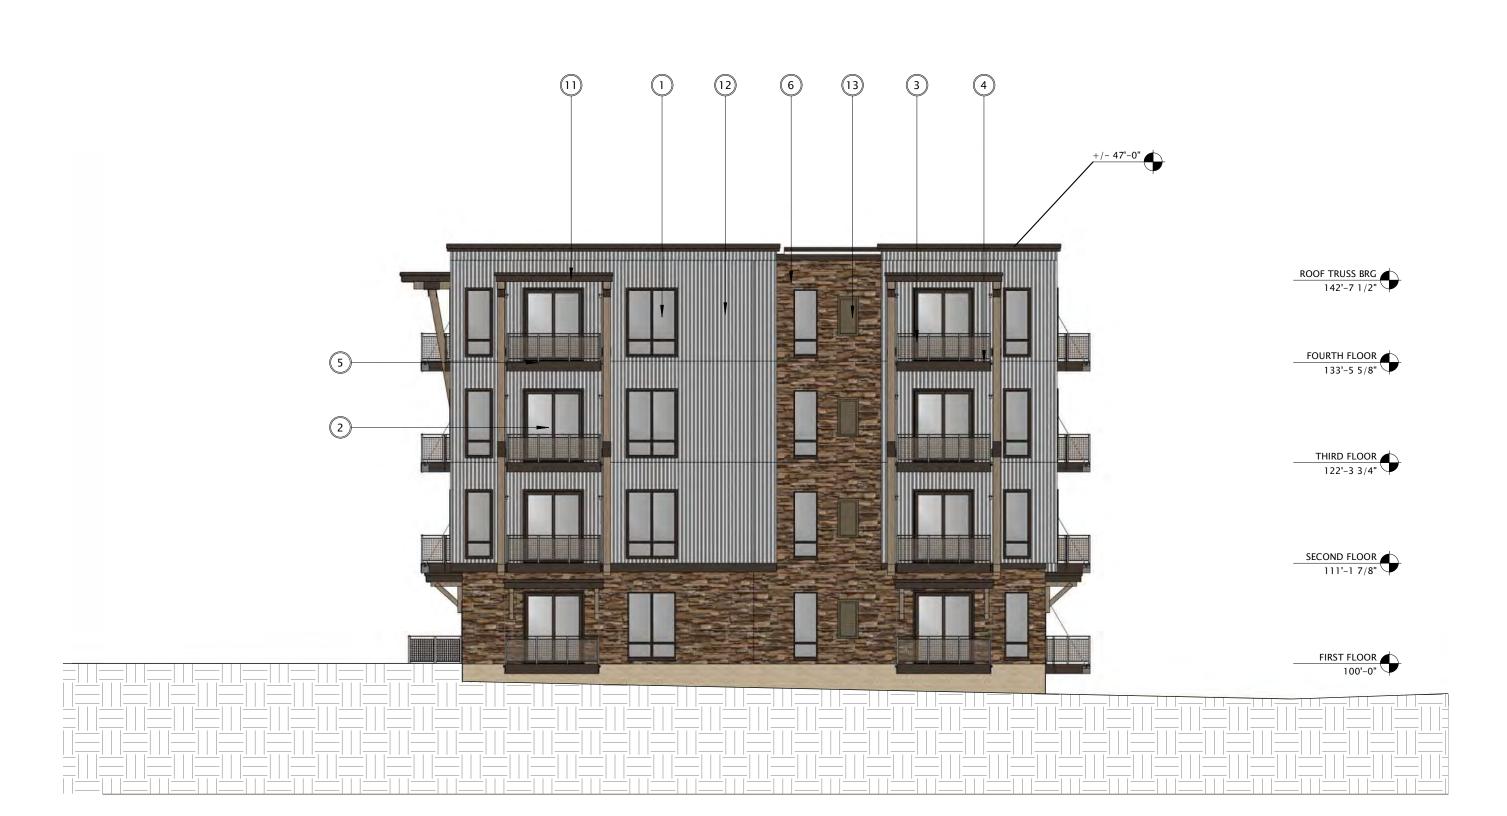

3 BUILDING D - WEST SHORT
3/32" = 1'-0"

		EXTERIOR MATERIALS SCHEDULE	
ЛARK	DESCRIPTION	TYPE / STYLE	COLOR
1	VINYL WINDOWS	LINDSAY WINDOWS & DOORS	BLACK
2	VINYL PATIO DOORS	LINDSAY WINDOWS & DOORS	BLACK
3	BALCONY RAILING	PAINTED METAL	BLACK
4	BALCONY / DECK	COMPOSITE	TBD
5	BALCONY FASCIA & TRIM	TBD	WALNUT
6	MASONRY - STONE	DRY STACKED STONE	STAKLEDGE
7	SIDING - 1 (LIGHT)	ULTRASHIELD	TEAK
8	SIDING - 1 (DARK)	ULTRASHIELD	WALNUT
9	DECORATIVE COLUMN	WOOD/WOOD COMPOSITE	TBD
10	DECORATIVE BEAM	WOOD/WOOD COMPOSITE	TBD
11	ACCENT CANOPY / ROOF	STANDING SEAM	WALNUT
12	METAL PANEL	CORRUGATED	GALVANIZED
13	RESIDENTIAL HVAC LOUVER / GRILLE	EXTRUDED ALUMINUM	PAINT TO MATCH ADJACENT MATERIALS
14	PRECAST CONCRETE BANDING	PRECAST CONCRETE - SMOOTH FACE	TBD
16	ALUMINUM ENTRANCE DOOR(S)	PREFINISHED ALUMINUM	BLACK

BUILDING D - SIGNAGE AREA

SIGNAGE TYPE ARE

EAST ELEVATION
CANOPY - RAISED 208 SF



1 BUILDING D - EAST 3/32" = 1'-0"





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DATE OF ISSUANCE AUGUST 17, 2022				
REVISION SCHEDULE				
Description		Date		
	REVISION SCHED	REVISION SCHEDULE		

SHEET TITLE

BUILDING D -EXTERIOR ELEVATIONS

SHEET NUMBER

SD202-D

	EXTERIOR MATERIALS SCHEDULE 2			
MARK	DESCRIPTION	TYPE / STYLE	COLOR	
1	VINYL WINDOWS	LINDSAY WINDOWS & DOORS	BLACK	
2	VINYL PATIO DOORS	LINDSAY WINDOWS & DOORS	BLACK	
3	BALCONY RAILING	PAINTED METAL	BLACK	
4	BALCONY / DECK	COMPOSITE	TBD	
5	BALCONY FASCIA & TRIM	TBD	WALNUT	
6	MASONRY - STONE	DRY STACKED STONE	STAKLEDGE	
7	SIDING - 1 (LIGHT)	ULTRASHIELD	TEAK	
8	SIDING - 1 (DARK)	ULTRASHIELD	WALNUT	
9	DECORATIVE COLUMN	WOOD/WOOD COMPOSITE	TBD	
10	DECORATIVE BEAM	WOOD/WOOD COMPOSITE	TBD	
11	ACCENT CANOPY / ROOF	STANDING SEAM	WALNUT	
12	METAL PANEL	CORRUGATED	GALVANIZED	
13	RESIDENTIAL HVAC LOUVER / GRILLE	EXTRUDED ALUMINUM	PAINT TO MATCH ADJACENT MATERIALS	
14	PRECAST CONCRETE BANDING	PRECAST CONCRETE - SMOOTH FACE	TBD	
16	ALUMINUM ENTRANCE DOOR(S)	PREFINISHED ALUMINUM	BLACK	

BUILDING D - SIGNAGE AREA			
SIGNAGE TYPE AREA			
EAST ELEVATION			
CANOPY - RAISED	208 SF		


ROOF TRUSS BRG 142'-7 1/2"

FOURTH FLOOR

THIRD FLOOR
122'-3 3/4"



2 BUILDING D - SOUTH LONG 1
3/32" = 1'-0"

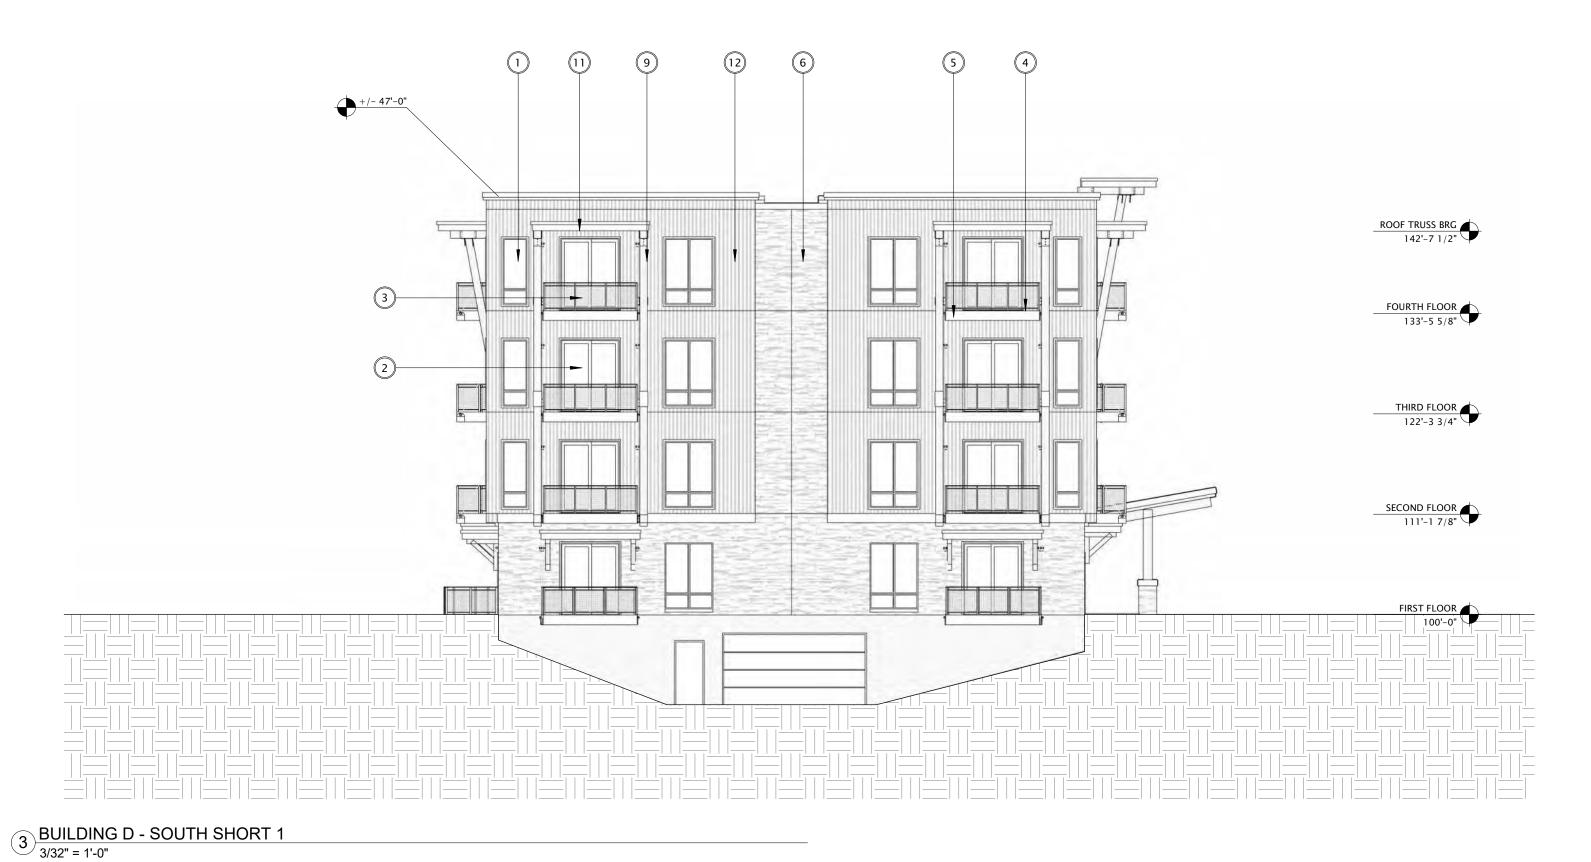

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DATE OF	ISSUANCE A	AUGUST 17, 2022	
revision schedule			
Mark	Description	Date	

SHEET TITLE

BUILDING D -EXTERIOR ELEVATIONS B&W

SHEET NUMBER

SD203-D

	EXTERIOR MATERIALS SCHEDULE 3				
MARK	DESCRIPTION	TYPE / STYLE	COLOR		
1	VINYL WINDOWS	LINDSAY WINDOWS & DOORS	BLACK		
2	VINYL PATIO DOORS	LINDSAY WINDOWS & DOORS	BLACK		
3	BALCONY RAILING	PAINTED METAL	BLACK		
4	BALCONY / DECK	COMPOSITE	TBD		
5	BALCONY FASCIA & TRIM	TBD	WALNUT		
6	MASONRY - STONE	DRY STACKED STONE	STAKLEDGE		
7	SIDING - 1 (LIGHT)	ULTRASHIELD	TEAK		
8	SIDING - 1 (DARK)	ULTRASHIELD	WALNUT		
9	DECORATIVE COLUMN	WOOD/WOOD COMPOSITE	TBD		
10	DECORATIVE BEAM	WOOD/WOOD COMPOSITE	TBD		
11	ACCENT CANOPY / ROOF	STANDING SEAM	WALNUT		
12	METAL PANEL	CORRUGATED	GALVANIZED		
13	RESIDENTIAL HVAC LOUVER / GRILLE	EXTRUDED ALUMINUM	PAINT TO MATCH ADJACENT MATERIALS		
14	PRECAST CONCRETE BANDING	PRECAST CONCRETE - SMOOTH FACE	TBD		
16	ALUMINUM ENTRANCE DOOR(S)	PREFINISHED ALUMINUM	BLACK		

BUILDING D - SIGNAGE AREA		
SIGNAGE TYPE AREA		
EAST ELEVATION		
CANOPY - RAISED	208 SF	





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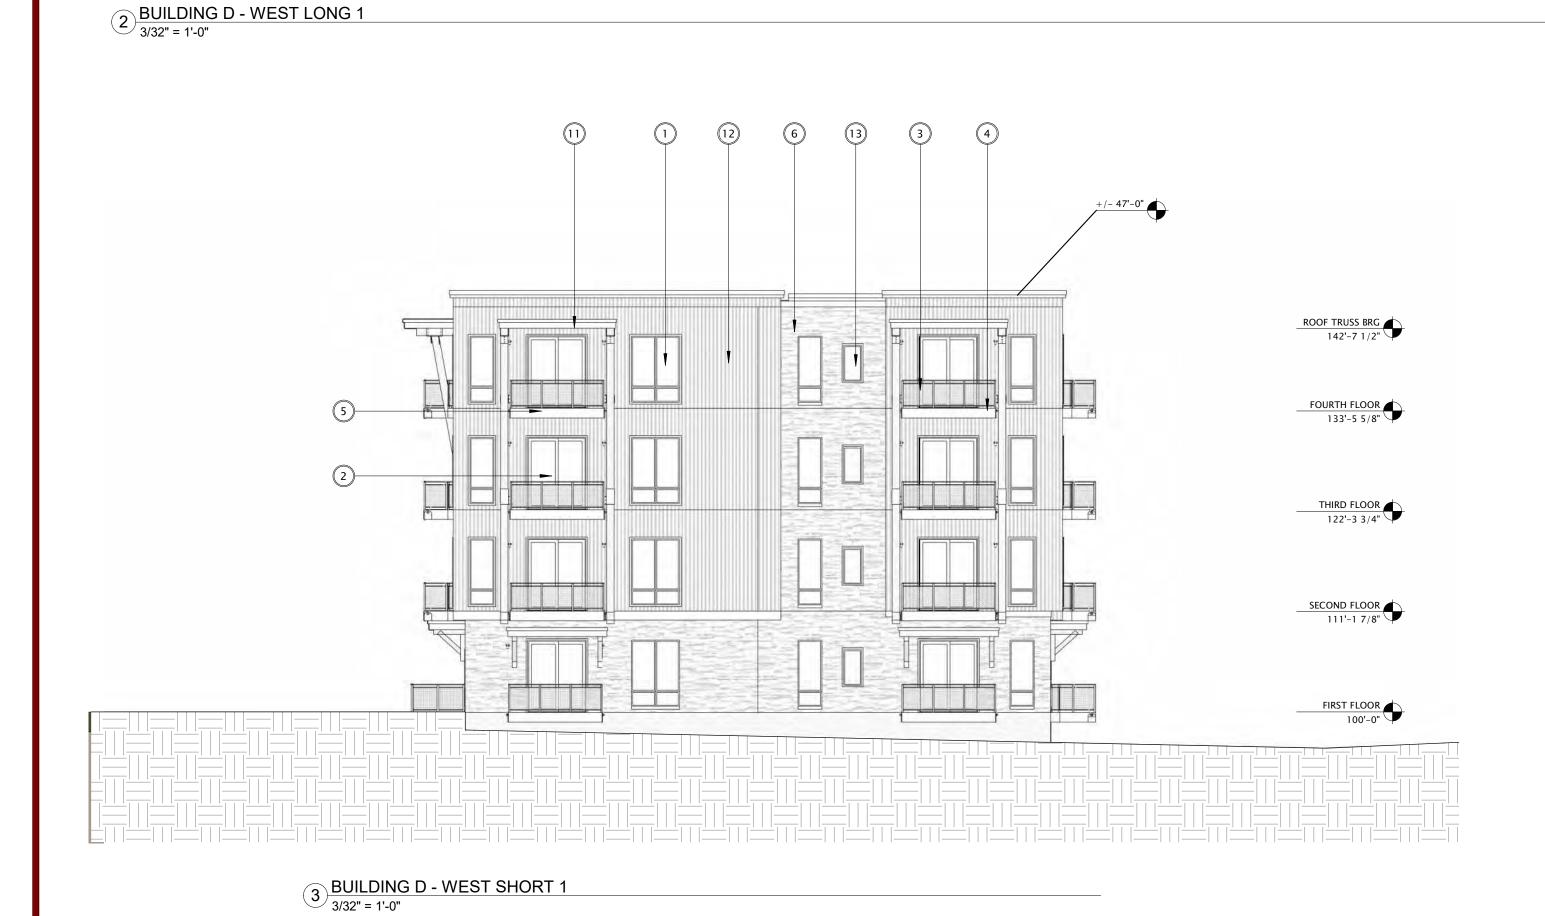
Mark Description E	Dat

SHEET T

BUILDING D -EXTERIOR ELEVATIONS B&W

SHEET NUMBER

SD204-D





5

2 BUILDING D - NORTH 1
3/32" = 1'-0"

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PROGRESS DOCUMENTS


may be subject to change, including additional detail. These are not final construction documents and should not be used for final bidding or construction-related purposes.


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	REVISION SCHEDULE	
ark	Description	Date

BUILDING D -EXTERIOR ELEVATIONS B&W

SHEET NUMBER

SD205-D

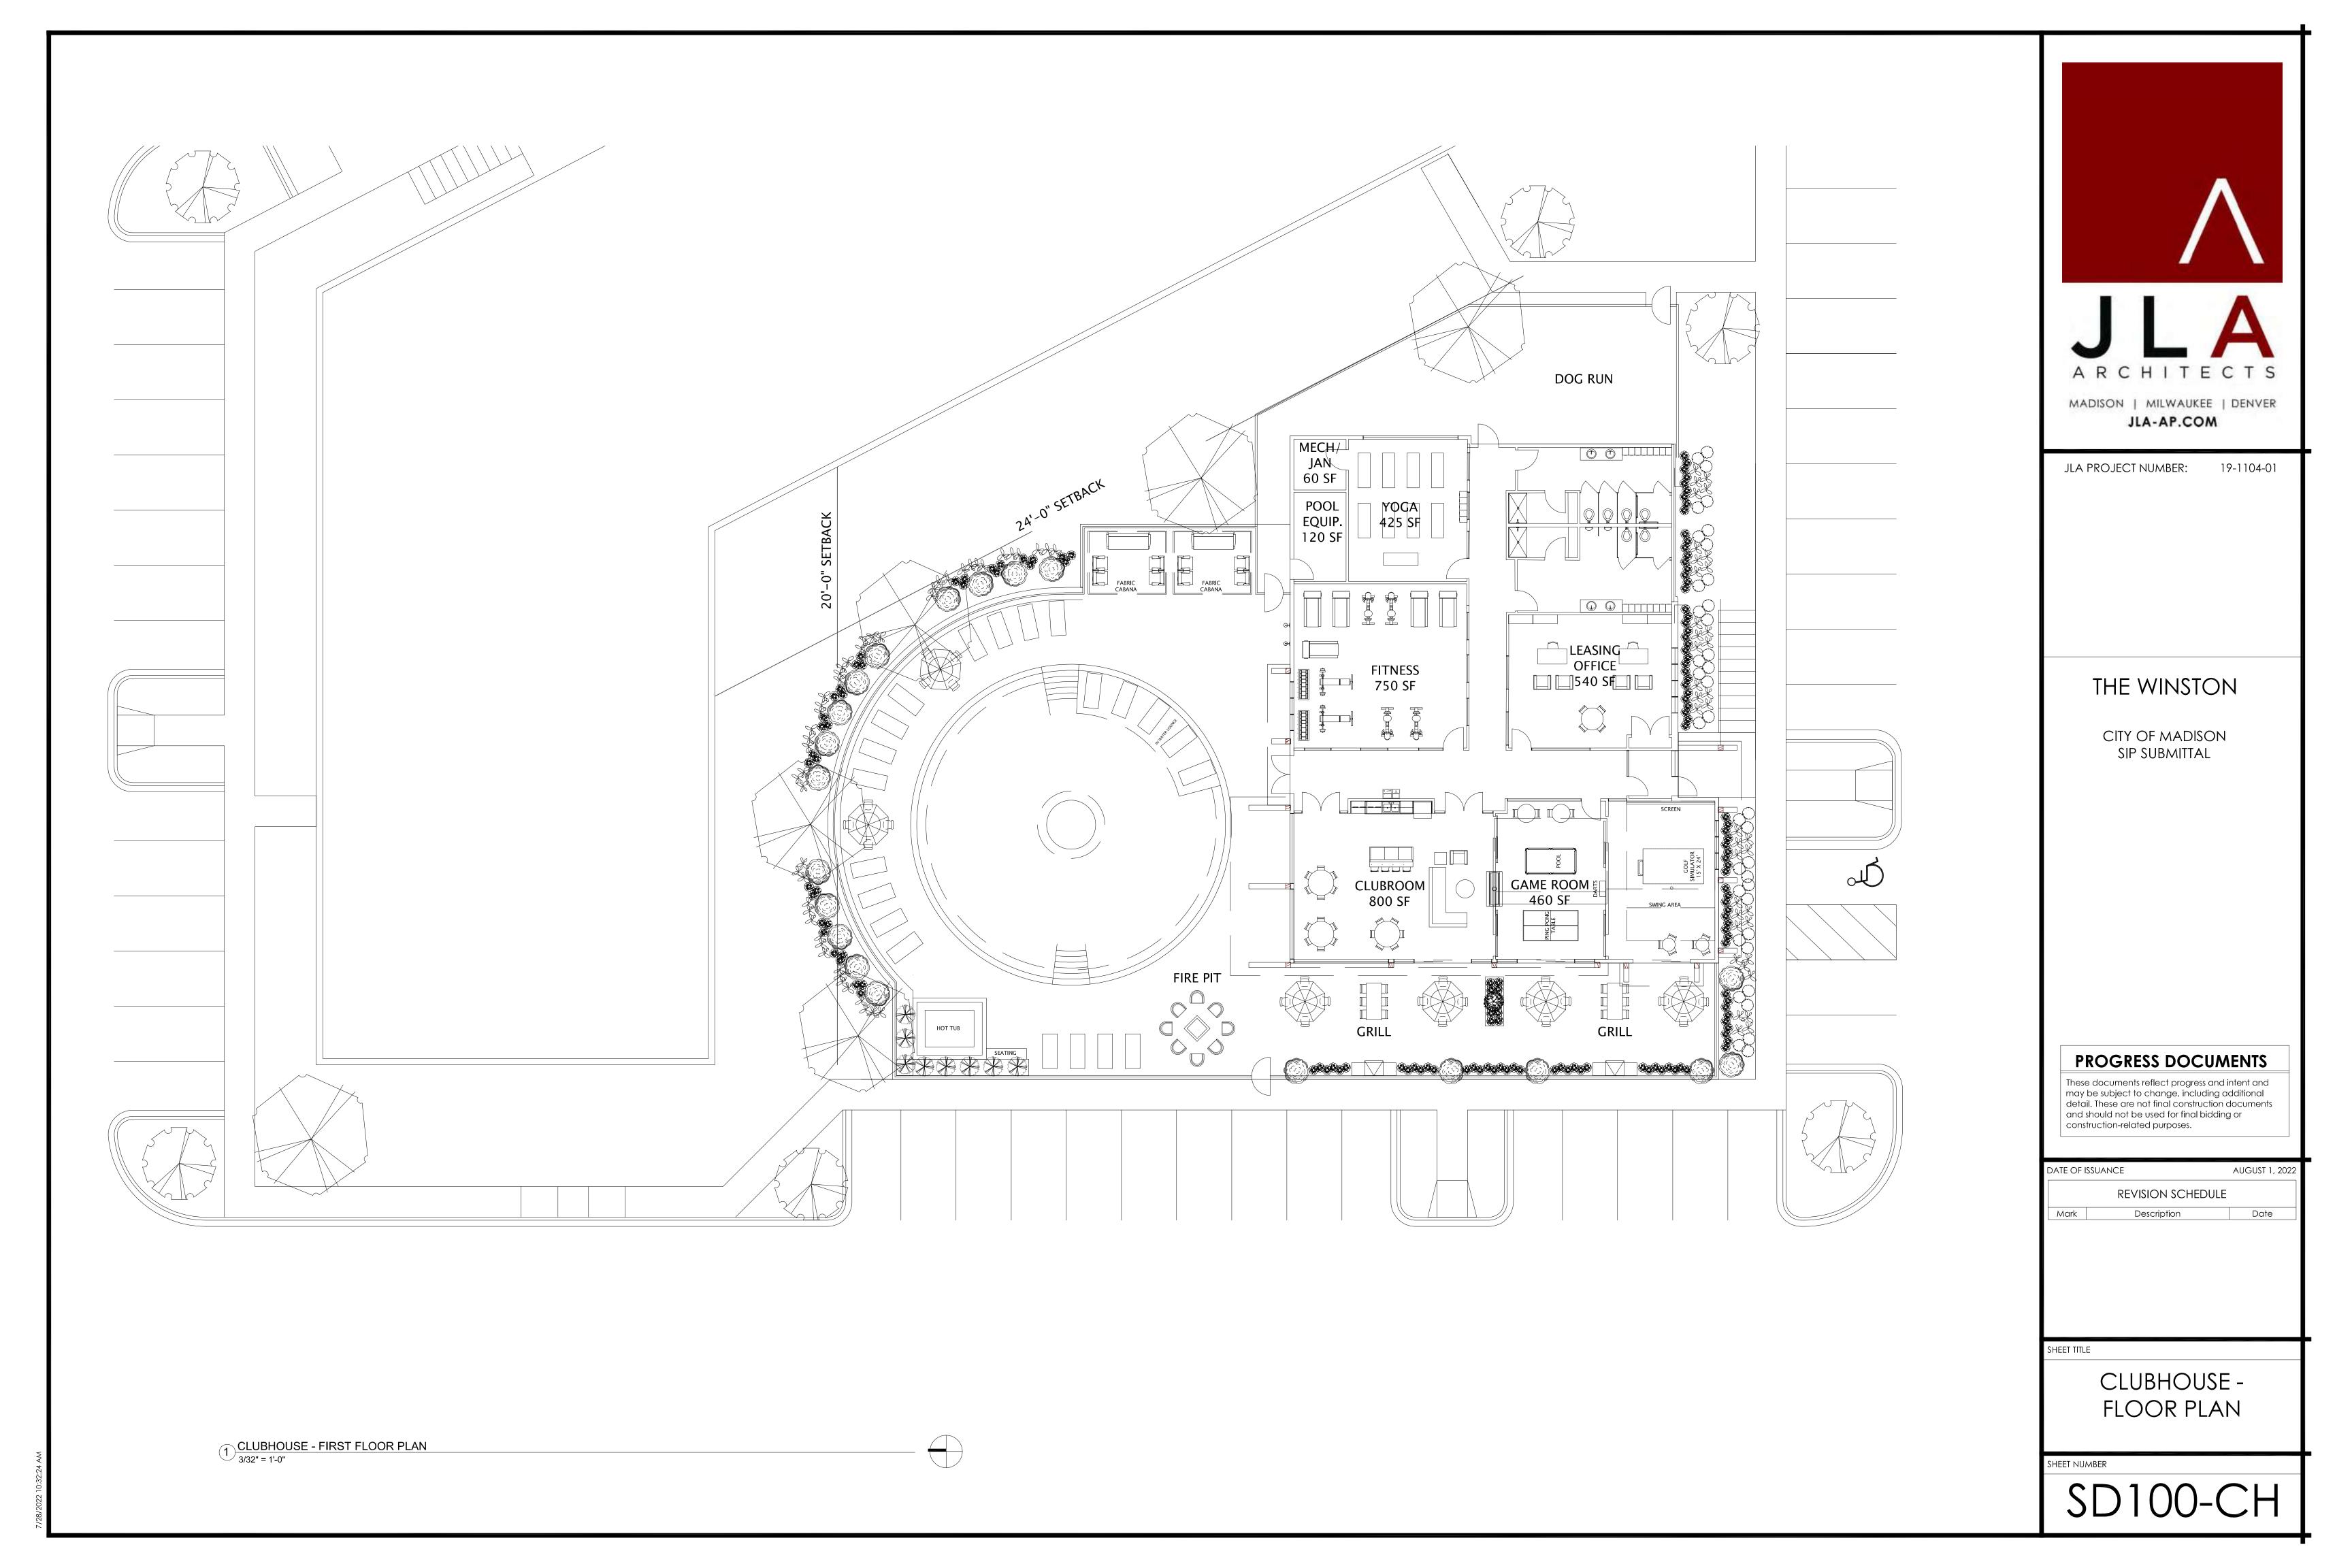

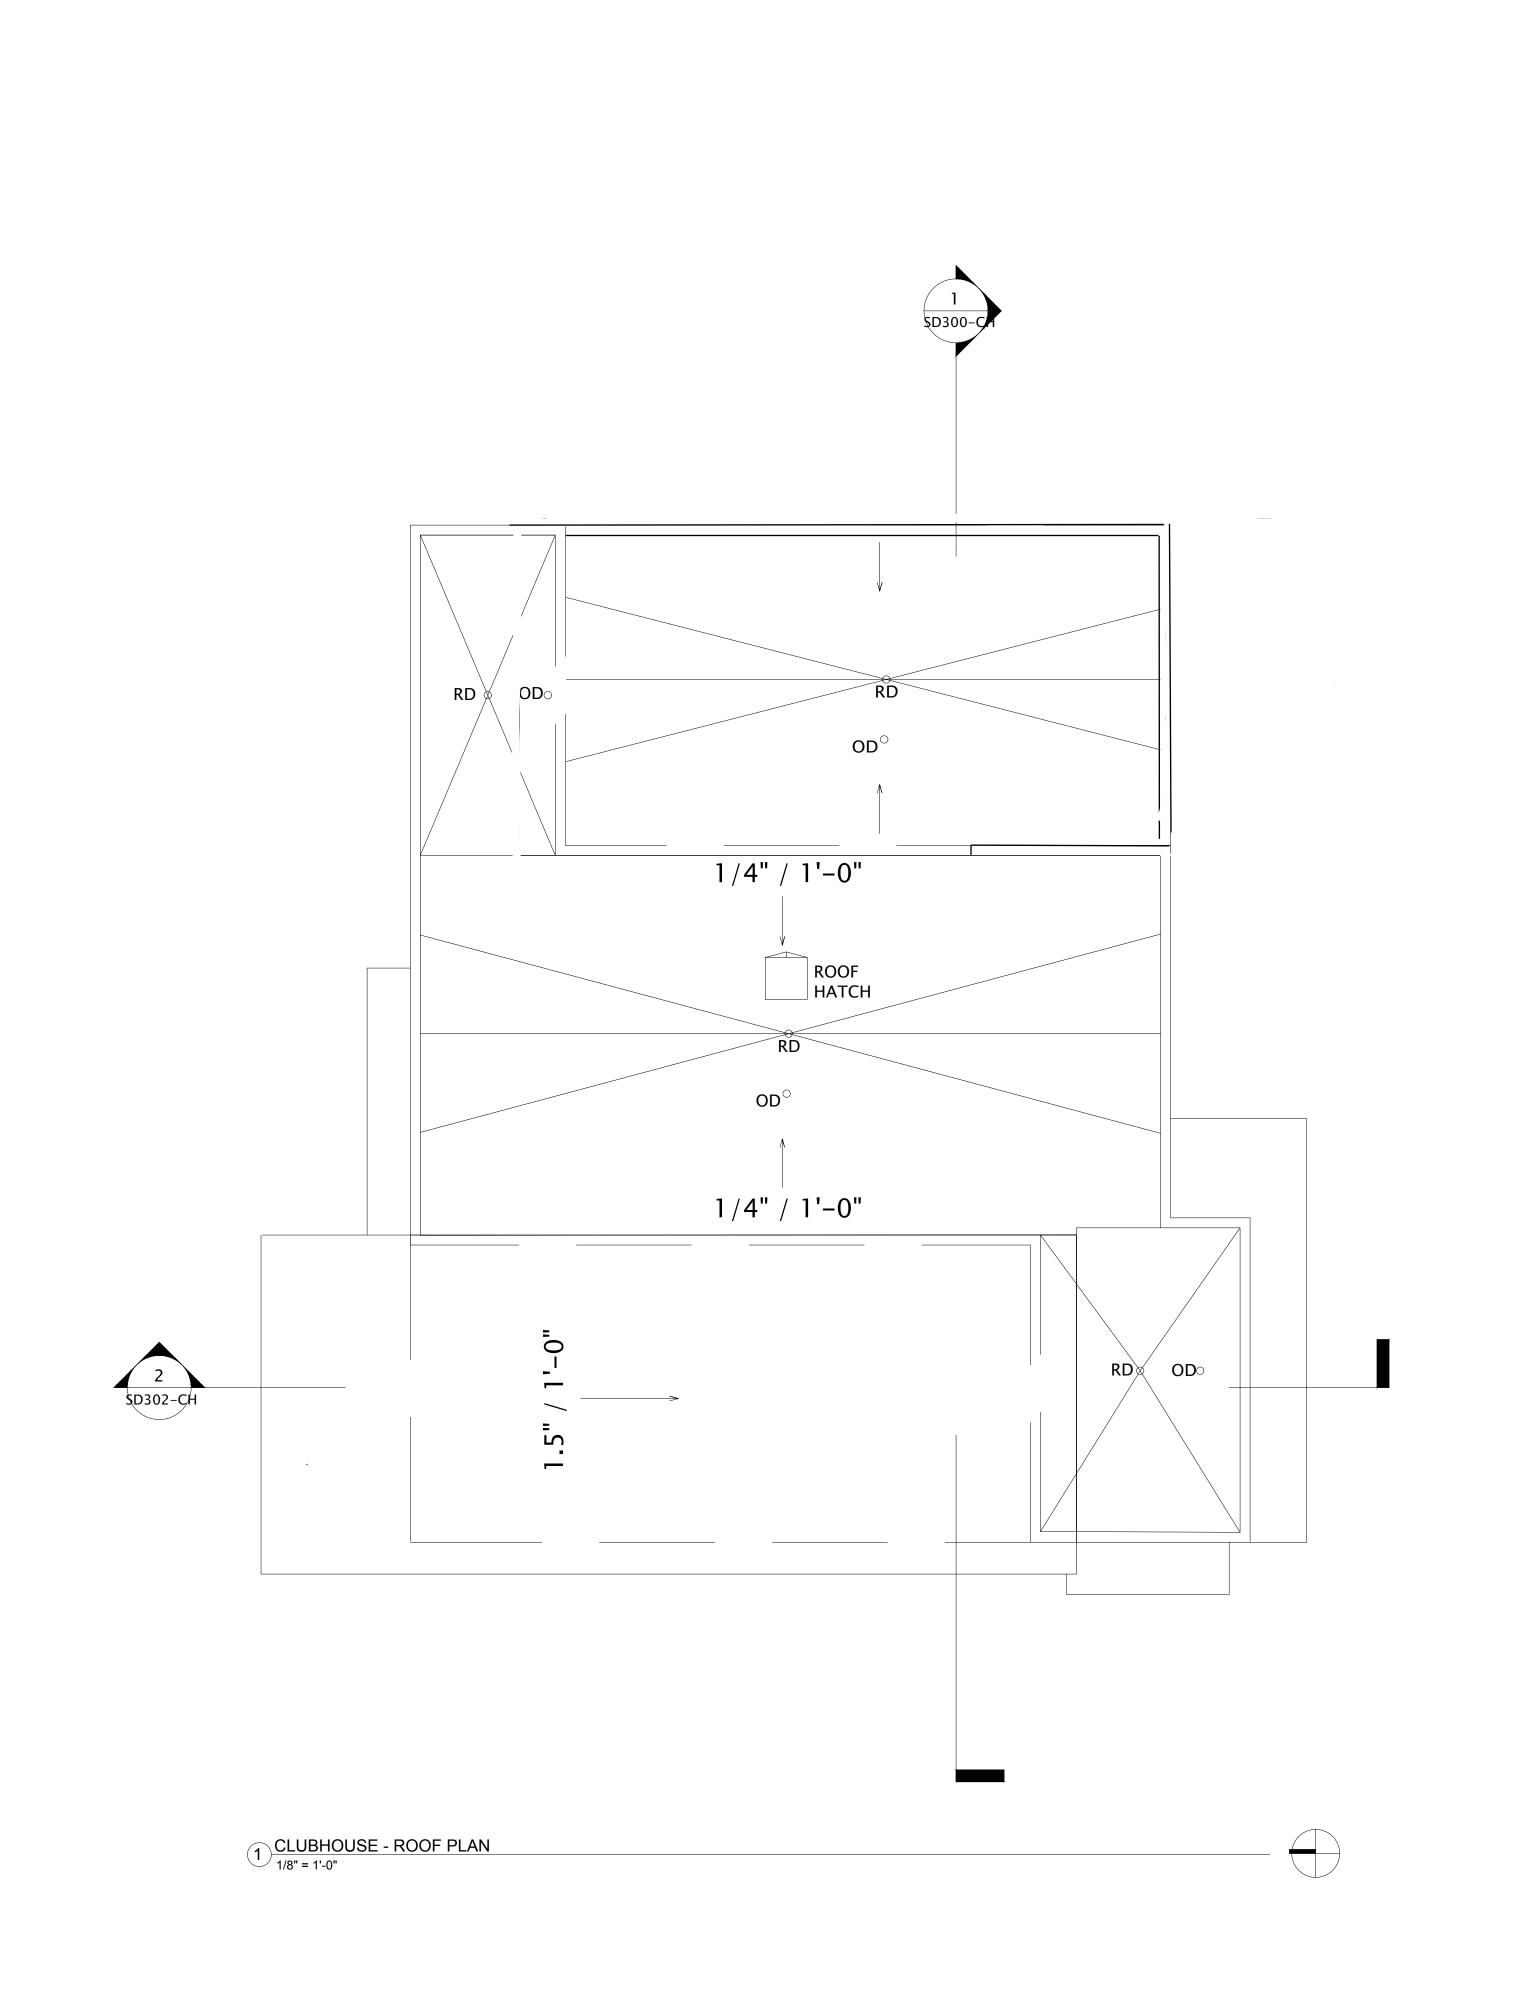



JLA PROJECT NUMBER: 19-1104-01

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CITY OF MADISON SIP SUBMITTAL

PROGRESS DOCUMENTS

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	revision schedule			
Mark	Description	Date		


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CLUBHOUSE -ROOF PLAN


SHEET NUMBER

SD101-CH

	EXTERIOR MATERIALS SCHEDULE 1					
MARK	DESCRIPTION	TYPE / STYLE	COLOR			
1	VINYL WINDOWS	LINDSAY WINDOWS & DOORS	BLACK			
2	VINYL PATIO DOORS	LINDSAY WINDOWS & DOORS	BLACK			
3	BALCONY RAILING	PAINTED METAL	BLACK			
4	BALCONY / DECK	COMPOSITE	TBD			
5	BALCONY FASCIA & TRIM	TBD	WALNUT			
6	MASONRY - STONE	DRY STACKED STONE	STAKLEDGE			
7	SIDING - 1 (LIGHT)	ULTRASHIELD	TEAK			
8	SIDING - 1 (DARK)	ULTRASHIELD	WALNUT			
9	DECORATIVE COLUMN	WOOD/WOOD COMPOSITE	TBD			
10	DECORATIVE BEAM	WOOD/WOOD COMPOSITE	TBD			
11	ACCENT CANOPY / ROOF	STANDING SEAM	WALNUT			
12	METAL PANEL	CORRUGATED	GALVANIZED			
13	RESIDENTIAL HVAC LOUVER / GRILLE	EXTRUDED ALUMINUM	PAINT TO MATCH ADJACENT MATERIALS			
14	PRECAST CONCRETE BANDING	PRECAST CONCRETE - SMOOTH FACE	TBD			
16	ALUMINUM ENTRANCE DOOR(S)	PREFINISHED ALUMINUM	BLACK			
17	60" ALUMINUM FENCE	PREFINISHED ALUMINUM	BLACK			

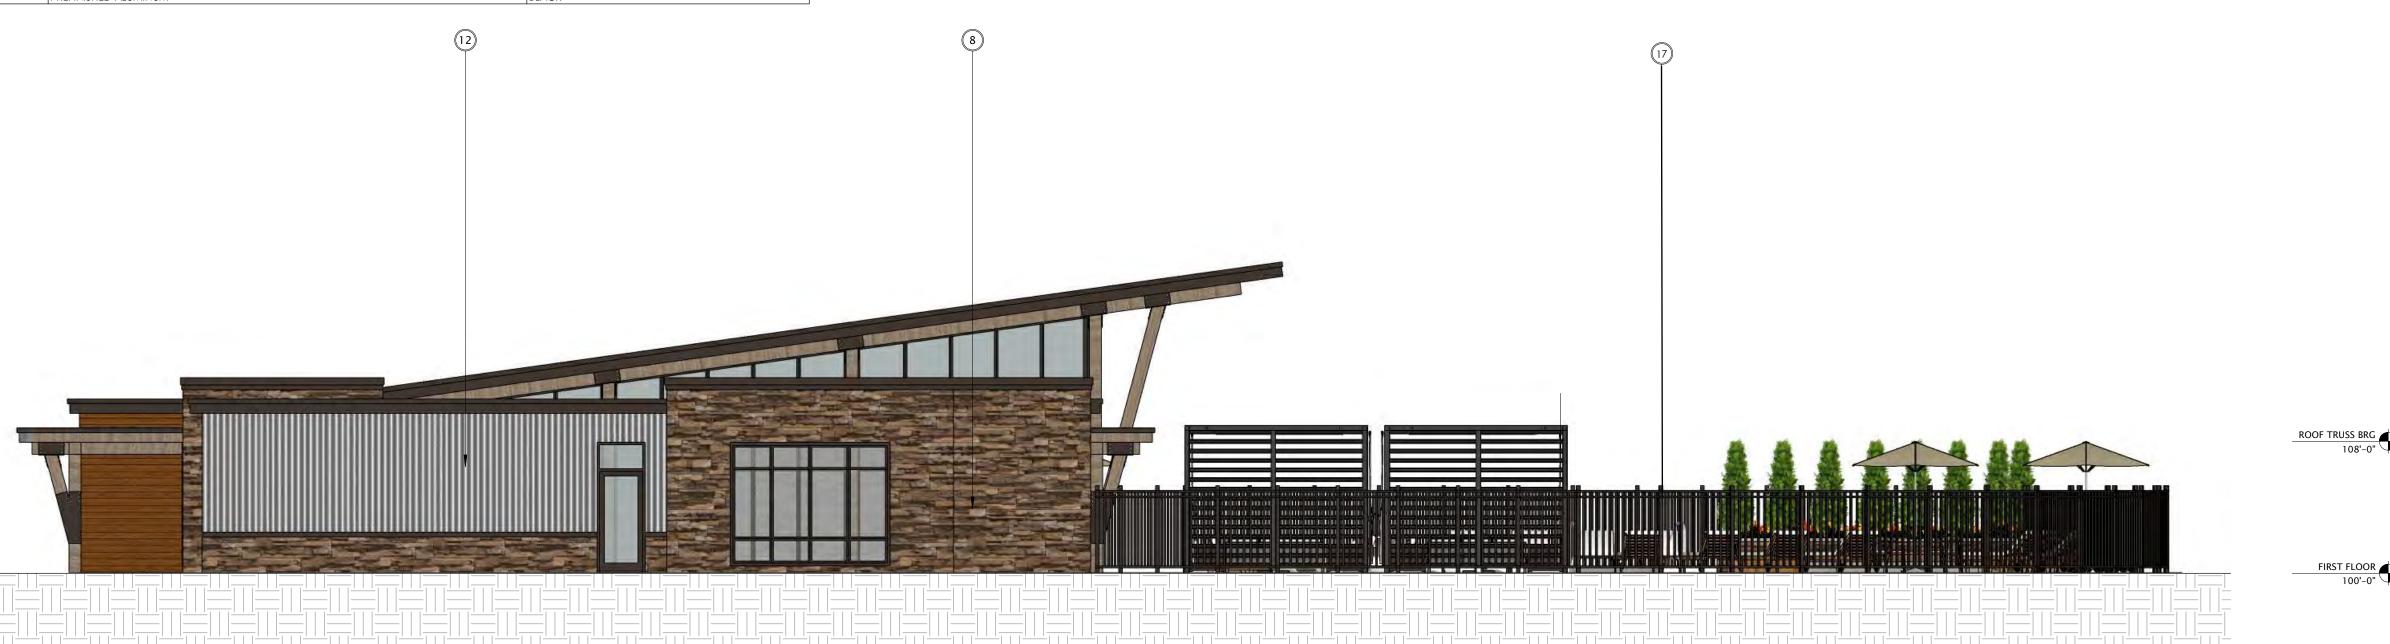

CLUBHOUSE - EAST 1

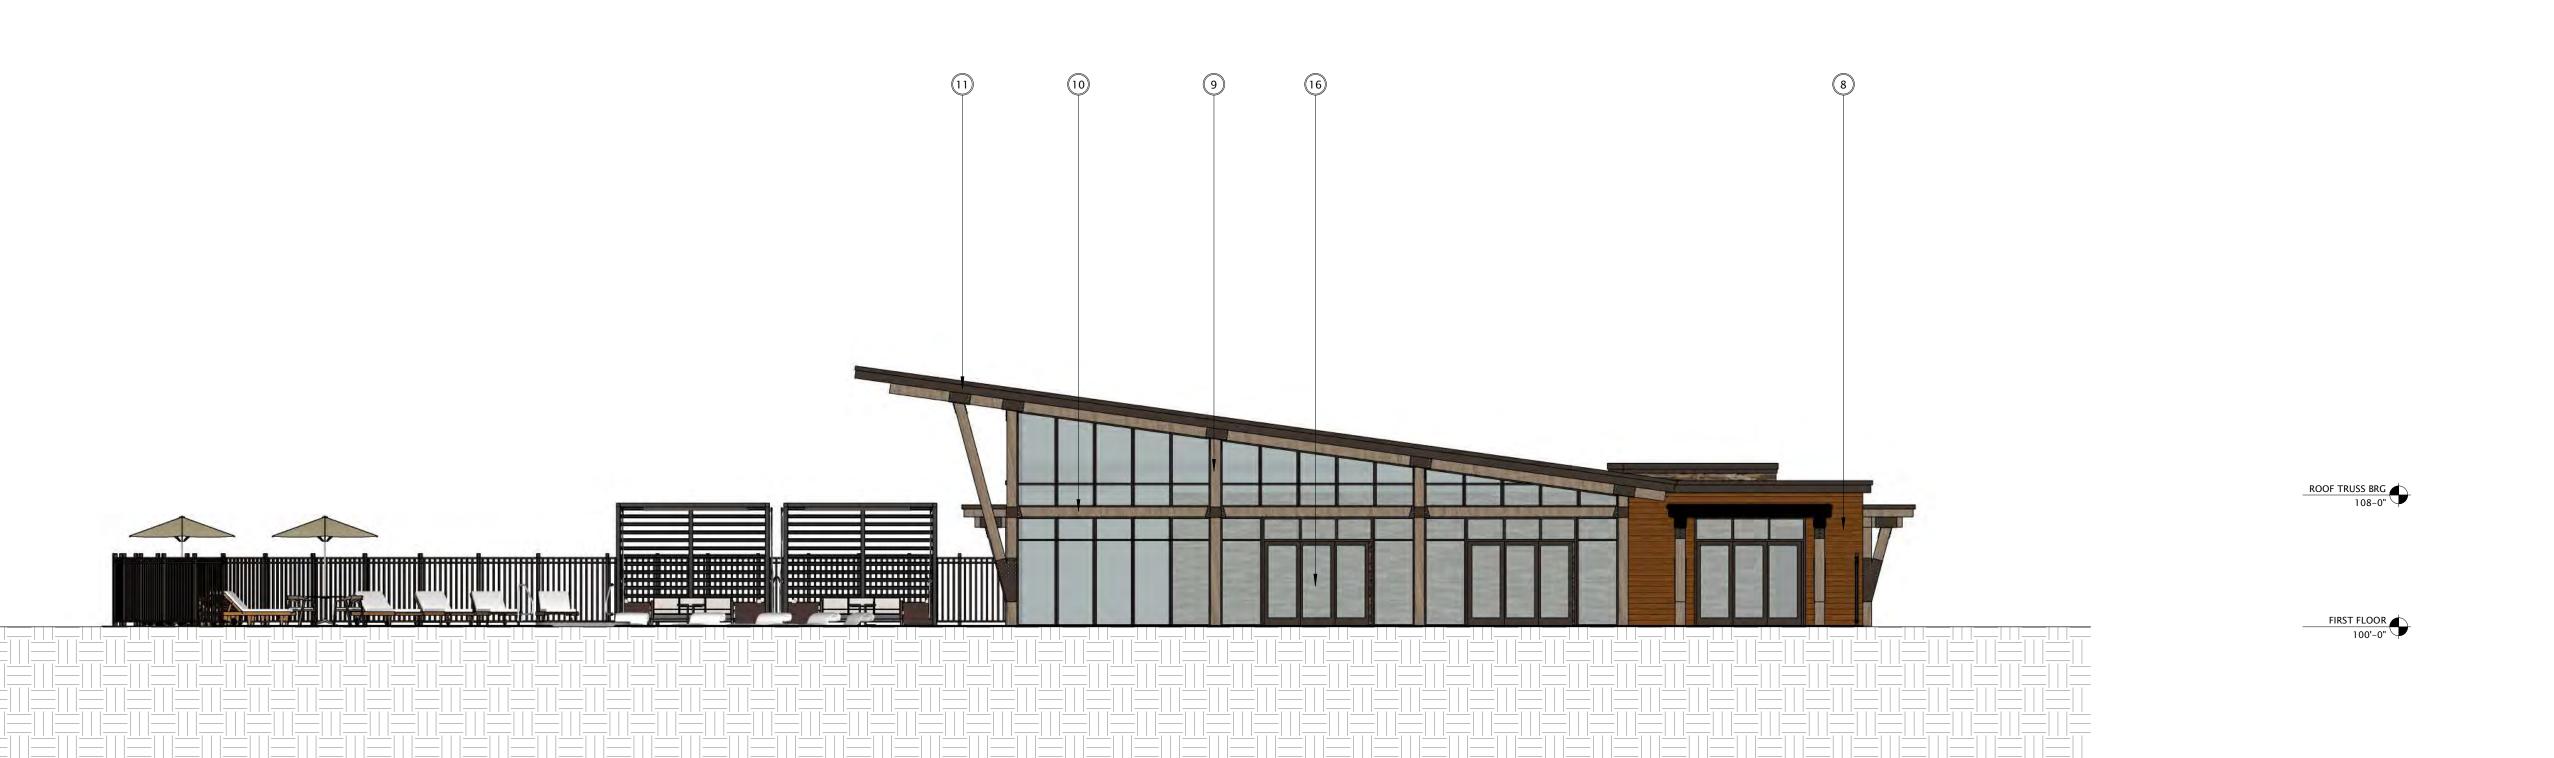



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DATE OF ISSUANCE

REVISION SCHEDULE

Mark Description Date

SHEET TITLE

CLUBHOUSE -EXTERIOR ELEVATIONS

SHEET NUMBER

SD200-CH

	EXTERIOR MATERIALS SCHEDULE 1					
MARK	DESCRIPTION	TYPE / STYLE	COLOR			
1	VINYL WINDOWS	LINDSAY WINDOWS & DOORS	BLACK			
2	VINYL PATIO DOORS	LINDSAY WINDOWS & DOORS	BLACK			
3	BALCONY RAILING	PAINTED METAL	BLACK			
4	BALCONY / DECK	COMPOSITE	TBD			
5	BALCONY FASCIA & TRIM	TBD	WALNUT			
6	MASONRY - STONE	DRY STACKED STONE	STAKLEDGE			
7	SIDING - 1 (LIGHT)	ULTRASHIELD	TEAK			
8	SIDING - 1 (DARK)	ULTRASHIELD	WALNUT			
9	DECORATIVE COLUMN	WOOD/WOOD COMPOSITE	TBD			
10	DECORATIVE BEAM	WOOD/WOOD COMPOSITE	TBD			
11	ACCENT CANOPY / ROOF	STANDING SEAM	WALNUT			
12	METAL PANEL	CORRUGATED	GALVANIZED			
13	RESIDENTIAL HVAC LOUVER / GRILLE	EXTRUDED ALUMINUM	PAINT TO MATCH ADJACENT MATERIALS			
14	PRECAST CONCRETE BANDING	PRECAST CONCRETE - SMOOTH FACE	TBD			
16	ALUMINUM ENTRANCE DOOR(S)	PREFINISHED ALUMINUM	BLACK			
17	60" ALUMINUM FENCE	PREFINISHED ALUMINUM	BLACK			



1 CLUBHOUSE - NORTH 1 3/16" = 1'-0"



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DATE OF ISSUANCE A			
REVISION SCHEDULE			
Mark Description			
	REVISION SCHEDULE		

SHEET TITL

CLUBHOUSE -EXTERIOR ELEVATIONS


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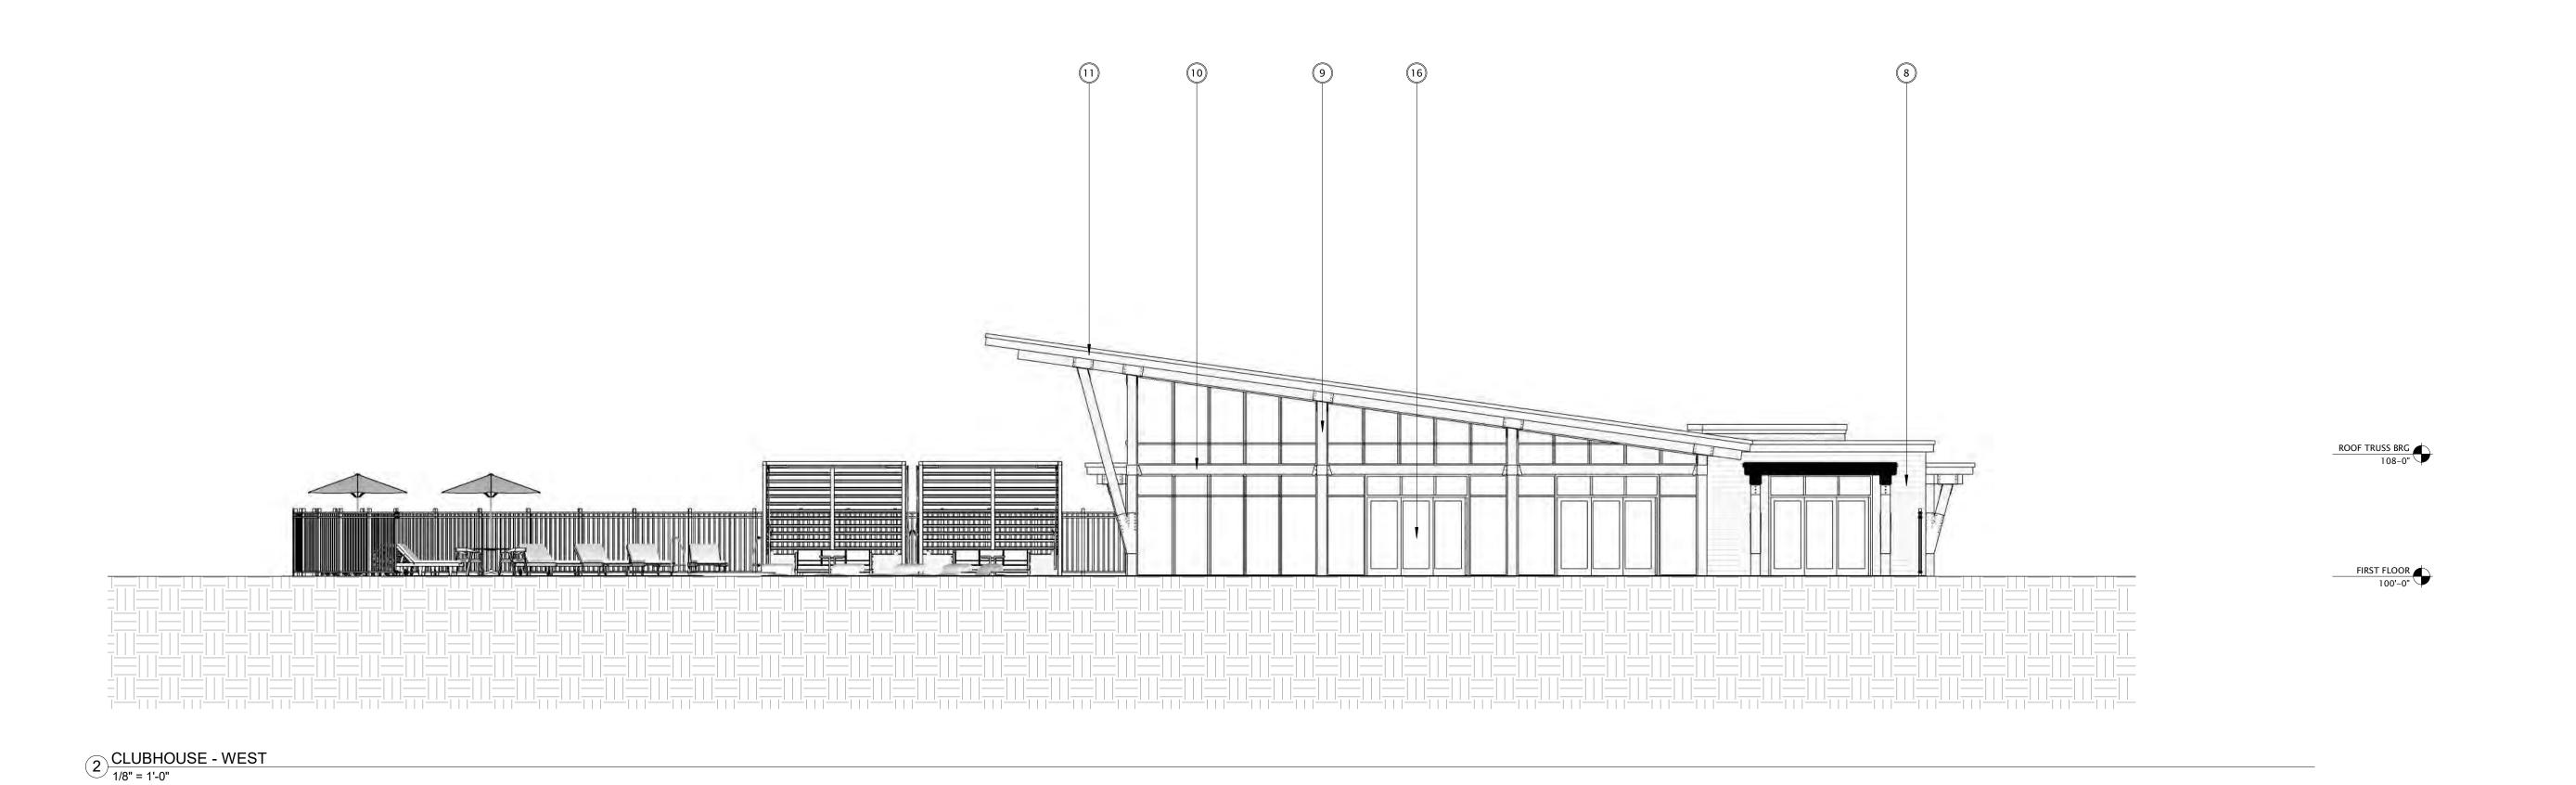
SD201-CH

2 CLUBHOUSE - SOUTH 1
3/16" = 1'-0"

EXTERIOR MATERIALS SCHEDULE				
MARK	DESCRIPTION	TYPE / STYLE	COLOR	
1	VINYL WINDOWS	LINDSAY WINDOWS & DOORS	BLACK	
2	VINYL PATIO DOORS	LINDSAY WINDOWS & DOORS	BLACK	
3	BALCONY RAILING	PAINTED METAL	BLACK	
4	BALCONY / DECK	COMPOSITE	TBD	
5	BALCONY FASCIA & TRIM	TBD	WALNUT	
6	MASONRY - STONE	DRY STACKED STONE	STAKLEDGE	
7	SIDING - 1 (LIGHT)	ULTRASHIELD	TEAK	
8	SIDING - 1 (DARK)	ULTRASHIELD	WALNUT	
9	DECORATIVE COLUMN	WOOD/WOOD COMPOSITE	TBD	
10	DECORATIVE BEAM	WOOD/WOOD COMPOSITE	TBD	
11	ACCENT CANOPY / ROOF	STANDING SEAM	WALNUT	
12	METAL PANEL	CORRUGATED	GALVANIZED	
13	RESIDENTIAL HVAC LOUVER / GRILLE	EXTRUDED ALUMINUM	PAINT TO MATCH ADJACENT MATERIALS	
14	PRECAST CONCRETE BANDING	PRECAST CONCRETE - SMOOTH FACE	TBD	
16	ALUMINUM ENTRANCE DOOR(S)	PREFINISHED ALUMINUM	BLACK	
17	60" ALUMINUM FENCE	PREFINISHED ALUMINUM	BLACK	

1) CLUBHOUSE - EAST 1/8" = 1'-0"



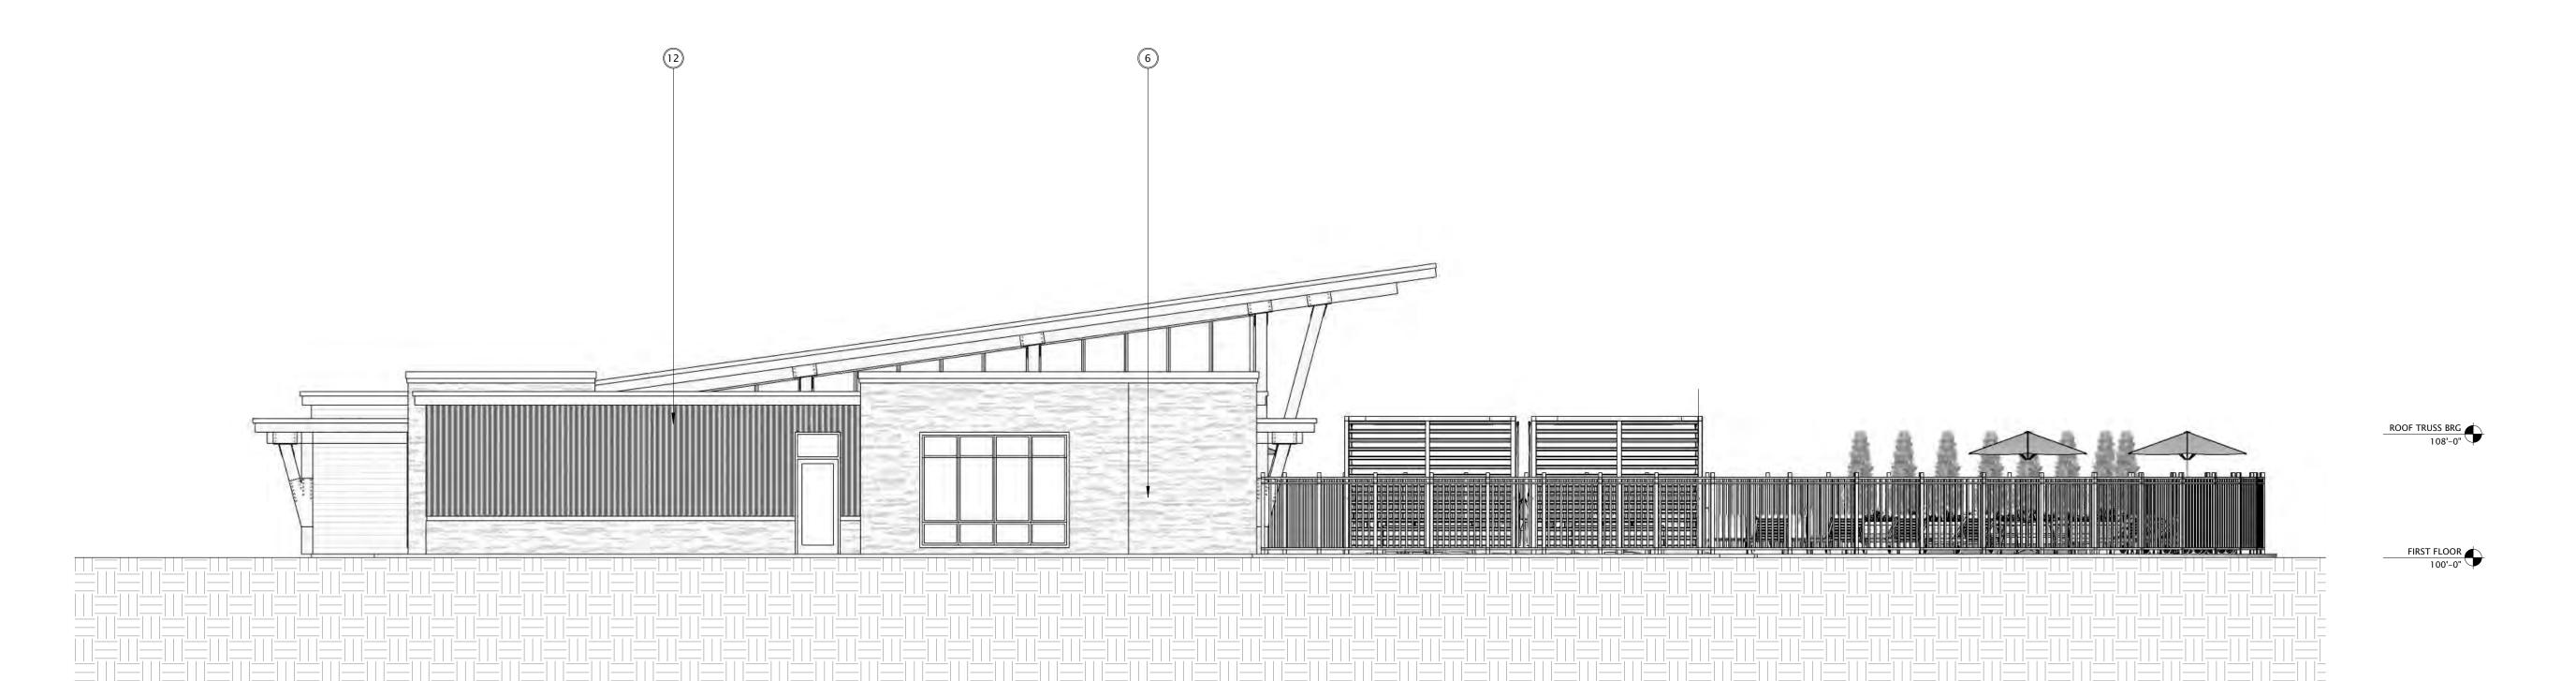



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DATE OF	ISSUANCE A	UGUST 17, 2022
	revision schedule	
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CLUBHOUSE -EXTERIOR ELEVATIONS B&W

SHEET NUMBER


SD202-CH

EXTERIOR MATERIALS SCHEDULE				
ЛARK	DESCRIPTION	TYPE / STYLE	COLOR	
1	VINYL WINDOWS	LINDSAY WINDOWS & DOORS	BLACK	
2	VINYL PATIO DOORS	LINDSAY WINDOWS & DOORS	BLACK	
3	BALCONY RAILING	PAINTED METAL	BLACK	
4	BALCONY / DECK	COMPOSITE	TBD	
5	BALCONY FASCIA & TRIM	TBD	WALNUT	
6	MASONRY - STONE	DRY STACKED STONE	STAKLEDGE	
7	SIDING - 1 (LIGHT)	ULTRASHIELD	TEAK	
8	SIDING - 1 (DARK)	ULTRASHIELD	WALNUT	
9	DECORATIVE COLUMN	WOOD/WOOD COMPOSITE	TBD	
10	DECORATIVE BEAM	WOOD/WOOD COMPOSITE	TBD	
11	ACCENT CANOPY / ROOF	STANDING SEAM	WALNUT	
12	METAL PANEL	CORRUGATED	GALVANIZED	
13	RESIDENTIAL HVAC LOUVER / GRILLE	EXTRUDED ALUMINUM	PAINT TO MATCH ADJACENT MATERIALS	
14	PRECAST CONCRETE BANDING	PRECAST CONCRETE - SMOOTH FACE	TBD	
16	ALUMINUM ENTRANCE DOOR(S)	PREFINISHED ALUMINUM	BLACK	
17	60" ALUMINUM FENCE	PREFINISHED ALUMINUM	BLACK	



1) CLUBHOUSE - NORTH
3/16" = 1'-0"

2 CLUBHOUSE - SOUTH
3/16" = 1'-0"

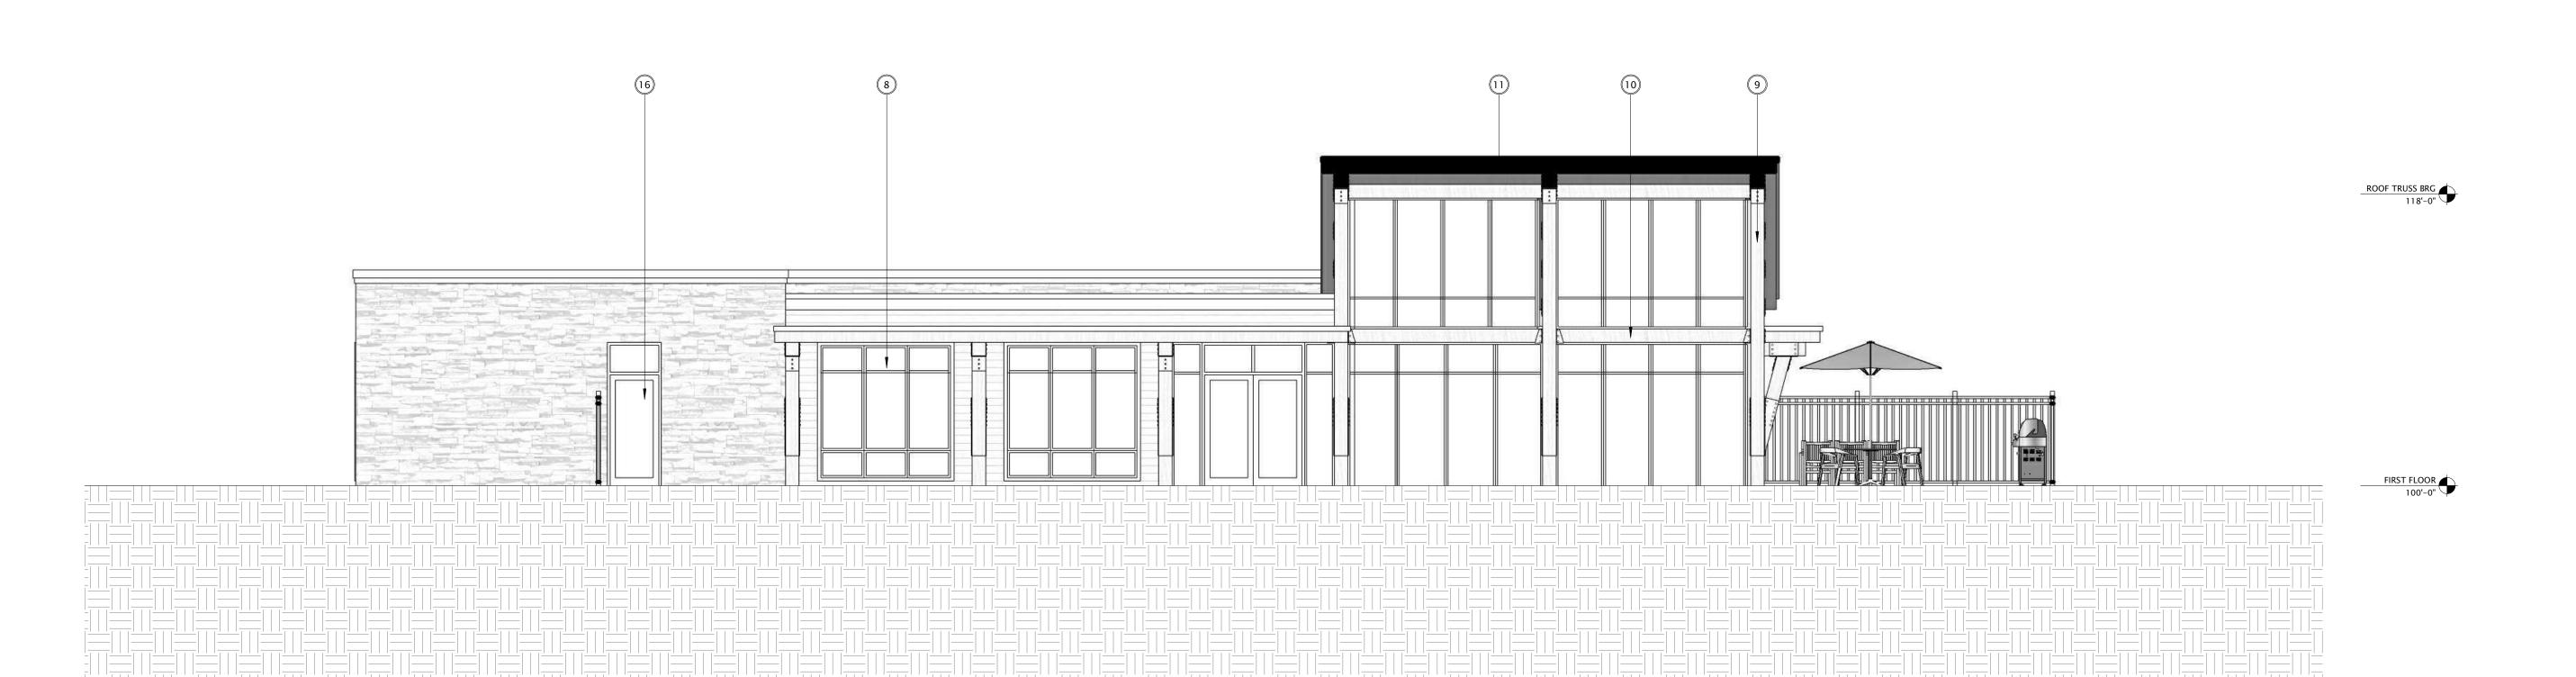



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THE WINSTON

19-1104

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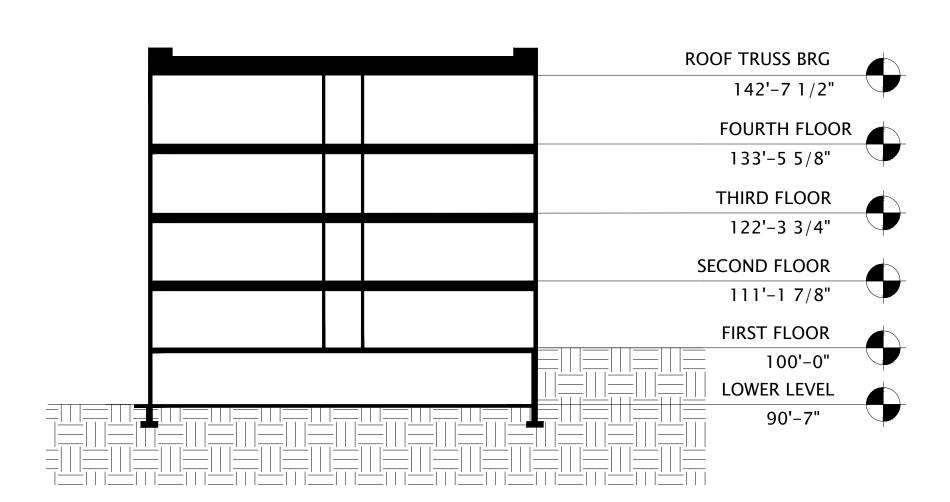
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Mark		Date

SHEET TITL

CLUBHOUSE -EXTERIOR ELEVATIONS B&W

SHEET NUMBER

SD203-CH



1 BUILDING D - SECTION 1
1/16" = 1'-0"



BUILDING D - SECTION 2

1/16" = 1'-0"



JLA PROJECT NUMBER: 19-1104-01

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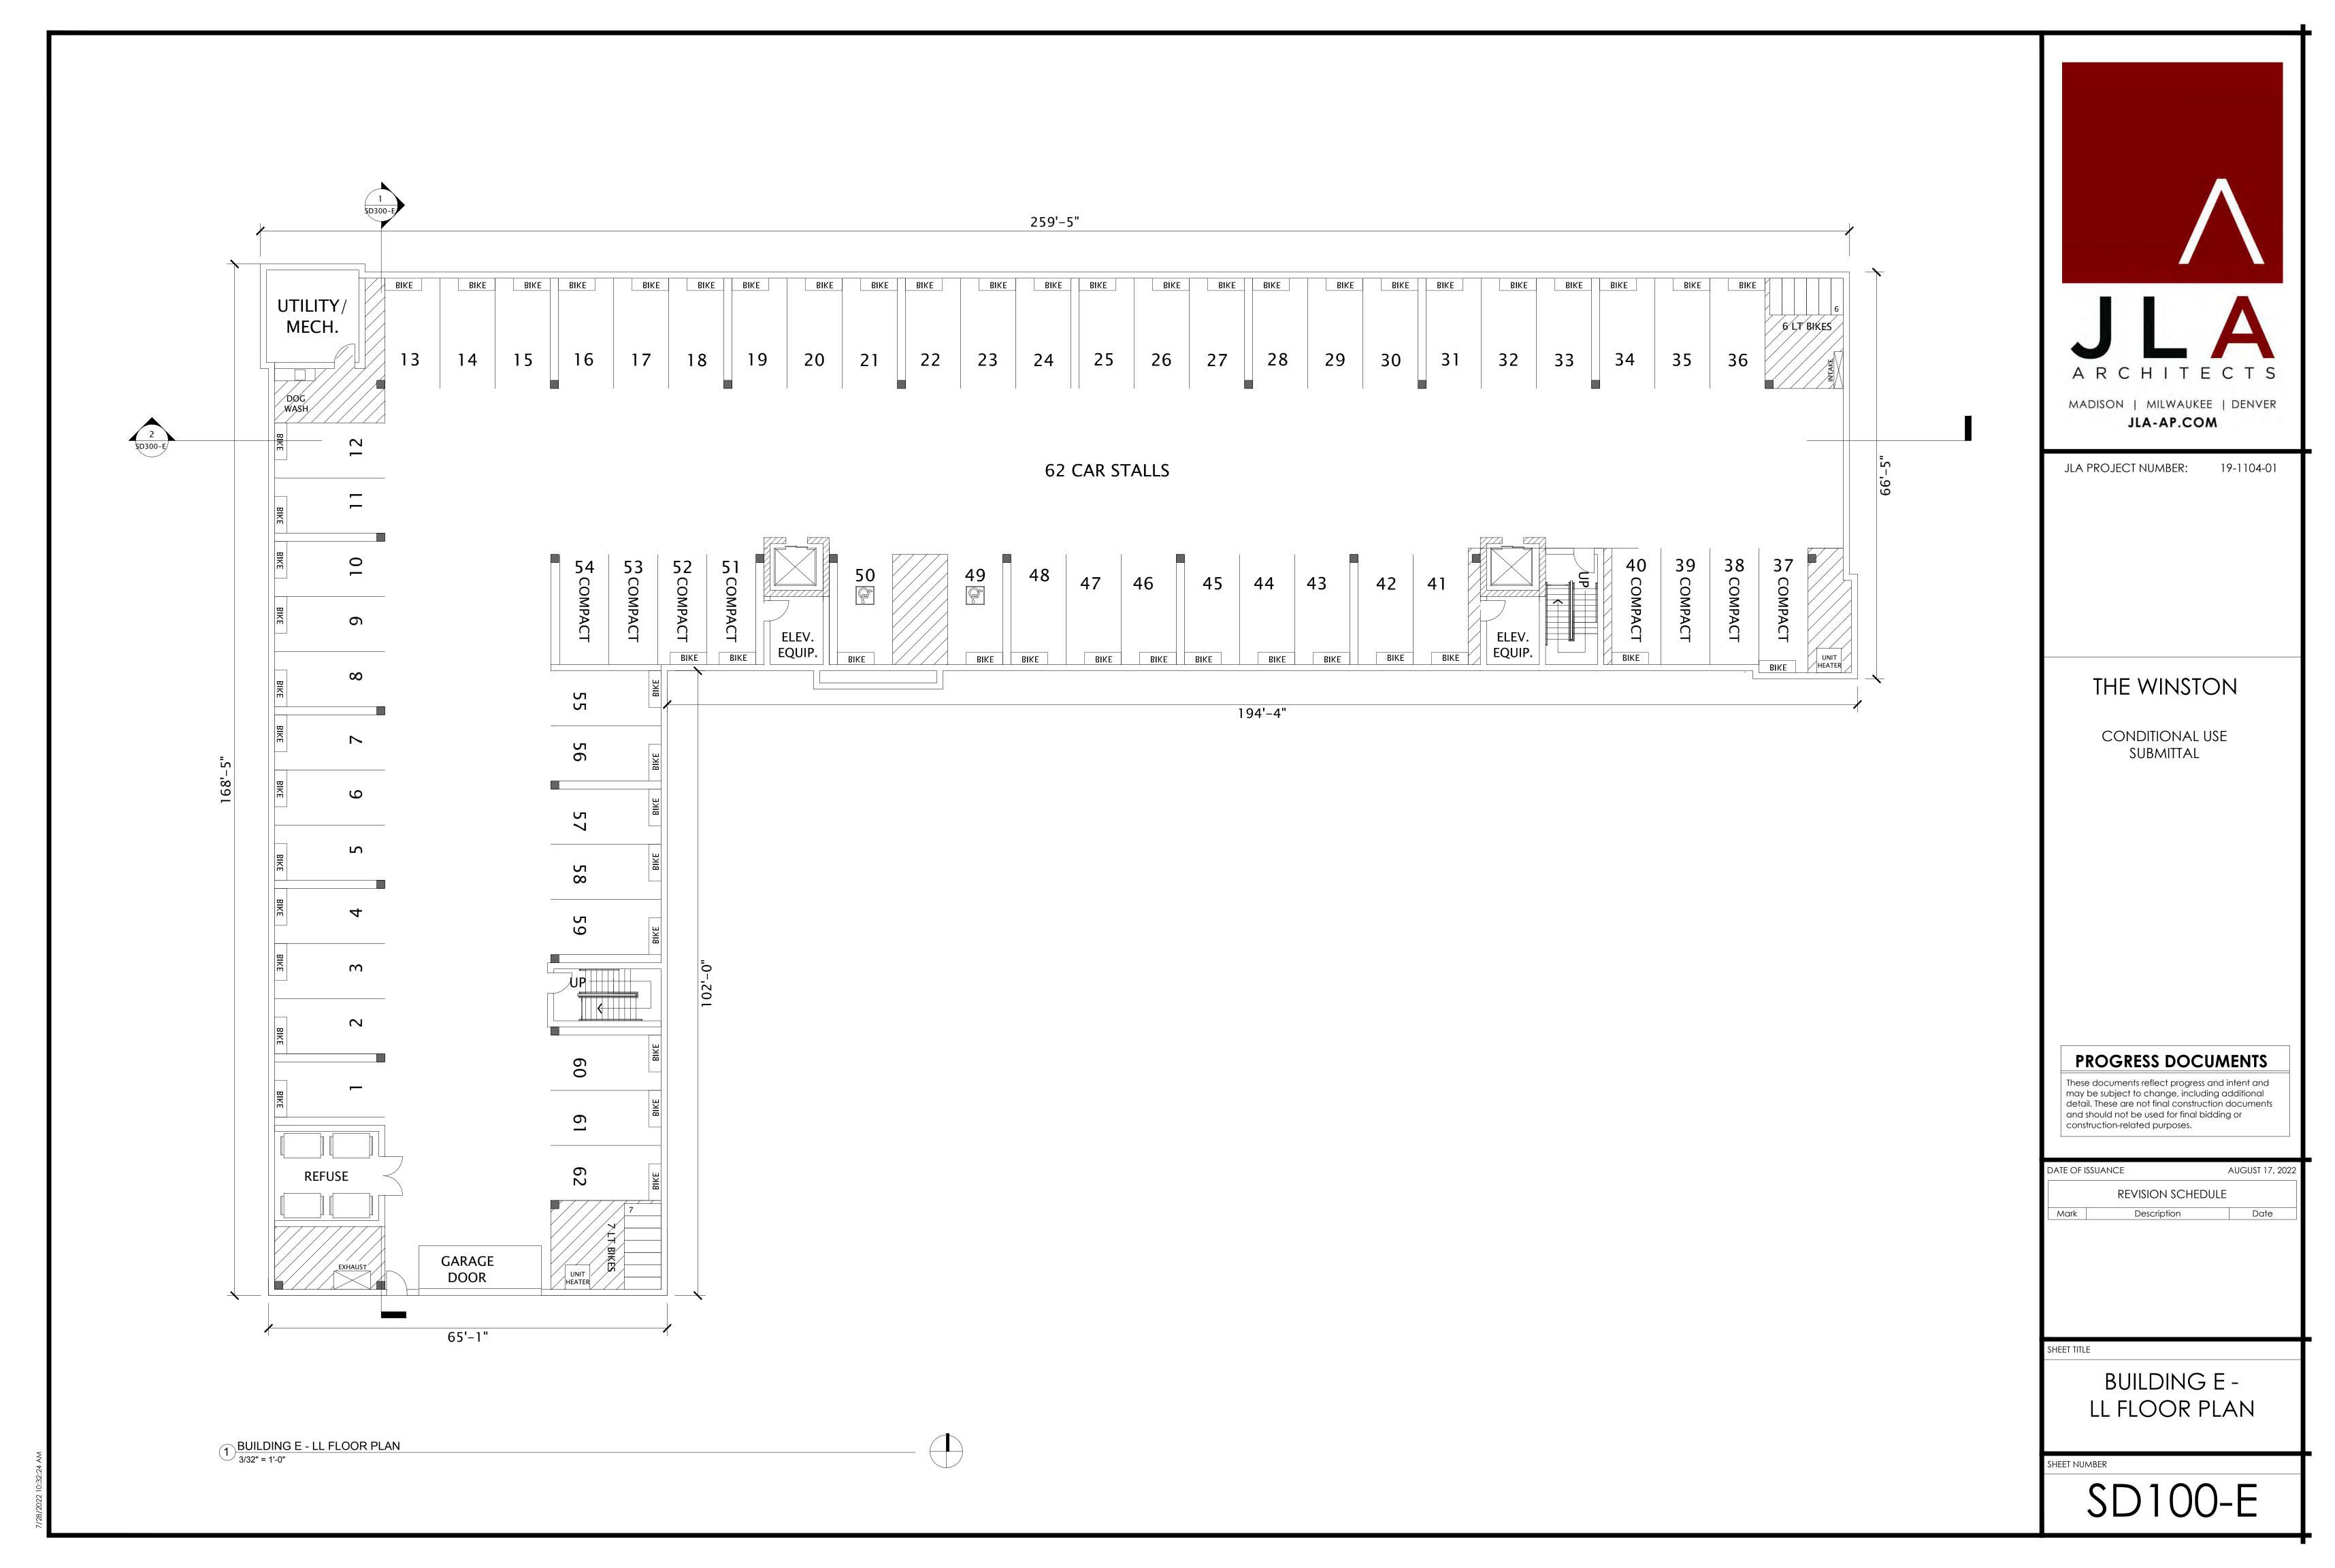
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ı		REVISION SCHEDULE	
ı	Mark	Description	Date


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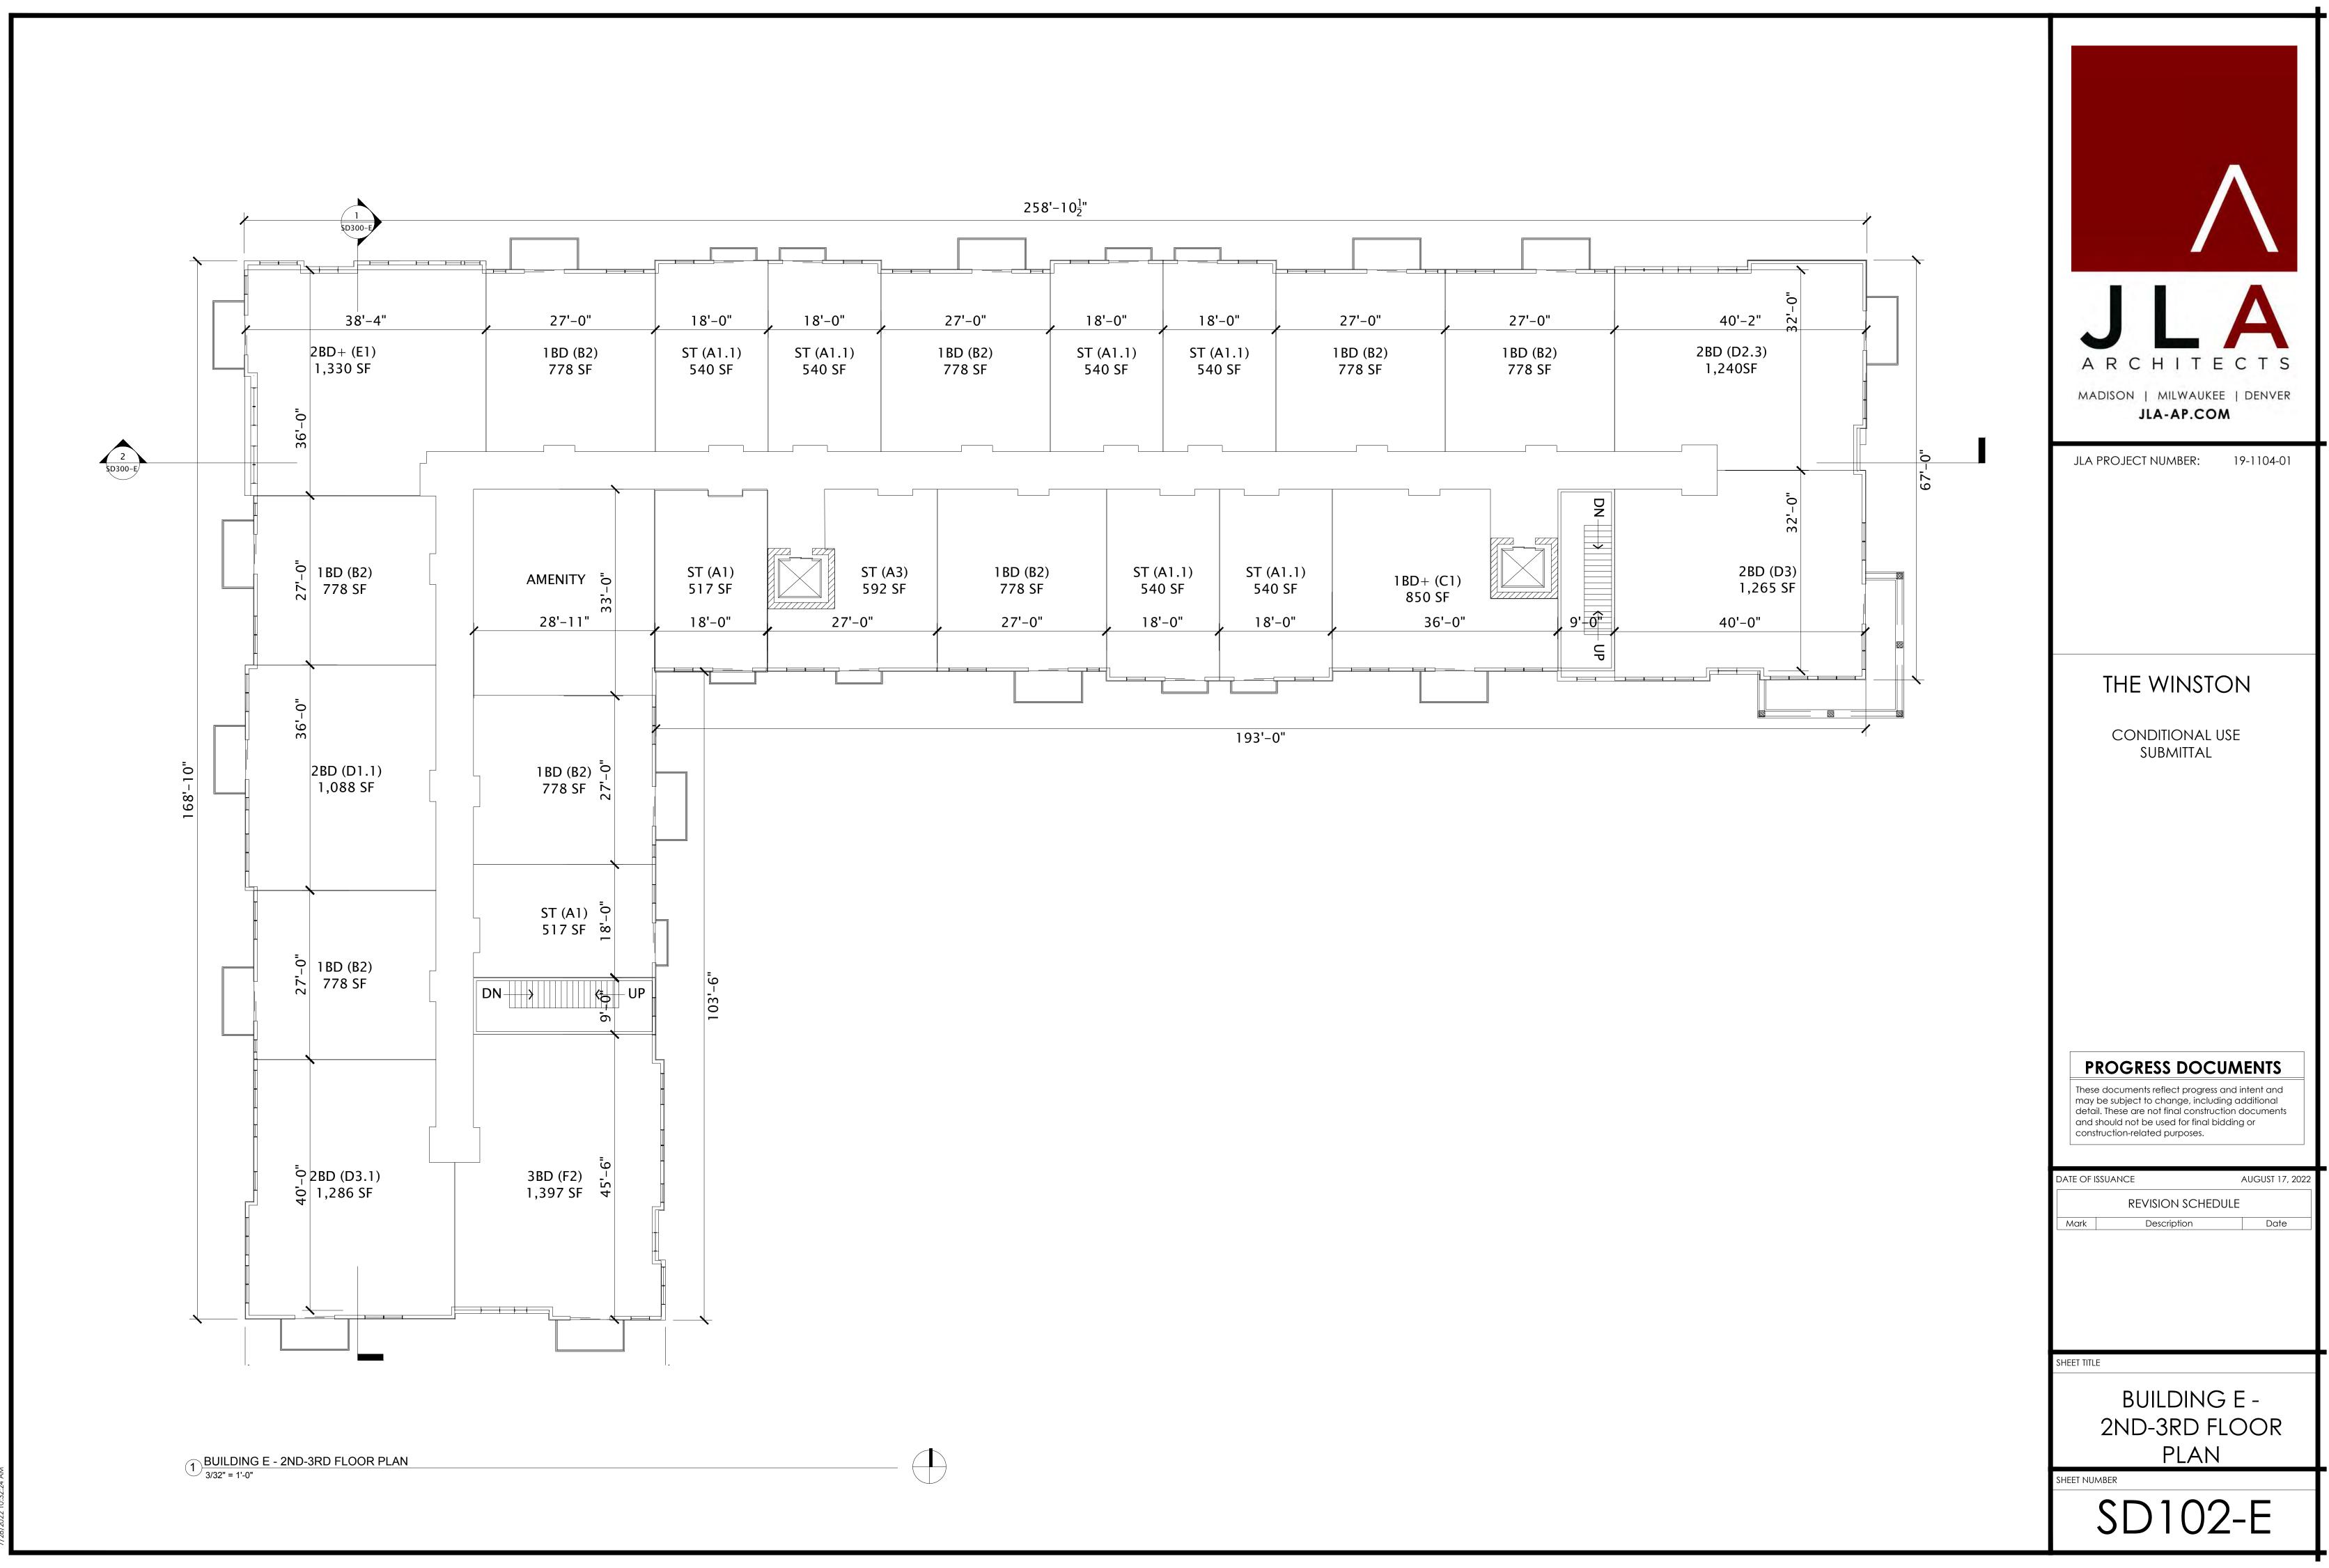
BUILDING D -SECTIONS

SHEET NUMBER


SD300-D






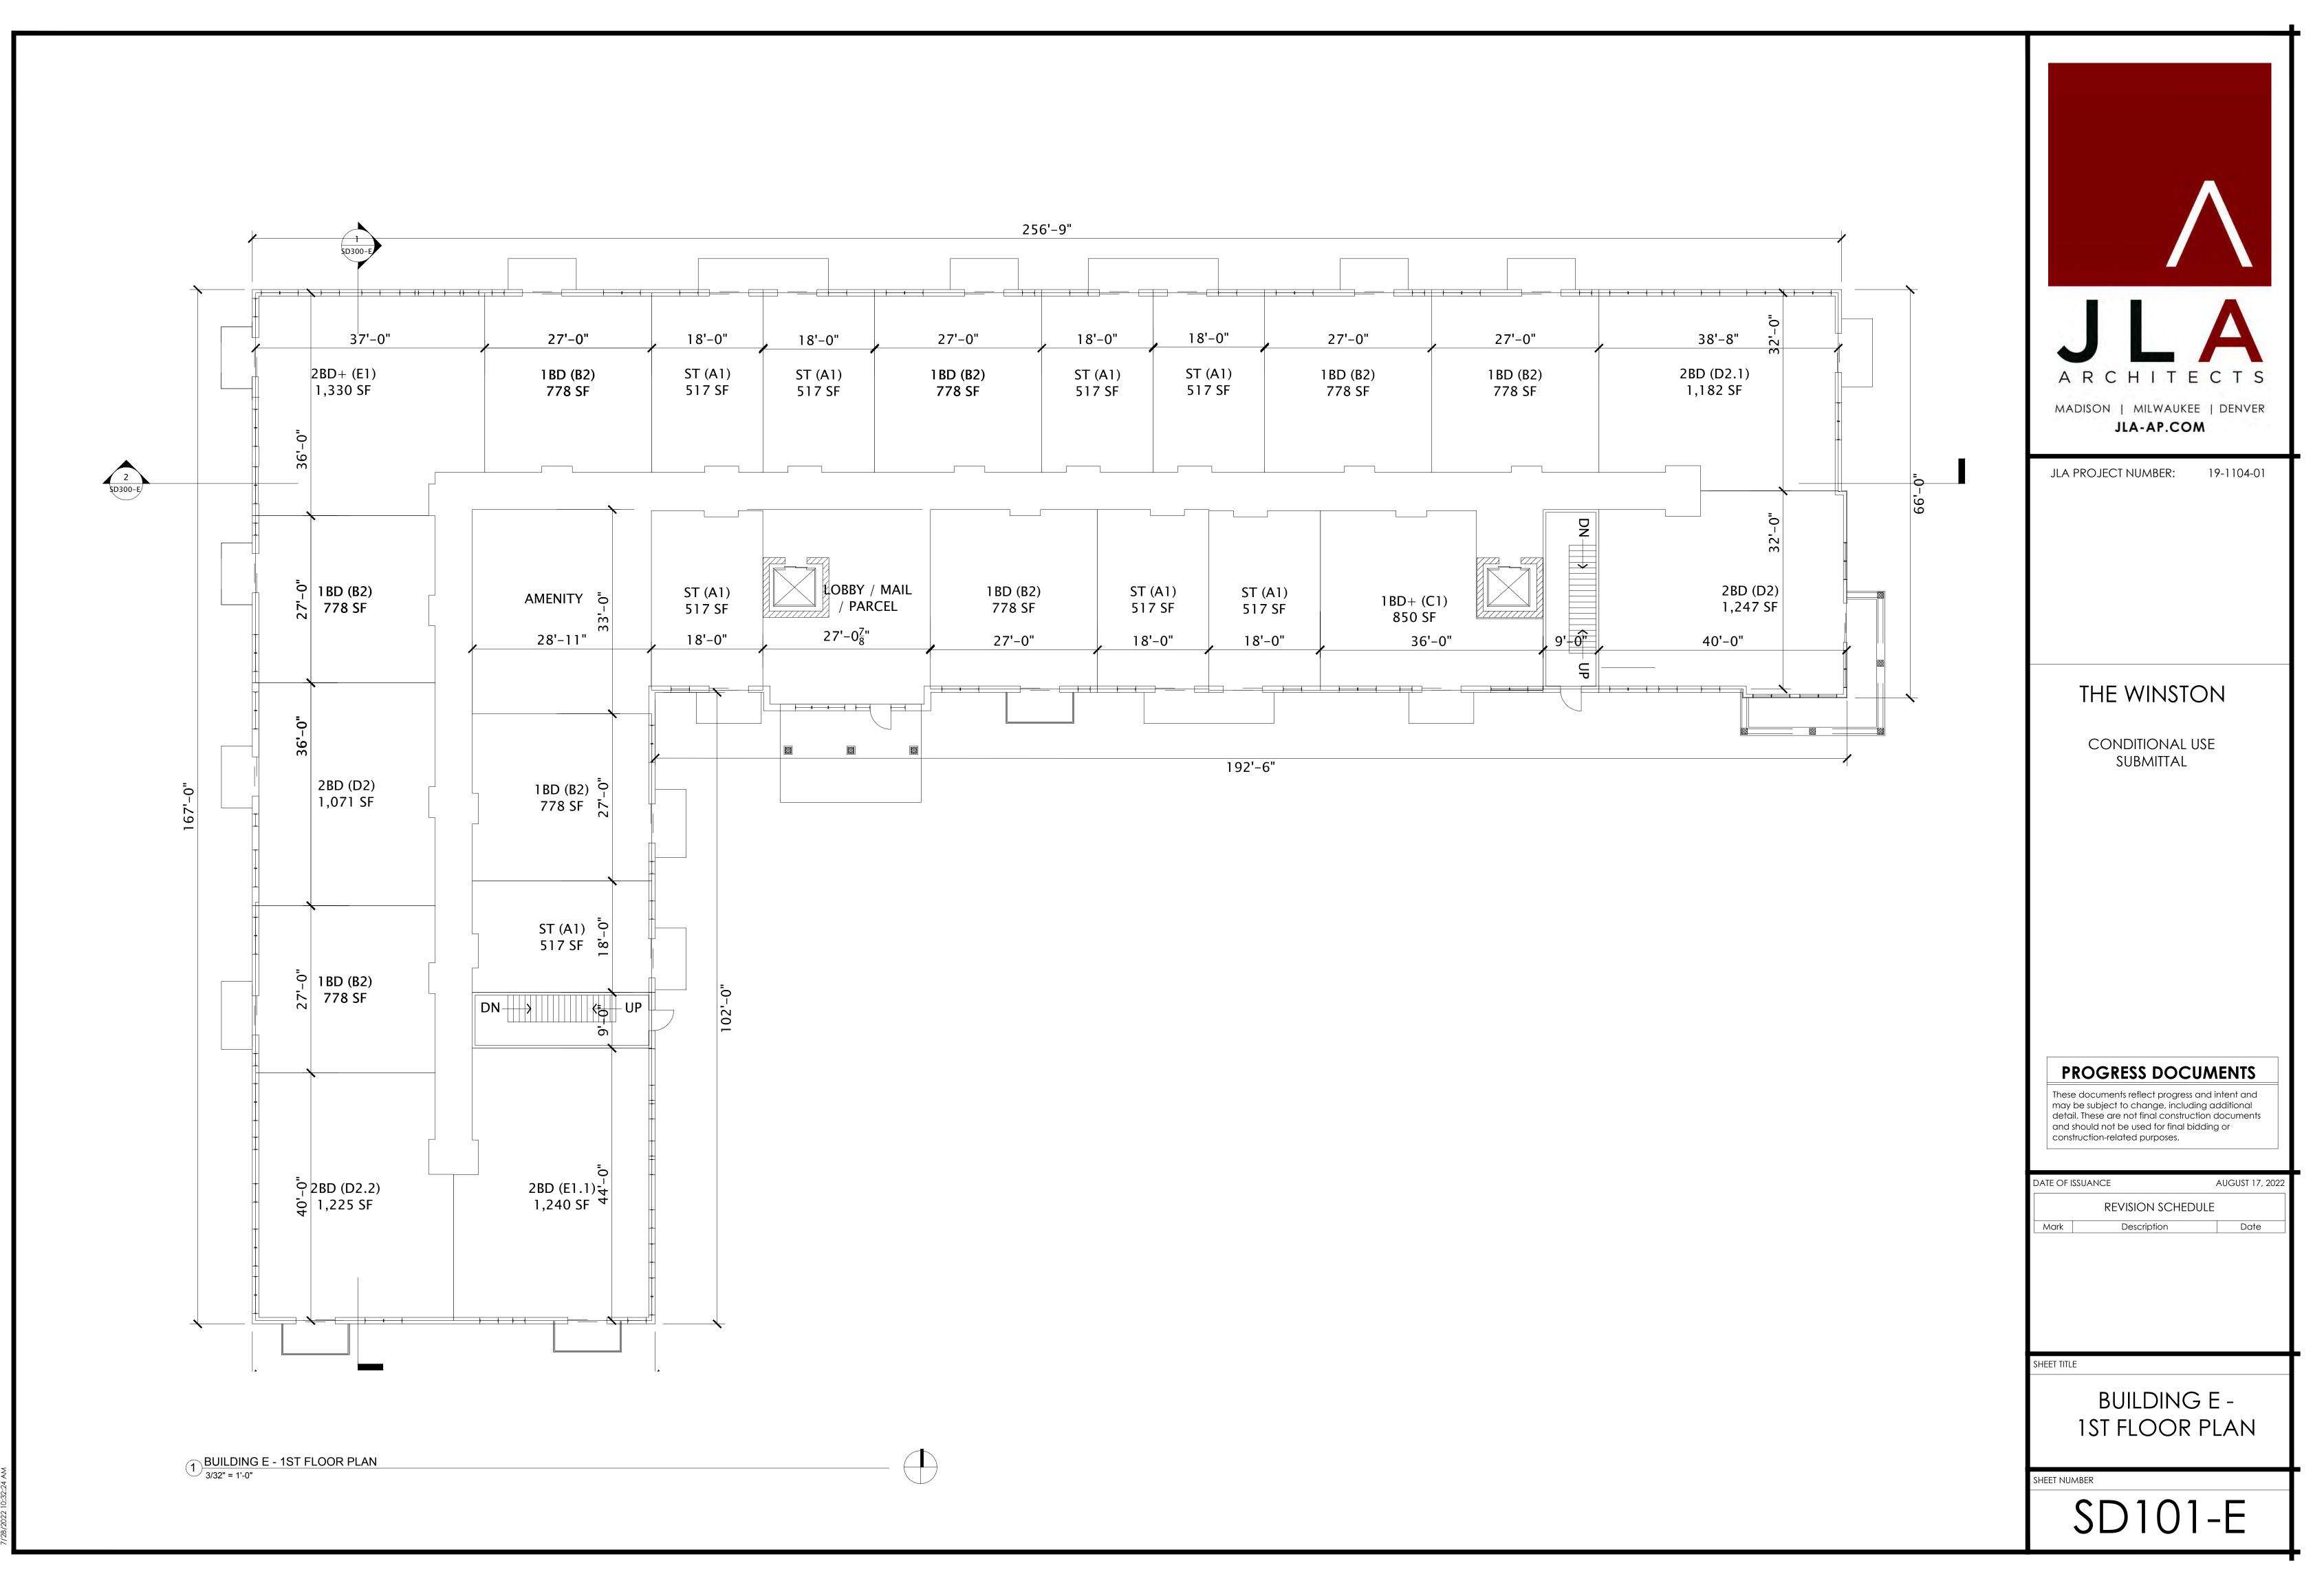

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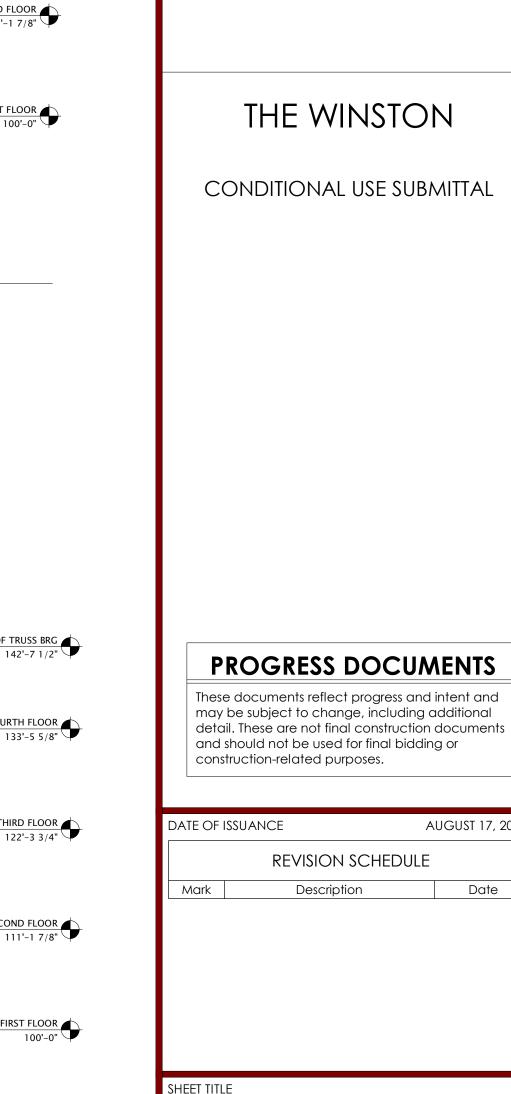


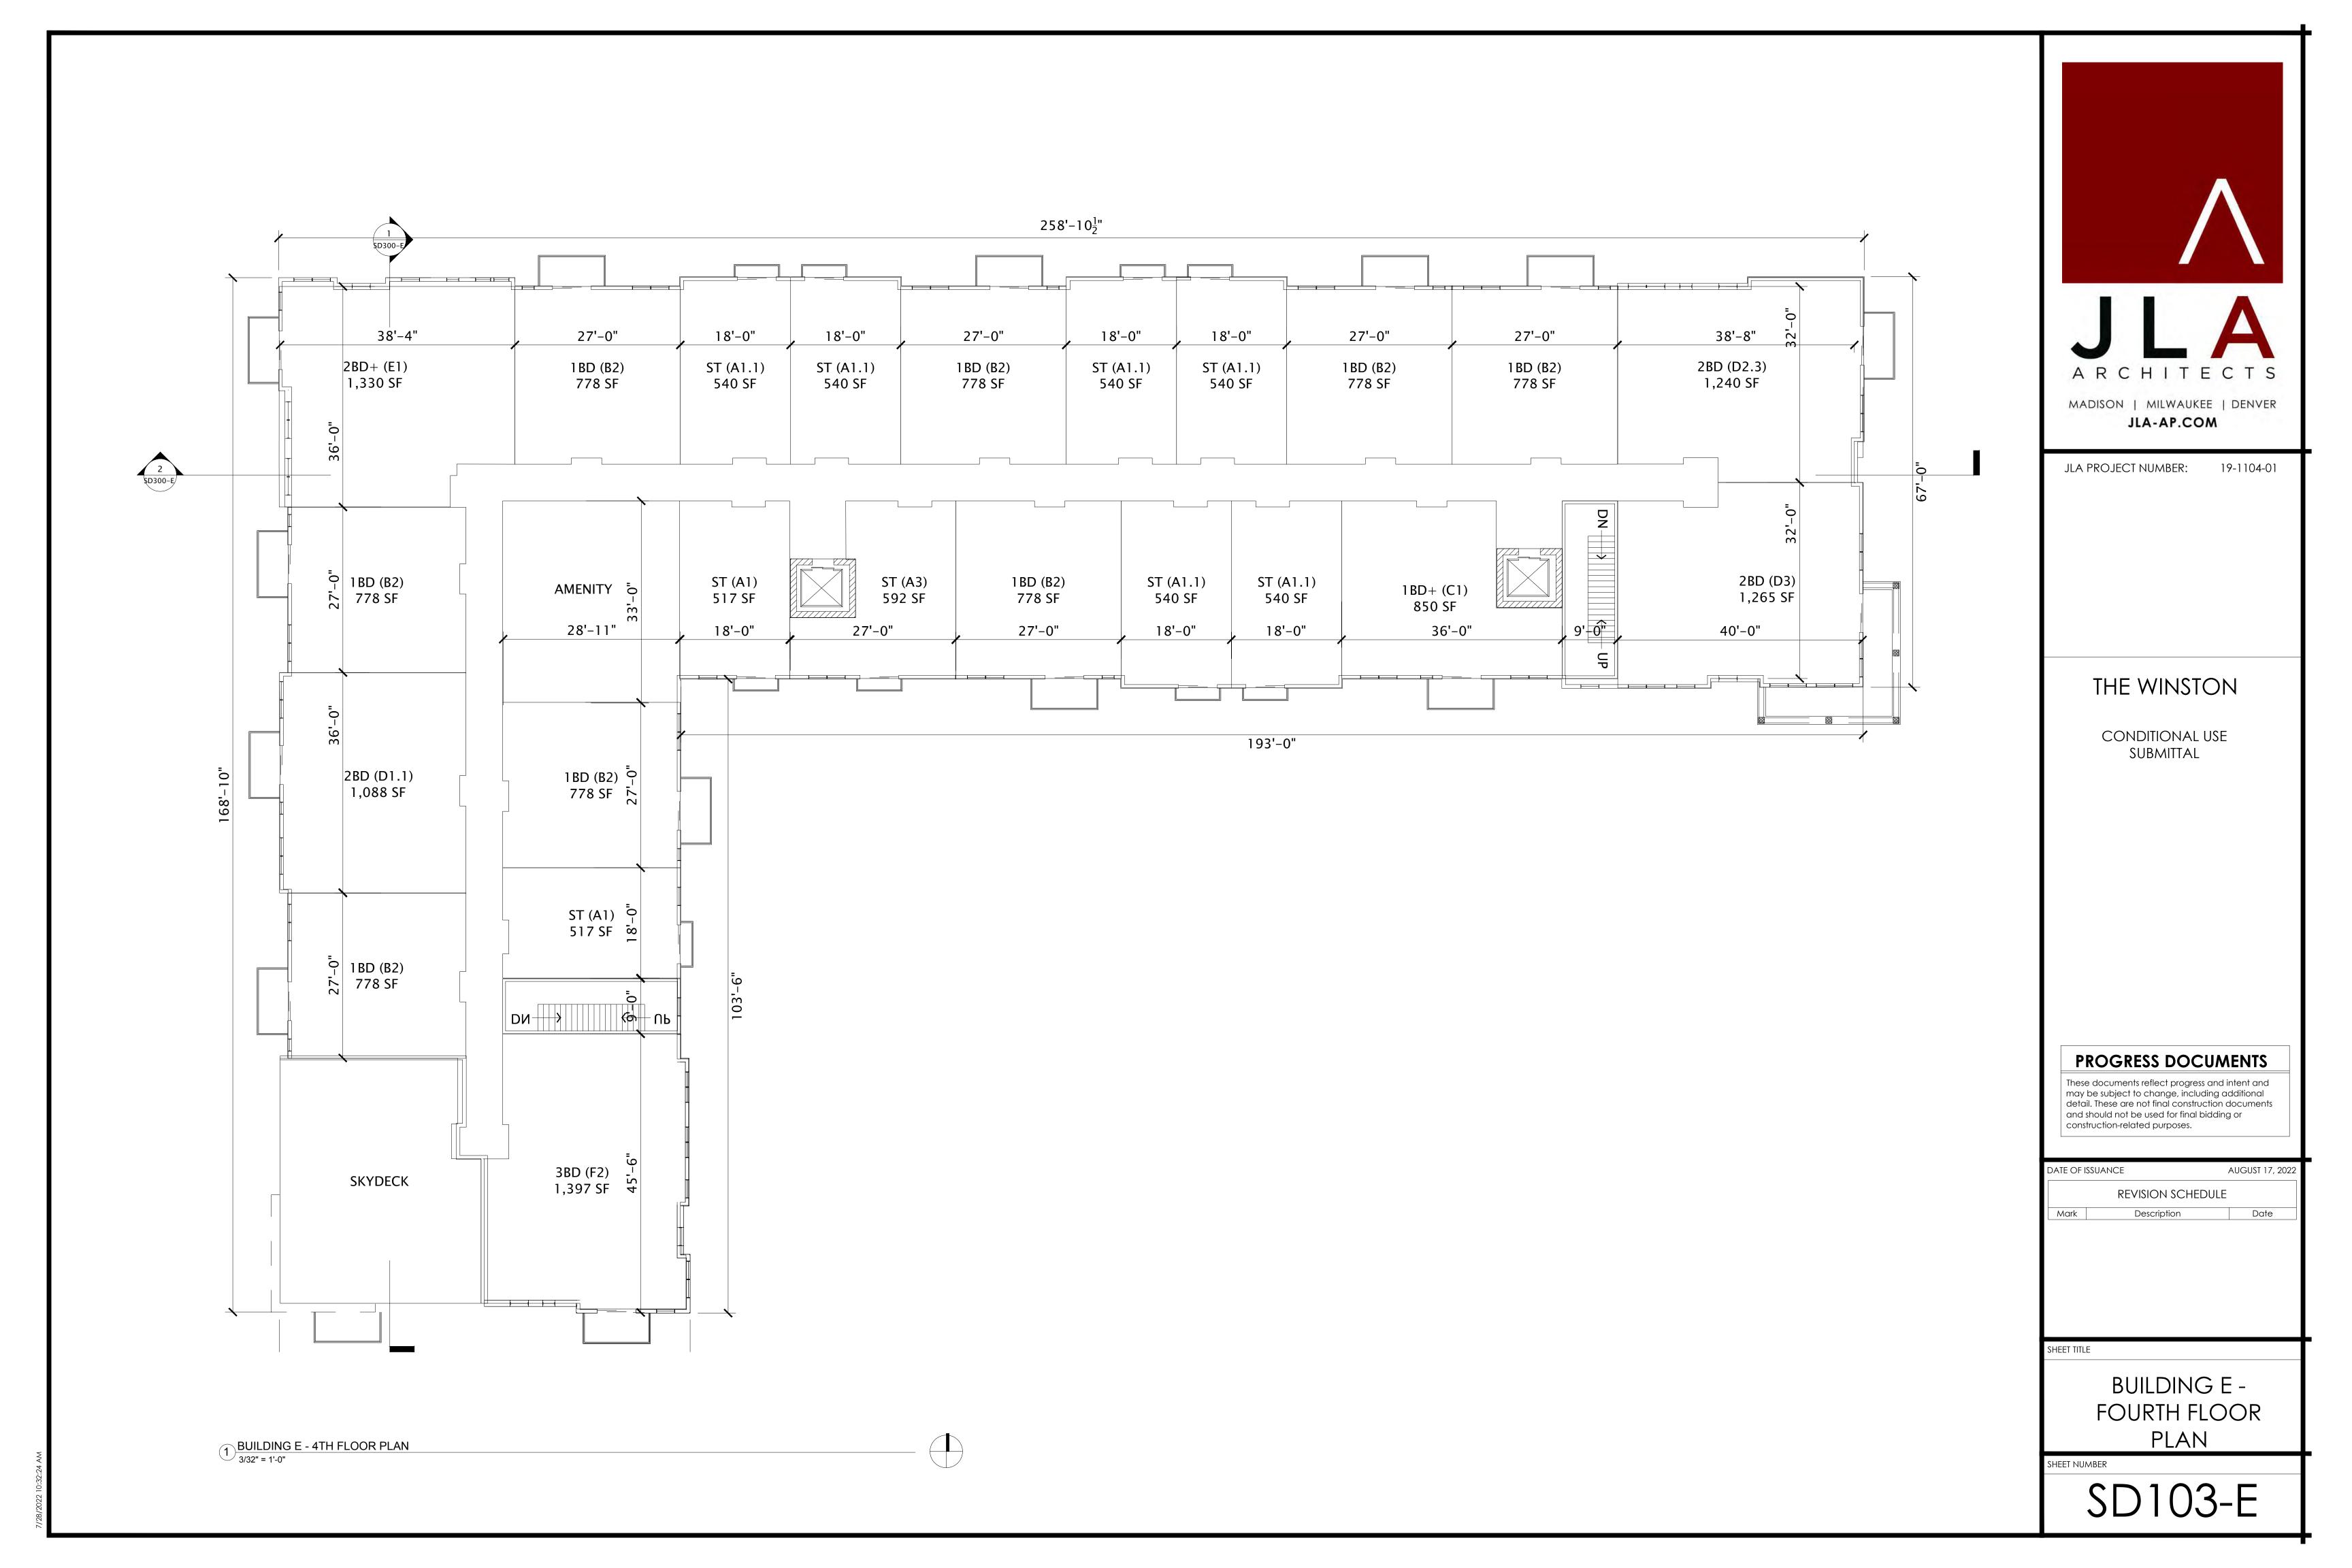

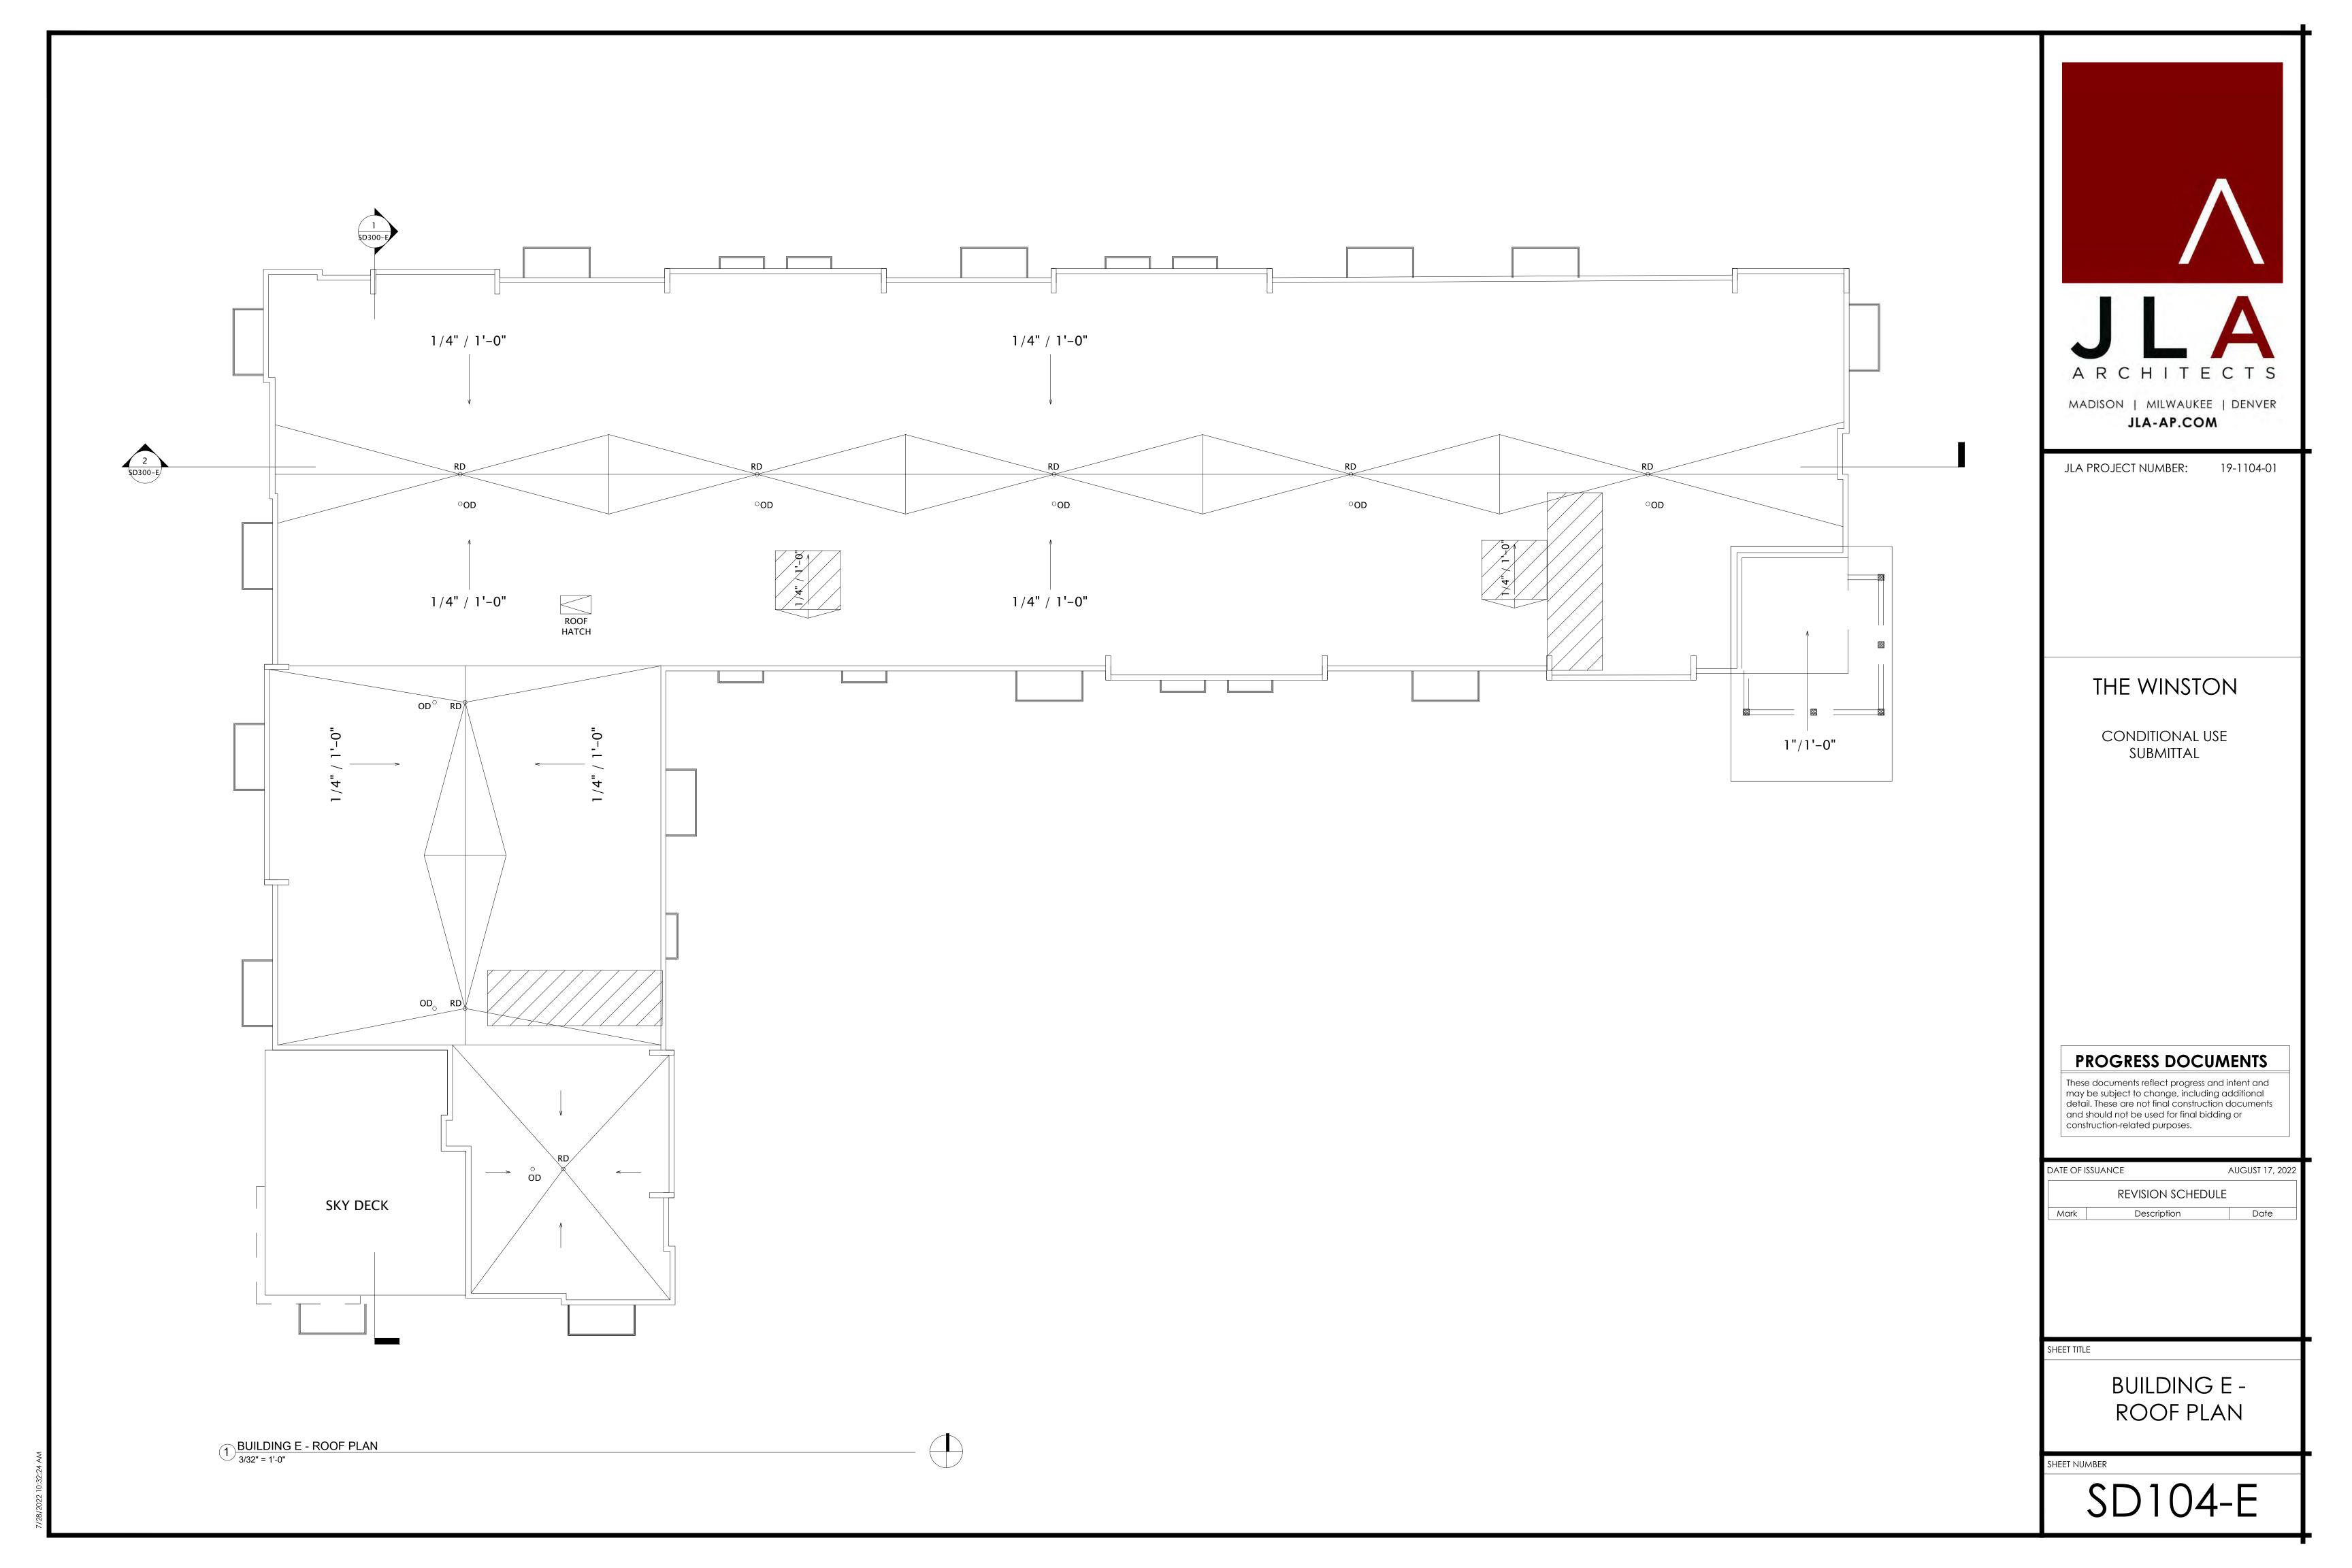

BUILDING E - SIGNAG	E AREA
SIGNAGE TYPE	AREA
EAST ELEVATION	
WALL - RAISED	208 SF





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AUGUST 17, 2022

Date

BUILDING E - EXTERIOR

ELEVATIONS

SD200-E

SHEET NUMBER

JLA PROJECT NUMBER:



BUILDING E - NORTH 3/32" = 1'-0"

		EXTERIOR MATERIALS SCHEDULE	
MARK	DESCRIPTION	TYPE / STYLE	COLOR
1	VINYL WINDOWS	LINDSAY WINDOWS & DOORS	BLACK
2	VINYL PATIO DOORS	LINDSAY WINDOWS & DOORS	BLACK
3	BALCONY RAILING	PAINTED METAL	BLACK
4	BALCONY / DECK	COMPOSITE	TBD
5	BALCONY FASCIA & TRIM	TBD	WALNUT
6	MASONRY - STONE	DRY STACKED STONE	STAKLEDGE
7	SIDING - 1 (LIGHT)	ULTRASHIELD	TEAK
8	SIDING - 1 (DARK)	ULTRASHIELD	WALNUT
9	DECORATIVE COLUMN	WOOD/WOOD COMPOSITE	TBD
10	DECORATIVE BEAM	WOOD/WOOD COMPOSITE	TBD
11	ACCENT CANOPY / ROOF	STANDING SEAM	WALNUT
12	METAL PANEL	CORRUGATED	GALVANIZED
13	RESIDENTIAL HVAC LOUVER / GRILLE	EXTRUDED ALUMINUM	PAINT TO MATCH ADJACENT MATERIALS
14	PRECAST CONCRETE BANDING	PRECAST CONCRETE - SMOOTH FACE	TBD
16	ALLIMINUM ENTRANCE DOOR(S)	PREFINISHED ALLIMINUM	BLACK

BUILDING E - SIGNAG	E AREA
SIGNAGE TYPE	AREA
EAST ELEVATION	
WALL - RAISED	208 SF



1 BUILDING E - EAST 3/32" = 1'-0"



2 BUILDING E - WEST
3/32" = 1'-0"



JLA PROJECT NUMBER:

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DATE OF	ISSUANCE /	AUGUST 17, 2022
	REVISION SCHEDULE	
Mark	Description	Date
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SHEET

BUILDING E - EXTERIOR ELEVATIONS

SHEET NUMBER

SD201-E



1 BUILDING E - SOUTH 1 3/32" = 1'-0"

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AUGUST 17, 2022

Date

BUILDING E - EXTERIOR ELEVATIONS B&W

SHEET NUMBER

SD202-E

		EXTERIOR MATERIALS SCHEDULE	
MARK	DESCRIPTION	TYPE / STYLE	COLOR
1	VINYL WINDOWS	LINDSAY WINDOWS & DOORS	BLACK
2	VINYL PATIO DOORS	LINDSAY WINDOWS & DOORS	BLACK
3	BALCONY RAILING	PAINTED METAL	BLACK
4	BALCONY / DECK	COMPOSITE	TBD
5	BALCONY FASCIA & TRIM	TBD	WALNUT
6	MASONRY - STONE	DRY STACKED STONE	STAKLEDGE
7	SIDING - 1 (LIGHT)	ULTRASHIELD	TEAK
8	SIDING - 1 (DARK)	ULTRASHIELD	WALNUT
9	DECORATIVE COLUMN	WOOD/WOOD COMPOSITE	TBD
10	DECORATIVE BEAM	WOOD/WOOD COMPOSITE	TBD
11	ACCENT CANOPY / ROOF	STANDING SEAM	WALNUT
12	METAL PANEL	CORRUGATED	GALVANIZED
13	RESIDENTIAL HVAC LOUVER / GRILLE	EXTRUDED ALUMINUM	PAINT TO MATCH ADJACENT MATERIALS
14	PRECAST CONCRETE BANDING	PRECAST CONCRETE - SMOOTH FACE	TBD
16	ALUMINUM ENTRANCE DOOR(S)	PREFINISHED ALUMINUM	BLACK

BUILDING E - SIGNAG	E AREA
SIGNAGE TYPE	AREA
EAST ELEVATION	
WALL - RAISED	208 SF







JLA PROJECT NUMBER: 19-1104

THE WINSTON

CONDITIONAL USE SUBMITTAL

PROGRESS DOCUMENTS


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	1ark	Description	١	Date

BUILDING E - EXTERIOR ELEVATIONS B&W

Sheet number


SD203-E

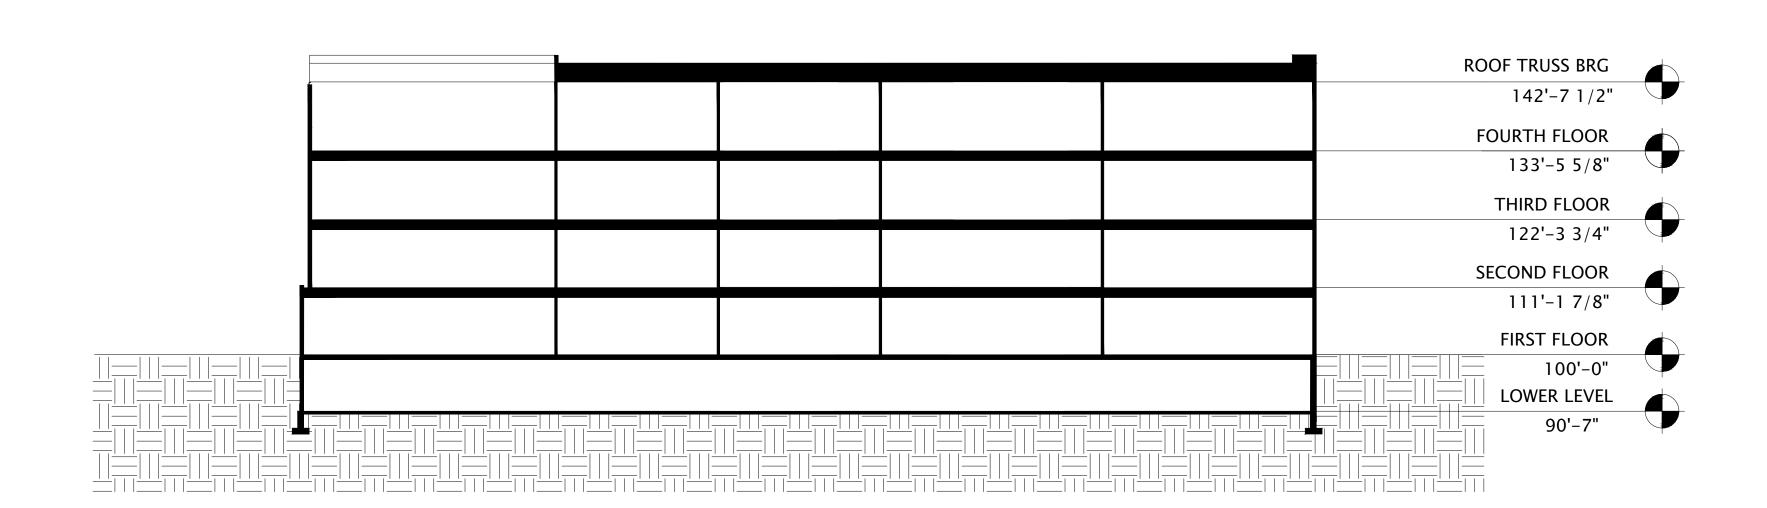

1)BUILDING E - SECTION 1
1/16" = 1'-0"

	ROOF TRUSS BRG	
	142'-7 1/2"	
	FOURTH FLOOR	
	133'-5 5/8"	
	THIRD FLOOR	
	122'-3 3/4"	
	SECOND FLOOR	
	111'-1 7/8"	
	FIRST FLOOR	
	100'-0"	
	LOWER LEVEL	
	90'-7"	

2 BUILDING E - SECTION 2
1/16" = 1'-0"

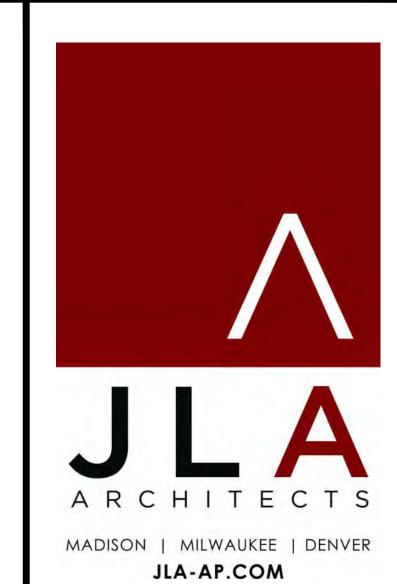

JLA PROJECT NUMBER: 19-1104-01

THE WINSTON

CONDITIONAL USE SUBMITTAL

PROGRESS DOCUMENTS


These documents reflect progress and intent and may be subject to change, including additional detail. These are not final construction documents and should not be used for final bidding or construction-related purposes.


DATE OF I	SSUANCE	AUGUST 17, 20
	REVISION SCHEDULE	
Mark	Description	Date

BUILDING E -SECTIONS

SHEET NUMBER

SD300-E

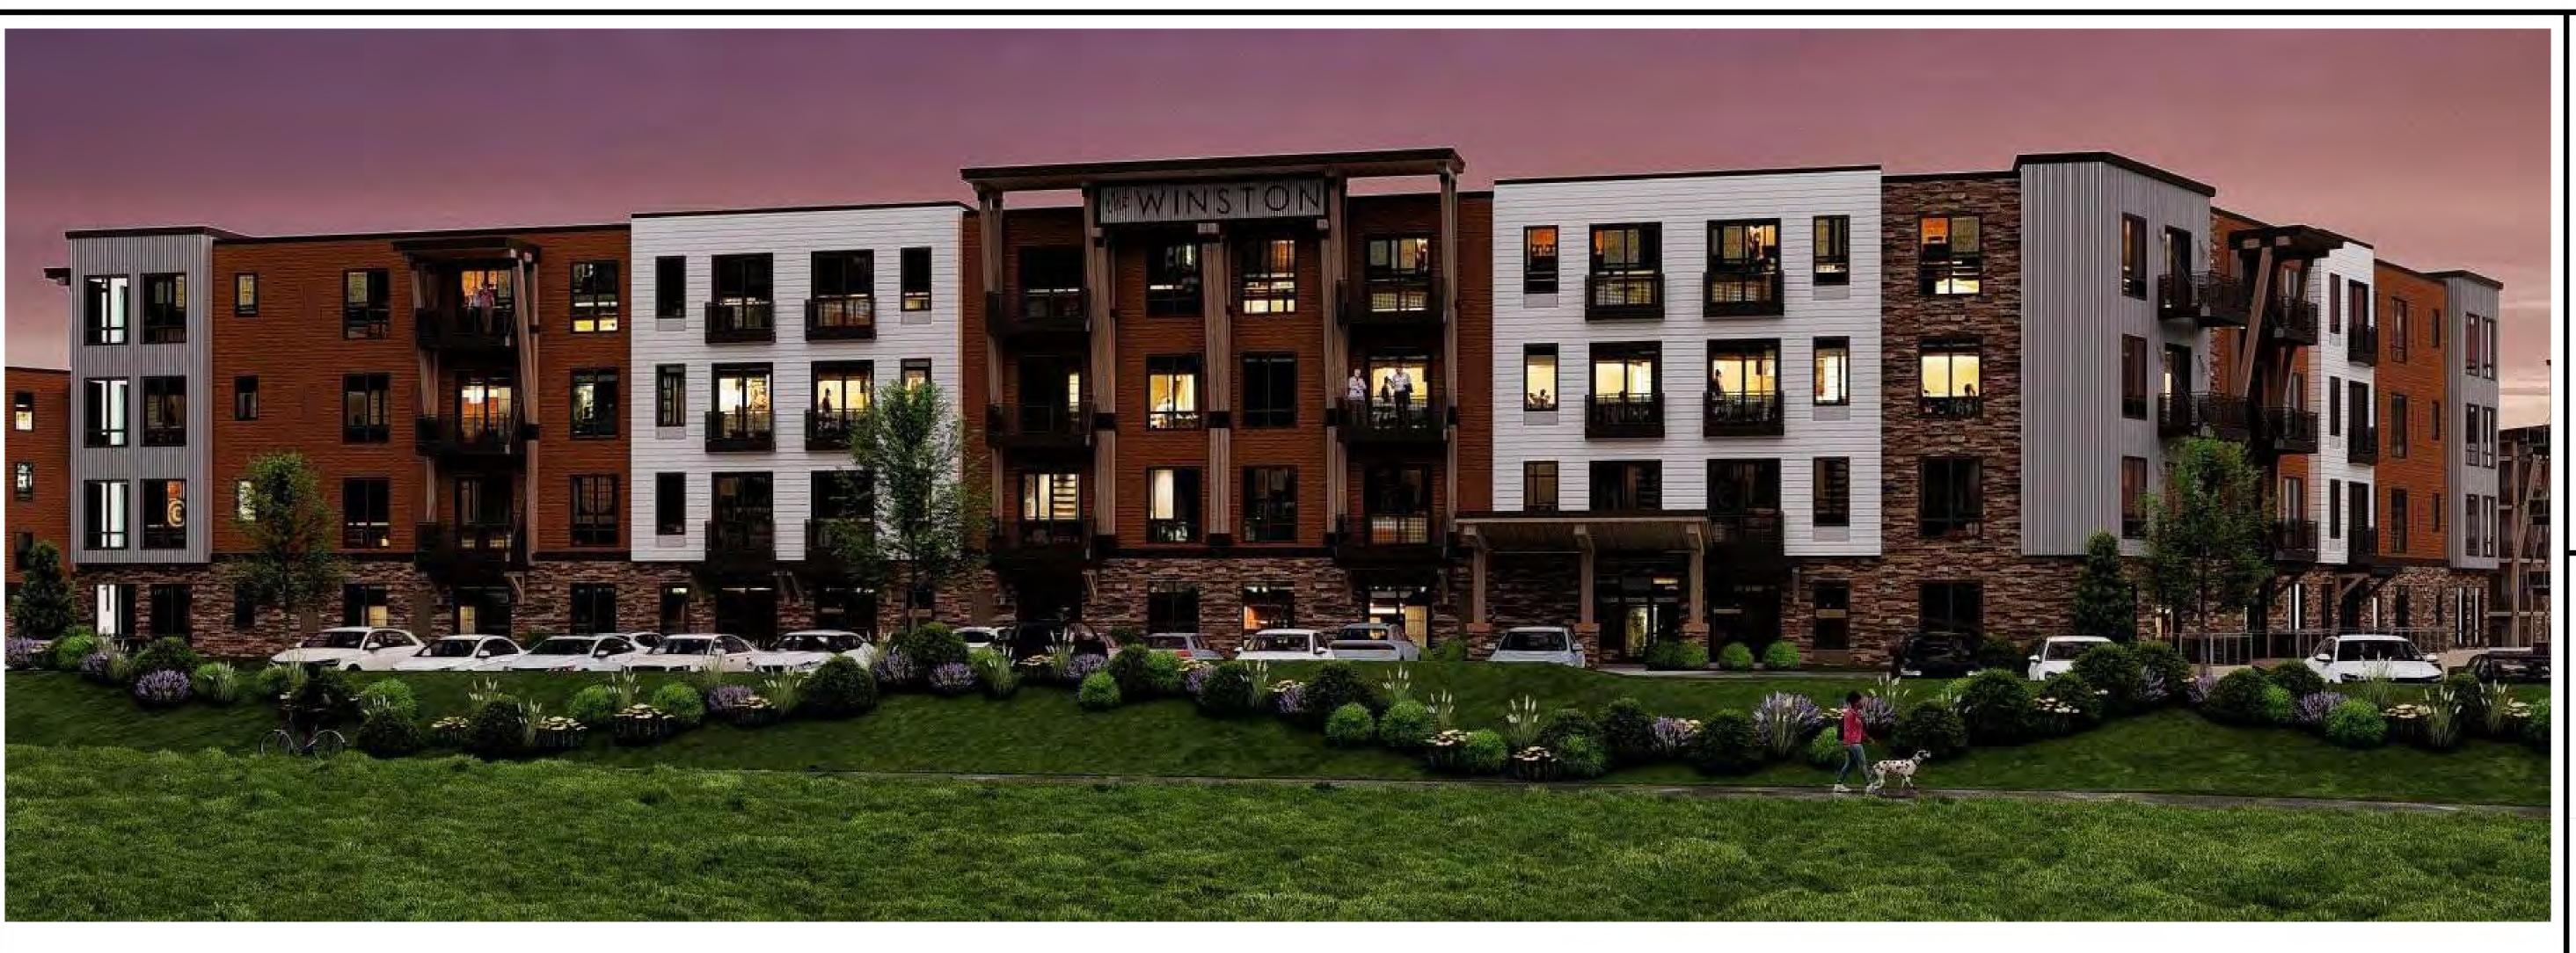

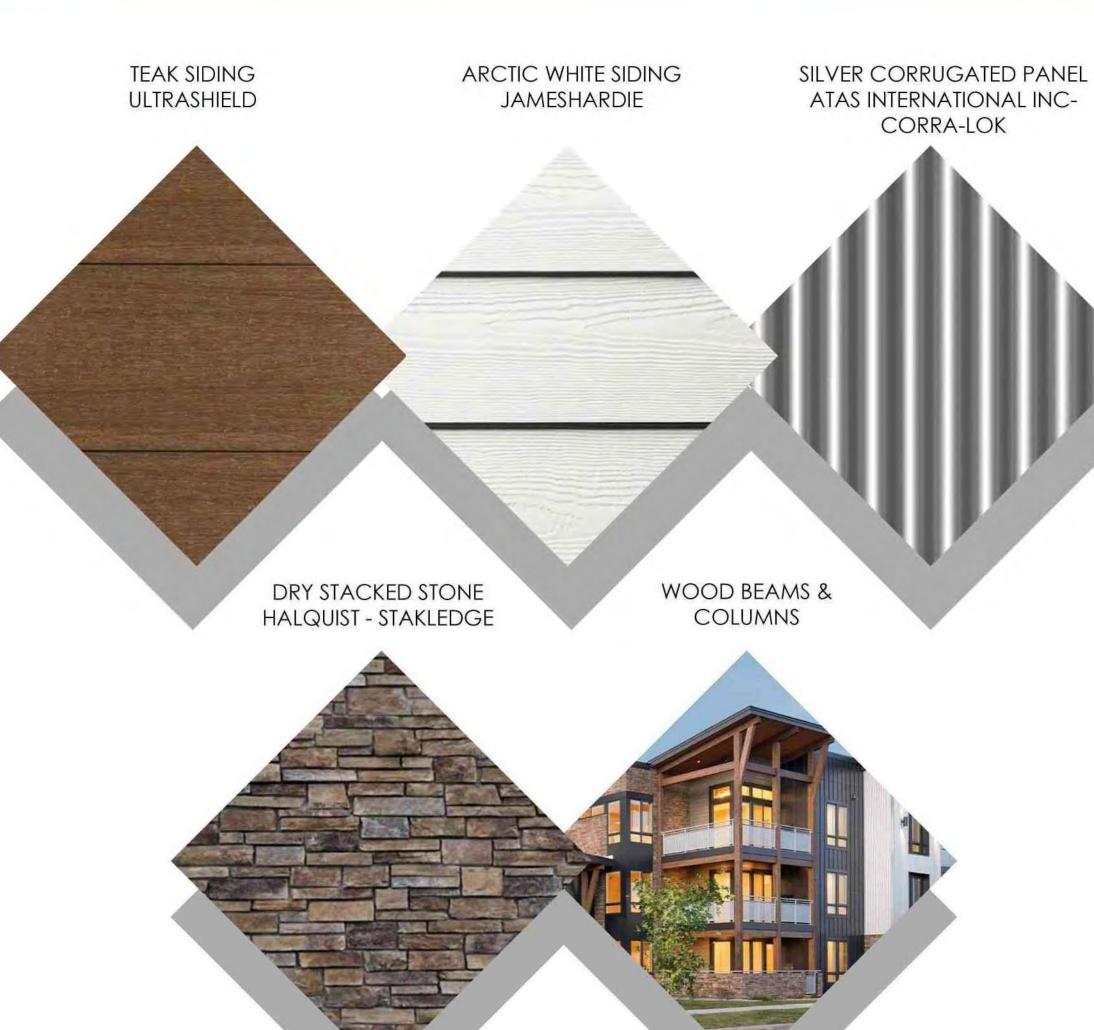



JLA-AP.COM

JLA PROJECT NUMBER: 19-1104-01

THE WINSTON

CONDITIONAL USE SUBMITTAL

PROGRESS DOCUMENTS

These documents reflect progress and intent and may be subject to change, including additional detail. These are not final construction documents and should not be used for final bidding or construction-related purposes.

	REVISION SCHED	ULE
Иark	Description	Date


SHEET TITL

MATERIALS BOARD

SHEET NUMBER

SD400




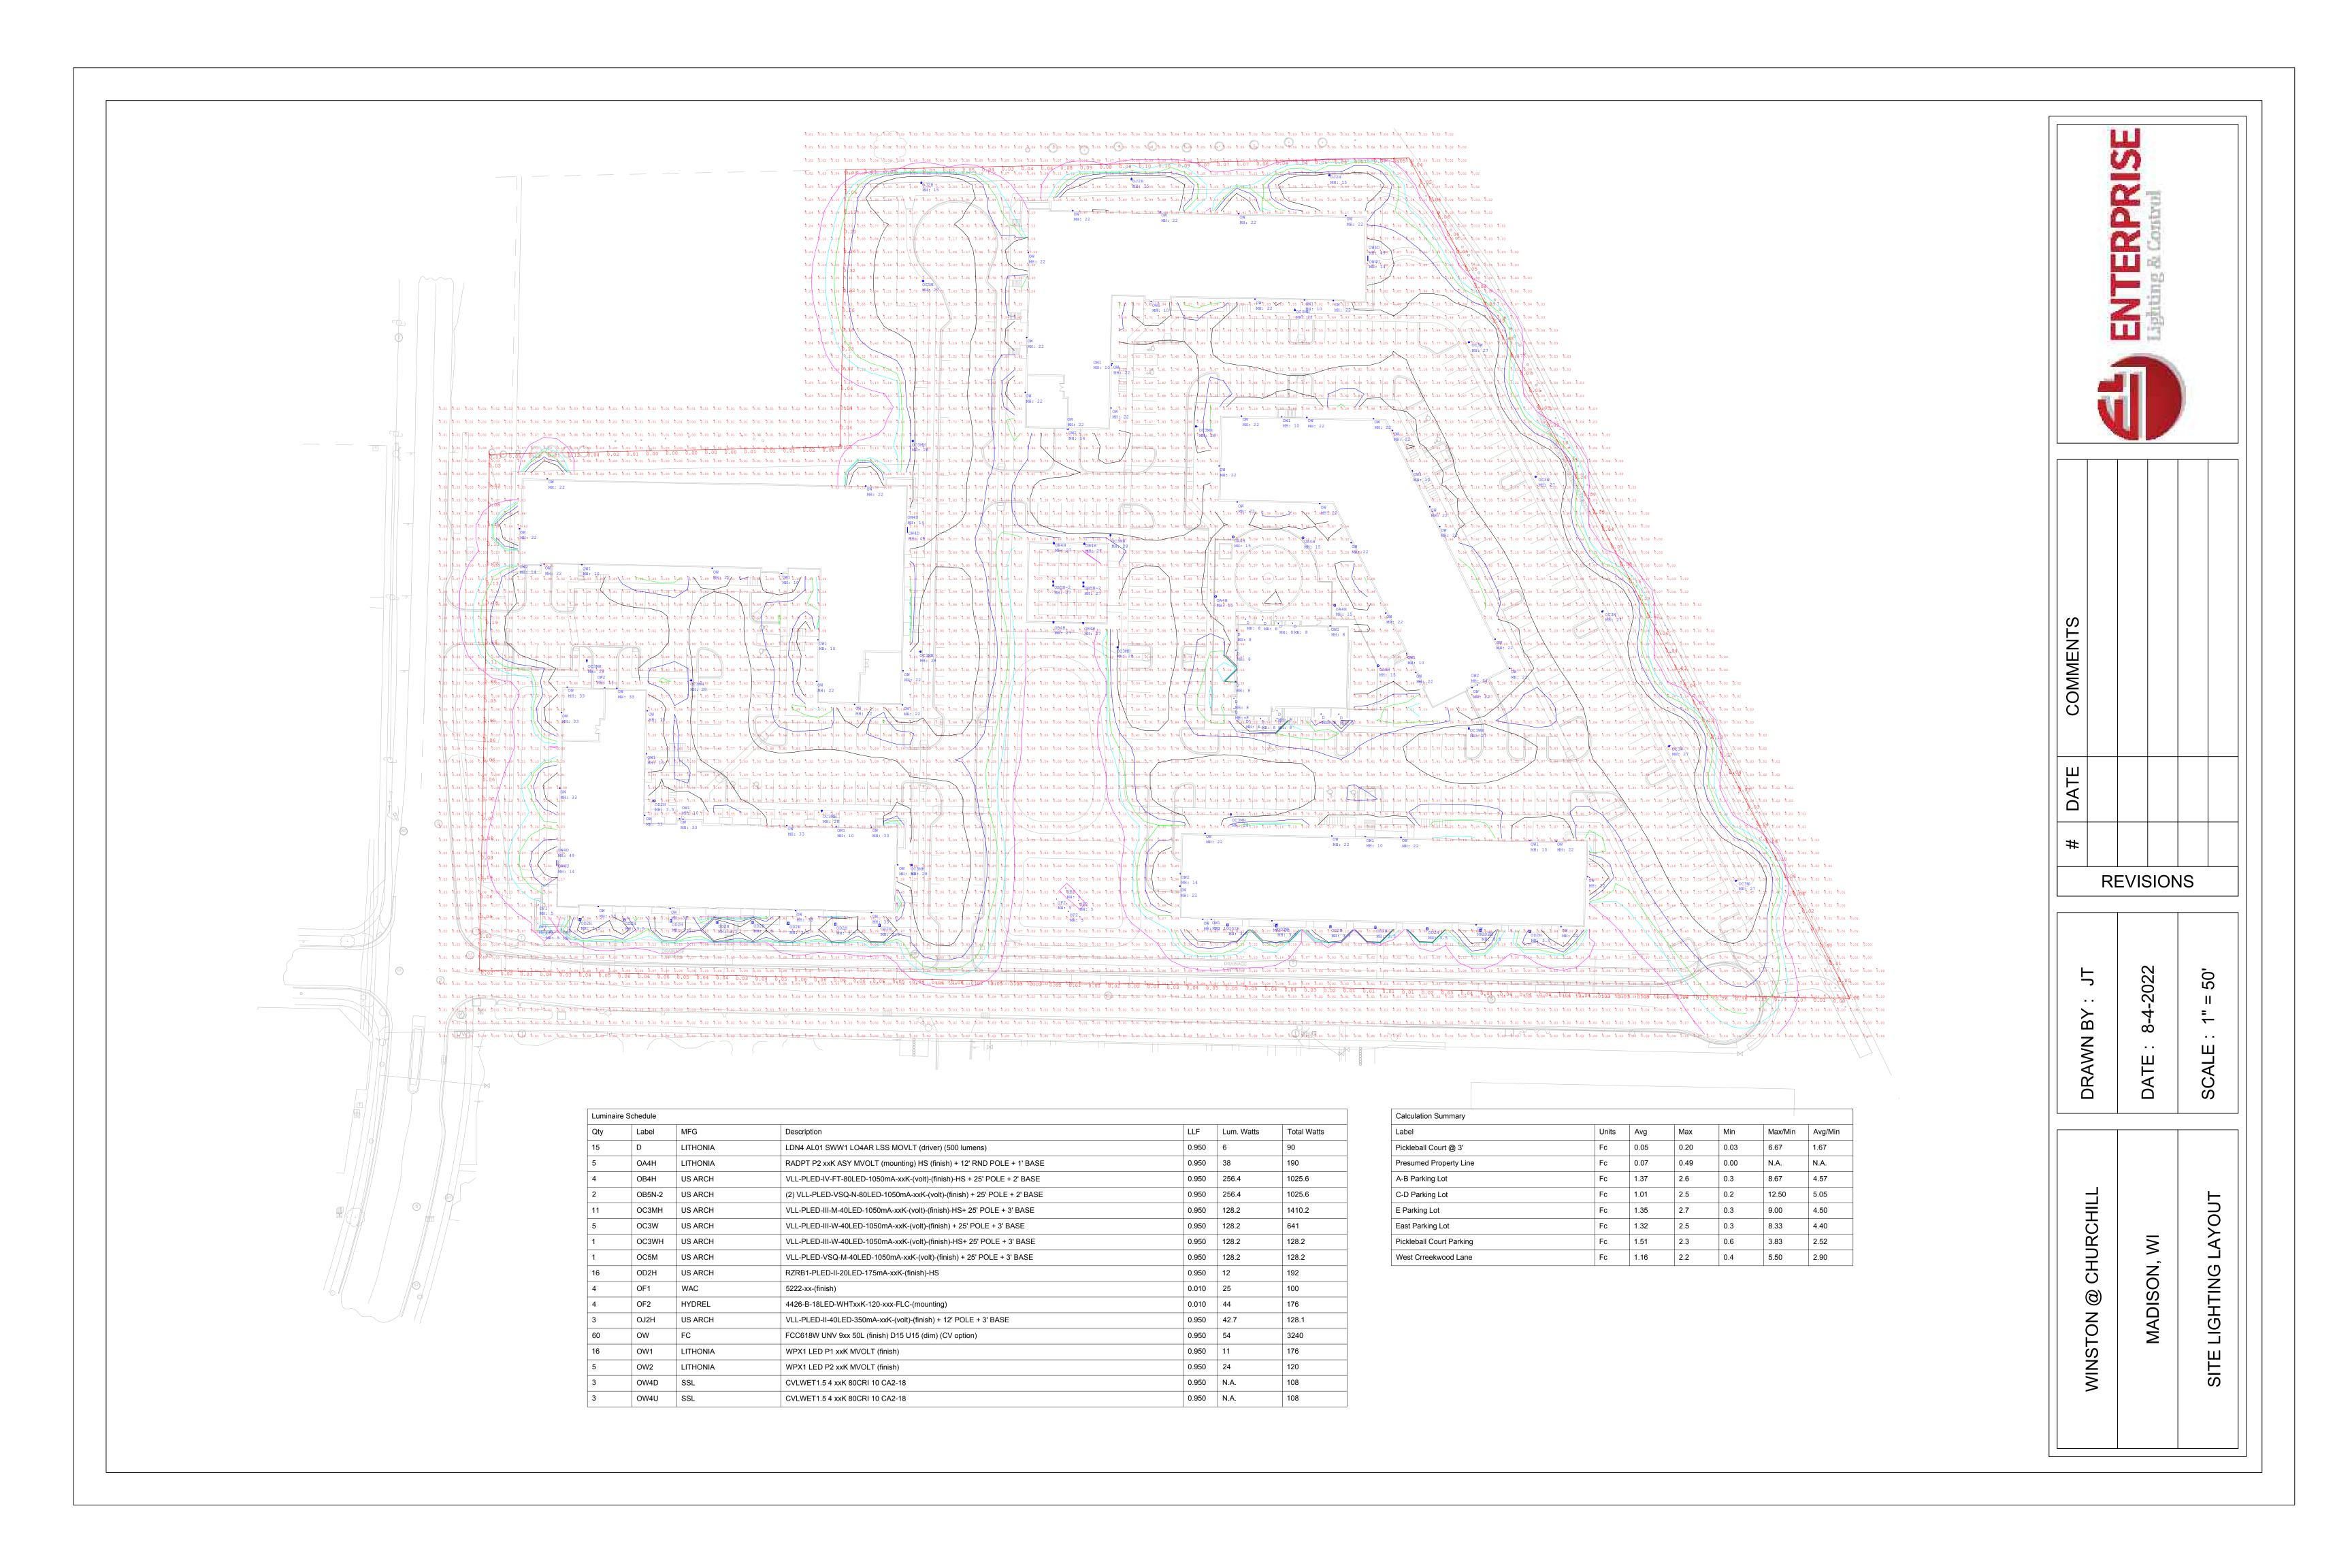

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- A 2.5"sq x 16ga POSTS
- **B** 0.75"sq x 18ga PICKETS
- © 1.4375"w x 1.5"h x 14ga RAILS
- 3', 3.5', 4', 4.5', 5' & 6' PANEL HEIGHTS

Refer to construction specification & tables within this section for recommended post space by bracket type

Effective: 04/01/20

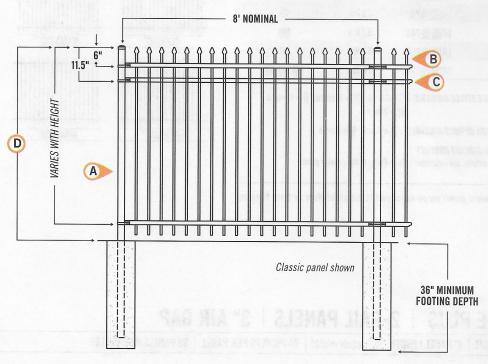AMERISTAR' ASSA ABLOY