## URBAN DESIGN COMMISSION APPLICATION



City of Madison **Planning Division** 126 S. Hamilton St. P.O. Box 2985 Madison, WI 53701-2985 (608) 266-4635



FOR OFFICE USE ONL	Υ;
Paid	Receipt #
Date received	en e
Received by	· · · · · · · · · · · · · · · · · · ·
Aldermanic District	
Zoning District	
Urban Design District	
Submittal reviewed by	<del></del>

the If y for	e desired meetir	ng date and the eter, translator, n immodations to a		Aldermanic District  Zoning District  Urban Design District  Submittal reviewed by						
		on W Washingto	on Avenue							
2. Ap		requested ment $\Box$	apply) and Requested Da August 8, 2018 Alteration to an existing of Initial approval	A. J. (1860. A. 1960. 1	ously-approved development Final approval					
3. Pro	Project Type  □ Project in an Urban Design District  □ Project in the Downtown Core District (DC), Urban Mixed-Use District (UMX), or Mixed-Use Center District (MXC)  □ Project in the Suburban Employment Center District (SEC), Campus Institutional District (CI), or Employment Campus District (EC)  □ Planned Development (PD)  □ General Development Plan (GDP)  □ Specific Implementation Plan (SIP)				Signage Variance (i.e. modification of signage height area, and setback)					
App Strong Tele Pro Strong Tele Pro	plicant name eet address ephone  pject contact per eet address ephone	Brendan 2303 W. 608-276- rson Kevin 7601 Uni 608-836- not applicant)	Beltline Hwy -0244 Burow versity Ave. Ste 201 3690	City/Si Email Compa City/Si Email	PJB-II Inc.  Tate/Zip Madison, WI 53713  baxter.bt@gmail.com  Tany Knothe and Bruce Architects  Tate/Zip Middleton, WI 53562  kburow@knothebruce.com					
	ephone									

Urba	n Design Commission Application (continued)
5 R	equired Submittal Materials
X	Application Form  Letter of Intent  Each submittal must include fourteen (14)
	• If the project is within an Urban Design District, a summary of how the development proposal addresses the district criteria is required  • If the project is within an Urban Design District, a summary of how the development proposal addresses the district criteria is required  • If the project is within an Urban Design District, a summary of how the development proposal addresses the district criteria is required
	<ul> <li>For signage applications, a summary of how the proposed signage is consistent with the applicable CDR or Signage Variance review criteria is required.</li> </ul> Lighting plans (if required) must be full-sized. Please
	Development plans (Refer to checklist provided below for plan details)  Filing fee  refrain from using plastic covers or spiral binding.
X	Electronic Submittal*
be	th the paper copies and electronic copies <u>must</u> be submitted prior to the application deadline before an application wil scheduled for a UDC meeting. Late materials will not be accepted. A completed application form is required for each UDC pearance.
Co	r projects also requiring Plan Commission approval, applicants must also have submitted an accepted application for Plar Immission consideration prior to obtaining any formal action (initial or final approval) from the UDC. All plans must be Bible when reduced.
co pr nc	lectronic copies of all items submitted in hard copy are required. Individual PDF files of each item submitted should be mpiled on a CD or flash drive, or submitted via email to <u>udcapplications@cityofmadison.com</u> . The email must include the oject address, project name, and applicant name. Electronic submittals via file hosting services (such as Dropbox.com) are allowed. Applicants who are unable to provide the materials electronically should contact the Planning Division at (608, 16-4635) for assistance.
6. A	oplicant Declarations
1.	Prior to submitting this application, the applicant is required to discuss the proposed project with Urban Design Commission staff. This application was discussed with Heather Stouder, Kevin Firchow, Bill Freuling or February 12, 2018
2.	The applicant attests that all required materials are included in this submittal and understands that if any required information is not provided by the application deadline, the application will not be placed on an Urban Design Commission agenda for consideration.
Aı	oplicant name Brendan Baxter Relationship to property Owner
	uthorized signature of Property Owner Date 5/2/2018
7. Ap	oplication Filing Fees
of Co	es are required to be paid with the first application for either initial or final approval of a project, unless the project is part the combined application process involving the Urban Design Commission in conjunction with Plan Commission and/or ommon Council consideration. Make checks payable to City Treasurer. Credit cards may be used for application fees of less an \$1,000.
Pl	ease consult the schedule below for the appropriate fee for your request:
	Urban Design Districts: \$350 (per §35.24(6) MGO).

Minor Alteration in the Downtown Core District (DC) or Urban Mixed-Use District (UMX): \$150 (per §33.24(6)(b) MGO)

Comprehensive Design Review: \$500 (per §31.041(3)(d)(1)(a) MGO)

Minor Alteration to a Comprehensive Sign Plan: \$100 (per §31.041(3)(d)(1)(c) MGO)

All other sign requests to the Urban Design Commission, including, but not limited to: appeals from the decisions of the Zoning Administrator, requests for signage variances (i.e. modifications of signage height, area, and setback), and additional sign code approvals: \$300 (per §31.041(3)(d)(2) MGO)

A filing fee is not required for the following project applications if part of the combined application process involving both Urban Design Commission and Plan Commission:

- Project in the Downtown Core District (DC), Urban Mixed-Use District (UMX), or Mixed-Use Center District (MXC)
- Project in the Suburban Employment Center District (SEC), Campus Institutional District (CI), or Employment Campus District (EC)
- Planned Development (PD): General Development Plan (GDP) and/or Specific Implementation Plan (SIP)
- Planned Multi-Use Site or Residential Building Complex

## **URBAN DESIGN COMMISSION APPROVAL PROCESS**



#### Introduction

The City of Madison's Urban Design Commission (UDC) has been created to:

- Encourage and promote high quality in the design of new buildings, developments, remodeling, and additions so as to maintain and improve the established standards of property values within the City.
- Foster civic pride in the beauty and nobler assets of the City, and in all other ways possible assure a functionally efficient and visually attractive City in the future.

#### **Types of Approvals**

There are three types of requests considered by the UDC:

- <u>Informational Presentation</u>. Applicants may, at their discretion, request to make an Informational Presentation to the UDC prior to seeking any approvals to obtain early feedback and direction before undertaking detailed design. Applicants should provide details on the context of the site, design concept, site and building plans, and other relevant information to help the UDC understand the proposal and provide feedback. (Does not apply to CDR's or Signage Variance requests)
- <u>Initial Approval</u>. Applicants may, at their discretion, request initial approval of a proposal by presenting preliminary design information. As part of their review, the Commission will provide feedback on the design information what should be addressed at Final Approval stage.
- <u>Final Approval</u>. Applicants may request Final Approval of a proposal by presenting all final project details. Recommendations or concerns expressed by the UDC in the initial approval must be addressed at this time.

#### **Presentations to the Commission**

Primarily, the UDC is interested in the appearance and design quality of projects. Emphasis should be given to the site plan, landscape plan, lighting plan, building elevations, exterior building materials, color scheme, and graphics.

When presenting projects to the UDC, applicants must fill out a registration slip provided in the meeting room and present it to the Secretary. Presentations should generally be limited to 5 minutes or as extended by motion by consent of the Commission. The Commission will withhold questions until the end of the presentation.

Applicants are encouraged to consider the use of various graphic presentation material including a locator map, photographs, renderings/model, scale drawings of the proposal in context with adjacent buildings/uses/signs, etc., as may be deemed appropriate to describe the project and its surroundings. Graphics should be mounted on rigid boards so that they may be easily displayed. Applicants/presenters are responsible for all presentation materials, AV equipment and easels.

## **URBAN DESIGN DEVELOPMENT PLANS CHECKLIST**



The items listed below are minimal application requirements for the type of approval indicated. Please note that the UDC and/or staff may require additional information in order to have a complete understanding of the project.

#### 1. Informational Presentation

- Locator Map
- Contextual site information, including photographs and layout of adjacent buildings/structures
- Two-dimensional (2D) images of proposed buildings or structures.

Providing additional information beyond these minimums may generate a greater level of feedback from the Commission.

#### **Requirements for All Plan Sheets**

- 1. Title block
- 2. Sheet number
- 3. North arrow
- 4. Scale, both written and graphic
- 5. Date
- 6. Fully dimensioned plans, scaled at 1"= 40' or larger

\*\* All plans must be legible, including the full-sized landscape and lighting plans (if required)

#### 2. Initial Approval

Locator Map
Letter of Intent (If the project is within a Urban Design District, a summary of <a href="https://example.com/how">how</a> the development proposal addresses the district criteria is required)
Contextual site information, including photographs and layout of adjacent buildings/structures
Site Plan showing location of existing and proposed buildings, walks, drives, bike lanes, bike parking, and existing trees over 18" diameter
Landscape Plan and Plant List (must be legible)
Building Elevations in both black $\&$ white and color for all building sides (include material callouts)
PD text and Letter of Intent (if applicable)

Providing additional information beyond these minimums may generate a greater level of feedback from the Commission.

#### 3. Final Approval

Αl	l	the re	quireme	ents of	the	Initial	App	oroval	(see a	bove	), p	lus:
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- ☑ Grading Plan
- ☐ Proposed Signage (if applicable)
- N/A Lighting Plan, including fixture cut sheets and photometrics plan (must be legible)
  - ☑ Utility/HVAC equipment location and screening details (with a rooftop plan if roof-mounted)
  - ☑ PD text and Letter of Intent (if applicable)
  - Samples of the exterior building materials (presented at the UDC meeting)

#### 4. Comprehensive Design Review (CDR) and Variance Requests (Signage applications only)

Locator Map
Letter of Intent (a summary of <u>how</u> the proposed signage is consistent with the CDR or Signage Variance criteria is required)
Contextual site information, including photographs of existing signage both on site and within proximity to the project site
Site Plan showing the location of existing signage and proposed signage, dimensioned signage setbacks, sidewalks, driveways, and right-of-ways
Proposed signage graphics (fully dimensioned, scaled drawings, including materials and colors, and night view)
Perspective renderings (emphasis on pedestrian/automobile scale viewsheds)
Graphic of the proposed signage as it relates to what the Ch. 31. MGO would permit

June 20, 2018

Ms. Heather Stouder
Department of Planning & Development
City of Madison
146 S. Hamilton Street
PO Box 2985
Madison, Wisconsin 53701

Re: Letter of Intent 555 W. Washington Ave. KBA Project #1713

Ms. Heather Stouder:

The following is submitted together with the plans and application for the staff and Plan Commission's consideration of approval.

#### **Organizational structure:**

Owner: PJB II, Inc. Architect: Knothe & Bruce Architects, LLC

2303 W. Beltline Hwy
Madison, WI 53713
7601 University Avenue, Ste 201
Middleton, WI 53562

608-276-0244 608-836-3690

Contact: Brendan Baxter

Contact: Kevin Burow

kburow@knothebruce.com

Engineer: Vierbicher Associates, Inc. Landscape Saiki Design

 999 Fourier Dr.
 Design:
 1110 S. Park Street

 Madison, WI 53717
 Madison, WI 53715

 (608) 826-0532
 (608) 251-3600

 (608) 826-0530 fax
 Contact: Ken Saiki

Contact: Justin Zampardi <u>ksaiki@ksd-la.com</u> jzam@vierbicher.com

#### Introduction:

The site is located at the east corner of W. Washington Ave. and S. Bedford St. The site is currently occupied by a two-story office building and is zoned UMX (Urban Mixed Use District). This application requests demolition of the existing structure and a conditional use approval to allow the construction of a new 5-story multi-family apartment building.

#### **Project Description:**

This proposed project is a multi-family apartment building consisting of 45 units along with 12 parking stalls in the first floor garage and 33 parking stalls in the basement parking garage. The building will be five stories total, with step-backs occurring at the fourth and fifth floors.

The UMX district allows for four stories, and up to two "bonus" stories can be approved with a conditional use approval if the Plan Commission and UDC find the design to be in line with the recommendations in adopted plans and the project demonstrates "exceptional design."



Letter of Intent –Conditional Use 555 W. Washington Ave. June 20, 2018 Page 2 of 3

The proposed project is designed with a set of criteria that set it apart from a typical apartment building:

#### • Unique and timeless architecture

- The project blends together three distinct architectural styles to complement the character of the neighborhood
  - Quintessential residential brownstone along W. Washington Ave.
  - Simple and traditional warehouse style along S. Bedford St.
  - Sleek, clean, and modern "cap" on the fourth and fifth floors

#### Thoughtful density through the use of careful site design and massing

- Improved setbacks along both W. Washington Ave. and S. Bedford St. allow for lush "front yards" that benefit the residents of the building as well as add to the character of the street.
- The three story façade along W. Washington Ave. allows the project to blend with the adjacent single family homes on the street.
- Generous step backs on the fourth and fifth floor reduce the visible scale from the street.

#### • Use of historic materials

- Solid stone brownstone
- Modular all-brick warehouse
- All four sides of the building are stone or brick

#### • Capture and accentuate the essence of residential enjoyment in an urban setting

- o Ground floor units will have direct walk-up access with private front doors
- Every unit has an outdoor living space, whether that is a street level patio, an upper floor balcony, or a thoughtfully landscaped roof terrace.
- Generous roof terraces allow residents to enjoy an outdoor experience in urban surroundings, including lake and Capital view sheds
- Green roofs on the second, fourth, and fifth floors introduce a softer, more natural environmental atmosphere

The massing of the proposed building was carefully designed to incorporate several unrequired setbacks and stepbacks in order to seamlessly blend with the scale of the adjacent neighborhood. A four-story, zero setback building, which is permitted at this location, would be much more visually obtrusive than this proposed building. A four story mass built up to the lot lines at W. Washington and Bedford would reduce views and diminish the scale of the surroundings. Even with the addition of a fifth story (which will be imperceptible at street level), the massing of this proposed building will be significantly less disruptive to the character of the neighborhood.

#### **Site Development Data:**

**Densities:** 

Gross Lot Area 16,735 sf / .38 Acres
Dwelling Units 45 DU
Lot Area / D.U. 372 sf / unit

Density 128 units/acre

Building Height 3 to 5 stories

Letter of Intent –Conditional Use 555 W. Washington Ave. June 20, 2018 Page 3 of 3

Lot Coverage	13,747 S.F. = 82% (90% Max.)
Usable Open Space	6,348 sf (570sf required - 10sf/bedroom)

#### **Dwelling Unit Mix:**

Efficiency	12
One Bedroom	21
Two Bedroom Apartments	12
Total Dwelling Units	45

#### Vehicle Parking:

First Floor Garage	12 stalls
<u>Underground</u>	33 stalls
Total	45 stalls

#### Bicycle Parking:

Surface	5 stalls
First Floor Garage	6 stalls
Underground Comers	20 stalle (Ctd 2

<u>Underground Garage</u> 39 stalls (Std. 2'x6')

Total 50 stalls


#### **Project Schedule:**

It is anticipated that the construction on this site will begin spring of 2019 with a final completion date of spring of 2020.


Thank you for your time reviewing our proposal.

Sincerely,

Kevin Burow, AIA

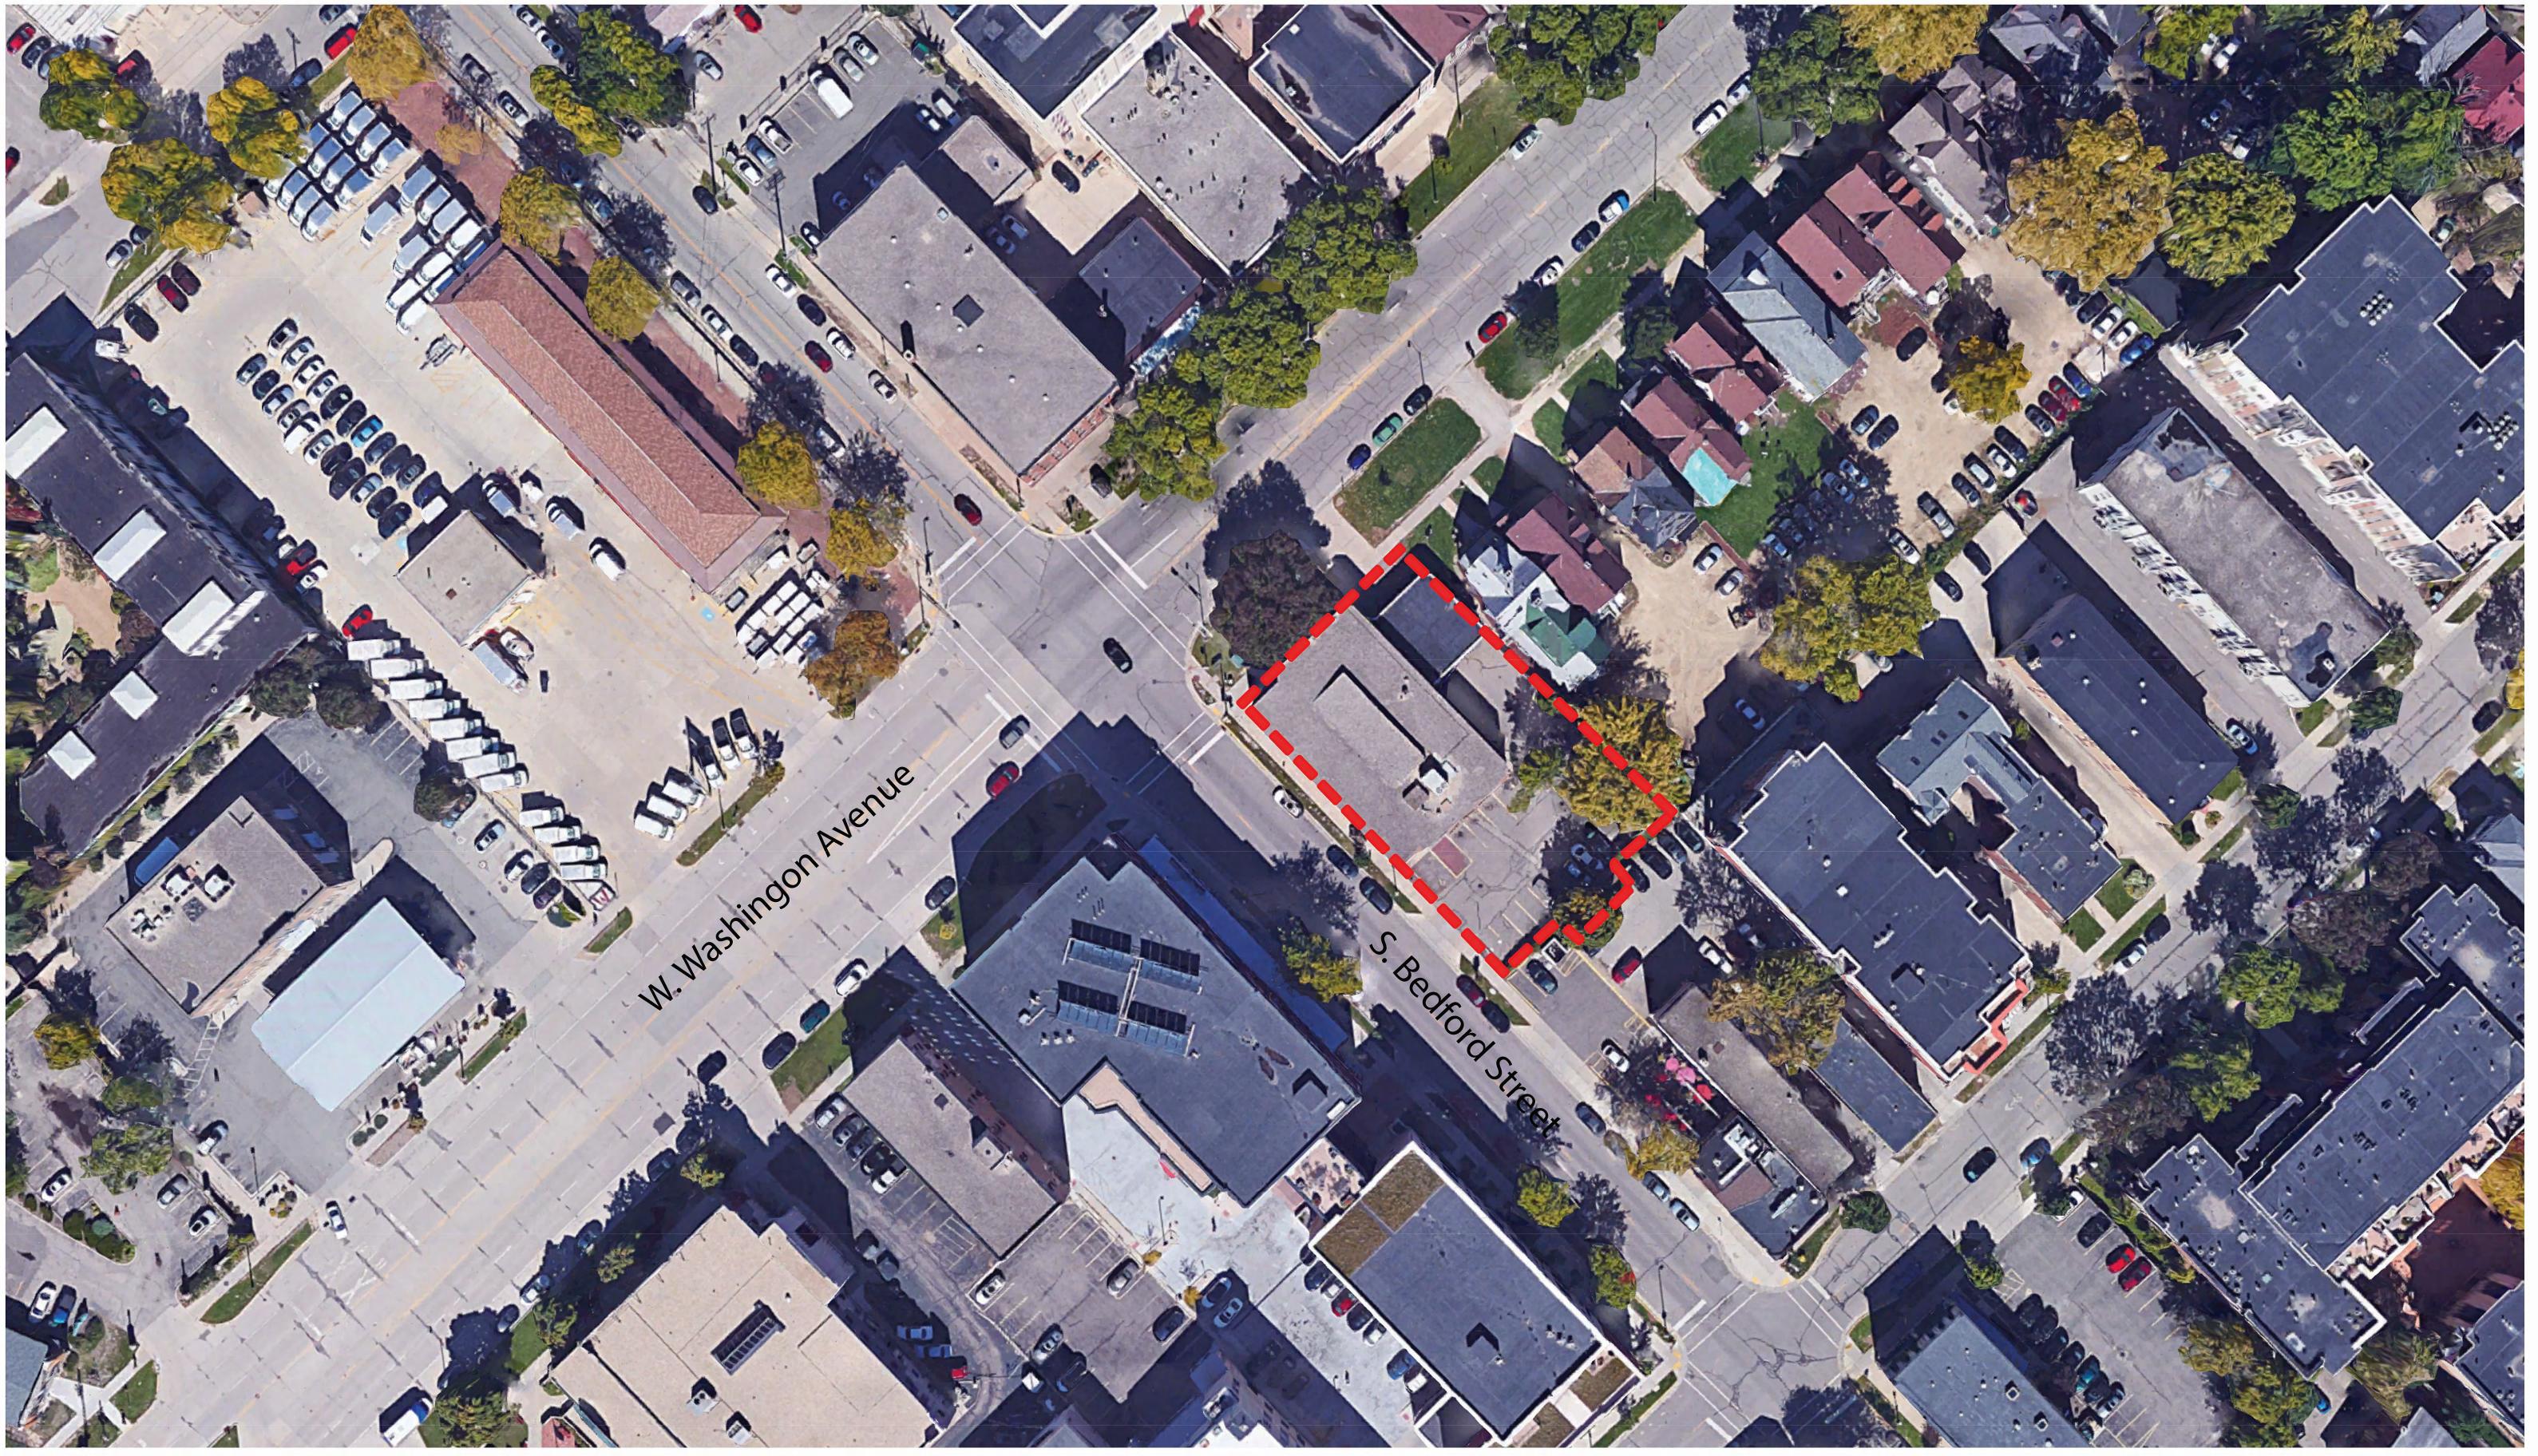




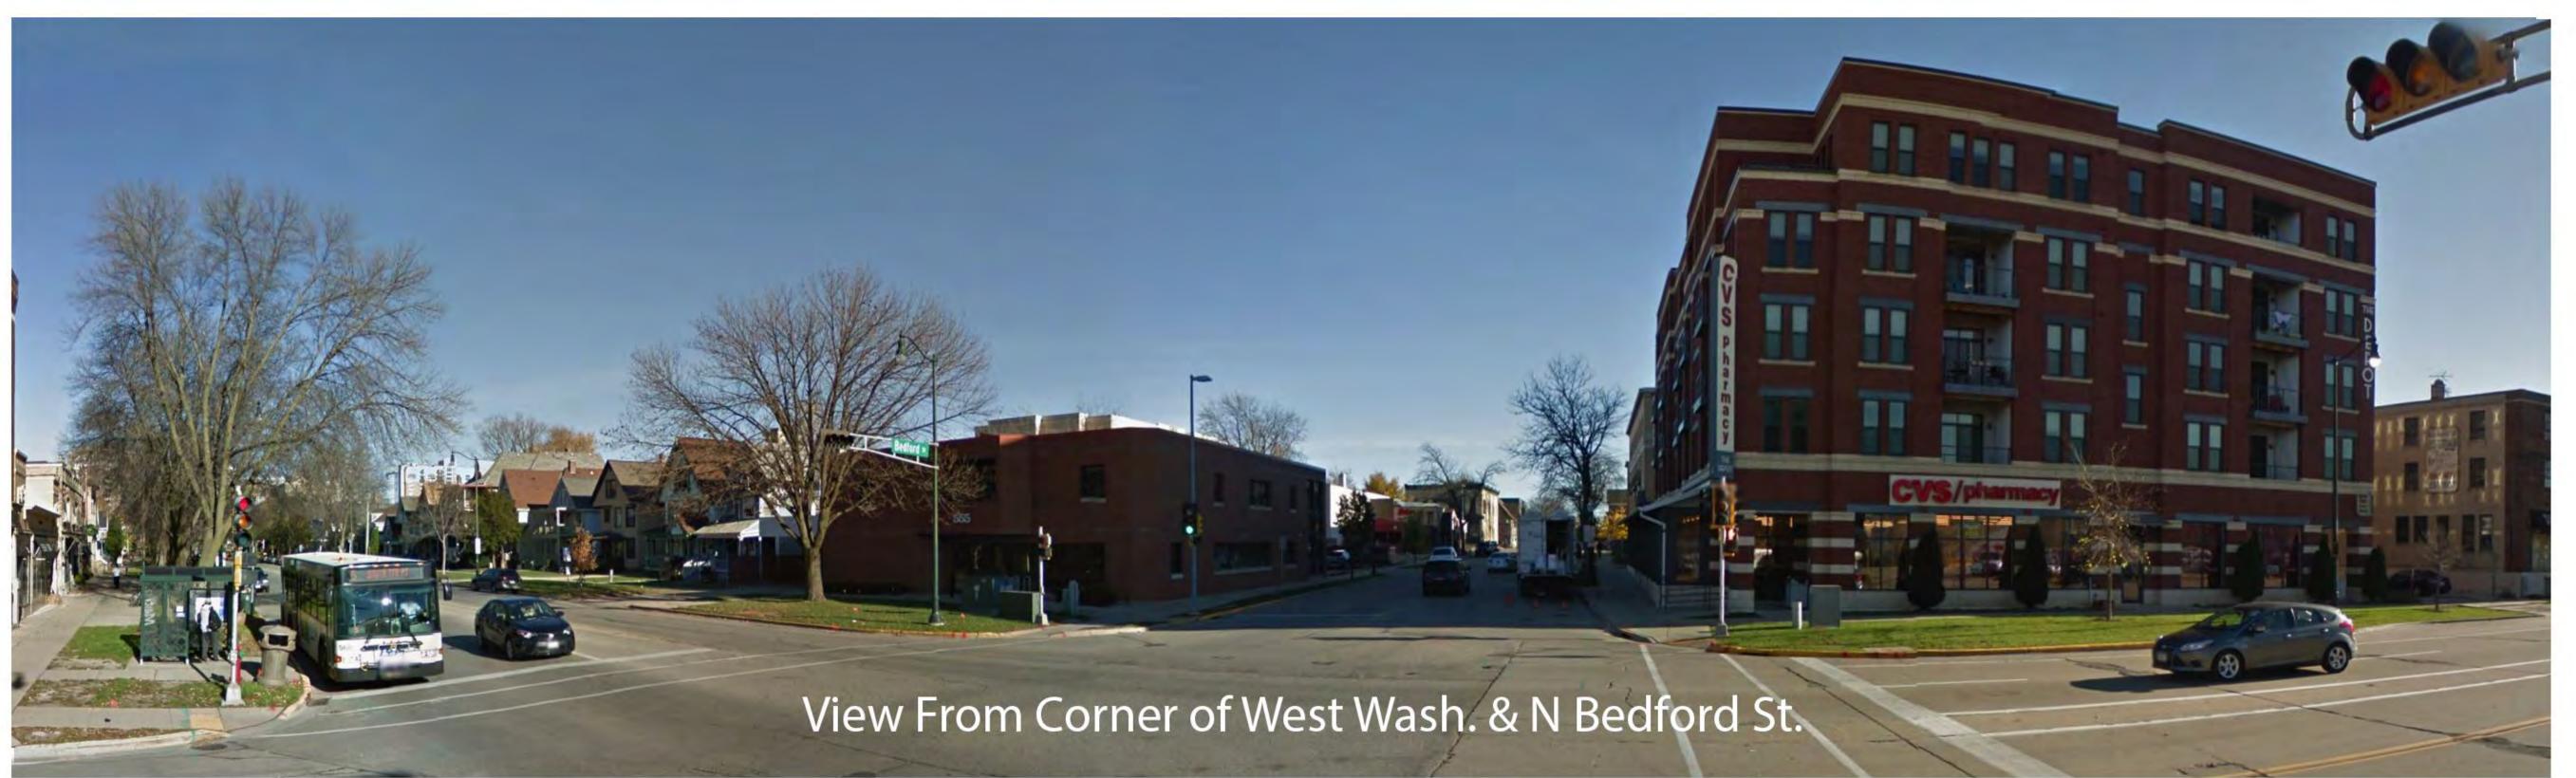









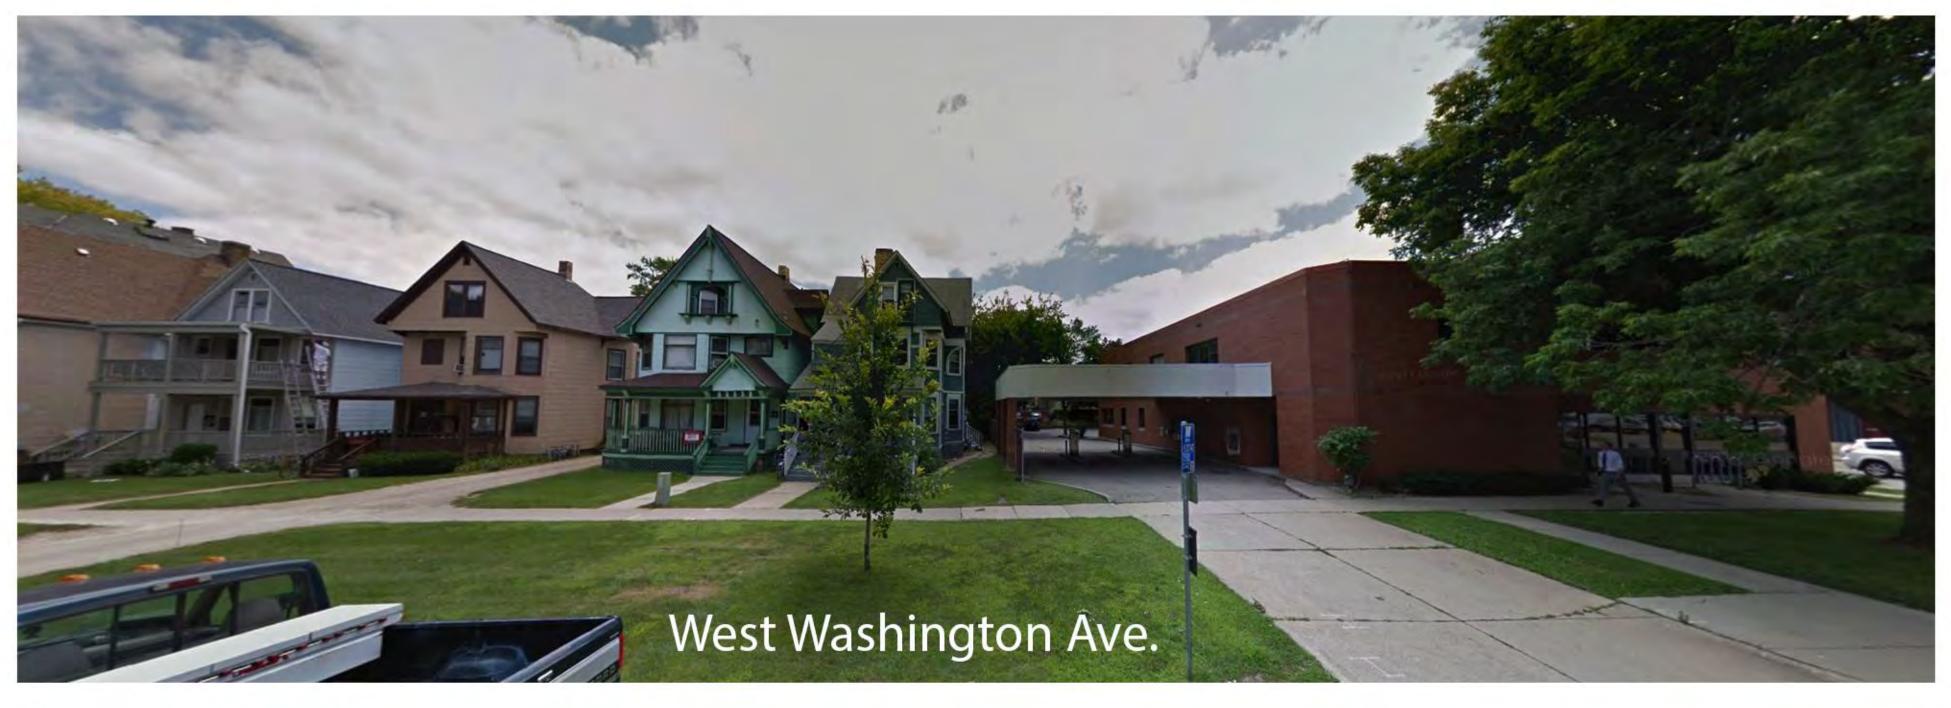



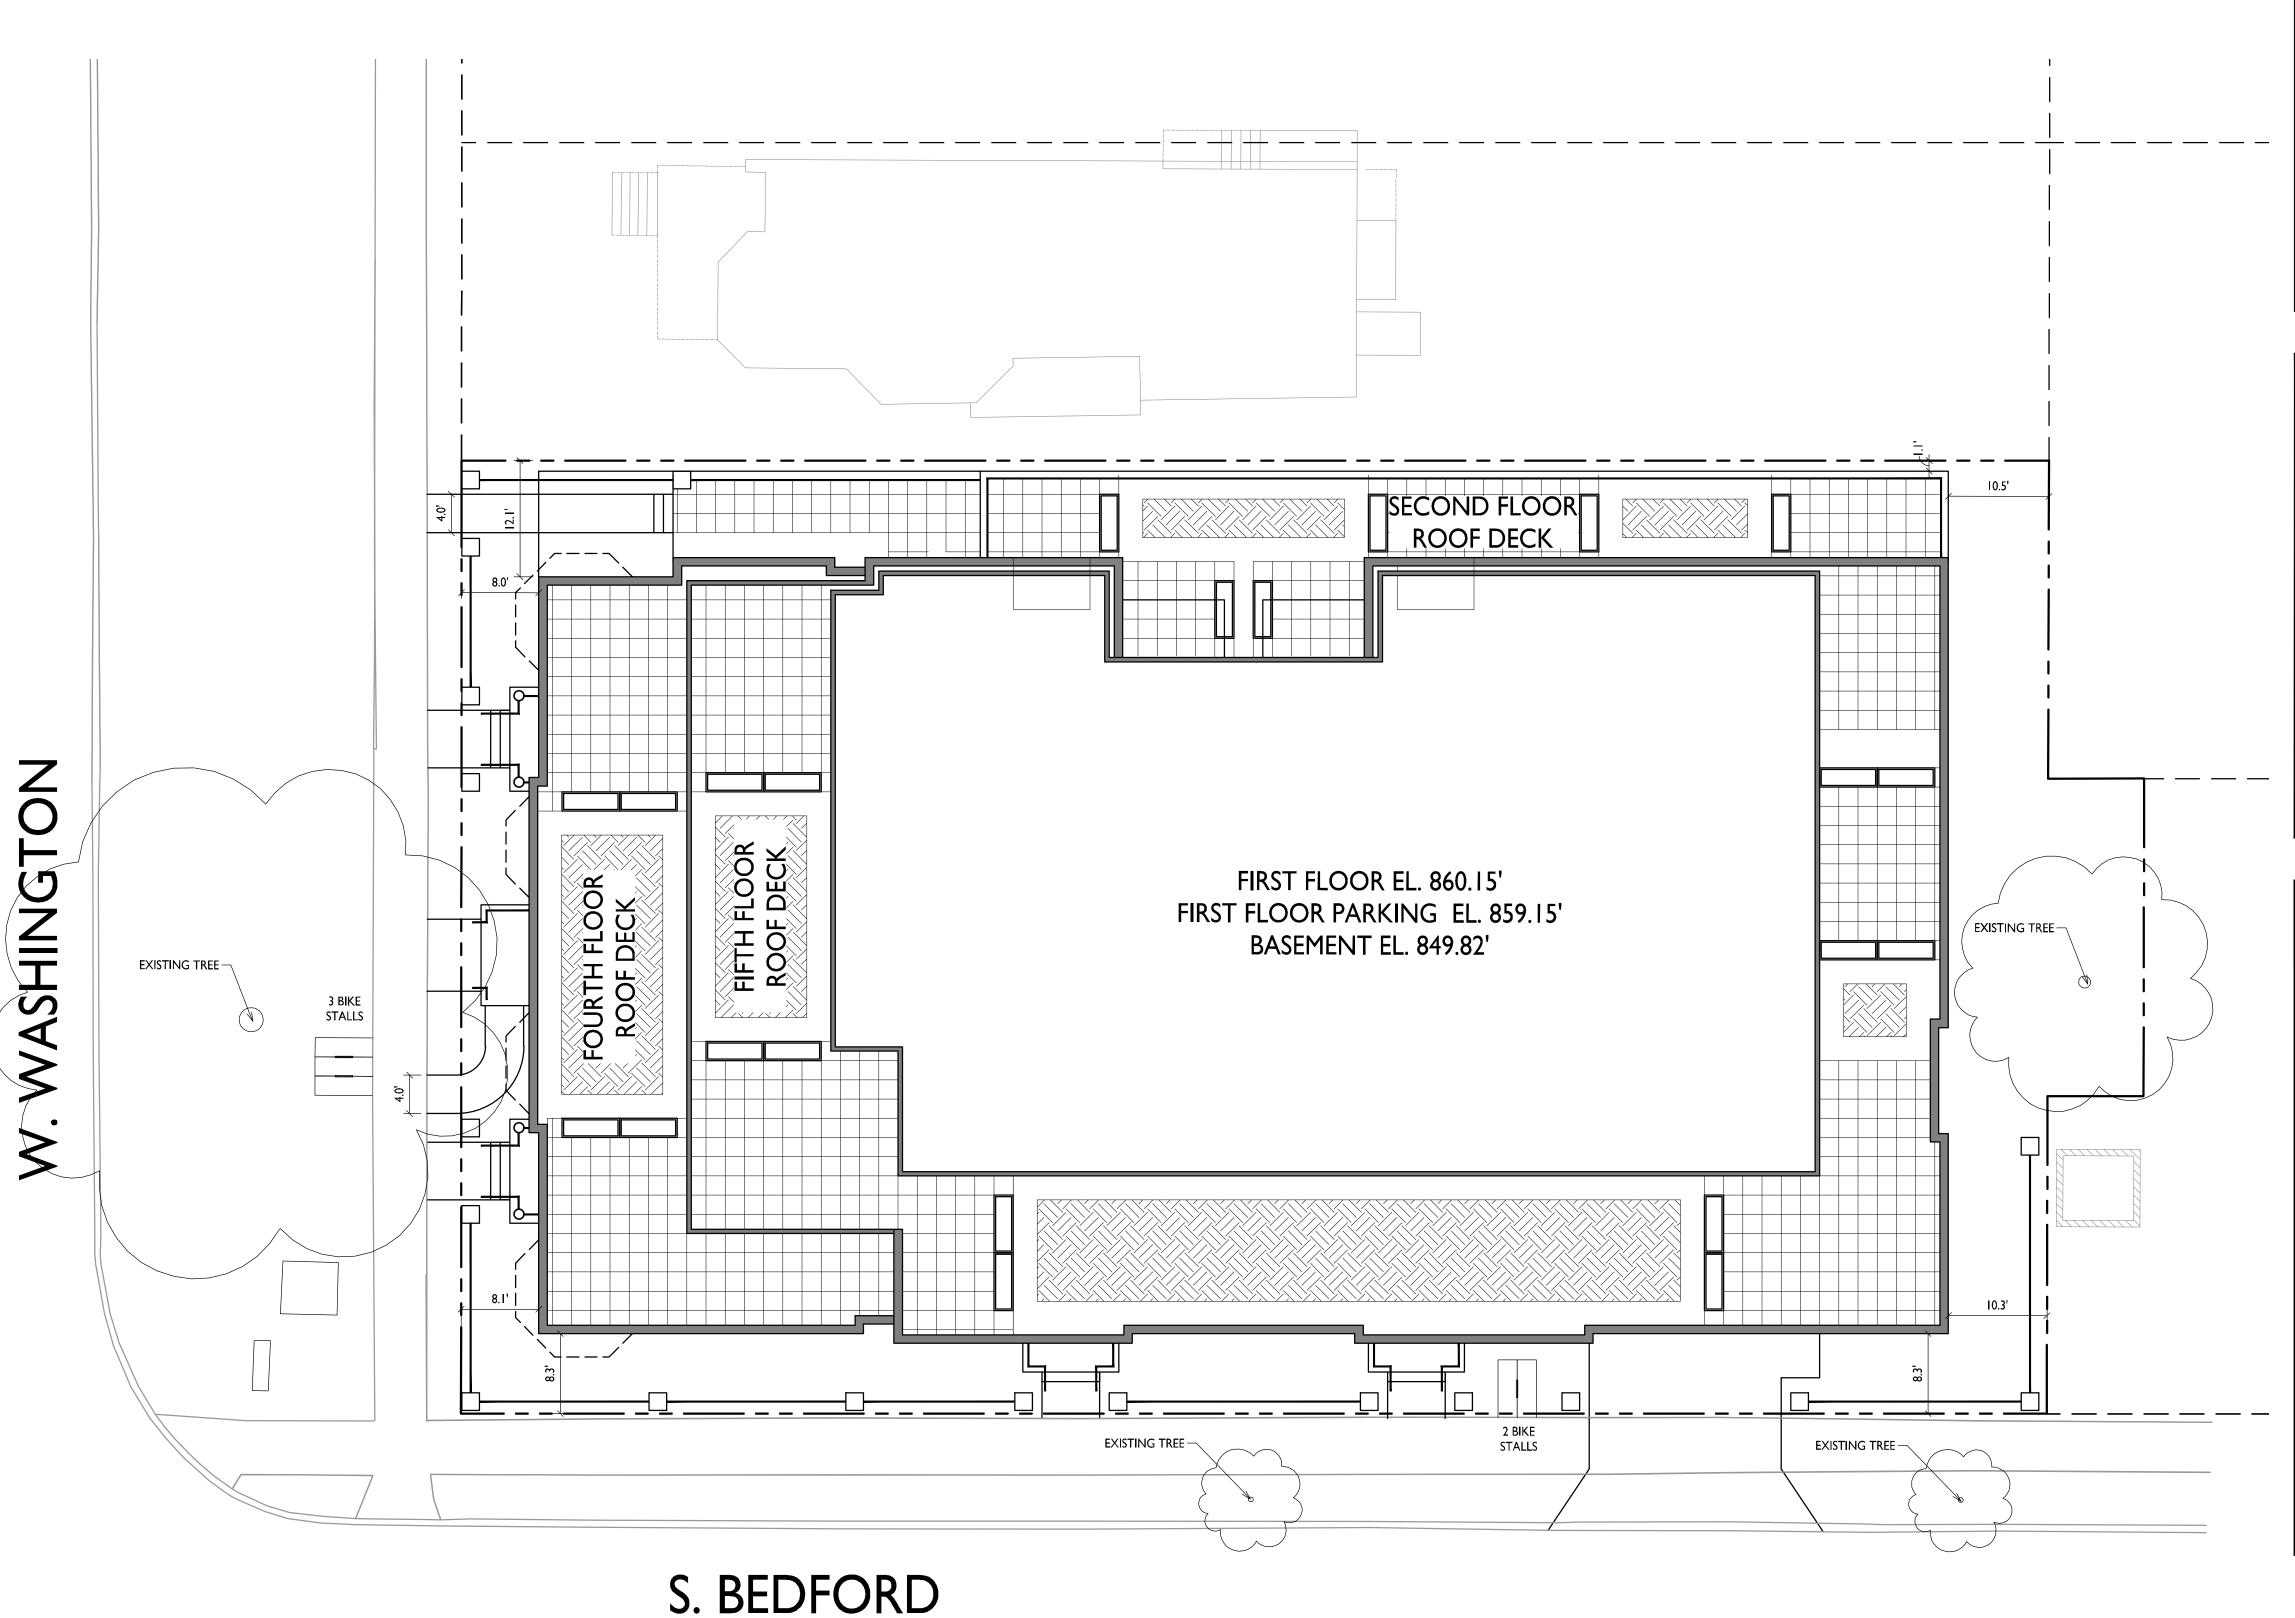

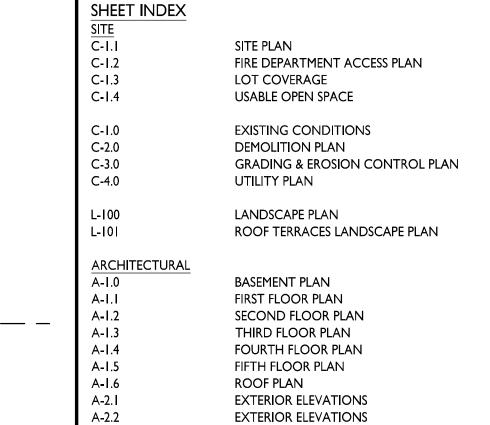

SITE DEVELOPMENT DATA DENSITIES: LOT AREA 16,735 SF / .38 ACRES **DWELLING UNITS** 372 SF / UNIT LOT AREA / D.U. DENSITY 128 UNITS/ACRE **BUILDING HEIGHT** 3-5 STORIES 13,747 S.F. = 82% (90% MAX.) LOT COVERAGE **USABLE OPEN SPACE** 6,348 S.F. ( 570 S.F. REQ'D) DWELLING UNIT MIX EFFICIENCY ONE BEDROOM TWO BEDROOM TOTAL DWELLING UNITS VEHICLE PARKING: FIRST FLOOR GARAGE **12 STALLS** 33 STALLS 45 STALLS UNDERGROUND **BICYCLE PARKING:** 5 STALLS SURFACE 6 STALLS FIRST FLOOR GARAGE 39 STALLS (STD. 2'X6') 50 STALLS UNDERGROUND GARAGE

TYPICAL UNIT PLANS

TYPICAL UNIT PLANS

## GENERAL NOTES:

A-5.1

A-5.2

- THE APPLICANT SHALL REPLACE ALL SIDEWALK AND CURB AND GUTTER WHICH ABUTS THE PROPERTY WHICH IS DAMAGED BY THE CONSTRUCTION OR ANY SIDEWALK AND CURB AND GUTTER WHICH THE CITY ENGINEER DETERMINES NEEDS TO BE REPLACED BECAUSE IT IS NOT AT A DESIRABLE GRADE REGARDLESS OF WHETHER THE CONDITION EXISTED PRIOR TO BEGINNING CONSTRUCTION.
- 2. ALL WORK IN THE PUBLIC RIGHT-OF-WAY SHALL BE PERFORMED BY A CITY LICENSED CONTRACTOR.
- 3. ALL DAMAGE TO THE PAVEMENT, ADJACENT TO THIS DEVELOPMENT SHALL BE RESTORED IN ACCORDANCE WITH THE CITY OF MADISON'S PAVEMENT PATCHING CRITERIA.
- EASEMENT LINES SHOWN ON THIS SHEET ARE FOR GENERAL REFERENCE ONLY SEE CSM AND CIVIL SHEETS FOR ADDITIONAL AND MORE COMPLETE EASEMENT INFORMATION.
- 5. THE RIGHT-OF-WAY IS THE SOLE JURISDICTION OF THE CITY OF MADISON AND IS SUBJECT TO CHANGE AT ANY TIME PER THE RECOMMENDATION OF TRAFFIC ENGINEERING AND CITY ENGINEERING DEPARTMENTS.
- CONTRACTOR SHALL INSTALL TREE PROTECTION FENCING IN THE AREA BETWEEN THE CURB AND SIDEWALK AND EXTEND IT AT LEAST 5 FEET FROM BOTH SIDES OF THE TREE ALONG THE LENGTH OF THE TERRACE. IF EXCAVATION WITHIN 5 FEET OF ANY TREE IS NECESSARY, CONTRACTOR SHALL CONTACT CITY FORESTRY (266-4816) PRIOR TO EXCAVATION TO ASSESS THE IMPACT TO THE TREE AND ROOT SYSTEM. TREE PRUNING SHALL BE COORDINATED WITH CITY FORESTRY PRIOR TO THE START OF CONSTRUCTION. TREE PROTECTION SPECIFICATIONS CAN BE FOUND IN SECTION 107.13 OF THE CITY OF MADISON STANDARD SPECIFICATIONS FOR PUBLIC WORKS CONSTRUCTION. ANY TREE REMOVALS THAT ARE REQUIRED FOR CONSTRUCTION AFTER THE DEVELOPMENT PLAN IS APPROVED WILL REQUIRE AT LEAST A 72 HOUR WAIT PERIOD BEFORE TREE REMOVAL PERMIT CAN BE ISSUED BY FORESTRY, TO NOTIFY THE ALDER OF THE CHANGE IN THE TREE PLAN.

555 W Washington Ave.

ARCHITECTS

Phone: 7601 University Ave, Ste 201

608.836.3690 Middleton, WI 53562

**ISSUED** 

Issued for Land Use - June 20, 2018

SHEET TITLE
Site Plan

PROJECT TITLE

**BAXTER** 


West Washington Development

SHEET NUMBER

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PROJECT NO.

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ISSUED
Issued for Land Use - June 20, 2018

PROJECT TITLE
BAXTER
West Washington
Development

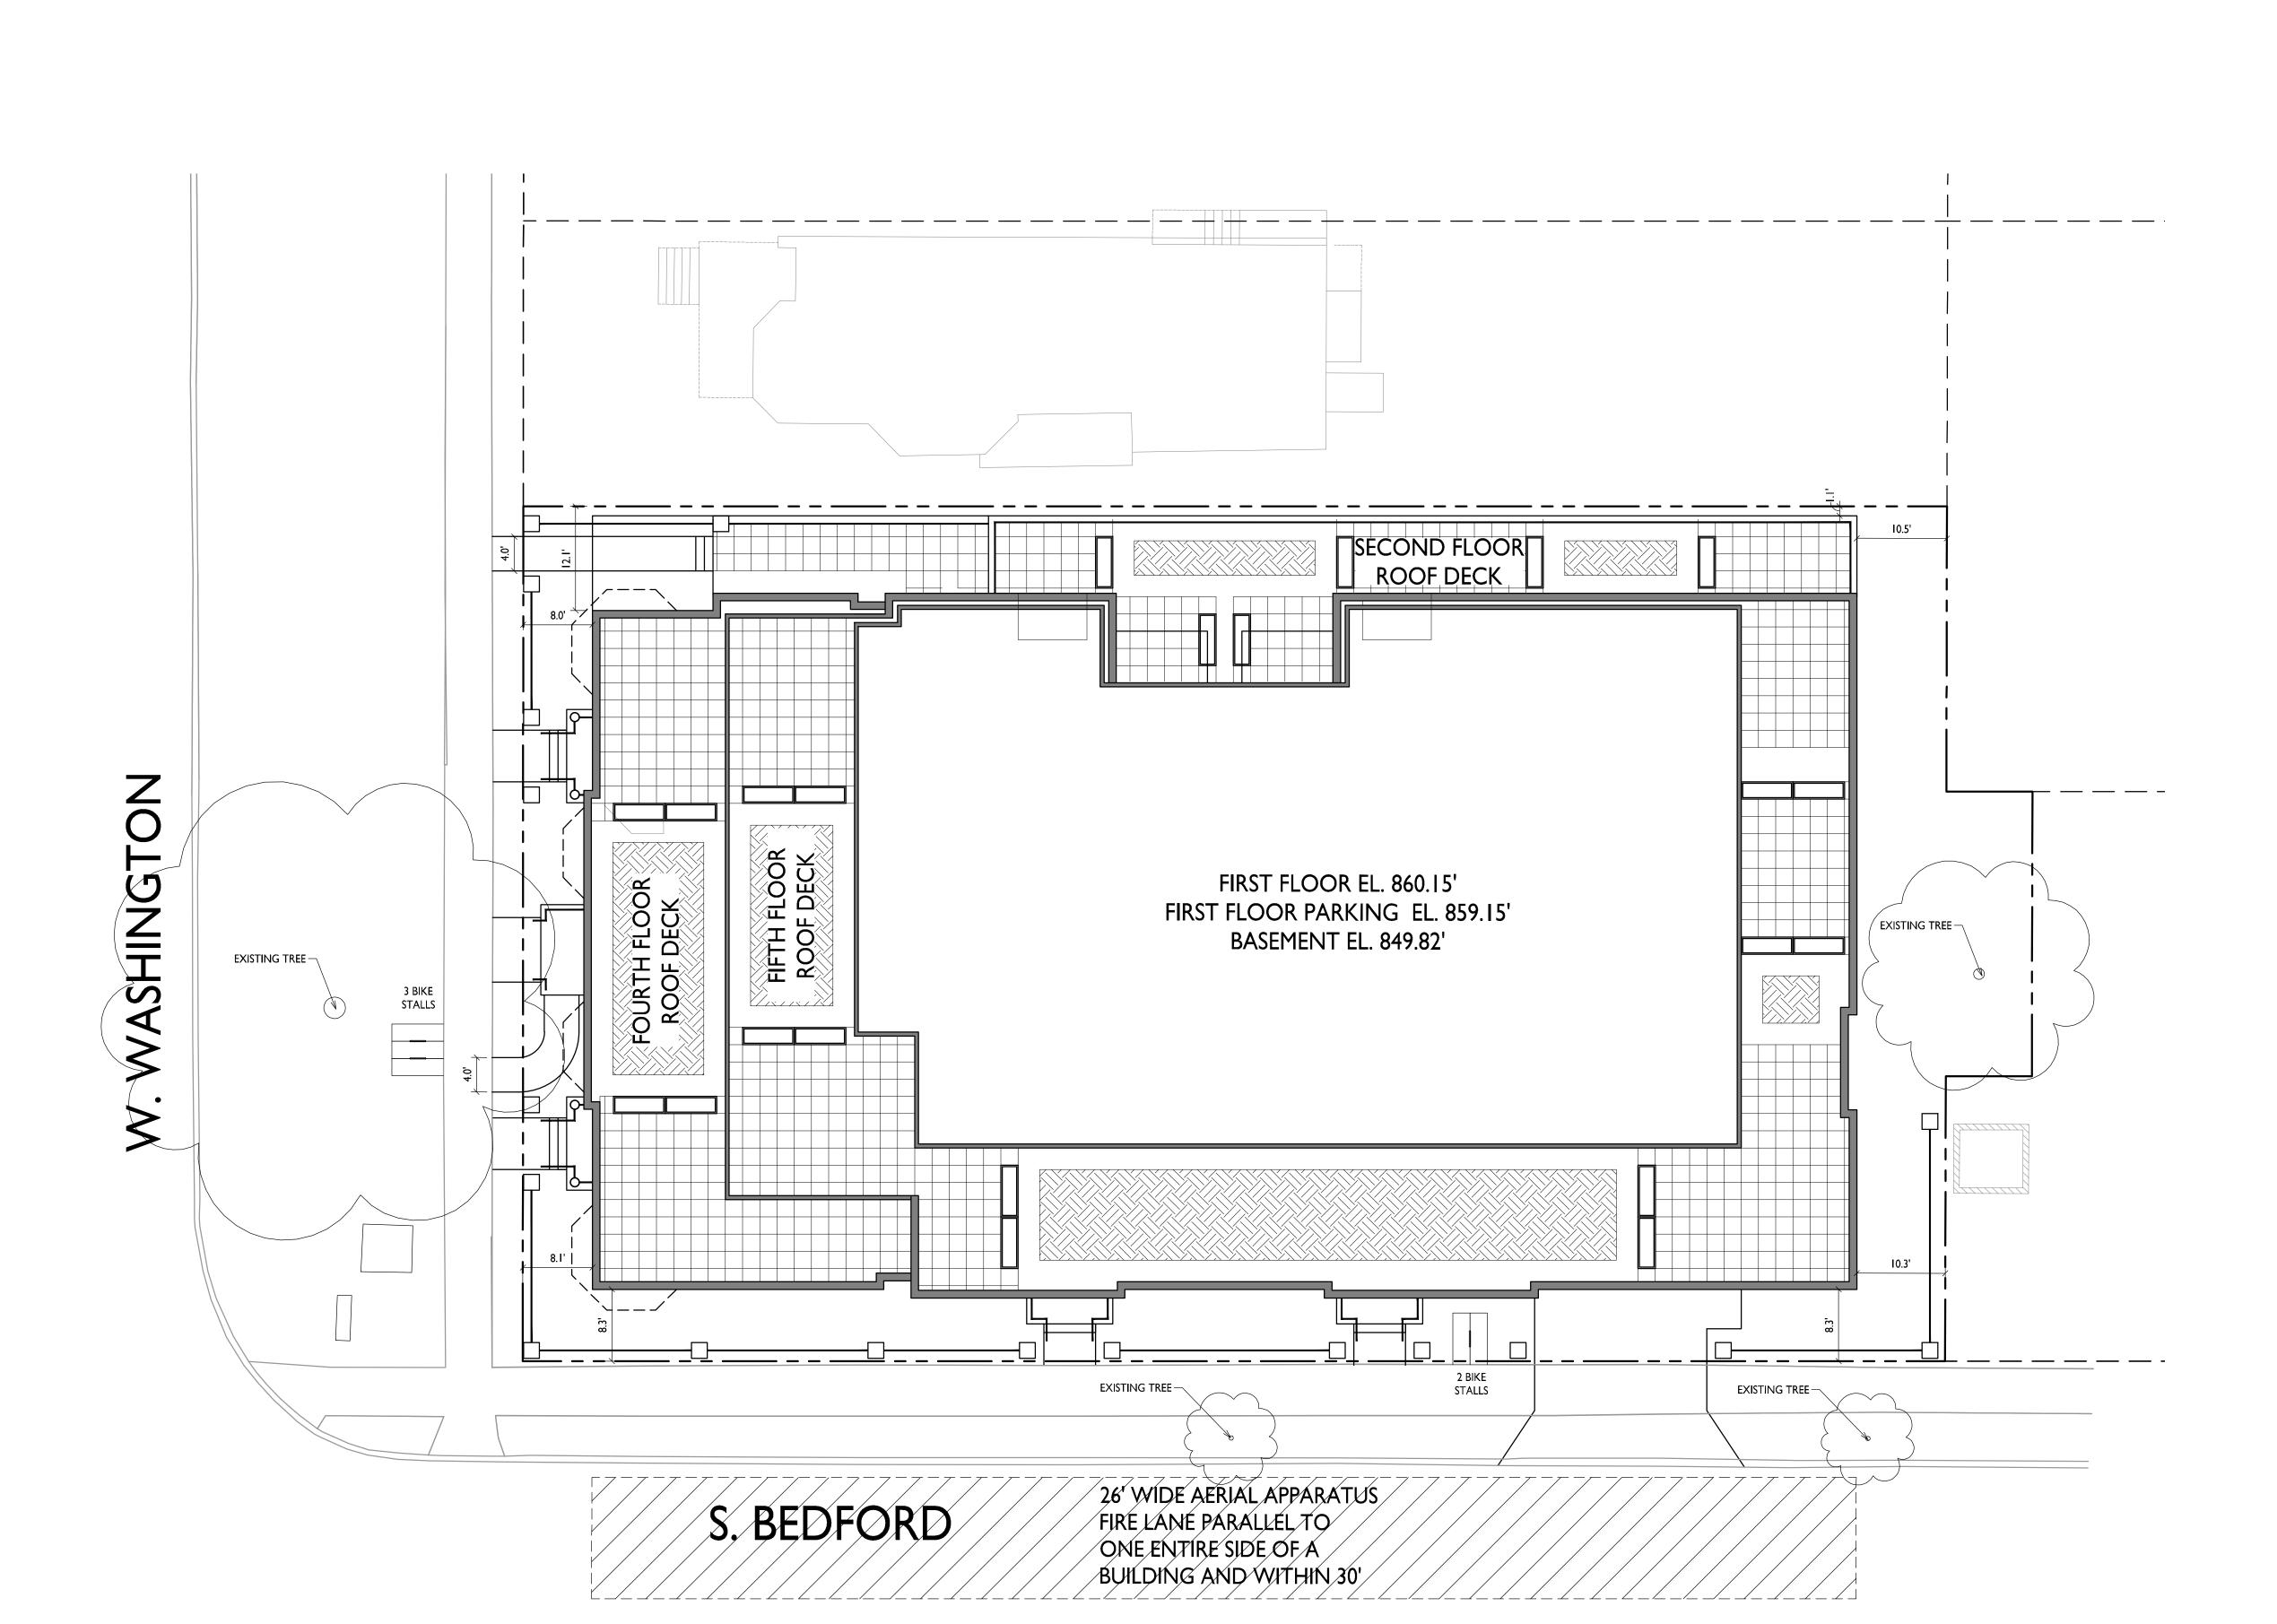555 W Washington Ave.


SHEET TITLE
Fire Department
Access Plan


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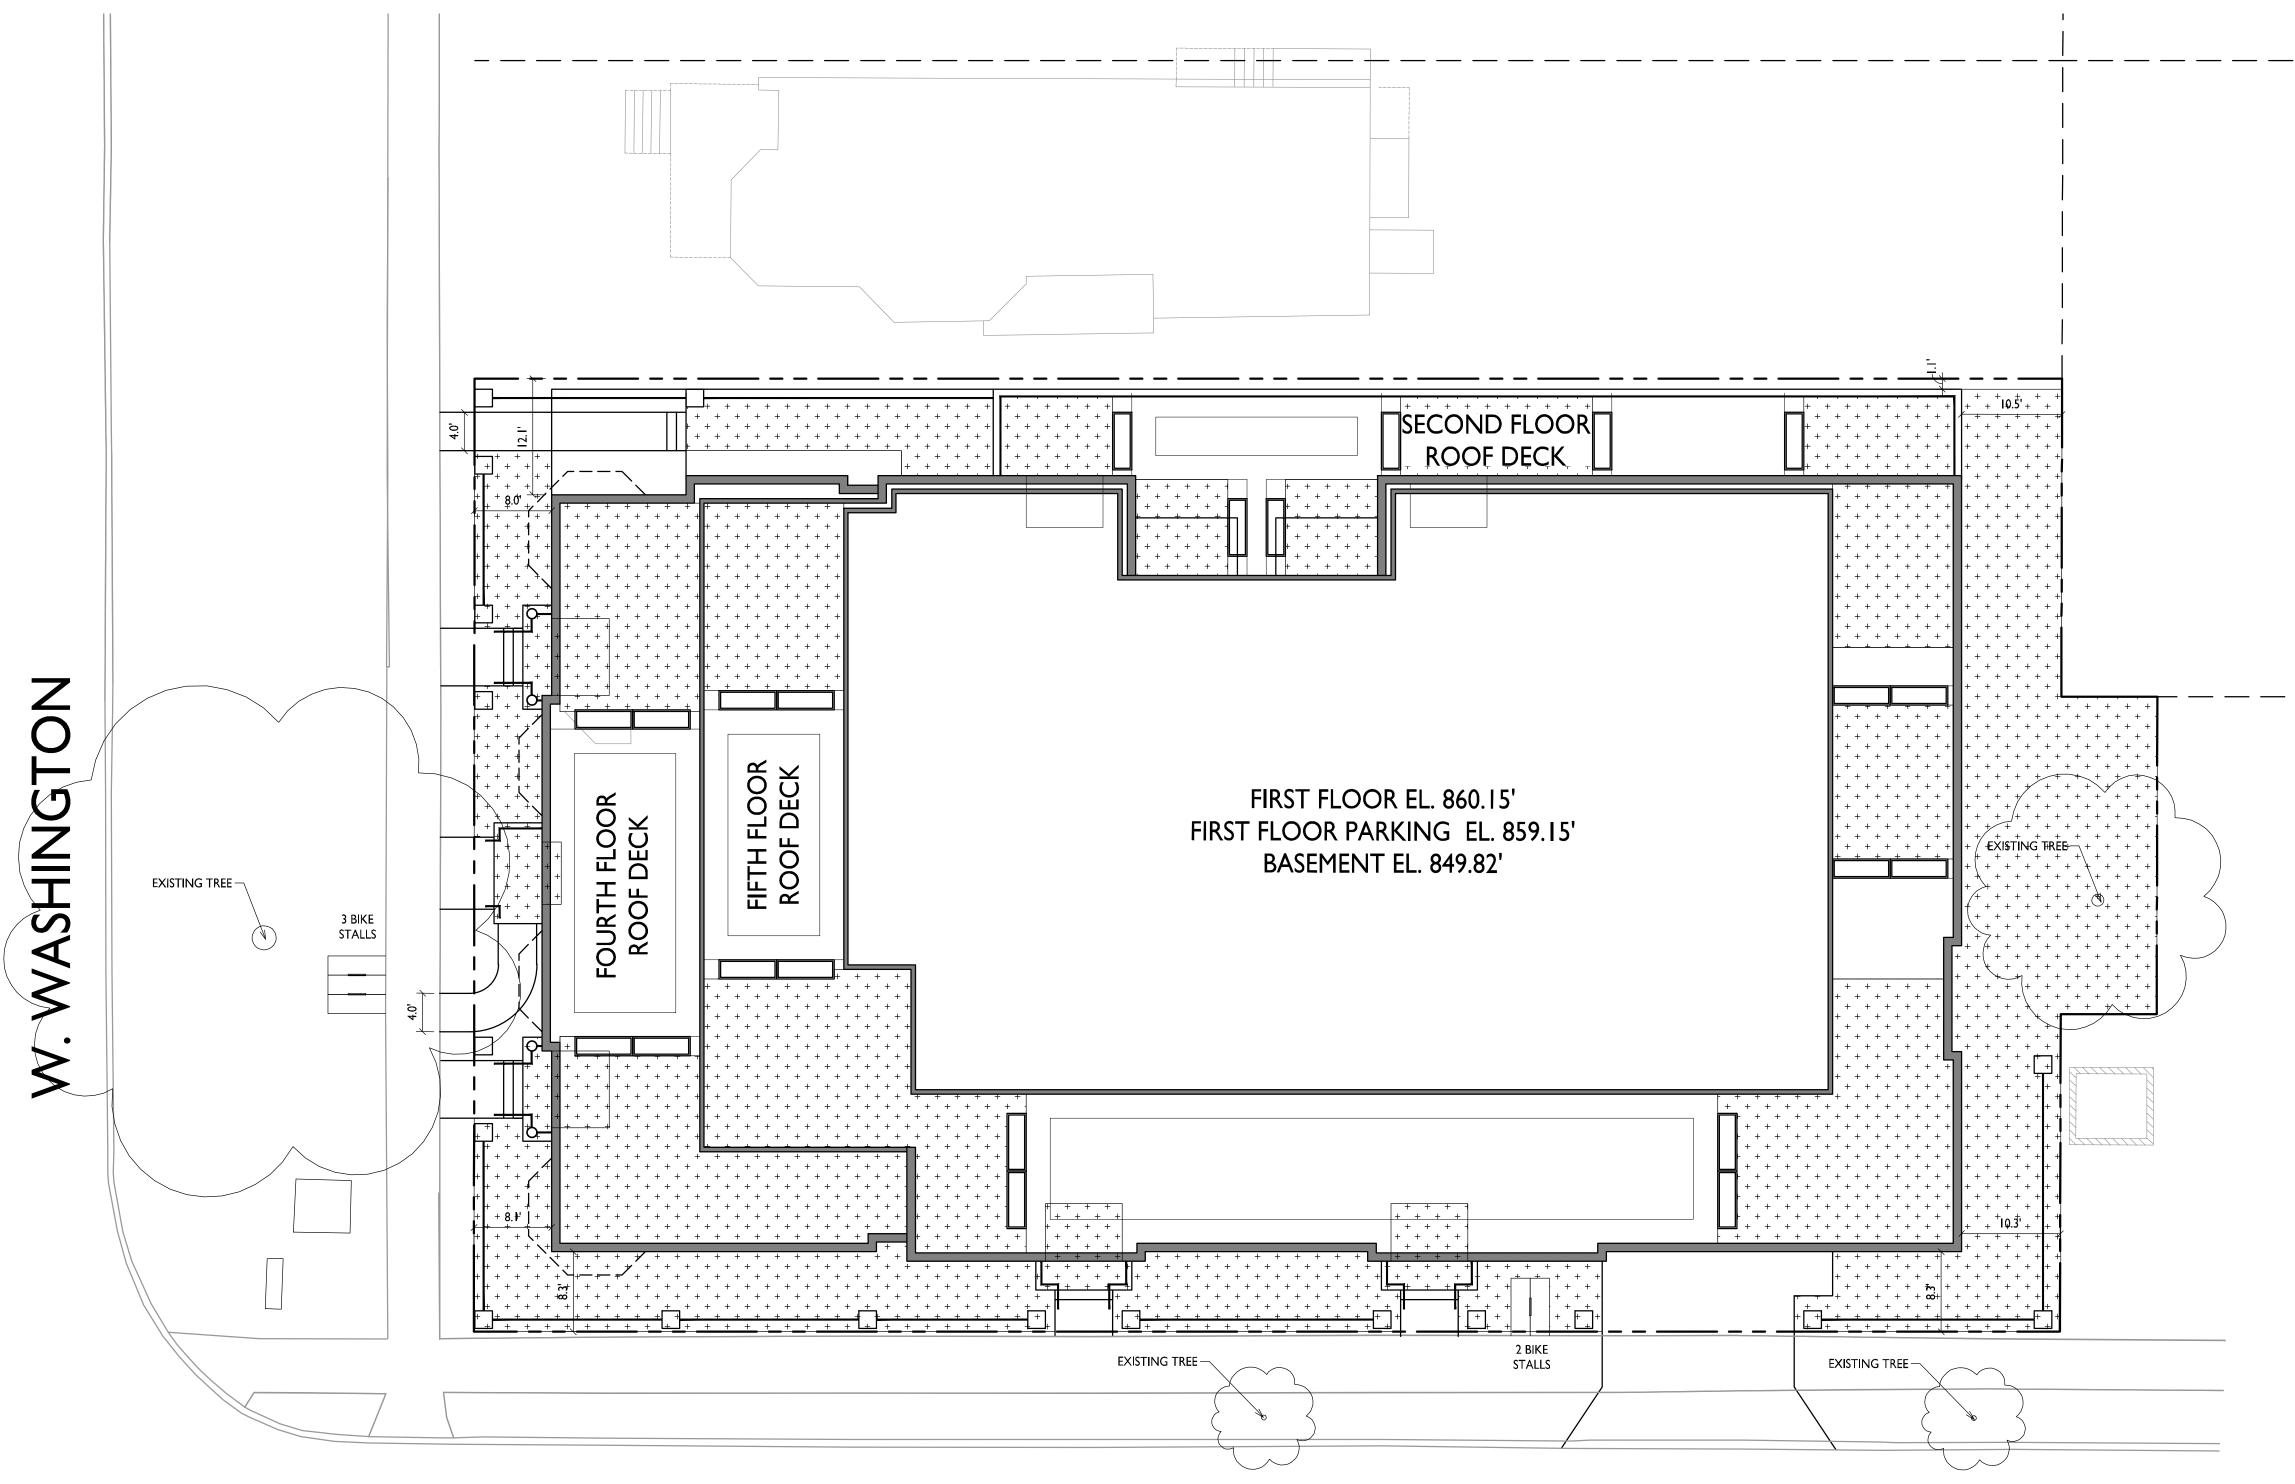
C-1.2

PROJECT NO. | 7 |
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**USABLE OPEN SPACE** 

**ZONING: UMX** 

REQUIRED OPEN SPACE: 10 S.F. / BEDROOM

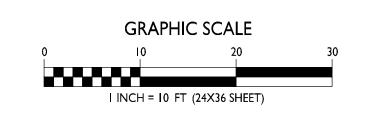DWELLING UNITS: 45 BEDROOMS: 57

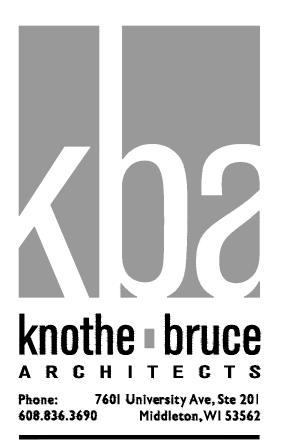10 X 57 = 570 S.F. OPEN SPACE REQUIRED

OPEN SPACE PROVIDED:

BALCONIES/ROOF TERRACES: 3,719 S.F.
SURFACE: 2,629 S.F.
TOTAL: 6,348 S.F.

ISSUED Issued for Land Use - June 20, 2018

PROJECT TITLE
BAXTER
West Washington
Development

555 W Washington Ave.

SHEET TITLE

Usable Open

SHEET NUMBER


Space


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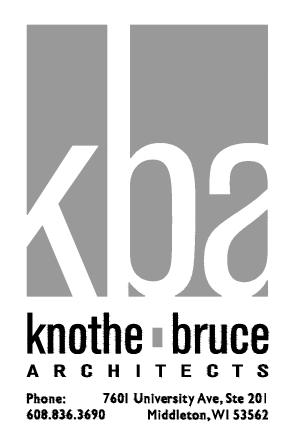
PROJECT NO. 7

S. BEDFORD





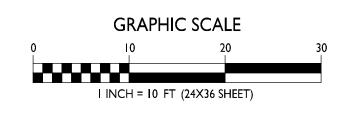

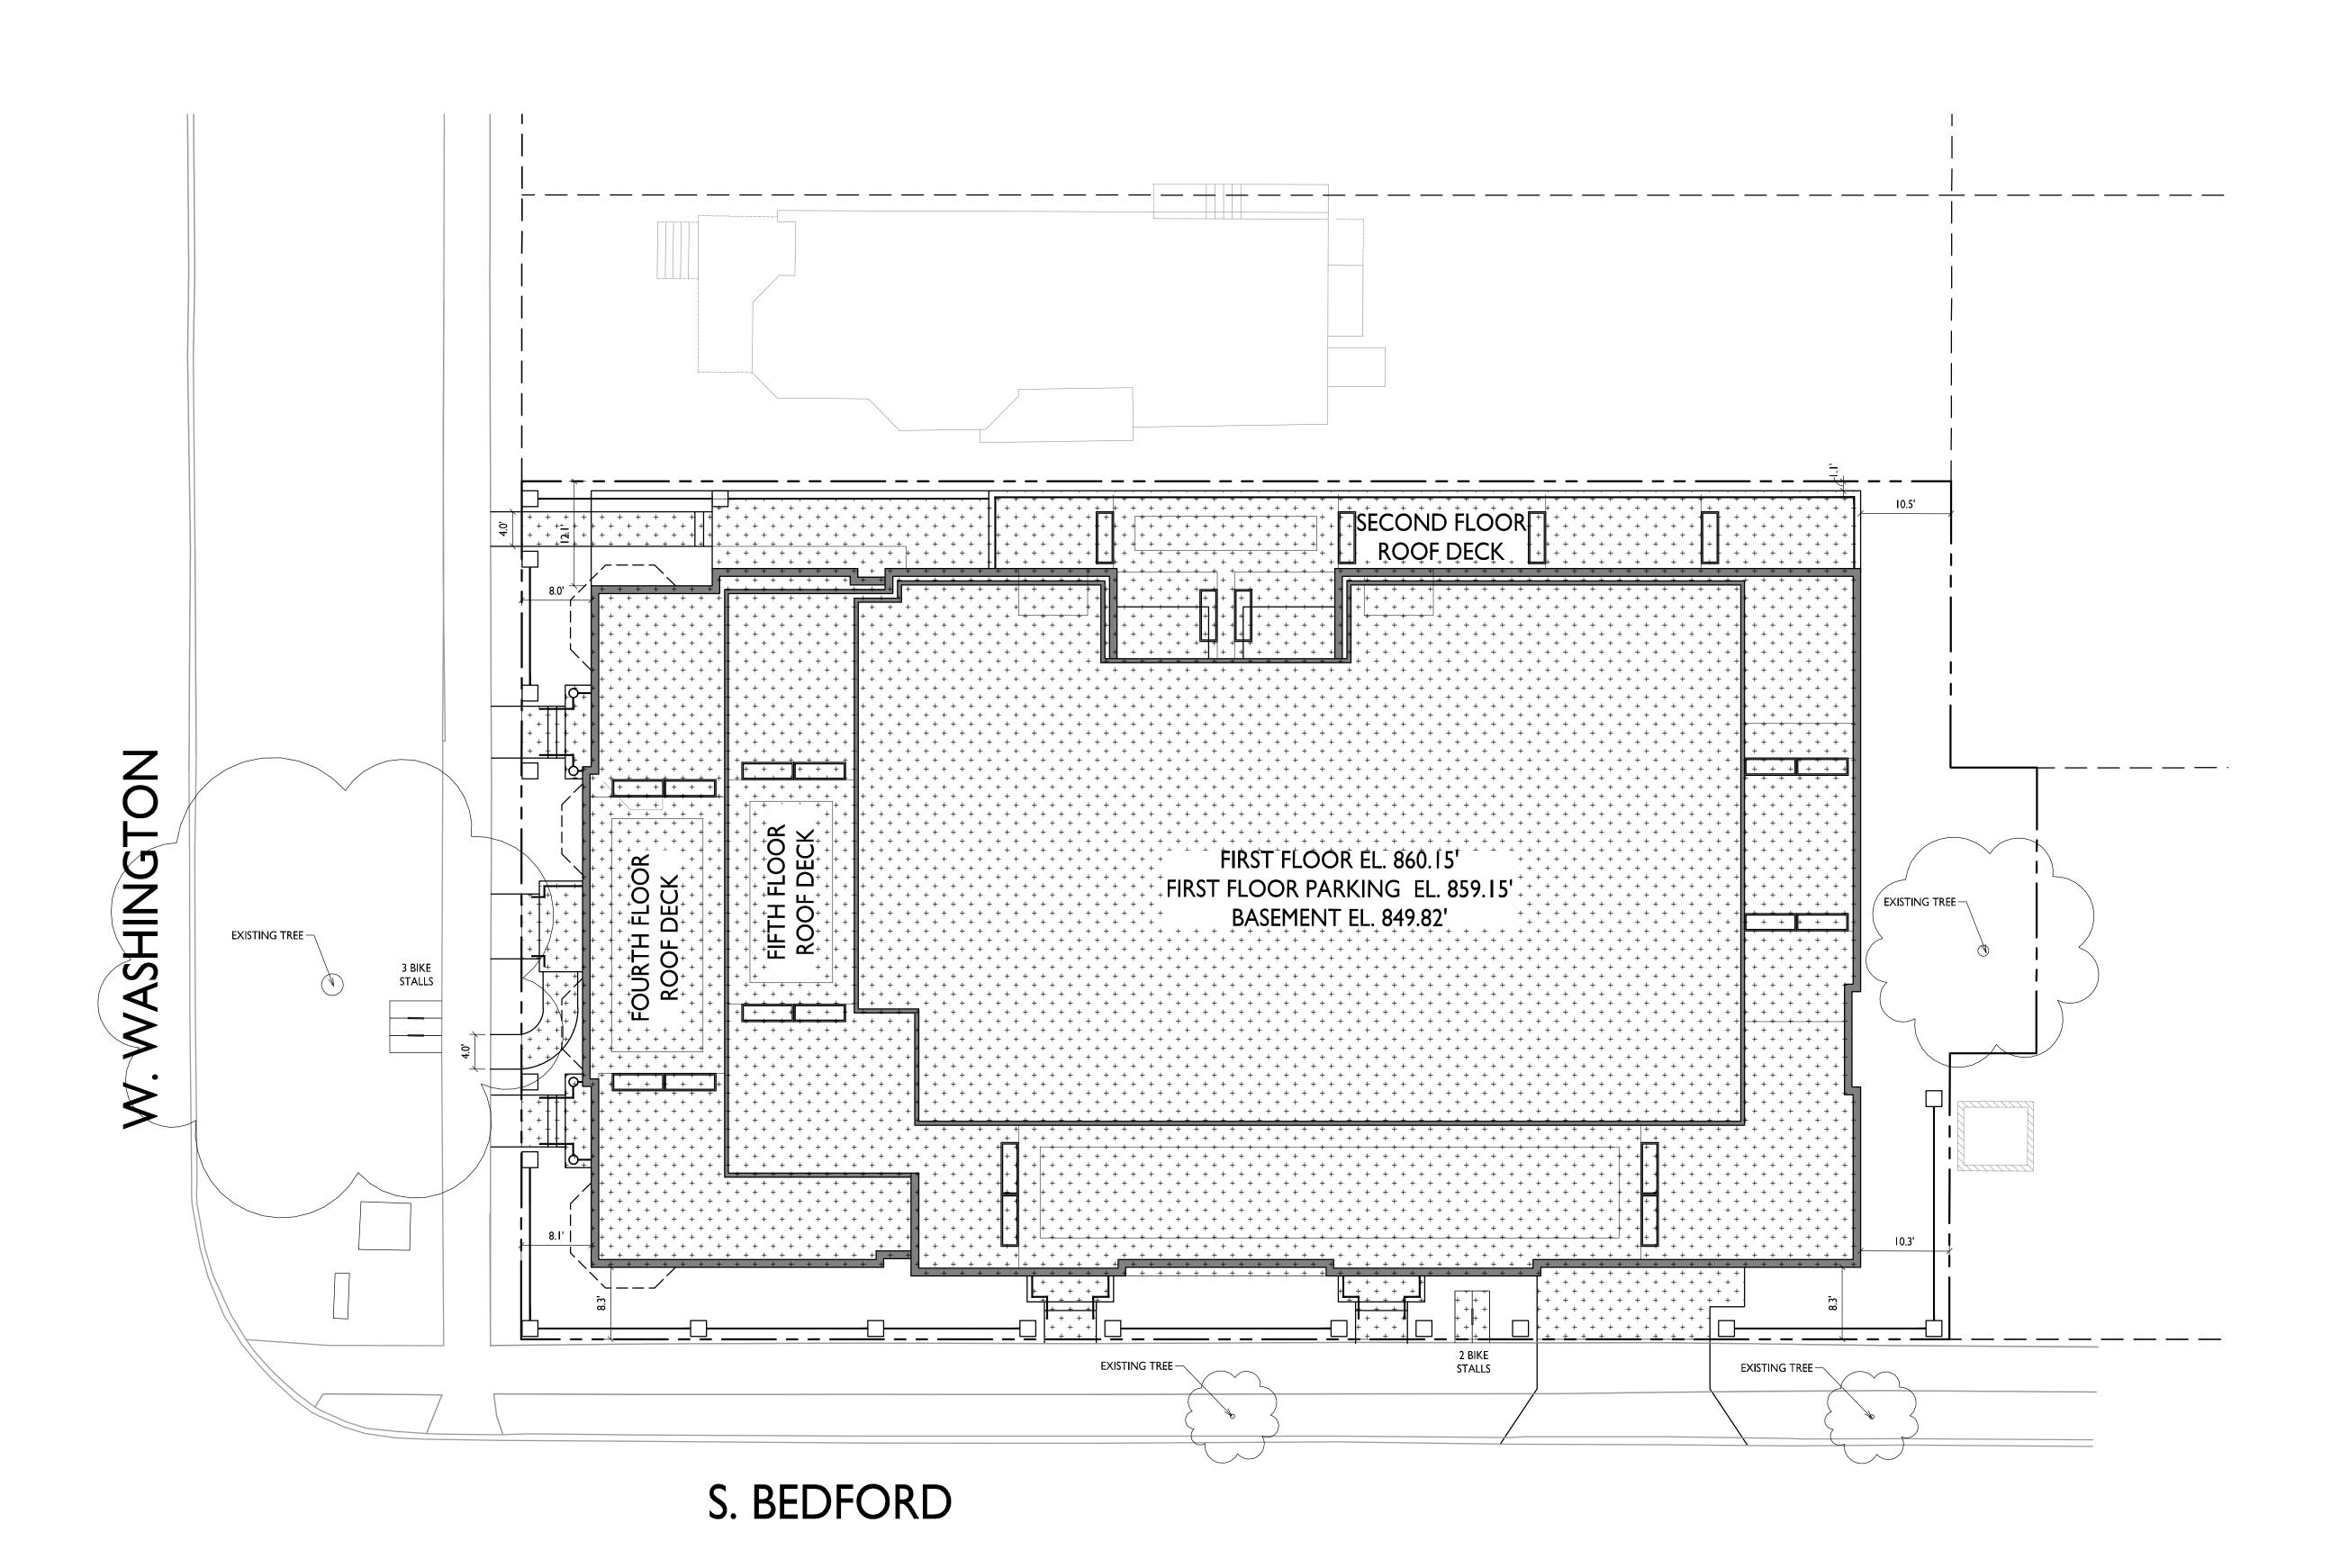

ISSUED
Issued for Land Use - June 20, 2018

PROJECT TITLE

SHEET TITLE

Lot Coverage


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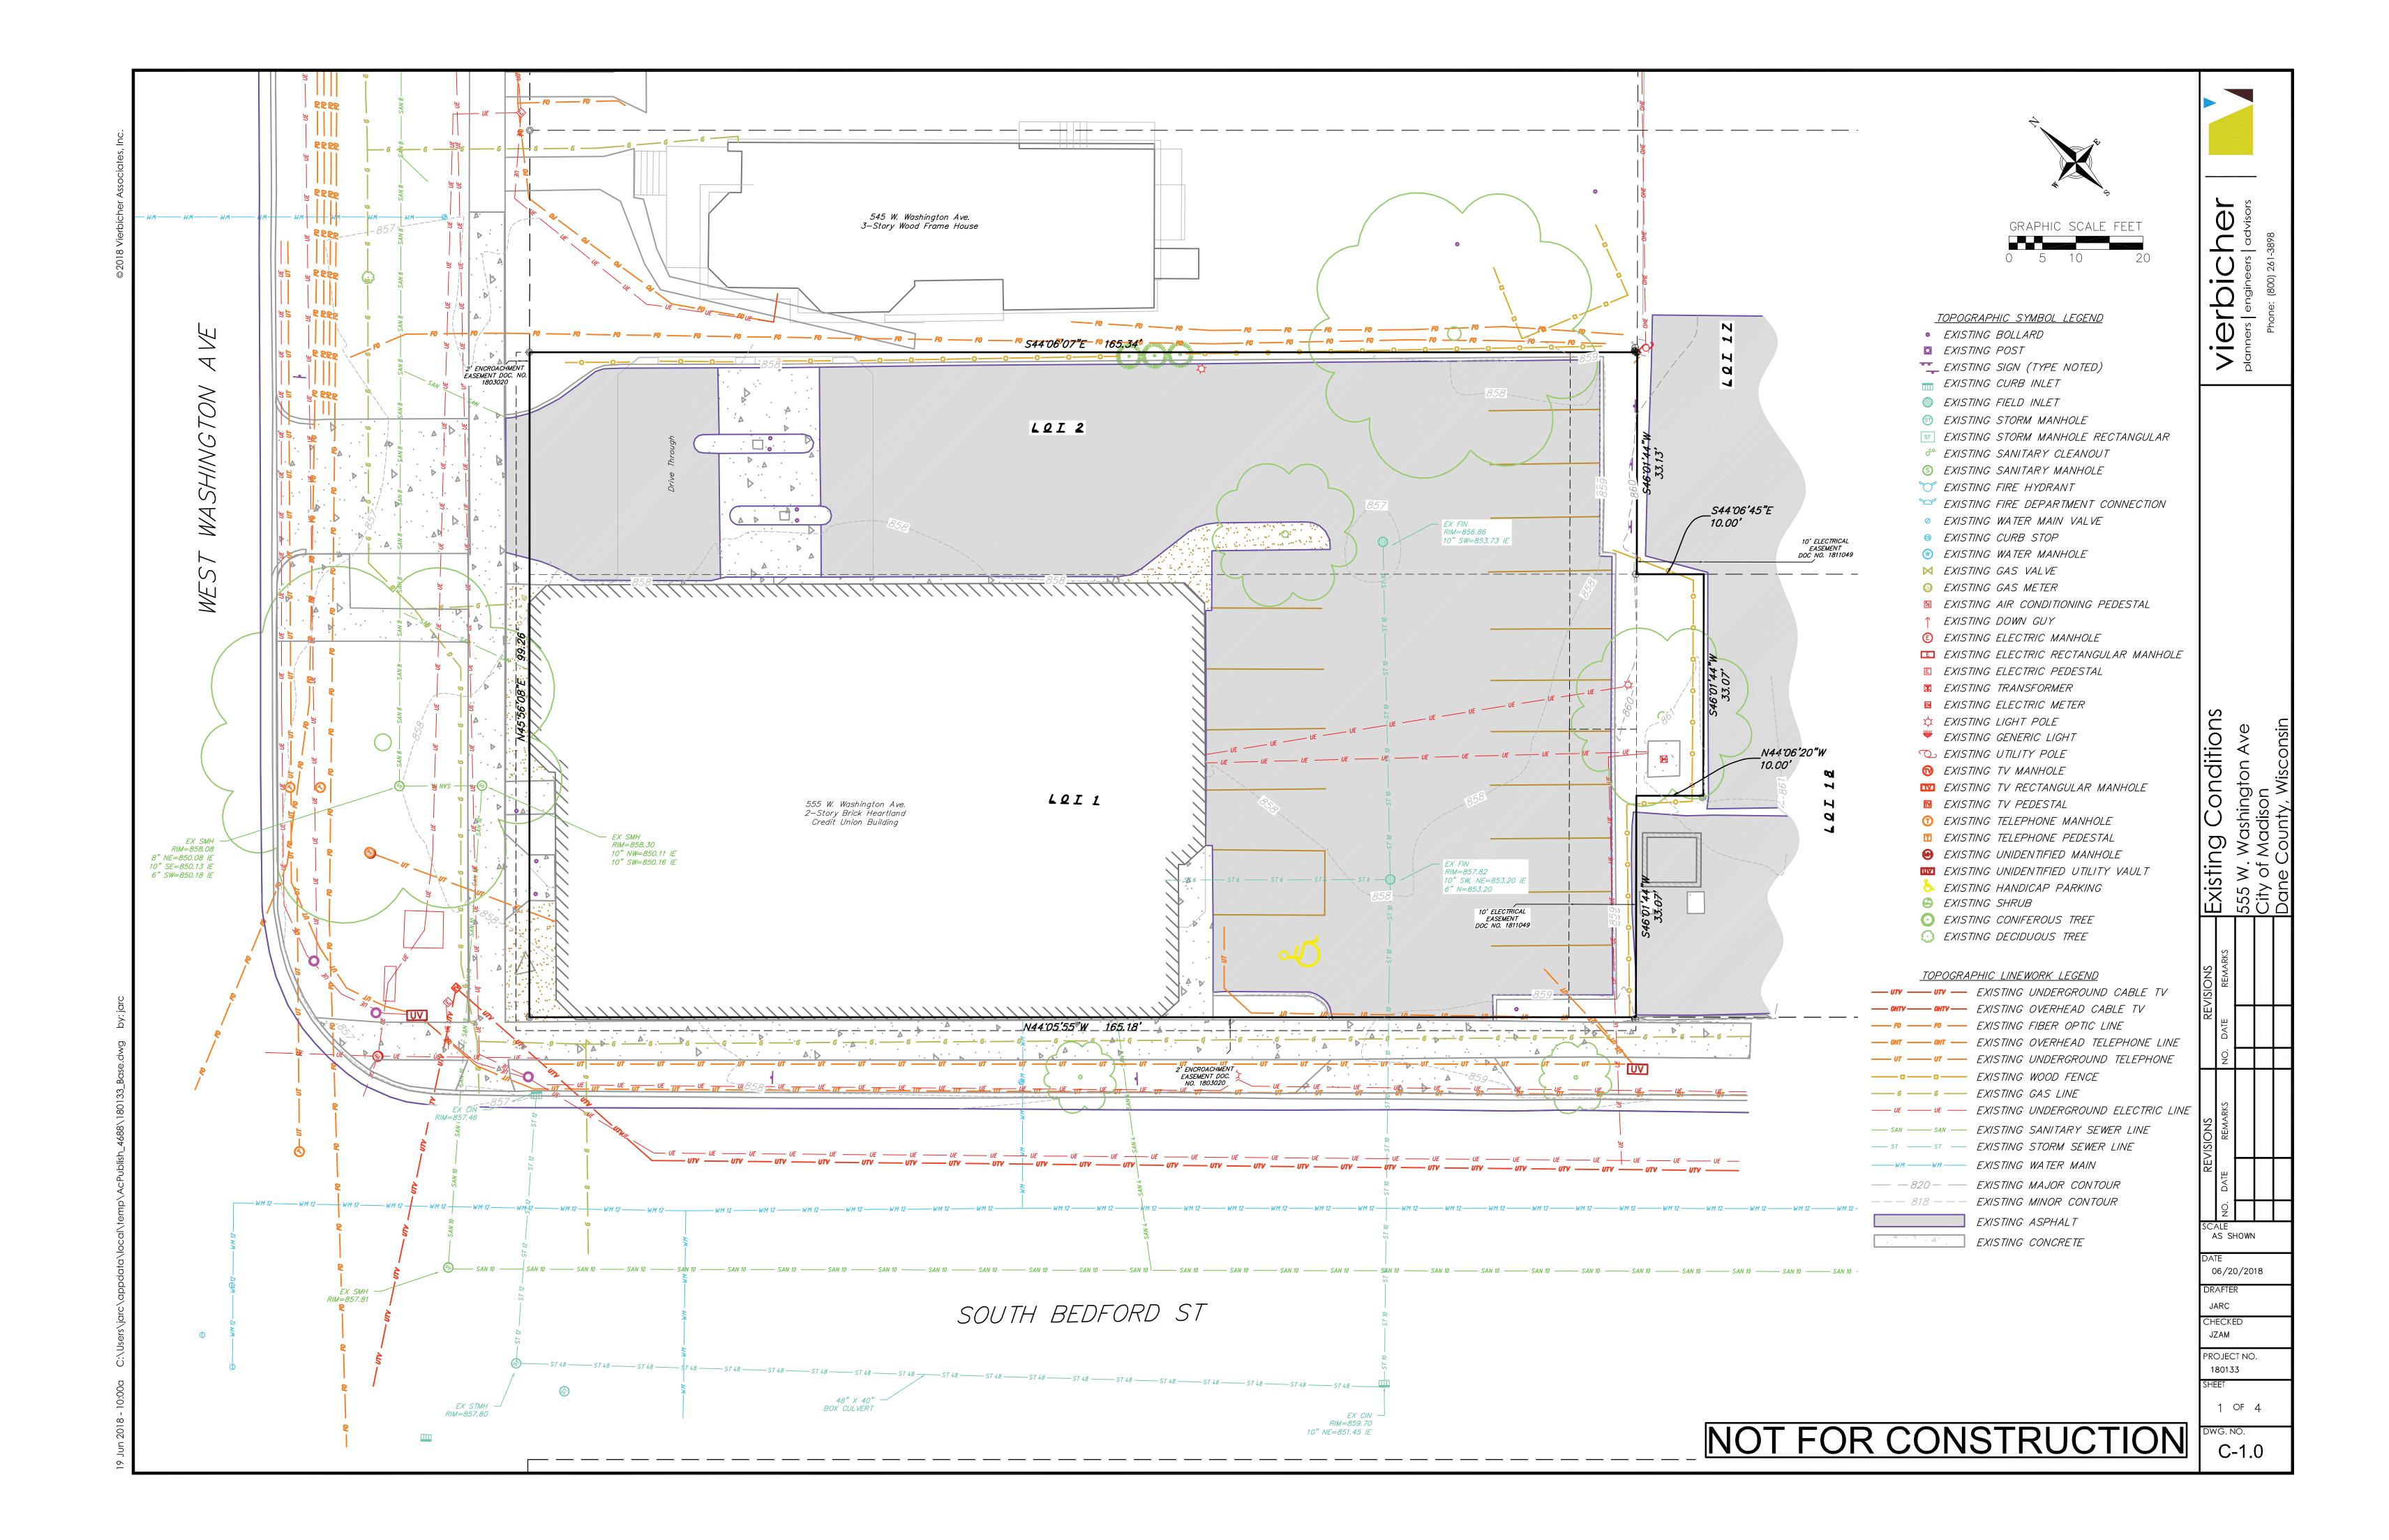
C-1.4


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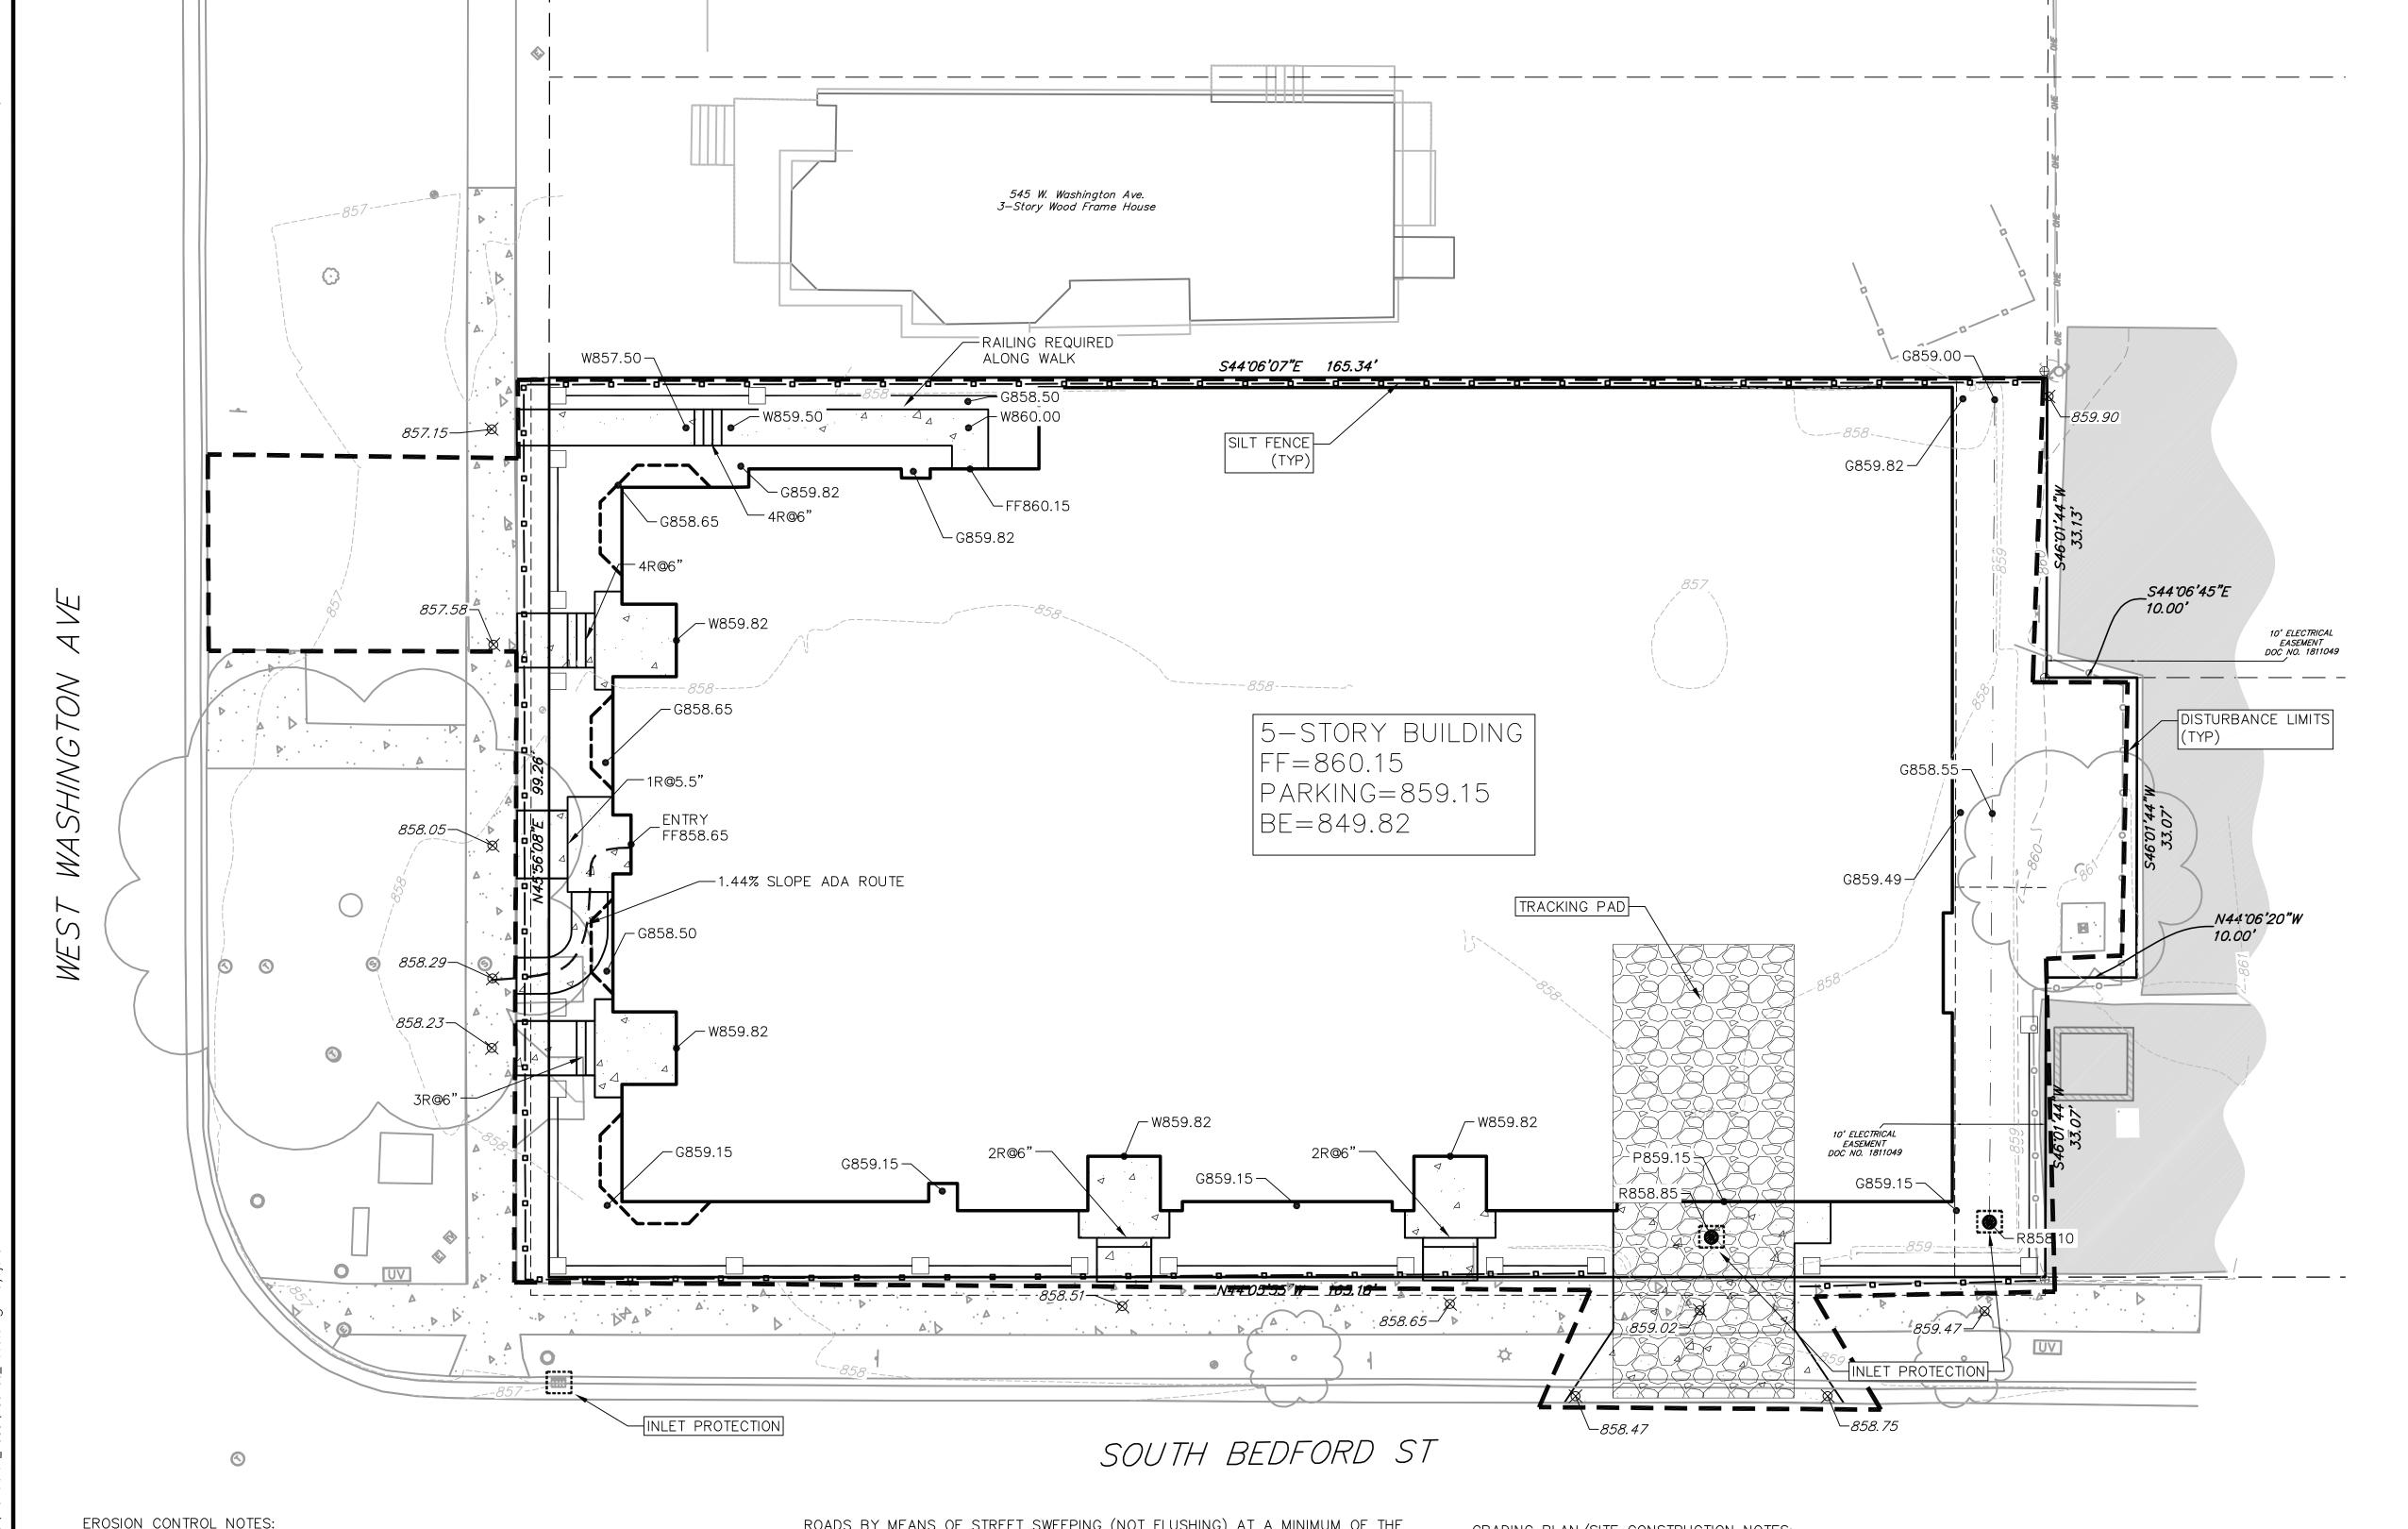
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GRAPHIC SCALE FEET

GRADING AND EROSION CONTROL LEGEND --820-- EXISTING MAJOR CONTOURS EXISTING MINOR CONTOURS

 DITCH CENTERLINE - SILT FENCE/SILT SOCK DISTURBED LIMITS - ADA ACCESSIBLE ROUTE DRAINAGE DIRECTION

2.92% PROPOSED SLOPE ARROWS EXISTING SPOT ELEVATIONS PROPOSED SPOT ELEVATIONS

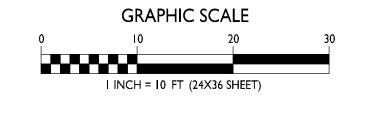INLET PROTECTION TRACKING PAD
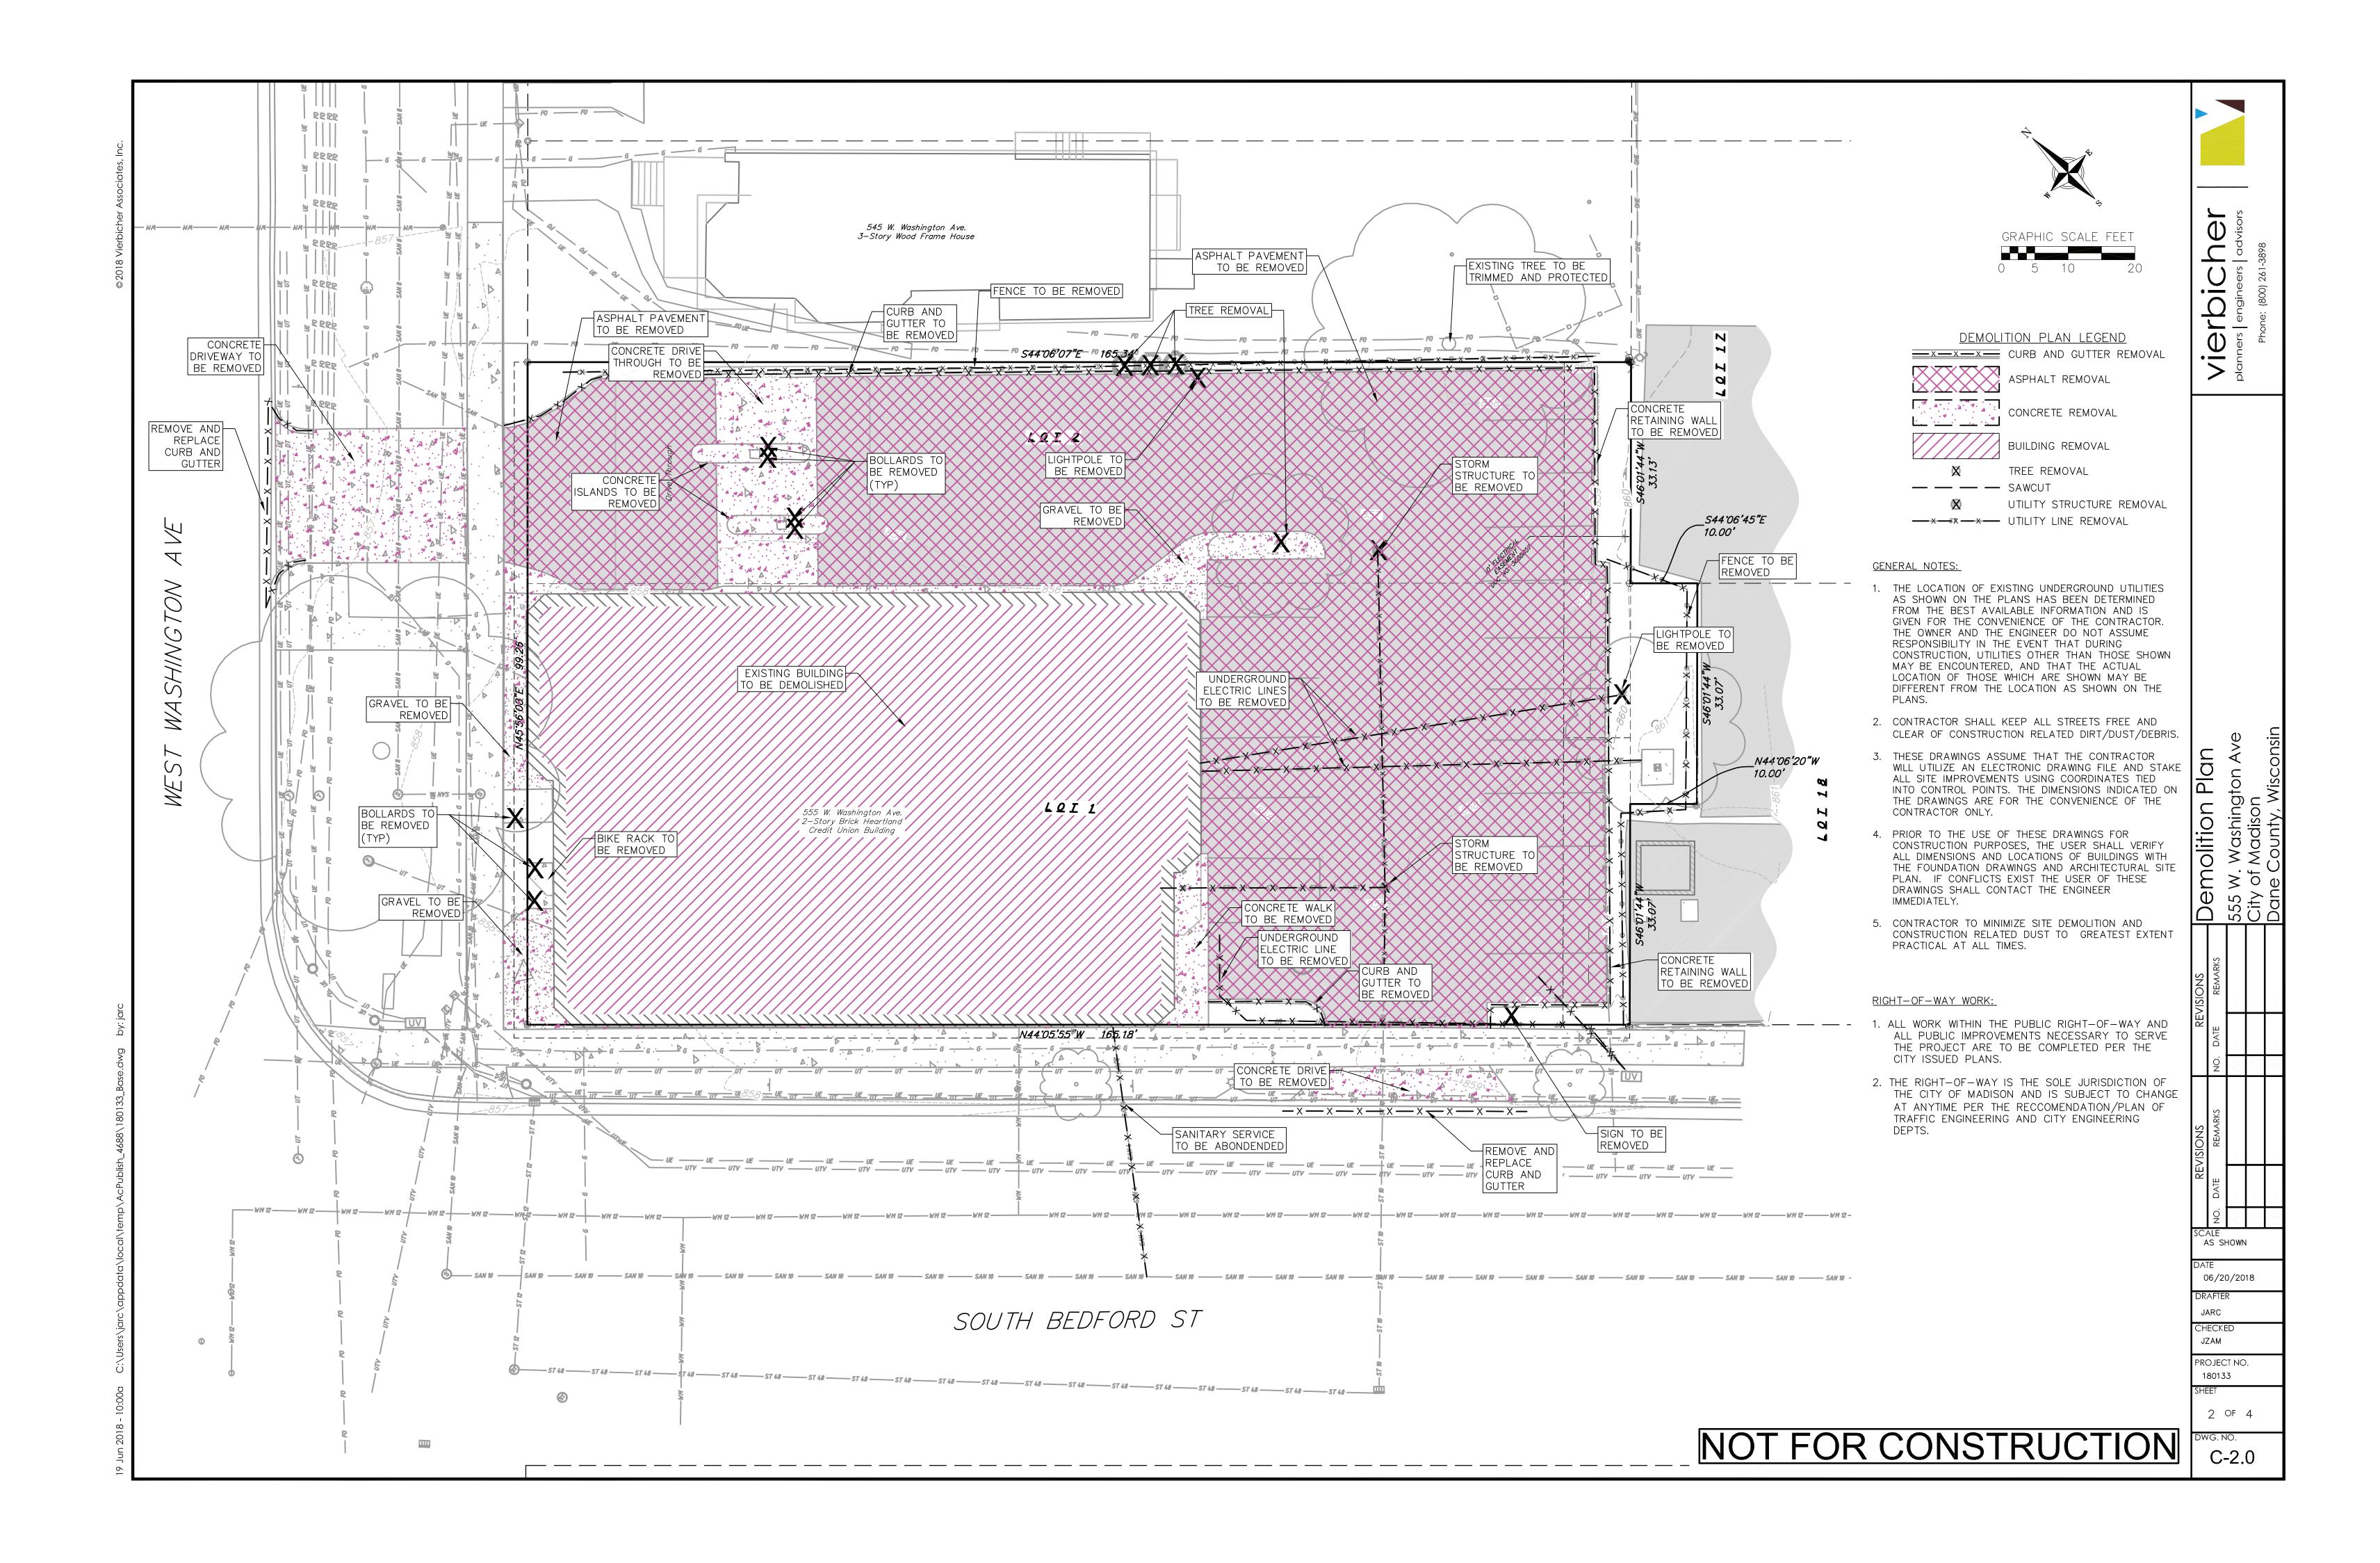
<u>ABBREVIATIONS</u> TC - TOP OF CURB

P - PAVEMENT
W - TOP OF WALK
R - RISER
FF - FINISHED FLOOR G — GROUND FF - FINISHED FLOOR
BE - BASEMENT ELEVATION
R - RIM

**EROSION CONTROL NOTES:** 

- 1. CONTRACTOR SHALL KEEP ALL CITY STREETS FREE AND CLEAR OF CONSTRUCTION RELATED DIRT/DUST/DEBRIS.
- 2. INSTALL A 50'L X 20'W X 1.5'D TRACKING PAD AT THE SITE ENTRANCE. THE TRACKING PAD SHALL BE MAINTAINED/REPAIRED AS NECESSARY TO ACCOMMODATE CONSTRUCTION.
- 3. THE CONTRACTOR IS REQUIRED TO MAKE EROSION CONTROL INSPECTIONS AT THE END OF EACH WEEK AND WHEN 0.5 INCHES OF RAIN FALLS WITHIN 24 HOURS. INSPECTION REPORTS SHALL BE PREPARED AND FILED AS REQUIRED BY THE DNR. ALL MAINTENANCE/REPAIR WILL FOLLOW AN INSPECTION WITHIN 24 HOURS.
- 4. INSTALL WISDOT TYPE D INLET PROTECTION IN EXISTING CURB INLETS AND WISDOT TYPE A IN FIELD INLETS.
- 5. ANY DAMAGE TO THE CITY PAVEMENT, INCLUDING DAMAGE RESULTING FROM CURB REPLACEMENT, WILL REQUIRE RESTORATION IN ACCORDANCE WITH THE CITY
- 6. THE CONTRACTOR SHALL REMOVE ANY SEDIMENT TRACKED ONTO ADJACENT

ROADS BY MEANS OF STREET SWEEPING (NOT FLUSHING) AT A MINIMUM OF THE END OF EACH WORK DAY OR MORE AS NEEDED.

7. SEE DETAIL SHEETS FOR ADDITIONAL EROSION CONTROL NOTES.

## RIGHT-OF-WAY WORK:

- 1. ALL WORK WITHIN THE PUBLIC RIGHT-OF-WAY AND ALL PUBLIC IMPROVEMENTS NECESSARY TO SERVE THE PROJECT ARE TO BE COMPLETED PER THE CITY ISSUED PLANS.
- 2. THE RIGHT-OF-WAY IS THE SOLE JURISDICTION OF THE CITY OF MADISON AND IS SUBJECT TO CHANGE AT ANYTIME PER THE RECCOMENDATION/PLAN OF TRAFFIC ENGINEERING AND CITY ENGINEERING DEPTS.

## GRADING PLAN/SITE CONSTRUCTION NOTES:

- 1. CONCRETE SIDEWALK TO BE 5" THICK, CONSTRUCTED ON A BASE OF 4" COMPACTED SAND OR CRUSHED STONE.
- 2. CONTRACTOR TO OBTAIN ANY NECESSARY UTILITY CONNECTION, DEMOLITION, DRIVEWAY CONNECTION, RIGHT-OF-WAY AND EXCAVATION PERMITS PRIOR TO CONSTRUCTION.
- 3. ANY SIDEWALK AND CURB & GUTTER ABUTTING THE PROPERTY SHALL BE REPLACED IF IT IS DAMAGED DURING CONSTRUCTION OR IF THE CITY ENGINEERING DEPARTMENT DETERMINES THAT IT IS NOT AT A DESIRABLE GRADE, REGARDLESS OF WHETHER THE CONDITION EXISTED PRIOR TO BEGINNING CONSTRUCTION.
- 4. TYPICAL SIDEWALK CROSS SECTION IS 1.5% SLOPE. THIS APPLIES TO ALL WALKWAYS IN THIS PLAN UNLESS OTHERWISE NOTED.

NOT FOR CONSTRUCTION

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Erosion


SCALE AS SHOWN

06/20/2018 JARC

CHECKED JZAM PROJECT NO. 180133

3 OF 4

C-3.0

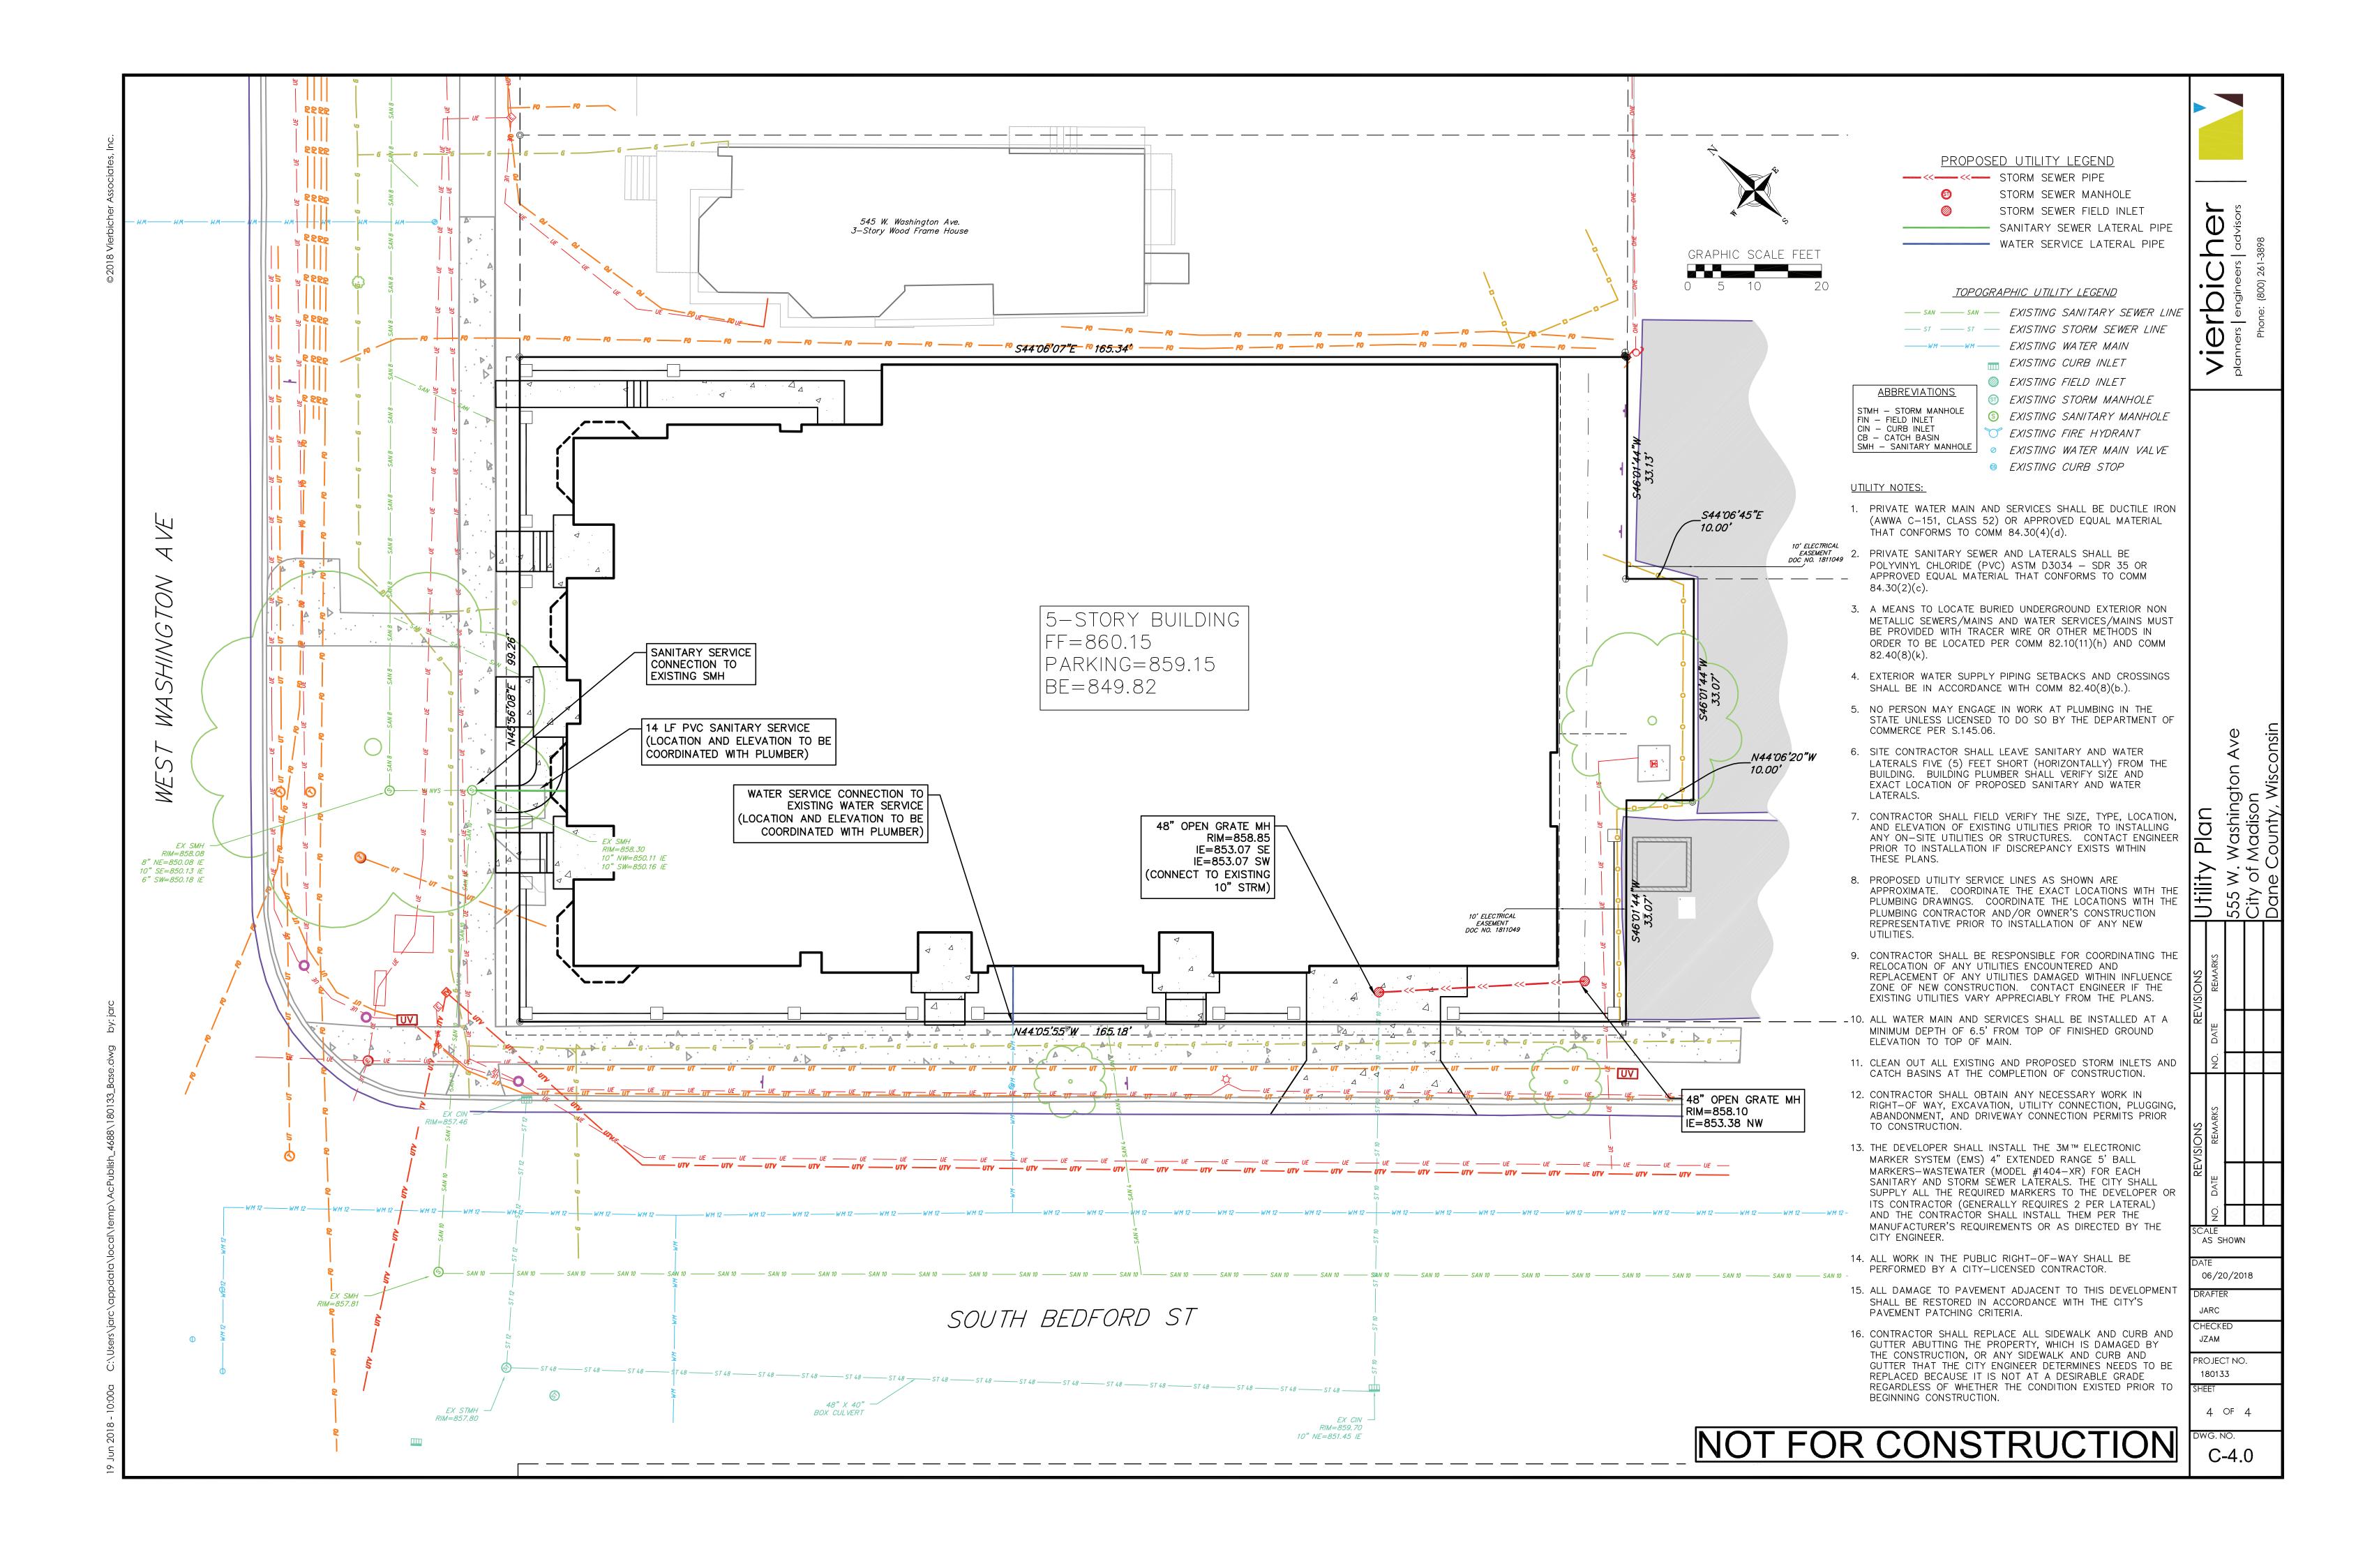

## **NOTES** 1. IT IS THE CONTRACTOR'S RESPONSIBILITY TO FIELD VERIFY SURVEY INFORMATION AND SITE CONDITIONS PRIOR TO START OF CONSTRUCTION AND REPORT ANY DISCREPANCIES. CONTRACTOR SHALL CONTACT DIGGER'S HOTLINE TO LOCATE ALL PUBLIC AND PRIVATE UTILITIES PRIOR TO START OF CONSTRUCTION. ANY DAMAGE CAUSED TO EXISTING UTILITIES, EITHER SHOWN OR NOT, SHALL BE REPAIRED AND PAID FOR AT THE CONTRACTOR'S EXPENSE. 2. CONTRACTOR SHALL PROTECT BENCHMARKS. 3. ALL TREES SHOWN TO BE RETAINED WITHIN THE PUBLIC RIGHT-OF-WAY SHALL BE PROTECTED DURING CONSTRUCTION WITH TREE PROTECTION FENCING. ALL TREE PROTECTION FENCING SHALL BE IN PLACE PRIOR TO ANY SITE WORK. PERFORM ALL WORK IN THE RIGHT-OF-WAY IN ACCORDANCE WITH CITY OF MADISON STANDARD 107.13 "TREE PROTECTION SPECIFICATION". 4. ALL EXISTING PLANT MATERIAL IS SHOWN AT EXISTING, APPROXIMATED SIZE PER CITY OF MADISON STANDARDS. 5. ALL WRAPPINGS, WIRE BASKETS, BURLAP, AND OTHER MISCELLANEOUS MATERIAL SHALL BE COMPLETELY REMOVED FROM ALL SHRUB AND TREE ROOT BALLS PRIOR TO INSTALLATION. 6. ALL LAWN AREAS DISTURBED BY CONSTRUCTION ACTIVITIES SHALL BE RE-SEEDED AT NO COST TO OWNER. 7. CONTRACTOR IS RESPONSIBLE FOR WATERING AND MAINTENANCE OF PLANT MATERIAL.

CONTRACTOR PER CITY STANDARD SPECIFICATIONS.

EXCAVATION IS PERMITTED WITHIN 5-FEET OF THE

10. CONTRACTOR SHALL INSTALL TREE PROTECTION FENCING IN THE AREA BETWEEN THE CURB AND SIDEWALK AND EXTEND IT AT LEAST 5-FEET FROM BOTH SIDES OF THE TREE ALONG THE LENGTH OF THE TERRACE. NO

OUTSIDE EDGE OF A TREE TRUNK. IF EXCAVATION WITHIN

5-FEET OF ANY TREE IS NECESSARY, CONTRACTOR SHALL CONTACT CITY FORESTRY (BRAD HOFMANN, 266-4816)

PRIOR TO EXCAVATION TO ASSESS THE IMPACT TO THE TREE AND ROOT SYSTEM. TREE PRUNING SHALL BE

COORDINATED WITH CITY FORESTRY PRIOR TO THE START

OF CONSTRUCTION. TREE PROTECTION SPECIFICATIONS

CAN BE FOUND IN SECTION 107.13 OF CITY OF MADISON

REQUIRED FOR CONSTRUCTION AFTER THE DEVELOPMENT

STANDARD SPECIFICATIONS FOR PUBLIC WORKS CONSTRUCTION. ANY TREE REMOVALS THAT ARE

8. ALL WORK IN THE PUBLIC RIGHT-OF-WAY SHALL BE PERFORMED BY A CITY LICENSED

9. CONTRACTOR SHALL OBTAIN PERMIT TO EXCAVATE IN THE PUBLIC RIGHT-OF-WAY.

555 West Washington					
Madison, WI					Development Frontage - South Bedford Street
20-Jun-18					Total LF of Street Frontage
Downtown & Urban Districts: Urban Mixed-Use (UMX) Zoni	ng				Between Parking/Building & Street
X 7					
				Landscape Points	Element
Developed Lots	SF	Acres		Subtotal	Overstory Deciduous Tree
Total Developed Area (Lot - Building Area)	4,113	0.09			Tall Evergreen Tree
Landscape Points (5 pts/300 SF for first 5 acres, 1 pt/100 SF fo	or additional)			69	Ornamental Tree
zarradospo i entre (e presede el fel met e sense, i por les el fi	, manufication,	Landeer	pe Points Requir		Upright Evergreen Shrub
		Landsca	ipe Folitis Requir	eu va	Shrub, deciduous
					Shrub, evergreen
			Overstory Trees		Ornamental Grass/Perennial
Development Frontage - West Washington Avenue	LF		Required *	Shrubs Required	
Total LF of Street Frontage					
Between Parking/Building & Street	82		3	14	General Site, Foundation, Screening
		Quantity	Quantity		
Element	Point Value	Proposed	Existing	Points Achieved	Element
Overstory Deciduous Tree	35			0	Existing Overstory Deciduous Tree (caliper " at DBH)
Tall Evergreen Tree	35			0	Overstory Deciduous Tree
Ornamental Tree	15	1		15	Tall Evergreen Tree
Upright Evergreen Shrub	10	1		10	Ornamental Tree
Shrub, deciduous	3	23		69	Upright Evergreen Shrub
Shrub, evergreen	4	6		36	Shrub, deciduous
Ornamental Grass/Perennial	2	68		136	Shrub, evergreen
		Development Fr	ontage Points To	tal 266	Ornamental Grass/Perennial
					Ornamental/Decorative Fence
					or Wall (4 pts/10 LF)

PROPOSED -

RAISED

**PLANTERS** 

PROPOSED 6' HT. \_


PRIVACY FENCE

\_<del>|boo|booooo</del>|\_

ent	Point Value	Proposed	Existing	Points Achieved	CUF	Carpinus caroliniana J.N. Upright	Fires
tory Deciduous Tree	35	Поросси	Lixroung	0	QC	Quercus robur 'Crimschmidt'	Crims
vergreen Tree	35			0		Evergreen Trees	
nental Tree	15	2		30	JT	Juniperus chinensis 'Trautman'	Traut
nt Evergreen Shrub	10	4		40	-	Deciduous Shrubs	111200
, deciduous	3	27		81	Aml	Aronia melanocarpa Low Scape Mound	Low S
, evergreen	4	22		88			+
nental Grass/Perennial	2	230		460	Hq	Hydrangea quercifolia 'Pee Wee'	Oakle
		Development Fr	rontage Points Total	699	Pdm	Physocarpus opulifolius 'Donna May'	Little
					Sbt	Spiraea betulifolia 'Tor'	Birchl
eral Site, Foundation, Screening						Evergreen Shrubs	
					Jpk	Juniperus chinensis 'Pfitzeriana Kallay'	Kallay
		Quantity	Quantity		Js	Juniperus sabina `Buffalo`	Buffal
ent	Point Value	Proposed	Existing	Points Achieved	Tmt	Taxus x media `Tauntonii`	Tauto
ng Overstory Deciduous Tree (caliper " at DBH)	14		1	14	11112	Perennials/Grasses/Groundcovers	Tauto
tory Deciduous Tree	35		4	140	1-		-
vergreen Tree	35			0	asb	Allium tanguticum `Summer Beauty`	Summ
nental Tree	15			0	abi	Amsonia tabernaemontana `Blue Ice`	Blue
nt Evergreen Shrub	10			0	acs	Aralia cordata `Sun King`	Sun Ki
, deciduous	3	21		63	expm	Echinacea x 'Pixie Meadowbrite'	Pixie
, evergreen	4	16		64	gck	Geranium x cantabrigiense `Karmina`	Bioko
nental Grass/Perennial	2	72		144	hmr	Heuchera x `Midnight Rose`	Coral
nental/Decorative Fence ill (4 pts/10 LF)	4	20.5		82	hbc	Hosta x `Blue Cadet`	Planta
iii (4 pts/10 Li )	1 4		l Ition Plantings Total		hgs	Hosta x `Gold Standard`	Gold S
		Tourida	idon riantings rotal	301	-		
	Г	TOTAL	ANDSCAPE POINTS	1472	Isk	Liatris spicata `Kobold`	Kobol
		TOTAL L	ANDSCAPE POINTS	1472	nk	Nepeta x faassenii `Kit Kat`	Kit Ka
ases where development frontage landscaping cannot b	pdd	Penstemon digitalis 'Dark Towers'	Beard				
ed due to site constraints, the zoning administrator ma the requirement or substitute alternative screening met	*				rfv	Rudbeckia fulgida speciosa 'Viette's Little Suzy'	` Black-
the requirement of substitute alternative screening men	illous					Caluia namanasa 'Caradanas'	Canda

* In d	ases where development frontage landscaping cannot be
	ded due to site constraints, the zoning administrator may
waive	the requirement or substitute alternative screening method
for th	e required landscaping.

Kev	PLANT LIST  Botanical Name	Common Name	Quantity	Size	Spec	Comments	Mature Size
,	Deciduous Trees	- Commonwant	Quarterty	0.20	Opec	Comments	Triduic Size
ARH	Amelanchier x grandiflora 'Robin Hill'	Robin Hill Serviceberry	2	2" Cal.	B&B	Upright multi-stem	20-25' ht x 12-15' sp
CCF	Carpinus caroliniana 'J.N. Upright'	Firespire Musclewood	1	2" Cal.	B&B	Upright multi-stem	20' ht x 8-10' sp
QC	Quercus robur 'Crimschmidt'	Crimson Spire English Oak	4	2" Cal.	B&B	Single, straight leader	45' ht x 15' sp
	Evergreen Trees	*					
IT	Juniperus chinensis 'Trautman'	Trautman Juniper	5	5' Ht.	в&в		12' ht x 4' sp
	Deciduous Shrubs						
4ml	Aronia melanocarpa Low Scape Mound	Low Scape Mound Aronia	20	2 Gal.	Cont.	Space 2'-0" o.c.	1-2' ht x 2-3' sp
Hq	Hydrangea quercifolia 'Pee Wee'	Oakleaf Hydrangea	24	2 Gal.	Cont.	Space 2.5'-0" o.c	2-4' ht x 2-3' sp
Pdm	Physocarpus opulifolius 'Donna May'	Little Devil Ninebark	12	2 Gal.	Cont.	Space 2.5'-0" o.c	3-4' ht x 3-4' sp
Sbt	Spiraea betulifolia 'Tor'	Birchleaf Spirea	22	2 Gal.	Cont.	Space 2'-0" o.c.	2-3' ht x 2-3' sp
	Evergreen Shrubs						
lpk	Juniperus chinensis 'Pfitzeriana Kallay'	Kallays Compact Pfitzer Juniper	25	2 Gal.	Cont.	Space 3.5'-0" o.c.	3' ht x 6-8' sp
ls	Juniperus sabina `Buffalo`	Buffalo Juniper	5	2 Gal.	Cont.	Space 4'-0" o.c.	1' ht x 4-6' sp
Tmt	Taxus x media `Tauntonii`	Tauton Yew	28	2 Gal.	Cont.	Space 4'-0" o.c.	3-5' ht x 6-8' sp
	Perennials/Grasses/Groundcovers						
asb	Allium tanguticum 'Summer Beauty'	Summer Beauty Allium	185	4-Inch	Pot	Space 1'-0" o.c.	1-1.5' ht x 1.5-2' sp
abi	Amsonia tabernaemontana 'Blue Ice'	Blue Ice Blue Star	11	4-Inch	Pot	Space 1.5'-0" o.c.	1-1.5' ht x 1.5-2' sp
acs	Aralia cordata 'Sun King'	Sun King Aralia	6	2 Gal.	Cont.	Space 3'-0" o.c.	3-4' ht x 3-4' sp
expm	Echinacea x 'Pixie Meadowbrite'	Pixie Meadowbrite Purple Coneflower	74	4-Inch	Pot	Space 1.5'-0" o.c.	1.5-2' ht x 1.5-2' sp
zck	Geranium x cantabrigiense 'Karmina'	Biokovo Cranesbíll	40	4-Inch	Pot	Space 1.5'-0" o.c.	.5-1' ht × .5-1' sp
hmr	Heuchera x `Midnight Rose`	Coral Bells	9	4-Inch	Pot	Space 1'-0" o.c.	1-2' ht x 1-1.5' sp
hbc	Hosta x `Blue Cadet`	Plantain Lily	23	4-Inch	Pot	Space 1.5'-0" o.c.	1' ht x 2-3' sp
hgs	Hosta x `Gold Standard`	Gold Standard Plantain Lily	20	4-Inch	Pot	Space 2'-0" o.c.	2-3' ht x 2' sp
lsk	Liatris spicata 'Kobold'	Kobold Spike Gayfeather	28	4-Inch	Pot	Space 1'-0" o.c.	1.5-3' ht x 1.5-2' sp
nk	Nepeta x faassenii `Kit Kat`	Kit Kat Catmint	18	4-Inch	Pot	Space 2'-0" o.c.	1' ht x 2' sp
bbc	Penstemon digitalis 'Dark Towers'	Beard-tongue	14	4-Inch	Pot	Space 1.5'-0" o.c.	3-4' ht x 1.5-2' sp
f∨	Rudbeckía fulgida speciosa 'Víette's Little Suzy'	Black-Eyed Susan	24	4-Inch	Pot	Space 1'-0" o.c.	2-3' ht x 1.5-2' sp
snc	Salvia nemorosa 'Caradonna'	Cardonna Sage	18	4-Inch	Pot	Space 1.5'-0" o.c.	2-2.5' ht x 1.5' sp
nm	Salvia nemorosa 'Marcus'	Woodland Sage	8	4-Inch	Pot	Space 1.5'-0" o.c.	8-12" ht x 1.5' sp
sa	Sesleria autumnalis	Autumn Moor Grass	31	1 Gal.	Cont.	Space 1'-0" o.c.	1-1.5' ht x 1-1.5' sp

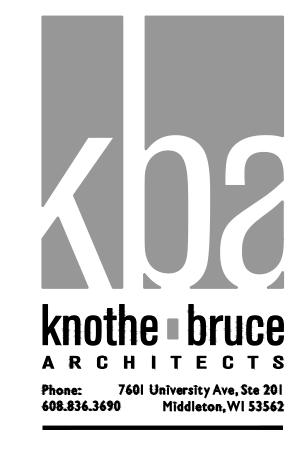



**ISSUED** Issued for Review - June 20,





PROJECT TITLE BAXTER West Washington Development


555 W Washington Ave. SHEET TITLE Landscape Plan


SHEET NUMBER

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## FOURTH FLOOR TERRACE

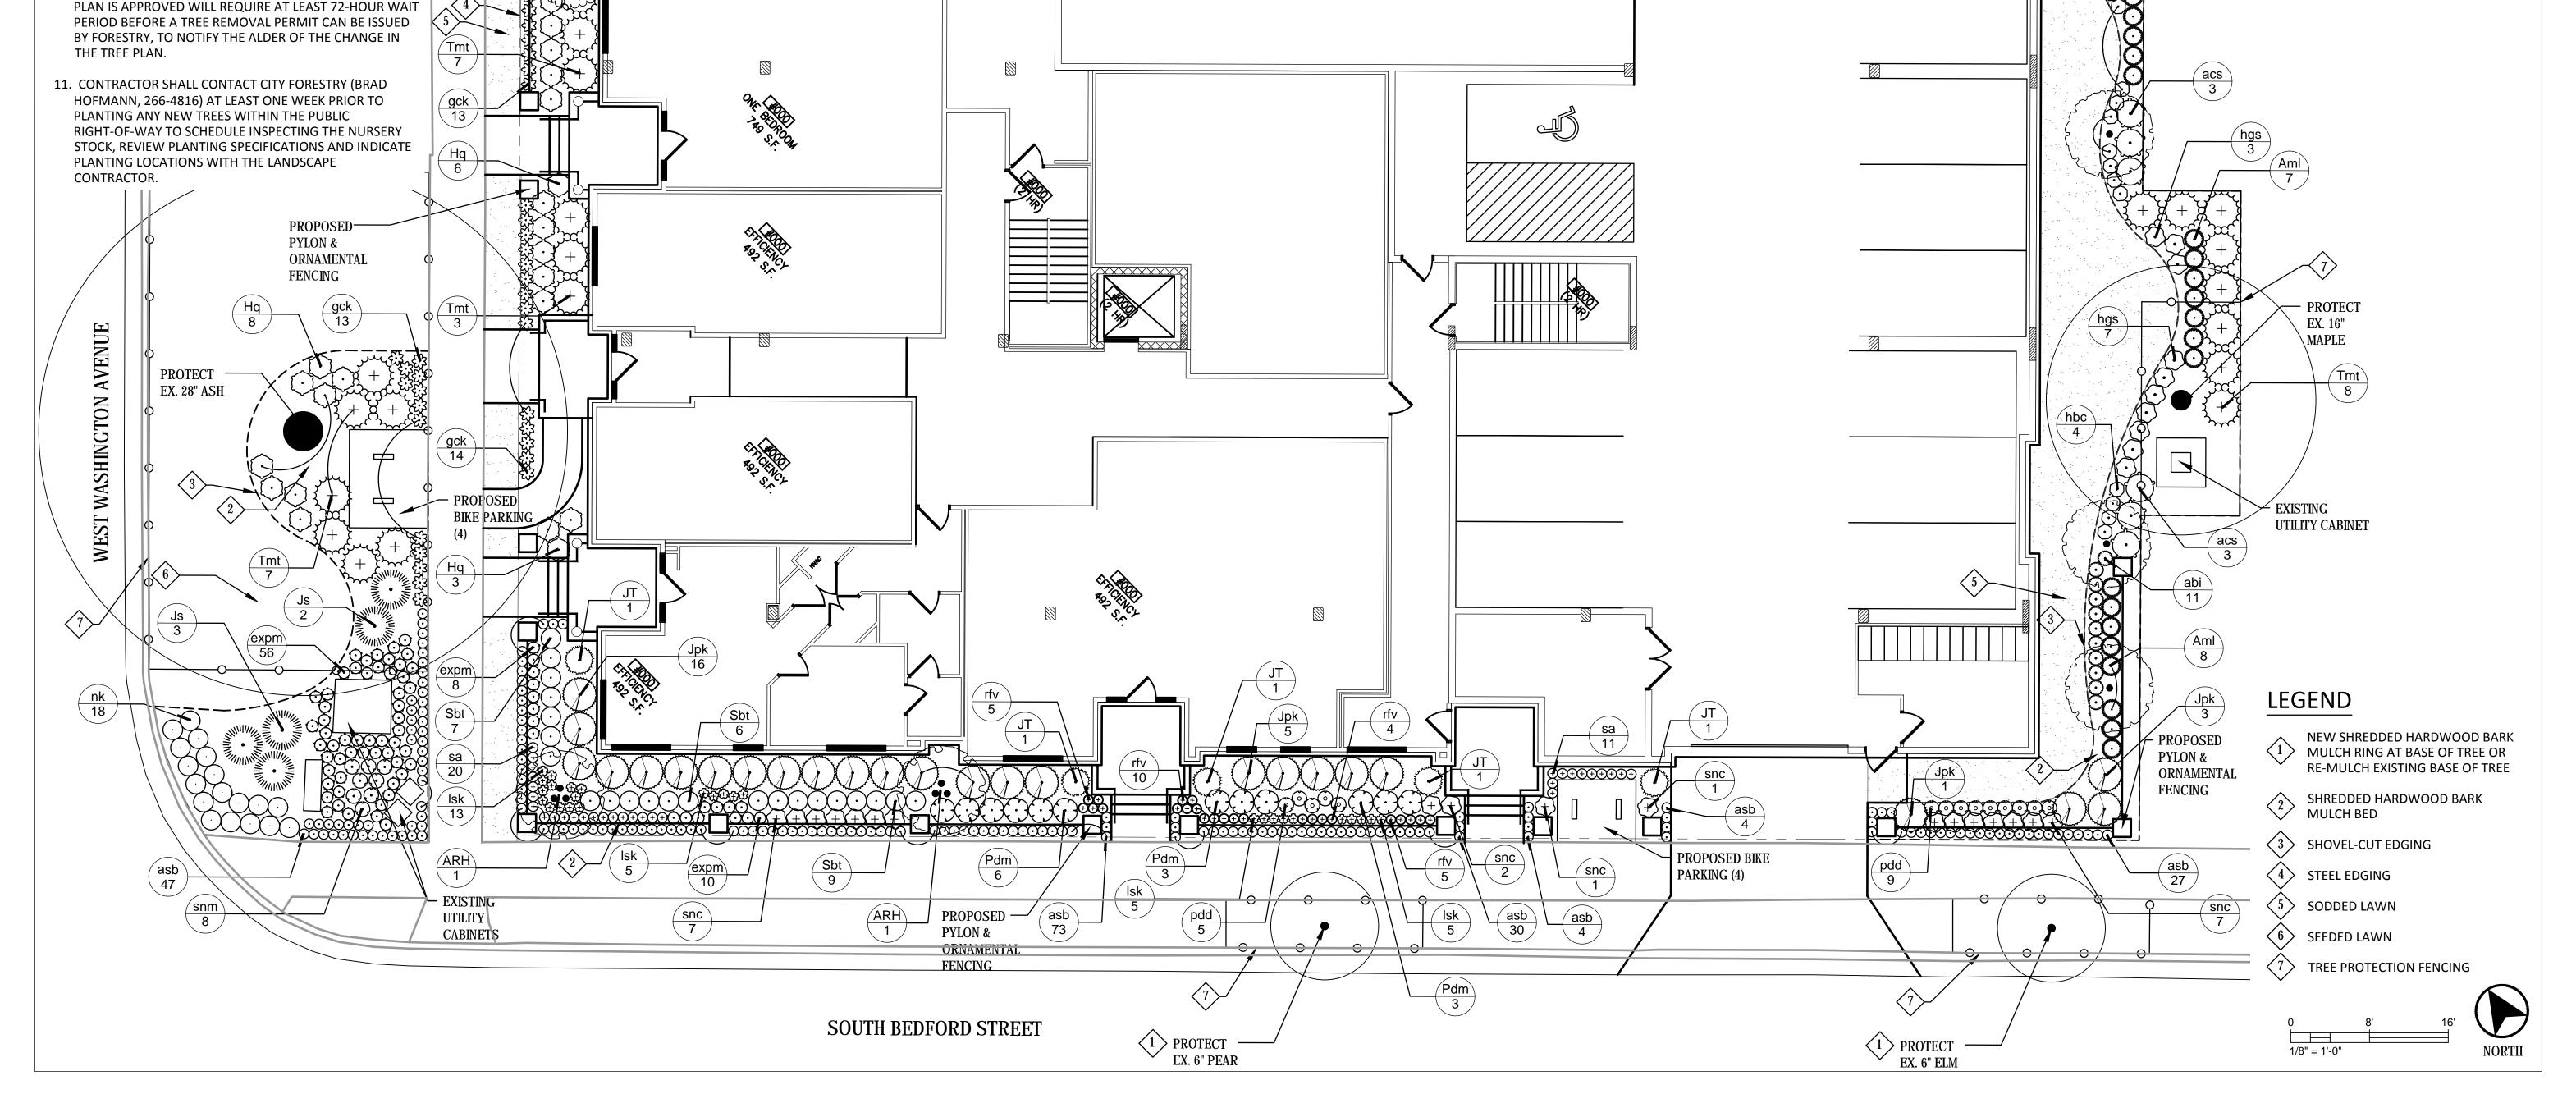Type A:	
Propogated Sedum Tray 'Tough Extreme Mix'	
by Liveroof or approved equal. Interplant with	
2.5" perennial plugs.	
Perennial Plugs	
Allium tanguticum 'Summer Beauty'	Summer Beauty Allium
Calamintha nepeta 'Montrose White'	Montrose White Calamint
Sedum kamtschaticum 'Takahira Dake'	Takahira Dake Stonecrop
Sedum spectabilie 'Neon'	Neon Stonecrop
Sesleria autumnalis	Autumn Moor Grass
Type B:	
Propogated Sedum Tray 'Shade Serene Mix'	
by Liveroof or approved equal. Interplant with	
2.5" perennial plugs.	
Perennial Plugs	
Geranium maculatum	Wild Geranium
Heuchera villosa var. atropurpurea	Maple-leaved Alum Root
Smilacina racemosa	False Solomon's Seal
Dryopteris marginalis	Leatherleaf Woodfern
Tiarella cordifolia	Foamflower

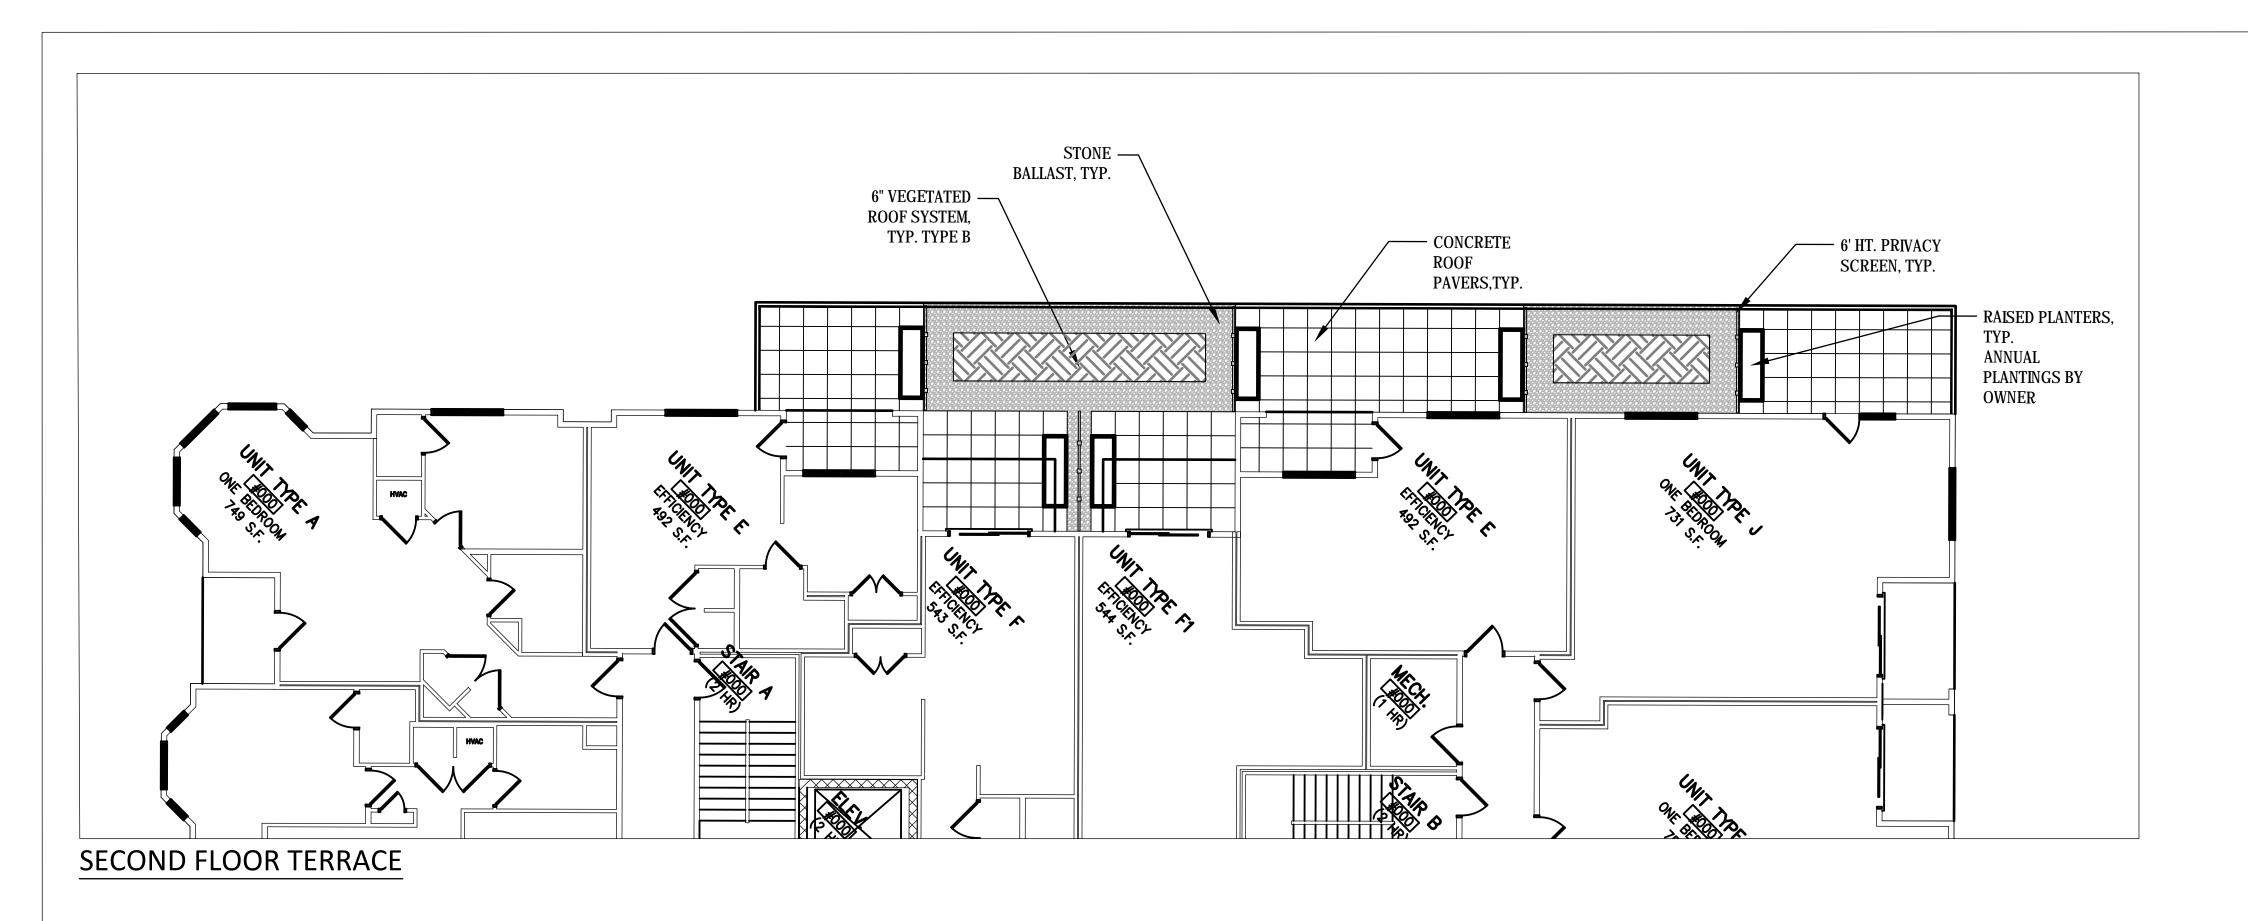

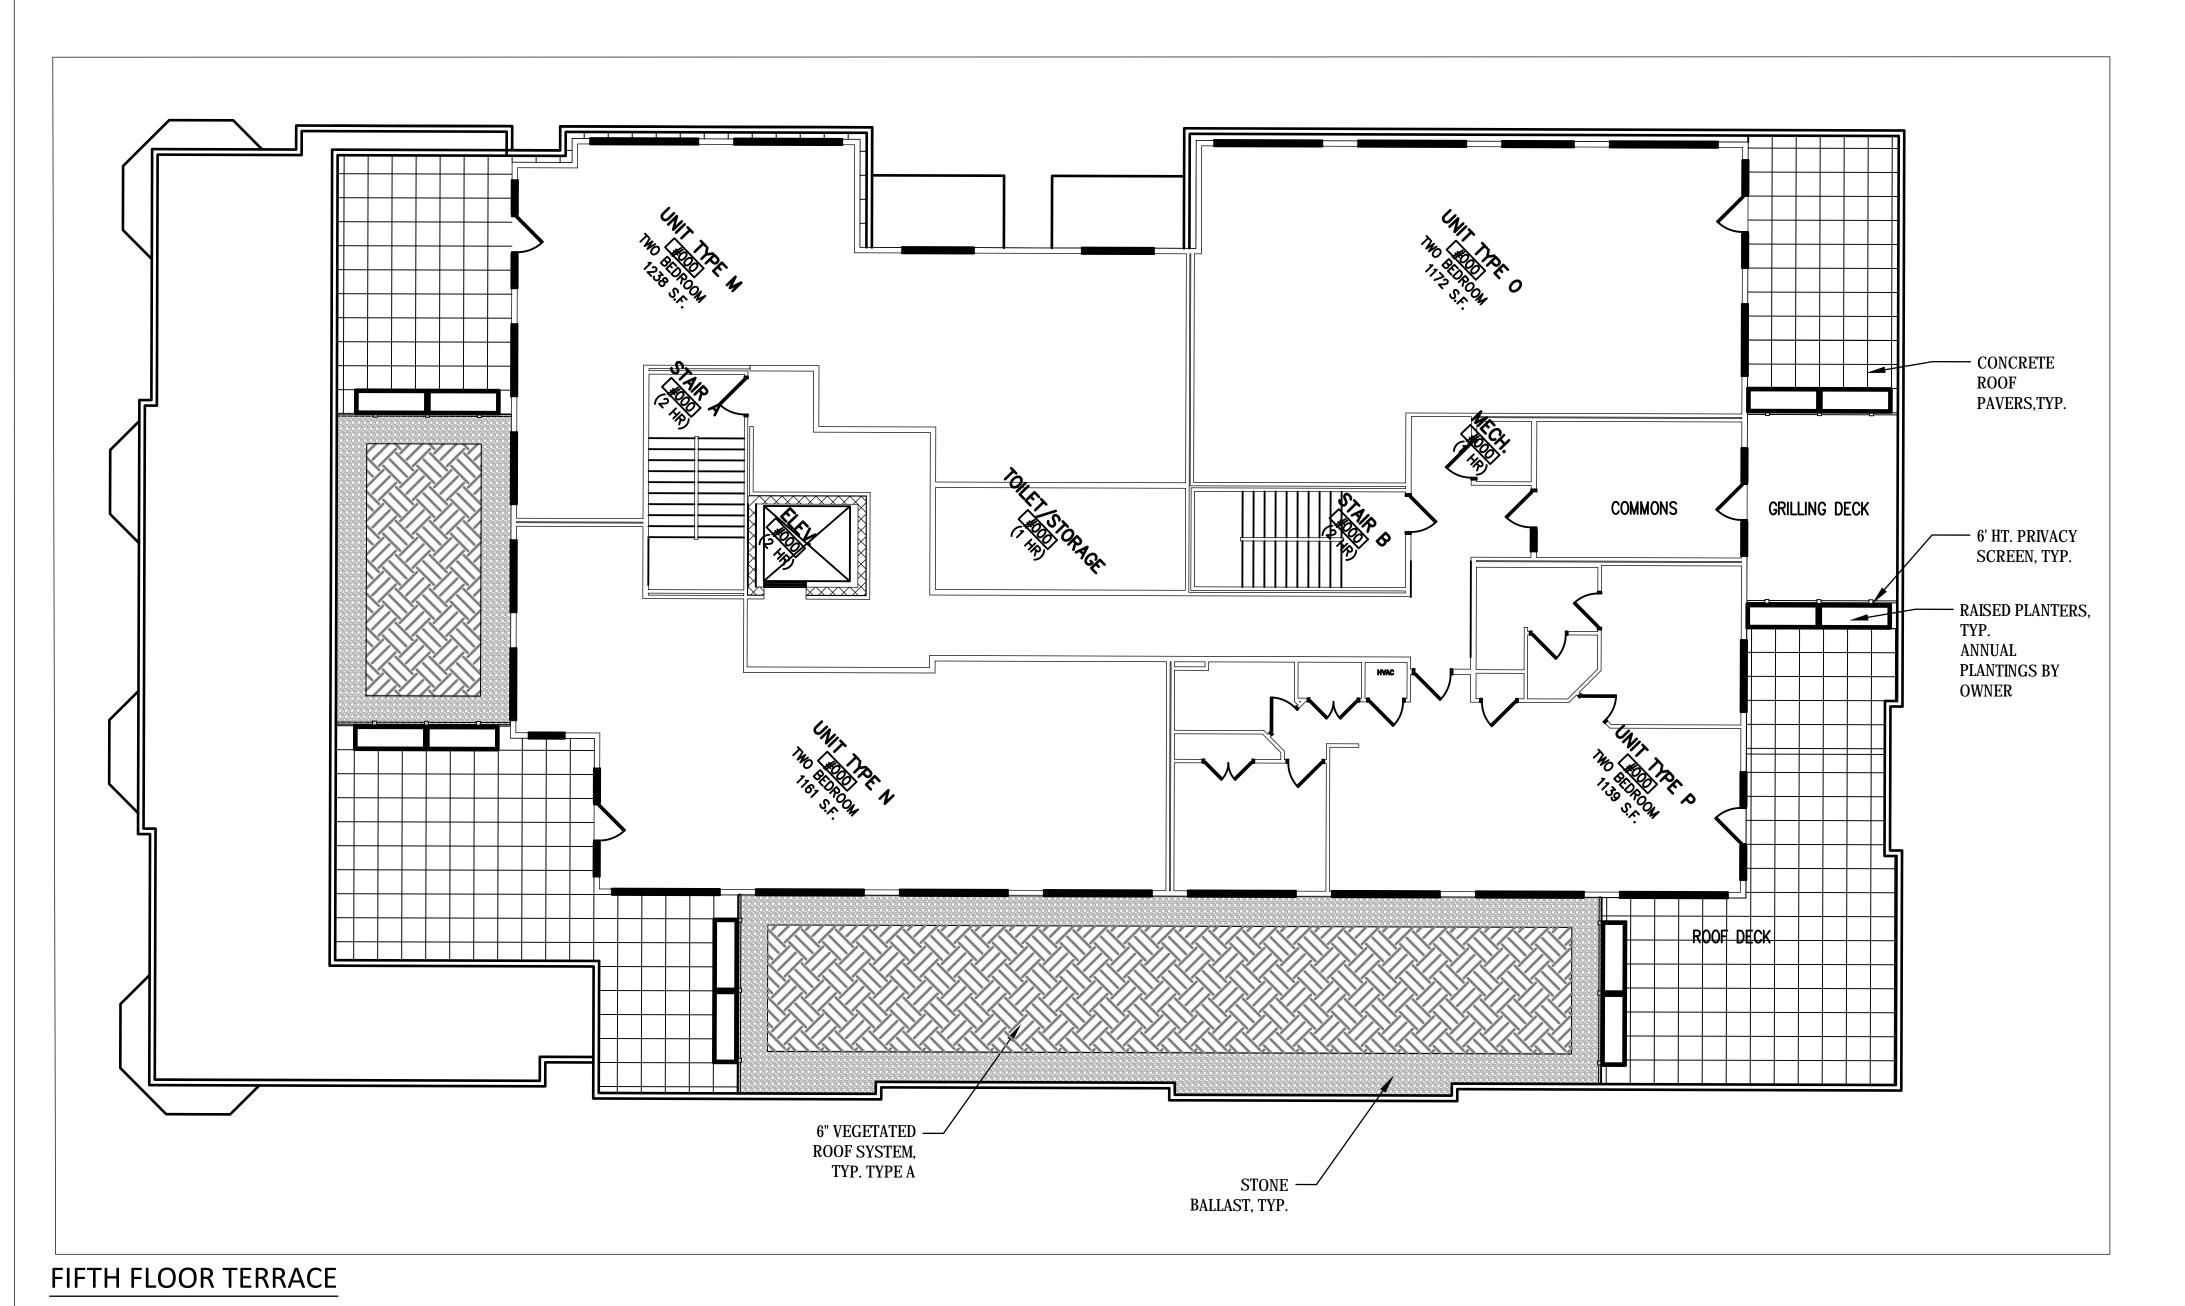
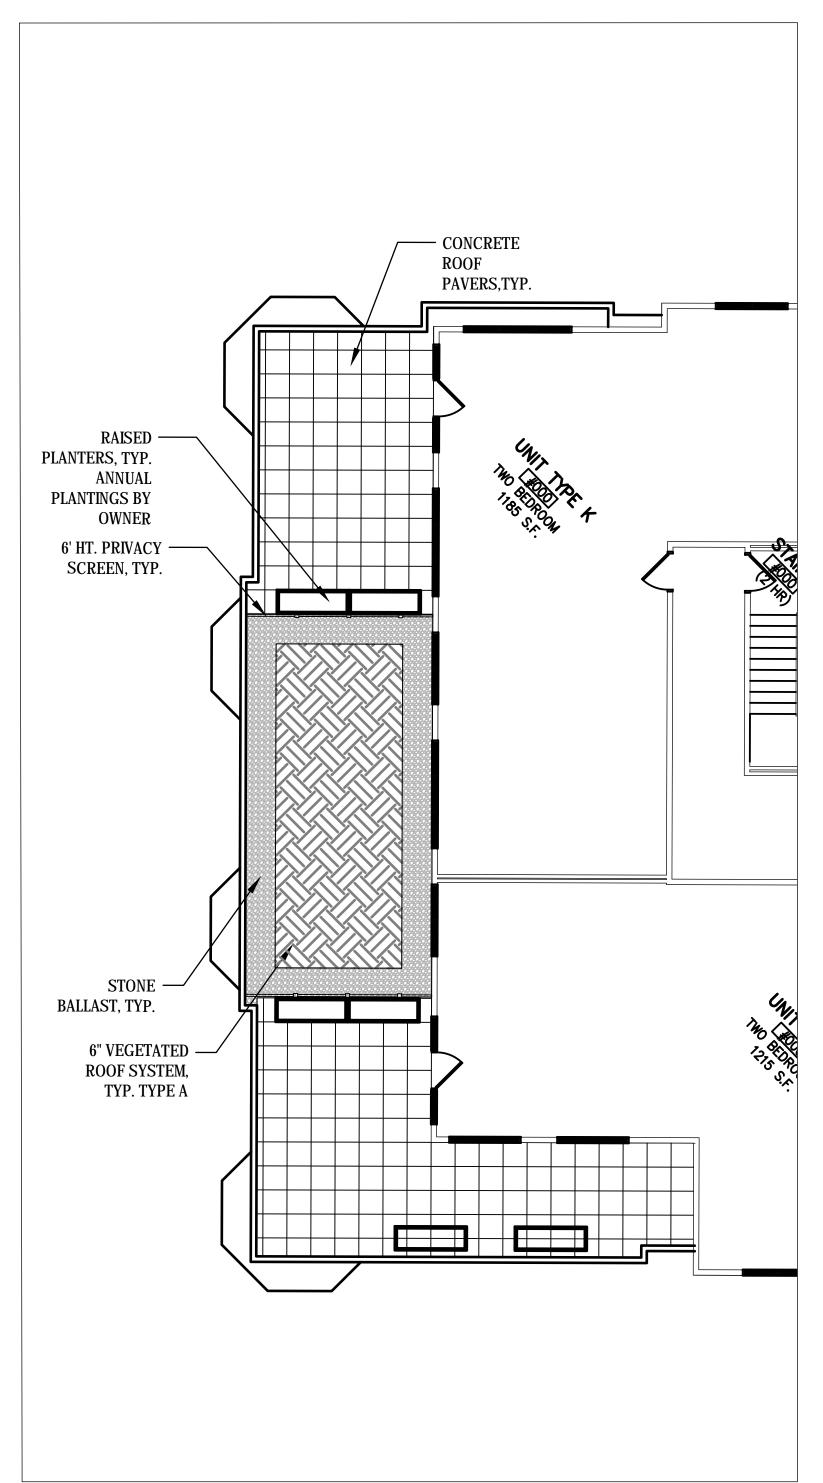
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PROJECT TITLE
BAXTER
West
Washington
Development

555 W
Washington Ave.


SHEET TITLE
Roof Terrace
Landscape
Plan


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PROJECT NO.

NORTH © 2013 Knothe



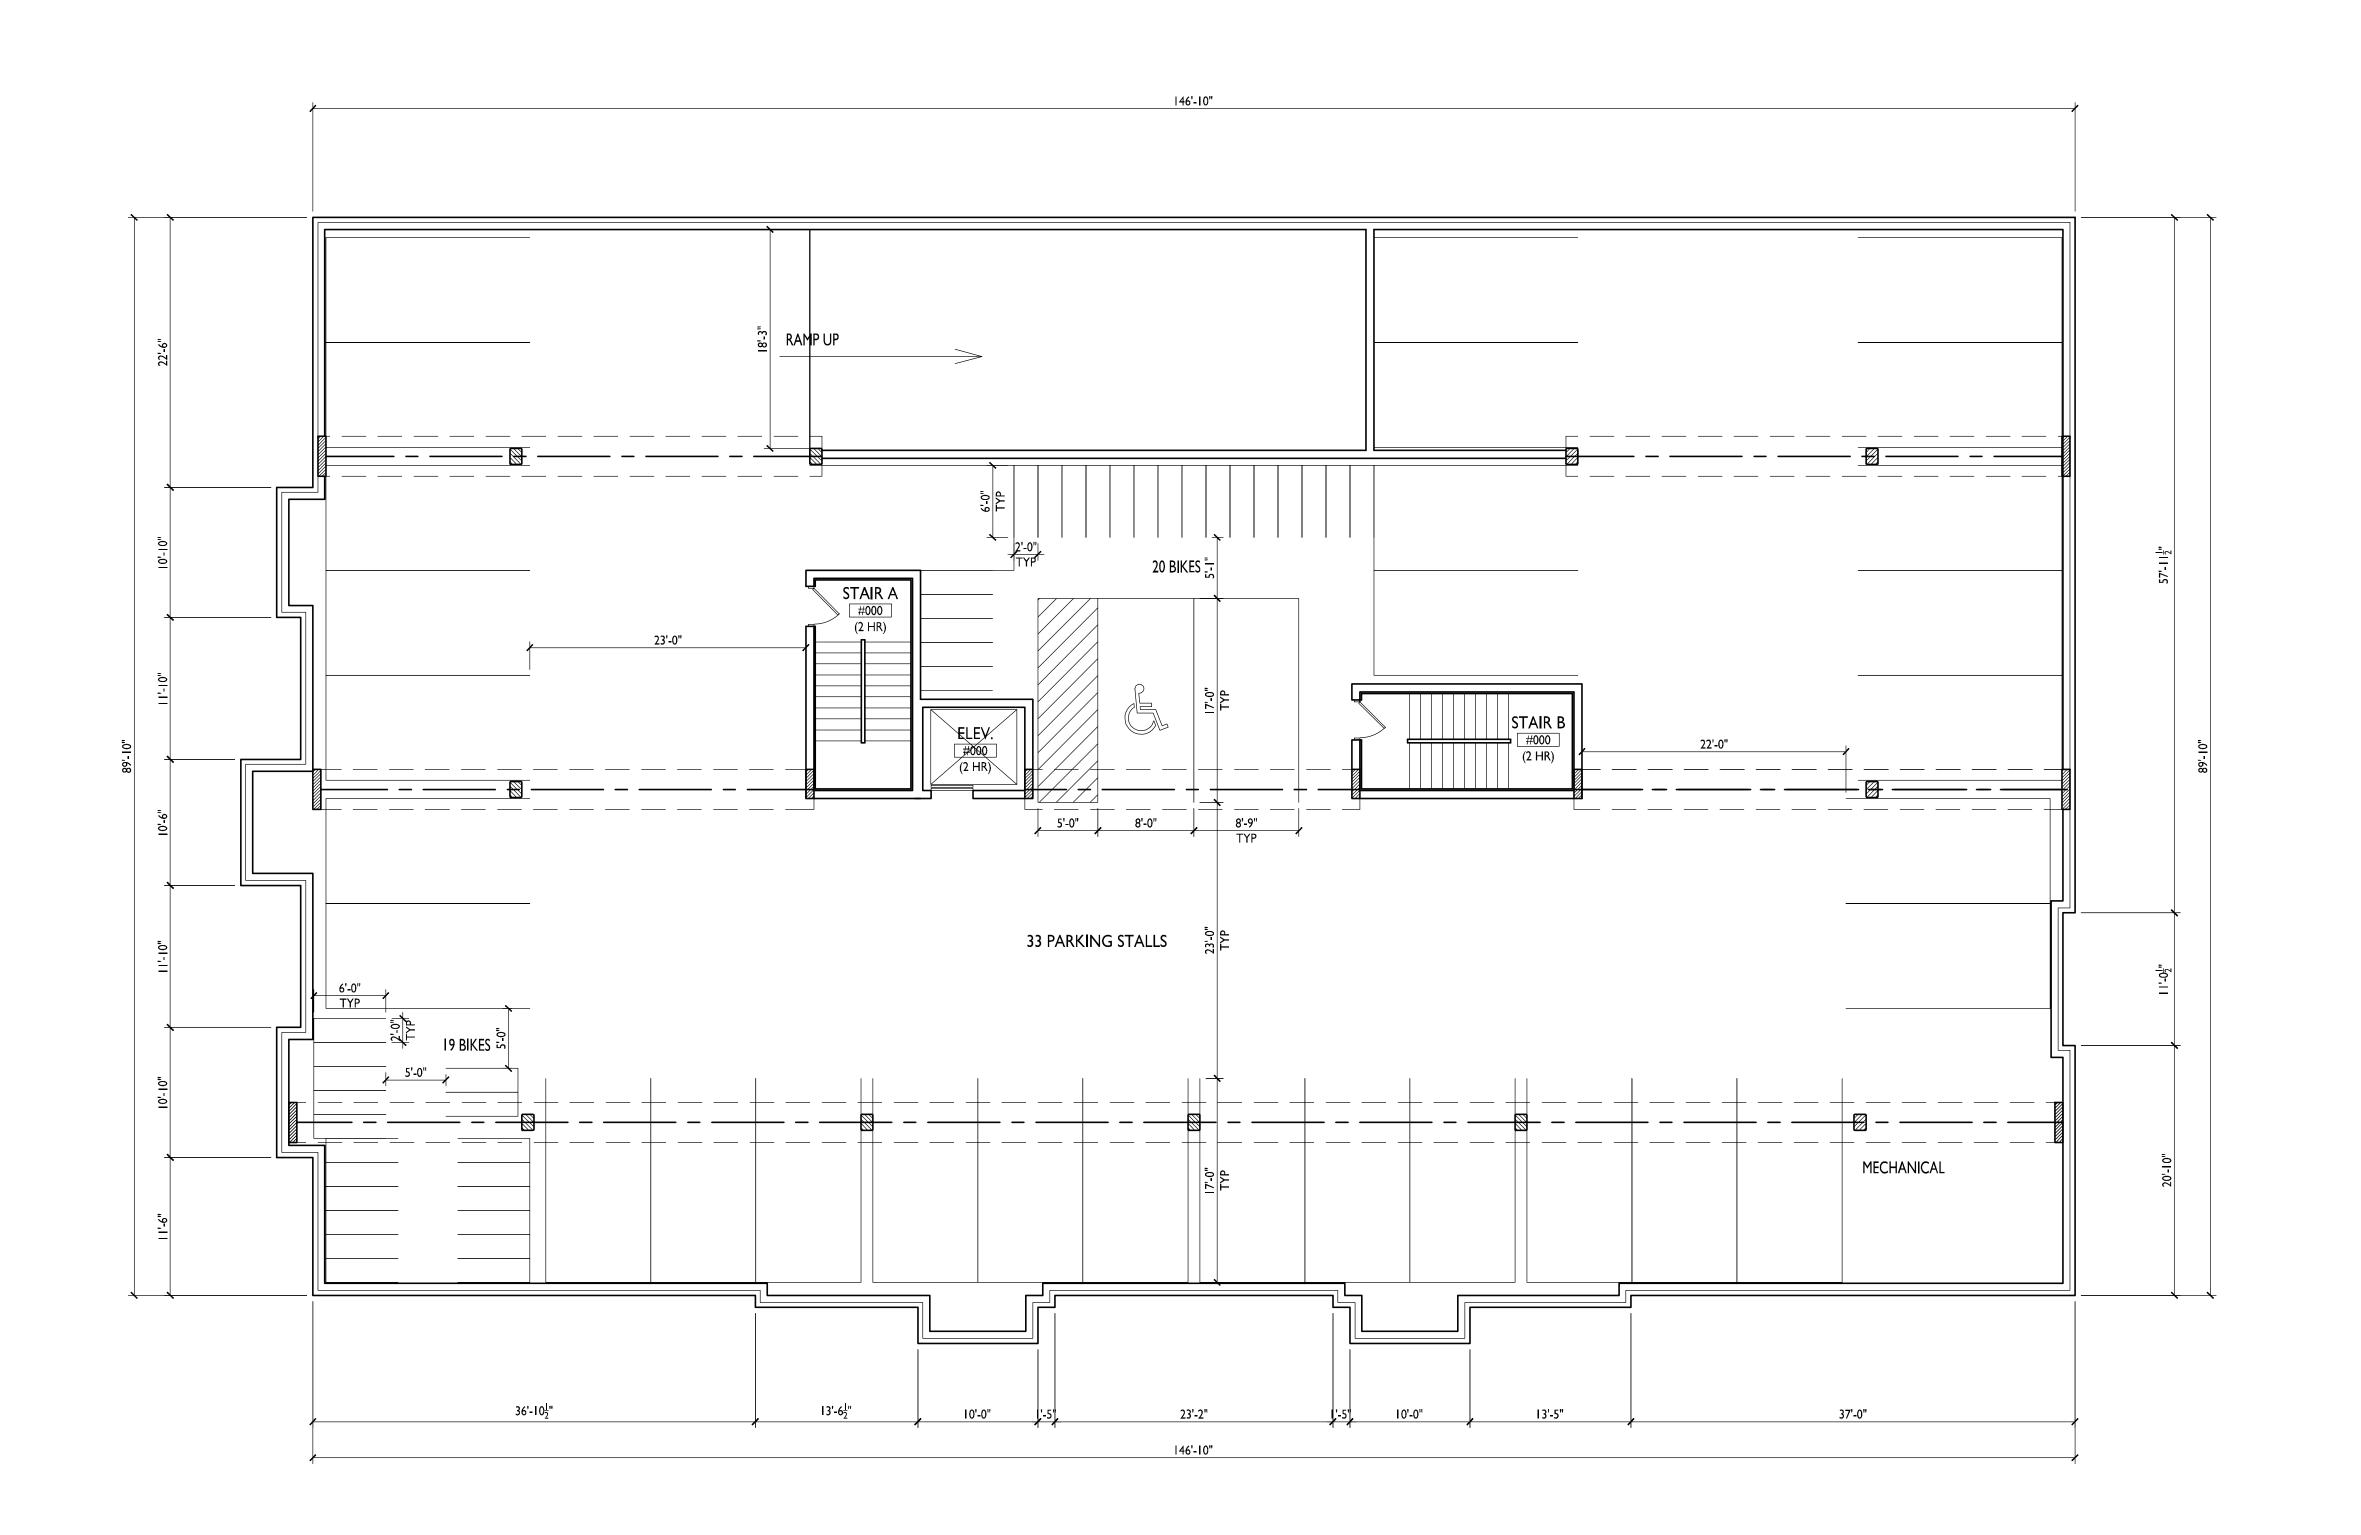

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PROJECT TITLE
BAXTER
West Washington
Development

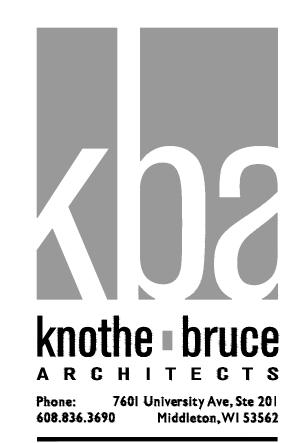555 W Washington Ave.

SHEET TITLE

Basement Plan

SHEET NUMBER

A-1.0

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PROJECT NO.





S. BEDFORD



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PROJECT TITLE

BAXTER West Washington Development

555 W Washington Ave.

SHEET TITLE
First Floor Plan


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PROJECT TITLE
BAXTER
West Washington
Development

555 W Washington Ave.

SHEET TITLE

Second Floor Plan

SHEET NUMBER

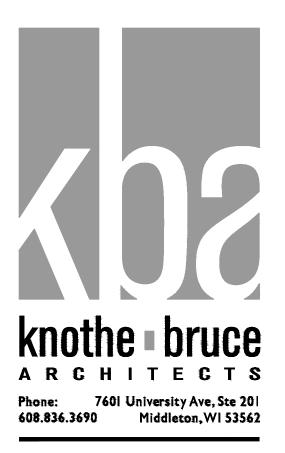A-1.2

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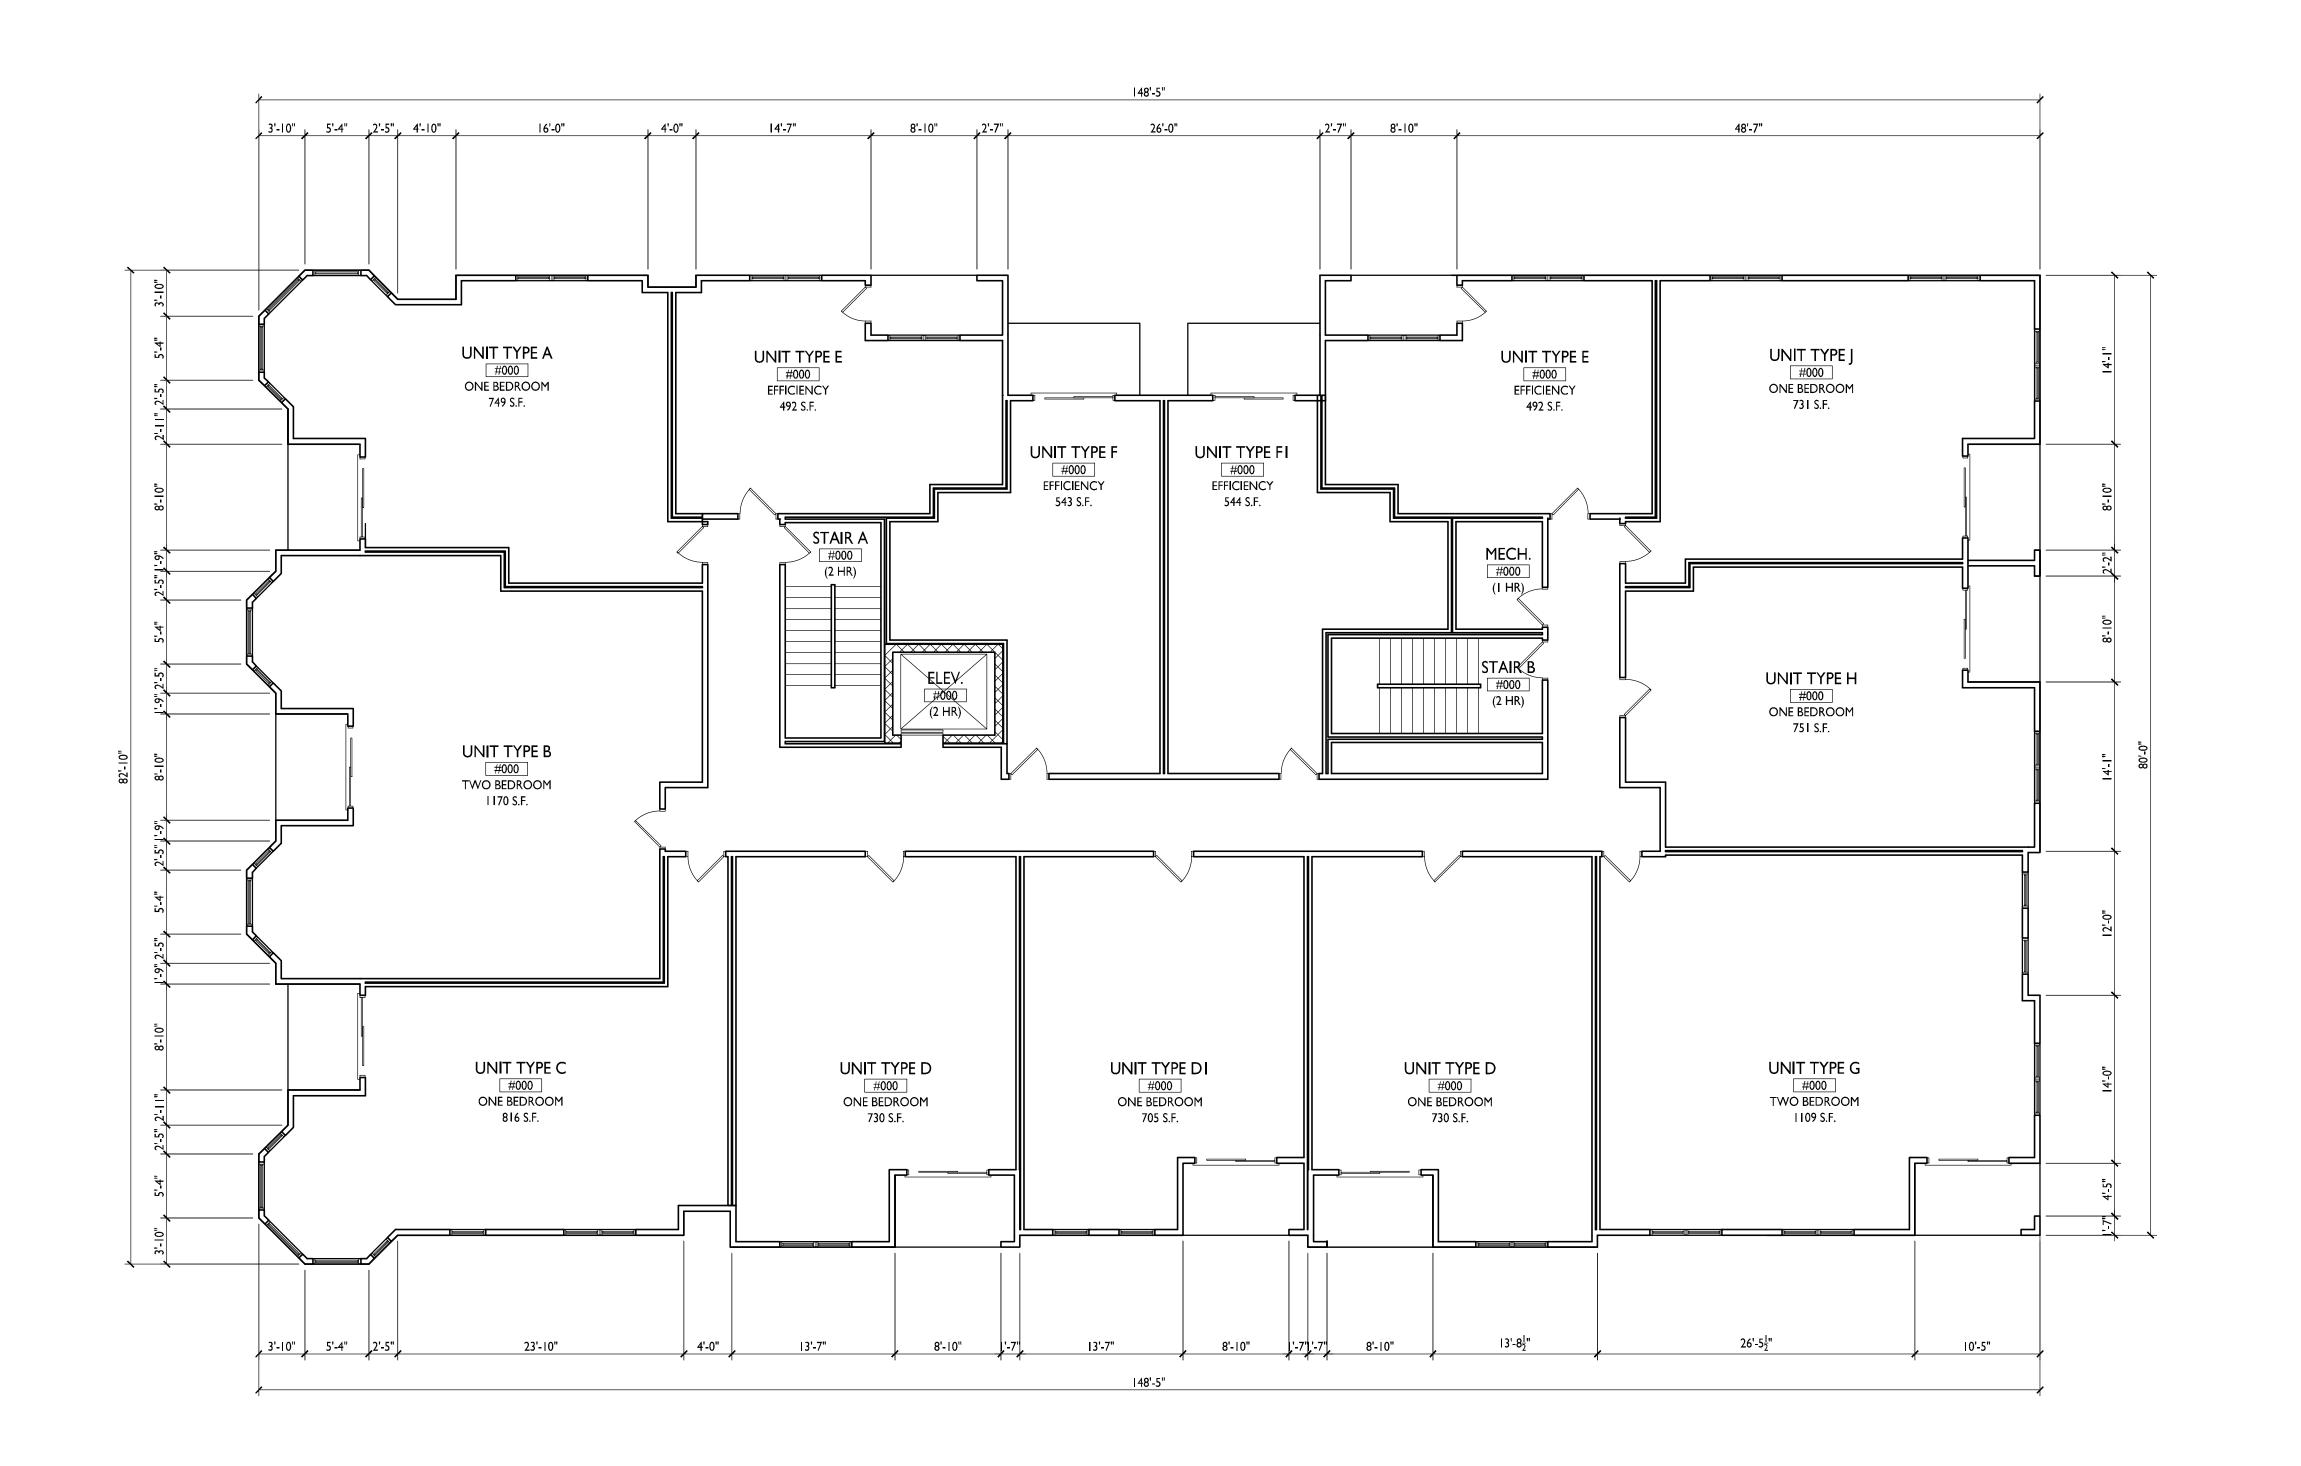
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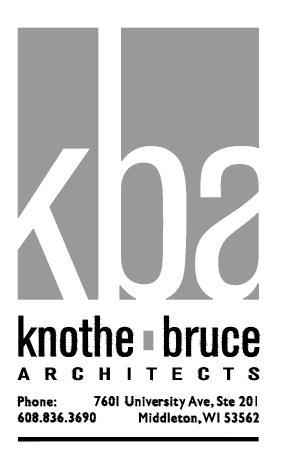
SECOND FLOOR PLAN

A-1.2

1/8"=1'-0"







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PROJECT TITLE

BAXTER West Washington Development

555 W Washington Ave.

SHEET TITLE
Third Floor Plan

SHEET NUMBER


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PROJECT TITLE

BAXTER West Washington Development

555 W Washington Ave.

SHEET TITLE

Fourth Floor Plan

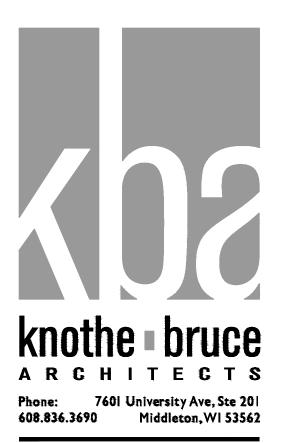
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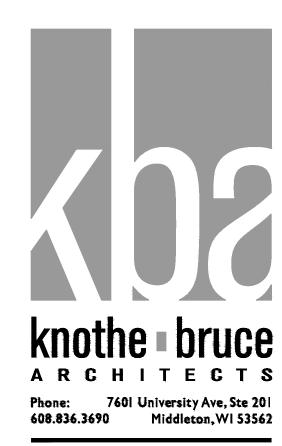


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PROJECT TITLE

BAXTER West Washington Development

555 W Washington Ave.

SHEET TITLE
Fifth Floor Plan

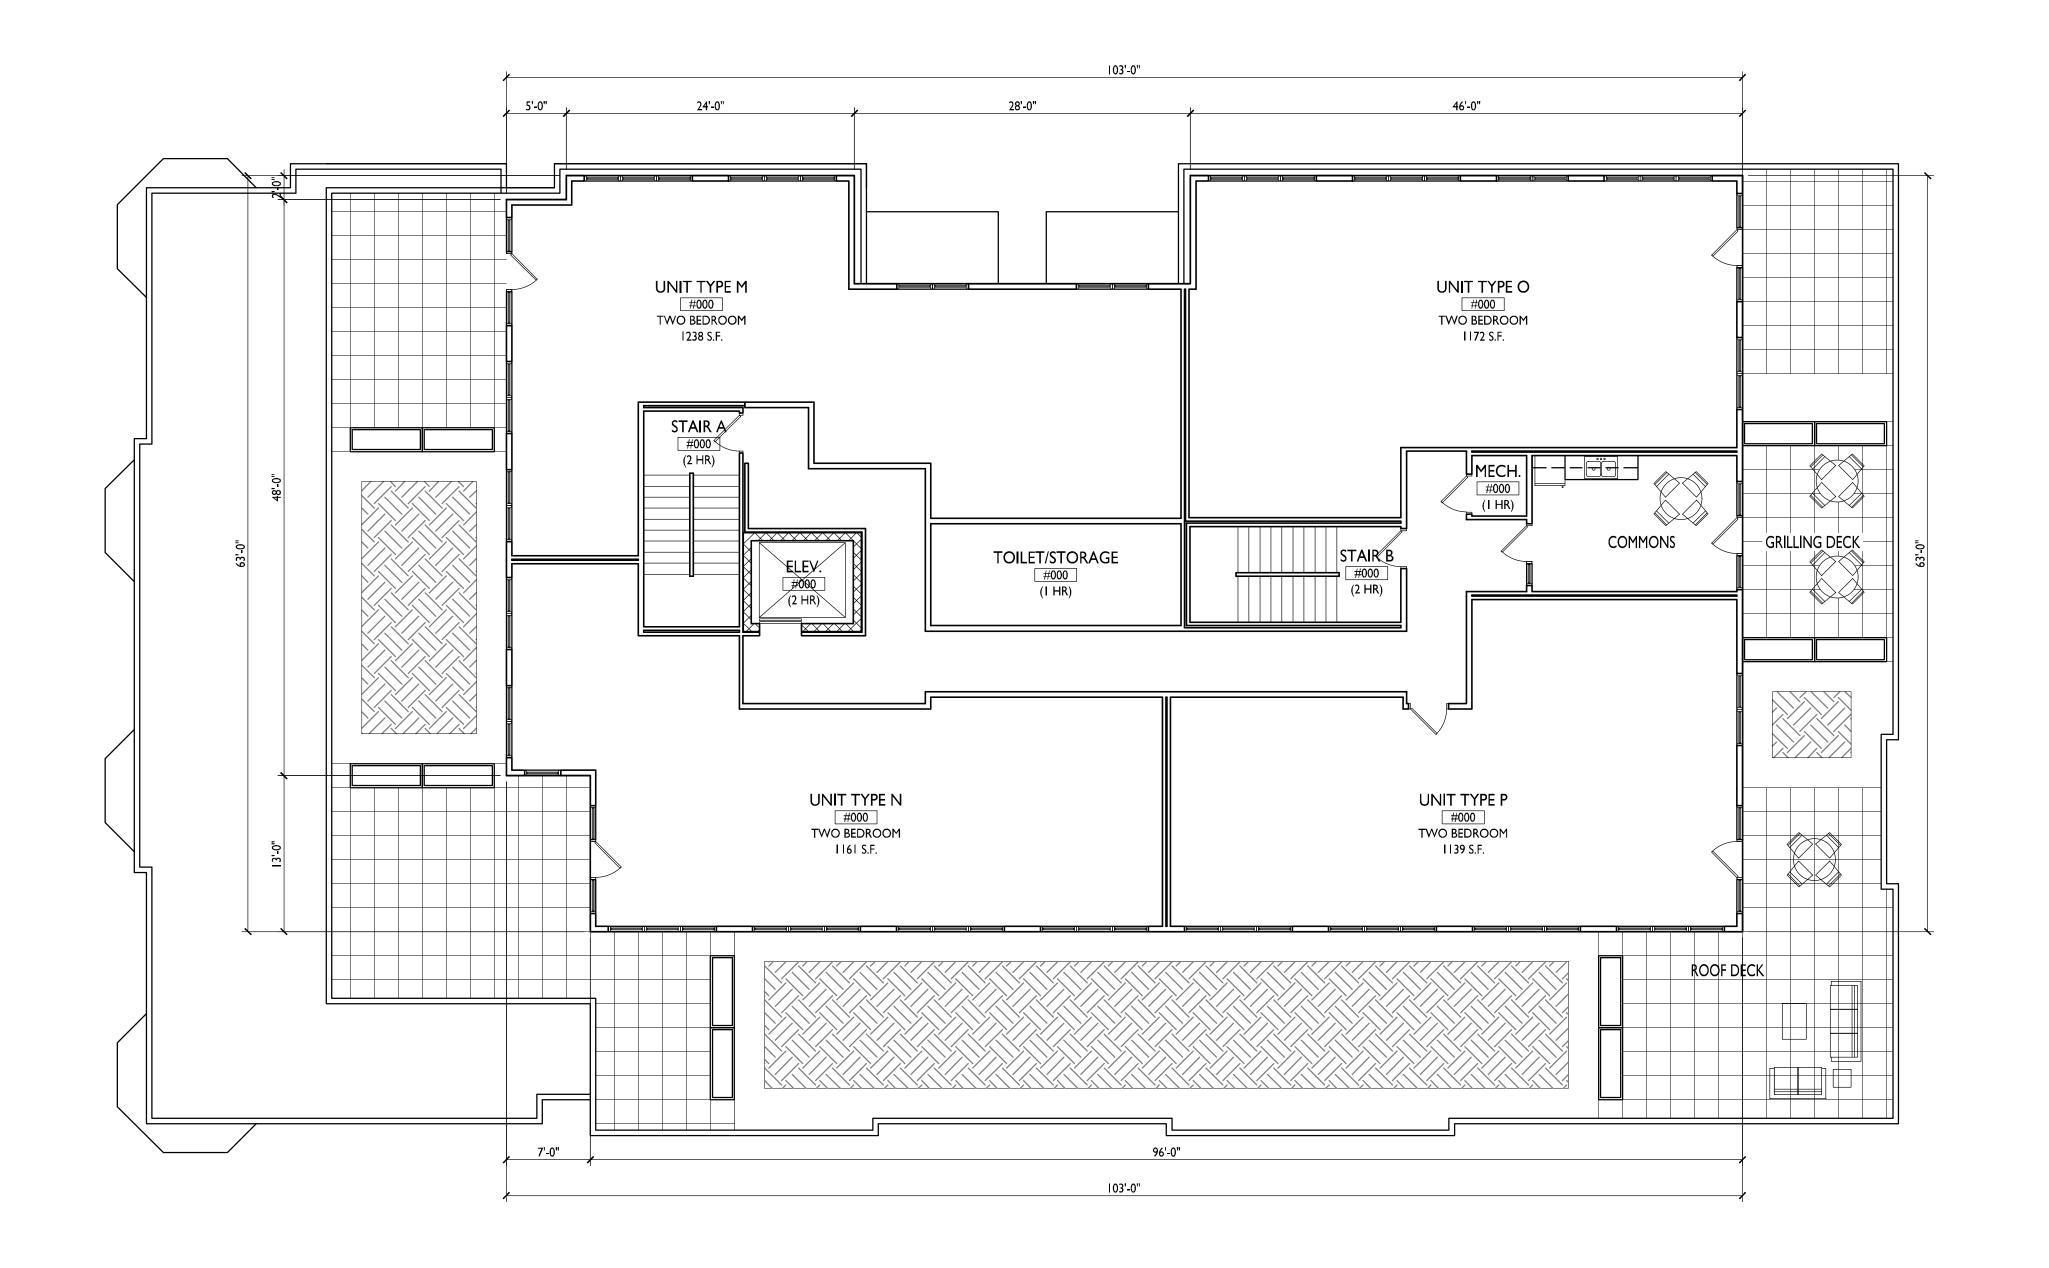SHEET NUMBER


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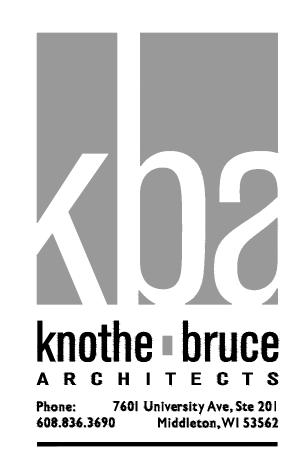
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PROJECT NO.







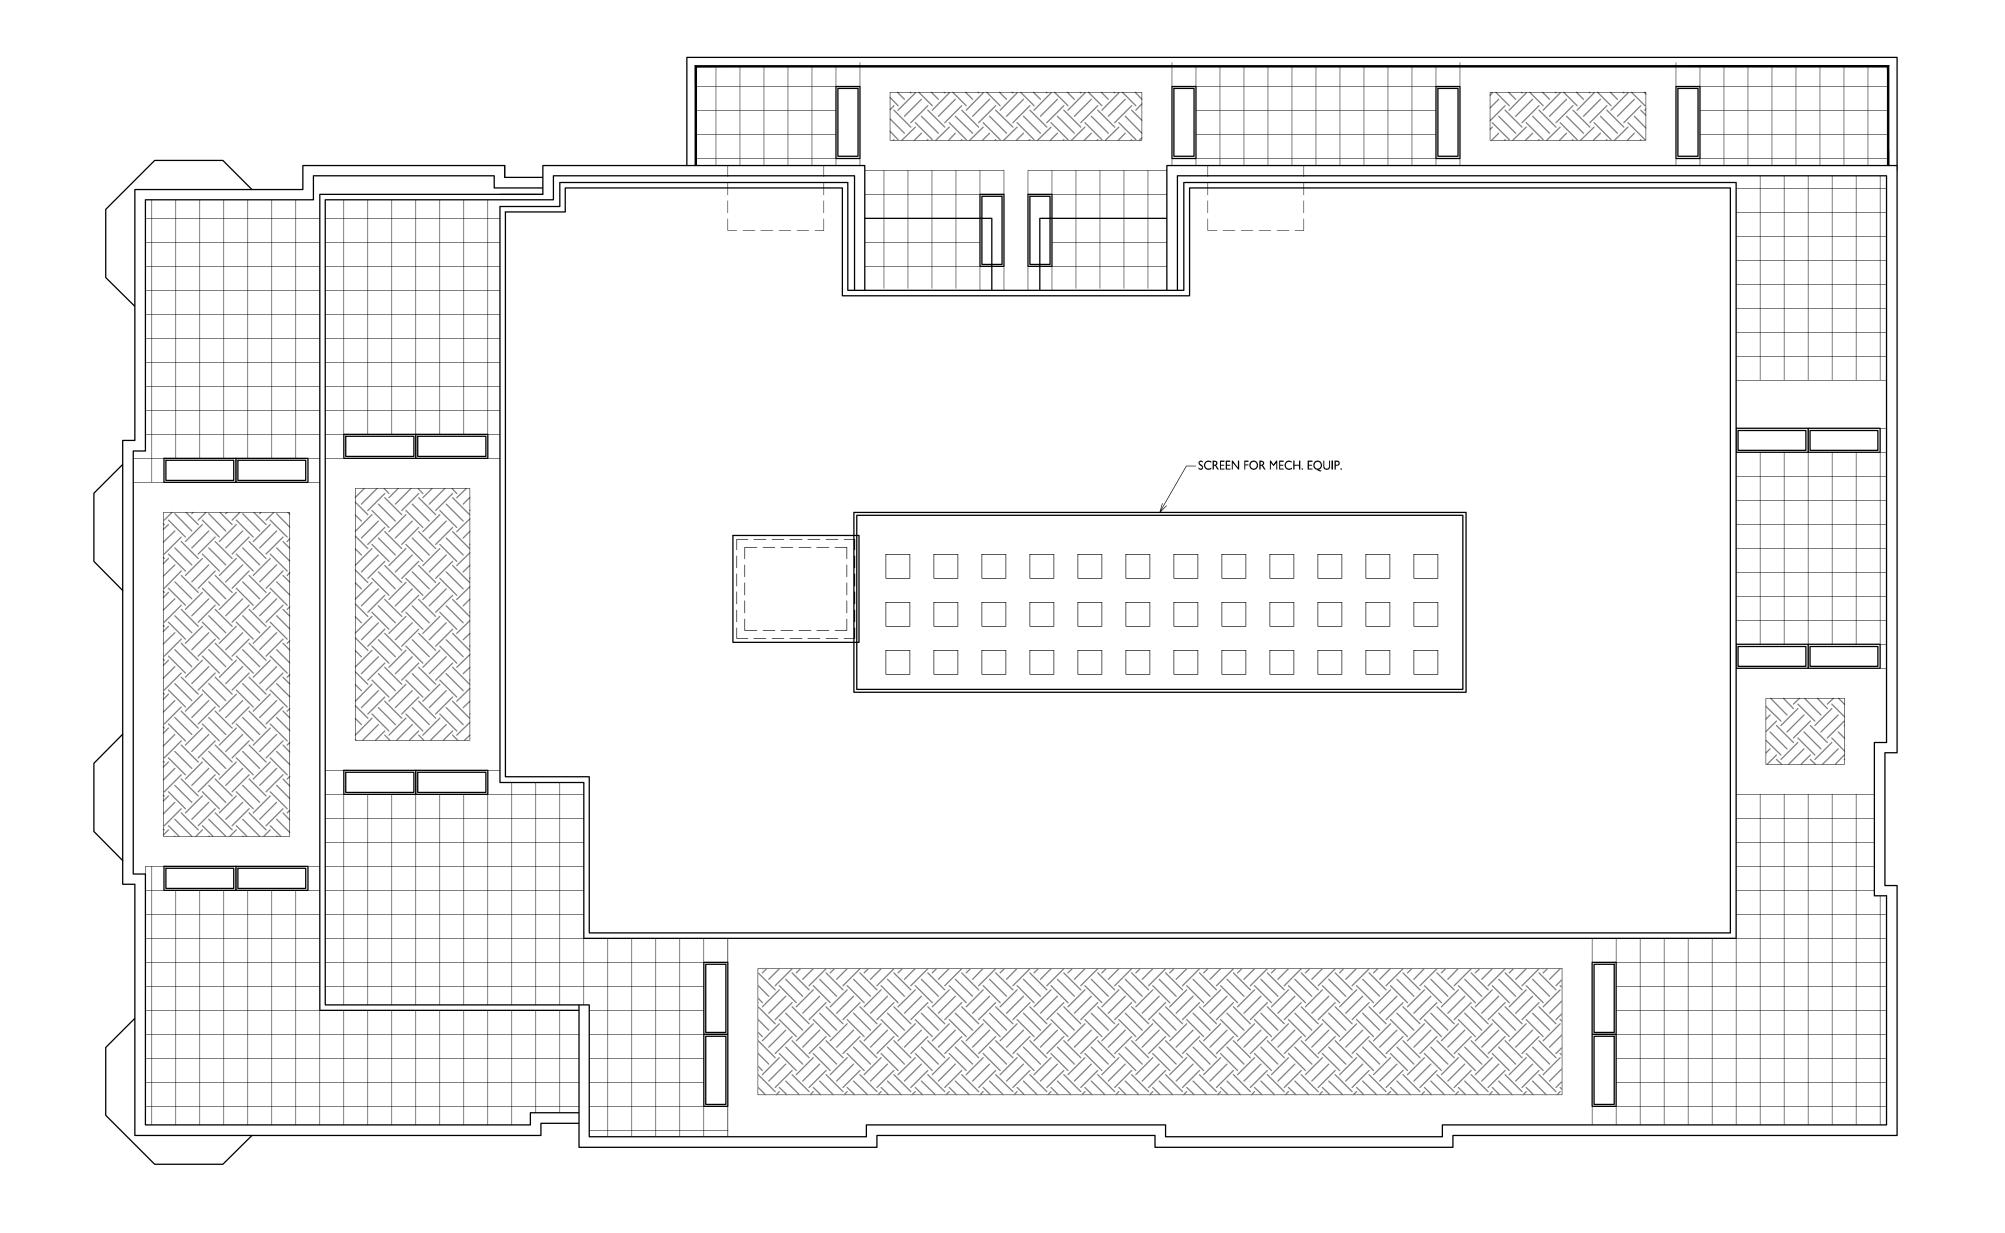

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PROJECT TITLE
BAXTER
West Washington
Development

555 W Washington Ave.

sheet title Roof Plan


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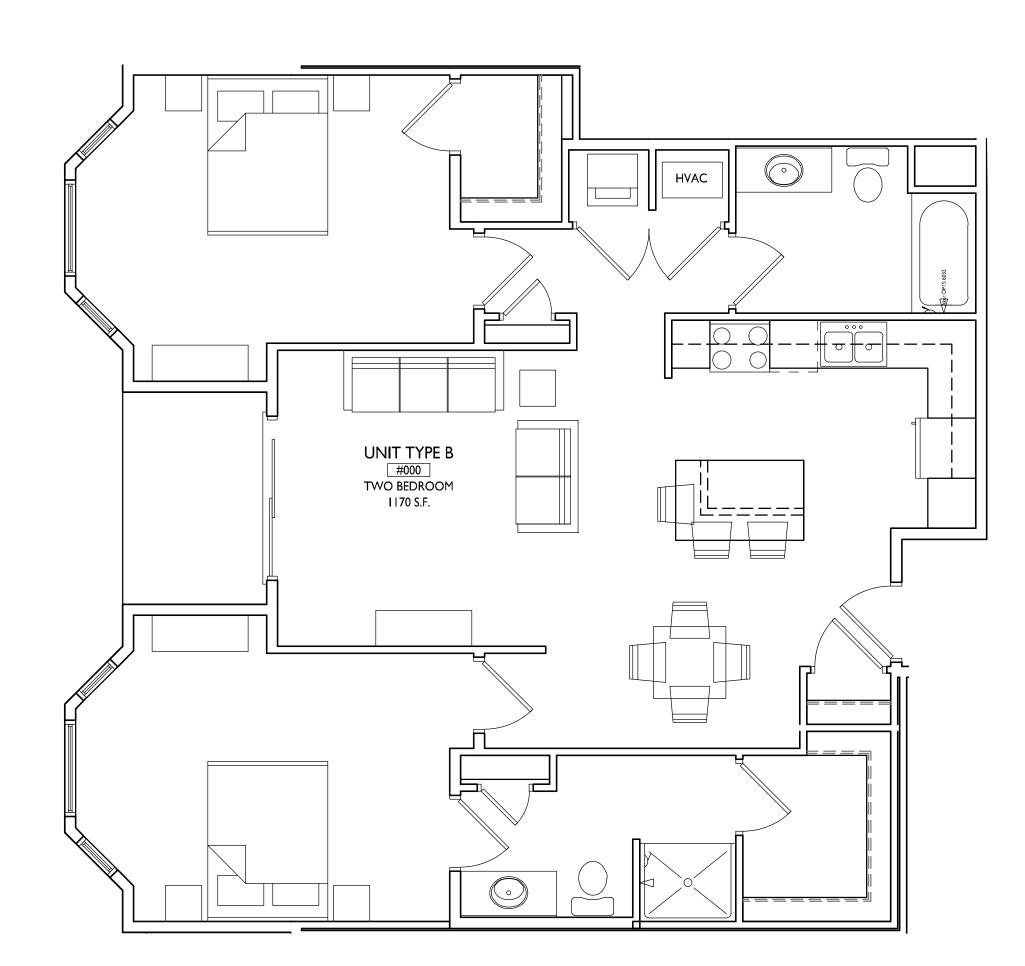
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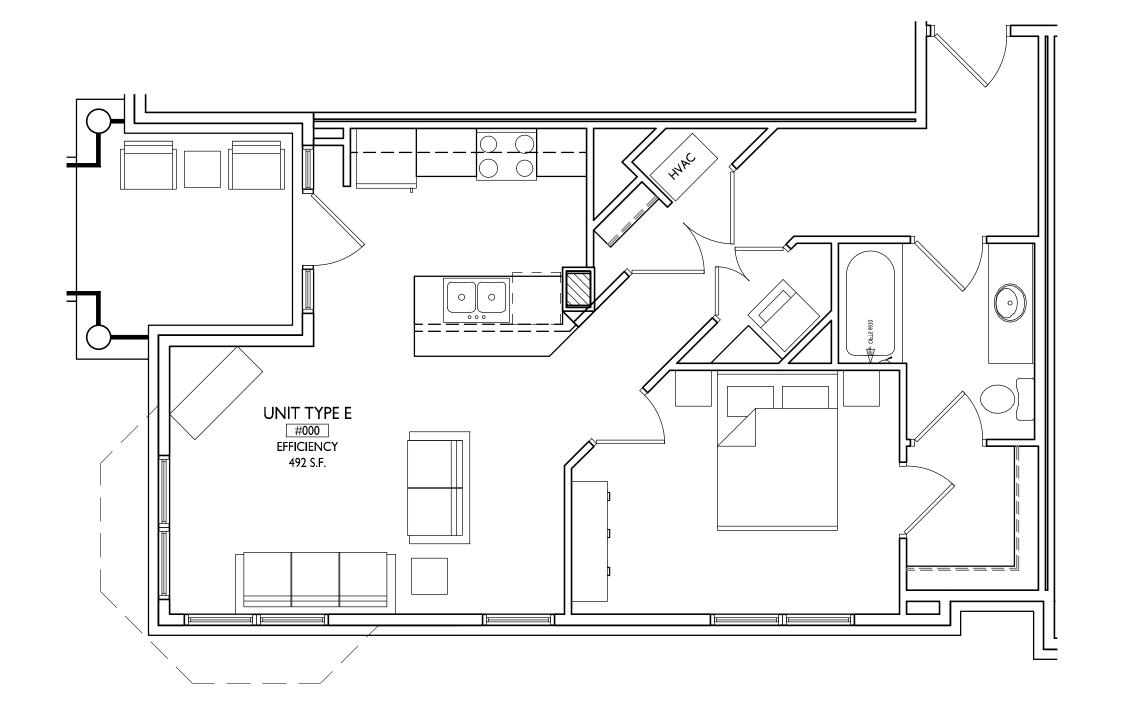









UNIT TYPE B

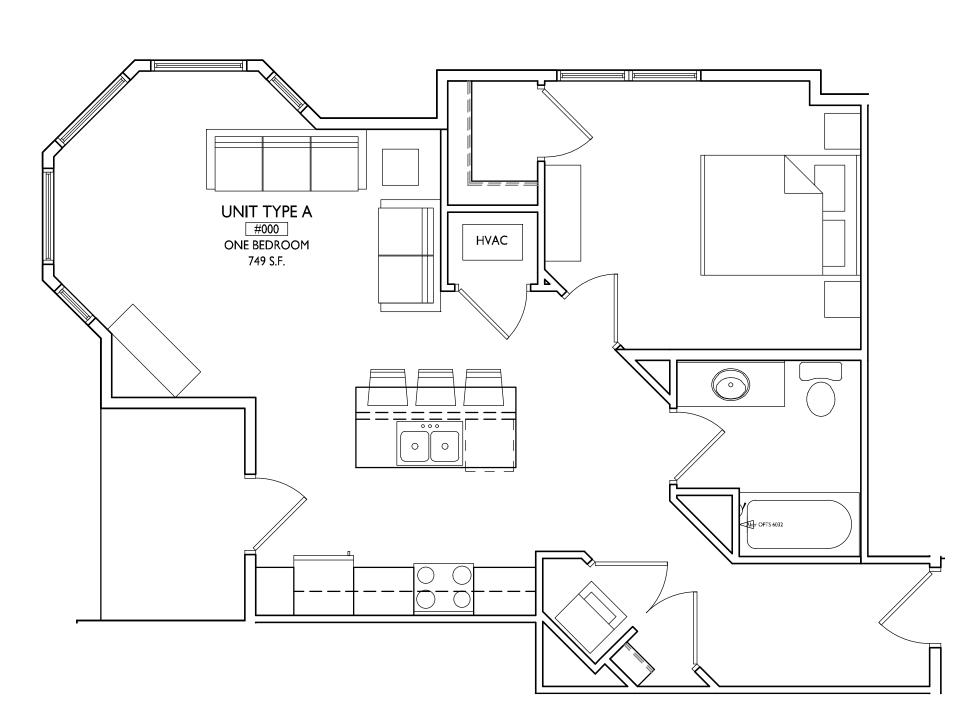

3 UNIT TYPE E

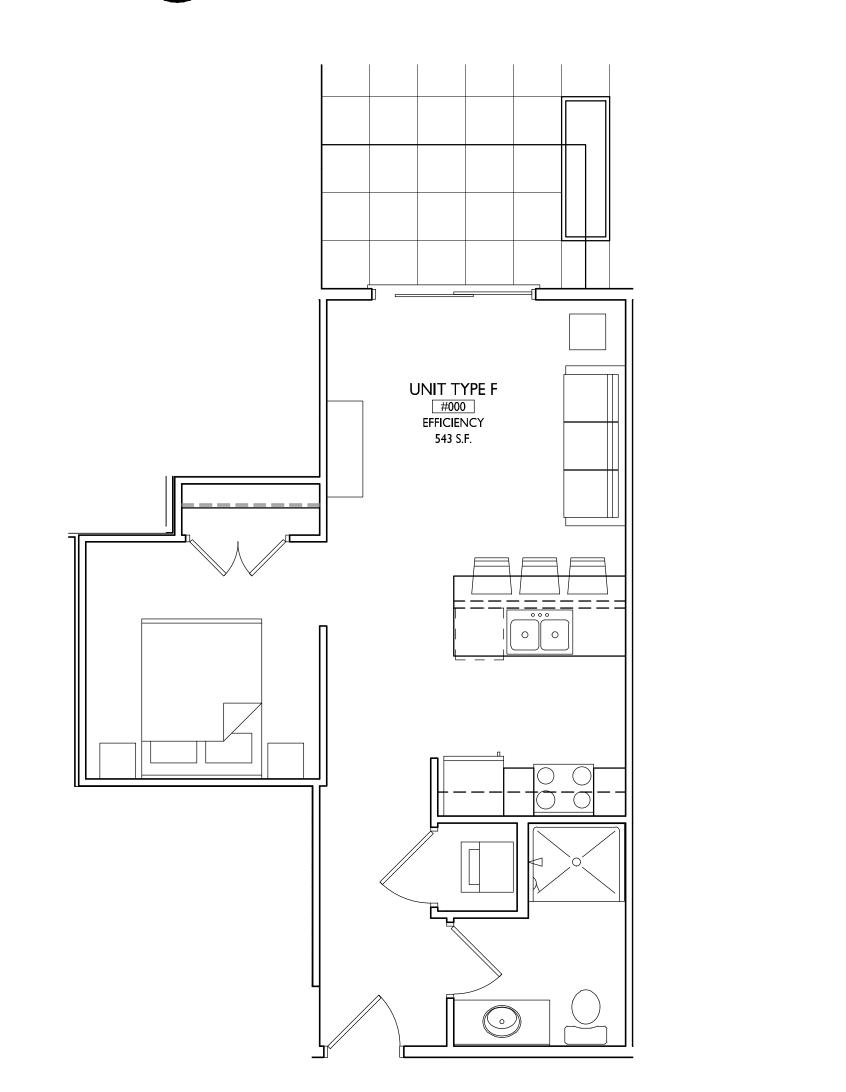

UNIT TYPE F



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PROJECT TITLE

BAXTER West Washington Development

555 W Washington Ave.


SHEET TITLE
Typical Unit Plans


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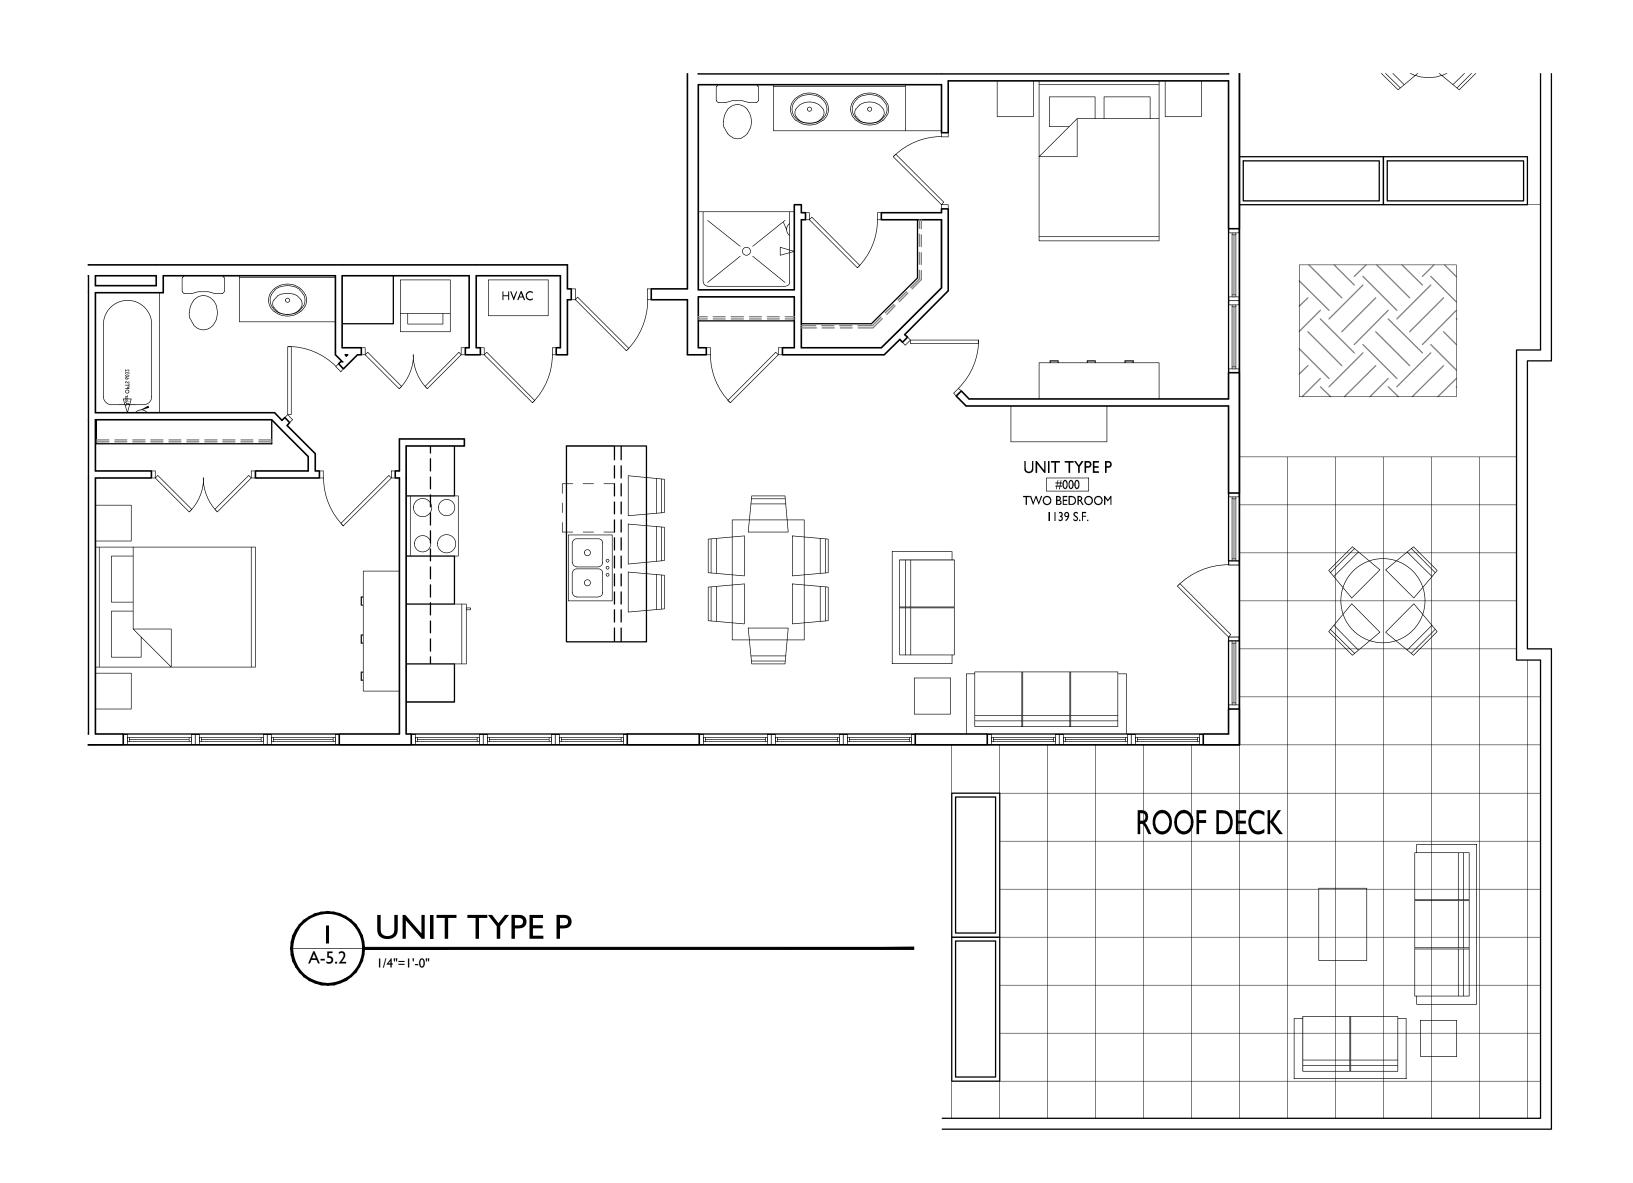
A-5.1

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PROJECT TITLE
BAXTER West Washington Development

555 W Washington Ave.

SHEET TITLE

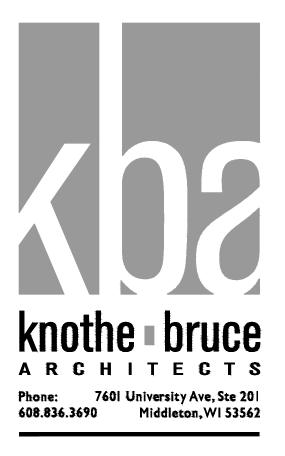Typical Unit Plans

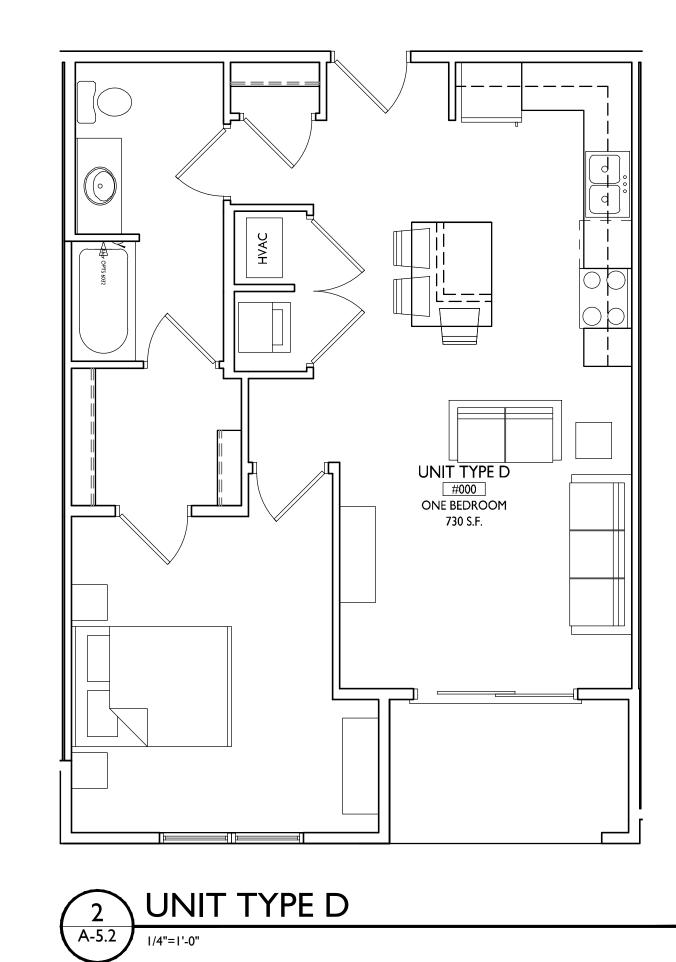
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A-5.2


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Use - June 20,
2018

PROJECT TITLE

SHEET TITLE

Exterior Elevations

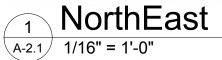
SHEET NUMBER

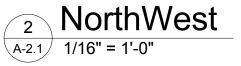A-2.1

PROJECT NUMBER 1713

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SouthEast
A-2.2 1/16" = 1'-0"

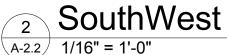

Issued For Land Use - June 20, 2018

PROJECT TITLE

SHEET TITLE


Exterior Elevations

SHEET NUMBER

A-2.2

PROJECT NUMBER 1713


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555 West Washington June 20, 2018

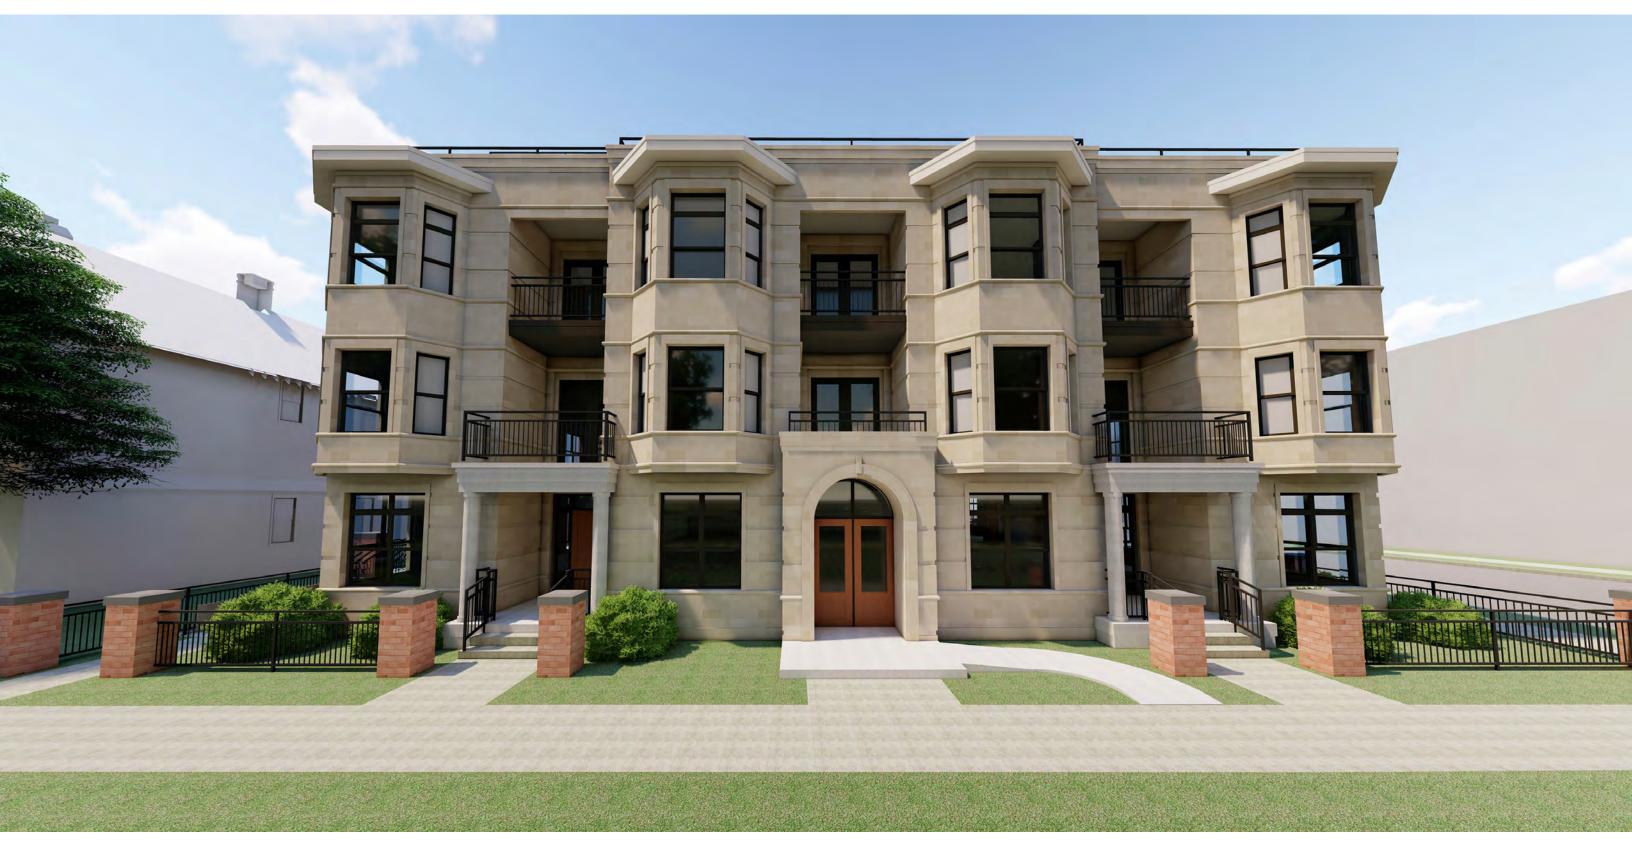



July 2, 2018

Ms. Janine Glaeser Urban Design Committee City of Madison 146 S. Hamilton Street PO Box 2985 Madison, Wisconsin 53701

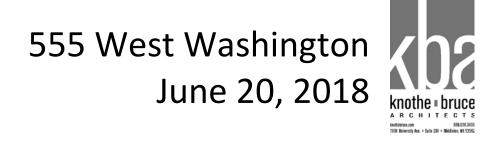Re: Letter of Intent 555 W. Washington Ave. KBA Project #1713

Ms. Janine Glaeser:

The exterior lighting will be a combination of wall sconces and downlights. We are required to provide illumination at each exit door to light the exit pathway. The main entry will have a recessed downlight and each balcony/patio will have a wall sconce light fixture. The exact light fixtures are yet to be determined.

Sincerely,

Kevin Burow, AIA





ISSUED
Issued for Review - June 1, 2018
Issued for UDC Supplement - July 2, 2018

# NORTHEAST ELEVATION 1/8"=1'-0"



NORTHWEST ELEVATION

A-2.1 | 1/8"=1'-0"

\ ALONG WEST WASHINGTON

555 W Washington Ave.

Exterior Elevations

PROJECT TITLE

EXTERIOR MATERIAL SCHEDULE		
BRICK	BRAMPTON - MORGAN - QUEEN SIZE	
STONE MASONRY	CORDOVA - BUFF	
PANELS & TRIM	COMPOSITE SIDING - DARK BRONZE	
WINDOWS	FIBREX - DARK BRONZE	
RAILING	ALUMINUM - DARK BRONZE	

SHEET NUMBER

A-2.

FACIA

ALUMINUM - MATCH TRIM

PROJECT NO. 1713

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A-2.2 | 1/8"=1'-0"



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# TYPICAL MATERIALS

ALUMINUM WRAPPED FACIA

COMPOSITE TRIM

COMPOSITE METAL PANELS

BRICK VENEER

ALUMINUM RAILINGS

VINYL WINDOWS

CAST STONE SILLS & BANDS

COMPOSITE SIDING

PROJECT TITLE

555 W Washington Ave.

SHEET TITLE

Exterior

Elevations

SHEET NUMBER

A-2.2

PROJECT NO. | 7 | 3

	SOUTHEAST ELEVATION
A-2.2	1/8"=1'-0"

EXTERIOR MATERIAL SCHEDULE		
BRICK	BRAMPTON - MORGAN - QUEEN SIZE	
STONE MASONRY	CORDOVA - BUFF	
PANELS & TRIM	COMPOSITE SIDING - DARK BRONZE	
WINDOWS	FIBREX - DARK BRONZE	
RAILING	ALUMINUM - DARK BRONZE	
FACIA	ALUMINUM - MATCH TRIM	