DEGEN UNIVERSITY AVENUE MIXED-USE





MADISON, WISCONSIN




UDC FINAL



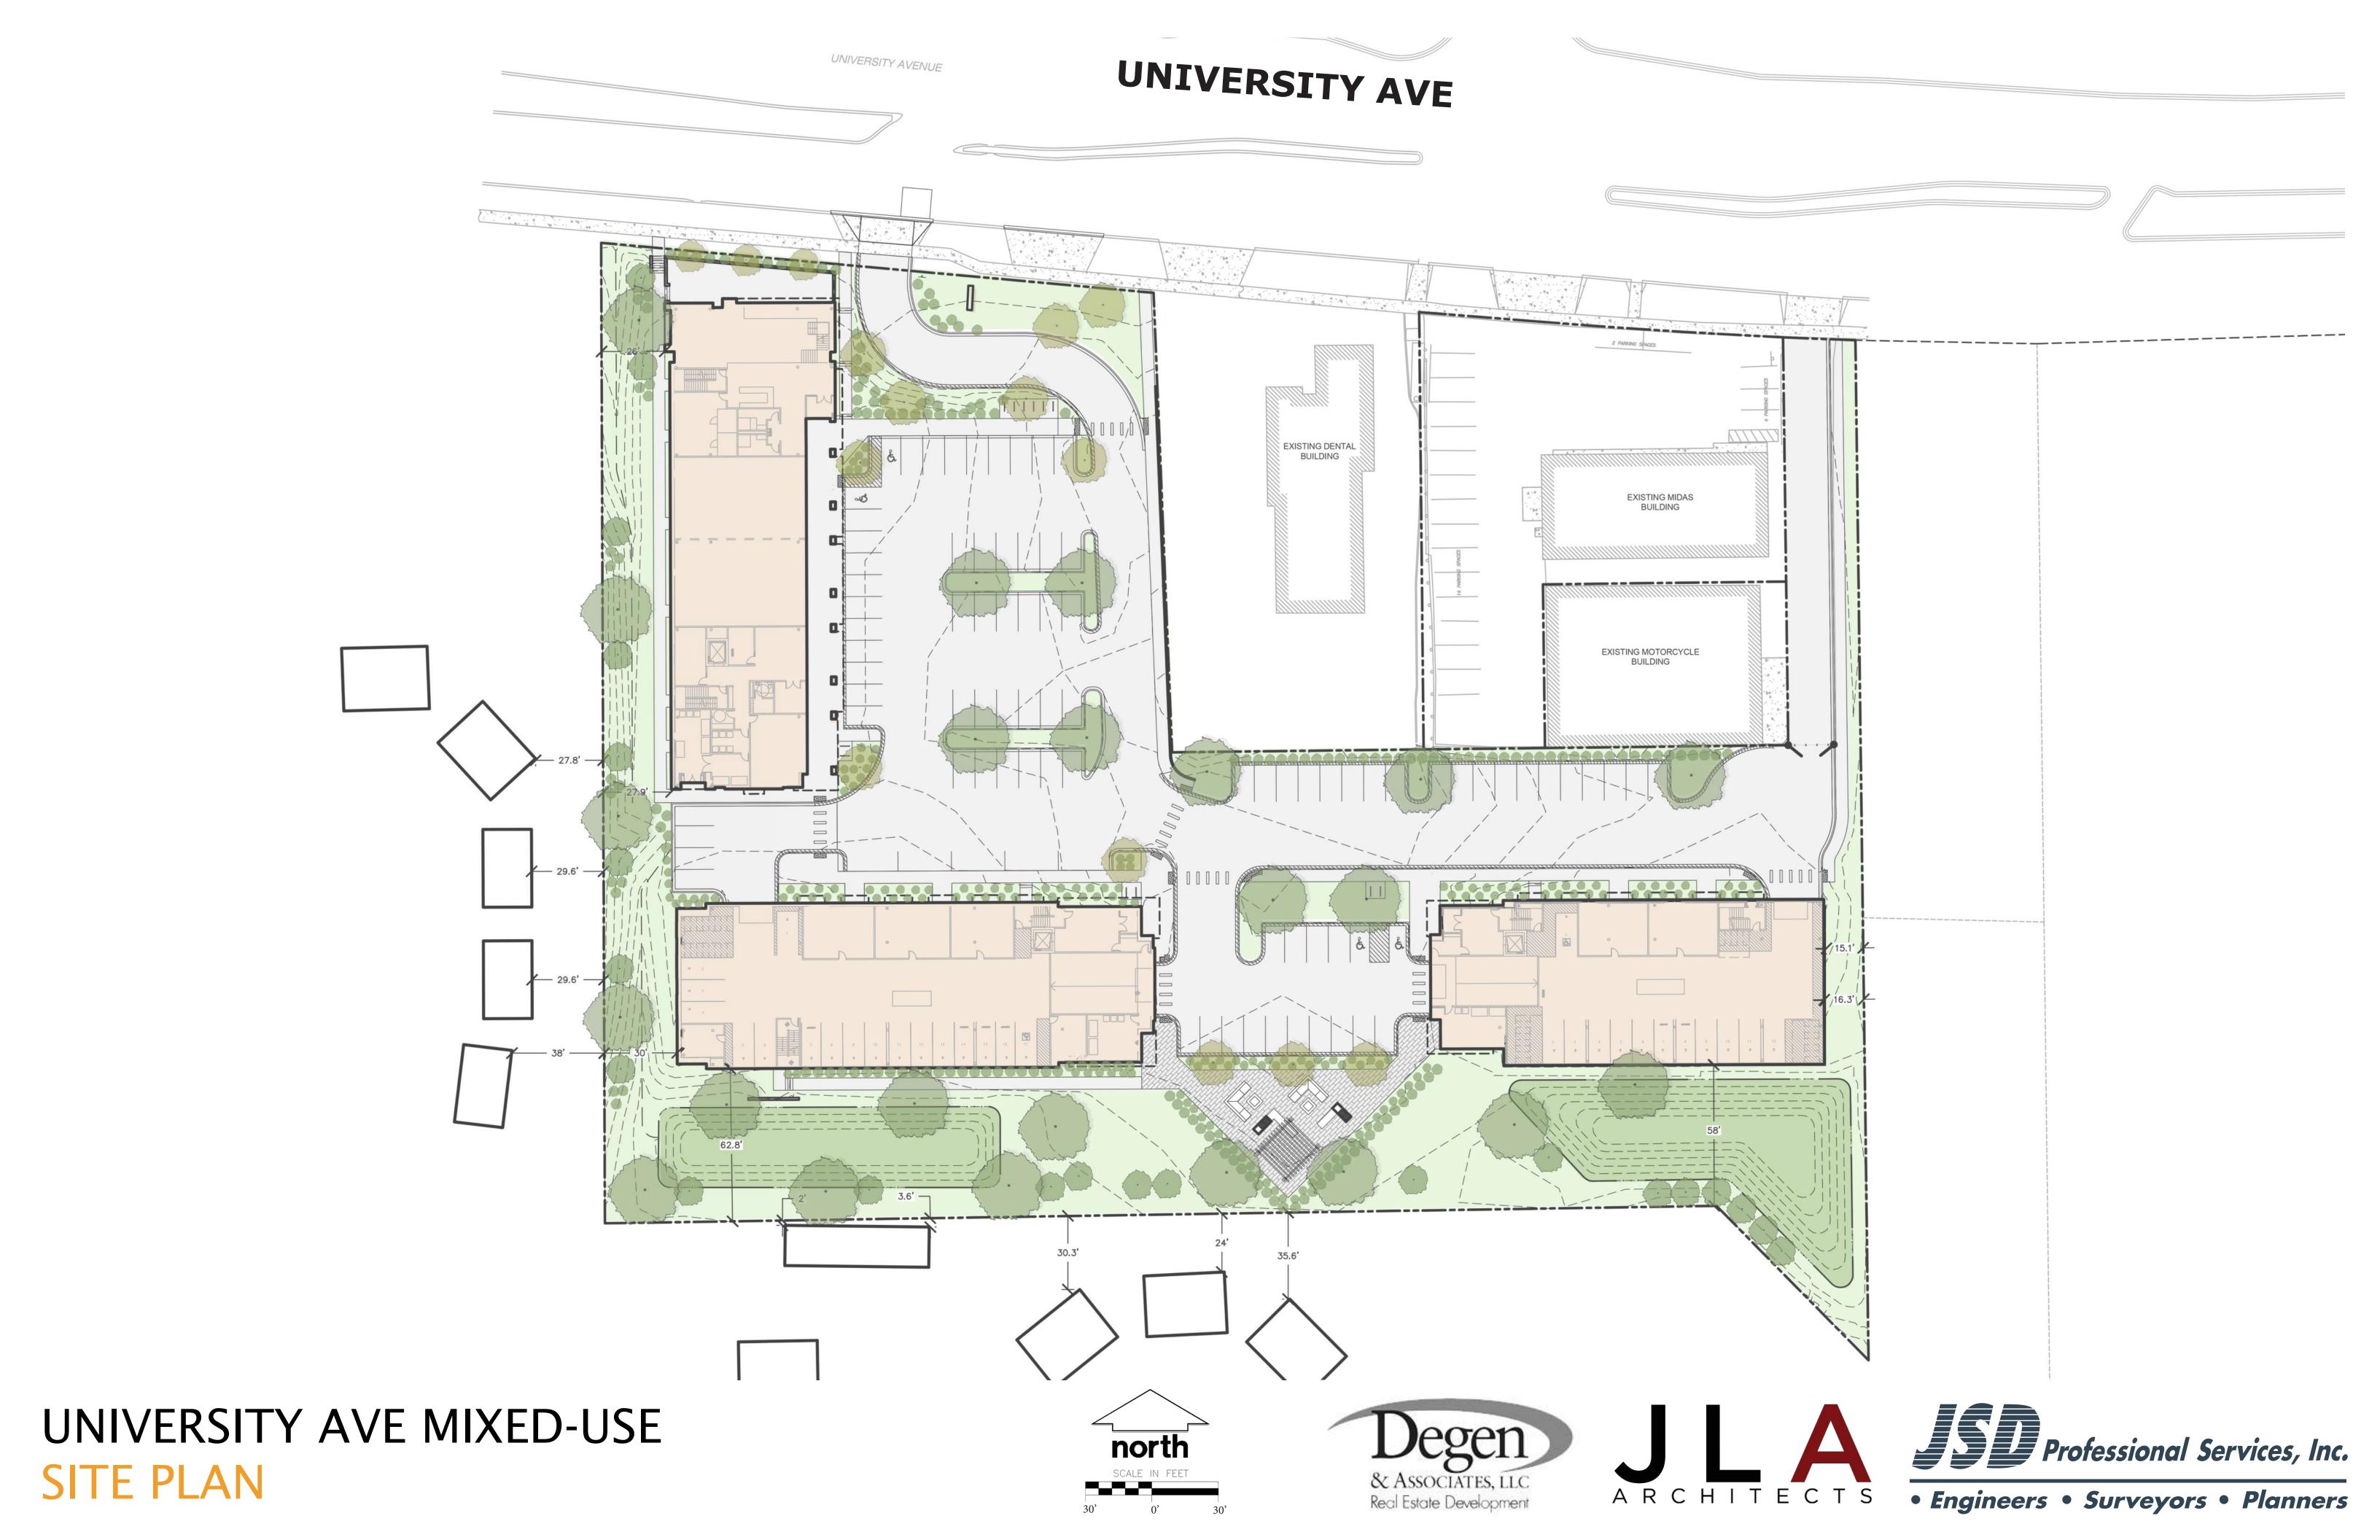

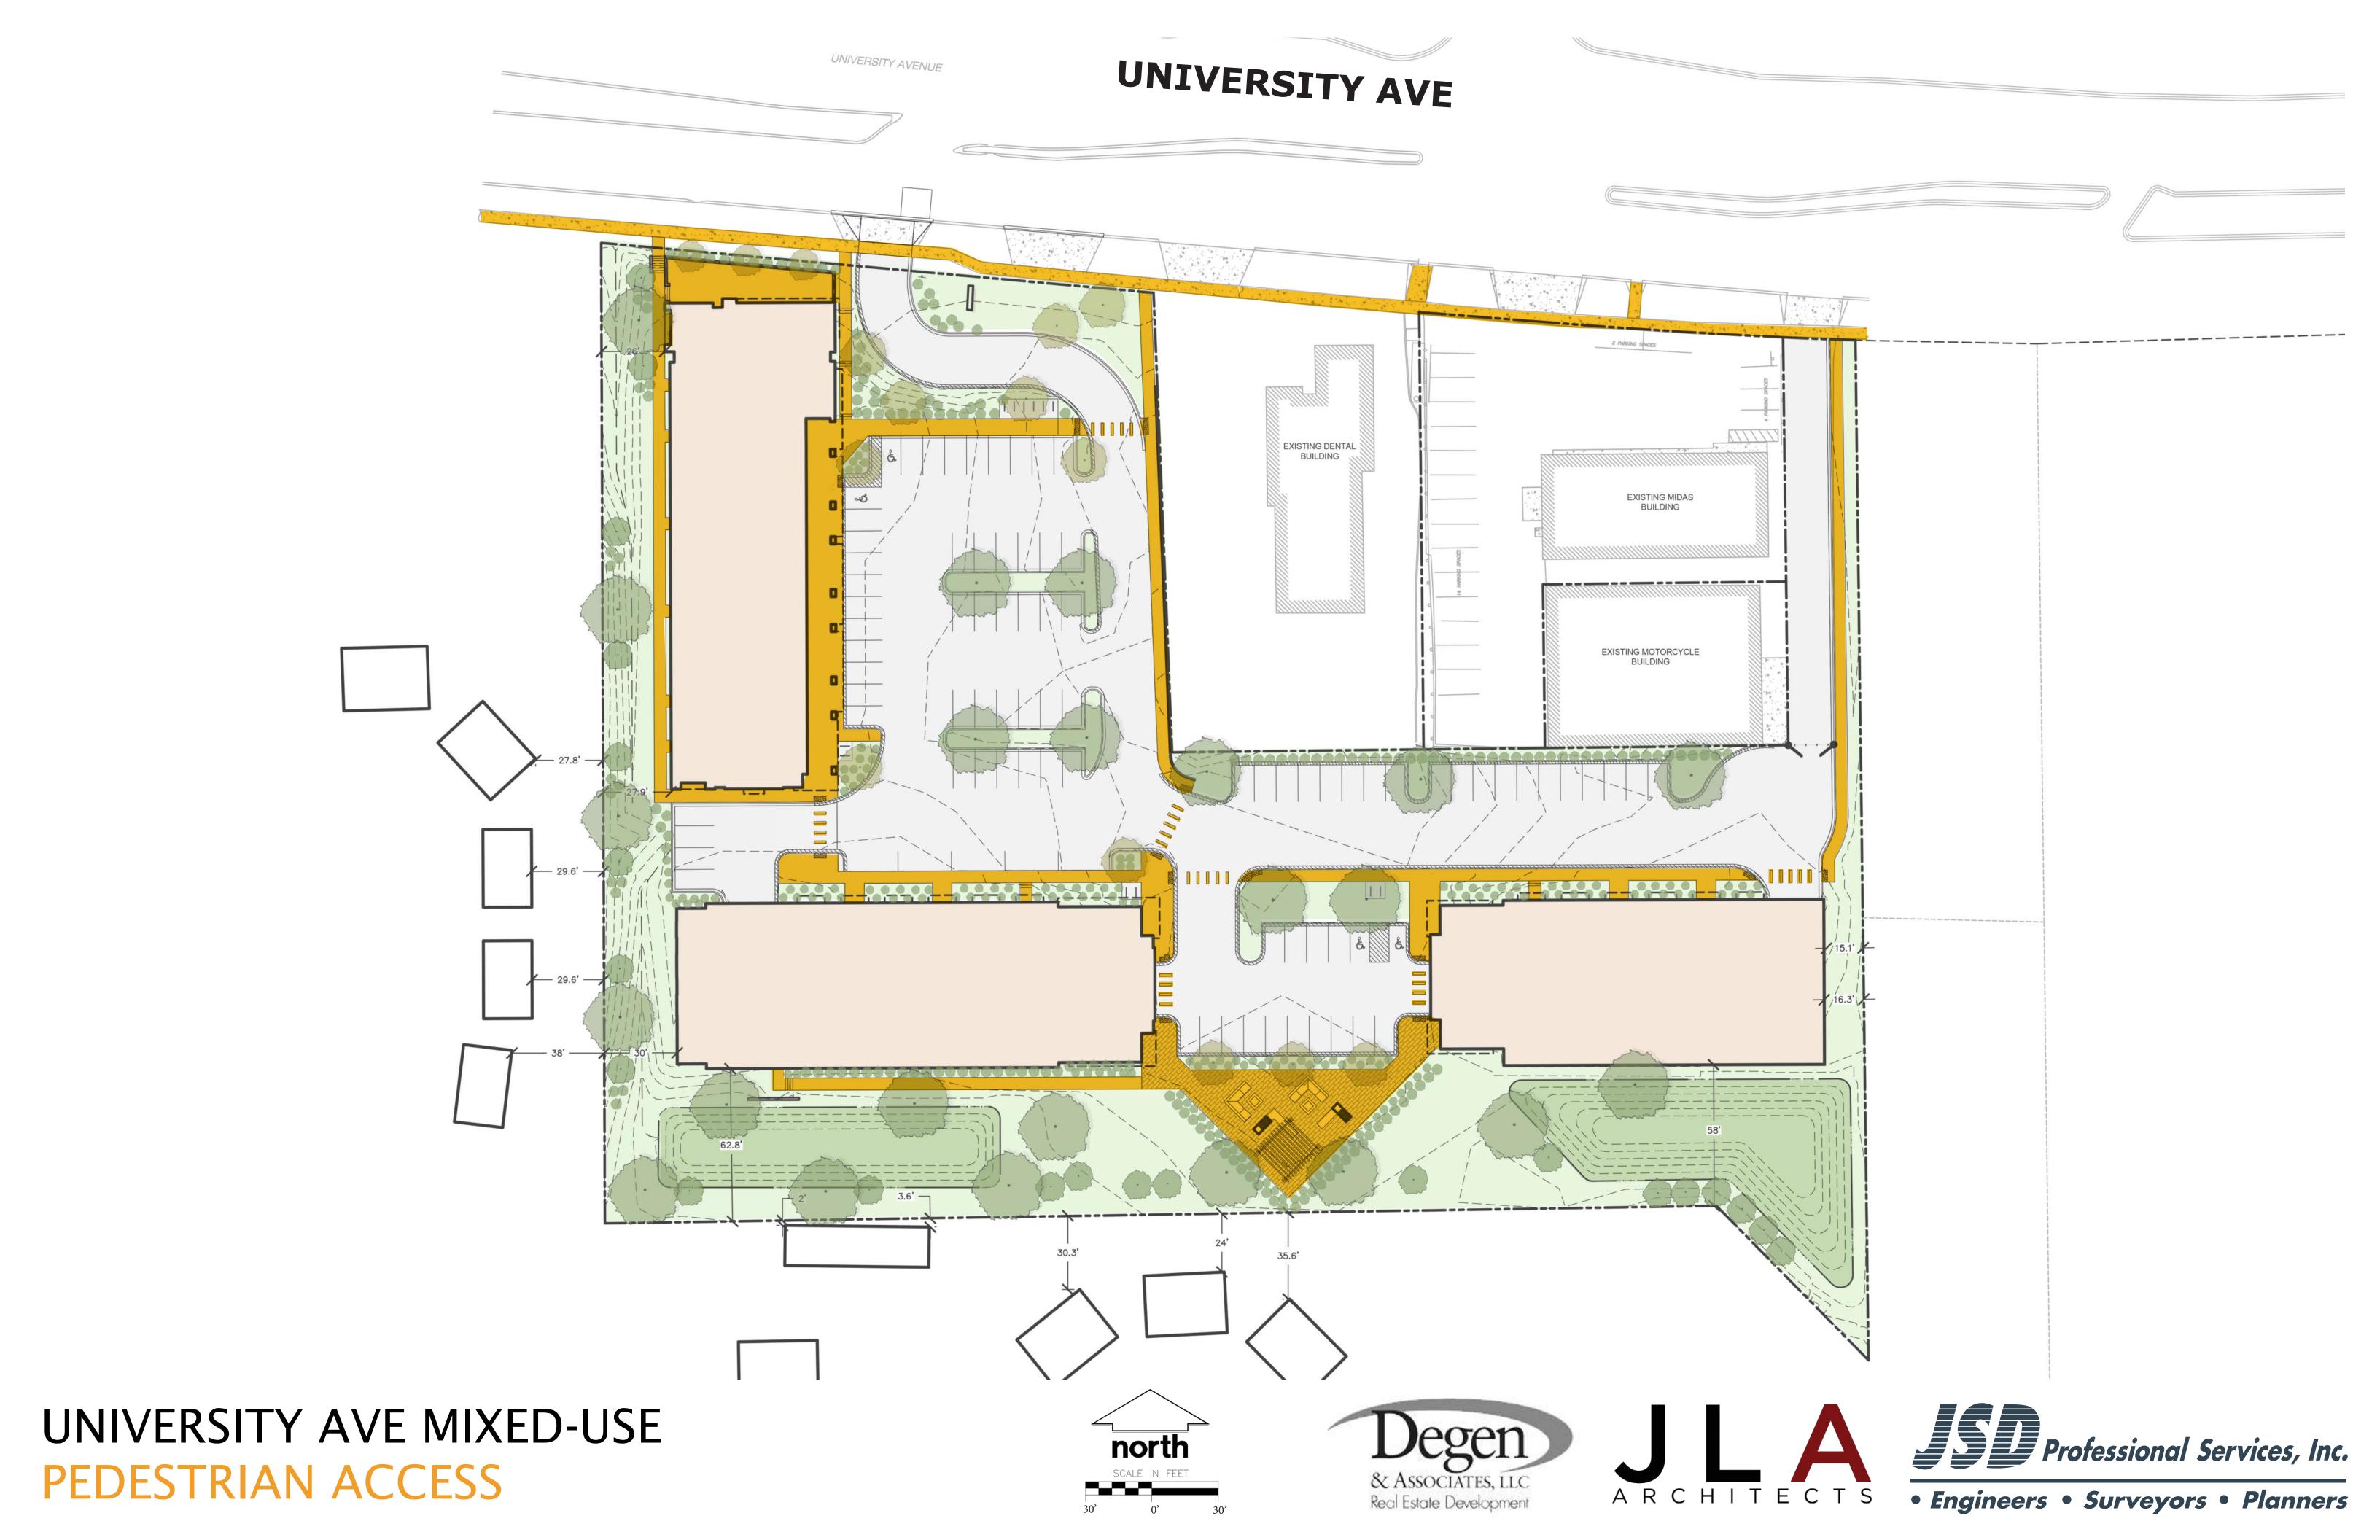

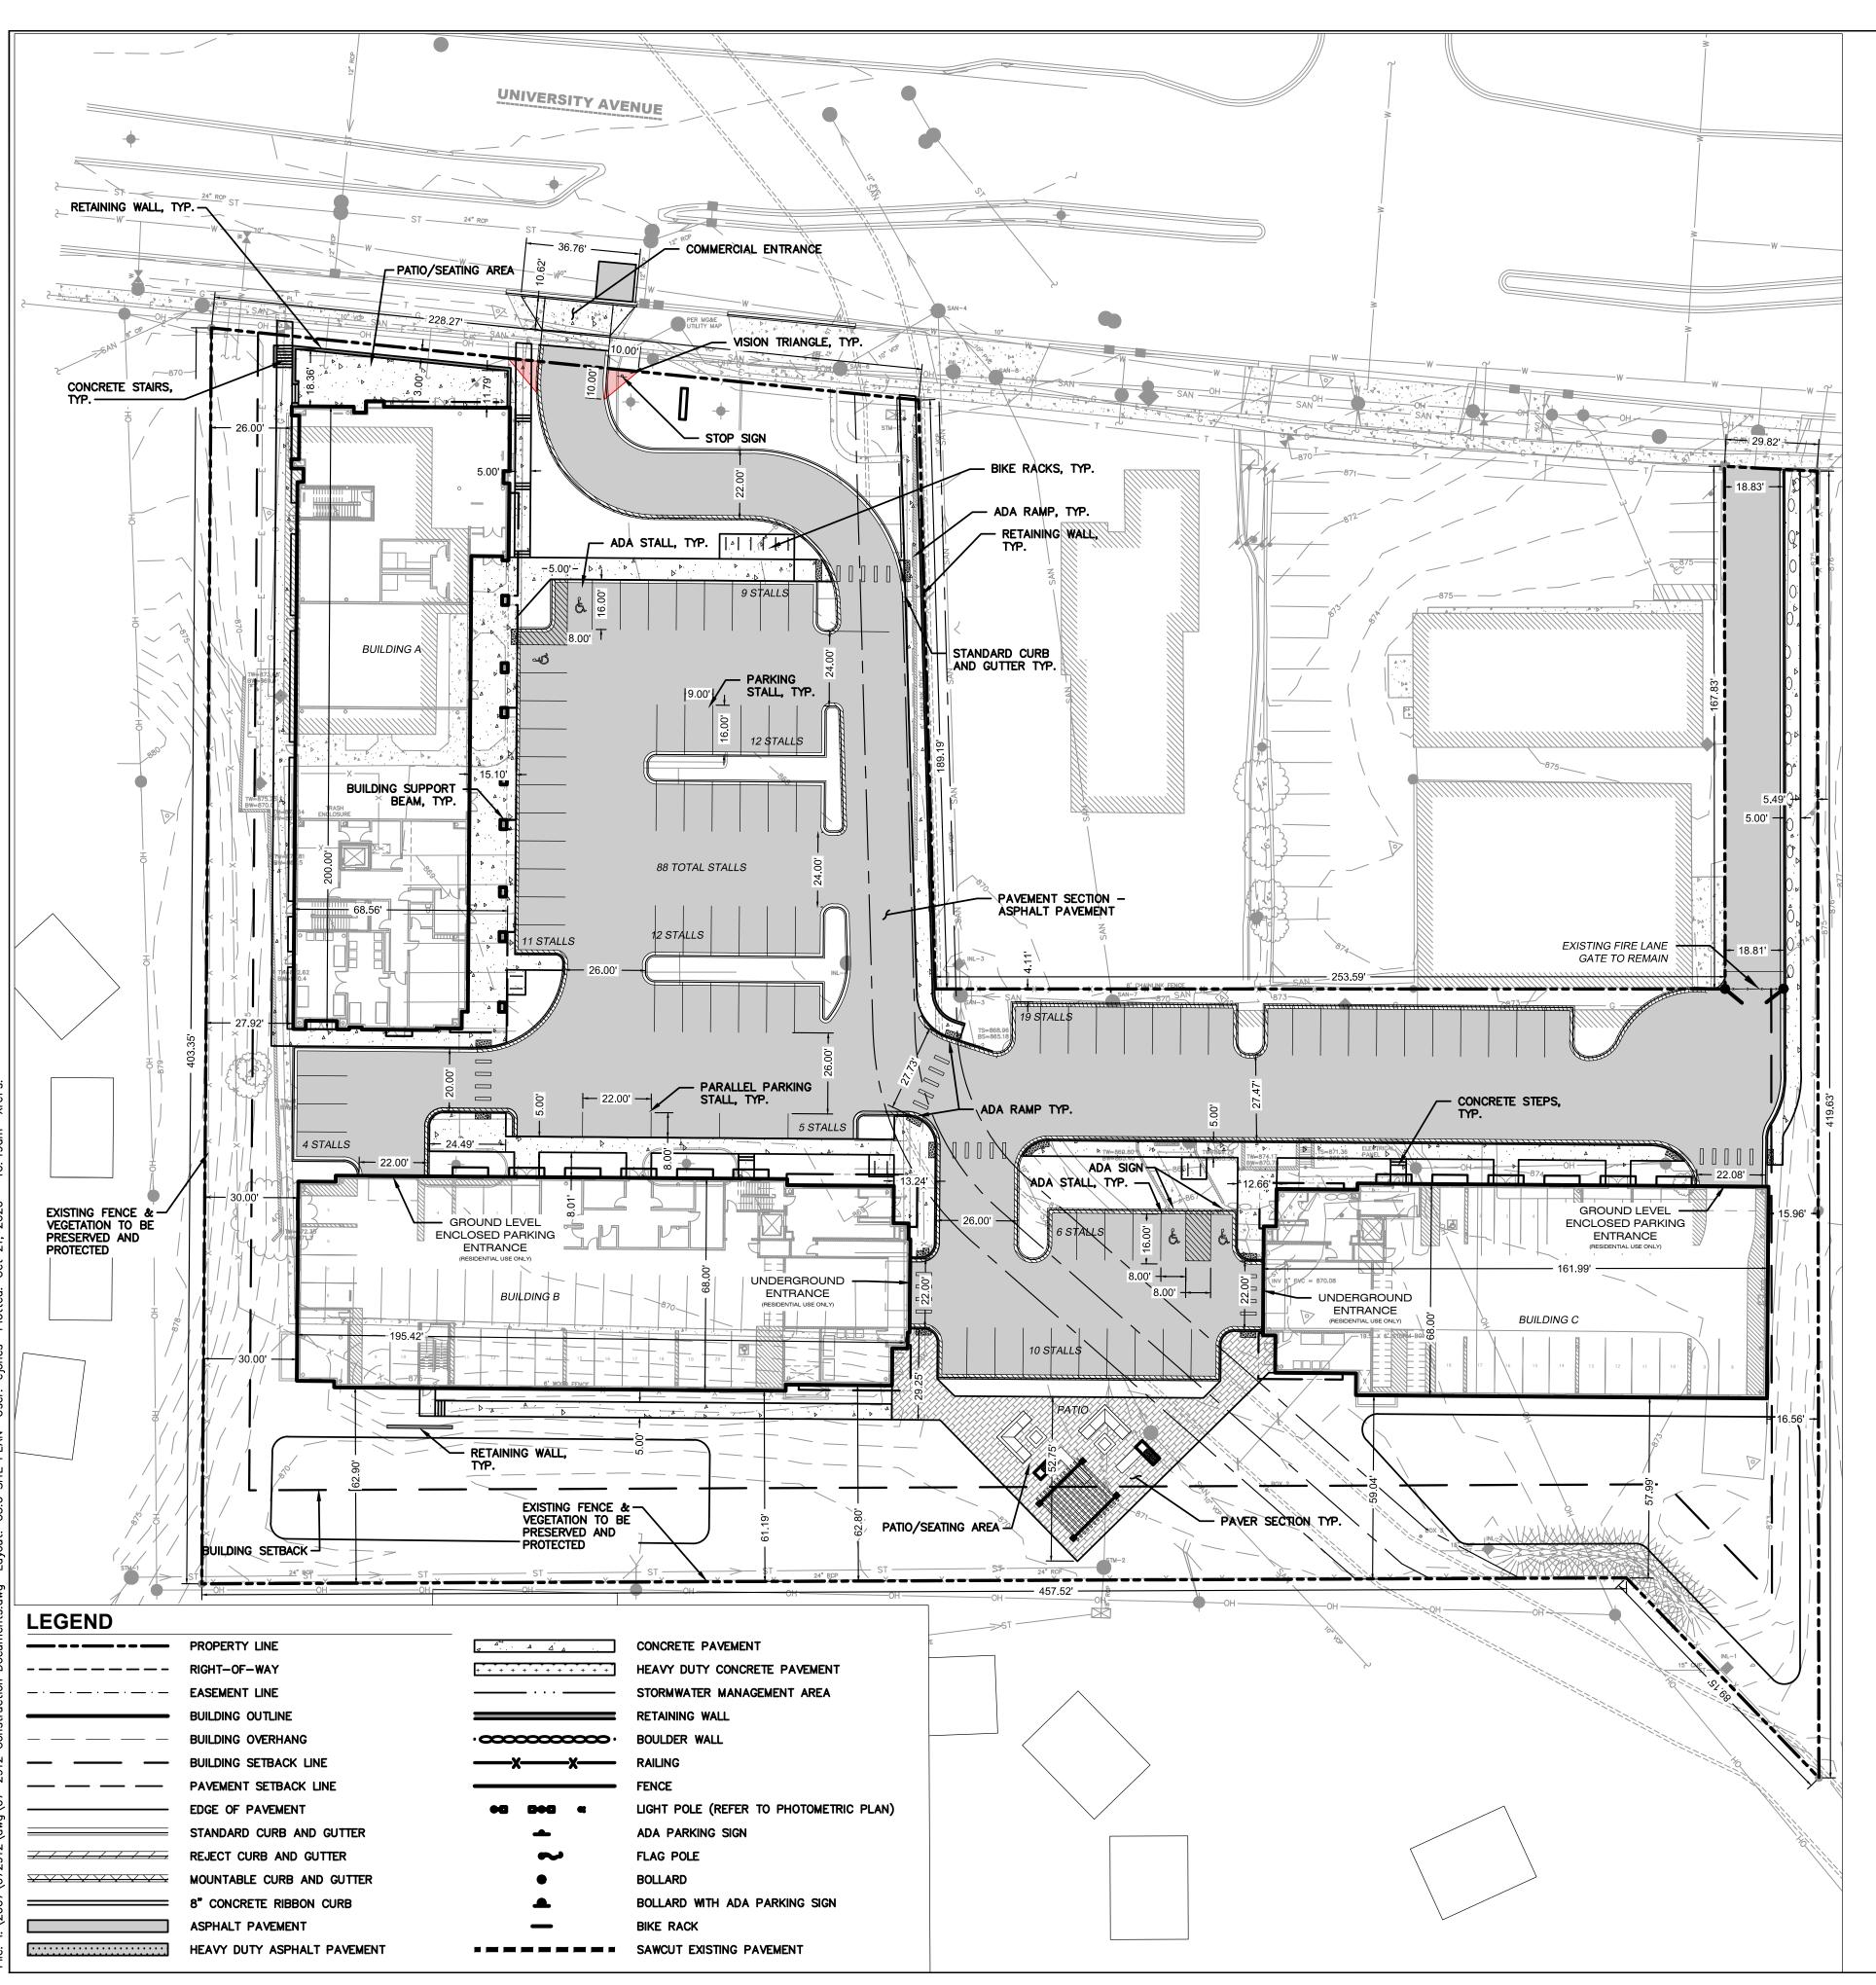

GENERAL NOTES

- 1. REFER TO THE EXISTING CONDITIONS SURVEY FOR EXISTING CONDITIONS NOTES AND LEGENDS.
- ALL WORK IN THE ROW AND/OR PUBLIC EASEMENTS SHALL BE IN ACCORDANCE WITH THE STANDARD SPECIFICATIONS FOR SEWER & WATER CONSTRUCTION IN WISCONSIN AND MUNICIPAL REQUIREMENTS.
- 3. EXISTING GRADE SPOT ELEVATIONS SHOWN FOR INFORMATIONAL PURPOSES. DURING CONSTRUCTION MATCH EXISTING GRADES AT CONSTRUCTION LIMITS.
- NO SITE GRADING OUTSIDE OR DOWNSLOPE OF PROPOSED SILT FENCE LOCATION. NO LAND DISTURBANCE BEYOND PROPERTY LINES.
- 5. JSD SHALL BE HELD HARMLESS AND DOES NOT WARRANT ANY DEVIATIONS BY THE OWNER/CONTRACTOR FROM THE APPROVED CONSTRUCTION PLANS THAT MAY RESULT IN DISCIPLINARY ACTIONS BY ANY OR ALL REGULATORY AGENCIES.

PAVING NOTES

1. GENERAL

- 1.1. ALL PAVING SHALL CONFORM TO "STATE OF WISCONSIN STANDARD SPECIFICATIONS FOR HIGHWAY & STRUCTURE CONSTRUCTION, LATEST EDITION, APPLICABLE CITY OF MADISON ORDINANCES AND THE GEOTECHNICAL REPORT PREPARED BY CGC, INC. DATED 4/6/2018.
- 1.2. ALL PAVING DIMENSIONS ARE TO FACE OF CURB UNLESS SPECIFIED OTHERWISE.
- 1.3. SURFACE PREPARATION NOTIFY CONTRACTOR OF UNSATISFACTORY CONDITIONS. DO NOT BEGIN PAVING WORK UNTIL DEFICIENT SUBBASE AREAS HAVE BEEN CORRECTED AND ARE READY TO RECEIVE PAVING.
- 1.4. ANY REQUIRED REPLACEMENT OF PUBLIC CURB AND GUTTER SHALL MATCH EXISTING AND MEET MUNICIPALITY REQUIREMENTS.

2. ASPHALTIC CONCRETE PAVING SPECIFICATIONS

- 2.1. CODES AND STANDARDS THE PLACING, CONSTRUCTION AND COMPOSITION OF THE ASPHALTIC BASE COURSE AND ASPHALTIC CONCRETE SURFACE COURSE SHALL BE IN ACCORDANCE WITH THE REQUIREMENTS OF SECTIONS 450, 455, 460 AND 465 OF THE STATE OF WISCONSIN STANDARD SPECIFICATIONS FOR HIGHWAY AND STRUCTURE CONSTRUCTION, LATEST EDITION. HEREAFTER, THIS PUBLICATION WILL BE REFERRED TO AS STATE HIGHWAY SPECIFICATIONS.
- 2.2. WEATHER LIMITATIONS APPLY TACK COATS WHEN AMBIENT TEMPERATURE IS ABOVE 50° F (10° C) AND WHEN TEMPERATURE HAS NOT BEEN BELOW 35° F (1° C) FOR 12 HOURS IMMEDIATELY PRIOR TO APPLICATION. DO NOT APPLY WHEN BASE IS WET OR CONTAINS EXCESS OF MOISTURE. CONSTRUCT ASPHALTIC CONCRETE SURFACE COURSE WHEN ATMOSPHERIC TEMPERATURE IS ABOVE 40° F (4° C) AND WHEN BASE IS DRY AND WHEN WEATHER IS NOT RAINY. BASE COURSE MAY BE PLACED WHEN AIR TEMPERATURE IS ABOVE 30° F (-1° C).
- 2.3. GRADE CONTROL ESTABLISH AND MAINTAIN REQUIRED LINES AND ELEVATIONS FOR EACH COURSE DURING CONSTRUCTION.
- 2.4. CRUSHED AGGREGATE BASE COURSE THE TOP LAYER OF BASE COURSE SHALL CONFORM TO SECTIONS 301 AND 305, STATE HIGHWAY SPECIFICATIONS.
- 2.5. BINDER COURSE AGGREGATE THE AGGREGATE FOR THE BINDER COURSE SHALL CONFORM TO SECTIONS 460 AND 315, STATE HIGHWAY SPECIFICATIONS.
- 2.6. SURFACE COURSE AGGREGATE THE AGGREGATE FOR THE SURFACE COURSE SHALL CONFORM TO SECTIONS 460 AND 465, STATE HIGHWAY SPECIFICATIONS.
- 2.7. ASPHALTIC MATERIALS THE ASPHALTIC MATERIALS SHALL CONFORM TO SECTION 455 AND 460, STATE HIGHWAY SPECIFICATIONS.


3. CONCRETE PAVING SPECIFICATIONS

- 3.1. CONCRETE PAVING SHALL BE IN ACCORDANCE WITH THE REQUIREMENTS OF SECTIONS 415 AND 416 OF THE STATE HIGHWAY SPECIFICATIONS.
- 3.2. CONCRETE PAVEMENT SHALL BE REINFORCED WITH NOVOMESH 950 (OR EQUAL) FIBER REINFORCEMENT AT A RATE OF 5 LBS/CUBIC YARD.
- 3.3. CURING COMPOUNDS SHALL CONFORM TO SECTION 415 OF THE STATE HIGHWAY SPECIFICATIONS.
- 3.4. CONTRACTOR SHALL PROVIDE CONTROL JOINTS AND CONSTRUCTION JOINTS OF ONE—QUARTER CONCRETE THICKNESS AT AN EQUAL RATIO OF LENGTH TO WIDTH WHEREVER POSSIBLE WITH A MAXIMUM LENGTH BETWEEN JOINTS OF 8' ON CENTER.
- 3.5. CONTRACTOR SHALL PROVIDE EXPANSION JOINTS IN SIDEWALKS AT A MAXIMUM 24' ON CENTER.
- 3.6. EXTERIOR CONCRETE SURFACES SHALL BE BROOM FINISHED.
- 3.7. ALL CONCRETE SURFACES TO BE SEALED WITH TYPE TK-26UV CONCRETE SEALANT.

4. PAVEMENT MARKING SPECIFICATIONS

- 4.1. USE 4" WIDE, HIGH VISIBILITY YELLOW LATEX PAINT FOR STALL LINES.
- 4.2. MARK AND STRIPE ADA PARKING SPACES APPROPRIATELY.
- 4.3. ALL PAVEMENT MARKINGS INCLUDING: STOP BARS, CROSSWALKS, DIRECTIONAL ARROWS, PARKING STALL LINES, ADA STALL MARKINGS, NO PARKING ZONES, DROP-OFF/PICK-UP ZONES SHALL BE PAINTED WITH LATEX PAINT PER SPECIFICATIONS.
- 4.4. 2' x 5' TRUNCATED DOME WARNING DETECTION FIELD SHALL BE PLACED AT ALL ADA RAMPS.

SITE II	IFORMATION BLOCK
Site Address	5133 & 5237 University Ave
Site Acreage (total)	3.482 Acres
Number of Building Stories-	- Building A, B,& C
(above grade)	3-4
Total Building Square Foota	ge-Building A 11,729 SF
Total Building Square Foota	ge-Building B 13,036 SF
Total Building Square Foota	ge-Building C 10,648 SF
Use of property	Mixed Use—Commercial/Residentia
Number of parking stalls:	minou des destinations, received
Automobile Stall	84
Underground/In-Building	Automobile Stall 12
Accessible	10 (4 SURFACE, 6 IN-BUILDING
Total Automobile Stalls	21:
Bicycle	110
Impervious vs. Pervious Are	ıs:
Existing Impervious	76,993 S.F
Existing Pervious	74,684 S.F
Existing Impervious/F	ervious Ratio 0.5
Proposed Impervious	100,618 S.F
Proposed Pervious	51,059 S.F
Proposed Impervious/	Pervious Ratio 0.6
Required Usable Open Sp	ace 34,000 S.F
Proposed Usable Open S	pace 35,747 S.F
Site	30,566 S.F
Balconies	5,181 S.F

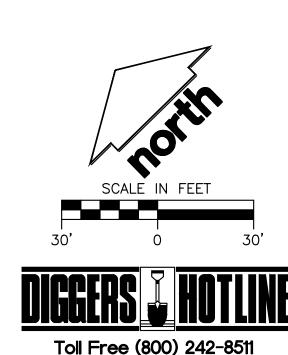



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161 HORIZON DRIVE, SUITE 101

VERONA, WISCONSIN 53593

P. 608.848.5060

CLIENT

DEGEN & ASSOCIATES, LLC

CLIENT ADDRESS:

PO BOX 5567 MADISON, WI 53705-0567

5133 & 5237 UNIVERSITY AVE

PROJECT LOCATION:

MADISON, WI


DANE COUNTY


PLAN MODIFICATIONS:

JSD PROJECT NO:

Date:	Description:
01.15.2020	LAND USE UDC INITIAL
04.17.2020	LAND USE RESUBMITTAL
10 21 2020	LAND USE RESUBMITTAL UDC FINAL
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07-2912



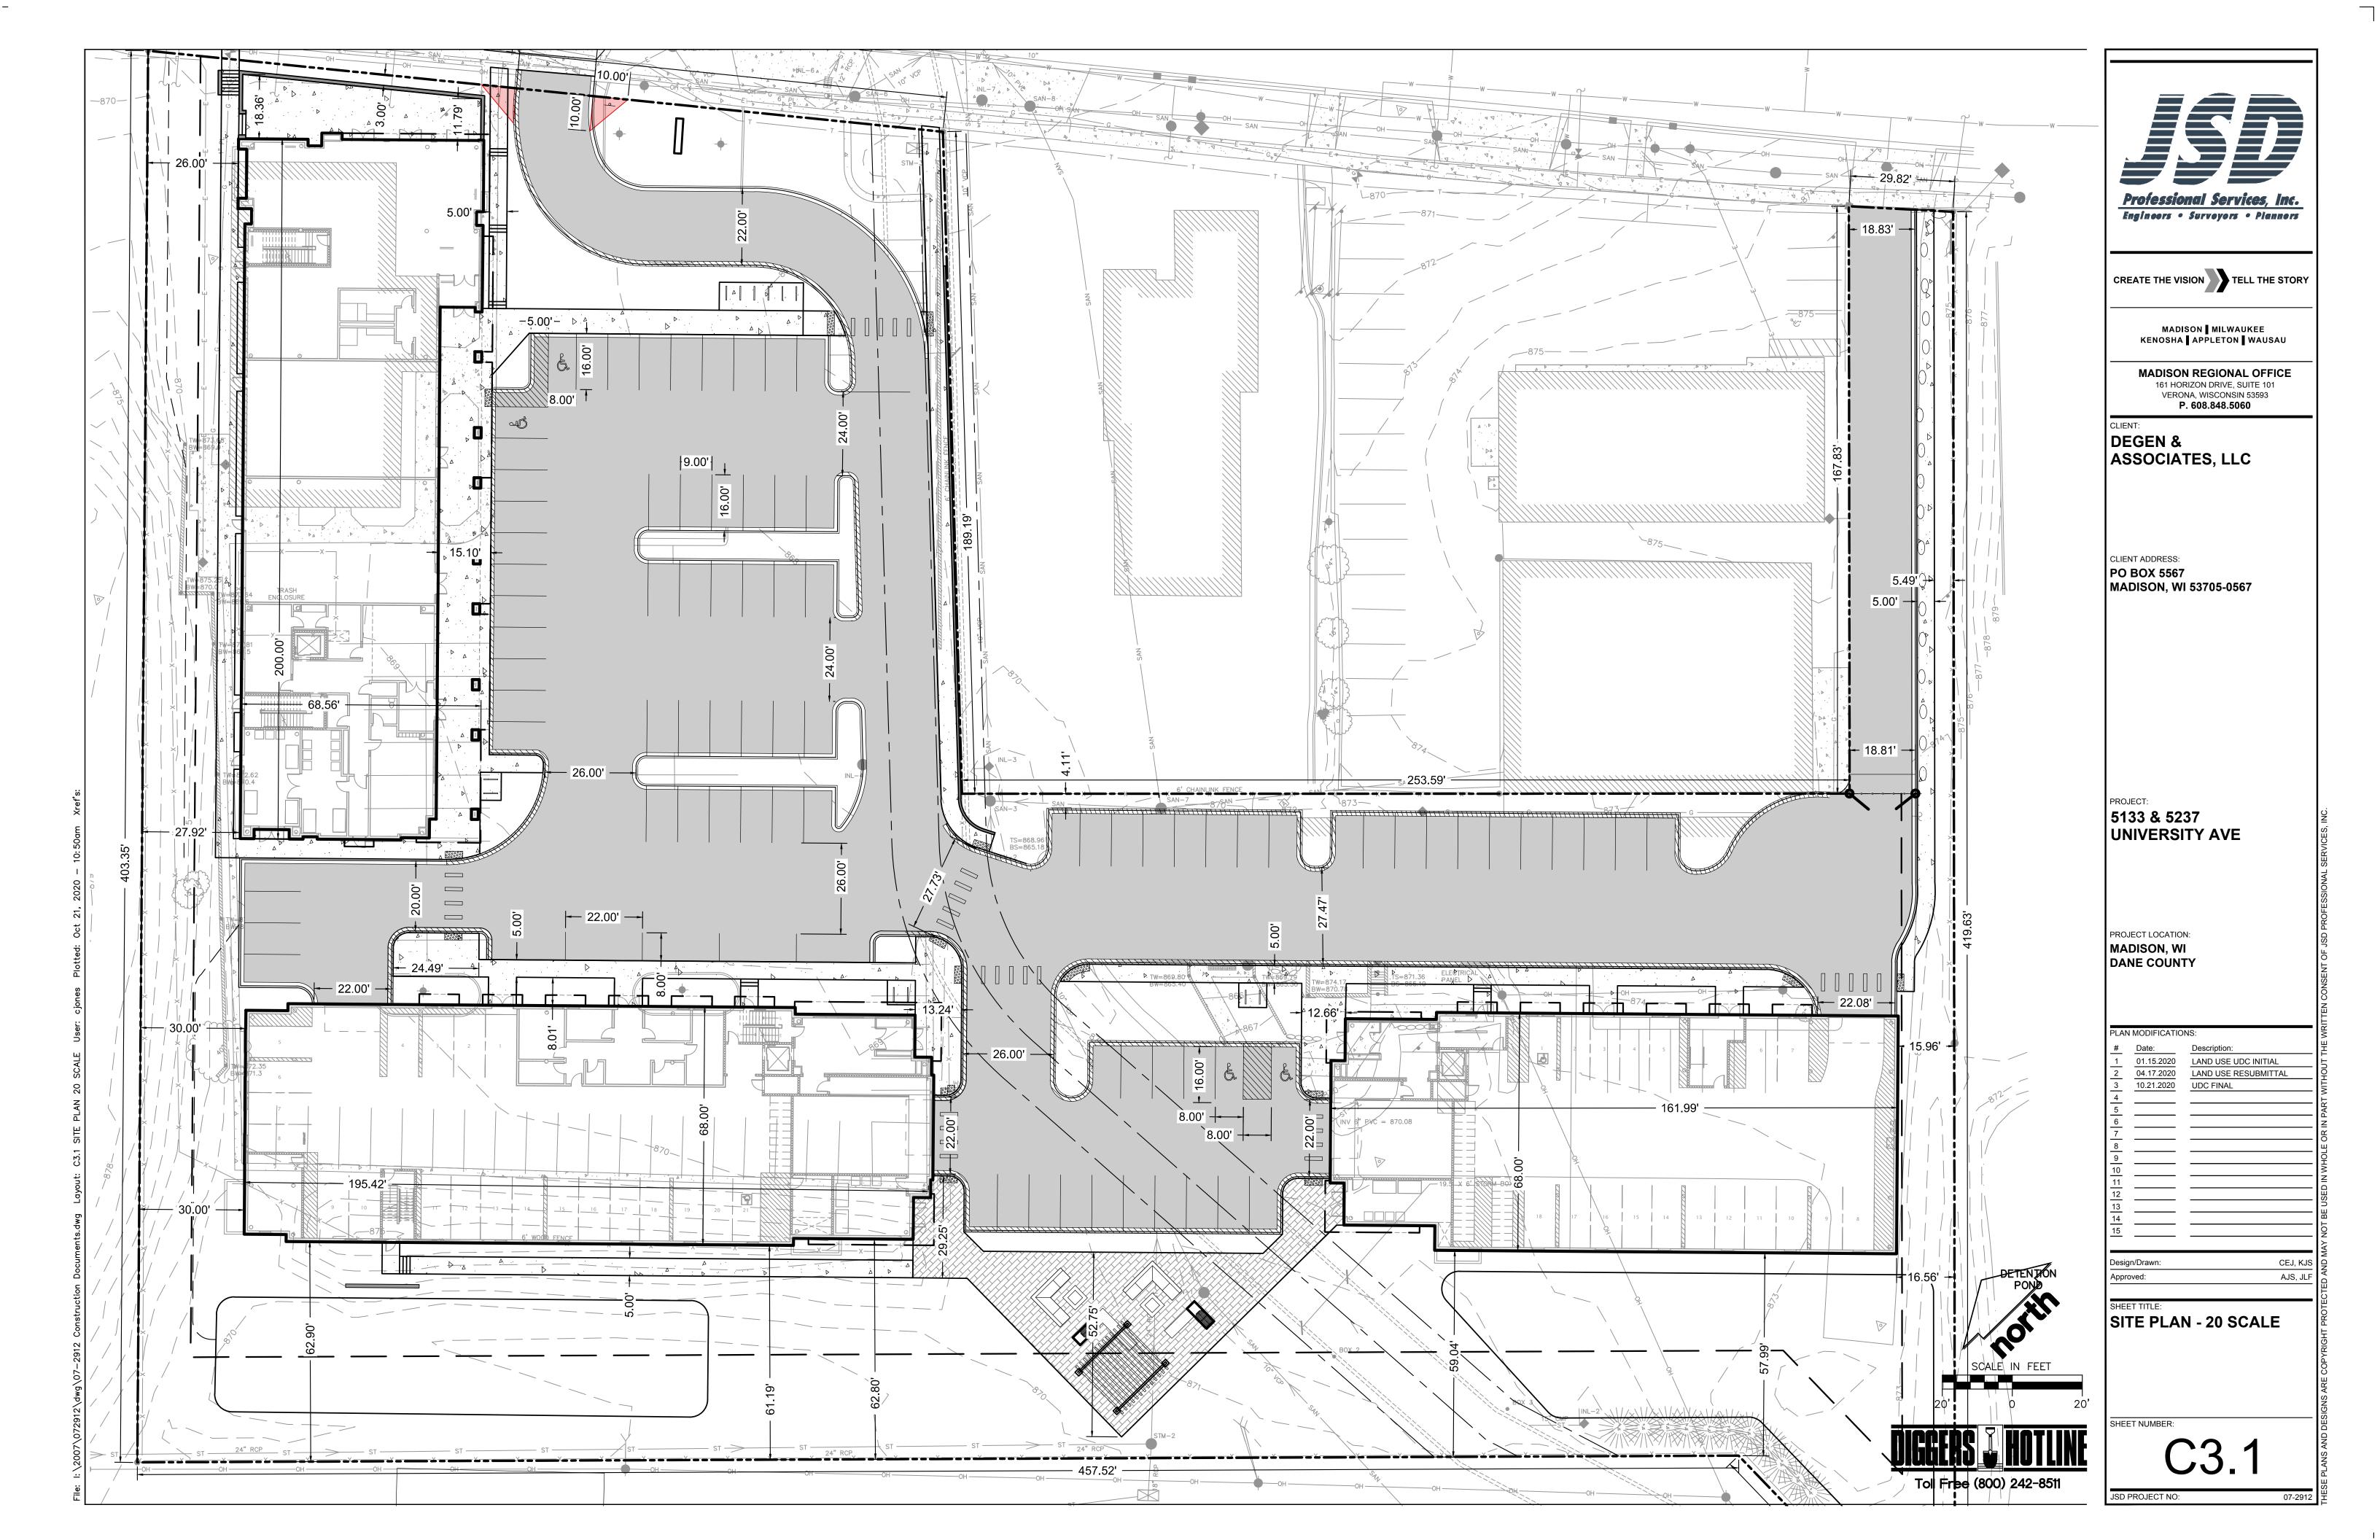

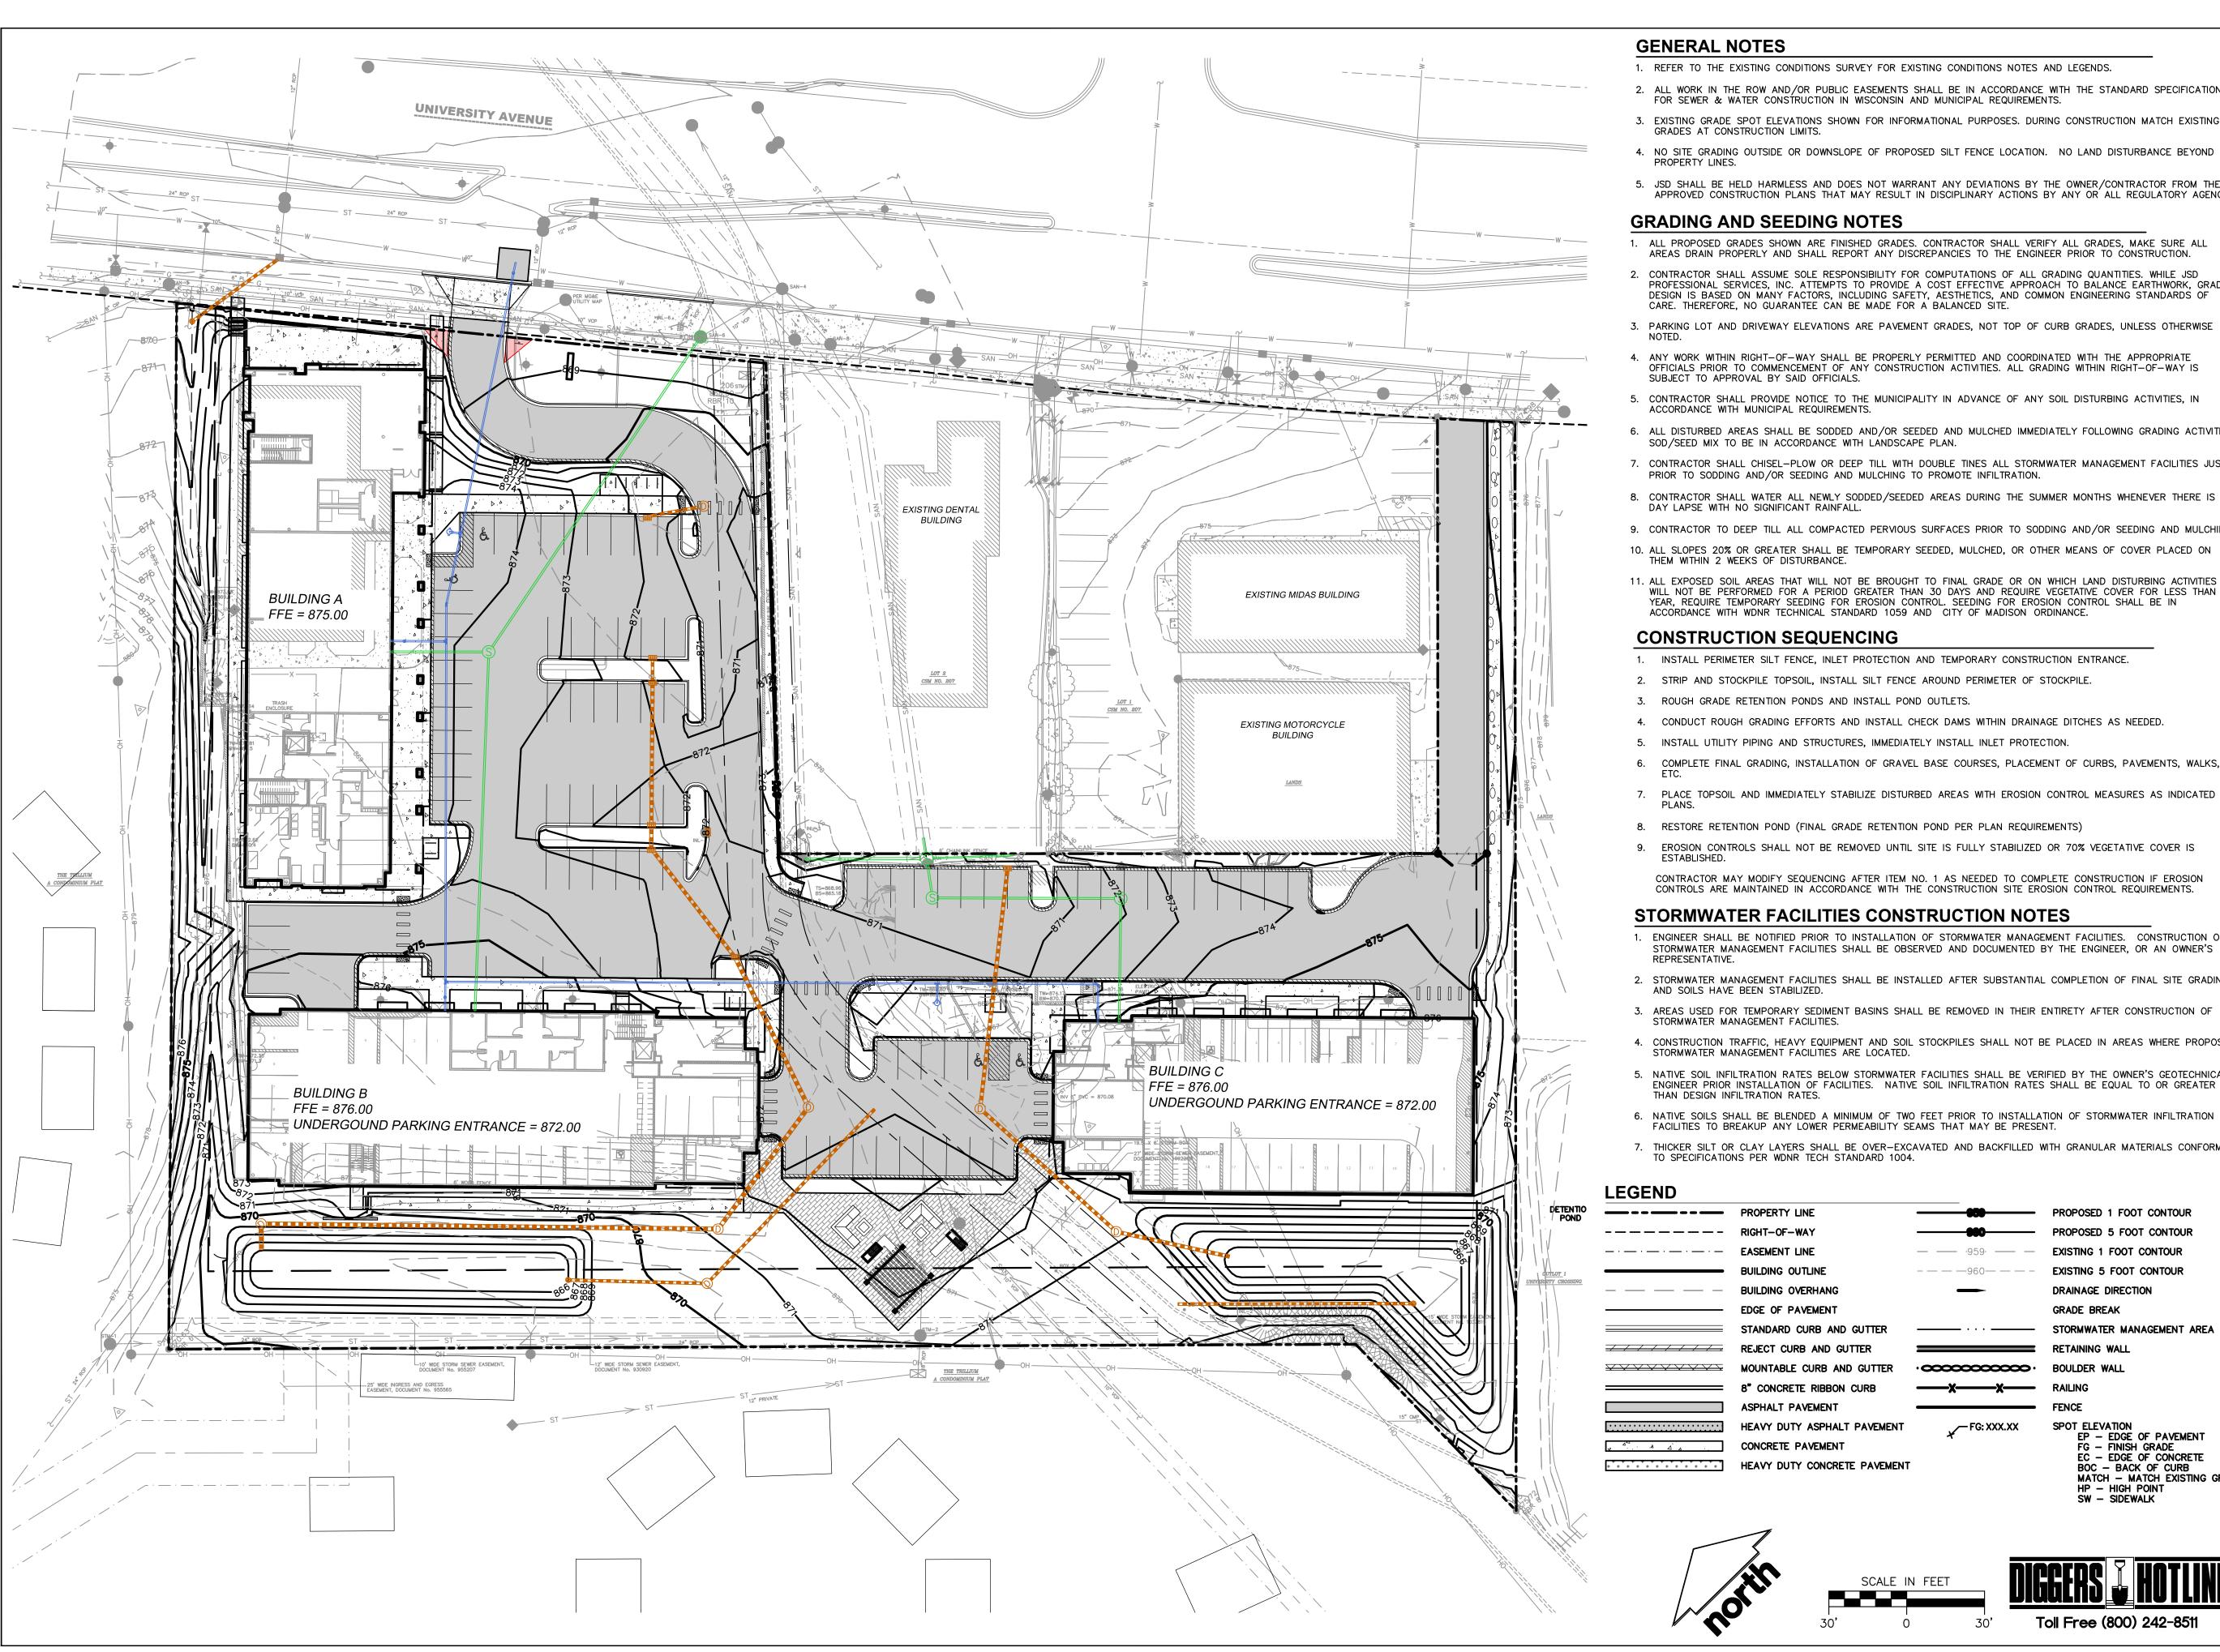GENERAL NOTES

- 1. REFER TO THE EXISTING CONDITIONS SURVEY FOR EXISTING CONDITIONS NOTES AND LEGENDS.
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- 3. EXISTING GRADE SPOT ELEVATIONS SHOWN FOR INFORMATIONAL PURPOSES. DURING CONSTRUCTION MATCH EXISTING GRADES AT CONSTRUCTION LIMITS.
- 4. NO SITE GRADING OUTSIDE OR DOWNSLOPE OF PROPOSED SILT FENCE LOCATION. NO LAND DISTURBANCE BEYOND PROPERTY LINES.
- 5. JSD SHALL BE HELD HARMLESS AND DOES NOT WARRANT ANY DEVIATIONS BY THE OWNER/CONTRACTOR FROM THE APPROVED CONSTRUCTION PLANS THAT MAY RESULT IN DISCIPLINARY ACTIONS BY ANY OR ALL REGULATORY AGENCIES

GRADING AND SEEDING NOTES

- ALL PROPOSED GRADES SHOWN ARE FINISHED GRADES. CONTRACTOR SHALL VERIFY ALL GRADES, MAKE SURE ALL AREAS DRAIN PROPERLY AND SHALL REPORT ANY DISCREPANCIES TO THE ENGINEER PRIOR TO CONSTRUCTION.
- CONTRACTOR SHALL ASSUME SOLE RESPONSIBILITY FOR COMPUTATIONS OF ALL GRADING QUANTITIES. WHILE JSD PROFESSIONAL SERVICES, INC. ATTEMPTS TO PROVIDE A COST EFFECTIVE APPROACH TO BALANCE EARTHWORK, GRADING DESIGN IS BASED ON MANY FACTORS, INCLUDING SAFETY, AESTHETICS, AND COMMON ENGINEERING STANDARDS OF CARE. THEREFORE, NO GUARANTEE CAN BE MADE FOR A BALANCED SITE.
- 3. PARKING LOT AND DRIVEWAY ELEVATIONS ARE PAVEMENT GRADES, NOT TOP OF CURB GRADES, UNLESS OTHERWISE
- 4. ANY WORK WITHIN RIGHT-OF-WAY SHALL BE PROPERLY PERMITTED AND COORDINATED WITH THE APPROPRIATE OFFICIALS PRIOR TO COMMENCEMENT OF ANY CONSTRUCTION ACTIVITIES. ALL GRADING WITHIN RIGHT-OF-WAY IS SUBJECT TO APPROVAL BY SAID OFFICIALS.
- 5. CONTRACTOR SHALL PROVIDE NOTICE TO THE MUNICIPALITY IN ADVANCE OF ANY SOIL DISTURBING ACTIVITIES, IN ACCORDANCE WITH MUNICIPAL REQUIREMENTS.
- 6. ALL DISTURBED AREAS SHALL BE SODDED AND/OR SEEDED AND MULCHED IMMEDIATELY FOLLOWING GRADING ACTIVITIES. SOD/SEED MIX TO BE IN ACCORDANCE WITH LANDSCAPE PLAN.
- 7. CONTRACTOR SHALL CHISEL-PLOW OR DEEP TILL WITH DOUBLE TINES ALL STORMWATER MANAGEMENT FACILITIES JUST PRIOR TO SODDING AND/OR SEEDING AND MULCHING TO PROMOTE INFILTRATION.
- 8. CONTRACTOR SHALL WATER ALL NEWLY SODDED/SEEDED AREAS DURING THE SUMMER MONTHS WHENEVER THERE IS A 7 DAY LAPSE WITH NO SIGNIFICANT RAINFALL.
- 9. CONTRACTOR TO DEEP TILL ALL COMPACTED PERVIOUS SURFACES PRIOR TO SODDING AND/OR SEEDING AND MULCHING.
- 10. ALL SLOPES 20% OR GREATER SHALL BE TEMPORARY SEEDED, MULCHED, OR OTHER MEANS OF COVER PLACED ON THEM WITHIN 2 WEEKS OF DISTURBANCE.
- 11. ALL EXPOSED SOIL AREAS THAT WILL NOT BE BROUGHT TO FINAL GRADE OR ON WHICH LAND DISTURBING ACTIVITIES WILL NOT BE PERFORMED FOR A PERIOD GREATER THAN 30 DAYS AND REQUIRE VEGETATIVE COVER FOR LESS THAN 1 YEAR, REQUIRE TEMPORARY SEEDING FOR EROSION CONTROL. SEEDING FOR EROSION CONTROL SHALL BE IN ACCORDANCE WITH WDNR TECHNICAL STANDARD 1059 AND CITY OF MADISON ORDINANCE.

CONSTRUCTION SEQUENCING

1. INSTALL PERIMETER SILT FENCE, INLET PROTECTION AND TEMPORARY CONSTRUCTION ENTRANCE.

- 2. STRIP AND STOCKPILE TOPSOIL, INSTALL SILT FENCE AROUND PERIMETER OF STOCKPILE.
- 3. ROUGH GRADE RETENTION PONDS AND INSTALL POND OUTLETS.
- 4. CONDUCT ROUGH GRADING EFFORTS AND INSTALL CHECK DAMS WITHIN DRAINAGE DITCHES AS NEEDED.
- 5. INSTALL UTILITY PIPING AND STRUCTURES, IMMEDIATELY INSTALL INLET PROTECTION.
- 6. COMPLETE FINAL GRADING, INSTALLATION OF GRAVEL BASE COURSES, PLACEMENT OF CURBS, PAVEMENTS, WALKS,
- 7. PLACE TOPSOIL AND IMMEDIATELY STABILIZE DISTURBED AREAS WITH EROSION CONTROL MEASURES AS INDICATED ON
- 8. RESTORE RETENTION POND (FINAL GRADE RETENTION POND PER PLAN REQUIREMENTS)
- 9. EROSION CONTROLS SHALL NOT BE REMOVED UNTIL SITE IS FULLY STABILIZED OR 70% VEGETATIVE COVER IS
- CONTRACTOR MAY MODIFY SEQUENCING AFTER ITEM NO. 1 AS NEEDED TO COMPLETE CONSTRUCTION IF EROSION CONTROLS ARE MAINTAINED IN ACCORDANCE WITH THE CONSTRUCTION SITE EROSION CONTROL REQUIREMENTS.

STORMWATER FACILITIES CONSTRUCTION NOTES

- 1. ENGINEER SHALL BE NOTIFIED PRIOR TO INSTALLATION OF STORMWATER MANAGEMENT FACILITIES. CONSTRUCTION OF STORMWATER MANAGEMENT FACILITIES SHALL BE OBSERVED AND DOCUMENTED BY THE ENGINEER, OR AN OWNER'S
- 2. STORMWATER MANAGEMENT FACILITIES SHALL BE INSTALLED AFTER SUBSTANTIAL COMPLETION OF FINAL SITE GRADING AND SOILS HAVE BEEN STABILIZED.
- 3. AREAS USED FOR TEMPORARY SEDIMENT BASINS SHALL BE REMOVED IN THEIR ENTIRETY AFTER CONSTRUCTION OF STORMWATER MANAGEMENT FACILITIES.
- 4. CONSTRUCTION TRAFFIC, HEAVY EQUIPMENT AND SOIL STOCKPILES SHALL NOT BE PLACED IN AREAS WHERE PROPOSED | DANE COUNTY
- STORMWATER MANAGEMENT FACILITIES ARE LOCATED. 5. NATIVE SOIL INFILTRATION RATES BELOW STORMWATER FACILITIES SHALL BE VERIFIED BY THE OWNER'S GEOTECHNICAL
- ENGINEER PRIOR INSTALLATION OF FACILITIES. NATIVE SOIL INFILTRATION RATES SHALL BE EQUAL TO OR GREATER THAN DESIGN INFILTRATION RATES.
- FACILITIES TO BREAKUP ANY LOWER PERMEABILITY SEAMS THAT MAY BE PRESENT.
- 7. THICKER SILT OR CLAY LAYERS SHALL BE OVER-EXCAVATED AND BACKFILLED WITH GRANULAR MATERIALS CONFORMIN TO SPECIFICATIONS PER WDNR TECH STANDARD 1004.

	PROPERTY LINE	
	RIGHT-OF-WAY	
_ · _ · _ · _ · _ · _	EASEMENT LINE	— •959· — −
	BUILDING OUTLINE	- 960 -
	BUILDING OVERHANG	-
	EDGE OF PAVEMENT	
	STANDARD CURB AND GUTTER	
	REJECT CURB AND GUTTER	
	MOUNTABLE CURB AND GUTTER	
	8" CONCRETE RIBBON CURB	——x——x—
	ASPHALT PAVEMENT	
	HEAVY DUTY ASPHALT PAVEMENT	FG: XXX.XX
4 A A	CONCRETE PAVEMENT	•
+ + + + + + + + + + + + + + + + + + + +	HEAVY DUTY CONCRETE PAVEMENT	

PROPOSED 1 FOOT CONTOUR PROPOSED 5 FOOT CONTOUR **EXISTING 1 FOOT CONTOUR**

EXISTING 5 FOOT CONTOUR DRAINAGE DIRECTION GRADE BREAK STORMWATER MANAGEMENT AREA

RETAINING WALL BOULDER WALL **RAILING** FENCE

> SPOT ELEVATION EP - EDGE OF PAVEMENT FG - FINISH GRADE EC - EDGE OF CONCRETE BOC - BACK OF CURB MATCH - MATCH EXISTING GRADE HP - HIGH POINT SW - SIDEWALK









Engineers • Surveyors • Planners

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MADISON REGIONAL OFFICE 161 HORIZON DRIVE, SUITE 101 VERONA, WISCONSIN 53593 P. 608.848.5060

DEGEN & ASSOCIATES, LLC

LIENT ADDRESS:

PO BOX 5567 **MADISON, WI 53705-0567**

5133 & 5237 **UNIVERSITY AVE**


PROJECT LOCATION: MADISON, WI

#_	Date:	Description:
1	01.15.2020	LAND USE UDC INITIAL
2	04.17.2020	LAND USE RESUBMITTAL
3	10.21.2020	UDC FINAL
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Desig	gn/Drawn:	CEJ
	oved:	AJS

GRADING PLAN

JSD PROJECT NO: 07-2912

Toll Free (800) 242-8511

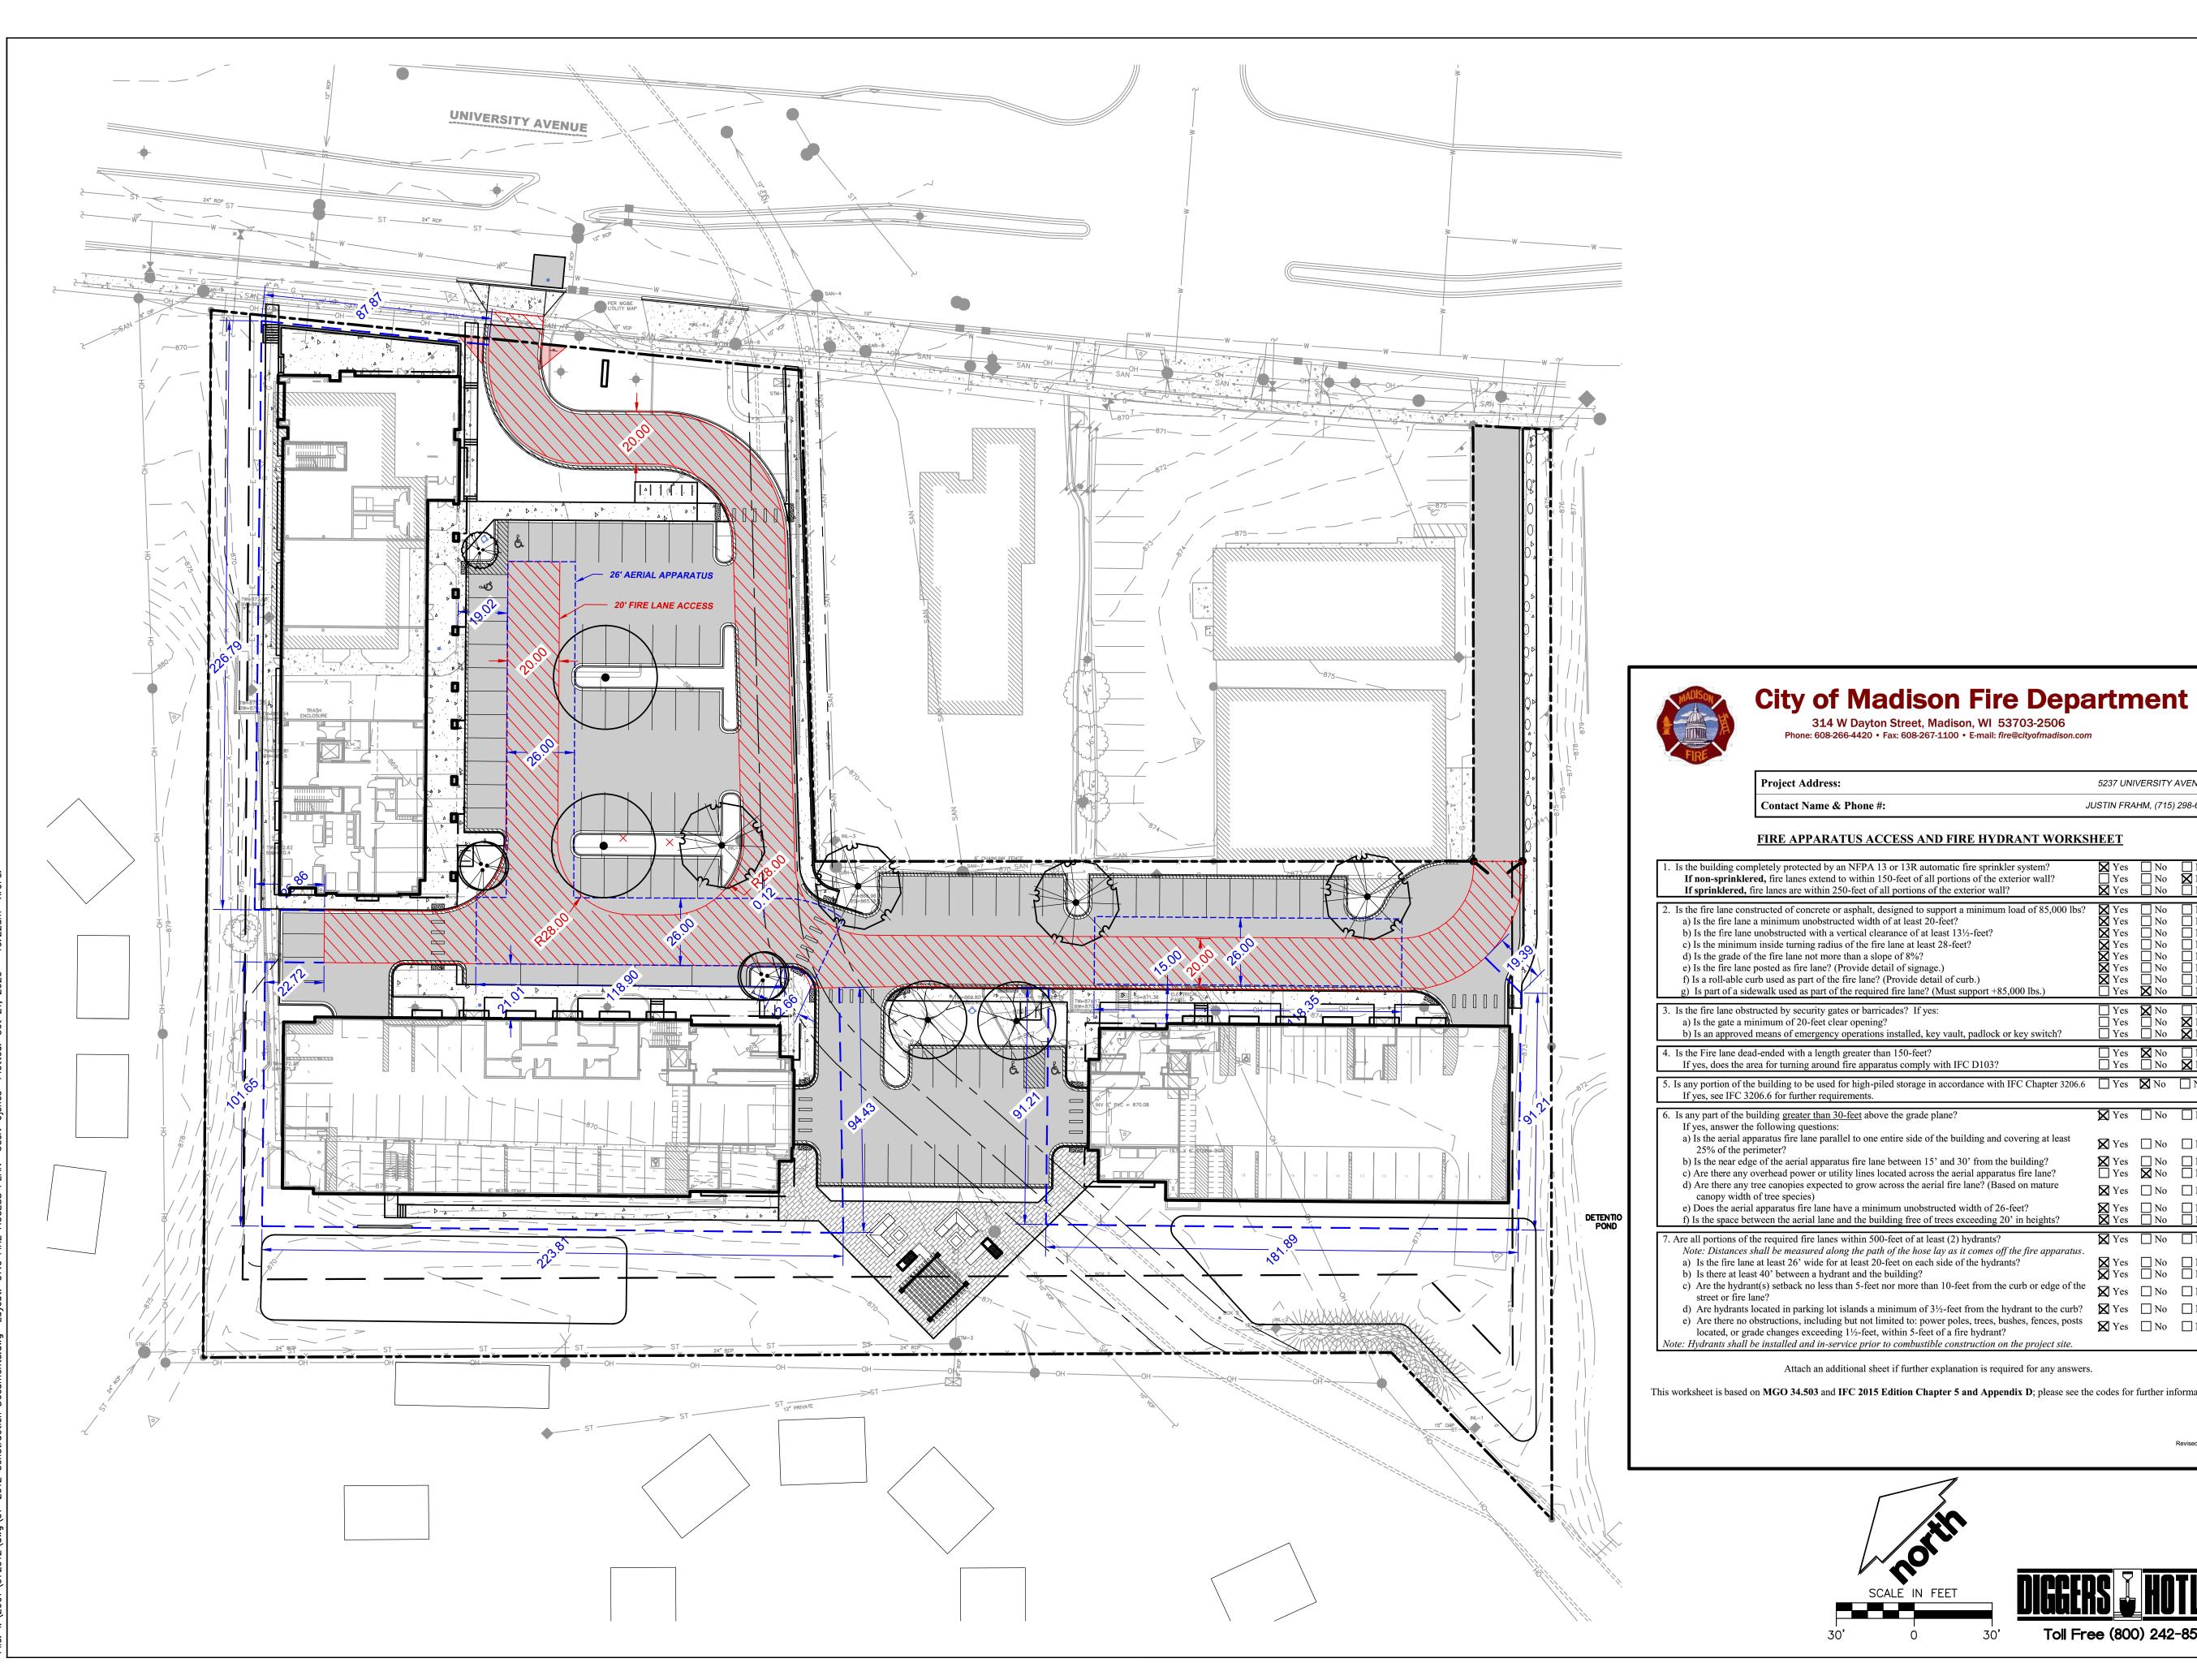



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161 HORIZON DRIVE, SUITE 101

VERONA, WISCONSIN 53593

P. 608.848.5060

DEGEN & ASSOCIATES, LLC

CLIENT ADDRESS: PO BOX 5567 MADISON, WI 53705-0567

314 W Dayton Street, Madison, WI 53703-2506 Phone: 608-266-4420 • Fax: 608-267-1100 • E-mail: fire@cityofmadison.com

Project Address:	5237 UNIVERSITY AVENUE
Contact Name & Phone #:	JUSTIN FRAHM, (715) 298-6330

FIRE APPARATUS ACCESS AND FIRE HYDRANT WORKSHEET

If non-sprinklered, fire lanes extend to within 150-feet of all portions of the exterior wall? If sprinklered, fire lanes are within 250-feet of all portions of the exterior wall?	☐ Yes ▼ Yes	☐ No ☐ No	⊠ N/A
 2. Is the fire lane constructed of concrete or asphalt, designed to support a minimum load of 85,000 lbs? a) Is the fire lane a minimum unobstructed width of at least 20-feet? b) Is the fire lane unobstructed with a vertical clearance of at least 13½-feet? c) Is the minimum inside turning radius of the fire lane at least 28-feet? d) Is the grade of the fire lane not more than a slope of 8%? e) Is the fire lane posted as fire lane? (Provide detail of signage.) f) Is a roll-able curb used as part of the fire lane? (Provide detail of curb.) g) Is part of a sidewalk used as part of the required fire lane? (Must support +85,000 lbs.) 	Yes	No No No No No No No No	N/A N/A
3. Is the fire lane obstructed by security gates or barricades? If yes:a) Is the gate a minimum of 20-feet clear opening?b) Is an approved means of emergency operations installed, key vault, padlock or key switch?	Yes Yes Yes	No No No	□ N/A X N/A X N/A
4. Is the Fire lane dead-ended with a length greater than 150-feet? If yes, does the area for turning around fire apparatus comply with IFC D103?	☐ Yes ☐ Yes	No No	□ N/A
5. Is any portion of the building to be used for high-piled storage in accordance with IFC Chapter 3206.6 If yes, see IFC 3206.6 for further requirements.	Yes	No No	□ N/A
6. Is any part of the building greater than 30-feet above the grade plane? If yes, answer the following questions:	X Yes	☐ No	□ N/A
a) Is the aerial apparatus fire lane parallel to one entire side of the building and covering at least 25% of the perimeter?	X Yes	□ No	□ N/A
b) Is the near edge of the aerial apparatus fire lane between 15' and 30' from the building? c) Are there any overhead power or utility lines located across the aerial apparatus fire lane?	Yes Yes	□ No ■ No	□ N/A
d) Are there any tree canopies expected to grow across the aerial fire lane? (Based on mature canopy width of tree species)	X Yes	☐ No	□ N/A
e) Does the aerial apparatus fire lane have a minimum unobstructed width of 26-feet?	Yes Yes	☐ No ☐ No	□ N/A
f) Is the space between the aerial lane and the building free of trees exceeding 20' in heights?	Z 1 1 0 5		□ N/A
f) Is the space between the aerial lane and the building free of trees exceeding 20' in heights? 7. Are all portions of the required fire lanes within 500-feet of at least (2) hydrants?	¥ Yes	☐ No	
f) Is the space between the aerial lane and the building free of trees exceeding 20' in heights? 7. Are all portions of the required fire lanes within 500-feet of at least (2) hydrants? Note: Distances shall be measured along the path of the hose lay as it comes off the fire apparatus. a) Is the fire lane at least 26' wide for at least 20-feet on each side of the hydrants? b) Is there at least 40' between a hydrant and the building?		☐ No ☐ No ☐ No	□ N/A
f) Is the space between the aerial lane and the building free of trees exceeding 20' in heights? 7. Are all portions of the required fire lanes within 500-feet of at least (2) hydrants? Note: Distances shall be measured along the path of the hose lay as it comes off the fire apparatus. a) Is the fire lane at least 26' wide for at least 20-feet on each side of the hydrants?	Yes	— □ No	□ N/A

Attach an additional sheet if further explanation is required for any answers.

This worksheet is based on MGO 34.503 and IFC 2015 Edition Chapter 5 and Appendix D; please see the codes for further information.

Revised 1/21/2016

Toll Free (800) 242-8511

PROJECT:
5133 & 5237
UNIVERSITY AVE


PROJECT LOCATION: MADISON, WI DANE COUNTY

PLAN	N MODIFICATIO	NS:
#	Date:	Description:
1	01.15.2020	LAND USE UDC INITIAL
	04.17.2020	LAND USE RESUBMITTAL
3	10.21.2020	UDC FINAL
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Doci	an/Drawn:	CEIKIS

CEJ, KJS AJS, JLF

SHEET TITLE:
FIRE ACCESS PLAN

JSD PROJECT NO:

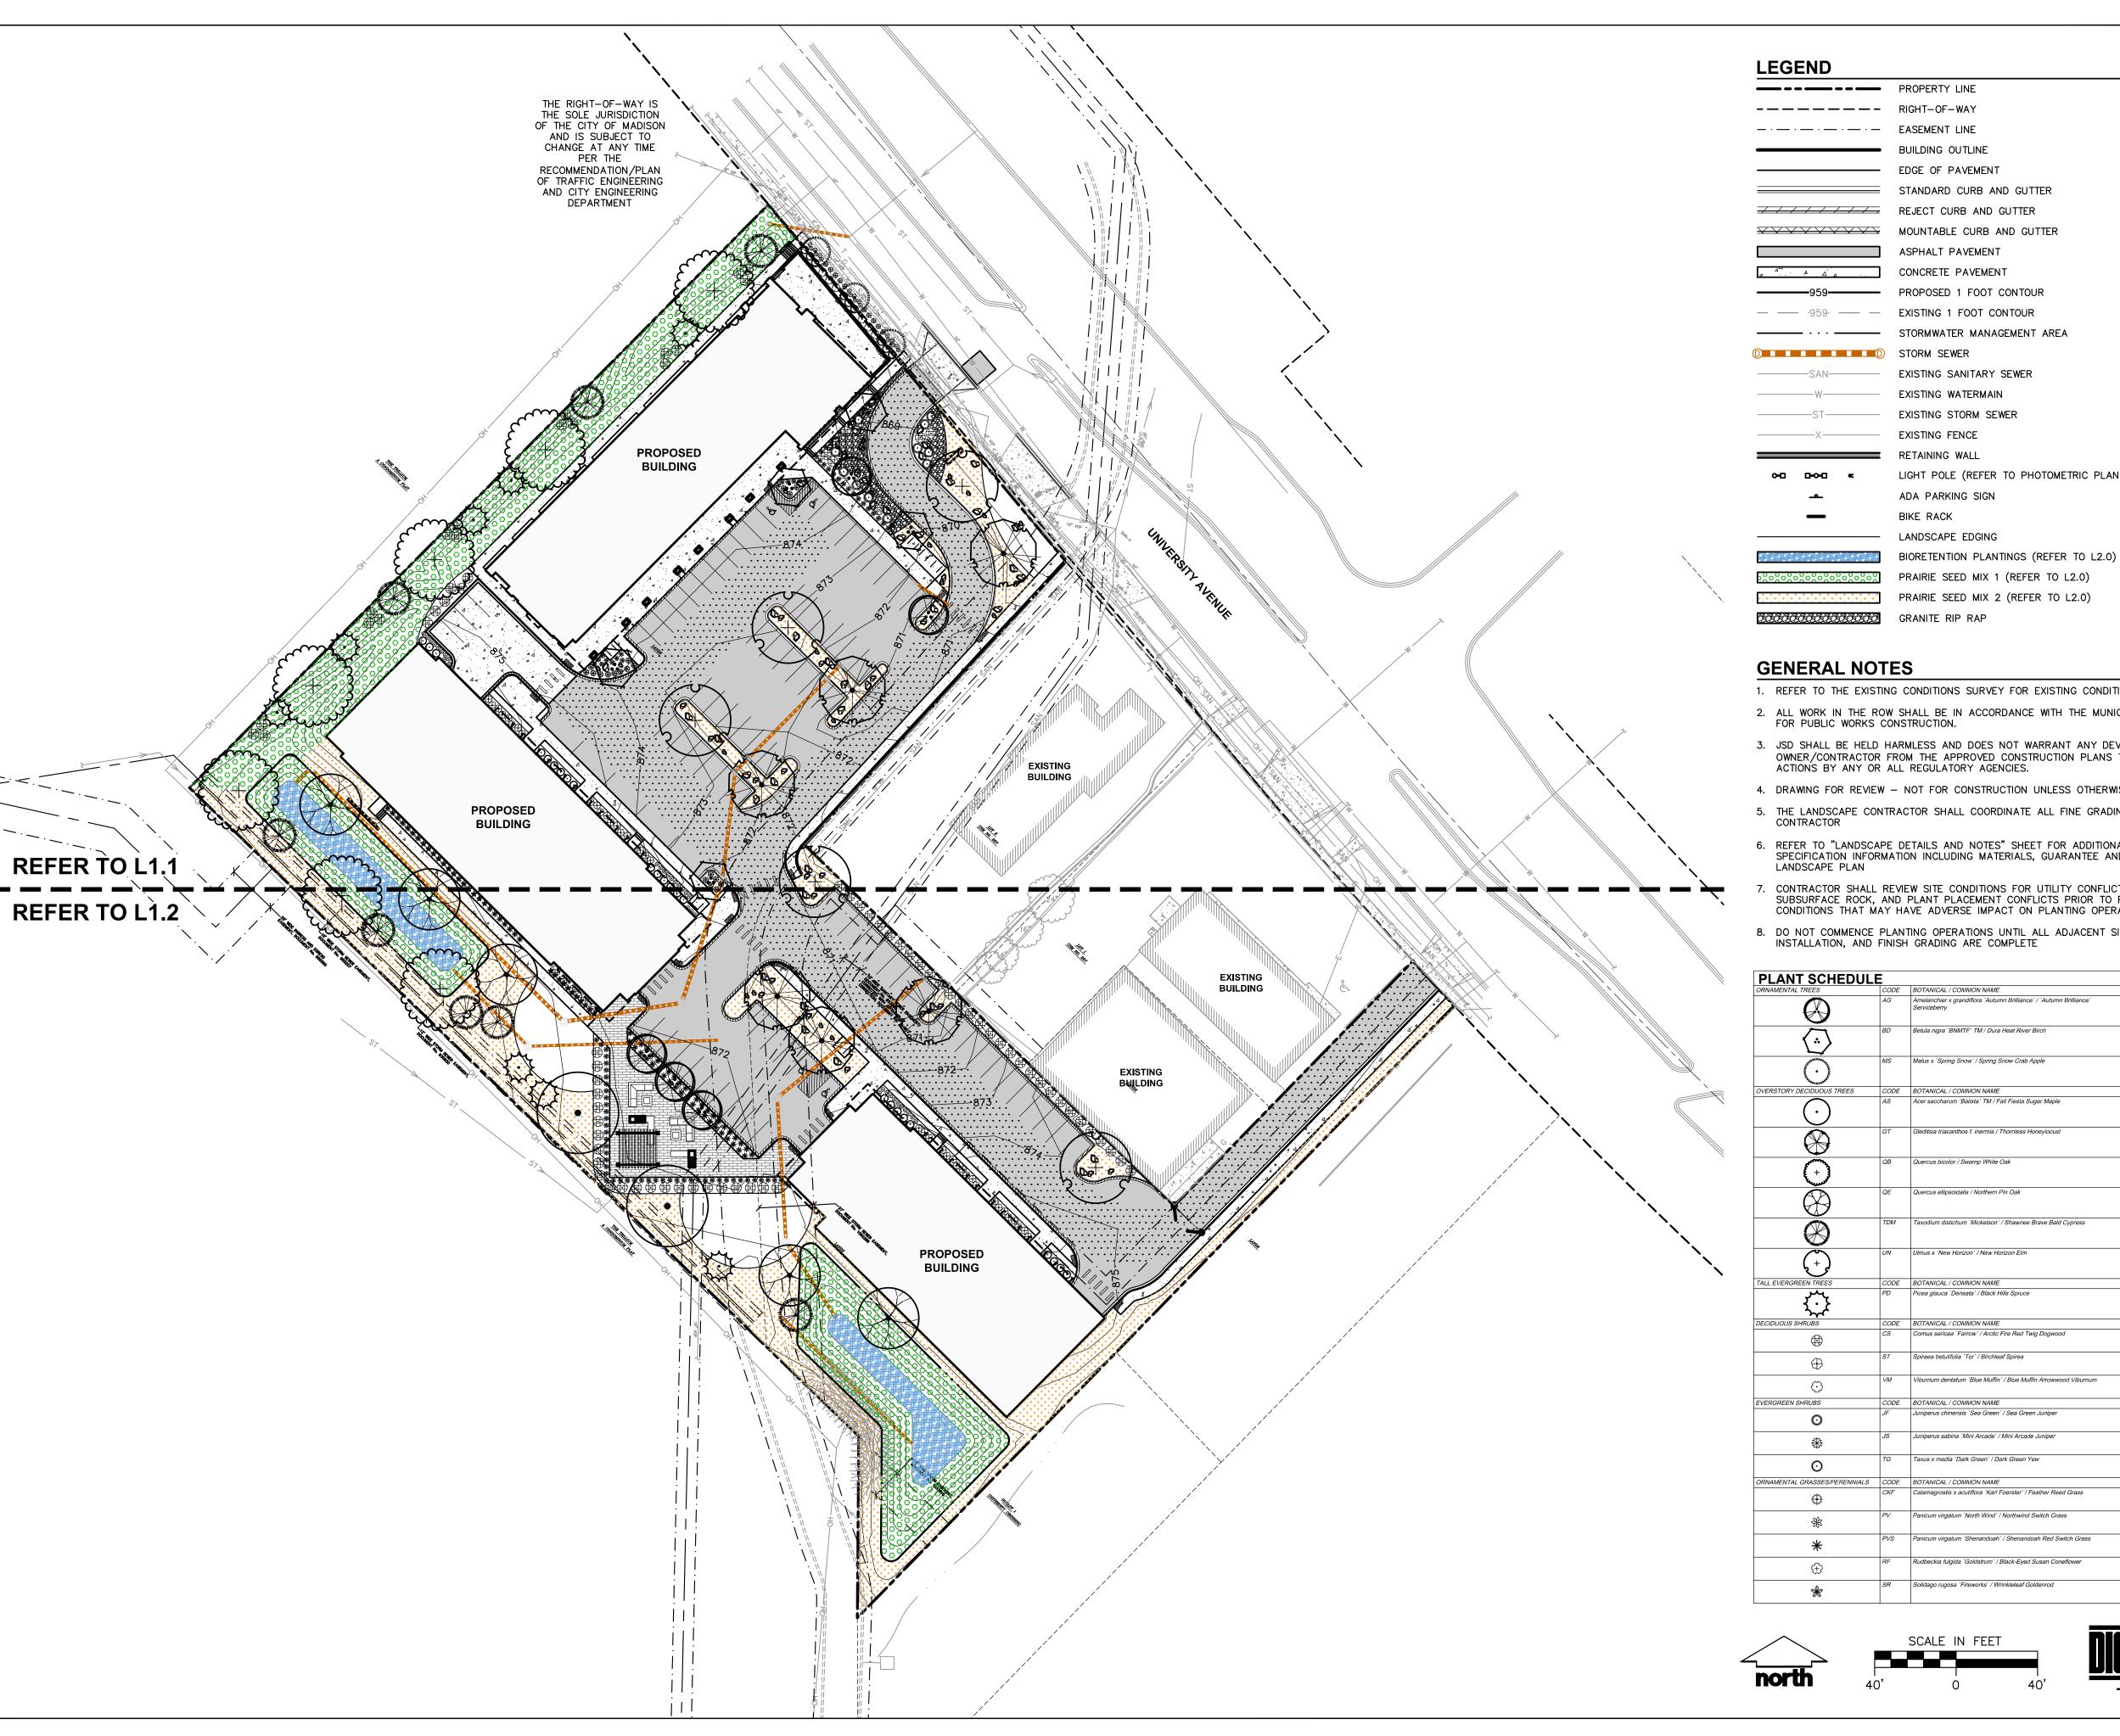

LIGHT POLE (REFER TO PHOTOMETRIC PLAN)

- 1. REFER TO THE EXISTING CONDITIONS SURVEY FOR EXISTING CONDITIONS NOTES AND LEGEND.
- 2. ALL WORK IN THE ROW SHALL BE IN ACCORDANCE WITH THE MUNICIPAL STANDARD SPECIFICATIONS
- 3. JSD SHALL BE HELD HARMLESS AND DOES NOT WARRANT ANY DEVIATIONS BY THE OWNER/CONTRACTOR FROM THE APPROVED CONSTRUCTION PLANS THAT MAY RESULT IN DISCIPLINARY
- 4. DRAWING FOR REVIEW NOT FOR CONSTRUCTION UNLESS OTHERWISE NOTED IN THE TITLE BLOCK.
- 5. THE LANDSCAPE CONTRACTOR SHALL COORDINATE ALL FINE GRADING AND TOPSOILING WITH GENERAL
- 6. REFER TO "LANDSCAPE DETAILS AND NOTES" SHEET FOR ADDITIONAL DETAILS, NOTES AND SPECIFICATION INFORMATION INCLUDING MATERIALS, GUARANTEE AND EXECUTION RELATED TO LANDSCAPE PLAN
- CONTRACTOR SHALL REVIEW SITE CONDITIONS FOR UTILITY CONFLICTS, DRAINAGE ISSUES, SUBSURFACE ROCK, AND PLANT PLACEMENT CONFLICTS PRIOR TO PLANT INSTALLATION. REPORT ANY CONDITIONS THAT MAY HAVE ADVERSE IMPACT ON PLANTING OPERATIONS TO LANDSCAPE ARCHITECT
- 8. DO NOT COMMENCE PLANTING OPERATIONS UNTIL ALL ADJACENT SITE IMPROVEMENTS, IRRIGATION

B & B 1.5" Cal (Multi-Stem) Taxodium distichum `Mickelson` / Shawnee Brave Bald Cypress Rudbeckia fulgida `Goldstrum` / Black-Eyed Susan Coneflower



Professional Services, Inc. Engineers • Surveyors • Planners

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DEGEN &

ASSOCIATES, LLC

CLIENT ADDRESS: PO BOX 5567 MADISON, WI 53705-0567

ROJECT:

5133 & 5237 **UNIVERSITY AVE**


PROJECT LOCATION: MADISON, WI DANE COUNTY

LAN MODIFICATIONS: 01.15.2020 LAND USE UDC INITIAL 04.17.2020 LAND USE RESUBMITTAL 10.21.2020 UDC FINAL 11.13.2020 PRELIMINARY BID SET

esign/Drawn: MAS Approved:

OVERALL LANDSCAPE PLAN

JSD PROJECT NO: 07-2912

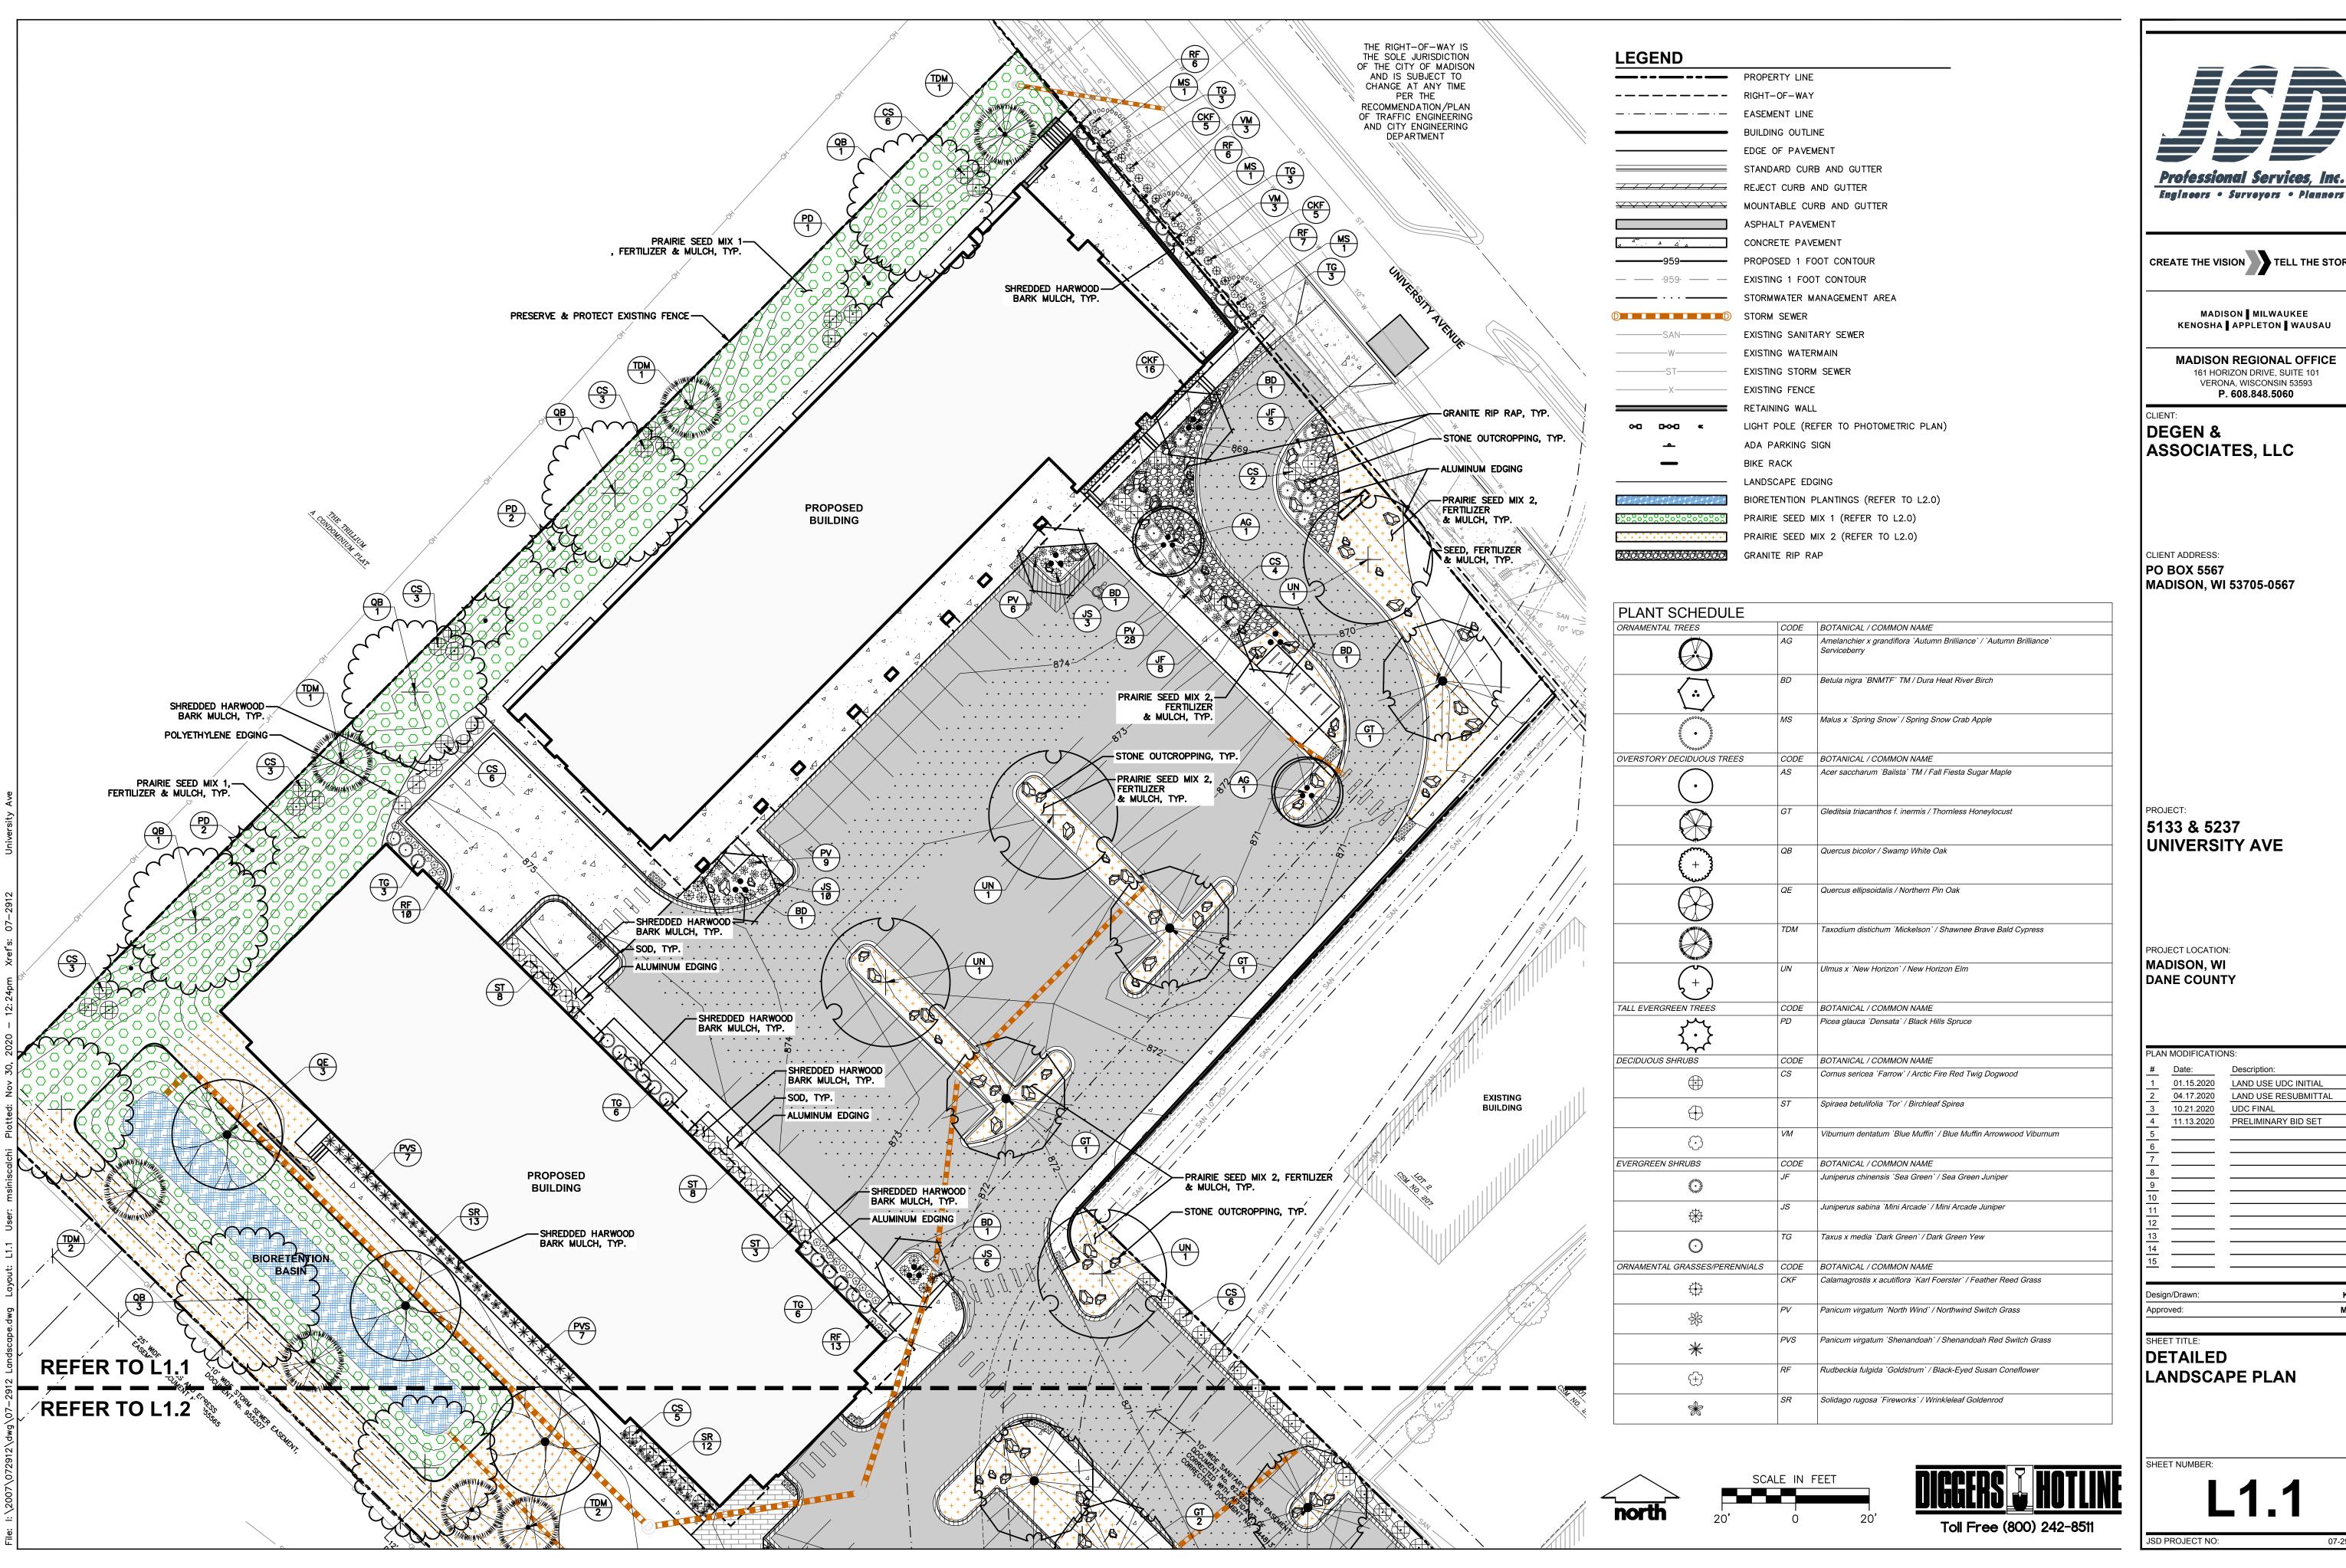


Professional Services, Inc.

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LAND USE UDC INITIAL LAND USE RESUBMITTAL PRELIMINARY BID SET





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MADISON REGIONAL OFFICE

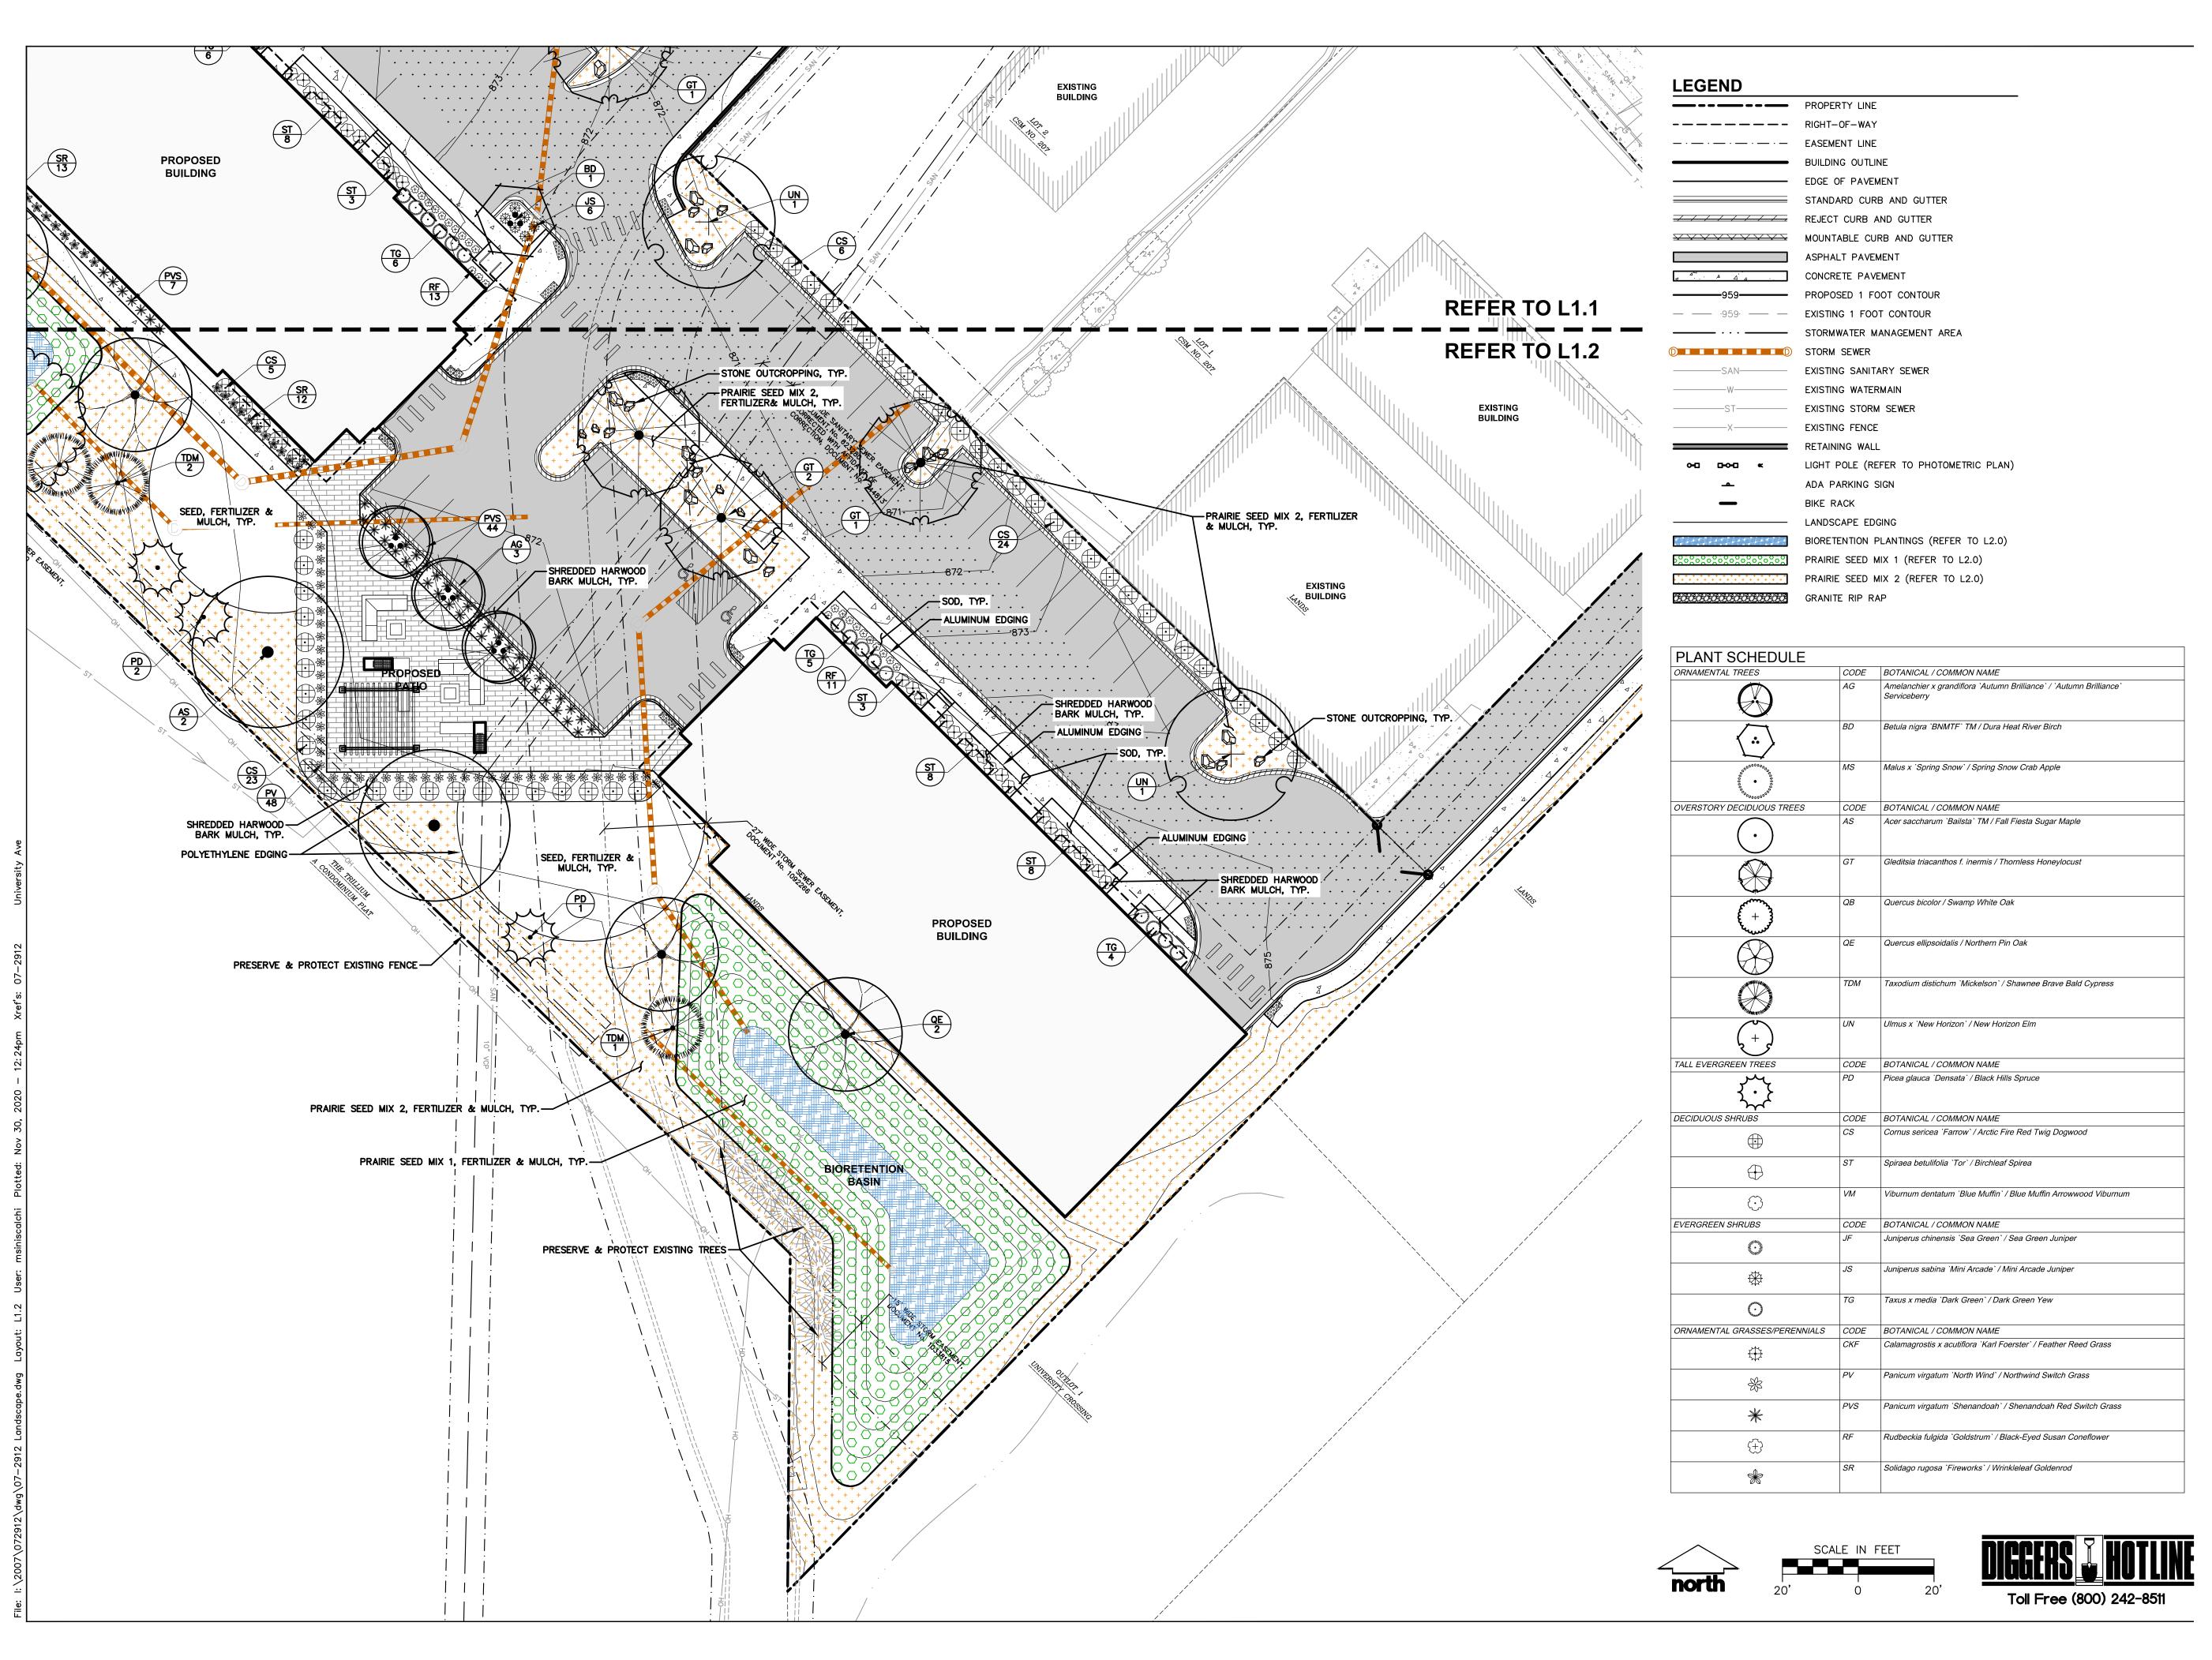161 HORIZON DRIVE, SUITE 101

VERONA, WISCONSIN 53593

P. 608.848.5060

CLIENT:

DEGEN &

ASSOCIATES, LLC

CLIENT ADDRESS:
PO BOX 5567
MADISON, WI 53705-0567

ROJECT:

5133 & 5237 UNIVERSITY AVE

PROJECT LOCATION:
MADISON, WI
DANE COUNTY

Design/Drawn: K
Approved: M

SHEET TITLE:

DETAILED

LANDSCAPE PLAN

ET NUMBER:


L1.2

JSD PROJECT NO:

SET ON UNDISTURBED SOIL UNLESS COMPACTED AGGREGATE STONE REMAINS FROM SITE EXCAVATOR. REMOVE REMAINING AGGREGATE STONE UNTIL SOIL LAYER IS

2. REMOVE NYLON STRAPPING WITHIN 9-18 MONTHS FOLLOWING

DECIDUOUS TREE PLANTING DETAIL

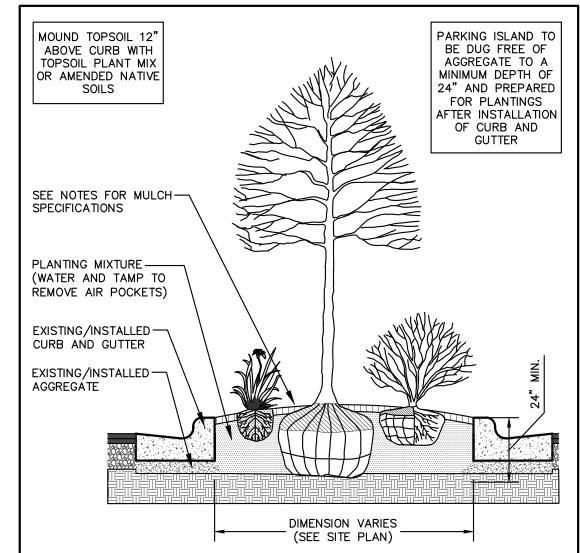


PARKING ISLAND LANDSCAPE DETAIL


N.T.S.

EV. 01-03-2019

REV. 01-03-2019

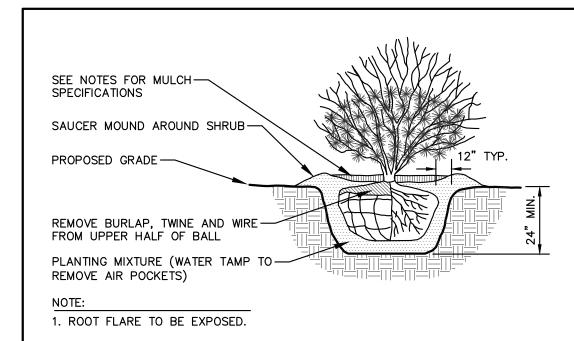


SHRUB PLANTING DETAIL

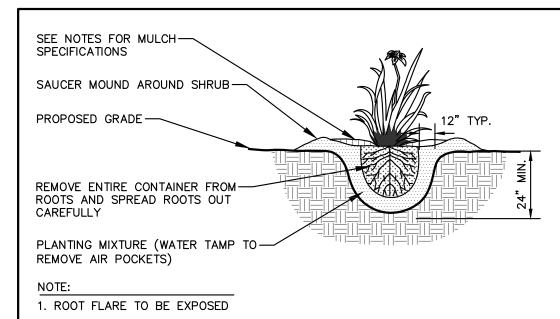

PERENNIAL/ORNAMENTAL GRASS PLANTING DETAIL


REV. 01-03-2019

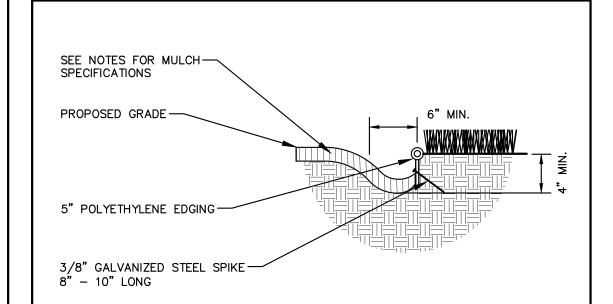

POLYETHYLENE LANDSCAPE EDGING **DETAIL**

N.T.S.

REV. 01-03-2019

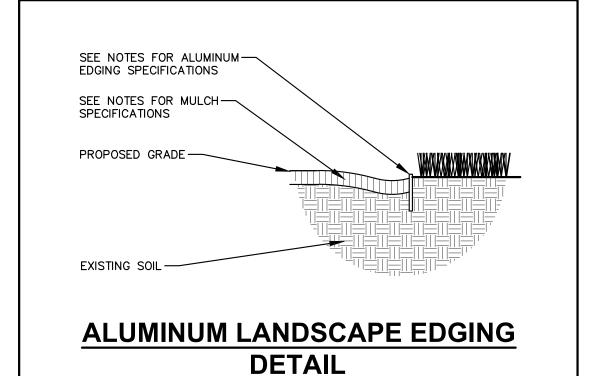

EV. 01-03-2019

N.T.S.

CONTRACTOR & OWNER RESPONSIBILITY NOTES

GUARANTEE: THE CONTRACTOR SHALL GUARANTEE ALL PLANTS THROUGH ONE (1) YEAR AFTER ACCEPTANCE BY THE OWNER'S REPRESENTATIVE. PLANTS SHALL BE ALIVE AND IN HEALTHY AND FLOURISHING CONDITION AT THE END OF THE GUARANTEE PERIOD. THE CONTRACTOR SHALL REPLACE (AT NO COST TO OWNER) ANY PLANTS THAT ARE DEAD OR NOT IN A VIGOROUS THRIVING CONDITION. REPLACEMENT PLANTS SHALL BE OF THE SAME KIND AND SIZE AS ORIGINALLY SPECIFIED UNLESS OTHERWISE DIRECTED BY OWNER'S REPRESENTATIVE. RESTORE BEDS AS NECESSARY FOLLOWING PLANT REPLACEMENT, INCLUDING BUT NOT LIMITED TO BEDDING, EDGING, MULCH, ETC. REPLACE PLANTS DAMAGED AT TIME OF PLANTING. REPAIR AREAS DISTURBED IN ANY WAY DURING PLANT REPLACEMENT AT NO COST TO OWNER. CONTRACTOR SHALL PROVIDE A ONE (1)-YEAR STRAIGHTENING GUARANTEE

CONTRACTOR IS RESPONSIBLE FOR STAKING THE PLANT MATERIALS FOR REVIEW BY OWNER'S REPRESENTATIVE PRIOR TO DIGGING AND PLACEMENT AND SHALL COORDINATE ALL FINE GRADING AND RESTORATION WITH THE GRADING

MAINTENANCE: (CONTRACTOR) FOR ALL PLANTINGS, SEEDED AND/OR SODDED LAWN AREAS: THE CONTRACTOR SHALL MAINTAIN ALL PLANTINGS AND LAWN AREAS FOR A MINIMUM TIME PERIOD OF 60 DAYS, UNTIL FINAL ACCEPTANCE BY OWNER'S REPRESENTATIVE. THE CONTRACTOR IS RESPONSIBLE FOR ADEQUATELY WATERING PLANTS AND LAWN/TURFGRASS DURING THIS 60 DAY ESTABLISHMENT PERIOD. CONTRACTOR IS RESPONSIBLE FOR THE ESTABLISHMENT OF HEALTHY VIGOROUS PLANT MATERIALS AND LAWN/TURFGRASS GROWTH. CONTRACTOR IS ALSO RESPONSIBLE FOR ANY PRUNING OF PLANT MATERIALS, AND SHAPING AND/OR REPLACEMENT OR SUPPLEMENT OF DEFICIENT SHREDDED HARDWOOD BARK MULCH DURING THIS PERIOD. LONG TERM PLANT MATERIALS AND LAWN/TURFGRASS MAINTENANCE AND ANY PROGRAM FOR SUCH IS THE RESPONSIBILITY OF THE OWNER. ALL PLANTINGS AND LAWN/TURFGRASS AREAS SHALL BE MAINTAINED IN A MANICURED CONDITION UNTIL THE TIME WHEN THE OWNER'S ACCEPTANCE IS

. MAINTENANCE: (OWNER) THE OWNER IS RESPONSIBLE FOR THE CONTINUED MAINTENANCE, REPAIR AND REPLACEMENT OF ALL LANDSCAPING MATERIALS AND WEED BARRIER FABRIC AS NECESSARY FOLLOWING THE ONE (1) YEAR CONTRACTOR GUARANTEE PERIOD.

GENERAL NOTES

GENERAL: ALL WORK IN THE R-O-W AND PUBLIC EASEMENTS SHALL BE IN ACCORDANCE WITH LOCAL MUNICIPAL REQUIREMENTS. JSD SHALL BE HELD HARMLESS AND DOES NOT WARRANT ANY DEVIATIONS BY THE OWNER/CONTRACTOR FROM THE APPROVED CONSTRUCTION PLANS THAT MAY RESULT IN DISCIPLINARY ACTIONS BY ANY OR ALL REGULATORY AGENCIES. LOCATE ALL UTILITIES PRIOR TO CONSTRUCTION. THE CONTRACTOR IS RESPONSIBLE FOR REPAIRING ANY DAMAGE DONE TO UTILITIES. CONTRACTOR MUST CALL 1-800-242-8511 FOR UTILITY LOCATIONS AT LEAST THREE DAYS PRIOR TO DIGGING. HAND DIG AND INSTALL ALL PLANTS THAT ARE NEAR EXISTING UTILITIES. PROTECT PREVIOUSLY INSTALLED WORK OF OTHER TRADES. CONTRACTOR IS RESPONSIBLE FOR STAKING THE PLANT MATERIALS FOR REVIEW BY OWNER PRIOR TO DIGGING AND PLACEMENT AND SHALL COORDINATE ALL FINE GRADING AND RESTORATION WITH THE GRADING CONTRACTOR.

- DELIVERY AND HANDLING: DO NOT DELIVER MORE PLANT MATERIALS THAN CAN BE PLANTED IN ONE DAY, UNLESS ADEQUATE, APPROPRIATE AND SECURE STORAGE IS PROVIDED AND APPROVED BY OWNER'S REPRESENTATIVE. AT ALL TIMES, PROTECT ALL PLANT MATERIALS FROM WIND AND DIRECT SUN. DELIVER PLANTS WITH LEGIBLE IDENTIFICATION LABELS. PROTECT PLANTS DURING DELIVERY AND DO NOT PRUNE PRIOR TO DELIVERY. ALL TREES AND SHRUBS SHALL BE PLANTED ON THE DAY OF DELIVERY; IF THIS IS NOT POSSIBLE, PROTECT THE PLANT MATERIALS NOT PLANTED BY STORING THEM IN A SHADED, SECURE AREA, PROTECTING THE ROOT MASŚ WITH WET SOIL, MULCH, HAY OR OTHER SUITABLE MEDIUM. CONTRACTOR TO KEEP ALL PLANT MATERIALS ADEQUATELY WATERED TO PREVENT ROOT DESICCATION. DO NOT REMOVE CONTAINER GROWN STOCK FROM CONTAINERS BEFORE TIME OF PLANTING. DO NOT PICK UP CONTAINER OR BALLED PLANTS BY STEM OR ROOTS. ALL PLANTS SHALL BE LIFTED AND HANDLED FROM THE BOTTOM OF THE CONTAINER OR BALL. PERFORM ACTUAL PLANTING ONLY WHEN WEATHER AND SOIL CONDITIONS ARE SUITABLE IN ACCORDANCE WITH LOCALLY
- MATERIALS PLANTS: ALL PLANTS SHALL CONFORM TO THE LATEST VERSION OF THE AMERICAN STANDARD FOR NURSERY STOCK ANSI Z60.1. PLANTS SHALL BE TRUE TO SPECIES AND VARIETY SPECIFIED AND NURSERY GROWN IN ACCORDANCE WITH GOOD HORTICULTURAL PRACTICES UNDER CLIMATIC CONDITIONS SIMILAR TO THOSE IN THE LOCALITY OF THE PROJECT FOR AT LEAST 2 YEARS. PLANTS SHALL BE FRESHLY DUG (DURING THE MOST RECENT FAVORABLE HARVEST SEASON). PLANTS SHALL BE SO TRAINED IN DEVELOPMENT AND APPEARANCE AS TO BE UNQUESTIONABLY SUPERIOR IN FORM, COMPACTNESS, AND SYMMETRY. PLANTS SHALL BE SOUND, HEALTHY, VIGOROUS, WELL BRANCHED AND DENSELY FOLIATED WHEN IN LEAF, AND FREE OF DISEASE AND INSECTS (ADULT EGGS, PUPAE OR LARVAE). THEY SHALL HAVE HEALTHY, WELL-DEVELOPED ROOT SYSTEMS AND SHALL BE FREE FROM PHYSICAL DAMAGE OR OTHER CONDITIONS THAT WOULD PREVENT THRIVING GROWTH OR PREMATURE MORTALITY. PLANTS SHALL BE OF THE HIGHEST QUALITY, POSSESS TYPICAL GROWTH HABITS AND FORM FOR THEIR SPECIES AND BE FREE OF INJURY. PARKWAY TREES AND PARKING LOT TREES SHALL HAVE A MINIMUM BRANCHING HEIGHT OF SIX (6) FEET ABOVE THE GROUND TO ALLOW ADEQUATE VISUAL AND PHYSICAL CLEARANCE.
- PRUNING: THE CONTRACTOR SHALL PRUNE ALL TREES AND REPAIR ANY INJURIES THAT OCCURRED DURING THE PLANTING PROCESS. DOUBLE LEADERS DEAD BRANCHES. AND LIMBS DAMAGED OR BROKEN DURING THE PLANTING PROCESS, SHALL BE PRUNED. THIS SHALL BE THE ONLY PRUNING ALLOWED AT PLANTING. PRUNING SHALL CONFORM TO THE LATEST VERSION OF THE AMERICAN STANDARD FOR TREE CARE OPERATIONS, ANSI A300. PRUNE TREES IN ACCORDANCE WITH NAA GUIDELINES. DO NOT TOP TREES. PRUNE SHRUBS ACCORDING TO STANDARD HORTICULTURAL PRACTICES. ON CUTS OVER 3/4" IN DIAMETER AND BRUISES OR SCARS ON BARK, TRACE THE INJURED CAMBIUM LAYER BACK TO LIVING TISSUE AND REMOVE. SMOOTH AND SHAPE WOUNDS SO AS NOT TO RETAIN WATER. TREAT THE AREA WITH AN APPROVED INCONSPICUOUS LATEX BASED ANTISEPTIC TREE PAINT, IF PRUNING OCCURS "IN SEASON". DO NOT PRUNE ANY OAK TREES DURING THE MONTHS FROM APRIL TO OCTOBER.
- 5. CLEANUP: THE WORK AREA SHALL BE KEPT SAFE AND NEAT AT ALL TIMES. DISPOSED OF EXCESS SOIL. REMOVE ALL CUTTINGS AND WASTE MATERIALS. SOIL AND BRANCHES. BIND AND WRAP THESE MATERIALS, ANY REJECTED PLANTS, AND ANY OTHER DEBRIS RESULTING FROM ALL PLANTING TASKS AND PROMPTLY CLEAN UP AND REMOVE FROM THE PROJECT SITE. UNDER NO CIRCUMSTANCES SHALL THE ACCUMULATION OF SOIL. BRANCHES OR OTHER DEBRIS BE ALLOWED UPON A PUBLIC PROPERTY IN SUCH A MANNER AS TO RESULT IN A PUBLIC SAFETY HAZARD OR DAMAGE. LIKEWISE, JNDER NO CIRCUMSTANCES SHALL ANY DEBRIS OR INCIDENTAL MATERIALS BE ALLOWED UPON ADJACENT PRIVATE PROPERTY.
- ANY SUBSTITUTIONS IN PLANT TYPE, LOCATION, OR SIZE SHALL BE APPROVED BY LANDSCAPE ARCHITECT PRIOR TO INSTALLATION.
- CONTRACTOR TO VERIFY PLANT MATERIAL QUANTITIES AND SQUARE FOOTAGES. QUANTITIES SHOWN ON PLAN TAKE PRECEDENCE OVER THOSE ON

LANDSCAPE MATERIAL NOTES

- MATERIALS PLANTING MIXTURE: ALL HOLES EXCAVATED FOR TREES, SHRUBS, PERENNIALS AND ORNAMENTAL GRASSES SHALL BE BACKFILLED WITH TWO (2) PARTS TOPSOIL, ONE (1) PART SAND AND ONE (1) PART COMPOST. SOIL MIXTURE SHALL BE WELL BLENDED PRIOR TO INSTALLATION.
- MATERIALS TOPSOIL: TOPSOIL TO BE CLEAN, FRIABLE LOAM FROM A LOCAL SOURCE, FREE FROM STONES OR DEBRIS OVER 3/4" IN DIAMETER, AND FREE FROM TOXINS OR OTHER DELETERIOUS MATERIALS. TOPSOIL SHALL HAVE A pH VALUE BETWEEN 6 AND 7. TOPSOIL AND PLANTING SOIL SHALL BE TESTED TO ENSURE CONFORMANCE WITH THESE SPECIFICATIONS AND SHALL BE AMENDED TO MEET THESE SPECIFICATIONS. PROVIDE TEST RESULTS TO OWNER'S REPRESENTATIVE PRIOR TO PLACEMENT. DO NOT PLACE FROZEN OR MUDDY TOPSOIL. APPLY SOIL AMENDMENTS TO ALL LANDSCAPE AREAS PER SOIL TEST.
- MATERIALS SHREDDED HARDWOOD BARK MULCH: ALL PLANTING AREAS LABELED ON PLAN SHALL RECEIVE CERTIFIED WEED FREE SHREDDED HARDWOOD BARK MULCH INSTALLED TO A MINIMUM AND CONSISTENT DEPTH OF 3-INCHES. SHREDDED HARDWOOD BARK MULCH SIZE & COLOR TO BE APPROVED BY OWNER'S REPRESENTATIVE PRIOR TO INSTALLATION. FERTILIZER SHALL BE IN ACCORDANCE WITH APPLICABLE LOCAL, COUNTY AND STATE REQUIREMENTS. SHREDDED HARDWOOD BARK MULCH AREAS SHALL NOT RECEIVE WOVEN WEED BARRIER FABRIC.
- MATERIALS TREE & SHRUB RINGS: ALL TREES AND/OR SHRUBS PLANTED IN SEEDED LAWN AREAS TO BE INSTALLED WITH A MINIMUM 5' DIAMETER SHREDDED HARDWOOD BARK MULCH TREE RING SPREAD TO A CONSISTENT DEPTH OF 3-INCHES. ALL TREE RINGS SHOULD BE INSTALLED WITH A 5" DEPTH SHOVEL CUT EDGE, ANGLED 45 DEGREES INTO SOIL AT A 5' DIAMETER ABOUT THE CENTER OF THE TREE PLANTING. A PRE-EMERGENT GRANULAR HERBICIDE WEED-PREVENTER SHOULD BE MIXED WITH MULCH USED TO INSTALL TREE RING AS WELL AS TOPICALLY APPLIED TO COMPLETED INSTALLATION OF TREE RING.
- MATERIALS ALUMINUM EDGING: EDGING SHALL BE 1/8" X 4", ALUMINUM EDGING, MILL FINISH. OWNER'S REPRESENTATIVE SHALL APPROVE PRODUCT SPECIFICATION PROVIDED BY LANDSCAPE CONTRACTOR
- MATERIALS POLYETHYLENE EDGING: EDGING SHALL BE 5" DEEP, POLYETHYLENE EDGING. OWNER'S REPRESENTATIVE SHALL APPROVE PRODUCT SPECIFICATION PROVIDED BY LANDSCAPE CONTRACTOR.
- MATERIALS TREE PROTECTION: ALL TREES TO BE INSTALLED WITH LDPE TREE GUARDS AS MANUFACTURED BY A.M. LEONARD HORTICULTURAL TOOL & SUPPLY CO., OR APPROVED EQUAL.
- MATERIALS TREE WATERING BAGS: ALL TREES TO BE INSTALLED WITH ONE (1) WATER BAG. PRODUCT TO BE "TREE GATOR ORIGINAL SLOW RELEASE WATERING BAG," PRODUCT NO. 98183-R OR APPROVED EQUAL. INSTALL IN ACCORDANCE WITH MANUFACTURER'S RECOMMENDATIONS.

SEEDING, SODDING, & POND VEGETATION NOTES

- MATERIALS TURFGRASS SEED: DISTURBED LAWN AREAS LABELED ON PLAN AS SUCH, SHALL RECEIVE 6" OF TOPSOIL AND "LANDMARK TURF AND NATIVE SEED" GRASS SEED, OR EQUIVALENT AS APPROVED BY THE OWNER'S REPRESENTATIVE, INSTALLED PER MANUFACTURER'S RECOMMENDATIONS. IN ADDITION TO TURFGRASS SEED, ANNUAL RYE SHALL BE APPLIED TO ALL DISTURBED AREAS AT A RATE OF 1 1/2 LBS PER 1000 SQUARE FEET. FERTILIZE AND MULCH PER MANUFACTURER'S RECOMMENDATIONS. MULCH SHALL BE CERTIFIED NOXIOUS WEED SEED-FREE
- MATERIALS TURF HIGHLAND ROUGH MIX SEED: DISTURBED LAWN AREAS LABELED ON PLAN AS SUCH, SHALL RECEIVE 6" OF TOPSOIL AND "TURF HIGHLAND ROUGH MIX" GRASS SEED, OR EQUIVALENT AS APPROVED BY THE OWNER'S REPRESENTATIVE, INSTALLED PER MANUFACTURER'S
- 3. MATERIALS SOD: DISTURBED LAWN AREAS LABELED ON PLAN AS SUCH, SHALL RECEIVE 6" OF TOPSOIL AND A PREMIUM GRADE TURFGRASS SOD. ONLY IMPROVED TYPES OF SOD (ELITE) ARE ACCEPTABLE. TURFGRASS SHALL BE MACHINE CUT AT A UNIFORM THICKNESS OF .60 INCH, PLUS OR MINUS .25 INCH, AT TIME OF CUTTING. MEASUREMENT FOR THICKNESS SHALL EXCLUDE TOP GROWTH AND THATCH. LARGE ROLL TURFGRASS SOD SHALL BE CUT TO THE SUPPLIER'S STANDARD WIDTH (36-48 INCHES) AND LENGTH. BROKEN PADS AND TORN OR UNEVEN ENDS WILL NOT BE ACCEPTABLE. STANDARD SIZE SECTIONS OF TURGRASS SOD SHALL BE STRONG ENOUGH SO THAT THEY CAN BE PICKED UP AND HANDLED WITHOUT DAMAGE. TUREGRASS SOD SHALL NOT BE HARVESTED OR TRANSPLANTED WHEN MOISTURE CONTENT IS EXCESSIVELY DRY OR WET. AS THIS MAY ADVERSELY AFFECT ITS SURVIVAL, POST-PLANT IRRIGATION WILL BE NECESSARY TO ENSURE SOD STAYS ALIVE AND ROOTS INTO SOIL. THE CONTRACTOR IS RESPONSIBLE FOR WATERING SOD UNTIL TIME OF ACCEPTANCE BY THE OWNER. TURFGRASS SOD SHALL BE HARVESTED, DELIVERED, AND INSTALLED/TRANSPLANTED WITHIN A PERIOD OF 24 HOURS. TURFGRASS SOD SHALL BE RELATIVELY FREE OF THATCH. UP TO 0.5 INCH ALLOWABLE (UNCOMPRESSED). TURFGRASS SOD SHALL BE REASONABLY FREE (10 WEEDS/100 SQ. FT.) OF DISEASES, NEMATODES AND SOIL-BORNE INSECTS. ALL TURFGRASS SOD SHALL BE FREE OF GRASSY AND BROAD LEAF WEEDS AND WEED SEED. THE SOD SUPPLIER SHALL MAKE RECOMMENDATIONS TO THE CONTRACTOR REGARDING WATERING SCHEDULE. THE WATERING SCHEDULE SHOULD BEGIN IMMEDIATELY AFTER SOD IS INSTALLED.
- . MATERIALS PRAIRIE SEED MIX 1: DISTURBED LAWN AREAS LABELED ON PLAN AS SUCH, SHALL BE BROADCAST SEEDED WITH "DIVERSE PRAIRIE FOR MEDIUM SOILS" SEED MIX, AS PROVIDED BY PRAIRIE NURSERY, P.O. BOX 306, WESTFIELD, WISCONSIN, 53964, TEL. 608-296-3679 (OR APPROVED EQUIVALENT). INSTALL SEED WITH SUPPLEMENTAL MATERIALS AND AMENDMENTS AS RECOMMENDED BY SEED SUPPLIER AND AT RATES AND OPTIMUM TIMES OF THE YEAR AS RECOMMENDED BY THE SEED SUPPLIER TO ENSURE SUCCESSFUL GERMINATION AND SEED/ROOT ZONE GROWTH DEVELOPMENT. REFER TO PRODUCT SPECIFICATIONS AND MANUFACTURERS RECOMMENDATIONS FOR INSTALLATION.
- 5. MATERIALS PRAIRIE SEED MIX 2: DISTURBED LAWN AREAS LABELED ON PLAN AS SUCH, SHALL BE BROADCAST SEEDED WITH "SHORT PRAIRIE FOR DRY SOILS" SEED MIX, AS PROVIDED BY PRAIRIE NURSERY, P.O. BOX 306, WESTFIELD, WISCONSIN, 53964, TEL. 608-296-3679 (OR APPROVED EQUIVALENT). INSTALL SEED WITH SUPPLEMENTAL MATERIALS AND AMENDMENTS AS RECOMMENDED BY SEED SUPPLIER AND AT RATES AND OPTIMUM TIMES OF THE YEAR AS RECOMMENDED BY THE SEED SUPPLIER TO ENSURE SUCCESSFUL GERMINATION AND SEED/ROOT ZONE GROWTH DEVELOPMENT. REFER TO PRODUCT SPECIFICATIONS AND MANUFACTURERS RECOMMENDATIONS FOR INSTALLATION.
- MATERIALS BIORETENTION BASIN PLUG PLANTINGS: PLUG PLANTINGS TO BE INSTALLED 1'-0" ON CENTER, MIXING SPECIES INTEGRALLY IN FLATS OF 20 AT A TIME, REFER TO WDNR PLUG PLANTING TECHNICAL STANDARDS FOR ROOTSTOCK AND INSTALLATION SPECIFICATIONS.

MATERIALS - BIORETENTION BASIN NATIVE VEGETATIVE MAT (NVM): AREAS SPECIFIED ON PLANS SHALL RECEIVE AGRECOL "RAINWATER RENEWAL" NATIVE VEGETATIVE MAT - DEGRADABLE CORE. CONTRACTOR SHALL CONTACT AGRECOL NATIVE NURSERY 16 WEEKS IN ADVANCE OF INSTALLATION FOR PROPER GROWING LEAD TIME. CONTRACTOR SHALL ASSUME AVAILABLE DELIVERY DATE TO BE BETWEEN MID-JUNE THROUGH THE END OF OCTOBER DUE TO THE NMV GROWING SEASON. REFER TO PRODUCT SPECIFICATIONS AND MANUFACTURERS RECOMMENDATIONS FOR INSTALLATION PROCEDURES.



CITY OF MADISON LANDSCAPE WORKSHEET

Section 28.142 Madison General Ordinance

Contact Email justin.frahm@jsdinc.com

Name of Project **DEGEN & ASSOCIATES, LLC**

Project Location / Address 5237 UNIVERSITY AVE. MADISON, WI 53705

Owner / Contact JUSTIN FRAHM

Contact Phone (715) 298–6330

** Landscape plans for zoning lots greater than ten thousand (10,000) square feet in size

The following standards apply to all exterior construction and development activity, including the expansion of existing buildings, structures and parking lots, except the construction of detached single-family and two-family dwellings and their accessory structures. The entire development site must be brought up to compliance with this section unless all of the following conditions apply, in which case only the affected areas need to be brought up to compliance

MUST be prepared by a registered landscape architect. **

- (a) The area of site disturbance is less than ten percent (10%) of the entire development site during any ten-(10) year period.
- (b) Gross floor area is only increased by ten percent (10%) during any ten-(10) year period.
- (c) No demolition of a principal building is involved.
- (d) Any displaced landscaping elements must be replaced on the site and shown on a revised landscaping plan.

Landscape Calculations and Distribution

uired landscaped areas shall be calculated based upon the total developed area of the property. Developed area is defined as that area within a single contiguous boundary which is made up of structures, parking, driveways and docking/loading facilities, but excluding the area of any building footprint at grade, land designated for open space uses such as athletic fields, and undeveloped land area on the same zoning lot. There are three methods for calculating landscape points depending on the size of the lot and Zoning District

(a) For all lots except those described in (b) and (c) below, five (5) landscape points shall be provided for each three hundred (300) square feet of developed area.

Total square footage of developed area 71,600

Total landscape points required 1,194

(b) For lots larger than five (5) acres, points shall be provided at five (5) points per three hundred (300) square feet for the first five (5) developed acres, and one (1) point per one hundred (100) square feet for all additional

Total square footage of developed area Five (5) acres = 217,800 square fee First five (5) developed acres = 3,630 point Remainder of developed area

Total landscape points required (c) For the Industrial - Limited (IL) and Industrial - General (IG) districts, one (1) point shall be provided per one hundred (100) square feet of developed area.

Total square footage of developed area

Total landscape points required

10/2013

Tabulation of Points and Credits

Use the table to indicate the quantity and points for all existing and proposed landscape elements.

	Minimum Size at Installation	Points	Credits/ Existing Landscaping		New/ Proposed Landscaping	
Plant Type/ Element			Quantity	Points Achieved	Quantity	Points Achieved
verstory deciduous tree	2½ inch caliper measured diameter at breast height (dbh)	35			33	1,155
all evergreen tree .e. pine, spruce)	5-6 feet tall	35			8	280
rnamental tree	1 1/2 inch caliper	15			13	195
pright evergreen shrub .e. arborvitae)	3-4 feet tall	10				
hrub, deciduous	#3 gallon container size, Min. 12"-24"	3			132	396
hrub, evergreen	#3 gallon container size, Min. 12"-24"	4			65	260
rnamental grasses/ erennials	#1 gallon container size, Min. 8"-18"	2			252	504
rnamental/ ecorative fencing or all	n/a	4 per 10 lineal ft.				
xisting significant pecimen tree	Minimum size: 2 ½ inch caliper dbh. *Trees must be within developed area and cannot comprise more than 30% of total required points.	14 per caliper inch dbh. Maximum points per tree: 200				
andscape furniture for ublic seating and/or ansit connections	* Furniture must be within developed area, publically accessible, and cannot comprise more than 5% of total required points.	5 points per "seat"				
ub Totals						2,790

Total Number of Points Provided 2,790

* As determined by ANSI, ANLA- American standards for nursery stock. For each size, minimum plant sizes shall conform to the specifications as stated in the current American Standard for Nursery Stock.



CREATE THE VISION TELL THE STORY

MADISON MILWAUKEE KENOSHA APPLETON WAUSAU

MADISON REGIONAL OFFICE 161 HORIZON DRIVE, SUITE 101 VERONA, WISCONSIN 53593

P. 608.848.5060 **DEGEN &**

ASSOCIATES. LLC

CLIENT ADDRESS: PO BOX 5567 MADISON, WI 53705-0567

ROJECT

5133 & 5237 **UNIVERSITY AVE**

ROJECT LOCATION: MADISON, WI **DANE COUNTY**

PLAN	N MODIFICATIO	NS:
#	Date:	Description:
1	01.15.2020	LAND USE UDC INITIAL
2	04.17.2020	LAND USE RESUBMITTAL
3	10.21.2020	UDC FINAL
4	11.13.2020	PRELIMINARY BID SET
5		
6		
7		
8		
9		
10		
11		
12		
13		
14		
15		

esign/Drawn: pproved: MAS

LANDSCAPE NOTES. **DETAILS & SPECIFICATIONS**

SD PROJECT NO:

		E	EXTERIOR MATERIALS SCHEDU	LE		
MARK	DESCRIPTION	MANUFACTURER	TYPE / STYLE	DIMENSIONS	COLOR	NOTES
1	VINYL WINDOWS	PLYGEM WINDOWS AND DOORS		SEE PLANS	CLAY	
2	VINYL SLIDING PATIO DOOR	PLYGEM WINDOWS AND DOORS		SEE PLANS	CLAY	
3	MASONRY - BRICK VENEER - COLOR #1	BOWERSTON SHALE COMPANY		UTILITY	BLEND: AUTUMN CLEAR W/C & SUNSET CLEAR W/C	
4	MASONRY - BURNISHED BLOCK VENEER - COLOR #1	COUNTY MATERIALS	PREMIER ULTRA BURNISHED MASONRY UNITS	3 5/8"x7 5/8"x15 5/8"	SOLSTICE (63-219C)	
5	MASONRY - BURNISHED BLOCK VENEER - COLOR #2	COUNTY MATERIALS	PREMIER ULTRA BURNISHED MASONRY UNITS	3 5/8"x7 5/8"x15 5/8"	BLACK GRANITE (CUSTOM COLOR)	
6	PRECAST CONCRETE SILL - COLOR #1	CAPITAL CAST STONE	SMOOTH FACE	SEE ELEVATIONS	VANILLA	
7	PRECAST CONCRETE SILL - COLOR #2	CAPITAL CAST STONE	SMOOTH FACE	SEE ELEVATIONS	GREYSTONE	
8	COMPOSITE LAP SIDING - COLOR #1	JAMES HARDIE	HARDIPLANK HORIZONTAL LAP SIDING	7" EXPOSURE	COBBLE STONE	SMOOTH FINISH
9	COMPOSITE LAP SIDING - COLOR #2	JAMES HARDIE	HARDIPLANK HORIZONTAL LAP SIDING	7" EXPOSURE	TERRAIN	SMOOTH FINISH
10	COMPOSITE PANEL SIDING - COLOR #1	JAMES HARDIE	HARDIPANEL VERTICAL SIDING	PANEL	COBBLE STONE	SMOOTH FINISH
11	COMPOSITE PANEL SIDING - COLOR #2	JAMES HARDIE	HARDIPANEL VERTICAL SIDING	PANEL	IRON GRAY	SMOOTH FINISH
12	COMPOSITE PANEL SIDING - COLOR #3	JAMES HARDIE	HARDIPANEL VERTICAL SIDING	PANEL	PRIMED FOR PAINT	SW 6907 FORSYTHIA
1 3	COMPOSITE PANEL SIDING - COLOR #4	JAMES HARDIE	HARDIPANEL VERTICAL SIDING	PANEL	KHAKI BROWN	SMOOTH FINISH
14	COMPOSITE PANEL BALCONY FASCIA	JAMES HARDIE	HARDIPANEL VERTICAL SIDING	PANEL	COBBLE STONE	SMOOTH FINISH
1 5	BALCONY RAILING	TBD			DARK GRAY	
16	BALCONY DECKING	TREX	COMPOSITE DECKING			
17	ALUMINUM GRAVEL STOP COLOR #1	(PREFABRICATED)	PREFINISHED ALUMINUM	SEE ELEVATIONS	TO MATCH HARDIPANEL COBBLE STONE	

MARK	DESCRIPTION	MANUFACTURER	TYPE / STYLE	DIMENSIONS	COLOR	NOTES
			7 -			NOTES
18	ALUMINUM GRAVEL STOP COLOR #2	(PREFABRICATED)	PREFINISHED ALUMINUM	SEE ELEVATIONS	TO MATCH HARDIPANEL IRON GRAY	
19	ALUMINUM COPING CAP COLOR #1	(PREFABRICATED)	PREFINISHED ALUMINUM	SEE ELEVATIONS	TO MATCH HARDIPANEL COBBLE STONE	
20	ALUMINUM COPING CAP COLOR #2	(PREFABRICATED)	PREFINISHED ALUMINUM	SEE ELEVATIONS	TO MATCH HARDIPANEL IRON GRAY	
2 1	ALUMINUM COPING CAP COLOR #3	(PREFABRICATED)	PREFINISHED ALUMINUM	SEE ELEVATIONS	TO MATCH MASONRY BRICK VENEER COLOR #1	
22	ALUMINUM STOREFRONT WINDOW SYSTEM	KAWNEER - OR EQUAL	TRIFAB 451T		BLACK	
2 3	ALUMINUM STOREFRONT ENTRANCE / EXIT DOORS	KAWNEER - OR EQUAL	500 WIDE STILE		BLACK	
2 4	OVERHEAD GARAGE DOOR	WAYNE DALTON - OR EQUAL	190 SERIES: INSULATED STEEL	SEE DOOR SCHEDULE	PAINT TO MATCH MASONRY - 1	
2 5	STEEL ENTRY DOOR	THERMA-TRU - OR EQUAL	INSULATED	SEE DOOR SCHEDULE	PAINT TO MATCH ADJACENT MATERIALS	
2 7	METAL SUNSHADE AWNING	(PREFABRICATED)	PREFABRICATED ALUMINUM		GRAY	
2 8	METAL CANOPY	(PREFABRICATED)	PREFABRICATED ALUMINUM		GRAY	
2 9	FIBERGLASS SHINGLES	OWENS CORNING - OR EQUAL	30 YEAR DIMENSIONAL ASPHALT	SEE PLANS	TEAK	
3 0	CANOPY SIGNAGE	TBD	BASE MOUNTED CUT-OUT CHARACTERS	16" HIGH LETTERING	TBD	
3 1	BUILDING SIGNAGE	TBD			TBD	
3 2	ROOF SCREEN COMPOSITE PANEL SIDING - COLOR #1	JAMES HARDIE	HARDIPANEL VERTICAL SIDING	PANEL	COBBLE STONE	SMOOTH FINISH
3 3	INSET DORMER ROOF					
3 4	METAL EXHAUST / INTAKE LOUVER					
3 5	HOLLOW METAL WINDOWS			SEE PLANS	BLACK	

E)	XTERIOR ELEVATION NOTES
1)	COORDINATE WITH ARCHITECT THE LOCATION OF ALL MEP- RELATED PENETRATIONS OF THE EXTERIOR ENVELOPE.
•	COORDINATE WITH ARCHITECT THE LOCATION OF ALL EXTERIOR MATERIAL PANEL JOINTS, CONTROL JOINTS, AND EXPANSION JOINTS.
3)	
4)	REFER TO BUILDING DETAILS FOR PRECAST BANDING AND SILL PROFILES.
	ALL WINDOW GLAZING IN PARKING AREAS SHALL BE OPAQUE – COLOR AND PATTERN TO BE DETERMINED.



JLA PROJECT NUMBER: 18-1112



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DATE OF	ISSUANCE	NOVEN	1BER 4, 2020	
revision schedule				
Mark	Descripti	ion	Date	

SHEET TITLE

EXTERIOR ELEVATIONS-BUILDING 'A'

SHEET NUMBER

A200-A






EXTERIOR MATERIALS SCHEDULE							
MARK	DESCRIPTION	MANUFACTURER	TYPE / STYLE	DIMENSIONS	COLOR	NOTES	
1	VINYL WINDOWS	PLYGEM WINDOWS AND DOORS		SEE PLANS	CLAY		
2	VINYL SLIDING PATIO DOOR	PLYGEM WINDOWS AND DOORS		SEE PLANS	CLAY		
3	MASONRY - BRICK VENEER - COLOR #1	BOWERSTON SHALE COMPANY		UTILITY	BLEND: AUTUMN CLEAR W/C & SUNSET CLEAR W/C		
1	MASONRY - BURNISHED BLOCK VENEER - COLOR #1	COUNTY MATERIALS	PREMIER ULTRA BURNISHED MASONRY UNITS	3 5/8"x7 5/8"x15 5/8"	SOLSTICE (63-219C)		
5	MASONRY - BURNISHED BLOCK VENEER - COLOR #2	COUNTY MATERIALS	PREMIER ULTRA BURNISHED MASONRY UNITS	3 5/8"x7 5/8"x15 5/8"	BLACK GRANITE (CUSTOM COLOR)		
5	PRECAST CONCRETE SILL - COLOR #1	CAPITAL CAST STONE	SMOOTH FACE	SEE ELEVATIONS	VANILLA		
7	PRECAST CONCRETE SILL - COLOR #2	CAPITAL CAST STONE	SMOOTH FACE	SEE ELEVATIONS	GREYSTONE		
3	COMPOSITE LAP SIDING - COLOR #1	JAMES HARDIE	HARDIPLANK HORIZONTAL LAP SIDING	7" EXPOSURE	COBBLE STONE	SMOOTH FINISH	
)	COMPOSITE LAP SIDING - COLOR #2	JAMES HARDIE	HARDIPLANK HORIZONTAL LAP SIDING	7" EXPOSURE	TERRAIN	SMOOTH FINISH	
0	COMPOSITE PANEL SIDING - COLOR #1	JAMES HARDIE	HARDIPANEL VERTICAL SIDING	PANEL	COBBLE STONE	SMOOTH FINISH	
1	COMPOSITE PANEL SIDING - COLOR #2	JAMES HARDIE	HARDIPANEL VERTICAL SIDING	PANEL	IRON GRAY	SMOOTH FINISH	
2	COMPOSITE PANEL SIDING - COLOR #3	JAMES HARDIE	HARDIPANEL VERTICAL SIDING	PANEL	PRIMED FOR PAINT	SW 6907 FORSYTHIA	
3	COMPOSITE PANEL SIDING - COLOR #4	JAMES HARDIE	HARDIPANEL VERTICAL SIDING	PANEL	KHAKI BROWN	SMOOTH FINISH	
1 4	COMPOSITE PANEL BALCONY FASCIA	JAMES HARDIE	HARDIPANEL VERTICAL SIDING	PANEL	COBBLE STONE	SMOOTH FINISH	
1 5	BALCONY RAILING	TBD			DARK GRAY		
16	BALCONY DECKING	TREX	COMPOSITE DECKING				
17	ALUMINUM GRAVEL STOP COLOR #1	(PREFABRICATED)	PREFINISHED ALUMINUM	SEE ELEVATIONS	TO MATCH HARDIPANEL COBBLE STONE		

MARK	DESCRIPTION	MANUFACTURER	TYPE / STYLE	DIMENSIONS	COLOR	NOTES
1 8	ALUMINUM GRAVEL STOP COLOR #2	(PREFABRICATED)	PREFINISHED ALUMINUM	SEE ELEVATIONS	TO MATCH HARDIPANEL IRON GRAY	
19	ALUMINUM COPING CAP COLOR #1	(PREFABRICATED)	PREFINISHED ALUMINUM	SEE ELEVATIONS	TO MATCH HARDIPANEL COBBLE STONE	
2 0	ALUMINUM COPING CAP COLOR #2	(PREFABRICATED)	PREFINISHED ALUMINUM	SEE ELEVATIONS	TO MATCH HARDIPANEL IRON GRAY	
2 1	ALUMINUM COPING CAP COLOR #3	(PREFABRICATED)	PREFINISHED ALUMINUM	SEE ELEVATIONS	TO MATCH MASONRY BRICK VENEER COLOR #1	
2 2	ALUMINUM STOREFRONT WINDOW SYSTEM	KAWNEER - OR EQUAL	TRIFAB 451T		BLACK	
2 3	ALUMINUM STOREFRONT ENTRANCE / EXIT DOORS	KAWNEER - OR EQUAL	500 WIDE STILE		BLACK	
2 4	OVERHEAD GARAGE DOOR	WAYNE DALTON - OR EQUAL	190 SERIES: INSULATED STEEL	SEE DOOR SCHEDULE	PAINT TO MATCH MASONRY - 1	
2 5	STEEL ENTRY DOOR	THERMA-TRU - OR EQUAL	INSULATED	SEE DOOR SCHEDULE	PAINT TO MATCH ADJACENT MATERIALS	
2 7	METAL SUNSHADE AWNING	(PREFABRICATED)	PREFABRICATED ALUMINUM		GRAY	
2 8	METAL CANOPY	(PREFABRICATED)	PREFABRICATED ALUMINUM		GRAY	
2 9	FIBERGLASS SHINGLES	OWENS CORNING - OR EQUAL	30 YEAR DIMENSIONAL ASPHALT	SEE PLANS	TEAK	
3 0	CANOPY SIGNAGE	TBD	BASE MOUNTED CUT-OUT CHARACTERS	16" HIGH LETTERING	TBD	
3 1	BUILDING SIGNAGE	TBD			TBD	
3 2	ROOF SCREEN COMPOSITE PANEL SIDING - COLOR #1	JAMES HARDIE	HARDIPANEL VERTICAL SIDING	PANEL	COBBLE STONE	SMOOTH FINISH
3 3	INSET DORMER ROOF					
3 4	METAL EXHAUST / INTAKE LOUVER					
3 5	HOLLOW METAL WINDOWS			SEE PLANS	BLACK	

1) COORDINATE WITH ARCHITECT THE LOCATION OF ALL MEP-RELATED PENETRATIONS OF THE EXTERIOR ENVELOPE. 2) COORDINATE WITH ARCHITECT THE LOCATION OF ALL EXTERIOR MATERIAL PANEL JOINTS, CONTROL JOINTS, AND EXPANSION JOINTS. REFER TO BUILDING DETAILS FOR PRECAST BANDING AND SILL 4) PROFILES.

ALL WINDOW GLAZING IN PARKING AREAS SHALL BE OPAQUE - COLOR AND PATTERN TO BE DETERMINED.

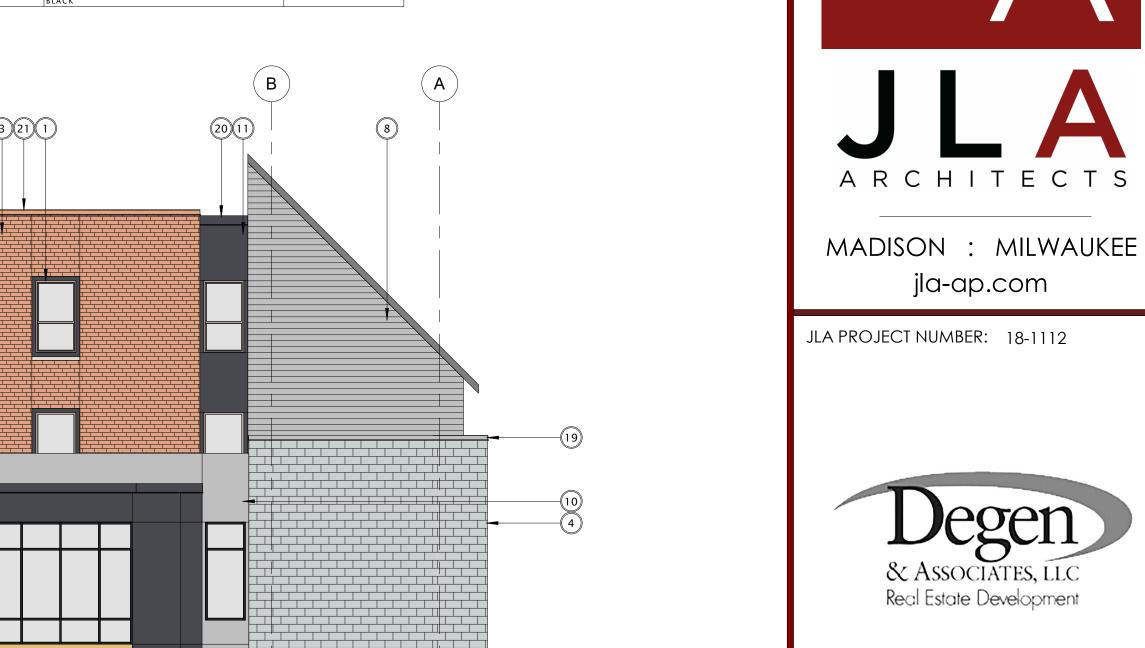

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& ASSOCIATES, LLC Real Estate Development

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revision schedule						
Mark	Descripti	on	Date			

SHEET TITLE

EXTERIOR ELEVATIONS-BUILDING 'A'

Sheet Number





18 BUILDING 'A' - SOUTH ELEVATION
1/8" = 1'-0"

EXTERIOR MATERIALS SCHEDULE						
MARK	DESCRIPTION	MANUFACTURER	TYPE / STYLE	DIMENSIONS	COLOR	NOTES
1	VINYL WINDOWS	PLYGEM WINDOWS AND DOORS		SEE PLANS	CLAY	
2	VINYL SLIDING PATIO DOOR	PLYGEM WINDOWS AND DOORS		SEE PLANS	CLAY	
3	MASONRY - BRICK VENEER - COLOR #1	BOWERSTON SHALE COMPANY		UTILITY	BLEND: AUTUMN CLEAR W/C & SUNSET CLEAR W/C	
4	MASONRY - BURNISHED BLOCK VENEER - COLOR #1	COUNTY MATERIALS	PREMIER ULTRA BURNISHED MASONRY UNITS	3 5/8"x7 5/8"x15 5/8"	SOLSTICE (63-219C)	
5	MASONRY - BURNISHED BLOCK VENEER - COLOR #2	COUNTY MATERIALS	PREMIER ULTRA BURNISHED MASONRY UNITS	3 5/8"x7 5/8"x15 5/8"	BLACK GRANITE (CUSTOM COLOR)	
6	PRECAST CONCRETE SILL - COLOR #1	CAPITAL CAST STONE	SMOOTH FACE	SEE ELEVATIONS	VANILLA	
7	PRECAST CONCRETE SILL - COLOR #2	CAPITAL CAST STONE	SMOOTH FACE	SEE ELEVATIONS	GREYSTONE	
8	COMPOSITE LAP SIDING - COLOR #1	JAMES HARDIE	HARDIPLANK HORIZONTAL LAP SIDING	7" EXPOSURE	COBBLE STONE	SMOOTH FINISH
9	COMPOSITE LAP SIDING - COLOR #2	JAMES HARDIE	HARDIPLANK HORIZONTAL LAP SIDING	7" EXPOSURE	TERRAIN	SMOOTH FINISH
10	COMPOSITE PANEL SIDING - COLOR #1	JAMES HARDIE	HARDIPANEL VERTICAL SIDING	PANEL	COBBLE STONE	SMOOTH FINISH
11	COMPOSITE PANEL SIDING - COLOR #2	JAMES HARDIE	HARDIPANEL VERTICAL SIDING	PANEL	IRON GRAY	SMOOTH FINISH
12	COMPOSITE PANEL SIDING - COLOR #3	JAMES HARDIE	HARDIPANEL VERTICAL SIDING	PANEL	PRIMED FOR PAINT	SW 6907 FORSYTHIA
1 3	COMPOSITE PANEL SIDING - COLOR #4	JAMES HARDIE	HARDIPANEL VERTICAL SIDING	PANEL	KHAKI BROWN	SMOOTH FINISH
14	COMPOSITE PANEL BALCONY FASCIA	JAMES HARDIE	HARDIPANEL VERTICAL SIDING	PANEL	COBBLE STONE	SMOOTH FINISH
15	BALCONY RAILING	TBD			DARK GRAY	
16	BALCONY DECKING	TREX	COMPOSITE DECKING			
1 7	ALUMINUM GRAVEL STOP COLOR #1	(PREFABRICATED)	PREFINISHED ALUMINUM	SEE ELEVATIONS	TO MATCH HARDIPANEL COBBLE STONE	

11 1 8 19

11 1 20

14 2 15

MARK	DESCRIPTION	MANUFACTURER	TYPE / STYLE	DIMENSIONS	COLOR	NOTES
3	ALUMINUM GRAVEL STOP COLOR #2	(PREFABRICATED)	PREFINISHED ALUMINUM	SEE ELEVATIONS	TO MATCH HARDIPANEL IRON GRAY	
)	ALUMINUM COPING CAP COLOR #1	(PREFABRICATED)	PREFINISHED ALUMINUM	SEE ELEVATIONS	TO MATCH HARDIPANEL COBBLE STONE	
)	ALUMINUM COPING CAP COLOR #2	(PREFABRICATED)	PREFINISHED ALUMINUM	SEE ELEVATIONS	TO MATCH HARDIPANEL IRON GRAY	
ı	ALUMINUM COPING CAP COLOR #3	(PREFABRICATED)	PREFINISHED ALUMINUM	SEE ELEVATIONS	TO MATCH MASONRY BRICK VENEER COLOR #1	
2	ALUMINUM STOREFRONT WINDOW SYSTEM	KAWNEER - OR EQUAL	TRIFAB 451T		BLACK	
3	ALUMINUM STOREFRONT ENTRANCE / EXIT DOORS	KAWNEER - OR EQUAL	500 WIDE STILE		BLACK	
4	OVERHEAD GARAGE DOOR	WAYNE DALTON - OR EQUAL	190 SERIES: INSULATED STEEL	SEE DOOR SCHEDULE	PAINT TO MATCH MASONRY - 1	
5	STEEL ENTRY DOOR	THERMA-TRU - OR EQUAL	INSULATED	SEE DOOR SCHEDULE	PAINT TO MATCH ADJACENT MATERIALS	
2 7	METAL SUNSHADE AWNING	(PREFABRICATED)	PREFABRICATED ALUMINUM		GRAY	
2.8	METAL CANOPY	(PREFABRICATED)	PREFABRICATED ALUMINUM		GRAY	
9	FIBERGLASS SHINGLES	OWENS CORNING - OR EQUAL	30 YEAR DIMENSIONAL ASPHALT	SEE PLANS	TEAK	
3 0	CANOPY SIGNAGE	TBD	BASE MOUNTED CUT-OUT CHARACTERS	16" HIGH LETTERING	TBD	
31	BUILDING SIGNAGE	TBD			TBD	
3 2	ROOF SCREEN COMPOSITE PANEL SIDING - COLOR #1	JAMES HARDIE	HARDIPANEL VERTICAL SIDING	PANEL	COBBLE STONE	SMOOTH FINISH
3 3	INSET DORMER ROOF					
3 4	METAL EXHAUST / INTAKE LOUVER					
3 5	HOLLOW METAL WINDOWS			SEE PLANS	BLACK	

XTERIOR ELEVATION NOTES	

1) COORDINATE WITH ARCHITECT THE LOCATION OF ALL MEP-RELATED PENETRATIONS OF THE EXTERIOR ENVELOPE.

2) COORDINATE WITH ARCHITECT THE LOCATION OF ALL EXTERIOR MATERIAL PANEL JOINTS, CONTROL JOINTS, AND EXPANSION JOINTS.

3)

3)
REFER TO BUILDING DETAILS FOR PRECAST BANDING AND SILL
4) PROFILES.

ALL WINDOW GLAZING IN PARKING AREAS SHALL BE OPAQUE – COLOR AND PATTERN TO BE DETERMINED.

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Mark	Descripti	on	Date	

SHEET TITLE

EXTERIOR ELEVATIONS-BUILDING 'B'

SHEET NUMBER

A200-B



14 2 14 18 10 15

12 11 1 9 21

6 1 4

16 BUILDING 'B' - SOUTH ELEVATION
1/8" = 1'-0"

T.O. PARAPET WALL – B/C

FOURTH FLOOR - B/C 133'-3 3/4"

SECOND FLOOR - B/C

FIRST FLOOR

ENTRY LEVEL - B/C

EXTERIOR MATERIALS SCHEDULE						
MARK	DESCRIPTION	MANUFACTURER	TYPE / STYLE	DIMENSIONS	COLOR	NOTES
1	VINYL WINDOWS	PLYGEM WINDOWS AND DOORS		SEE PLANS	CLAY	
2	VINYL SLIDING PATIO DOOR	PLYGEM WINDOWS AND DOORS		SEE PLANS	CLAY	
3	MASONRY - BRICK VENEER - COLOR #1	BOWERSTON SHALE COMPANY		UTILITY	BLEND: AUTUMN CLEAR W/C & SUNSET CLEAR W/C	
4	MASONRY - BURNISHED BLOCK VENEER - COLOR #1	COUNTY MATERIALS	PREMIER ULTRA BURNISHED MASONRY UNITS	3 5/8"x7 5/8"x15 5/8"	SOLSTICE (63-219C)	
5	MASONRY - BURNISHED BLOCK VENEER - COLOR #2	COUNTY MATERIALS	PREMIER ULTRA BURNISHED MASONRY UNITS	3 5/8"x7 5/8"x15 5/8"	BLACK GRANITE (CUSTOM COLOR)	
5	PRECAST CONCRETE SILL - COLOR #1	CAPITAL CAST STONE	SMOOTH FACE	SEE ELEVATIONS	VANILLA	
7	PRECAST CONCRETE SILL - COLOR #2	CAPITAL CAST STONE	SMOOTH FACE	SEE ELEVATIONS	GREYSTONE	
3	COMPOSITE LAP SIDING - COLOR #1	JAMES HARDIE	HARDIPLANK HORIZONTAL LAP SIDING	7" EXPOSURE	COBBLE STONE	SMOOTH FINISH
)	COMPOSITE LAP SIDING - COLOR #2	JAMES HARDIE	HARDIPLANK HORIZONTAL LAP SIDING	7" EXPOSURE	TERRAIN	SMOOTH FINISH
10	COMPOSITE PANEL SIDING - COLOR #1	JAMES HARDIE	HARDIPANEL VERTICAL SIDING	PANEL	COBBLE STONE	SMOOTH FINISH
11	COMPOSITE PANEL SIDING - COLOR #2	JAMES HARDIE	HARDIPANEL VERTICAL SIDING	PANEL	IRON GRAY	SMOOTH FINISH
2	COMPOSITE PANEL SIDING - COLOR #3	JAMES HARDIE	HARDIPANEL VERTICAL SIDING	PANEL	PRIMED FOR PAINT	SW 6907 FORSYTHIA
3	COMPOSITE PANEL SIDING - COLOR #4	JAMES HARDIE	HARDIPANEL VERTICAL SIDING	PANEL	KHAKI BROWN	SMOOTH FINISH
1 4	COMPOSITE PANEL BALCONY FASCIA	JAMES HARDIE	HARDIPANEL VERTICAL SIDING	PANEL	COBBLE STONE	SMOOTH FINISH
1 5	BALCONY RAILING	TBD			DARK GRAY	
16	BALCONY DECKING	TREX	COMPOSITE DECKING			
1 7	ALUMINUM GRAVEL STOP COLOR #1	(PREFABRICATED)	PREFINISHED ALUMINUM	SEE ELEVATIONS	TO MATCH HARDIPANEL COBBLE STONE	

			EXTERIOR MATERIALS SCHED	ULE		
MARK	DESCRIPTION	MANUFACTURER	TYPE / STYLE	DIMENSIONS	COLOR	NOTES
18	ALUMINUM GRAVEL STOP COLOR #2	(PREFABRICATED)	PREFINISHED ALUMINUM	SEE ELEVATIONS	TO MATCH HARDIPANEL IRON GRAY	
19	ALUMINUM COPING CAP COLOR #1	(PREFABRICATED)	PREFINISHED ALUMINUM	SEE ELEVATIONS	TO MATCH HARDIPANEL COBBLE STONE	
20	ALUMINUM COPING CAP COLOR #2	(PREFABRICATED)	PREFINISHED ALUMINUM	SEE ELEVATIONS	TO MATCH HARDIPANEL IRON GRAY	
21	ALUMINUM COPING CAP COLOR #3	(PREFABRICATED)	PREFINISHED ALUMINUM	SEE ELEVATIONS	TO MATCH MASONRY BRICK VENEER COLOR #1	
22	ALUMINUM STOREFRONT WINDOW SYSTEM	KAWNEER - OR EQUAL	TRIFAB 451T		BLACK	
23	ALUMINUM STOREFRONT ENTRANCE / EXIT DOORS	KAWNEER - OR EQUAL	500 WIDE STILE		BLACK	
2 4	OVERHEAD GARAGE DOOR	WAYNE DALTON - OR EQUAL	190 SERIES: INSULATED STEEL	SEE DOOR SCHEDULE	PAINT TO MATCH MASONRY - 1	
2 5	STEEL ENTRY DOOR	THERMA-TRU - OR EQUAL	INSULATED	SEE DOOR SCHEDULE	PAINT TO MATCH ADJACENT MATERIALS	
27	METAL SUNSHADE AWNING	(PREFABRICATED)	PREFABRICATED ALUMINUM		GRAY	
28	METAL CANOPY	(PREFABRICATED)	PREFABRICATED ALUMINUM		GRAY	
29	FIBERGLASS SHINGLES	OWENS CORNING - OR EQUAL	30 YEAR DIMENSIONAL ASPHALT	SEE PLANS	TEAK	
3 0	CANOPY SIGNAGE	TBD	BASE MOUNTED CUT-OUT CHARACTERS	16" HIGH LETTERING	TBD	
3 1	BUILDING SIGNAGE	TBD			TBD	
3 2	ROOF SCREEN COMPOSITE PANEL SIDING - COLOR #1	JAMES HARDIE	HARDIPANEL VERTICAL SIDING	PANEL	COBBLE STONE	SMOOTH FINISH
3 3	INSET DORMER ROOF					
3 4	METAL EXHAUST / INTAKE LOUVER					
3 5	HOLLOW METAL WINDOWS			SEE PLANS	BLACK	

EXTERIOR ELEVATION NOTES

1) COORDINATE WITH ARCHITECT THE LOCATION OF ALL MEP-RELATED PENETRATIONS OF THE EXTERIOR ENVELOPE.

2) COORDINATE WITH ARCHITECT THE LOCATION OF ALL EXTERIOR MATERIAL PANEL JOINTS, CONTROL JOINTS, AND EXPANSION JOINTS.

3)

REFER TO BUILDING DETAILS FOR PRECAST BANDING AND SILL
4) PROFILES.

ALL WINDOW GLAZING IN PARKING AREAS SHALL BE OPAQUE – COLOR AND PATTERN TO BE DETERMINED.



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	·				

SHEET TITLE

EXTERIOR ELEVATIONS-BUILDING 'B'

SHEET NUMBER

A201-B





		E	XTERIOR MATERIALS SCHEDU	LE		
MARK	DESCRIPTION	MANUFACTURER	TYPE / STYLE	DIMENSIONS	COLOR	NOTES
1	VINYL WINDOWS	PLYGEM WINDOWS AND DOORS		SEE PLANS	CLAY	
2	VINYL SLIDING PATIO DOOR	PLYGEM WINDOWS AND DOORS		SEE PLANS	CLAY	
3	MASONRY - BRICK VENEER - COLOR #1	BOWERSTON SHALE COMPANY		UTILITY	BLEND: AUTUMN CLEAR W/C & SUNSET CLEAR W/C	
4	MASONRY - BURNISHED BLOCK VENEER - COLOR #1	COUNTY MATERIALS	PREMIER ULTRA BURNISHED MASONRY UNITS	3 5/8"x7 5/8"x15 5/8"	SOLSTICE (63-219C)	
5	MASONRY - BURNISHED BLOCK VENEER - COLOR #2	COUNTY MATERIALS	PREMIER ULTRA BURNISHED MASONRY UNITS	3 5/8"x7 5/8"x15 5/8"	BLACK GRANITE (CUSTOM COLOR)	
ŝ	PRECAST CONCRETE SILL - COLOR #1	CAPITAL CAST STONE	SMOOTH FACE	SEE ELEVATIONS	VANILLA	
7	PRECAST CONCRETE SILL - COLOR #2	CAPITAL CAST STONE	SMOOTH FACE	SEE ELEVATIONS	GREYSTONE	
8	COMPOSITE LAP SIDING - COLOR #1	JAMES HARDIE	HARDIPLANK HORIZONTAL LAP SIDING	7" EXPOSURE	COBBLE STONE	SMOOTH FINISH
)	COMPOSITE LAP SIDING - COLOR #2	JAMES HARDIE	HARDIPLANK HORIZONTAL LAP SIDING	7" EXPOSURE	TERRAIN	SMOOTH FINISH
10	COMPOSITE PANEL SIDING - COLOR #1	JAMES HARDIE	HARDIPANEL VERTICAL SIDING	PANEL	COBBLE STONE	SMOOTH FINISH
11	COMPOSITE PANEL SIDING - COLOR #2	JAMES HARDIE	HARDIPANEL VERTICAL SIDING	PANEL	IRON GRAY	SMOOTH FINISH
12	COMPOSITE PANEL SIDING - COLOR #3	JAMES HARDIE	HARDIPANEL VERTICAL SIDING	PANEL	PRIMED FOR PAINT	SW 6907 FORSYTHIA
3	COMPOSITE PANEL SIDING - COLOR #4	JAMES HARDIE	HARDIPANEL VERTICAL SIDING	PANEL	KHAKI BROWN	SMOOTH FINISH
1 4	COMPOSITE PANEL BALCONY FASCIA	JAMES HARDIE	HARDIPANEL VERTICAL SIDING	PANEL	COBBLE STONE	SMOOTH FINISH
1 5	BALCONY RAILING	TBD			DARK GRAY	
16	BALCONY DECKING	TREX	COMPOSITE DECKING			
1 7	ALUMINUM GRAVEL STOP COLOR #1	(PREFABRICATED)	PREFINISHED ALUMINUM	SEE ELEVATIONS	TO MATCH HARDIPANEL COBBLE STONE	

17) BUILDING 'C' - SOUTH ELEVATION
1/8" = 1'-0"

MARK	DESCRIPTION	MANUFACTURER	TYPE / STYLE	DIMENSIONS	COLOR	NOTES
8	ALUMINUM GRAVEL STOP COLOR #2	(PREFABRICATED)	PREFINISHED ALUMINUM	SEE ELEVATIONS	TO MATCH HARDIPANEL IRON GRAY	
9	ALUMINUM COPING CAP COLOR #1	(PREFABRICATED)	PREFINISHED ALUMINUM	SEE ELEVATIONS	TO MATCH HARDIPANEL COBBLE STONE	
0	ALUMINUM COPING CAP COLOR #2	(PREFABRICATED)	PREFINISHED ALUMINUM	SEE ELEVATIONS	TO MATCH HARDIPANEL IRON GRAY	
2 1	ALUMINUM COPING CAP COLOR #3	(PREFABRICATED)	PREFINISHED ALUMINUM	SEE ELEVATIONS	TO MATCH MASONRY BRICK VENEER COLOR #1	
2	ALUMINUM STOREFRONT WINDOW SYSTEM	KAWNEER - OR EQUAL	TRIFAB 451T		BLACK	
23	ALUMINUM STOREFRONT ENTRANCE / EXIT DOORS	KAWNEER - OR EQUAL	500 WIDE STILE		BLACK	
<u>.</u> 4	OVERHEAD GARAGE DOOR	WAYNE DALTON - OR EQUAL	190 SERIES: INSULATED STEEL	SEE DOOR SCHEDULE	PAINT TO MATCH MASONRY - 1	
2.5	STEEL ENTRY DOOR	THERMA-TRU - OR EQUAL	INSULATED	SEE DOOR SCHEDULE	PAINT TO MATCH ADJACENT MATERIALS	
.7	METAL SUNSHADE AWNING	(PREFABRICATED)	PREFABRICATED ALUMINUM		GRAY	
8	METAL CANOPY	(PREFABRICATED)	PREFABRICATED ALUMINUM		GRAY	
29	FIBERGLASS SHINGLES	OWENS CORNING - OR EQUAL	30 YEAR DIMENSIONAL ASPHALT	SEE PLANS	TEAK	
3 0	CANOPY SIGNAGE	TBD	BASE MOUNTED CUT-OUT CHARACTERS	16" HIGH LETTERING	TBD	
3 1	BUILDING SIGNAGE	TBD			TBD	
32	ROOF SCREEN COMPOSITE PANEL SIDING - COLOR #1	JAMES HARDIE	HARDIPANEL VERTICAL SIDING	PANEL	COBBLE STONE	SMOOTH FINISH
3 3	INSET DORMER ROOF					
3 4	METAL EXHAUST / INTAKE LOUVER					
3 5	HOLLOW METAL WINDOWS			SEE PLANS	BLACK	

XTERIOR ELEVATION NOTES	

1) COORDINATE WITH ARCHITECT THE LOCATION OF ALL MEP-RELATED PENETRATIONS OF THE EXTERIOR ENVELOPE.

2) COORDINATE WITH ARCHITECT THE LOCATION OF ALL EXTERIOR MATERIAL PANEL JOINTS, CONTROL JOINTS, AND EXPANSION JOINTS.

3)
REFER TO BUILDING DETAILS FOR PRECAST BANDING AND SILL

ALL WINDOW GLAZING IN PARKING AREAS SHALL BE OPAQUE – COLOR AND PATTERN TO BE DETERMINED.







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JLA PROJECT NUMBER: 18-1112



DEGEN UNIVERSITY AVENUE MIXED-USE

UDC FINAL

PROGRESS DOCUMENTS

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DATE C)F ISSUANCE	NOVEN	1BER 4, 2020					
REVISION SCHEDULE								
Mark	Descripti	ion	Date					

SHEET TITLE

EXTERIOR ELEVATIONS-BUILDING 'C'

SHEET NUMBER

A200-C

			EXTERIOR MATERIALS SCHEDU	LE		
MARK	DESCRIPTION	MANUFACTURER	TYPE / STYLE	DIMENSIONS	COLOR	NOTES
1	VINYL WINDOWS	PLYGEM WINDOWS AND DOORS		SEE PLANS	CLAY	
2	VINYL SLIDING PATIO DOOR	PLYGEM WINDOWS AND DOORS		SEE PLANS	CLAY	
3	MASONRY - BRICK VENEER - COLOR #1	BOWERSTON SHALE COMPANY		UTILITY	BLEND: AUTUMN CLEAR W/C & SUNSET CLEAR W/C	
4	MASONRY - BURNISHED BLOCK VENEER - COLOR #1	COUNTY MATERIALS	PREMIER ULTRA BURNISHED MASONRY UNITS	3 5/8"x7 5/8"x15 5/8"	SOLSTICE (63-219C)	
5	MASONRY - BURNISHED BLOCK VENEER - COLOR #2	COUNTY MATERIALS	PREMIER ULTRA BURNISHED MASONRY UNITS	3 5/8"x7 5/8"x15 5/8"	BLACK GRANITE (CUSTOM COLOR)	
6	PRECAST CONCRETE SILL - COLOR #1	CAPITAL CAST STONE	SMOOTH FACE	SEE ELEVATIONS	VANILLA	
7	PRECAST CONCRETE SILL - COLOR #2	CAPITAL CAST STONE	SMOOTH FACE	SEE ELEVATIONS	GREYSTONE	
8	COMPOSITE LAP SIDING - COLOR #1	JAMES HARDIE	HARDIPLANK HORIZONTAL LAP SIDING	7" EXPOSURE	COBBLE STONE	SMOOTH FINISH
9	COMPOSITE LAP SIDING - COLOR #2	JAMES HARDIE	HARDIPLANK HORIZONTAL LAP SIDING	7" EXPOSURE	TERRAIN	SMOOTH FINISH
10	COMPOSITE PANEL SIDING - COLOR #1	JAMES HARDIE	HARDIPANEL VERTICAL SIDING	PANEL	COBBLE STONE	SMOOTH FINISH
11	COMPOSITE PANEL SIDING - COLOR #2	JAMES HARDIE	HARDIPANEL VERTICAL SIDING	PANEL	IRON GRAY	SMOOTH FINISH
12	COMPOSITE PANEL SIDING - COLOR #3	JAMES HARDIE	HARDIPANEL VERTICAL SIDING	PANEL	PRIMED FOR PAINT	SW 6907 FORSYTHIA
13	COMPOSITE PANEL SIDING - COLOR #4	JAMES HARDIE	HARDIPANEL VERTICAL SIDING	PANEL	KHAKI BROWN	SMOOTH FINISH
1 4	COMPOSITE PANEL BALCONY FASCIA	JAMES HARDIE	HARDIPANEL VERTICAL SIDING	PANEL	COBBLE STONE	SMOOTH FINISH
1 5	BALCONY RAILING	TBD			DARK GRAY	
16	BALCONY DECKING	TREX	COMPOSITE DECKING			
17	ALUMINUM GRAVEL STOP COLOR #1	(PREFABRICATED)	PREFINISHED ALUMINUM	SEE ELEVATIONS	TO MATCH HARDIPANEL COBBLE STONE	

EXTERIOR MATERIALS SCHEDULE						
MARK	DESCRIPTION	MANUFACTURER	TYPE / STYLE	DIMENSIONS	COLOR	NOTES
18	ALUMINUM GRAVEL STOP COLOR #2	(PREFABRICATED)	PREFINISHED ALUMINUM	SEE ELEVATIONS	TO MATCH HARDIPANEL IRON GRAY	
19	ALUMINUM COPING CAP COLOR #1	(PREFABRICATED)	PREFINISHED ALUMINUM	SEE ELEVATIONS	TO MATCH HARDIPANEL COBBLE STONE	
20	ALUMINUM COPING CAP COLOR #2	(PREFABRICATED)	PREFINISHED ALUMINUM	SEE ELEVATIONS	TO MATCH HARDIPANEL IRON GRAY	
21	ALUMINUM COPING CAP COLOR #3	(PREFABRICATED)	PREFINISHED ALUMINUM	SEE ELEVATIONS	TO MATCH MASONRY BRICK VENEER COLOR #1	
22	ALUMINUM STOREFRONT WINDOW SYSTEM	KAWNEER - OR EQUAL	TRIFAB 451T		BLACK	
23	ALUMINUM STOREFRONT ENTRANCE / EXIT DOORS	KAWNEER - OR EQUAL	500 WIDE STILE		BLACK	
24	OVERHEAD GARAGE DOOR	WAYNE DALTON - OR EQUAL	190 SERIES: INSULATED STEEL	SEE DOOR SCHEDULE	PAINT TO MATCH MASONRY - 1	
25	STEEL ENTRY DOOR	THERMA-TRU - OR EQUAL	INSULATED	SEE DOOR SCHEDULE	PAINT TO MATCH ADJACENT MATERIALS	
27	METAL SUNSHADE AWNING	(PREFABRICATED)	PREFABRICATED ALUMINUM		GRAY	
28	METAL CANOPY	(PREFABRICATED)	PREFABRICATED ALUMINUM		GRAY	
29	FIBERGLASS SHINGLES	OWENS CORNING - OR EQUAL	30 YEAR DIMENSIONAL ASPHALT	SEE PLANS	TEAK	
30	CANOPY SIGNAGE	TBD	BASE MOUNTED CUT-OUT CHARACTERS	16" HIGH LETTERING	TBD	
31	BUILDING SIGNAGE	TBD			TBD	
32	ROOF SCREEN COMPOSITE PANEL SIDING - COLOR #1	JAMES HARDIE	HARDIPANEL VERTICAL SIDING	PANEL	COBBLE STONE	SMOOTH FINISH
3 3	INSET DORMER ROOF					
3 4	METAL EXHAUST / INTAKE LOUVER					
3 5	HOLLOW METAL WINDOWS			SEE PLANS	BLACK	

1) COORDINATE WITH ARCHITECT THE LOCATION OF ALL MEP-RELATED PENETRATIONS OF THE EXTERIOR ENVELOPE.

2) COORDINATE WITH ARCHITECT THE LOCATION OF ALL EXTERIOR MATERIAL PANEL JOINTS, CONTROL JOINTS, AND EXPANSION JOINTS.

3)

REFER TO BUILDING DETAILS FOR PRECAST BANDING AND SILL 4) PROFILES.

ALL WINDOW GLAZING IN PARKING AREAS SHALL BE OPAQUE -COLOR AND PATTERN TO BE DETERMINED.



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SHEET TITLE

EXTERIOR ELEVATIONS-BUILDING 'C'

SHEET NUMBER

A201-C











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NOVEMBER 18, 2020 DATE OF ISSUANCE REVISION SCHEDULE Mark Description

SHEET TITLE

EXTERIOR PERSPECTIVES

SHEET NUMBER





JLA PROJECT NUMBER: 18-1112



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	REVISION	SCHEDULE	
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SHEET TITLE

EXTERIOR PERSPECTIVES

SHEET NUMBER

A221

1) BUILDING A LOOKING SOUTHEAST

1





JLA PROJECT NUMBER: 18-1112



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SHEET TITLE

EXTERIOR PERSPECTIVES

SHEET NUMBER

A222





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UDC FINAL

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	REVISION	SCHEDULE
Mark	Descrip	tion Date

SHEET TITLE

EXTERIOR PERSPECTIVES

SHEET NUMBER

A223





JLA PROJECT NUMBER: 18-1112



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SHEET TITLE

EXTERIOR PERSPECTIVES

SHEET NUMBER

A224