1 | 2 | 3 | 4 | 5 | 6 | 7 | 8 | 9 | 10 | 11 | 12 | 13 | 14 | 15 | 25 | 25 |

1 | 2 | 3 | 4 | 5 | 6 | 7 | 8 | 9 | 10 | 11 | 12 | 13 | 14 | 25 | 25 |

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APPLICATION PLANS REFERENCED

IN THIS DRAWING

Fire access plan


SITE GEOMETRY PLAN

A002-1



1 | 2 | 3 | 4 | 5 | 6 | 7 | 8 | 9 | 10 | 11 | 12 | 13 | 14 | 15 | 25 |

KID ZONE FENCE PLANTER

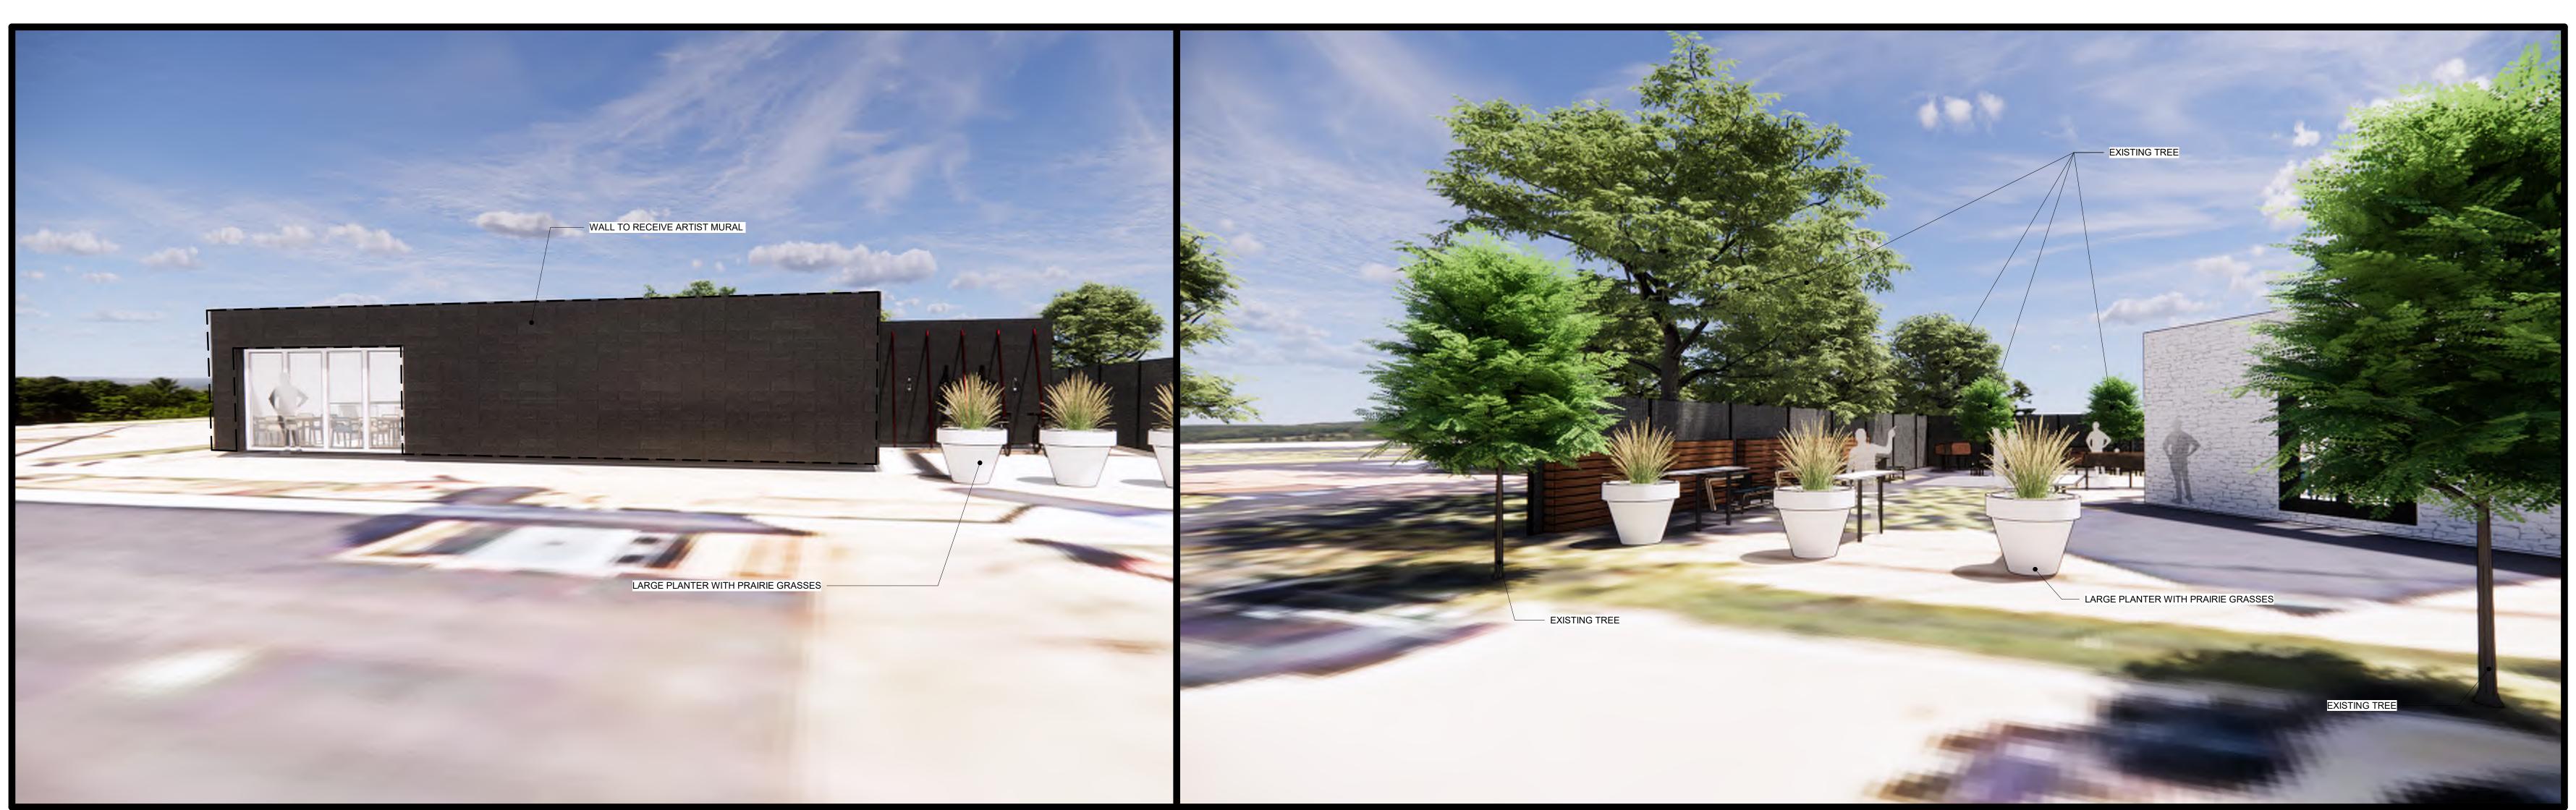

NORTH STREET ELEVATION OUTDOOR DINING AREA ENTRY PRELIMINARY. NOT FOR CONSTRUCTION.
Sheet Number

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General Contractor

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MP-SQUARED STRUCTURAL **ENGINEERS** 583 D'ONOFRIO DR UNIT 201 MADISON, WI 53719

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**EXTERIOR RENDERINGS** 

A002-2

1. DIMENSIONS ARE MEASURED FACE-OF-FINISH TO FACE-OF-FINISH OR ROUGH MASONRY OPENING UNLESS NOTED OTHERWISE - TYPICAL FOR ALL

2. FIELD VERIFY ALL DIMENSIONS AND EXISTING CONDITIONS - TYPICAL FOR ALL DRAWINGS. 3. IN THE EVENT OF A DISCREPANCY BETWEEN ARCHITECTURAL AND CONSULTANT DRAWINGS, NOTIFY

ARCHITECT IMMEDIATELY PRIOR TO COMMENCING WORK - TYPICAL FOR ALL DRAWINGS. ALL PENETRATIONS IN FIRE RATED
 FLOORS AND WALLS MUST BE SEALED WITH APPROPRIATE FIRESTOPPING

5. PATCH AND REPAIR EXISTING FLOOR SLABS AND WALL SURFACES DAMAGED FROM DEMOLITION.

**KEYNOTE LEGEND** 

**ACCESSORIES LEGEND** 

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**FLOOR PLAN** 

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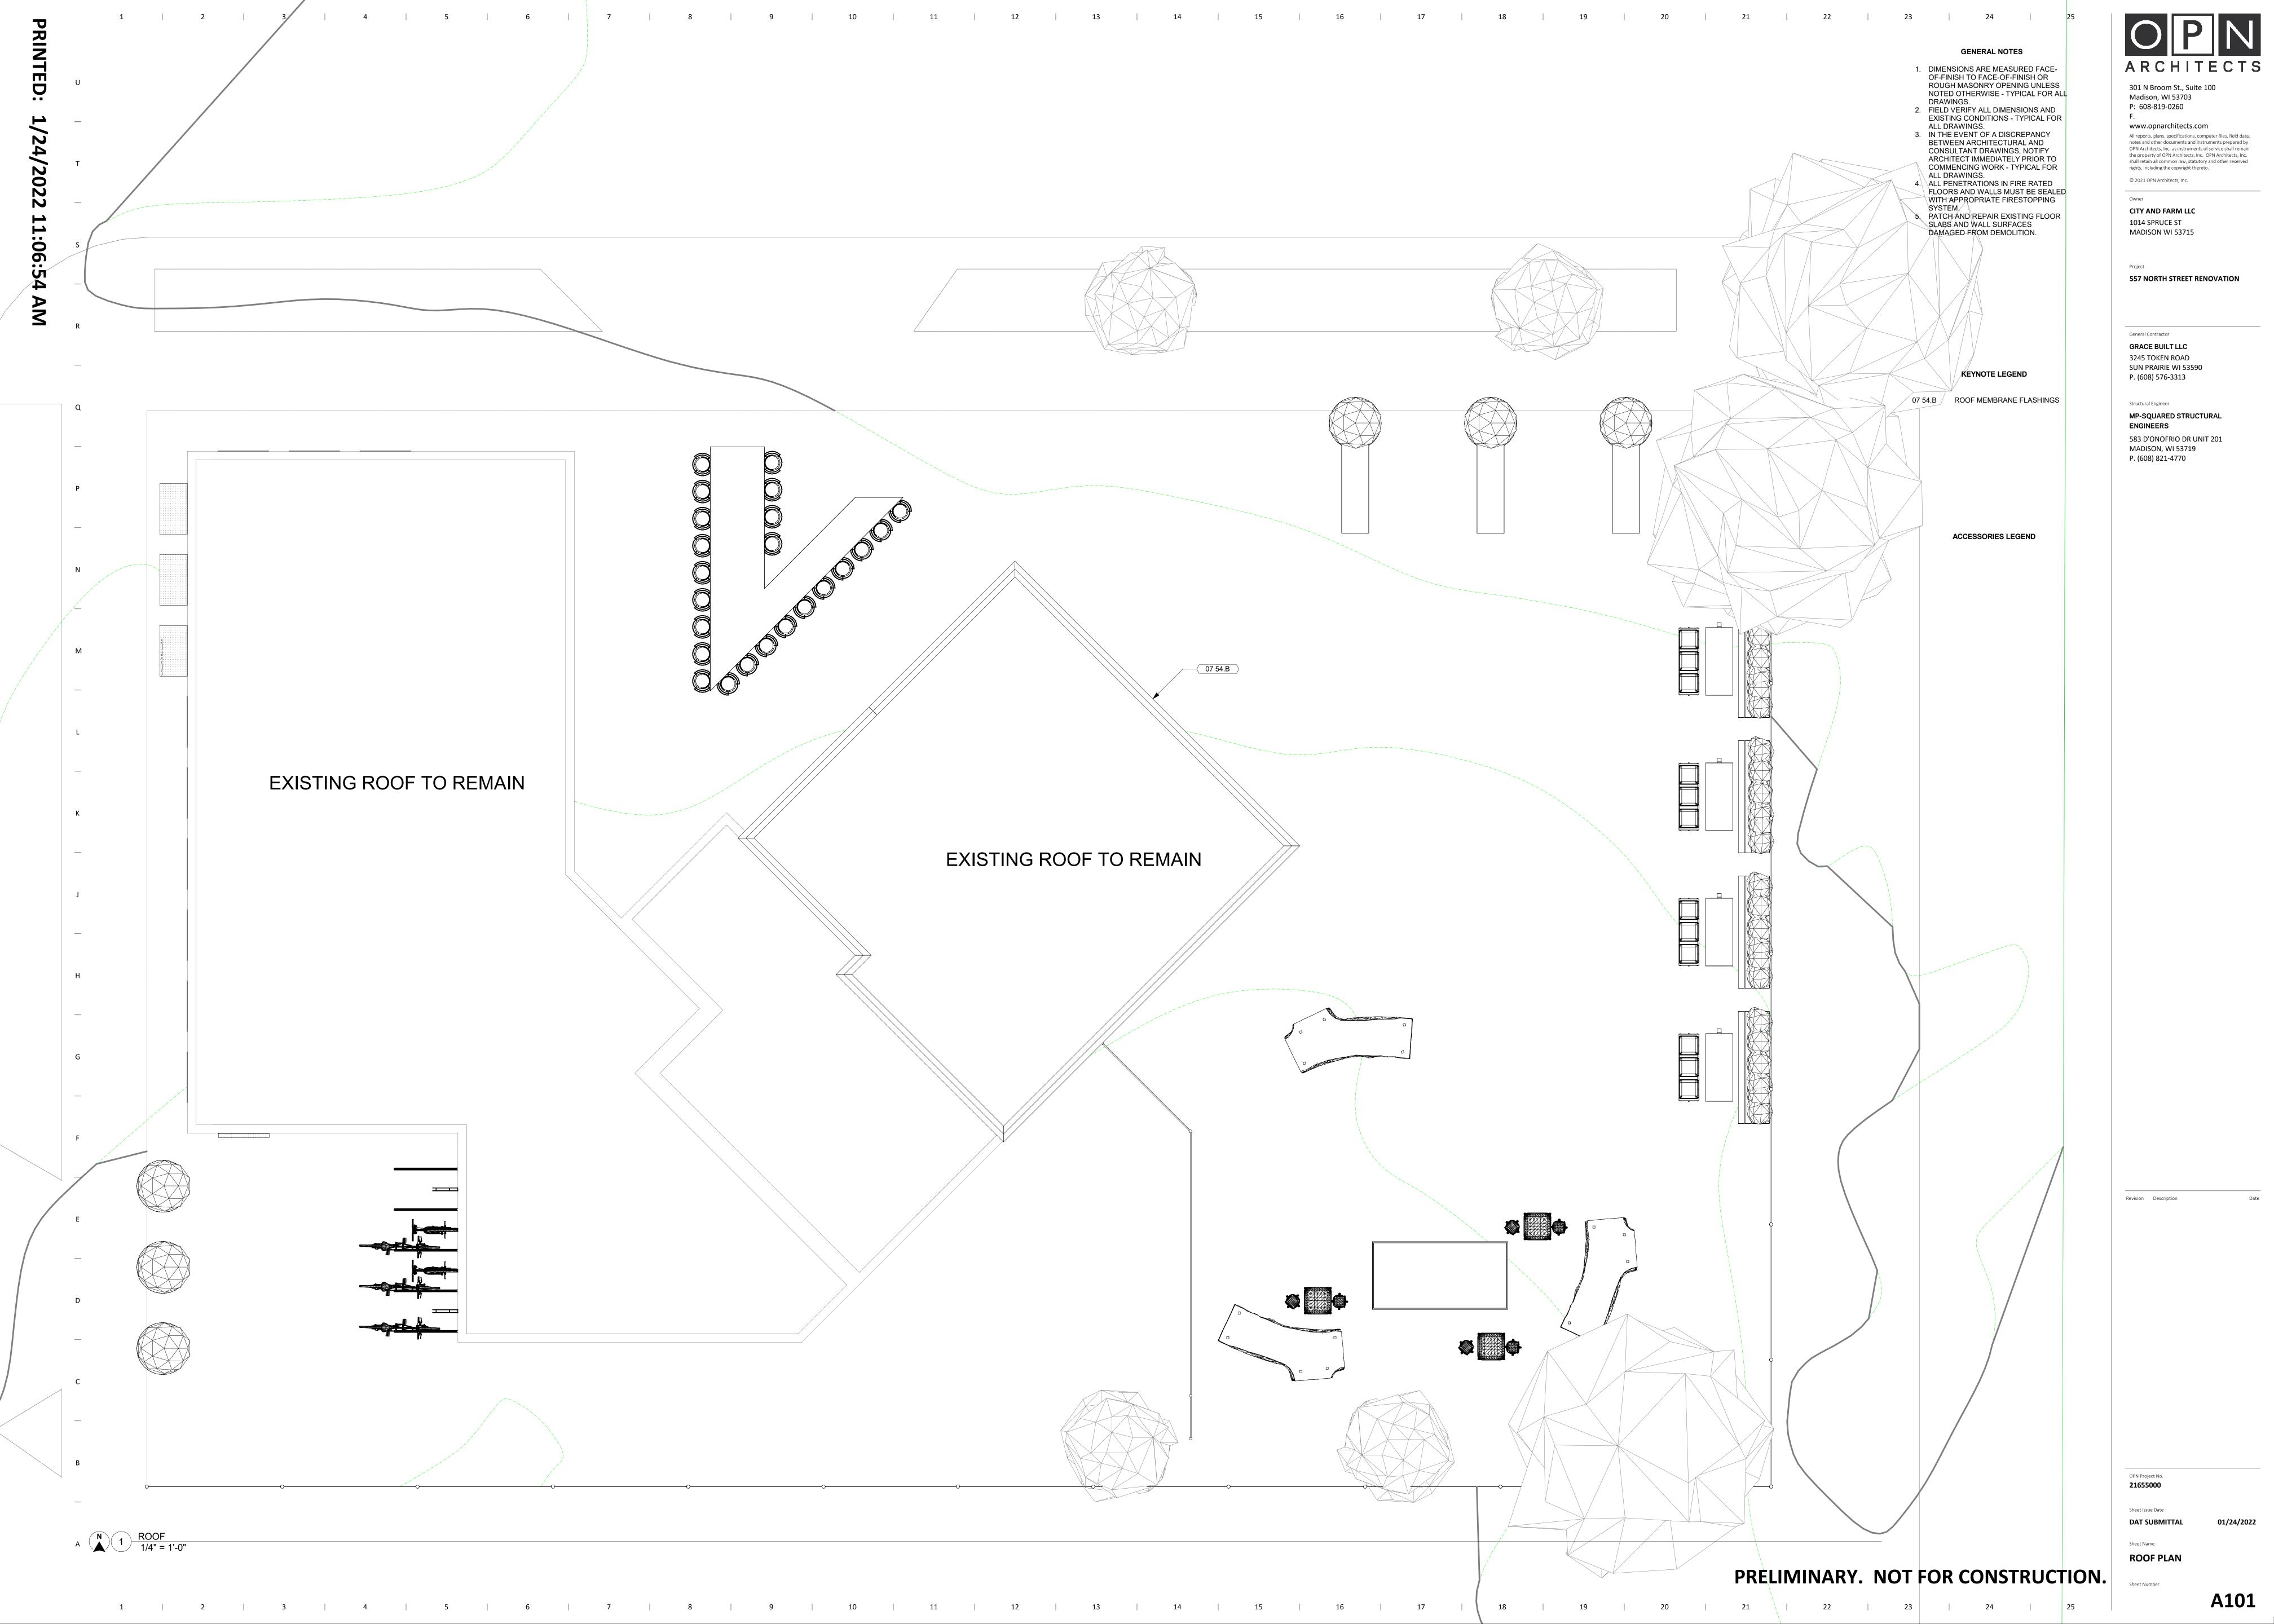
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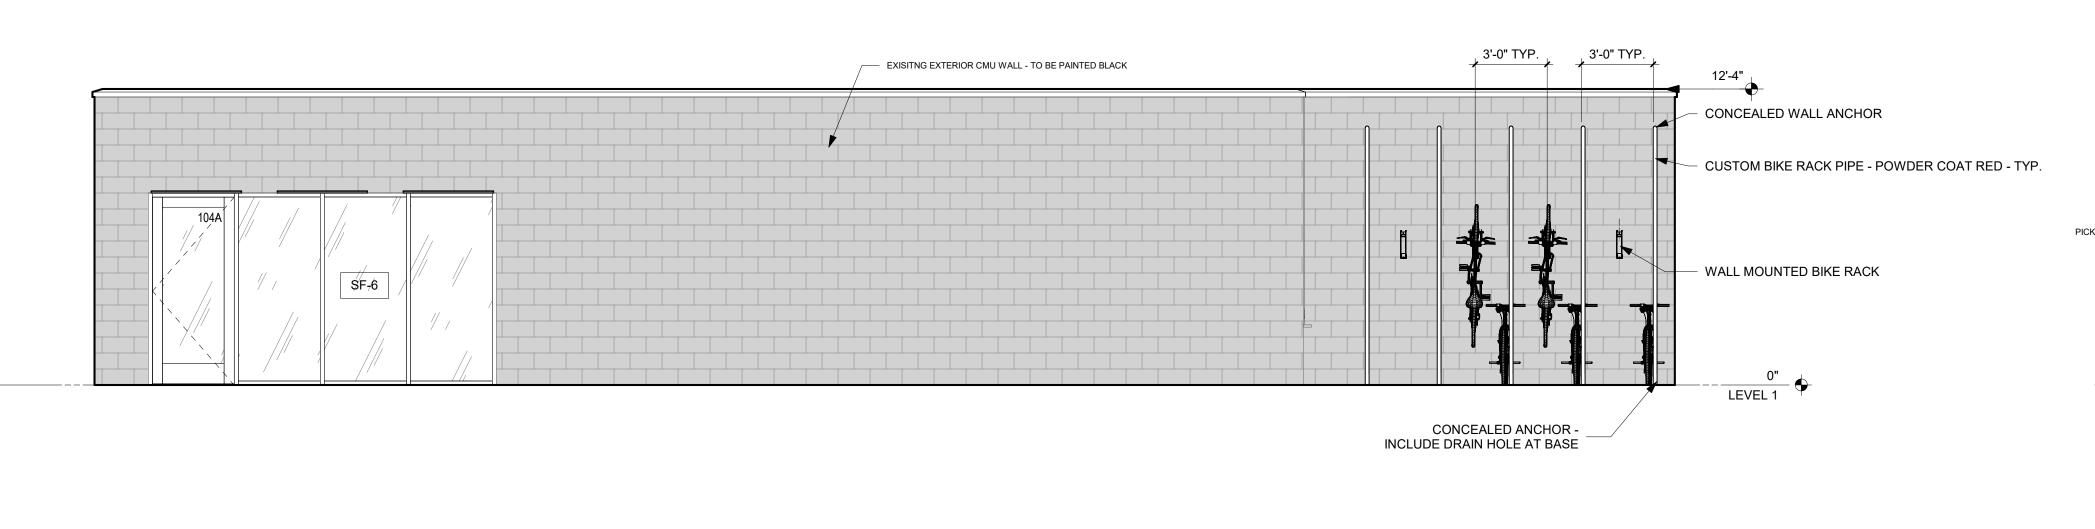
SF-6


25'-3 3/4"

1 | 2 | 3 | 4 | 5 | 6 | 7 | 8 | 9 | 10 | 11 | 12 | 13 | 14 | 15 | 25 |


SF-4





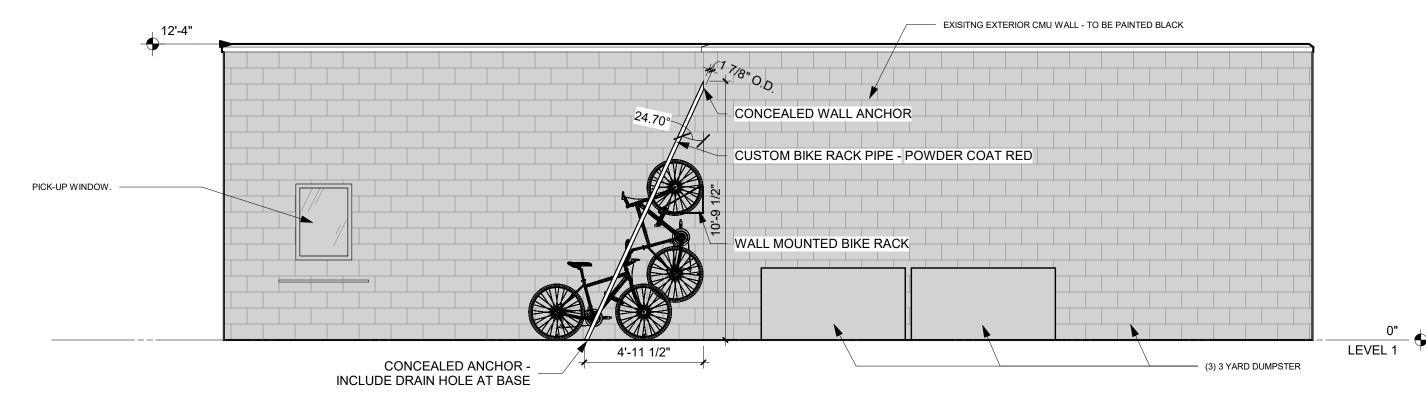


H1 SOUTH ELEVATION 1/4" = 1'-0"

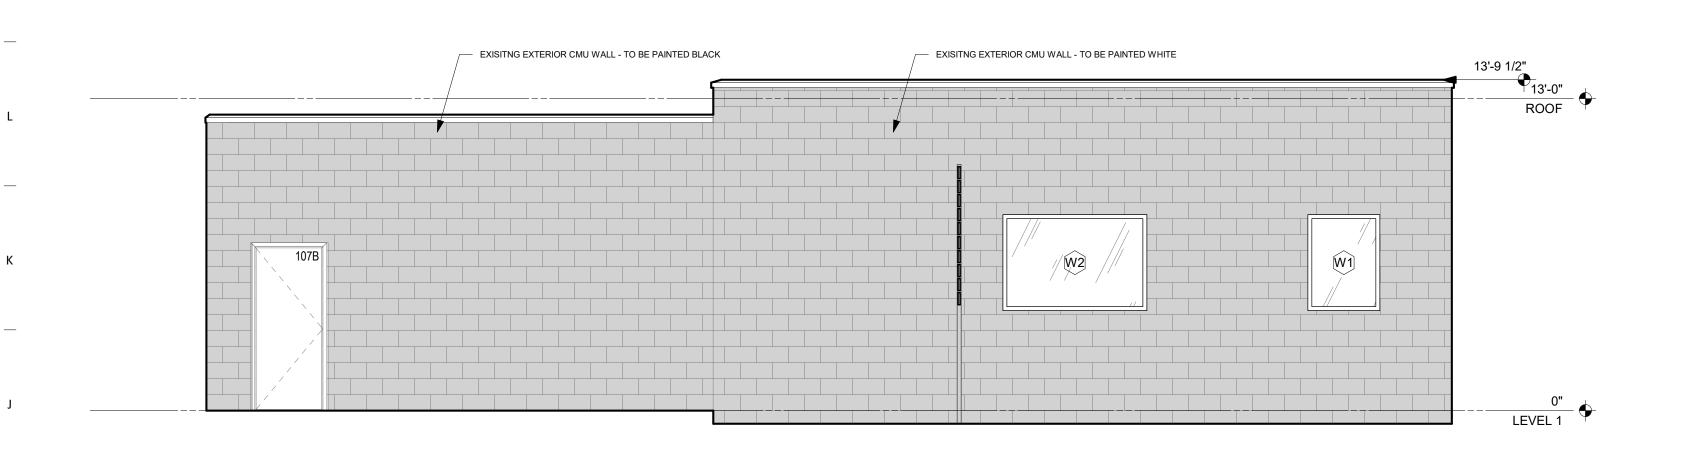


SOUTH EAST ELEVATION


A9 NORTH WEST ELEVATION
1/4" = 1'-0"

P8 WEST ELEVATION
1/4" = 1'-0"

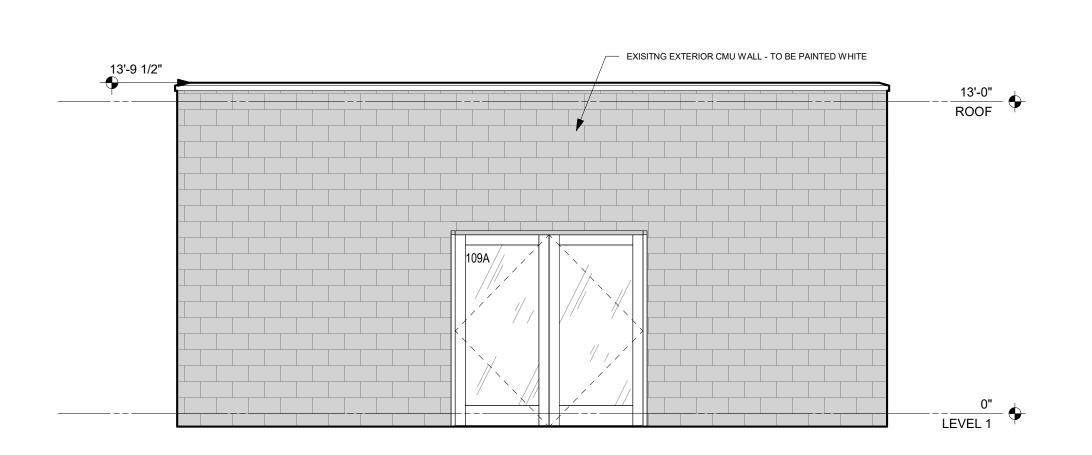


A1 NORTH EAST ELEVATION
1/4" = 1'-0"

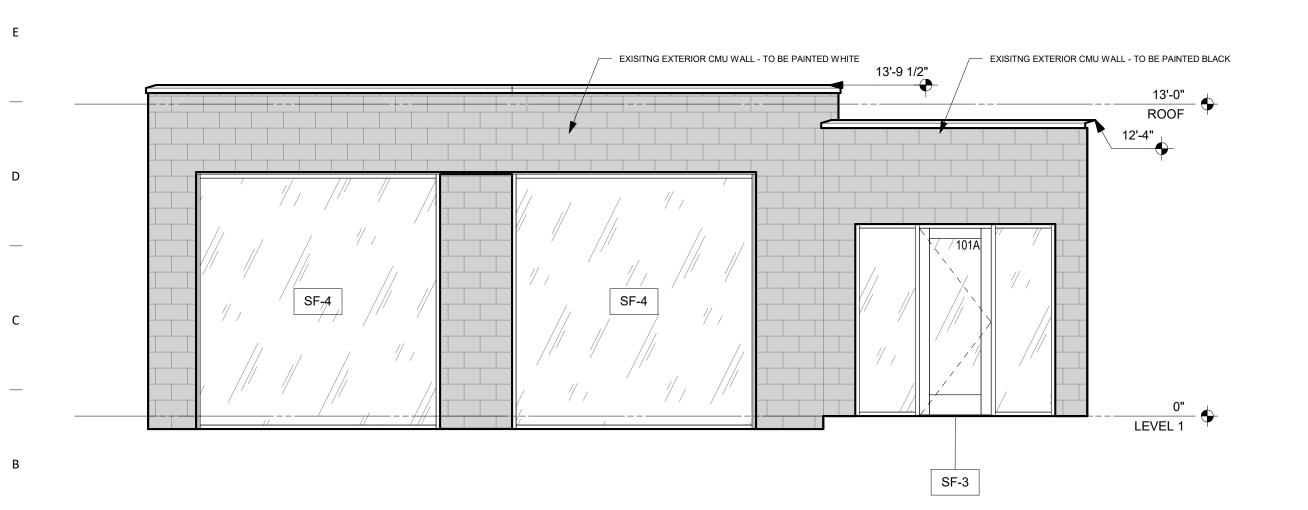

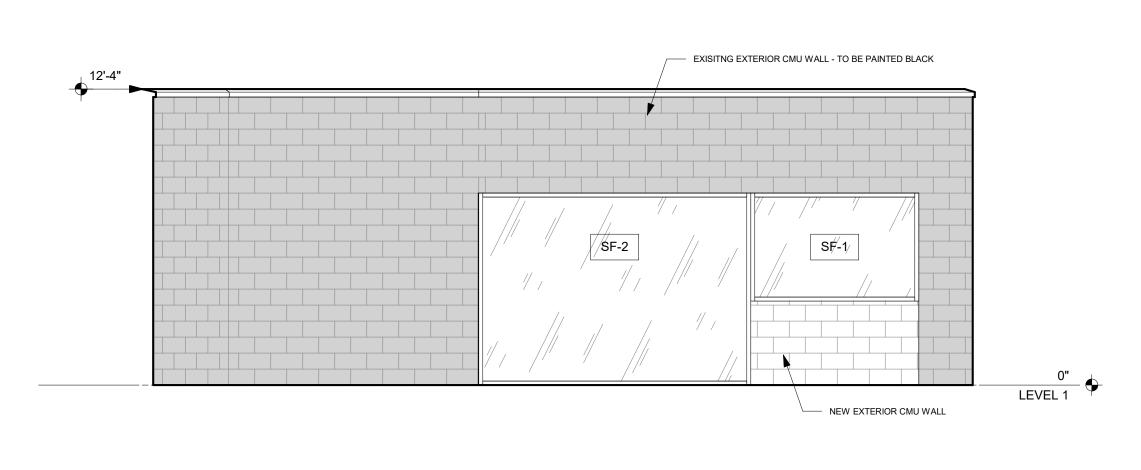

1 | 2 | 3 | 4 | 5 | 6 | 7 | 8 | 9 | 10 | 11 | 12 | 13 | 24 | 25 |

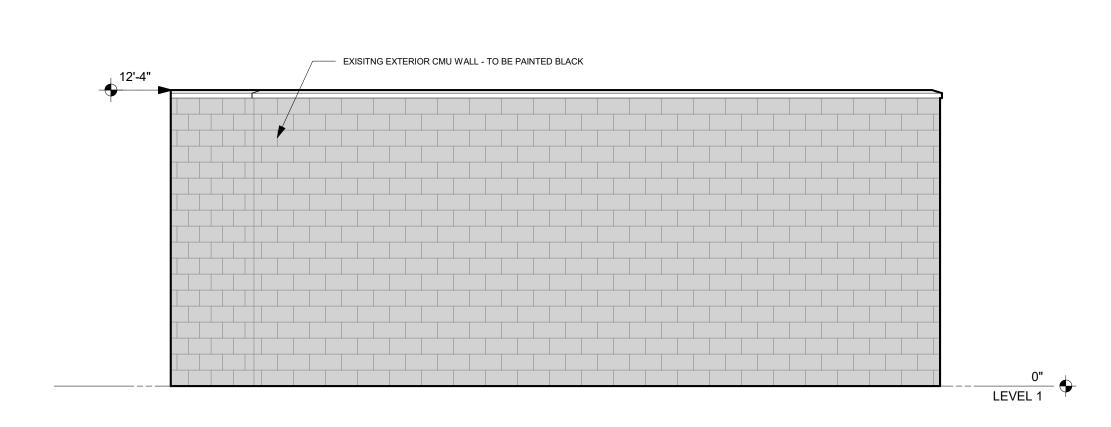

P1 EAST ELEVATION
1/4" = 1'-0"

NORTH ELEVATION
1/4" = 1'-0"

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F.

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ENGINEERS
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OPN Project No. **21655000** 


Sheet Issue Date

DAT SUBMITTAL 01/24/20

Sheet Name


EXTERIOR ELEVATIONS


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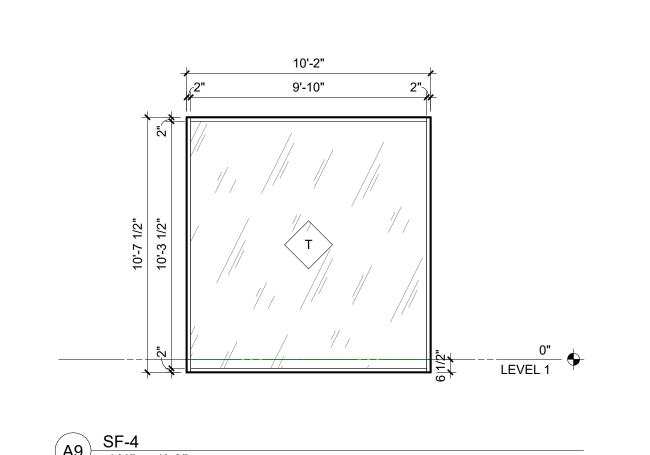


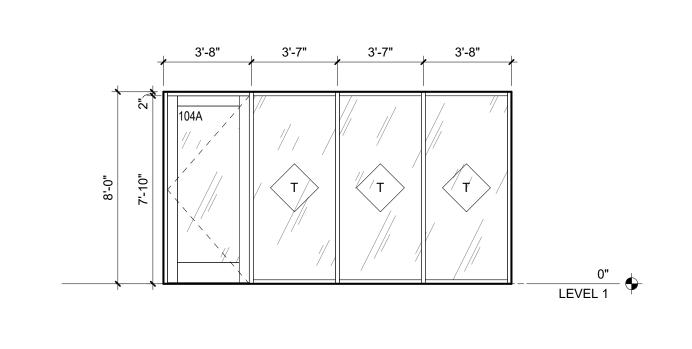
109A | 0" | LEVEL 1


F17 SF-6 1/4" = 1'-0" 22 SF-5 1/4" = 1'-0"




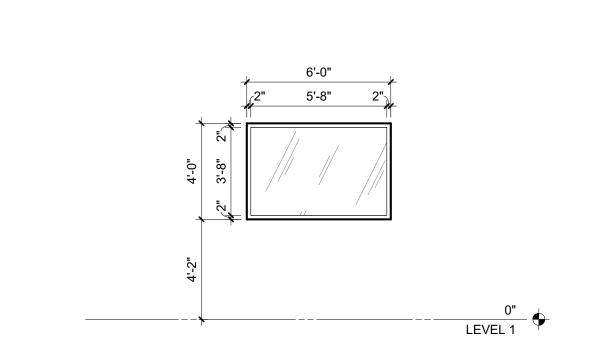

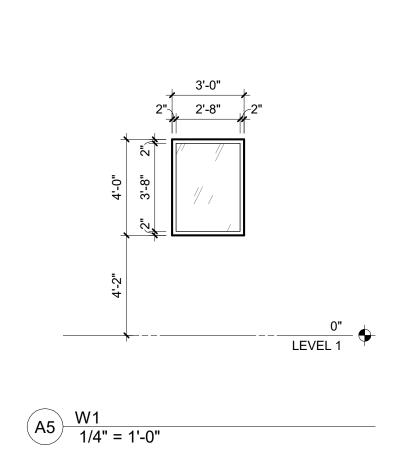

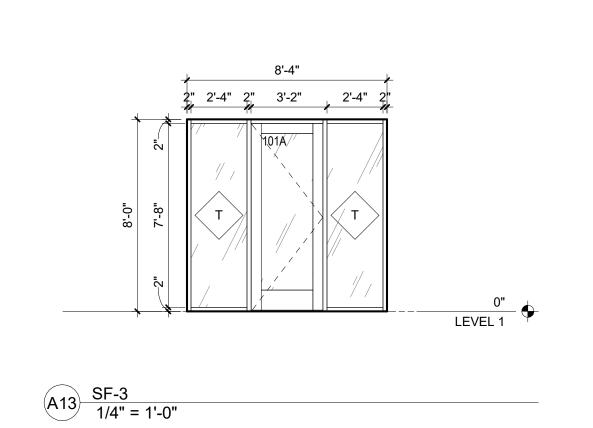

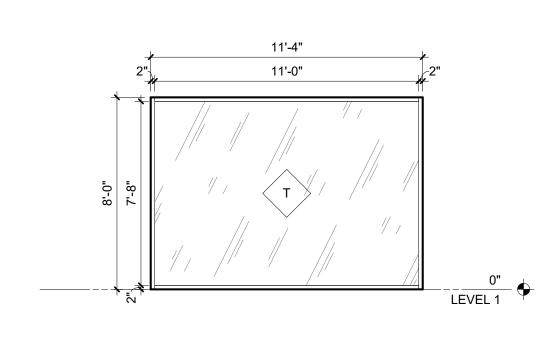

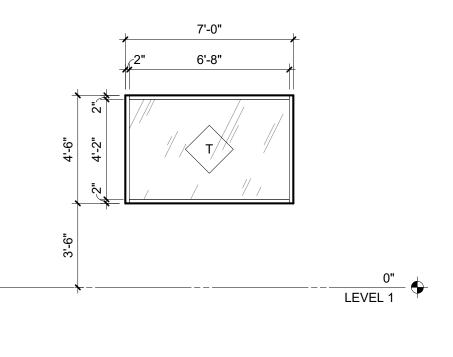

A22 SF-1 1/4" = 1'-0"

SF-1 1/4" = 1'-0"

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GLAZING ELEVATIONS

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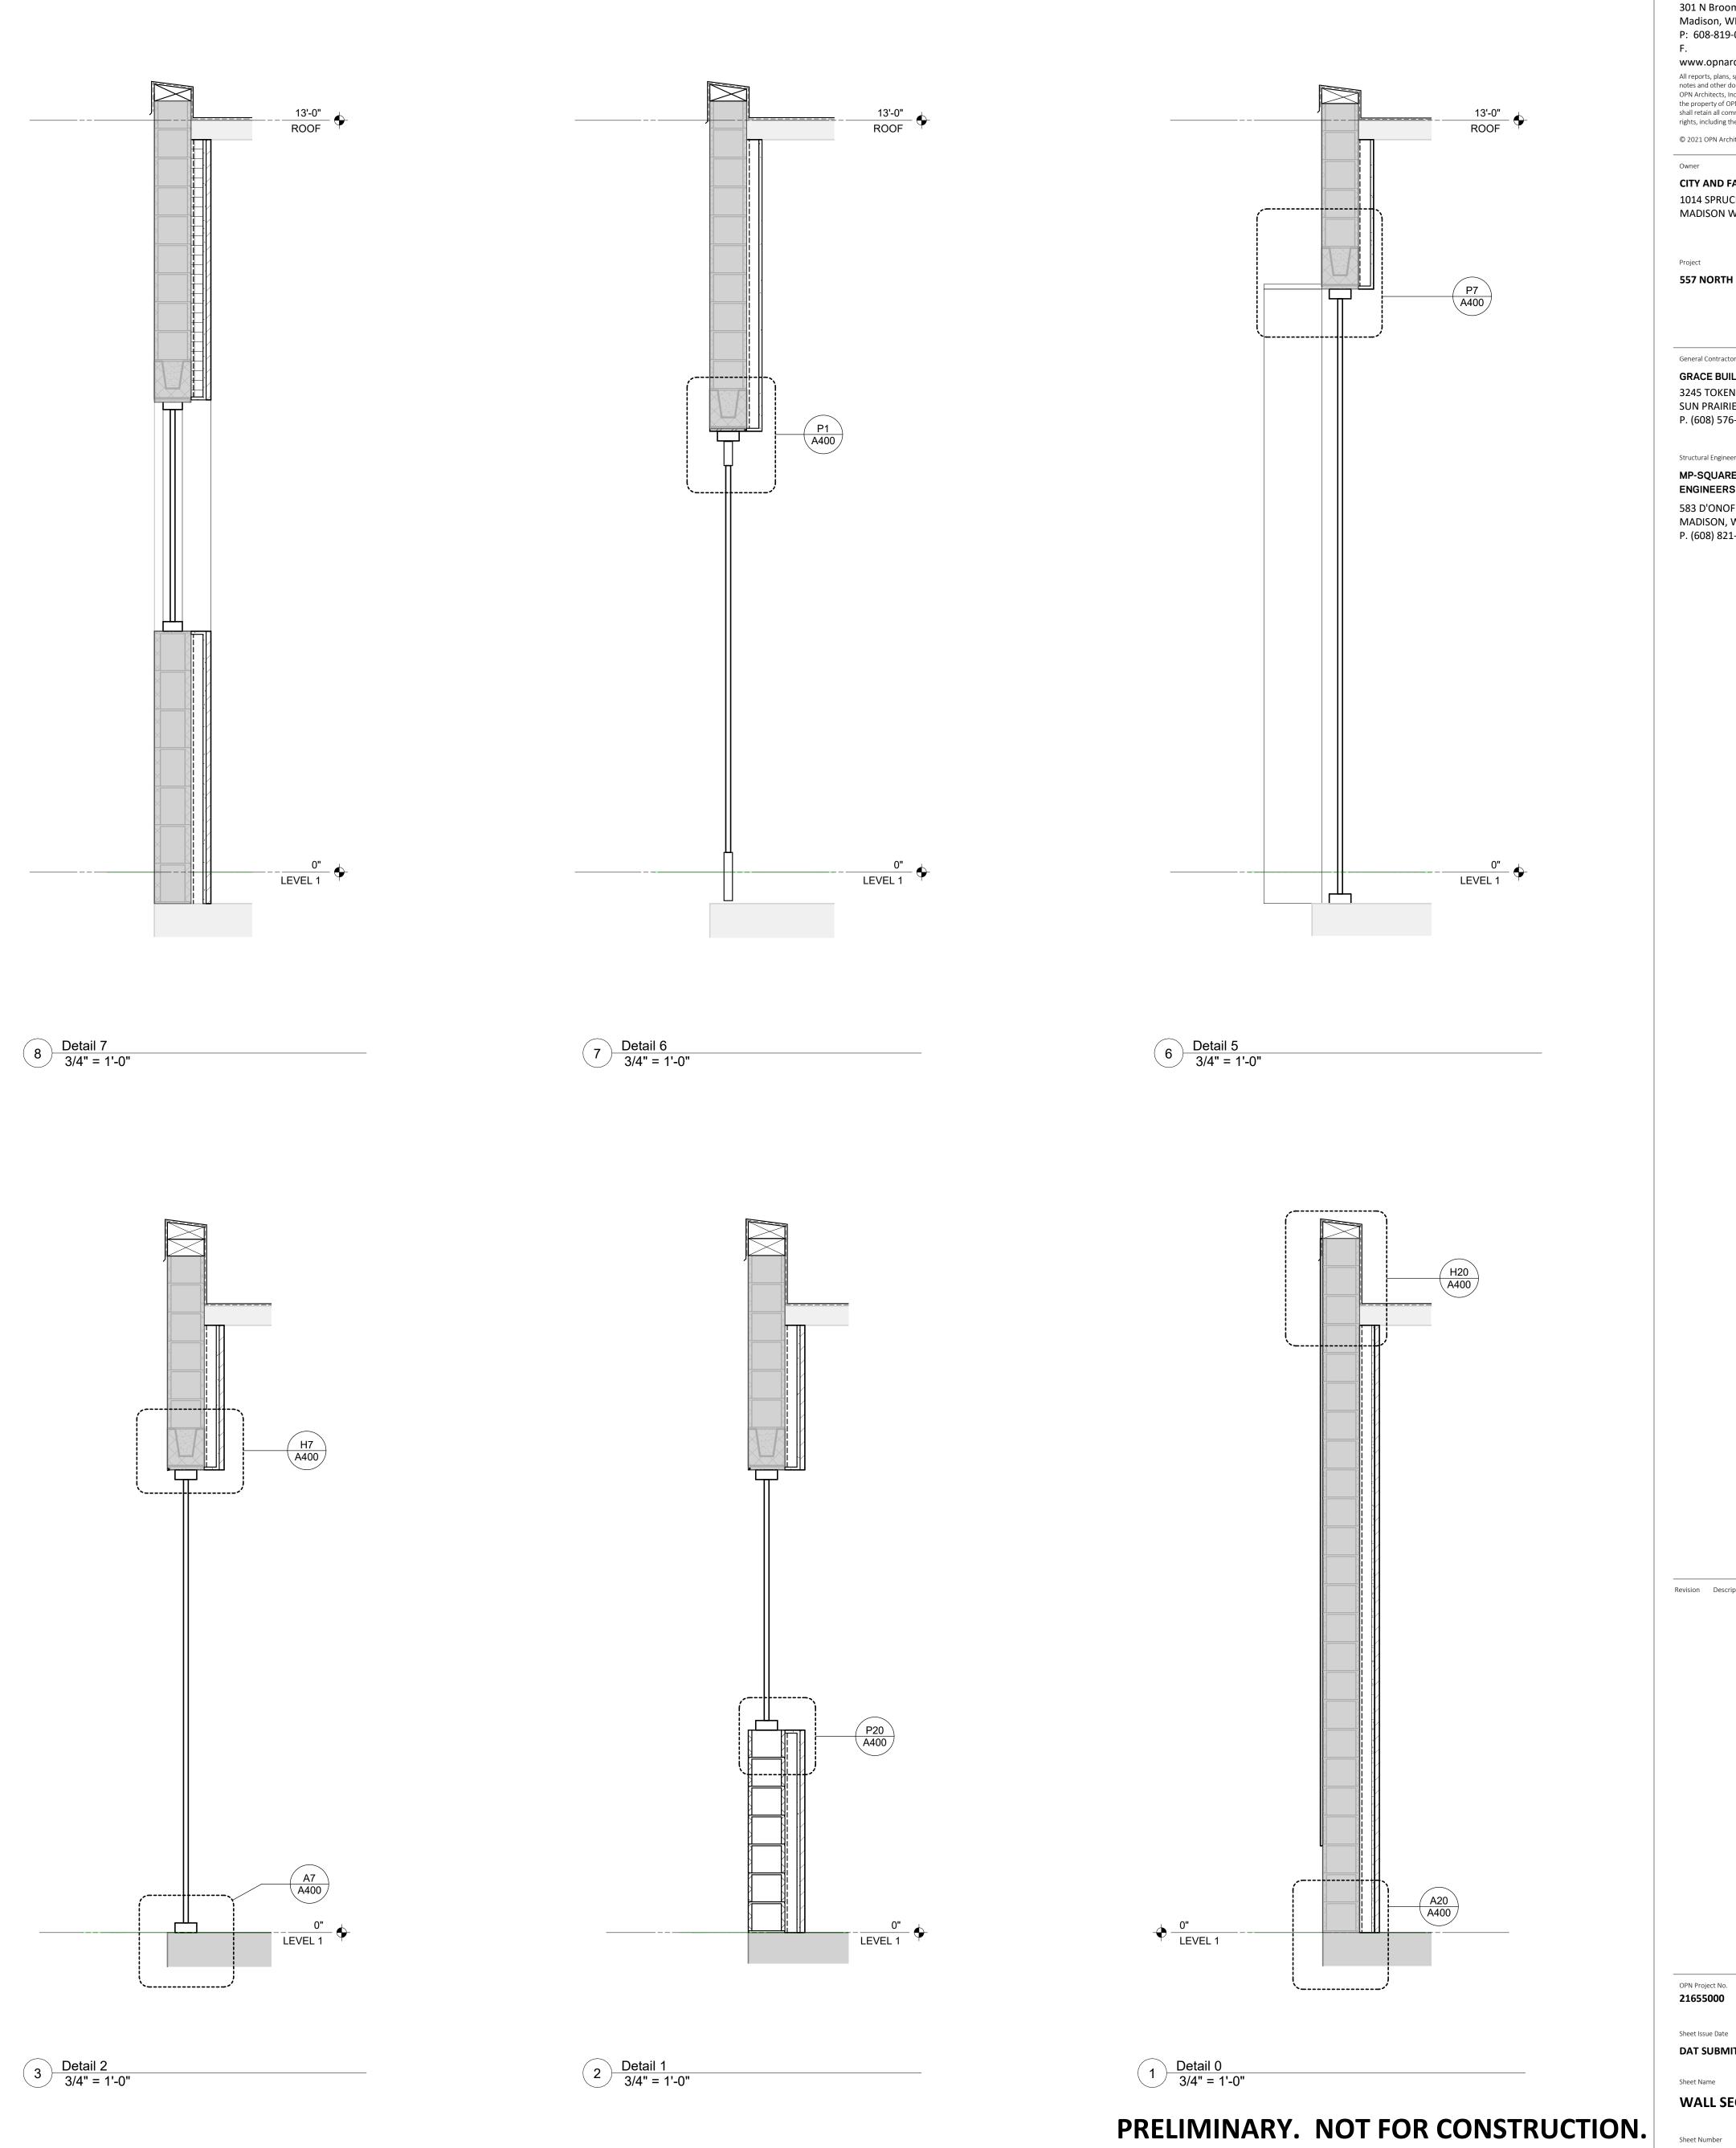
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**BUILDING SECTIONS** 

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OPN Project No. **21655000** 

Sheet Name

**WALL SECTIONS** 


## APPLICABLE CODE INFORMATION

```
IBC Chapter 10 - Means of Egress
The project shall comply with the following codes:
  2015 International Building Code.
                                                                                                                                                                        1004 Occupant Load (See Building Occupant Load Calculations for details)
   2015 International Mechanical Code
   2021 Internation Fire Code
                                                                                                                                                                       OCCUPANT COUNT
                                                                                                                                                                          A-2:1,402 SF/15 SF PER OCC = 93.4 OCC
   2015 National Electrical Code
   2015 International Plumbing Code and the Wisconsin State Plumbing Code
                                                                                                                                                                          S: 576 SF/200 SF PER OCC = 2.88 OCC
                                                                                                                                                                                                        96.28 OCC Actual occupancy count below will be posted
                                                                                                                                                                                             80 Interior max per calculation
                                                                                                                                                                          Exterior:
                                                                                                                                                                       TOTAL OCCUPANTS: 200 OCC
                                                                                                                                                                        1005 Means of Egress Sizing
Building Characteristics
                                                                                                                                                                           1005.3.1 & 1005.3.2 Means of Egress Capacity Factors
   Project description:
                         Existing building to be renovated into a tavern with food being brough in from vendors. No food will be cooked on site.
                         3,348 ŠF
   Building Area:
                                                                                                                                                                                                 .3"/Occupant (Minimum stair width 44" - 1011.2)
   Building Height:
                                                                                                                                                                              Other Elements .2"/Occupant
   Number of Stories:
                        1 (see below for detailed information)
                         No - Equipped with fully automated sprinkler system
   Fully Sprinkled:
                                                                                                                                                                                                                                    Egress Required
                                                                                                                                                                                                                                                         Egress Provided
   Fie Alarm:
                         No - Equipped with emergency voice/alarm communication system
                                                                                                                                                                              Level 1 Egress Width 200 Occupants x .2"/Occupant = 40"
IBC Chapter 3 - Use and Occupancy Classification
                                                                                                                                                                        1006 Number of Exits and Exit Access Doorways
   Occupancy Group: A-2, S-1
                                                                                                                                                                           1006.2.1 Common Path of Egress Travel Distance
IBC Chapter 5 - General Building Heights and Areas
                                                                                                                                                                                                                                                         Maximum Actual
                                                                                                                                                                              Group A-2 (With Sprinkler System)
                                                                                                                                                                                                                                  75'-0"
                                                                                                                                                                                                                                                         25'-0"
   Occupancy Group A-2
                                                                                                                                                                              Group S (With Sprinkler System)
                                                                                                                                                                                                                                   75'-0"
                                                                                                                                                                                                                                                         25'-0"
      Building Height: 12'-0" (55'-0" max per IBC Table 504.3)
       Number of Stories: 1 (2 max per IBC Table 504.4)
                                                                                                                                                                           1006.3.1 Minimum Number of Exits or Access to Exits Per Story
       Building Area: 3,348 GSF (9,500 per IBC Section 507.5)
                                                                                                                                                                                                                                                         Number Provided
   Occupancy Group S-1
                                                                                                                                                                              Level 1
      Building Height: 12'-0" (55'-0" max per IBC Table 504.3)
       Number of Stories: 1 (2 max per IBC Table 504.4)
                                                                                                                                                                        1017 Exit Access Travel Distance
       Building Area: 3,348 GSF (17,500 per IBC Section 507.4)
                                                                                                                                                                           Table 1017.2 Exit Access Travel Distance
   508 Mixed Use and Occupancy
                                                                                                                                                                                                                                   Maximum Allowed
                                                                                                                                                                                                                                                         Maximum Actual
       508.3 Nonseperated occupancies: Buildings or portions of buildings that comply with the provisions of this section shall be considered as nonseparated
                                                                                                                                                                           Group A-2 (With Sprinkler System)
                                                                                                                                                                                                                                  200'-0"
              occupancies.
                                                                                                                                                                          Group S (With Sprinkler System)
                                                                                                                                                                                                                                  200'-0"
                                                                                                                                                                                                                                                         89'-0"
IBC Chapter 6 - Types of Construction
   Construction Classification: Type IIIB
                                                                                                                                                                   2015 International Energy Conservation Code
   Table 601 Fire Resisteance Rating Required
                                                                                                                                                                       Exterior wall assemblies for this project have been calculated to have a U-Value of .0625 which exceeds the minimum U-Value of .076 for metal framed building
                                                                                                                                                                       envelopes in Climate Zone 5 as dictated by Table C402.1.3.
       Primary Structural Frame
                                                2 HR
       Bearing Walls (Exterior)
                                                                                                                                                                   lowa Administrative Code, Chapter 16, Division VII - Accessibility Requirements For Facilities Used by the General Public:
       Bearing Walls (Interior)
                                                0 HR
                                              0 HR
       Nonbearing Wall and Partition (Exterior)
                                                                                                                                                                       Accessibility within the building will be maintained.
       Nonbearing Wall and Partitions (Interior)
       Floor Construction and Secondary Members 0 HR
                                                                                                                                                                   Plumbing Fixture Requirements per 2015 Uniform Plumbing Code (UPC)
       Roof Construction and Secondary Members 0 HR
                                                                                                                                                                        Table 2902.1 Minimum Number of Required Plumbing Fixtures
IBC Chaper 7 - Fire and Smoke Protection Features
                                                                                                                                                                        Occupancy W.C.
   705 Exterior Walls
                                                                                                                                                                        A-2 M / F
                                                                                                                                                                                                      1 per 75
                                                                                                                                                                                      705.11 Parapets shall be provided on exterior walls of buildings. Exception 1: The wall is not required to be rire-resistance rated in accordance with Table 602
              because of fire separation distance.
```

705.8 Openings in exterior walls shall comply with Sections 705.8.1 through 705.8.6

1 | 2 | 3 | 4 | 5 | 6 | 7 | 8 | 9 | 10 | 11 | 12 | 13 | 24 | 25 |

1 | 2 | 3 | 4 | 5 | 6 | 7 | 8 | 9 | 10 | 11 | 12 | 13 | 14 | 15 | 16 | 17 | 18 |

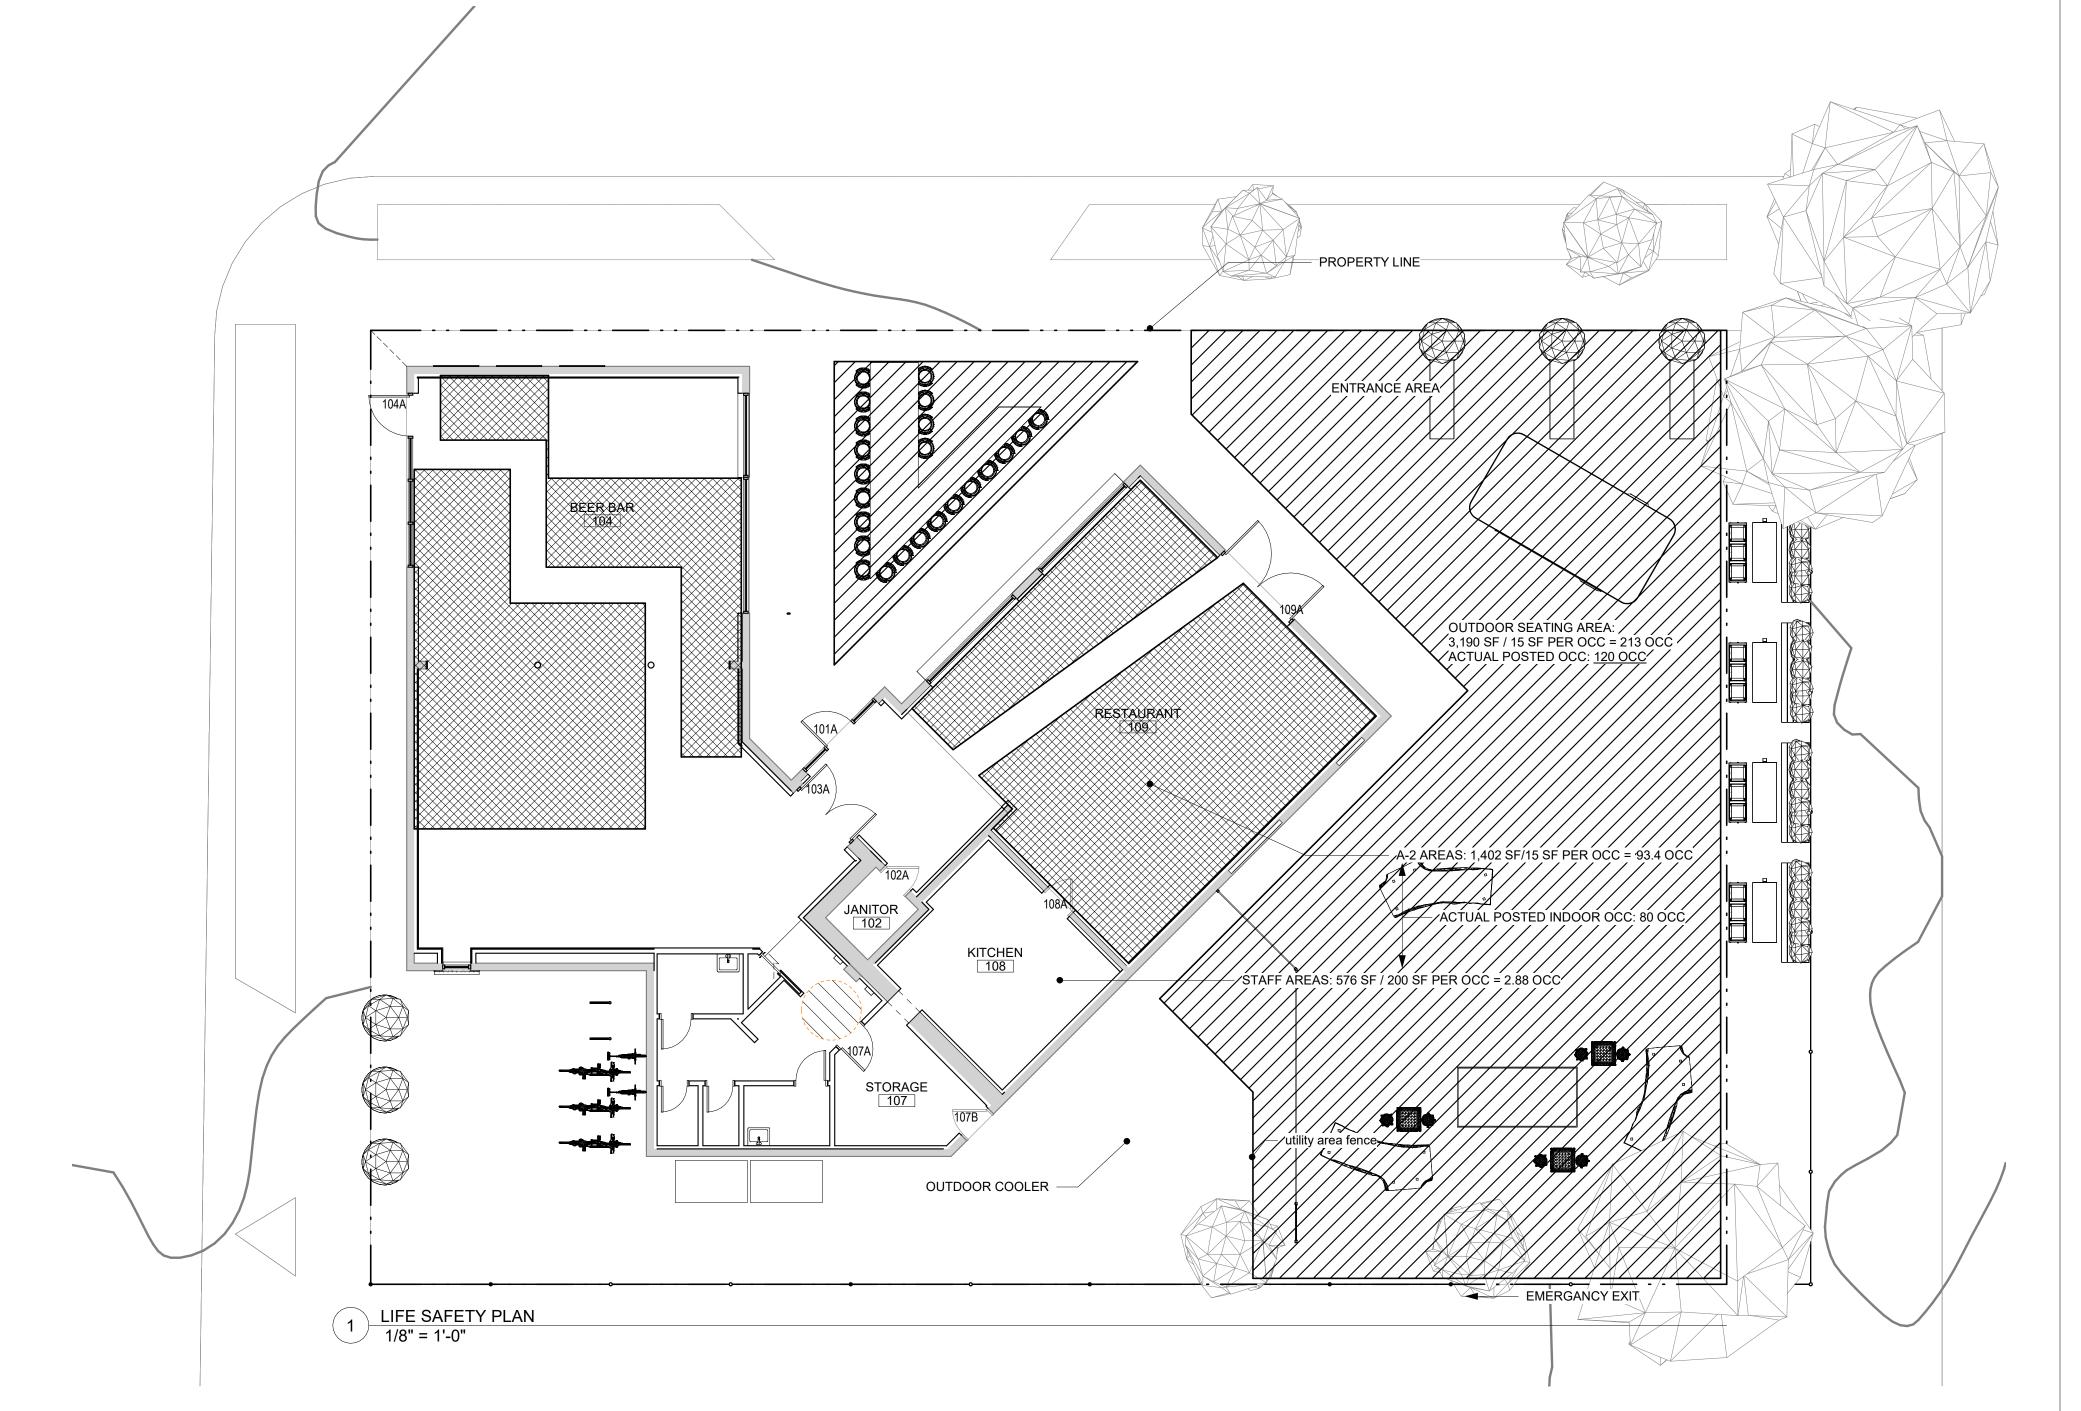

S1 / S2

TOTAL=

1 per 100

1 per 100

<u>2.653 -> 4</u>

4 occ/100=0.04 4 occ/100=0.04

1 per 1000 1 Service Sink

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SUMMAR Sheet Number

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21655000

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LIFE SAFETY AND CODE SUMMARY

G002