APPLICATION FOR URBAN DESIGN COMMISSION

REVIEW AND APPROVAL

AGENDA ITEM#	
Project #	
Legistar #	

Action Requested

UDC MEETING DATE: 2013-07-17 UDC MEETING DATE: 2013-07-24	Informational Presentation Initial Approval and/or Recommendation Final Approval and/or Recommendation
PROJECT ADDRESS: 1750 Pearson Street ALDERMANIC DISTRICT: 12 OWNER/DEVELOPER (Partners and/or Principals) Madison College	ARCHITECT/DESIGNER/OR AGENT: JSD Professional Services, Inc.
well as a fee) School, Public Building or Space (Fee may be re	vices, Inc. ite 101 Urban Design District * (A public hearing is required as equired) g of a Retail, Hotel or Motel Building Exceeding 40,000
(See Section D for:) Comprehensive Design Review* (Fee required) Street Graphics Variance* (Fee required) Other *Public Hearing Required (Submission Deadline 3 Wee	

Public Hearing Required (Submission Deadline 3 Weeks in Advance of Meeting Date)

Where fees are required (as noted above) they apply with the first submittal for either initial or final approval of a project.



July 17, 2013

City of Madison Urban Design Commission c/o Al Martin City of Madison Planning Division PO Box 2985 Madison, WI 53701-2985

Subject: Madison College Fire Training Facility

Dear Commissioners:

Madison College (College) is proposing to construct an outdoor Fire Training Facility at the College's Truax campus in Madison, Wisconsin. The facility will be located on land directly west of Pearson Street and north of Anderson Street at the west end of the campus. This land is directly adjacent to the Dane County Regional Airport (Airport). The space will consist of a series of props to be used for outdoor fire training and certification.

Due to ongoing lease negotiations with the Airport, the College has determined it would be easier to construct the project in 2 phases. The first phase will develop the 2.135 acre site to the north currently leased by the College. The second phase, the 2.517 acre site to the south, will be developed once the lease is finalized with the Airport. This 2-phase approach will allow the College the ability to start this project in September/October, 2013. Phase 2 would be developed in spring, 2014. Madison College is seeking approval for the construction of both Phases 1 and 2 at this time.

The new outdoor Fire Training Facility will consist of a series of props including a residential and commercial burn tower, ladder tower, vertical vent prop, gas vehicle vent prop, gas control valves, pallet shed, gas commercial dumpster, natural gas prop, car extrication prop, water tank, confined space prop, LP gas prop, and gas extinguisher prop.

Please find enclosed Application Materials addressing comments and concerns provided at the June 19th UDC meeting. We look forward to our continued coordination efforts for successful implementation of the Fire Training Facility.

Sincerely,

JSD Professional Services, Inc.

Wade P. Vyn

Wade P. Wyse, P.E. Senior Project Engineer

LOCATOR MAP
MADISON, WI














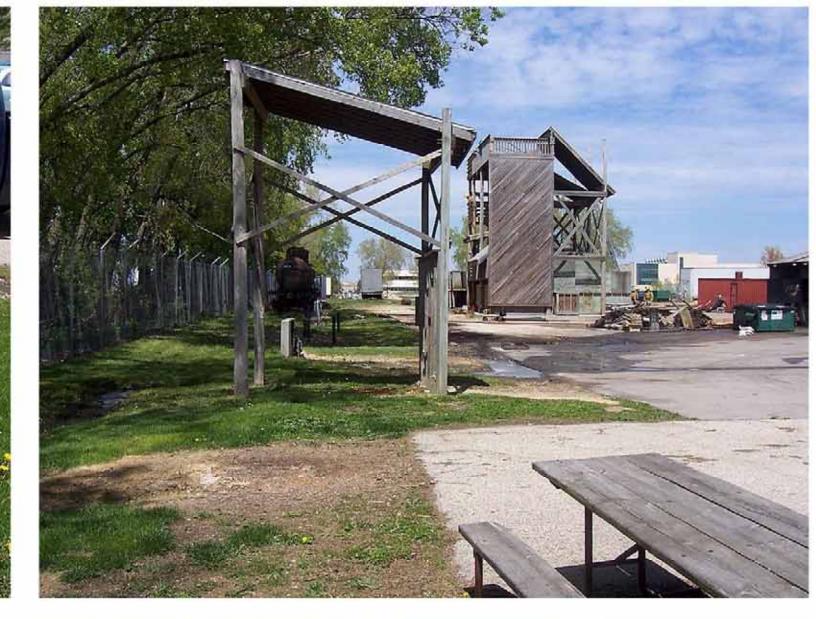















Madison College Truax Site Utilities

Exterior Lighting Submittal

Specification Section 26 56 00

SUBMITTAL NO. 26 56 00-001

J.H. FINDORFF & SON INC.
THE REVIEW OF THIS DOCUMENT IS FOR GENERAL CONFORMANCE WITH THE CONTRACT DOCUMENTS ONLY AND IN NO WAY RELIEVES THE SUB-CONTRACTOR OR SUPPLIER OF HIS RESPONSIBILITY TO FURNISH SPECIFIED MATERIALS AS REQUIRED TO COMPLETE THE CONTRACT WORK. UNLESS NOTED OTHERWISE, FIELD DIMENSIONS HAVE NOT BEEN VERIFIED AND ARE THE RESPONSIBILITY OF THE SUB-CONTRACTOR OR SUPPLIER.

THIS DOCUMENT REVIEWED BY

REVIEWED BY NY DATE 5-21-12



Lighting Submittals MATC Site Utilities

Submitted By: Forward Electric

In Partnership With: Werner Electric Supply Company

SUBMITTAL INDEX

MATC SITE UTILITES

TYPE	MANUFACTURER	CATALOG NUMBER	LAMPS
		PARKING LOT LIGHTS	LED
S1	CREE	ARE-EDG-3MB-DA-08-D-UL-350-BK-43K single head	
S1	HAPCO	RSA20C5-4-BA-GFI	
S2,S3	CREE	ARE-EDG-4M-DA-08-D-UL-350-BK-43K single head	LED
S2,S3	HAPCO	RSA20C5-4-BA-GFI	
		PEDESTRIAN LIGHTS	
S4	HYDREL	TLPRO152 108LED 350MA 41K R4 120 PT4 14H 4C DDB	LED
S4GFI	HYDREL	TLPRO152 108LED 350MA 41K R4 120 PT4 14H 4C DDB	LED
		WITH GFI PROVISION	
S4A	HYDREL	TLPRO152 108LED 350MA 41K R5 120 PT4 14H 4C DDB	LED
S4AGFI	HYDREL	TLPRO152 108LED 350MA 41K R5 120 PT4 14H 4C DDB	LED
		WITH GFI PROVISION	
C.F.	DECA	OFF ALED CIDS	LED
S5	BEGA	8554LED CTBS	LED
		FLOOD LIGHTS	
S6	GARDCO	DFL7J HSP 75LA NW UNIV BRP	LED
S6A	GARDCO	DFL7ST HSP 75LA NW UNIV BRP	LED
0071	C. III.D CC		
		FOUNTAIN LIGHTING	
7/S8A/S8B/S8C	CRYSTAL	LOT CYRSTAL BOM CONSISTING OF:	LED
		LEDC052P 12V/30WATT LIGHT FIXTURE 11 IN GUARD F	
		ELCORD160L20 18/5 STW CABLE 20FT FOR LED160 SERIES	
		LED160004 RGB RING LIGHT, SLAB MOUNTED	
		ELCORD160L20 18/5 STW CABLE 20FT FOR LED160 SERIES	
		LEDPS503 12V 12 LIGHT POWER SUPPLY	
		LEDPS250 12V 6 LIGHT POWER SUPPLY	
		LEDQUE1 DMX STORAGE AND PLAYBACK UNIT IPLAY3	
		EBJ208A101 JUNCTION BOX FACTORY-DRILLED	
		EBJ204A101 JUNCTION BOX FACTORY-DRILLED	
		EGS053 CORD SEAL #18/5 CABLE PLASTIC	
		LED CADID LICITATING	
	TIVOFLEY	LED STRIP LIGHTING	LED
S9	TIVOFLEX	TVFP-WW-24-14'	LED
S9	TIVOFLEX	TVFP-EPA-24-180 END PREP W/5' 180 DEGREE	
S9	TIVOFLEX	TVFP-NOTCH*-6.5 6' 5" NOTCHED CHANNEL Line Note: *-V for vertical, H for horizontal	
S9	TIVOFLEX	MT-100-1-4-24-D	
S9 S9	TIVOFLEX	TVFM-END CAP	
33	IIVOFLEX	I VI WI LIVE CAL	
		BUILDING UPLIGHTS	
S10	BK LTG	AR-LED-TR-E23-NSP-A9-BZP-12-11-A-12-277-PP	LED
S11	COLOR	523 000036 01/120 000103 02 w/	LED
		120 000080 02 Confirm color	
S12	COLOR	523 000036 01/120 000103 02 w/	LED
-		120 000080 00 Confirm color	



PARKING LOT LIGHTS




TYPE: S1

CREE / HAPCO ARE-EDG-3MB-DA-08-D-UL-350-BK-43K single head RSA20C5-4-BA-GFI

Rev. Date: 8/23/11

THE EDGE® LED Area Light – Type III Medium **ARE-EDG-3M-DA**



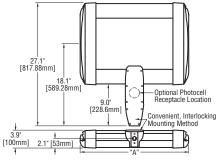

# of LEDs	Dim. "A"
20	12.06" [306mm]
40	12.06" [306mm]
60	14.06" [357mm]
80	16.06" [408mm]
100	18.06" [459mm]
120	20.06" [510mm]
140	22.06" [560mm]
160	24.06" [611mm]
200	28.06" [713mm]
240	32.06" [814mm]

Product	Family	Optic	Mounting	# of LEDs (x 10)	LED Series	Voltage	Color Options	Drive Current Not Field Adjustable	Factory-Installed Options Please type additional options in manually on the lines provided above.
ARE	EDG	3M ¹ 3MB ²	DA ³	02 04 06 08 10 12 14 16 20	D	UL Universal 120–277V UH Universal 347–480V 34 347V	SV Silver BK Black BZ Bronze PB Platinum Bronze WH White	350 350mA 525 ⁴ 525mA 700 ⁵ 700mA	43K 4300K Color Temperature ⁶ DIM 0-10V Dimming ^{7,8,9} F Fuse ^{10,11,12} HL Hi/Low (175/350/525, dual circuit input) ¹³ P Photocell ^{12,14} R NEMA Photocell Receptacle ^{12,15,16} ML Multi-Level (75/525) ¹³

Footnotes

- IESNA Type III Medium distribution
- IESNA Type III Medium distribution w/ backlight control
- Direct mounting arm for use with 3-6" (76-152mm) square or round pole
- Available on fixtures with 20-160 LEDs
- Available on fixtures with 20-60 LEDs
- 6. Color temperature per fixture; 6000K standard; minimum 70 CRI
- Control by others
- Refer to dimming spec sheet for availability and additional information
- Not available when UH voltage is selected
- 10. When code dictates fusing use time delay fuse
- 11. Not available with all multi-level options. Refer to the multi-level spec sheet for availability and additional information
- 12. Refer to multi-level spec sheet for availability and additional
- 13. Must specify voltage other than UH14. Intended for horizontal mounting
- 15. Photocell by others

# of LEDs	III Medium @	B U G	Initial Delivered Lumens – Type III Medium w/ backlight control @ 6000K	B U G	Initial Delivered Lumens – Type III Medium @ 4300K	Ra	U G	Type III Medium w/ backlight control @ 4300K	Ra	U G	System Watts 120–480V	Total Current @ 120V	Total Current @ 240V	Total Current @ 277V	Total Current @ 347	Total Current @ 480V	L ₇₀ Hours [*] @ 25° C (77° F)	50K Hours Lumer Maintenance Factor @ 15° C (59° F)
20	1.814 (02)	14 14	1.342 (02)	0111	1.672 (02)	4	35UII	A Fixture Operati 1.237 (02)	UU.	at ∠o*	26	0.20	0.11	0.10	0.09	0.07	>150,000	
40	3.628 (04)	1 1	2,683 (04)	1 1 1	3.343 (04)	+	1 1	2.473 (04)	0	1 1	47	0.40	0.11	0.10	0.09	0.07	>150,000	
60		2 2 2	3,973 (06)	1 2 1	4,950 (06)	2	2 2	3,662 (06)	1	2 1	68	0.58	0.30	0.19	0.13	0.12	>150,000	
80	7,161 (08)	2 2 2	5,298 (08)	1 2 2	6,600 (08)		2 2	4.882 (08)		2 1	90	0.77	0.38	0.34	0.26	0.20	>150,000	
100		3 3 3	6,605 (10)	1 3 2	8 230 (10)		2 2	6.088 (10)		2 2	111	0.95	0.47	0.42	0.32	0.24	>150,000	
120		3 3	7.926 (12)	1 3 2	9.876 (12)	3	3 3	7.305 (12)		3 2	132	1.15	0.56	0.50	0.38	0.28	>150,000	93%
140		3 3	9,205 (14)	1 3 2	11,469 (14)		3 3	8,484 (14)		3 2	157	1.34	0.67	0.61	0.47	0.35	149,000	
160		3 3	10.520 (16)	1 3 2	13,108 (16)	3		9,696 (16)		3 2	179	1.54	0.76	0.68	0.53	0.39	149.000	i .
200	17,778 (20) 3	3 3	13.151 (20)	2 3 3	16.385 (20)	3	3 3	12.120 (20)	1	3 2	221	1.92	0.95	0.84	0.65	0.48	149,000	
240	21,333 (24)	3 3	15,781 (22)	2 3 3	19,662 (24)	3	3 3	14,544 (24)	2	3 3	264	2.30	1.12	1.00	0.77	0.56	149,000	
							<u>525n</u>	A Fixture Operati	ng	at 25°								
20	2,539 (02) 1	1 1	1,878 (02)	0 1 1	2,340 (02)	1	1 1	1,731 (02)	0	1 1	37	0.31	0.17	0.16	0.12	0.10	136,000	
40		2 2	3,757 (04)	1 2 1	4,681 (04)	2		3,462 (04)		2 1	70	0.57	0.29	0.26	0.21	0.16	136,000	
60		2 2	5,562 (06)	1 2 2			2 2	5,127 (06)		2 1	102	0.87	0.44	0.39	0.30	0.22	129,000	
80		3 3	7,417 (08)	1 3 2			3 3	6,835 (08)		3 2	133	1.14	0.56	0.49	0.39	0.29	129,000	92%
100		3 3	9,247 (10)	1 3 2	11,521 (10)	3		8,523 (10)		3 2	172	1.47	0.75	0.67	0.51	0.38	128,000	0270
120		3 3	11,097 (12)	1 3 2	13,826 (12)	3		10,227 (12)		3 2	204	1.76	0.88	0.78	0.60	0.44	128,000	
140		3 3	12,888 (14)	2 3 2	16,057 (14)	3		11,878 (14)		3 2	233	2.01	0.99	0.87	0.69	0.51	123,000	
160	19,911 (16)	3 3 3	14,729 (16)	2 3 2	18,351 (16)	3	3 3	13,575 (16)		3 3	265	2.29	1.11	0.98	0.78	0.57	123,000	
0.0	0.400 (00)	4 4	0.001.(00)	0 1 1	0.050 (00)	- 1	uum	A Fixture Operati	Ш	at 25°		0.40	0.00	0.00	0.15	0.40	111 000	
20 40	3,102 (02) 1 6,203 (04) 2	2 2 2	2,281 (02) 4,562 (04)	1 2 1	2,858 (02) 5,717 (04)	2	2 2	2,102 (02) 4,204 (04)	1	2 1	50 93	0.42 0.79	0.22	0.20	0.15 0.27	0.12	111,000 111,000	90%
60	9,185 (06)	3 3	6,754 (06)	1 3 2	8,465 (06)		3 2	6,225 (06)		$\frac{2}{2} \frac{1}{2}$	137	1.18	0.59	0.55	0.39	0.29	111,000	90%

NOTE: All data subject to change without notice.

© 2011 BetaLED®, a division of Ruud Lighting • 1200 92nd Street • Sturtevant, WI 53177 • 800-236-6800 • www.betaLED.com





Job Name:

MATC Truax Landscape

Catalog Number:

ARE-EDG-3MB-DA-08-D-UL-350-BK-43K

Notes: single head

Type:

ARE-EDG-3M-DA

THE EDGE® LED Area Light - Type III Medium

Rev. Date: 8/23/11

General Description

Slim, low profile design minimizes wind load requirements. Fixture sides are rugged cast aluminum with integral, weather-tight LED driver compartments and high performance aluminum heatsinks. Convenient, interlocking mounting method. Mounting housing is rugged die cast aluminum and mounts to 3-6" (76-152mm) square or round pole. Fixture is secured by two (2) 5/16-18 UNC bolts spaced on 2" (51mm) centers. Includes leaf/debris guard. Five year limited warranty on fixture.

Electrical

Modular design accommodates varied lighting output from high power, white, 6000K (+/- 500K per full fixture), minimum 70 CRI, long life LED sources. Optional 4300K (+/- 300K per full fixture) also available. 120-277V 50/60 Hz, Class 1 LED drivers are standard. 347-480V 50/60 Hz driver is optional. LED drivers have power factor >90% and THD <20% at full load. Units provided with integral 10kV surge suppression protection standard. Integral weather-tight electrical box with terminal strips (12Ga - 20Ga) for easy power hook-up. Surge protection tested in accordance with IEEE/ANSI C62.41.2.

Testing & Compliance

UL listed in the U.S. and Canada for wet locations and enclosure rated IP66 per IEC 60529 when ordered without P or R options. Consult factory for CE Certified products. Certified to ANSI C136.31-2001, 3G bridge and overpass vibration standards. Dark Sky Friendly. IDA Approved. RoHS Compliant.







Product qualified on the Design Lights Consortium ("DLC") Qualified Products List ("QPL") when ordered without backlight control shield.

Finish

Exclusive Colorfast DeltaGuard® finish features an E-Coat epoxy primer with an ultradurable silver powder topcoat, providing excellent resistance to corrosion, ultraviolet degradation and abrasion, Bronze, black, white and platinum bronze powder topcoats are also available. The finish is covered by our 10 year limited warranty.

Fixture and finish are endurance tested to withstand 5.000 hours of elevated ambient salt fog conditions as defined in ASTM Standard B 117.

U.S. and international patents granted and pending. BetaLED is a division of Ruud Lighting, Inc. For a listing of Ruud Lighting, Inc. patents, visit www.uspto.gov.

THE EDGE® EPA & Weight Calculations

Single

0.60 1.20

0.60 1.20

0.60 1.20

0.60 1.20

2@ 2@ 3@ 4@

180° 90° 90 90°

1 20

1.20

1.20

1.20

1.21

1. Add 5 lbs. (2.3kg) for transformer in 347-480V fixtures when multi-level

2. For applications requiring 200 or more LEDs at 90 degrees refer to the

0.87

0.87 1.47

0.92 1.51

0.96 1.55

1 00 1 60

1.04 1.64

1.08

1.12 1.72

n/a2 n/a

n/a2 n/a2

1.47

1.68

1.75

1.75

1 83

1.91

2 00

2.08

2.16

2.24

n/a²

n/a2

Approximate Weight

23.7 lbs. (10.8g)

27.0 lbs. (12.3kg)

28.1 lbs. (12.8kg)

32.3 lbs. (14.7kg) 0.60

33.5 lbs. (15.2kg) 0.60

36.9 lbs. (16.7kg) 0.60

41.4 lbs. (18.8kg) 0.60

43.3 lbs. (19.6kg) 0.61

DL mount version of our spec sheet.

options are selected.

47.8 lbs. (21.7kg) 0.69 1.38

120-480V

Fixed Arm Mount 21.0 lbs. (9.5kg)

LEDs

20

80

100

140

160


240

Field-Installed Accessories




Bird Spikes XA-BRDSPK


Photometrics

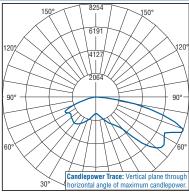




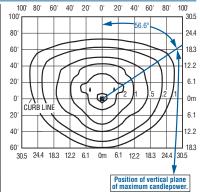



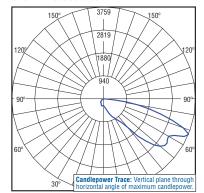

Independent Testing Laboratories certified test, Report No. TIL68599. Candlepower trace of 4300K, 40 LED Type III
Medium w/ backlight control area luminaire with 5,084 initial
delivered lumens operating at 525mA. All published luminaire photometric testing performed to IESNA LM-79-08 standards.

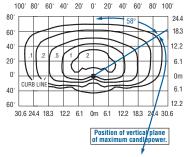

Isofootcandle plot of 4300K, 120 LED Type III Medium area luminaire at 25' (7.6m) A.F.G. Luminaire with 10,227 initial delivered lumens operating at 525mA. Initial FC at grade.

NOTE: All data subject to change without notice.

© 2011 BetaLED®, a division of Ruud Lighting 1200 92nd Street
 Sturtevant, WI 53177
 800-236-6800
 www.betaLED.com



Made in the U.S.A. of U.S. and imported parts. Meets Buy American requirements within the ARRA






Enterprise Ligh

Notes:

Type:

S1,S2,S3

LL12-23054

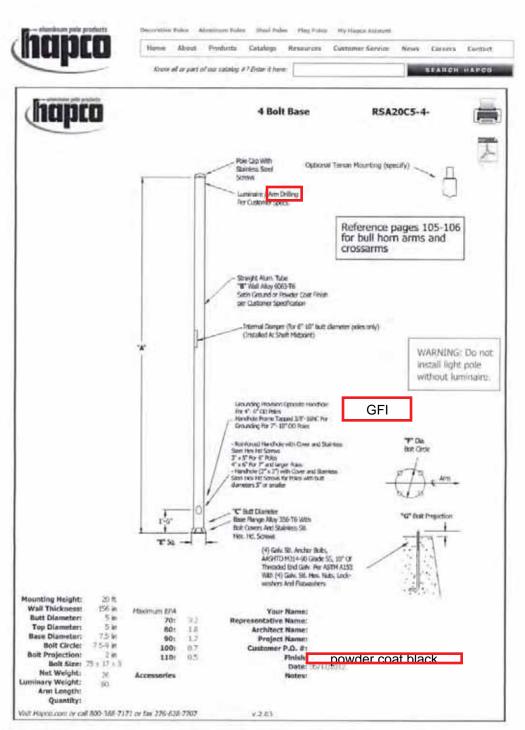





TYPE: S2,S3

CREE / HAPCO ARE-EDG-4M-DA-08-D-UL-350-BK-43K single head RSA20C5-4-BA-GFI

Job Name: MATC Truax Landscape Catalog Number: ARE-EDG-4M-DA-08-D-UL-350-BK-

Notes: single head

Type:

S2,S3


Rev. Date: 8/23/11

1112-23054

ARE-EDG-4M-AA THE EDGE® LED Area Light — Type IV Medium



Notes:

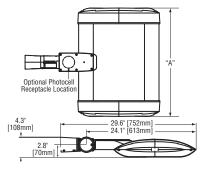

Dim. "A"
12.06" [306mm]
12.06" [306mm]
14.06" [357mm]
16.06" [408mm]
18.06" [459mm]
20.06" [510mm]
22.06" [560mm]
24.06" [611mm]
28.06" [713mm]
32.06" [814mm]

Product	Family	Optic	Mounting	# of LEDs (x 10)	LED Series	Voltage	Color Options	Drive Current Not Field Adjustable	Factory-Installed Options Please type additional options in manually on the lines provided above.
ARE	EDG	4MB ²	AA ³	02 04 06 08 10 12 14 16 20 24	D	UL Universal 120–277V UH Universal 347–480V 12 120V 24 240V 27 277V	SV Silver BK Black BZ Bronze PB Platinum Bronze WH White	350 mA 525 ⁴ 525mA 700 ⁵ 700mA	43K 4300K Color Temperature DIM 0-10V Dimming ^{7,8,3} F Fuse ^{10,11,12} HL Hi/Low (175/350/525, dual circuit input) ¹³ P Photocell ^{12,14} R NEMA Photocell Receptacle ^{12,15,16} ML Multi-Level (75/525) ¹³
Footnotes	;					34 347V			

- IESNA Type IV Medium distribution
- 2. IESNA Type IV Medium distribution with backlight control
- Adjustable arm for mounting to 2" (2-3/8" [60mm] 0.D.) tenon
 Available on fixtures with 20–160 LEDs
- Available on fixtures with 20–160 LEDs
 Available on fixtures with 20–60 LEDs
- 6. Color temperature per fixture; 6000K standard; minimum 70 CRI
- 7. Control by others
- Refer to dimming spec sheet for availability and additional information
- Can't exceed specified drive current. Consult factory if exceeding drive current is necessary
- Not available when UH voltage is selected
- 11. When code dictates fusing use time delay fuse
- 12. Not available with all multi-level options. Refer to multi-level spec sheet for availablilty and additional information
- Refer to multi-level spec sheet for availability and additional information
- 14. Must specify voltage other than UH
- 15. Intended for horizontal mounting
- 16. Photcell by others

	LED PERFORMANCE SPECS															
# of LEDs	Initial Delivered Lumens – Type IV Medium @ 6000K	B U G	Initial Delivered Lumens – Type IV Medium w/ backlight control @ 6000K	B U G	Type IV Medium @ 4300K	Rating*	IV Medium w/ backlight control @ 4300K	Rating**	System Watts 120–480V	Total Current @ 120V	Total Current @ 240V	Total Current @ 277V	Total Current @ 347	Total Current @ 480V	L ₇₀ Hours* @ 25° C (77° F)	50K Hours Lumen Maintenance Factor [*] @ 15° C (59° F)
						50mA (S	tandard) Fixture O	perating	at 25° C (77°							
20	1,913 (02)	1 1 1	1,441 (02)	0 1 1	1,763 (02)	1 1 .	1,328 (02)	0 1 1	26	0.20	0.11	0.10	0.09	0.07	>150,000	
40	3,826 (04)	1 1 1	2,882 (04)	0 1 1	3.526 (04)	1 1 1	2,656 (04)	0 1 1	47	0.40	0.21	0.19	0.15	0.12	>150,000]
60		2 1 2	4,267 (06)	1 2 1	5,221 (06)	2 1	3,933 (06)	1 1 1	68	0.58	0.30	0.26	0.20	0.16	>150,000	
80		2 2 2	5,690 (08)	1 2 2		2 2 2		1 2 2	90	0.77	0.38	0.34	0.26	0.20	>150,000	
100		2 2 2	7,095 (10)	1 2 2	8,681 (10)	2 2 2		1 2 2	111	0.95	0.47	0.42	0.32	0.24	>150,000	93%
120		3 2 3	8,513 (12)	1 3 2	10,417 (12)	2 2 2		1 2 2	132	1.15	0.56	0.50	0.38	0.28	>150,000	93/0
140		3 3 3	9,887 (14)	1 3 2	12,098 (14)	3 3 3	9,113 (14)	1 3 2	157	1.34	0.67	0.61	0.47	0.35	149,000	J
160		3 3 3	11,300 (16)	1 3 2	13,826 (16)	3 3 3		1 3 2	179	1.54	0.76	0.68	0.53	0.39	149,000]
200		3 3 3	14,125 (20)	1 3 3	17,282 (20)	3 3 3		1 3 2	221	1.92	0.95	0.84	0.65	0.48	149,000	l l
240	22,502 (24)	3 3 3	16,950 (22)	2 3 3	20,739 (24)	3 3 3		2 3 3	264	2.30	1.12	1.00	0.77	0.56	149,000	
						<u>525</u>	mA Fixture Operat	ing at 25°								
20	2,678 (02)	1 1 1	2,017 (02)	0 1 1	2,469 (02)	1 1 1	1,859 (02)	0 1 1	37	0.31	0.17	0.16	0.12	0.10	136,000	Į į
40		2 1 1	4,035 (04)	1 1 1		2 1 1		1 1 1	70	0.57	0.29	0.26	0.21	0.16	136,000	
60		2 2 2	5,974 (06)	1 2 2		2 2 2		1 2 2	102	0.87	0.44	0.39	0.30	0.22	129,000	
80		2 2 2	7,966 (08)	1 2 2	9,747 (08)	2 2 2		1 2 2	133	1.14	0.56	0.49	0.39	0.29	129,000	92%
100		3 3 3	9,932 (10)	1 3 2	12,153 (10)	3 3 3	9,154 (10)	1 3 2	172	1.47	0.75	0.67	0.51	0.38	128,000	32 /0
120		3 3 3	11,919 (12)	1 3 2		3 3 3		1 3 2	204	1.76	0.88	0.78	0.60	0.44	128,000	
140		3 3 3		1 3 2	16,937 (14)	3 3 3		1 3 2	233 265	2.01	0.99	0.87	0.69	0.51	123,000	
160	21,002 (16)	3 3 3	15,820 (16)	2 3 3	19,356 (16)	3 3 3		1 3 3		2.29	1.11	0.98	0.78	0.57	123,000	
						700n	nA Fixture Operat	ing at 25	°C (77°F)							
20	3,271 (02)	1 1 1	2,450 (02)	0 1 1	3,015 (02)	1 1 '	2,258 (02)	0 1 1	50	0.42	0.22	0.20	0.15	0.12	111,000	
40		2 2 2	4,900 (04)	1 2 1		2 2 2		1 2 1	93	0.79	0.40	0.35	0.27	0.20	111,000	90%
60	9,688 (06)	2 2 2	7,255 (06)	1 2 2	8,929 (06)	2 2 2	6,686 (06)	1 2 2	137	1.18	0.59	0.51	0.39	0.29	111,000	
* For re	ecommended lumen	maintena	nce factor data see	TD-13	** For more	informa	tion on the IES BUG	(Backlight-	Uplight-Glare) Rating vis	sit www.ies	na.org/PDF	/Erratas/T	M-15-07Bu	gRatingsAdde	ndum.pdf

NOTE: All data subject to change without notice.

© 2011 BetaLED®, a division of Ruud Lighting • 1200 92nd Street • Sturtevant, WI 53177 • 800-236-6800 • www.betaLED.com



Job Name: MATC Truax Landscape Catalog Number: ARE-EDG-4M-DA-08-D-UL-350-BK-

Notes: single head

Type:

S2,S3

Rev. Date: 8/23/11

4@

1 97

1.97

2.05

2.13

2.46

2.62

ARE-EDG-4M-AA

THE EDGE® LED Area Light – Type IV Medium

General Description

Slim, low profile design minimizes wind load requirements. Fixture sides are rugged cast aluminum with integral, weather-tight LED driver compartments and high performance aluminum heatsinks. Adjustable mounting arm is rugged die cast aluminim and mounts to 2" (51mm) tenon. Includes leaf/debris guard. Five year limited warranty on fixture.

Modular design accommodates varied lighting output from high power, white, 6000K (+/- 500K per full fixture), minimum 70 CRI, long life LED sources. Optional 4300K (+/- 300K per full fixture) also available. 120-277V 50/60 Hz, Class 1 LED drivers are standard. 347-480V 50/60 Hz driver is optional. LED drivers have power factor >90% and THD <20% at full load. Units provided with integral 10kV surge suppression protection standard. Integral weather-tight electrical box with terminal strips (12Ga - 20Ga) for easy power hook-up. Surge protection tested in accordance with IEEE/ANSI C62.41.2.

Testing & Compliance

UL listed in the U.S. and Canada for wet locations and enclosure classified IP66 per IEC 60529 when ordered without P or R options. Consult factory for CE Certified products. Certified to ANSI C136.31-2001 3G bridge & overpass vibration standards. RoHS





Product qualified on the Design Lights Consortium ("DLC") Qualified Products List ("QPL") when ordered without backlight control shield.

Exclusive Colorfast DeltaGuard® finish features an E-Coat epoxy primer with an ultradurable silver powder topcoat, providing excellent resistance to corrosion, ultraviolet degradation and abrasion. Bronze, black, white and platinum bronze powder topcoats are also available. The finish is covered by our 10 year limited warranty.

Fixture and finish are endurance tested to withstand 5,000 hours of elevated ambient salt fog conditions as defined in ASTM Standard B 117.

Patents

U.S. and international patents granted and pending. BetaLED is a division of Ruud Lighting, Inc. For a listing of Ruud Lighting, Inc. patents, visit www.uspto.gov.

THE EDGE® EPA & Weight Calcalculations

Single 180° 90° 90° 90°

0.66 1.31

0.66

0.66 1.31

1. Add 5 lbs. (2.3kg) for transformer in 347-480V fixtures when

2. For applications requiring 240 LEDs at 90 degrees refer to the DL mount version of our spec sheet.

1.31

1.31

1.31

1.31

1.31

1.31

1.31

1.48

0.98 1 64

0.98 1.64

1.02 1.68

1 07 1 72

1.11 1.76 2.21 2.29

1.15

1 19 1 84 2.38

1.23 1.89

1.31 1.97

n/a2

1.80

Approximate

Weight

120-480V

Adjustable Fitter Mount 0°

20 21.0 lbs. (9.5kg) 0.66

23.8 lbs. (10.8kg)

27.1 lbs. (12.3kg)

35.4 lbs. (16.1kg)

28.2 lbs. (12.8kg) 0.66

33.5 lbs. (15.2kg) 0.66

36.9 lbs. (16.7kg) 0.66

41.4 lbs. (18.8kg) 0.66

43.3 lbs. (19.6kg) 0.66

47.8 lbs. (21.7kg) 0.74

multi-level options are selected.

LEDs

120

140

160


200

Field-Installed Accessories




Bird Spikes XA-BRDSPK


Photometrics

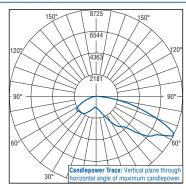


Independent Testing Laboratories certified test. Report No. ITL68090, Candlepower trace of 4300K, 120 LED Type IV Medium area luminaire with 14,934 initial delivered lumens operating at 525mA. All published luminaire photometric testing performed to IESNA LM-79-08 standards.

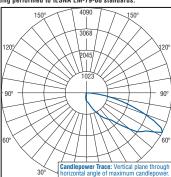

Independent Testing Laboratories certified test. Report No ITL68090. Candlepower trace of 4300K, 40 LED Type IV Medium w/ backlight control area luminaire with 4.926 initial delivered lumens operating at 525mA. All published luminaire photometric testing performed to IESNA LM-79-08 standards.

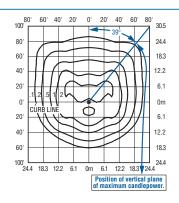

Isofootcandle plot of 4300K, 120 LED Type IV Medium area luminaire at 25' (7.6 m) A.F.G. Luminaire with 14,583 initial delivered lumens operating at 525mA. Initial FC at grade.

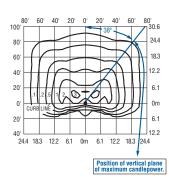

Isofootcandle plot of 4300K, 120 LED Type IV Medium area luminaire at 25' (7.6 m) A.F.G. Luminaire with 10.985 initial delivered lumens operating at 525mA. Initial FC at grade.


NOTE: All data subject to change without notice.

© 2011 BetaLED®, a division of Ruud Lighting • 1200 92nd Street • Sturtevant, WI 53177 • 800-236-6800 • www.betaLED.com




Enterprise Ligh

LL12-23054

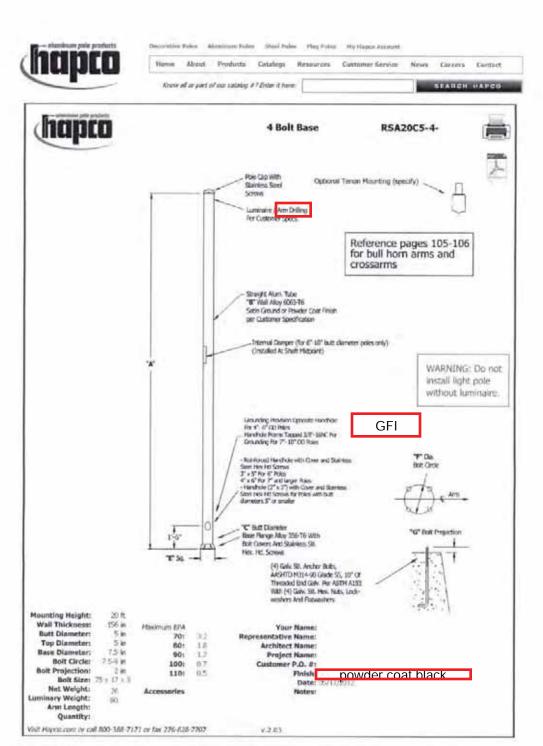



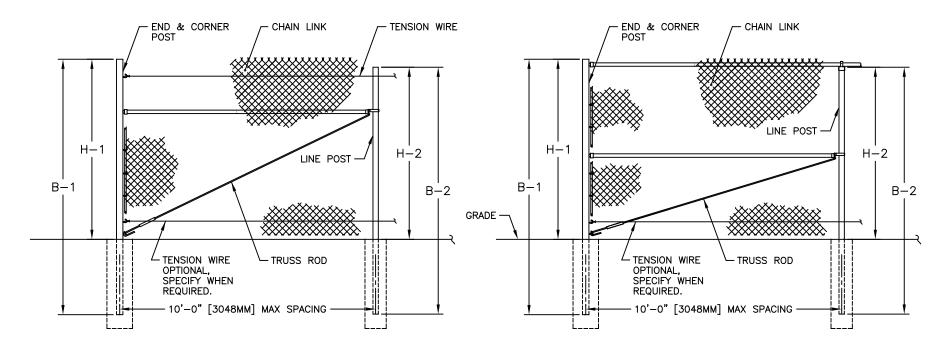

FENCE SECTION ELEVATION WITHOUT TOP RAIL & WITHOUT BARBED WIRE

FENCE SECTION ELEVATION WITH TOP RAIL & WITHOUT BARBED WIRE

FENCE HEIGHT	END & CC	RNER POSTS	LINE POSTS				
NOMINAL HEIGHT	B-1 BAR LENGTH	H-1 HEIGHT ABOVE GRADE	B-2 BAR LENGTH	H-2 HEIGHT ABOVE GRADE			
5'-0" [1524MM]	8'-0" [2438MM]	5'-0 5/8" [1540MM]	7'-8" [2337MM]	4'-8 7/8" [1445MM]			
6'-0" [1829MM]	9'-0" [2743MM]	6'-0 5/8" [1845MM]	8'-8" [2642MM]	5'-8 7/8" [1749MM]			
7'-0" [2134MM]	10'-0" [3048MM]	7'-0 5/8" [2150MM]	9'-8" [2946MM]	6'-8 7/8" [2054MM]			
8'-0" [2438MM]	11'-0" [3353MM]	8'-0 5/8" [2454MM]	10'-8" [3251MM]	7'-8 7/8" [2359MM]			
9'-0" [2743MM]	12'-0" [3658MM]	9'-0 5/8" [2759MM]	11'-8" [3556мм]	8'-8 7/8" [2664MM]			
10'-0" [3048MM]	13'-0" [3962MM]	10'-0 5/8" [3064MM]	12'-8" [3861MM]	9'-8 7/8" [2969MM]			
11'-0" [3353MM]	14'-0" [4267MM]	11'-0 5/8" [3369MM]	13'-8" [4166MM]	10'-8 7/8" [3273MM]			
12'-0" [3658MM]	15'-0" [4572MM]	12'-0 5/8" [3674MM]	14'-8" [4470MM]	11'-8 7/8" [3578MM]			

- NOTES: 1. THIS DWG CORRESPONDS WITH DWGS 1-1110 & 1-1130.
- 2. SPECIFICATIONS SHOWN CAN BE CHANGED BY MASTER HALCO ONLY.

MASTER HALCO®
001-2006 MASTER HALCO, INC. RIGHTS RESERVED.

ANCHOR FENCE PRODUCTS by Master Halco

Orange, CA Phone No.: 800-229-5615 www.FenceOnline.com


TYPICAL HIGH FENCE WITHOUT BARRED WIRED	BY: DATE:	JRR 09-27-95	DWG:	1-1000
DIMENSIONS & SPECIFICATIONS	REV:	С	LAYER:	1
DIMENSIONS & SPECIFICATIONS	REV DATE:	08-04-06	SCALE:	1/4" = 1'-0"









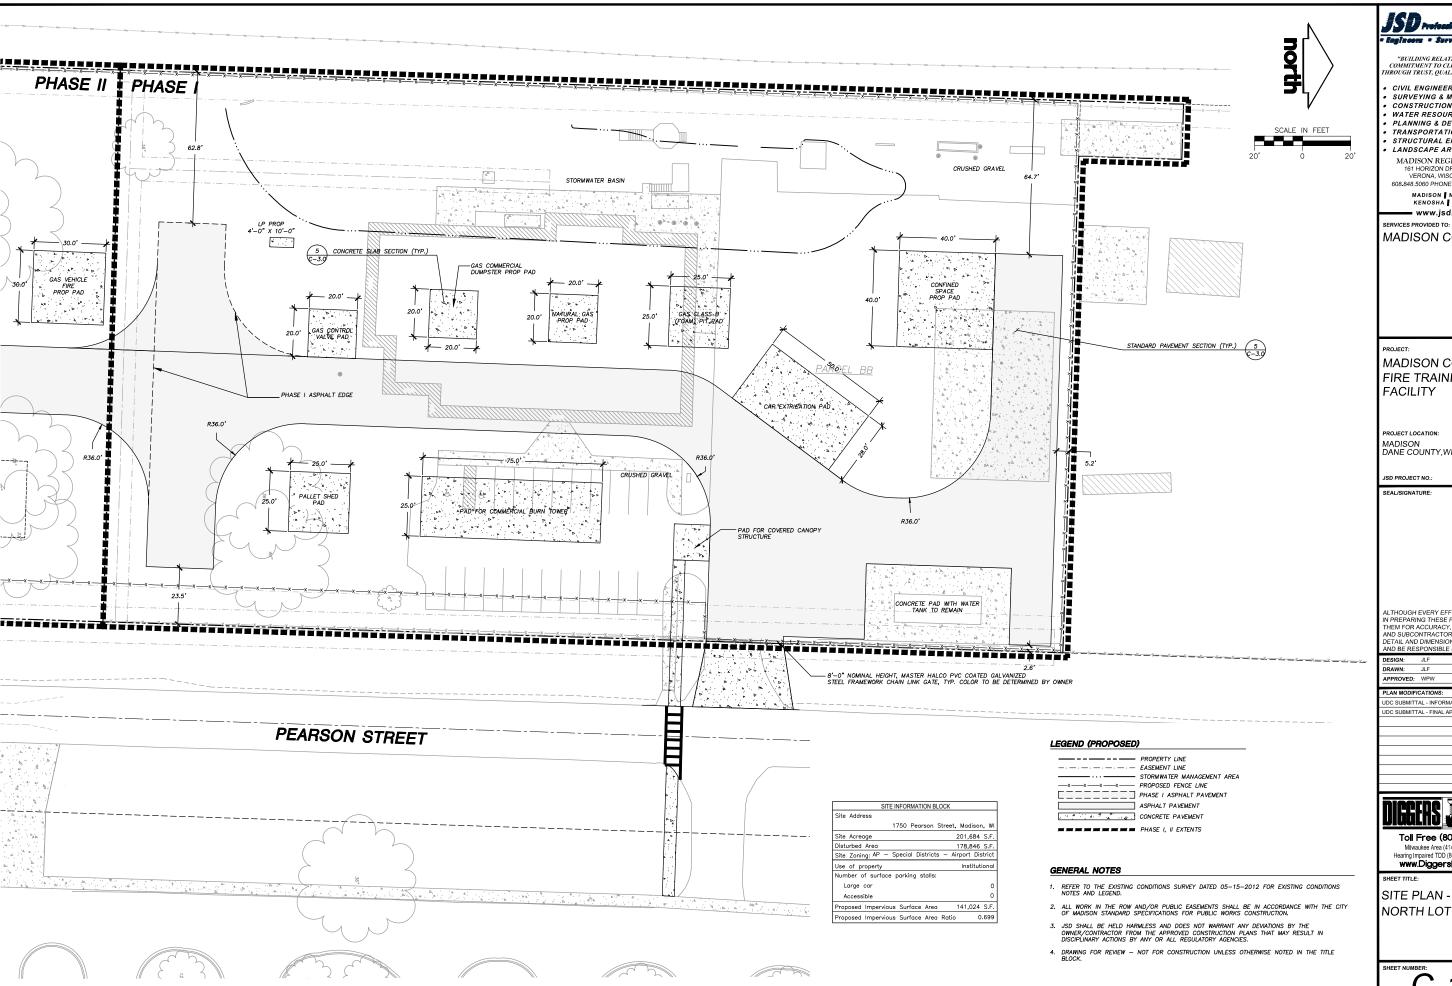

"BUILDING RELATIONSHIPS WITH A COMMITMENT TO CLIENT SATISFACTION HROUGH TRUST, QUALITY AND EXPERIENCE

- CIVIL ENGINEERING
- SURVEYING & MAPPING CONSTRUCTION SERVICES
- WATER RESOURCES
- PLANNING & DEVELOPMENT
 TRANSPORTATION ENGINEERING
- STRUCTURAL ENGINEERING LANDSCAPE ARCHITECTURE

MADISON REGIONAL OFFICE 161 HORIZON DRIVE, SUITE 101 VERONA, WISCONSIN 53593

608.848.5060 PHONE 608.848.2255 FAX MADISON MILWAUKEE KENOSHA APPLETON

www.jsdinc.com

MADISON COLLEGE

MADISON COLLEGE FIRE TRAINING FACILITY

PROJECT LOCATION: MADISON DANE COUNTY,WI

JSD PROJECT NO.

ALTHOUGH EVERY EFFORT HAS BEEN MADE ALTHOUGH EVERY EFFORT HAS BEEN MADE IN PREPARING THESE PLANS AND CHECKING THEM FOR ACCURACY, THE CONTRACTOR AND SUBCONTRACTORS MUST CHECK ALL DETAIL AND DIMENSIONS OF THEIR TRADE AND BE RESPONSIBLE FOR THE SAME.


DESIGN. SEI	00-20-11	
DRAWN: JLF	03-27-13	
APPROVED: WPW		
PLAN MODIFICATIONS:	DATE:	
UDC SUBMITTAL - INFORMATIONAL	06-05-13	
UDC SUBMITTAL - FINAL APPROVAL	07-17-13	




Toll Free (800) 242-8511 Milwaukee Area (414) 259-1181 Hearing Impaired TDD (800) 542-2289

www.DiggersHotline.com

SITE PLAN -NORTH LOT

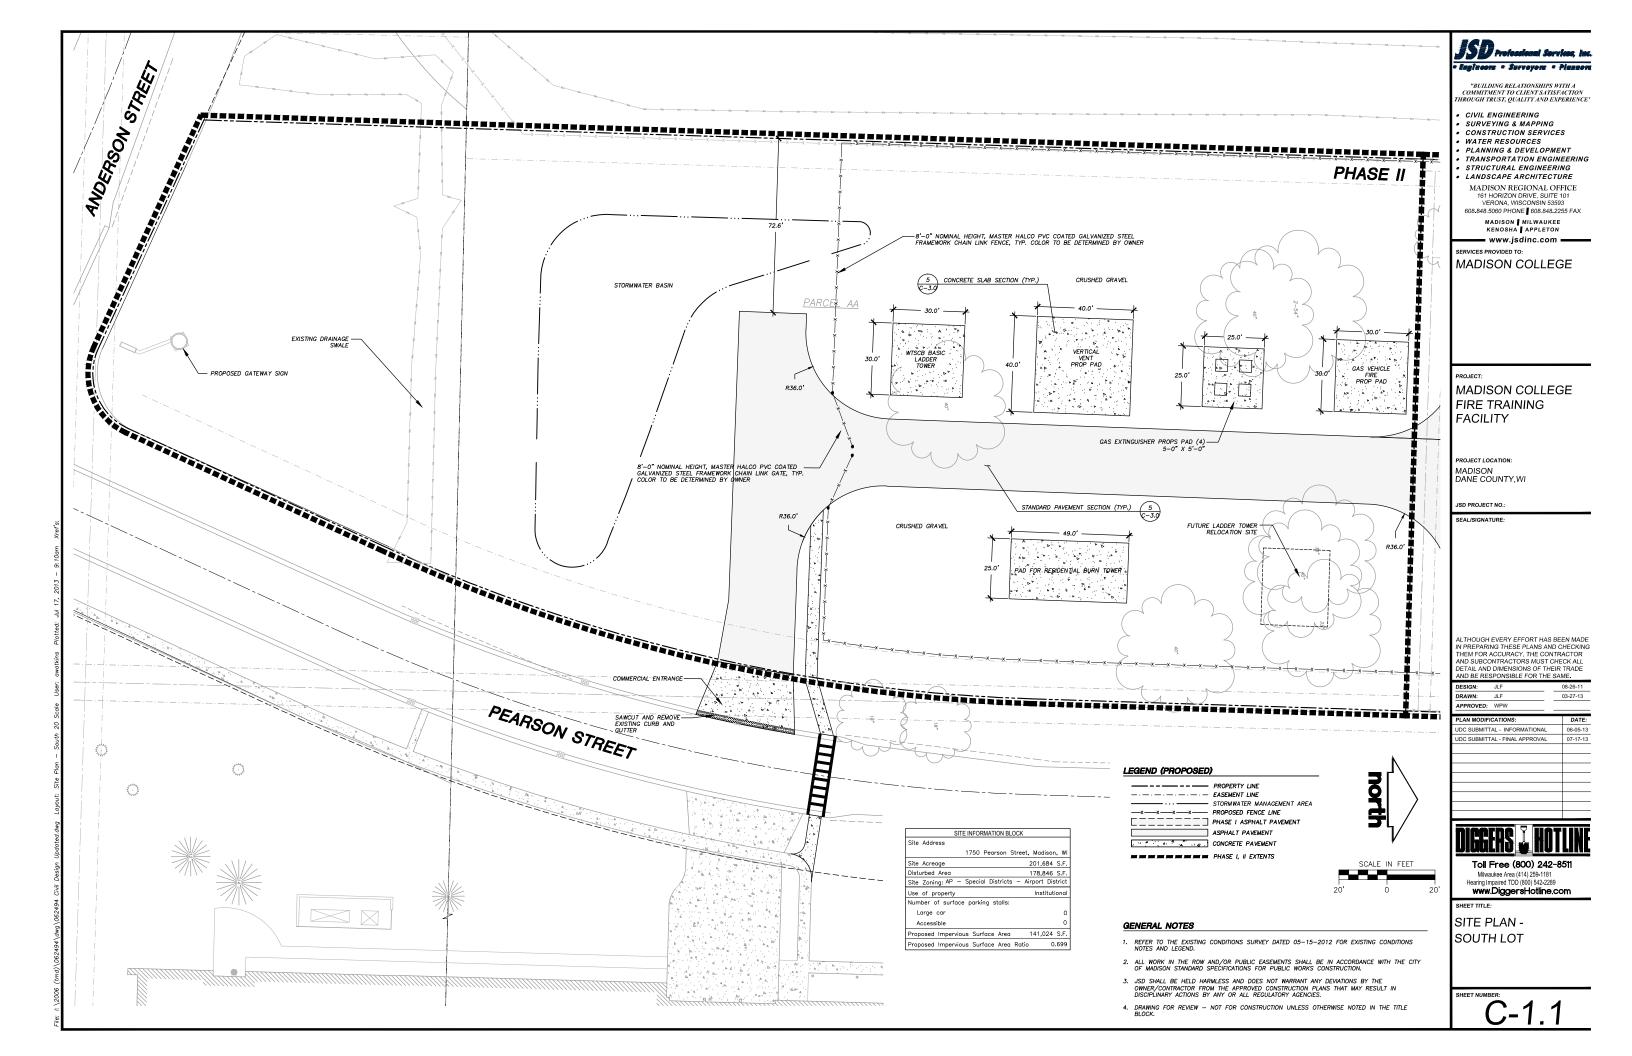

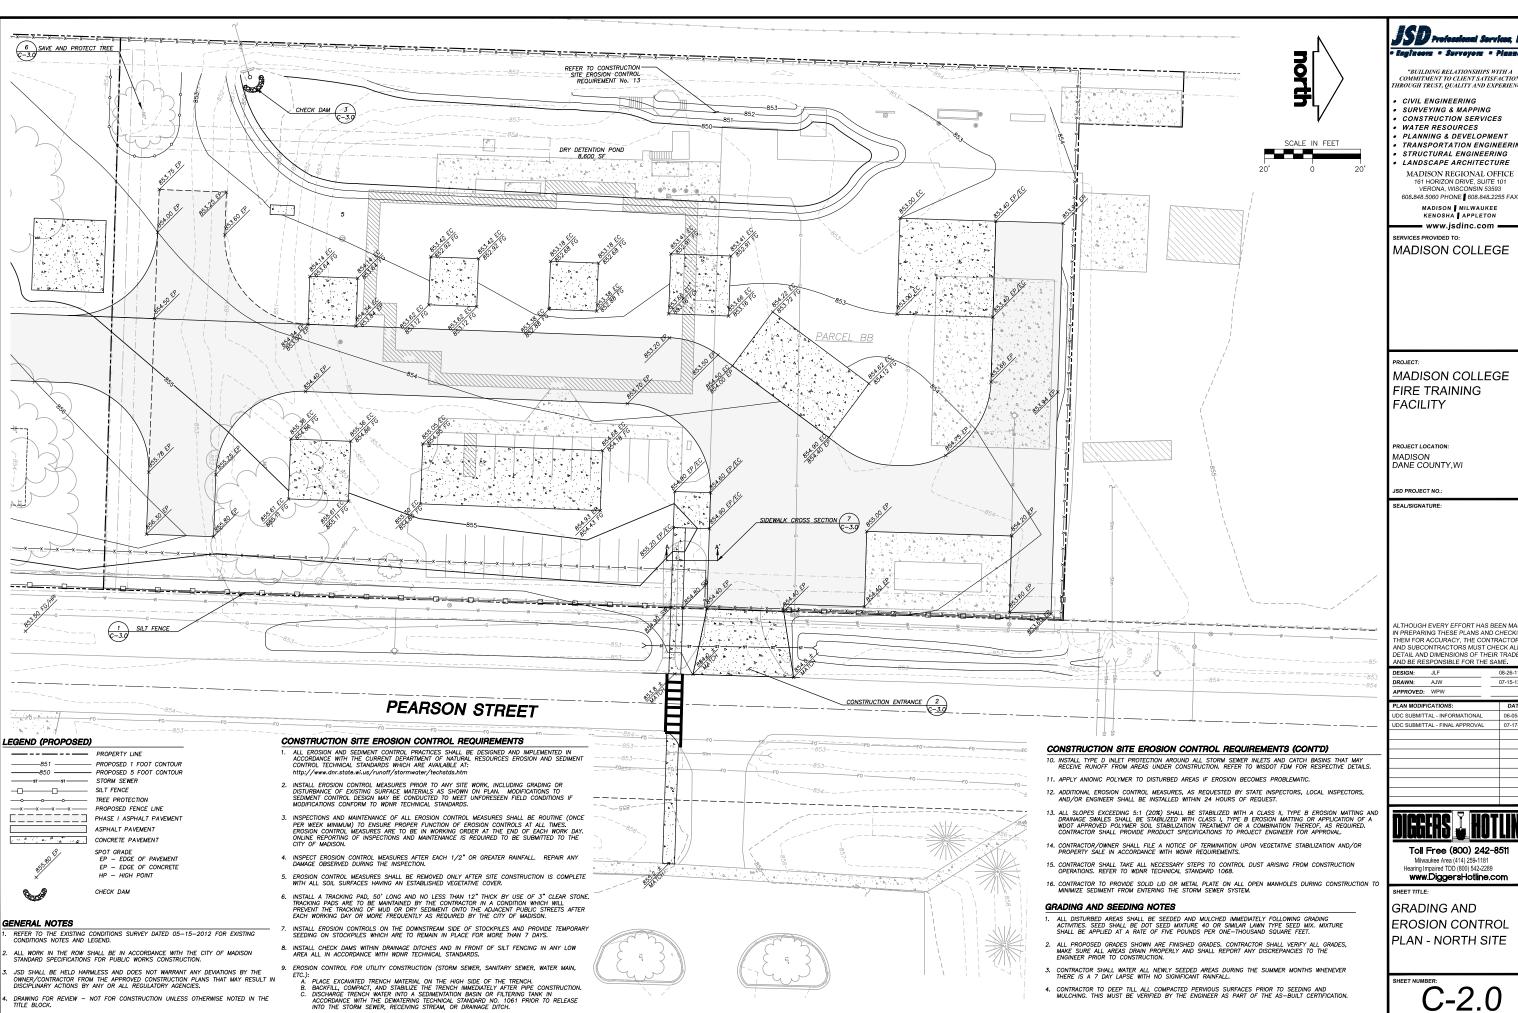

"BUILDING RELATIONSHIPS WITH A COMMITMENT TO CLIENT SATISFACTION HROUGH TRUST, QUALITY AND EXPERIENCE

- CIVIL ENGINEERING
- SURVEYING & MAPPING **CONSTRUCTION SERVICES**
- WATER RESOURCES
- PLANNING & DEVELOPMENT
- TRANSPORTATION ENGINEERING
- STRUCTURAL ENGINEERING LANDSCAPE ARCHITECTURE

MADISON REGIONAL OFFICE 161 HORIZON DRIVE, SUITE 101 VERONA, WISCONSIN 53593

MADISON | MILWAUKEE KENOSHA | APPLETON

SERVICES PROVIDED TO:

MADISON COLLEGE

MADISON COLLEGE FIRE TRAINING **FACILITY**

PROJECT LOCATION: MADISON DANE COUNTY,WI

JSD PROJECT NO

SEAL/SIGNATURE

ALTHOUGH EVERY EFFORT HAS BEEN MADE PREPARING THESE PLANS AND CHECKING THEM FOR ACCURACY. THE CONTRACTOR THEM FOR ACCURACY, THE CONTRACTOR AND SUBCONTRACTORS MUST CHECK ALL DETAIL AND DIMENSIONS OF THEIR TRADE AND BE RESPONSIBLE FOR THE SAME.


DRAWN: AJW	07-15-13	
APPROVED: WPW		
PLAN MODIFICATIONS:	DATE:	
UDC SUBMITTAL - INFORMATIONAL	06-05-13	
UDC SUBMITTAL - FINAL APPROVAL	07-17-13	



Toll Free (800) 242-851 Milwaukee Area (414) 259-1181 Hearing Impaired TDD (800) 542-2289

www.DiggersHotline.com

GRADING AND EROSION CONTROL PLAN - NORTH SITE

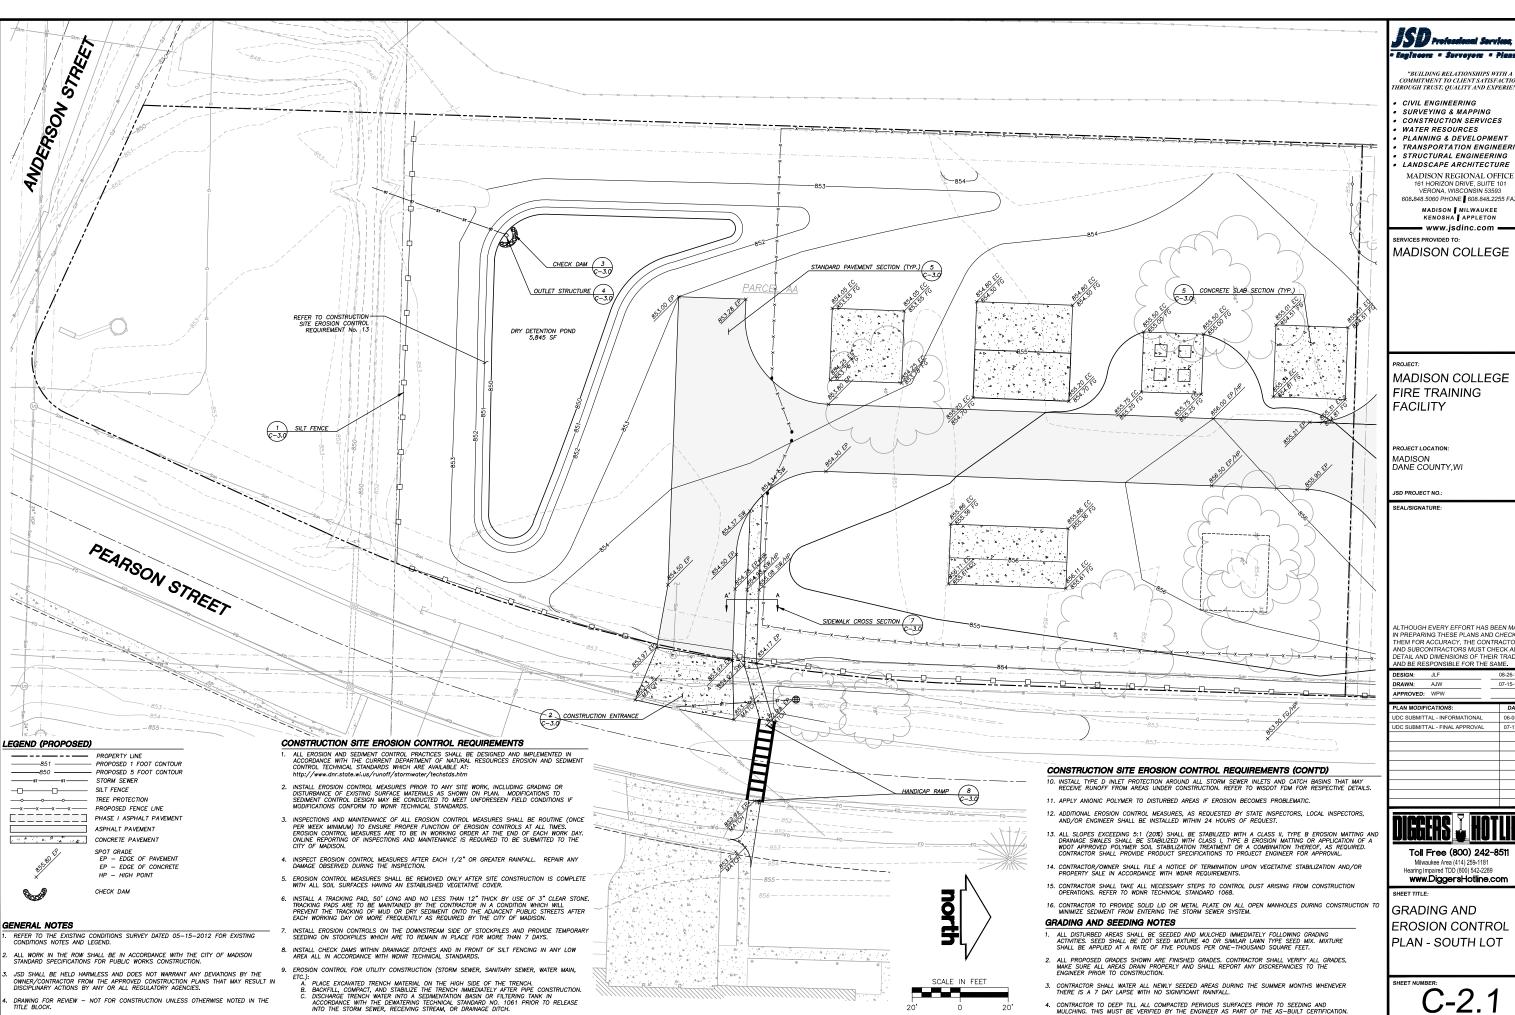

"BUILDING RELATIONSHIPS WITH A COMMITMENT TO CLIENT SATISFACTION HROUGH TRUST, QUALITY AND EXPERIENCE

- CIVIL ENGINEERING
- SURVEYING & MAPPING CONSTRUCTION SERVICES
- WATER RESOURCES
- PLANNING & DEVELOPMENT
- TRANSPORTATION ENGINEERING
- STRUCTURAL ENGINEERING
- LANDSCAPE ARCHITECTURE
- MADISON REGIONAL OFFICE 161 HORIZON DRIVE, SUITE 101 VERONA, WISCONSIN 53593

MADISON MILWAUKEE KENOSHA APPLETON

SERVICES PROVIDED TO:

MADISON COLLEGE

MADISON COLLEGE FIRE TRAINING FACILITY

PROJECT LOCATION: MADISON DANE COUNTY,WI

JSD PROJECT NO


SEAL/SIGNATURE

ALTHOUGH EVERY EFFORT HAS BEEN MADE PREPARING THESE PLANS AND CHECKING THEM FOR ACCURACY. THE CONTRACTOR THEM FOR ACCURACY, THE CONTRACTOR AND SUBCONTRACTORS MUST CHECK ALL DETAIL AND DIMENSIONS OF THEIR TRADE AND BE RESPONSIBLE FOR THE SAME.

DRAWN: AJW	07-15-13
APPROVED: WPW	
PLAN MODIFICATIONS:	DATE:
UDC SUBMITTAL - INFORMATIO	NAL 06-05-13
UDC SUBMITTAL - FINAL APPRO	OVAL 07-17-13

Toll Free (800) 242-851 Milwaukee Area (414) 259-1181 Hearing Impaired TDD (800) 542-2289 www.DiggersHotline.com

GRADING AND EROSION CONTROL

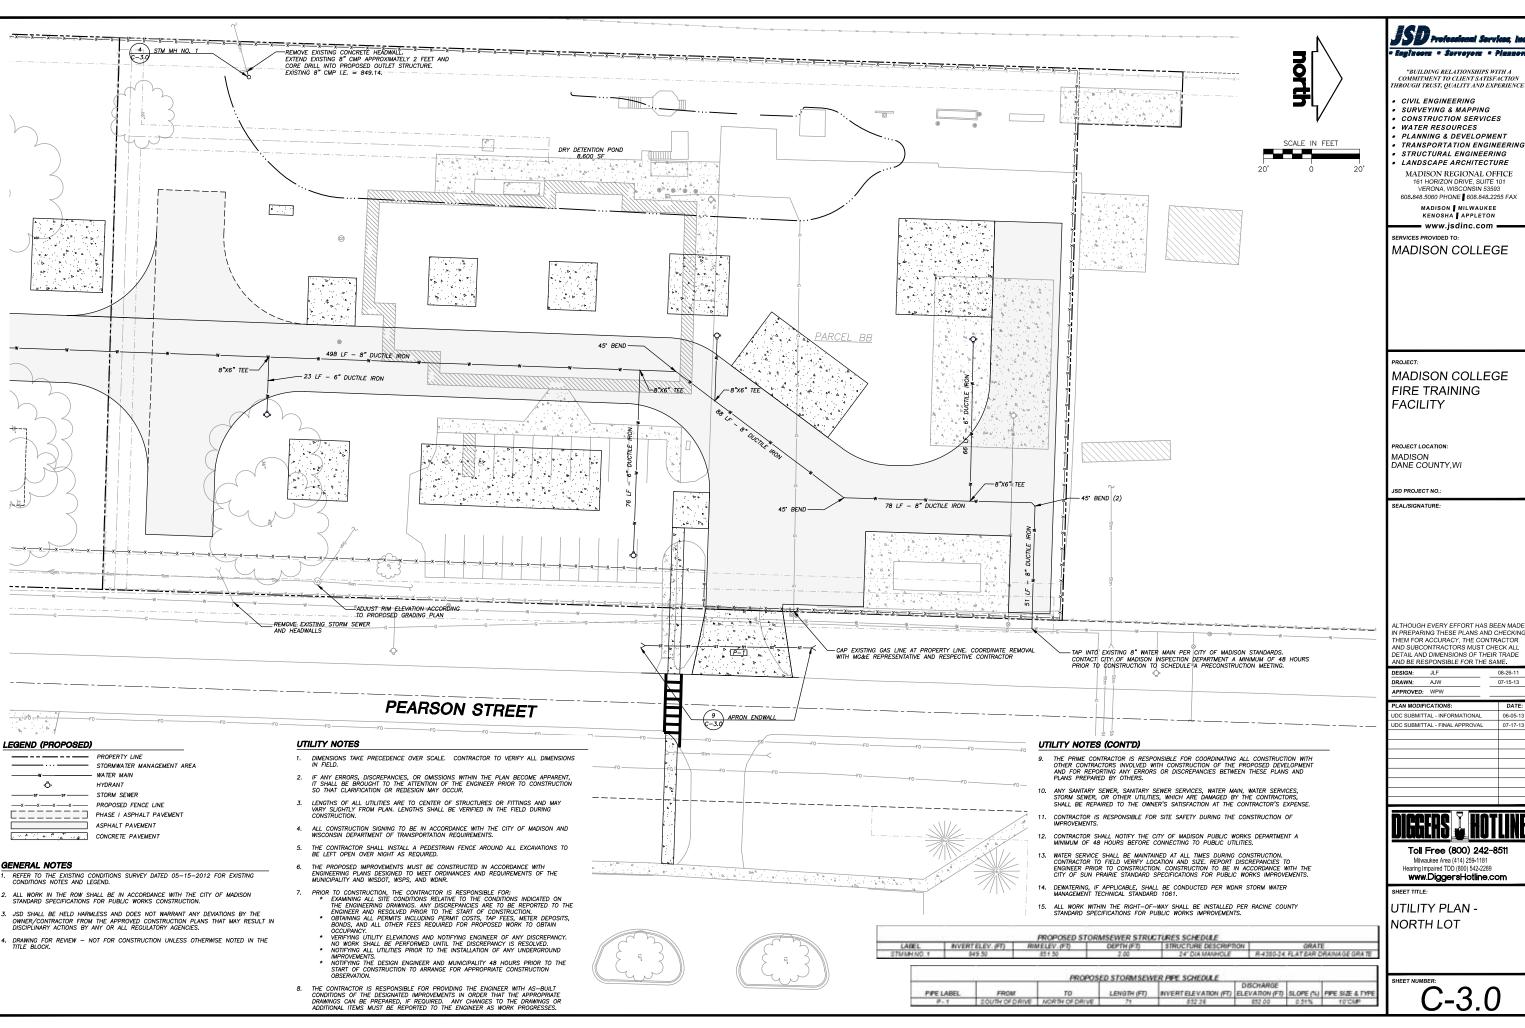

JSD Professional Services, Inc

"BUILDING RELATIONSHIPS WITH A COMMITMENT TO CLIENT SATISFACTION "HROUGH TRUST, QUALITY AND EXPERIENCE"

- CIVIL ENGINEERING

- STRUCTURAL ENGINEERING
- MADISON REGIONAL OFFICE 161 HORIZON DRIVE, SUITE 101 VERONA, WISCONSIN 53593

608.848.5060 PHONE ■ 608.848.2255 FAX

www.jsdinc.com

MADISON COLLEGE

MADISON COLLEGE FIRE TRAINING

ALTHOUGH EVERY EFFORT HAS BEEN MADE ALTHOUGH EVERY EFFORT HAS BEEN MADE IN PREPARING THESE PLANS AND CHECKING THEM FOR ACCURACY, THE CONTRACTOR AND SUBCONTRACTORS MUST CHECK ALL DETAIL AND DIMENSIONS OF THEIR TRADE AND BE RESPONSIBLE FOR THE SAME.


DESIGN: JLF		08-26-11
DRAWN:	AJW	07-15-13
APPROVED:	WPW	
PLAN MODIFI	CATIONS:	DATE:



Toll Free (800) 242-851 Milwaukee Area (414) 259-1181 Hearing Impaired TDD (800) 542-2289

www.DiggersHotline.com

UTILITY PLAN -NORTH LOT

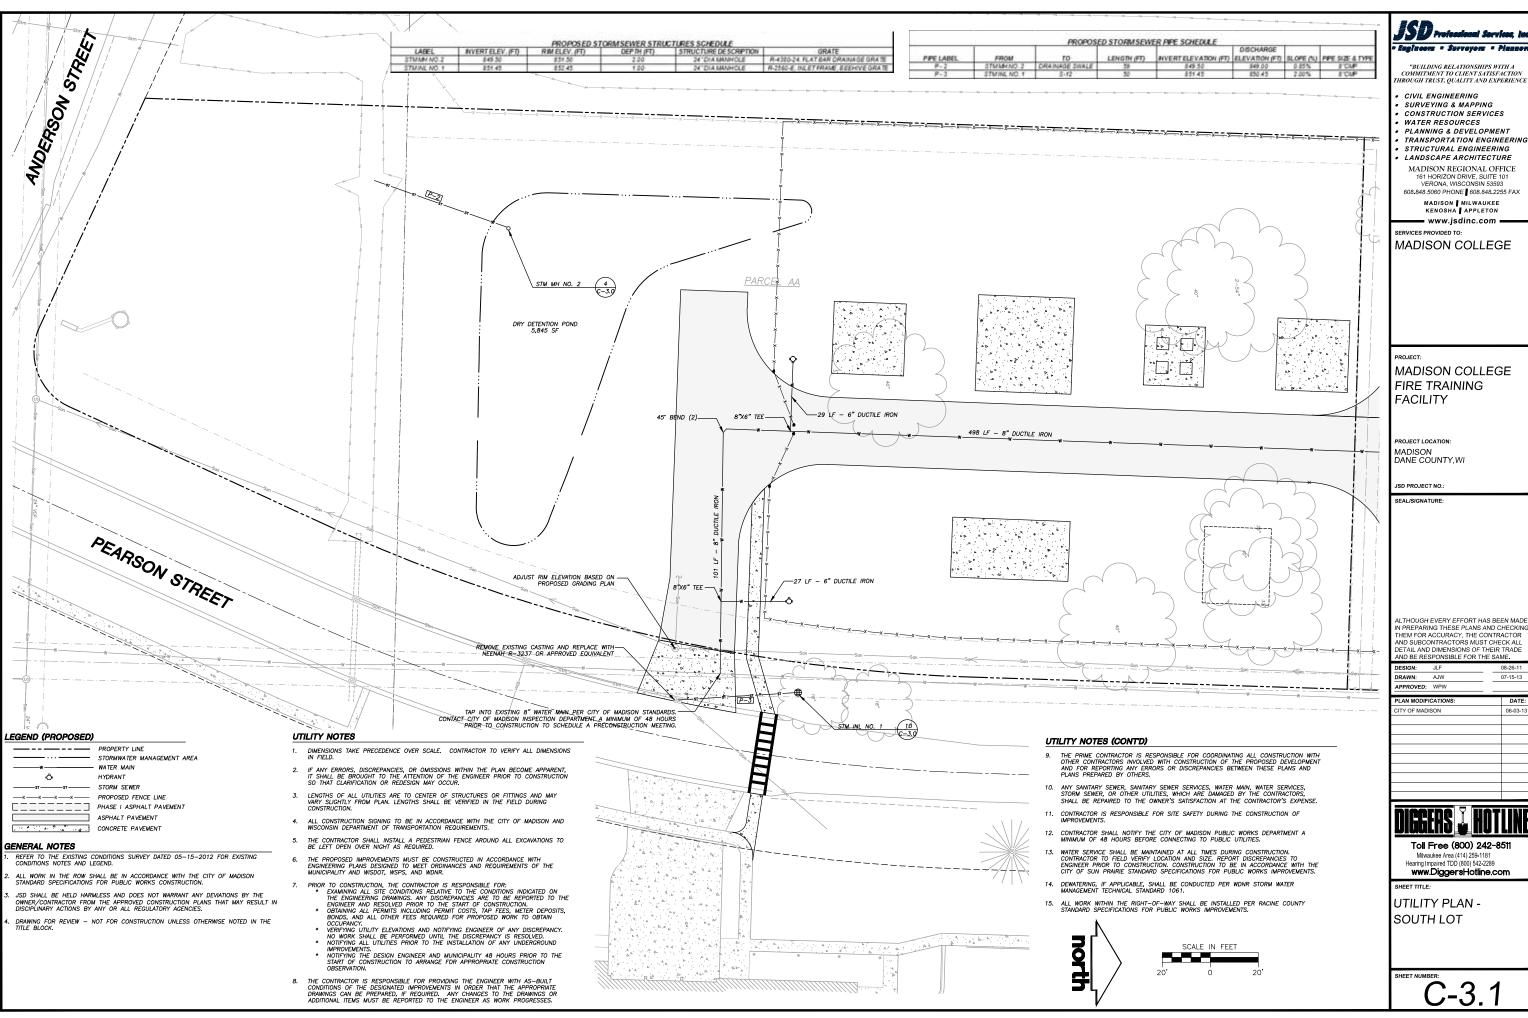



- MADISON REGIONAL OFFICE

ALTHOUGH EVERY EFFORT HAS BEEN MADE PREPARING THESE PLANS AND CHECKING IN PREPARING THESE PLANS AND CHECKIN THEM FOR ACCURACY, THE CONTRACTOR AND SUBCONTRACTORS MUST CHECK ALL DETAIL AND DIMENSIONS OF THEIR TRADE AND BE RESPONSIBLE FOR THE SAME.

DRAWN: AJW	M3VV 07-13-13	
APPROVED: WPW		
PLAN MODIFICATIONS:	DATE:	
CITY OF MADISON	06-03-13	



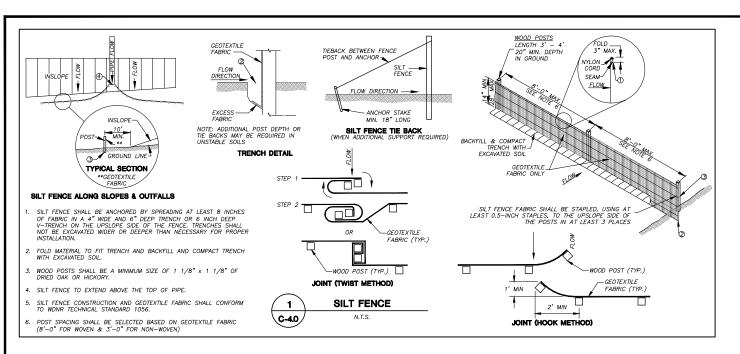

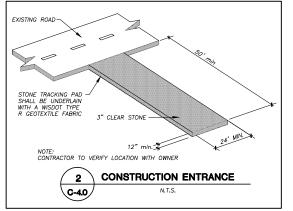

کار کی

NOTE: FENCE TO BE INSTALLED TO PROTECT EXISTING


TREE(S) DURING CONSTRUCTION. CONTRACTOR TO COORDINATE FENCE LOCATION WITH OWNER PRIOR TO INSTALLATION. SILT FENCE MATERIAL, OR OTHER APPROVED BARRIER MATERIAL MAY BE USED.

TREE PROTECTION

6

C-4.0

-DRIP LINE, TYP

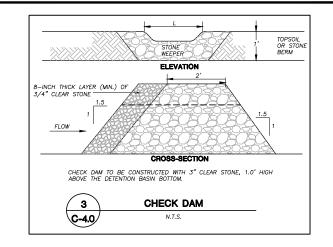



"BUILDING RELATIONSHIPS WITH A COMMITMENT TO CLIENT SATISFACTION HROUGH TRUST, QUALITY AND EXPERIENCE

- CIVIL ENGINEERING
- SURVEYING & MAPPING CONSTRUCTION SERVICES
- WATER RESOURCES
- PLANNING & DEVELOPMENT
- STRUCTURAL ENGINEERING
- LANDSCAPE ARCHITECTURE MADISON REGIONAL OFFICE

VERONA, WISCONSIN 53593 608.848.5060 PHONE ■ 608.848.2255 FAX

MADISON | MILWAUKEE KENOSHA | APPLETON www.jsdinc.com

SERVICES PROVIDED TO:

MADISON COLLEGE

PRO IECT


MADISON COLLEGE FIRE TRAINING FACILITY

PROJECT LOCATION: MADISON DANE COUNTY,WI

JSD PROJECT NO.

SEAL/SIGNATURE

ADJACENT ASPHALT DRIVE-- CONCRETE SIDEWALK 2% CROSS SLOPE 4 · v - 1 · q · v - 1 · q · v - 1 · q · v - 1 · q · v PITCH SUBGRADE TO DRAIN 4" MIN. CRUSHED AGGREGATE BASE COURSE SIDEWALK CROSS SECTION ´ 7 `\ C-4.0

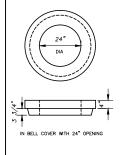

IN BELL GRATE IS CUSTOM MANUFACTURED BY THE NEENAH FOUNDRY COMPANY TO MADISON CONCRETE PIPE SPECIFICATIONS

GRATE IS CAST GRAY IRON MANUFACTURED TO MEET ASTM A-48 CLASS 35 B AND AASHTO M105 SPECIFICATIONS — GRATE HYDRAULICS ARE AVAILABLE UPON REQUEST

GRATES ARE AASHTO H20 LOAD RATED

GRATE SETS FLUSH WITH TOP OF CATCH BASIN BELL

PRECAST REINFORCED CONCRETE CATCH BASIN IS MANUFACTURED TO MEET ASTM C-478 AND AASHTO M199 SPECIFICATIONS


STANDARD CATCH BASIN BARREL HEIGHTS: 0'-6", 1'-0", 2'-0", 3'-0" AND 4'-0"


STOCK 36" DIA. CATCH BASINS AVAILABLE WITH OR WITHOUT A 6" THICK INTEGRAL BASE OR AS SPECIFIED

-FLOGARD PLUS CATCH BASIN JOINT MATERIAL: CONSEAL FILTER SEE CS-102 AND/OR CS-202 AS NOTE * MANUFACTURED BY CONSEAL CONSEAL CATCHING BY CONSEAL CONSEAL CATCHING BY CONSEAL CATCHING BY CONSEAL CATCHING BY CONSEAL CATCHING CAICH BASIN JOINI MAIERIAL: CONSEAL CS-102 AND/OR CS-202 AS MANUFACTURED BY CONCRETE SEALANTS INC., WHICH MEETS OR EXCEEDS REQUIREMENTS OF FEDERAL SPECIFICATION SS-S-210 (210A), AASHTO M-198B AND ASTM C-990

PIPE TO CATCH BASIN CONNECTORS: KOR-N-SEAL AS MANUFACTURED BY NPC INC., WHICH MEETS OR EXCEEDS REQUIREMENTS OF ASTM C-923

NISTALL FLOGARD PLUS CATCH BASIN FILTER INSERT AS MANUFACTURED BY KRISTAR ENTERPRISES, INC. OR EQUIVALENT. FILTER SHALL BE INSTALLED IN ACCORDANCE WITH MANUFACTURERS INSTRUCTIONS, RECOMMENDATIONS AND SPECIFICATIONS. DETAIL INFORMATION RECARDING MAINTENANCE AND FILTER REPLACEMENT CAN BE FOUND AT WWW.KRISTAR.COM OR BY CALLING KRISTAR WINDLYSBEES AL MEDIA SET, SEED.

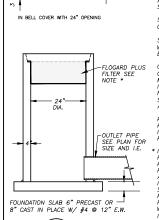

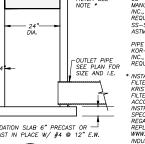

INDUSTRIES AT (800) 579-8819.

10 \ 24" DIAMETER STORM INLET **∖c-3.0**/

ALTHOUGH EVERY EFFORT HAS BEEN MADE PREPARING THESE PLANS AND CHECKING IN PREPARING THESE PLANS AND CHECKIN THEM FOR ACCURACY, THE CONTRACTOR AND SUBCONTRACTORS MUST CHECK ALL DETAIL AND DIMENSIONS OF THEIR TRADE AND BE RESPONSIBLE FOR THE SAME.


DEGICIT. GET	00 20 11	
DRAWN: AJW	07-15-13	
APPROVED: WPW		
PLAN MODIFICATIONS:	DATE:	
UDC SUBMITTAL - INFORMATIONAL	06-05-13	
UDC SUBMITTAL - FINAL APPROVAL	07-17-13	




Milwaukee Area (414) 259-1181 Hearing Impaired TDD (800) 542-2289

www.DiggersHotline.com

DETAILS

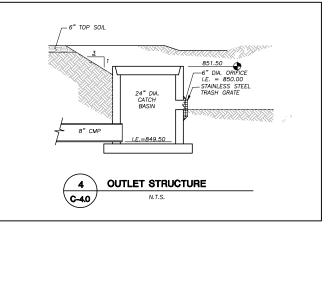


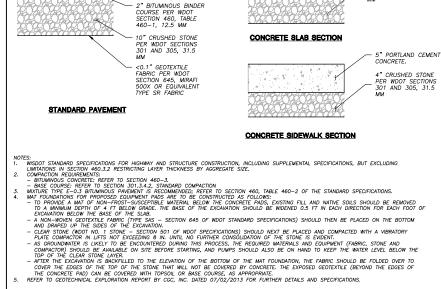

PAVEMENT SECTIONS


5


∖C-4.0∕

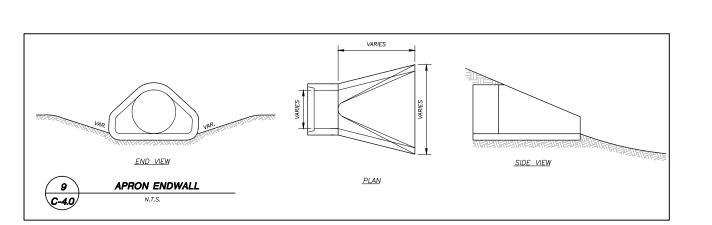

6" PORTLAND CEMENT CONCRETE.

6" CRUSHED STONE PER WDOT SECTIONS 301 AND 305, 31.5

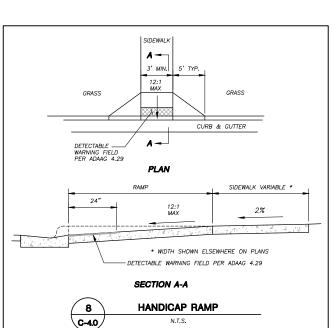

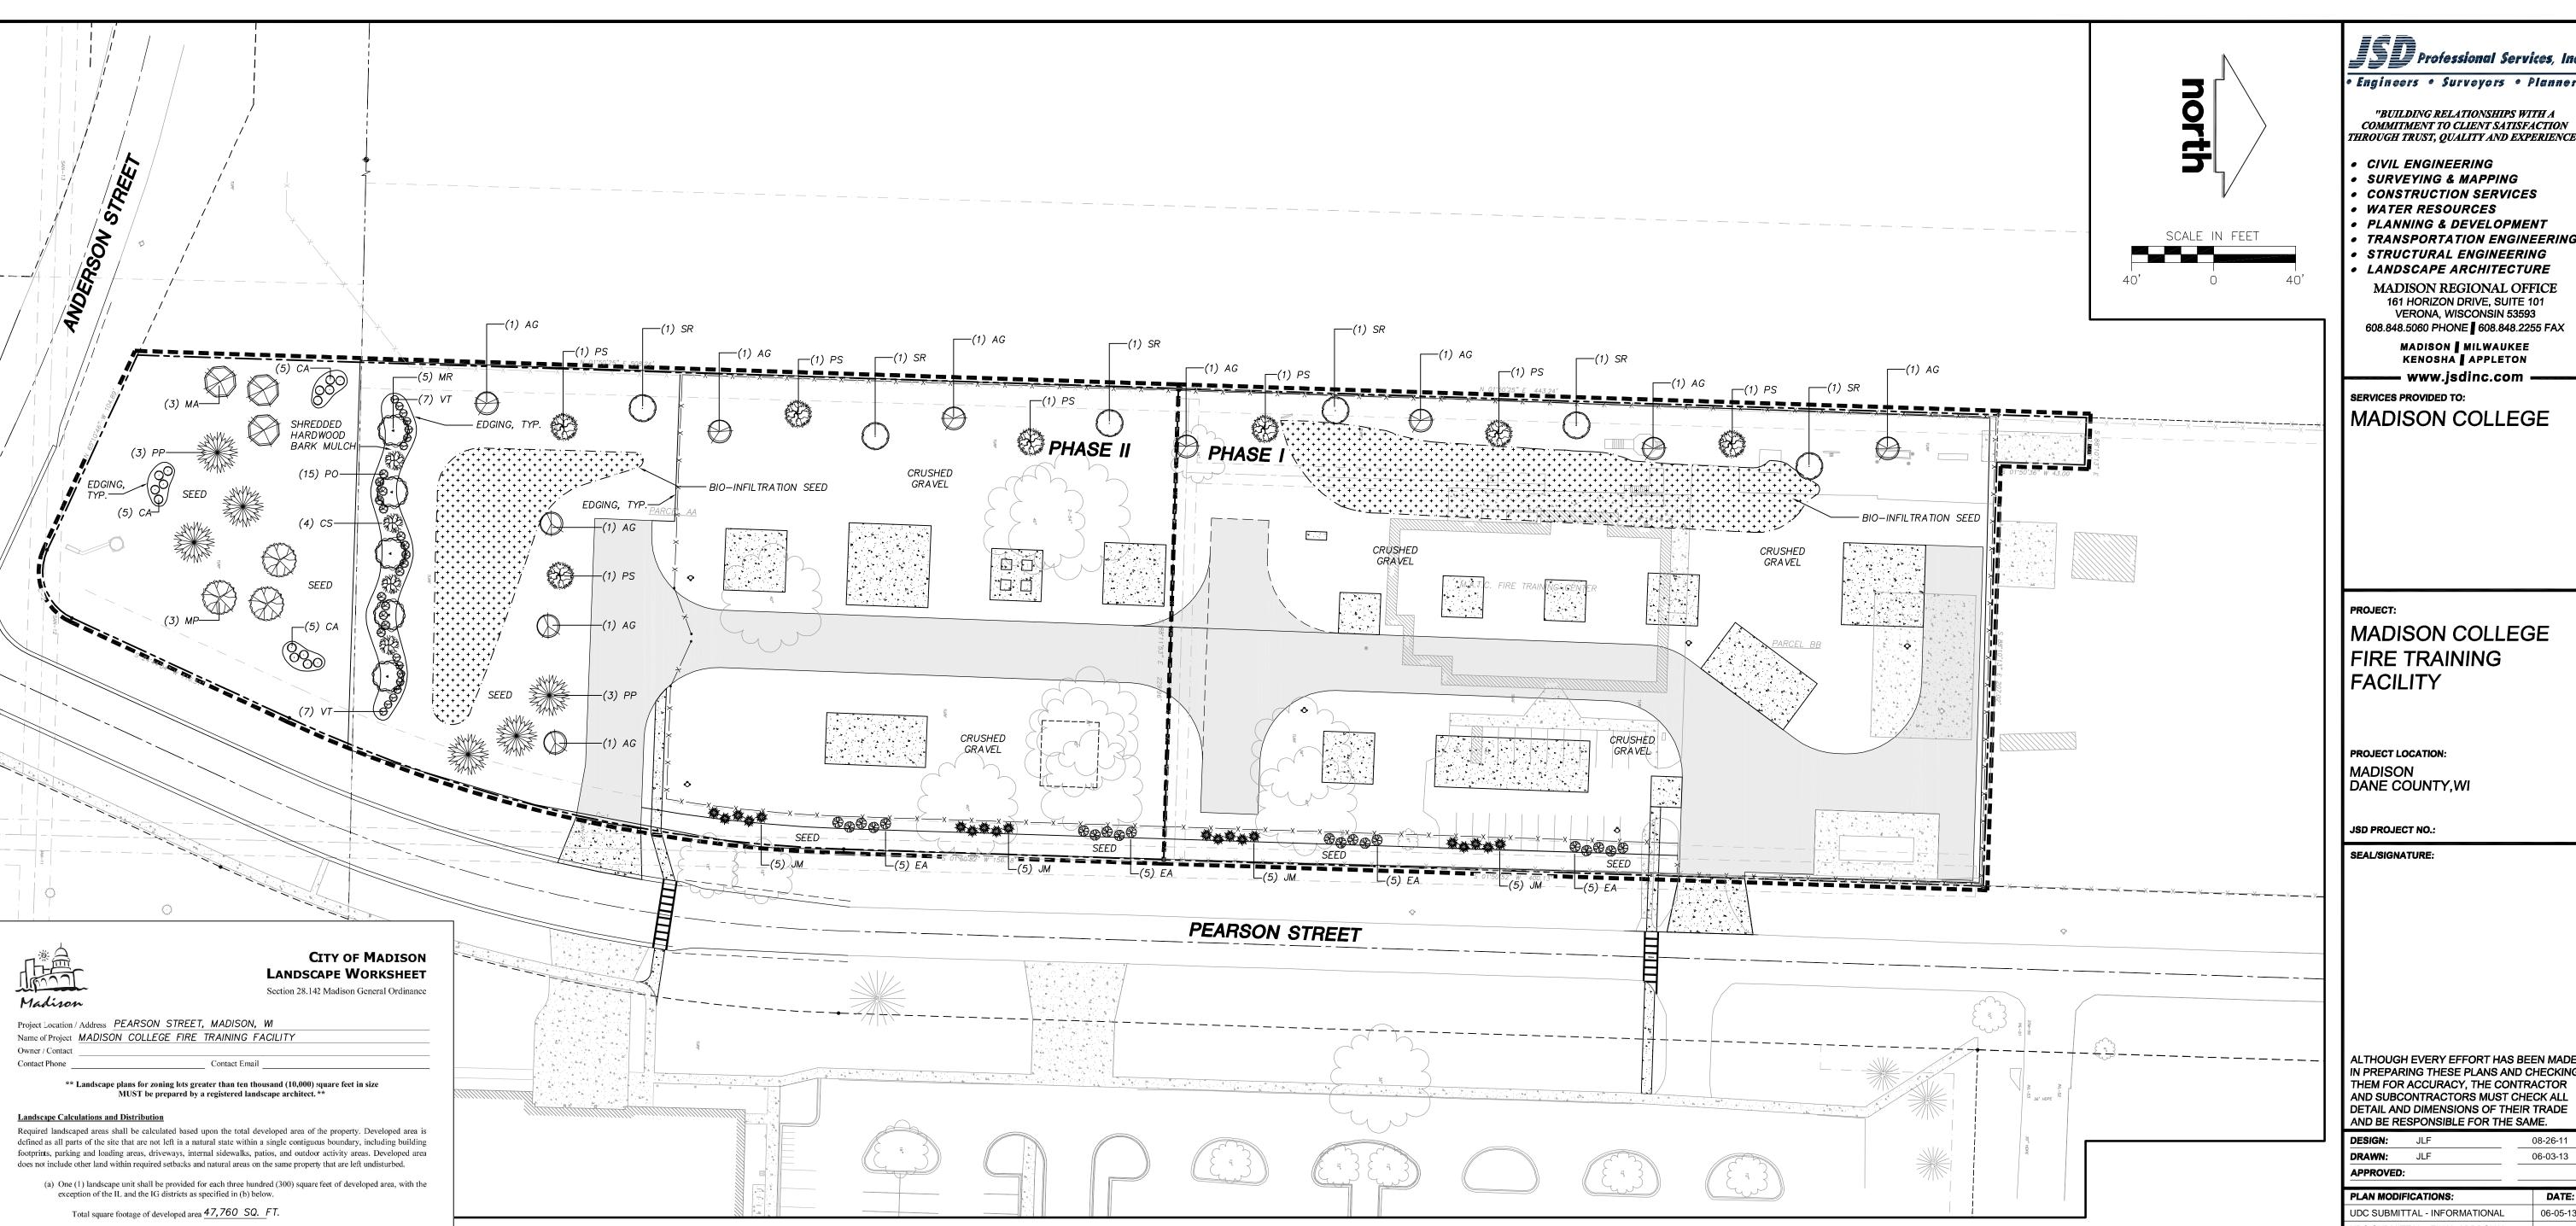

SYM	QTY.	COMMON NAME	BOTANICAL NAME	SIZE	ROOT	POINTS	TOTAL POINTS
LOW E	DECIDUO	JS TREES					
AG	10	Autumn Brilliance Serviceberry	AMELANCHIER x grandiflora 'Autumn Brilliance'	1 1/2"Cal.	B&B	15	150
MA	3	Adams Crabapple	MALUS 'Adams'	1 1/2"Cal.	B&B	15	45
MP	3	Prairifire Crabapple	MALUS 'Prairifire'	1 1/2"Cal.	B&B	15	45
MR	5	Red Baron Crab apple	MALUS 'Red Baron'	1 1/2"Cal.	B&B	15	75
PS	7	Spring Wonder Cherry	PRUNUS sargentii 'Hokkaido Normandale'	1 1/2"Cal.	B&B	15	105
SR	6	Ivory Silk Japanese Tree Lilac	SYRINGA reticulata 'Irory Silk'	1 1/2"Cal.	B&B	15	90
LOW E	VERGRE	EN TREES					
PP	6	Fat Albert Colorado Blue Spruce	PICEA pungens 'Fat Albert'	4' Ht.	B&B	15	90
MEDIU	IM EVER	GREEN SHRUBS					
MJ	20	Mountbatten Juniper	JUNIPERUS chinensis 'Mountb atten'	48" Min Ht.	# 3 Cont.	3	60
LARGI	E DECIDU	OUS SHRUBS					
CS	4	Redosier Dogwood	CORNUS sericea	24-30" Min. Ht.	# 3 Cont.	2	8
EA	20	Chicago Fire Burning Bush	EUONYMUS alatus 'Timber Creek'	24-30" Min. Ht.	#3 Cont.	2	40
PO	15	Dwarf Common Ninebark	PHYSOCARPUS oppulifolius 'Nana'	24-30" Min. Ht.	#3 Cont.	2	30
VT	15	Spring Red Compact Cranberrybush Vib.	VIBURNUM trilob um 'Spring Red'	24-30" Min. Ht.	# 3 Cont.	2	30
ORNA	MENTAL	GRASSES					
CA	15	Karl Foerester Feather Reed Grass	CALAMAGROSTIS x acutiflora 'Karl Foerester'	10 - 12" Ht.	# 1 Cont.	2	30
						TOTAL:	798

GENERAL NOTES

- 1. ALL WORK IN THE ROW AND/OR PUBLIC EASEMENTS SHALL BE IN ACCORDANCE WITH THE CITY OF MADISON STANDARD SPÉCIFICATIONS FOR PUBLIC WORKS CONSTRUCTION.
- 2. JSD SHALL BE HELD HARMLESS AND DOES NOT WARRANT ANY DEVIATIONS BY THE OWNER/CONTRACTOR FROM THE APPROVED CONSTRUCTION PLANS THAT MAY RESULT IN DISCIPLINARY ACTIONS BY ANY OR ALL REGULATORY AGENCIES.
- 3. DRAWING FOR REVIEW NOT FOR CONSTRUCTION UNLESS OTHERWISE NOTED IN THE TITLE
- 4. FOR ALL OTHER LANDSCAPE NOTES AND SPECIFICATIONS PLEASE SEE LANDSCAPE DETAILS AND SPECIFICATIONS SHEET L-2.0.

LEGEND (PROPOSED)

—x——x——x——x—— PROPOSED FENCE LINE ASPHALT PAVEMENT CONCRETE PAVEMENT = 18" CURB AND GUTTER

PHASE I, II EXTENTS

LOW DECIDUOUS TREES



LOW EVERGREEN TREES

MEDIUM EVERGREEN SHRUBS

\$\&\ \& \operatorname{\operatorname{O}} \operatorname{O} \operatorname{

ORNAMENTAL GRASSES

JSD Professional Services, Inc • Engineers • Surveyors • Planner:

"BUILDING RELATIONSHIPS WITH A

- CIVIL ENGINEERING
- SURVEYING & MAPPING
- **CONSTRUCTION SERVICES**
- **WATER RESOURCES** PLANNING & DEVELOPMENT
- TRANSPORTATION ENGINEERING
- STRUCTURAL ENGINEERING
- MADISON REGIONAL OFFICE 161 HORIZON DRIVE, SUITE 101 VERONA, WISCONSIN 53593

608.848.5060 PHONE 608.848.2255 FAX

MADISON MILWAUKEE Kenosha Appleton **—** www.jsdinc.com **-**

SERVICES PROVIDED TO: MADISON COLLEGE

PROJECT:

MADISON COLLEGE FIRE TRAINING FACILITY

PROJECT LOCATION: MADISON DANE COUNTY,WI

JSD PROJECT NO.:

SEAL/SIGNATURE:

ALTHOUGH EVERY EFFORT HAS BEEN MADE IN PREPARING THESE PLANS AND CHECKING THEM FOR ACCURACY, THE CONTRACTOR AND SUBCONTRACTORS MUST CHECK ALL DETAIL AND DIMENSIONS OF THEIR TRADE AND BE RESPONSIBLE FOR THE SAME.

DESIGN: JLF 08-26-11 DRAWN: JLF 06-03-13 APPROVED:

PLAN MODIFICATIONS: DATE: JDC SUBMITTAL - INFORMATIONAL 06-05-13 UDC SUBMITTAL - FINAL APPROVAL 07-17-13

Toll Free (800) 242-8511 Milwaukee Area (414) 259-1181 Hearing Impaired TDD (800) 542-2289 www.DiggersHotline.com

SHEET TITLE:

LANDSCAPE PLAN

Tabulation of Points and Credits Use the table to indicate the quantity and points for all existing and proposed landscape elements. Calculations yielding a fraction up to one-half (1/2 or 0.5) shall be rounded down to the nearest whole number; fractions of more than one half (1/2) shall be rounded up. New/ Proposed Landscaping Minimum Size at Quantity Achieved Installation Overstory deciduous tree 2½ inch caliper 34 510 1 1/2 inch caliper Ornamental tree 90 6 Evergreen tree 3 feet tall 15 18" or 3 gallon Shrub, deciduous 54 108 18" or 3 gallon 20 60 Shrub, evergreen 18" or 3 gallon 15 30 Ornamental grasses container size Ornamental/ decorative fencing or wall 798 Sub Totals

Developed area divided by three hundred (300) square feet = 159.00 Landscape Units (b) Within the Industrial - Limited (IL) and Industrial - General (IG) districts, one (1) landscape unit shall be

Developed area divided by six hundred (600) square feet = _____ Landscape Units

(c) One landscape unit consists of five (5) landscape points. Landscape points are calculated as shown in the


Landscape units multiplied by five (5) landscape points = 795.00 Total Points Required


provided for every six hundred (600) square feet of developed area.

Total square footage of developed area _____

Total Number of Points Provided ______798

3/2013

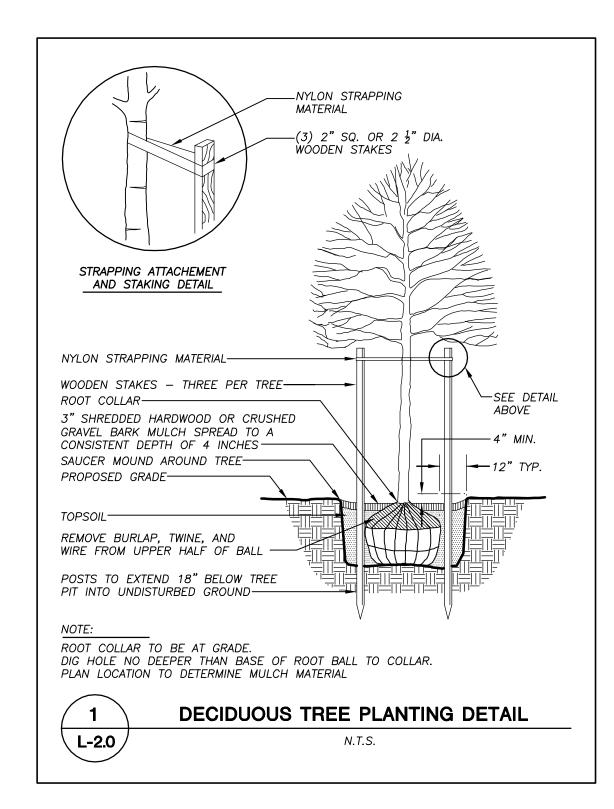

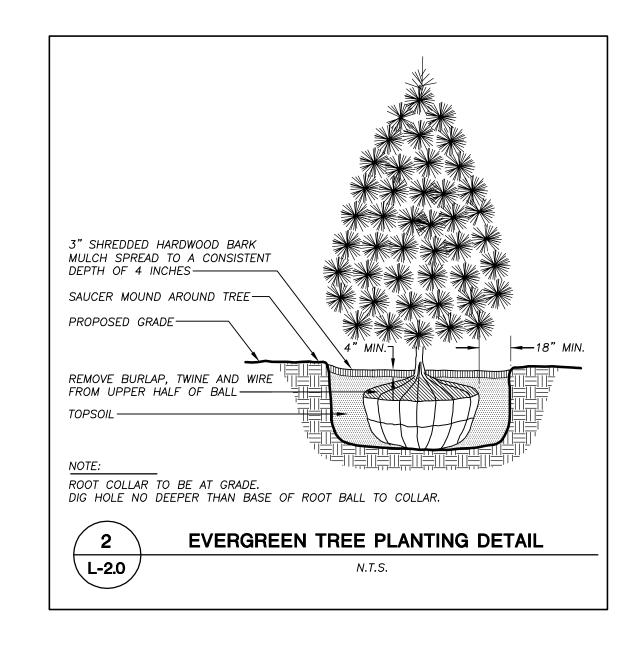



LANDSCAPE NOTES & SPECIFICATIONS


- GENERAL: ALL WORK IN THE R-O-W AND PUBLIC EASEMENTS SHALL BE IN ACCORDANCE WITH THE CITY OF MADISON REQUIREMENTS. JSD SHALL BE HELD HARMLESS AND DOES NOT WARRANT ANY DEVIATIONS BY THE OWNER/CONTRACTOR FROM THE APPROVED CONSTRUCTION PLANS THAT MAY RESULT IN DISCIPLINARY ACTIONS BY ANY OR ALL REGULATORY AGENCIES. LOCATE ALL UTILITIES PRIOR TO CONSTRUCTION. THE CONTRACTOR IS RESPONSIBLE FOR REPAIRING ANY DAMAGE DONE TO UTILITIES. CONTRACTOR MUST CALL 1-800-382-5544 FOR UTILITY LOCATIONS AT LEAST THREE DAYS PRIOR TO DIGGING. HAND DIG AND INSTALL ALL PLANTS THAT ARE NEAR EXISTING UTILITIES. PROTECT PREVIOUSLY INSTALLED WORK OF OTHER TRADES. CONTRACTOR IS RESPONSIBLE FOR STAKING THE PLANT MATERIALS FOR REVIEW BY OWNER PRIOR TO DIGGING AND PLACEMENT. THE LANDSCAPE CONTRACTOR SHALL COORDINATE ALL FINE GRADING AND RESTORATION WITH THE GRADING CONTRACTOR.
- DELIVERY AND HANDLING: DO NOT DELIVER MORE PLANT MATERIALS THAN CAN BE PLANTED IN ONE DAY. DELIVER PLANTS WITH LEGIBLE IDENTIFICATION LABELS. PROTECT PLANTS DURING DELIVERY AND DO NOT PRUNE PRIOR TO DELIVERY. ALL TREES AND SHRUBS SHALL BE PLANTED ON THE DAY OF DELIVERY; IF THIS IS NOT POSSIBLE, PROTECT THAT STOCK NOT PLANTED BY STORING STOCK IN A SHADED AREA PROTECTING THE ROOT MASS WITH WET SOIL, MOSS OR OTHER SUITABLE MEDIA AND KEEPING WELL WATERED. DO NOT REMOVE CONTAINER GROWN STOCK FROM CONTAINERS BEFORE TIME OF PLANTING. DO NOT PICK UP CONTAINER OR BALLED PLANTS BY STEM OR ROOTS. ALL PLANTS SHALL BE LIFTED AND HANDLED FROM THE BOTTOM OF THE BALL. PERFORM ACTUAL PLANTING ONLY WHEN WEATHER AND SOIL CONDITIONS ARE SUITABLE IN ACCORDANCE WITH LOCALLY ACCEPTED
- 3. GUARANTEE: THE CONTRACTOR SHALL GUARANTEE ALL PLANTS THROUGH ONE (1) YEAR AFTER ACCEPTANCE BY OWNER. PLANTS SHALL BE ALIVE AND IN GOOD HEALTHY AND FLOURISHING CONDITION AT THE END OF THE GUARANTEE PERIOD. THE CONTRACTOR SHALL REPLACE WITHOUT COST TO THE OWNER ANY PLANTS THAT ARE DEAD OR NOT IN A VIGOROUS THRIVING CONDITION. REPLACEMENT PLANTS SHALL BE OF THE SAME KIND AND SIZE AS ORIGINALLY SPECIFIED UNLESS OTHERWISE DIRECTED BY OWNER. RESTORE BEDS AS NECESSARY FOLLOWING PLANT REPLACEMENT, INCLUDING BUT NOT LIMITED TO BEDS, EDGING, MULCH, GRASS, ETC. REPAIR DAMAGE TO OTHER PLANTS OR LAWNS DURING PLANT REPLACEMENT AT NO COST TO OWNER. CONTRACTOR SHALL PROVIDE A TWO (2)-YEAR STRAIGHTENING GUARANTEE FOR ALL TREES.
- 4. MATERIALS PLANTS: ALL PLANTS SHALL CONFORM TO THE AMERICAN STANDARD FOR NURSERY STOCK ANSI Z60.1-2004. PLANTS SHALL BE TRUE TO SPECIES AND VARIETY SPECIFIED AND NURSERY GROWN IN ACCORDANCE WITH GOOD HORTICULTURAL PRACTICES UNDER CLIMATIC CONDITIONS SIMILAR TO THOSE IN THE LOCALITY OF THE PROJECT FOR AT LEAST 2 YEARS. PLANTS SHALL BE FRESHLY DUG (DURING THE MOST RECENT FAVORABLE HARVEST SEASON). PLANTS SHALL BE SO TRAINED IN DEVELOPMENT AND APPEARANCE AS TO BE UNQUESTIONABLY SUPERIOR IN FORM, COMPACTNESS, AND SYMMETRY. PLANTS SHALL BE SOUND, HEALTHY, VIGOROUS, WELL BRANCHED AND DENSELY FOLIATED WHEN IN LEAF. AND FREE OF DISEASE AND INSECTS (ADULT EGGS. PUPAE OR LARVAE). THEY SHALL HAVE HEALTHY, WELL-DEVELOPED ROOT SYSTEMS AND SHALL BE FREE FROM PHYSICAL DAMAGE OR OTHER CONDITIONS THAT WOULD PREVENT THRIVING GROWTH. PLANTS SHALL BE OF THE HIGHEST QUALITY, HAVE TYPICAL GROWTH HABITS FOR THEIR SPECIES, BE SOUND, HEALTHY, VIGOROUS AND FREE OF INJURY. PARKWAY TREES AND PARKING LOT TREES SHALL HAVE A MINIMUM BRANCHING HEIGHT OF SIX (6) FEET ABOVE THE GROUND TO ALLOW ADEQUATE VISUAL AND PHYSICAL CLEARANCE.
- 5. CONTRACTOR IS RESPONSIBLE FOR STAKING OF ALL LANDSCAPE MATERIALS AND PLANT LOCATIONS PRIOR TO DIGGING FOR REVIEW BY OWNER OR OWNER'S A/E REPRESENTATIVE.
- 6. MATERIALS SOIL: PLANTING SOIL/COMPACTED TOPSOIL SHALL MEET THESE REQUIREMENTS:
- 1. SEEDED AREAS = 7" 2. PLANTED AREAS AND PARKING ISLANDS = 20"

PLANTING SOIL TO BE A MINIMUM 7" DEPTH, UNLESS OTHERWISE SPECIFIED AS ABOVE OR ON DETAILS. TOPSOIL TO BE CLEAN, FRIABLE LOAM FROM LOCAL SOURCE, FREE FROM STONES OR DEBRIS OVER 3/4" IN DIAMETER, AND FREE FROM TOXINS. TOPSOIL SHALL HAVE A pH BETWEEN 6 AND 7. TOPSOIL AND PLANTING SOIL SHALL BE TESTED TO CONFORM TO THESE SPECIFICATIONS AND SHALL BE AMENDED TO MEET THESE SPECIFICATIONS. DO NOT PLACE FROZEN OR MUDDY TOPSOIL. APPLY SOIL AMENDMENTS TO ALL LANDSCAPE

- 7. MATERIALS PRE-EMERGENT: PRE-EMERGENT HERBICIDE TO BE APPLIED TO ALL PLANTING AREAS PRIOR TO LANDSCAPE INSTALLATION.
- 8. MATERIALS EDGING: EDGING SHALL BE 5" DEEP, BLACK, POLYETHYLENE EDGING 'VALLEY VIEW BLACK DIAMOND' OR APPROVED EQUIVALENT AS APPROVED BY OWNER, EXCEPT FOR TREE RINGS. ALL DECIDUOUS AND EVERGREEN TREES NOT WITHIN EDGED LANDSCAPE PLANTING BEDS SHALL BE INSTALLED WITH A 5' DIAMETER TREE RING WITH SHOVEL CUT EDGING
- 9. SEEDING: ALL DISTURBED AREAS SHALL BE SEEDED AS SPECIFIED IN THESE NOTES.
- 10. MATERIALS SEED: ALL LAWN SEED SHALL BE EARTH CARPET'S 'SURVIVOR' OR OWNER APPROVED EQUIVALENT AS APPROVED BY THE OWNER'S REPRESENTATIVE, INSTALLED PER MANUFACTURER'S RECOMMENDATIONS. IN ADDITION TO LAWN SEED, ANNUAL RYE SHALL BE APPLIED TO ALL DISTURBED AREAS AT A RATE OF 6 LBS PER 1000 SQUARE FEET. FERTILIZE AND MULCH PER MANUFACTURER'S RECOMMENDATIONS.
- 11. MATERIALS SEED: BIORETENTION AREA TO BE HAND SEEDED WITH "DIVERSE PRAIRIE FOR MEDIUM SOILS" SEED MIX (ITEM NO. 50012) AS PROVIDED BY PRAIRIE NURSERY, P.O. BOX 306, WESTFIELD, WISCONSIN, 53964, TEL. 608-296-3679. INSTALL SEED WITH SUPPLEMENTAL MATERIALS AND AMENDMENTS AS RECOMMENDED BY SEED SUPPLIER AND AT RATES AND OPTIMUM TIMES OF THE YEAR AS RECOMMENDED BY THE SEED SUPPLIER TO ENSURE SUCCESSFUL GERMINATION AND SEED/ROOT ZONE GROWTH DEVELOPMENT.
- 12. MATERIALS FERTILIZER AND MULCH: TREES RINGS (TREES NOT WITHIN PLANTING BEDS OUTSIDE OF FENCE AREA) SHALL RECEIVE FINELY SHREDDED, WEED FREE, HARDWOOD BARK MULCH (DYE-FREE) SPREAD TO A CONSISTENT DEPTH OF 4 INCHES OVER ENTIRE PLANTING BED OR TREE RING, UNLESS OTHERWISE SPECIFIED ON PLANS. FERTILIZER SHALL BE IN ACCORDANCE WITH APPLICABLE LOCAL, COUNTY AND STATE OF WISCONSIN REQUIREMENTS.
- 13. MATERIALS MULCH: AREA WITHIN FENCE LIMITS TO RECEIVE CRUSHED GRAVEL. SIZE AND COLOR TO BE DETERMINED BY OWNER PRIOR TO FINAL CONSTRUCTION DOCUMENTS.
- 14. MATERIALS WEED BARRIER FABRIC: ALL PLANTING AREAS AND FENCED AREA WITH CRUSHED GRAVEL SHALL BE INSTALLED WITH WEED BARRIER FABRIC. NO PLASTIC/IMPERVIOUS BARRIERS WILL BE PERMITTED. EXAMPLE: BLACK VISCQUEEN.
- 15. PRUNING: THE CONTRACTOR SHALL PRUNE ALL TREES AND REPAIR ANY INJURIES THAT OCCURRED DURING THE PLANTING PROCESS. DOUBLE LEADERS, DEAD BRANCHES, AND LIMBS DAMAGED OR BROKEN DURING THE PLANTING PROCESS SHALL BE PRUNED. THIS SHALL BE THE ONLY PRUNING ALLOWED AT PLANTING. PRUNING SHALL CONFORM TO AMERICAN STANDARD FOR TREE CARE OPERATIONS, ANSI A300. PRUNE TREES IN ACCORDANCE WITH NAA GUIDELINES. DO NOT TOP TREES. PRUNE SHRUBS ACCORDING TO STANDARD HORTICULTURAL PRACTICES. ON CUTS OVER 3/4" IN DIAMETER AND BRUISES OR SCARS ON BARK, TRACE THE INJURED CAMBIUM LAYER BACK TO LIVING TISSUE AND REMOVE. SMOOTH AND SHAPE WOUNDS SO AS NOT TO RETAIN WATER AND COAT THE TREATED AREA WITH AN APPROVED ANTISEPTIC TREE PAINT.
- 16. CLEANUP: DISPOSE OF EXCESS SOIL. REMOVE ALL CUTTINGS AND WASTE MATERIALS. SOIL, BRANCHES, BINDING AND WRAPPING MATERIALS, REJECTED PLANTS, OR OTHER DEBRIS RESULTING FROM ANY PLANTING SHALL BE PROMPTLY CLEANED UP AND REMOVED. THE WORK AREA SHALL BE KEPT SAFE AND NEAT AT ALL TIMES UNTIL THE CLEANUP OPERATION IS COMPLETED. UNDER NO CONDITION SHALL THE ACCUMULATION OF SOIL, BRANCHES OR OTHER DEBRIS BE ALLOWED UPON A PUBLIC PROPERTY IN SUCH A MANNER AS TO RESULT IN A PUBLIC HAZARD. LIKEWISE, UNDER NO CIRCUMSTANCES SHALL ANY DEBRIS OR INCIDENTAL MATERIALS BE ALLOWED UPON ADJACENT PRIVATE PROPERTY.
- 17. MAINTENANCE: (CONTRACTOR) FOR ALL PLANTINGS, BUFFER AREAS AND SEEDED LAWN AREAS: THE CONTRACTOR SHALL MAINTAIN ALL PLANTINGS AND LAWN AREAS FOR AT LEAST A PERIOD OF 30 DAYS, OR UNTIL FINAL ACCEPTANCE FROM THE OWNER. THE CONTRACTOR IS RESPONSIBLE FOR ADEQUATELY WATERING PLANTS AND LAWN DURING THIS 30 DAY ESTABLISHMENT PERIOD. CONTRACTOR IS RESPONSIBLE FOR THE ESTABLISHMENT OF HEALTHY VIGOROUS PLANT MATERIALS AND LAWN/TURFGRASS GROWTH. CONTRACTOR IS ALSO RESPONSIBLE FOR ANY PRUNING OF PLANT MATERIALS, AND SHAPING AND/OR REPLACEMENT OF DEFICIENT BARK MULCH DURING THIS PERIOD.
- 18. MAINTENANCE: (OWNER) THE OWNER IS RESPONSIBLE FOR THE CONTINUED MAINTENANCE, REPAIR AND REPLACEMENT OF ALL LANDSCAPING MATERIALS AND SEEDED AREAS AS NECESSARY FOLLOWING THE ONE (1) YEAR PLANT GUARANTEE PERIOD.

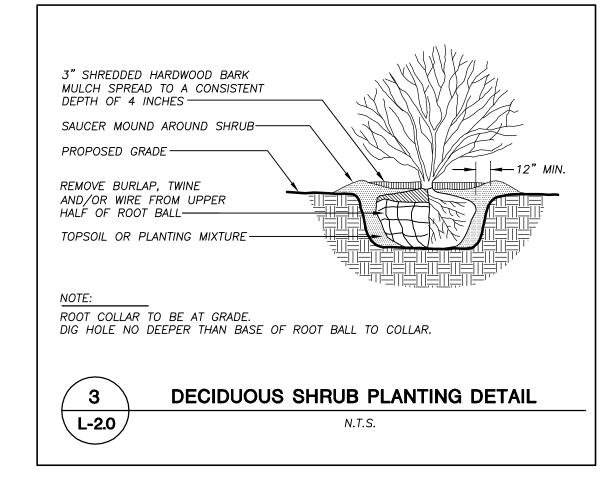

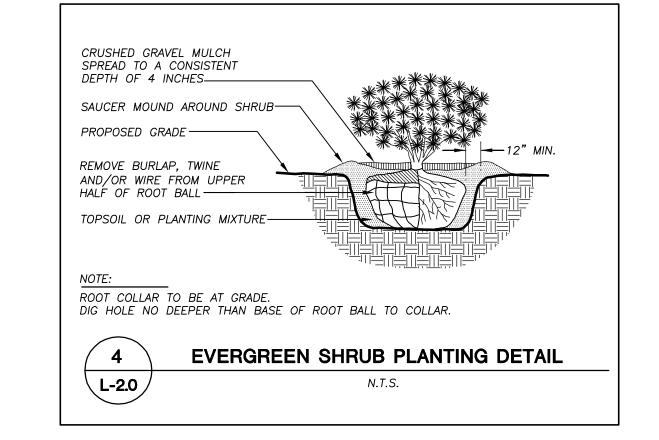

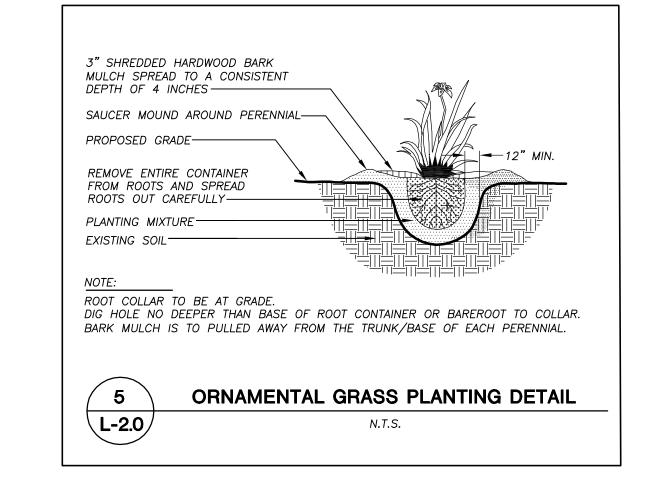



"BUILDING RELATIONSHIPS WITH A COMMITMENT TO CLIENT SATISFACTION THROUGH TRUST, QUALITY AND EXPERIENCE

- CIVIL ENGINEERING
- SURVEYING & MAPPING CONSTRUCTION SERVICES
- **WATER RESOURCES**
- PLANNING & DEVELOPMENT
- TRANSPORTATION ENGINEERING STRUCTURAL ENGINEERING
- LANDSCAPE ARCHITECTURE MADISON REGIONAL OFFICE 161 HORIZON DRIVE, SUITE 101

VERONA, WISCONSIN 53593 608.848.5060 PHONE 608.848.2255 FAX MADISON | MILWAUKEE

KENOSHA APPLETON — www.jsdinc.com —

SERVICES PROVIDED TO:

MADISON COLLEGE

MADISON COLLEGE FIRE TRAINING **FACILITY**

PROJECT LOCATION: MADISON DANE COUNTY, WI

JSD PROJECT NO.:

SEAL/SIGNATURE:

ALTHOUGH EVERY EFFORT HAS BEEN MADE IN PREPARING THESE PLANS AND CHECKING THEM FOR ACCURACY, THE CONTRACTOR AND SUBCONTRACTORS MUST CHECK ALL **DETAIL AND DIMENSIONS OF THEIR TRADE** AND BE RESPONSIBLE FOR THE SAME.

08-26-11 DRAWN: JLF 06-03-13 APPROVED:

PLAN MODIFICATIONS: DATE: JDC SUBMITTAL - INFORMATIONAL 06-05-13 JDC SUBMITTAL - FINAL APPROVAL 07-16-13



Toll Free (800) 242-8511 Milwaukee Area (414) 259-1181 Hearing Impaired TDD (800) 542-2289 www.DiggersHotline.com

SHEET TITLE:

LANDSCAPE DETAILS & SPECIFICATIONS